
# Existing Zoning:

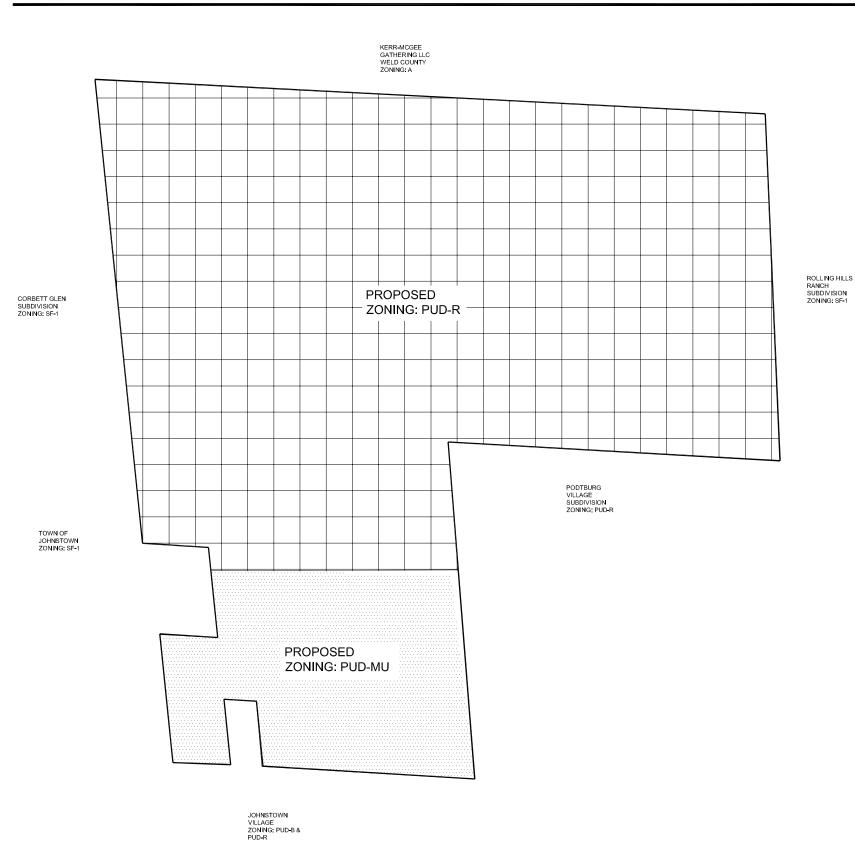

#### Approvals:

JOHNSTOWN LLC, BEING THE OWNER(S) OF THE PROPERTY LOCATED IN THE TOWN OF JONHSTOWN, COUNTY OF WELD, AND STATE OF COLORADO, DO HEREBY SUBMIT THIS OUTLINE DEVELOPMENT PLAN AND AGREE TO PERFORM UNDER THE TERMS NOTED HEREIN.

NAME:

TITLE:

PLANNING AND ZONING COMMISSION

THIS OUTLINE DEVELOMENT PLAN TO BE KNOWN AS , WAS APPROVED BY ACTION OF THE PLANNING AND ZONING COMMISSION OF THE TOWN OF JOHNSTOWN, COLORADO AT A REGULAR MEETING HELD ON THE \_\_\_\_DAY OF \_\_\_\_\_\_, \_\_\_\_\_\_.

CHAIR, PLANNING & ZONING COMMISSIOIN:

TOWN COUNCIL

MEETING OF THE TOWN COUNCIL OF THE TOWN OF JOHNSTOWN, COLORADO HELD ON THE \_\_\_\_\_ DAY OF


MAYOR

ATTEST:

TOWN CLERK

# PURVIS FARM OUTLINE DEVELOPMENT PLAN

LOCATED IN THE SOUTH ONE-HALF OF SECTION 6, TOWNSHIP 4 NORTH, RANGE 67 WEST OF THE SIXTH PRINCIPAL MERIDIAN, COUNTY OF WELD, STATE OF COLORADO

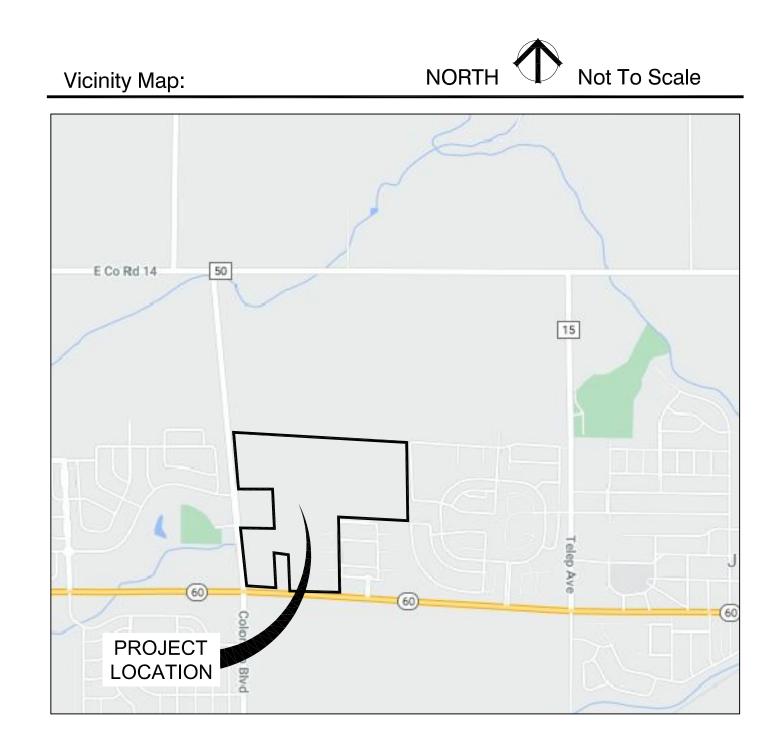

### General Notes:

- 1. ACCESS POINTS SHOWN ON THIS ODP ARE APPROXIMATE. EXACT LOCATIONS TO BE DETERMINED DURING THE PRELIMINARY AND FINAL PLATTING PROCESS BASED ON THE FINAL TRAFFIC IMPACT STUDY.
- 2. LOCAL AND COLLECTOR STREETS MAY CHANGE LOCATION, SIZE AND CONFIGURATION AT TIME OF PLATTING. LOCAL AND COLLECTOR STREETS SHALL CONFORM TO THE TOWN OF JOHNSTOWN STREET STANDARDS AT THE TIME OF PLATTING.
- 3. ALL DENSITIES AND UNIT COUNTS ARE PROJECTIONS, FINAL DENSITIES TO BE DETERMINED AT TIME OF PLATTING. DENSITY OF ANY GIVEN PHASE SHALL NOT EXCEED 9 DU/AC. ACTUAL NUMBER OF UNITS WILL BE DETERMINED AT TIME OF SUBDIVISION PLATTING.
- 4. AREAS OF DEVELOPMENT PARCELS SHOWN ARE APPROXIMATE AND MAY VARY. EXACT LOT SIZES WILL BE DETERMINED WITH EACH PRELIMINARY AND FINAL SUBDIVISION SUBMITTAL.
- 5. FINAL CONFIGURATION OF PARCELS, OPEN SPACE AREAS AND STREETS MAY VARY FROM THAT SHOWN.
- 6. WHERE A PROPOSED USE IS NOT LISTED IN THE ODP, THE TOWN SHALL HAVE SOLE DISCRETION RELATING TO THE PROPOSED USE. 7. ALL DRAINAGE ELEMENTS ARE CONCEPTUAL IN NATURE AND FINAL DETERMINATIONS OF THE DRAINAGE SYSTEM, TO INCLUDE THE PLACEMENT OF DETENTION/RETENTION PONDS, CHANNELS, AND STORM SEWER, WILL BE MADE DURING THE PRELIMINARY AND FINAL DRAINAGE REPORTS AND DURING THE PRELIMINARY DEVELOPMENT PLAN PROCESS AS A PART OF THE FINAL SUBDIVISION PLATTING.
- 8. LANDSCAPING, SIGNAGE, ARCHITECTURE, NON-RESIDENTIAL PARKING, FENCING AND LIGHTING FOR DEVELOPMENT WITH THIS PUD SHALL EITHER FOLLOW THOSE APPLICABLE STANDARDS IN THE TOWN OF JOHNSTON MUNICIPAL CODE OR THE DEVELOPER MAY FORMULATE DESIGN STANDARDS REGULATING THE DESIGN, CHARACTER, LOCATION AND OTHER DETAILS OF THESE ELEMENTS PRIOR TO THEIR IMPLEMENTATION. THE DEVELOPER FORMULATED DESIGN STANDARDS MUST RECEIVE APPROVAL BY THE PLANNING AND DEVELOPMENT DIRECTOR PRIOR TO IMPLEMENTATION.

### Development Phasing:

PHASING WILL OCCUR IN A LOGICAL AND COST EFFECTIVE MANNER BASED ON INFRASTRUCTURE EXTENTION, AVAILABILITY OF UTILITY SERVICE, AND MARKET CONDITIONS. IT IS ANTICIPATED THE PROJECT WILL BE BUILT-OUT IN THREE PHASES. ALL PHASING IS SUBJECT TO TOWN OF JOHNSTOWN AND FRONT RANGE FIRE RESCUE AUTHORITY APPROVAL.

### Legal Description:

A PORTION OF THE SOUTH ONE-HALF OF SECTION 6, TOWNSHIP 4 NORTH, RANGE 67 WEST OF THE SIXTH PRINCIPAL MERIDIAN, COUNTY OF WELD, STATE OF COLORADO.

THE INTENT OF THIS OUTLINE DEVELOPMENT PLAN (ODP) IS TO PROVIDE THE FRAMEWORK FOR THE PURVIS FARM PROPERTY DEVELOPMENT. A HIGH QUALITY RESIDENTIAL COMMUNITY IS ENVISIONED FOR THIS SITE. FOUR PRODUCT TYPES ARE ANTICIPATED AS FOLLOWS:

TOWNHOME UNITS

# Project Team::

#### OWNER:

JOHNSTOWN LLC FORT COLLINS, CO 80524 970.407.7808

JEFF JENSEN 1603 OAKRIDGE DRIVE, SUITE 101 FORT COLLINS CO 80525 970.227.0622 JEFF@JENSENLAPLANTE.COM

PLANNER: CATHY MATHIS TB GROUP 444 MOUNTAIN AVENUE BERTHOUD, CO 80513 970.532.5891

CIVIL ENGINEER: JOHN TUFTE PE

SANDERSON STEWART ENGINEERING FORT COLLINS, CO 80521 855.656.5255

# GROUF landscape architecture planning illustration

444 Mountain Ave. | TEL 970.532.5891 Berthoud,CO 80513 | WEB TBGroup.us



# Narrative/Operation Plan:

SINGLE-FAMILY LOTS (50' X 110') SINGLE-FAMILY LOTS (60' X 110') DUPLEX UNITS

IN ADDITION, +/- 8 ACRES OF COMMERCIAL AND MIXED USE ARE PLANNED FOR THE SOUTHWEST CORNER OF THE PROPERTY

THIS DEVELOPMENT HAS ARTERIAL ROADS LOCATED ON THE SOUTH AND WEST BOUNDARIES OF THE PROPERTY. THE PROXIMITY TO AN ARTERIAL ROAD NETWORK WILL PROVIDE EXCELLENT ACCESS TO THE PROPERTY.

THE PUD WILL PROVIDE VARIOUS OPTIONS FOR THE SITE TO DEVELOP CREATIVELY. FLEXIBILITY IN LOT SIZES AND HOUSING TYPES WILL ENCOURAGE INVENTIVE DESIGN TO FIT MARKET DEMANDS. IN ADDITION, FLEXIBILITY IN OPEN SPACES, PARK LOCATIONS AND THE TRAIL SYSTEM WILL ALLOW FOR A PEDESTRIAN-FRIENDLY COMMUNITY.

114 NORTH MASON STREET

### OWNER'S REPRESENTATIVE

JENSEN LAPLANTE DEVELOPMENT

CATHY@TBGROUP.US

425 EAST MULBERRY STREET

JTUFTE@SANDERSONSTEWART.COM

# PURVIS FARM OUTLINE DEVELOPMENT PLAN

JOHNSTOWN, CO

PROJECT\_TITLE

OWNER: JOHNSTOWN LLC

144 North Mason Street Fort Collins CO 80524

taff Comments	0 <u>3.02.2</u> 1

REVISIONS\_\_\_\_\_DATE

\_\_\_\_\_

\_\_\_\_\_

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December 30, 2020

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# **Cover Sheet**

\_\_\_SHEET\_TITLE-----

#### \_\_\_SHEET INFORMATION

Sheet Number: 2

Of: 5

Sheet Index:

COVER SHEET


CONCEPT PLAN

OUTLINE DEVELOPMENT PLAN

MASTER GRADING & DRAINAGE PLAN

MASTER UTILITY & ACCESS LOCATIONS PLAN

SHEET 1 SHEET 2 SHEET 3 SHEET 4 SHEET 5

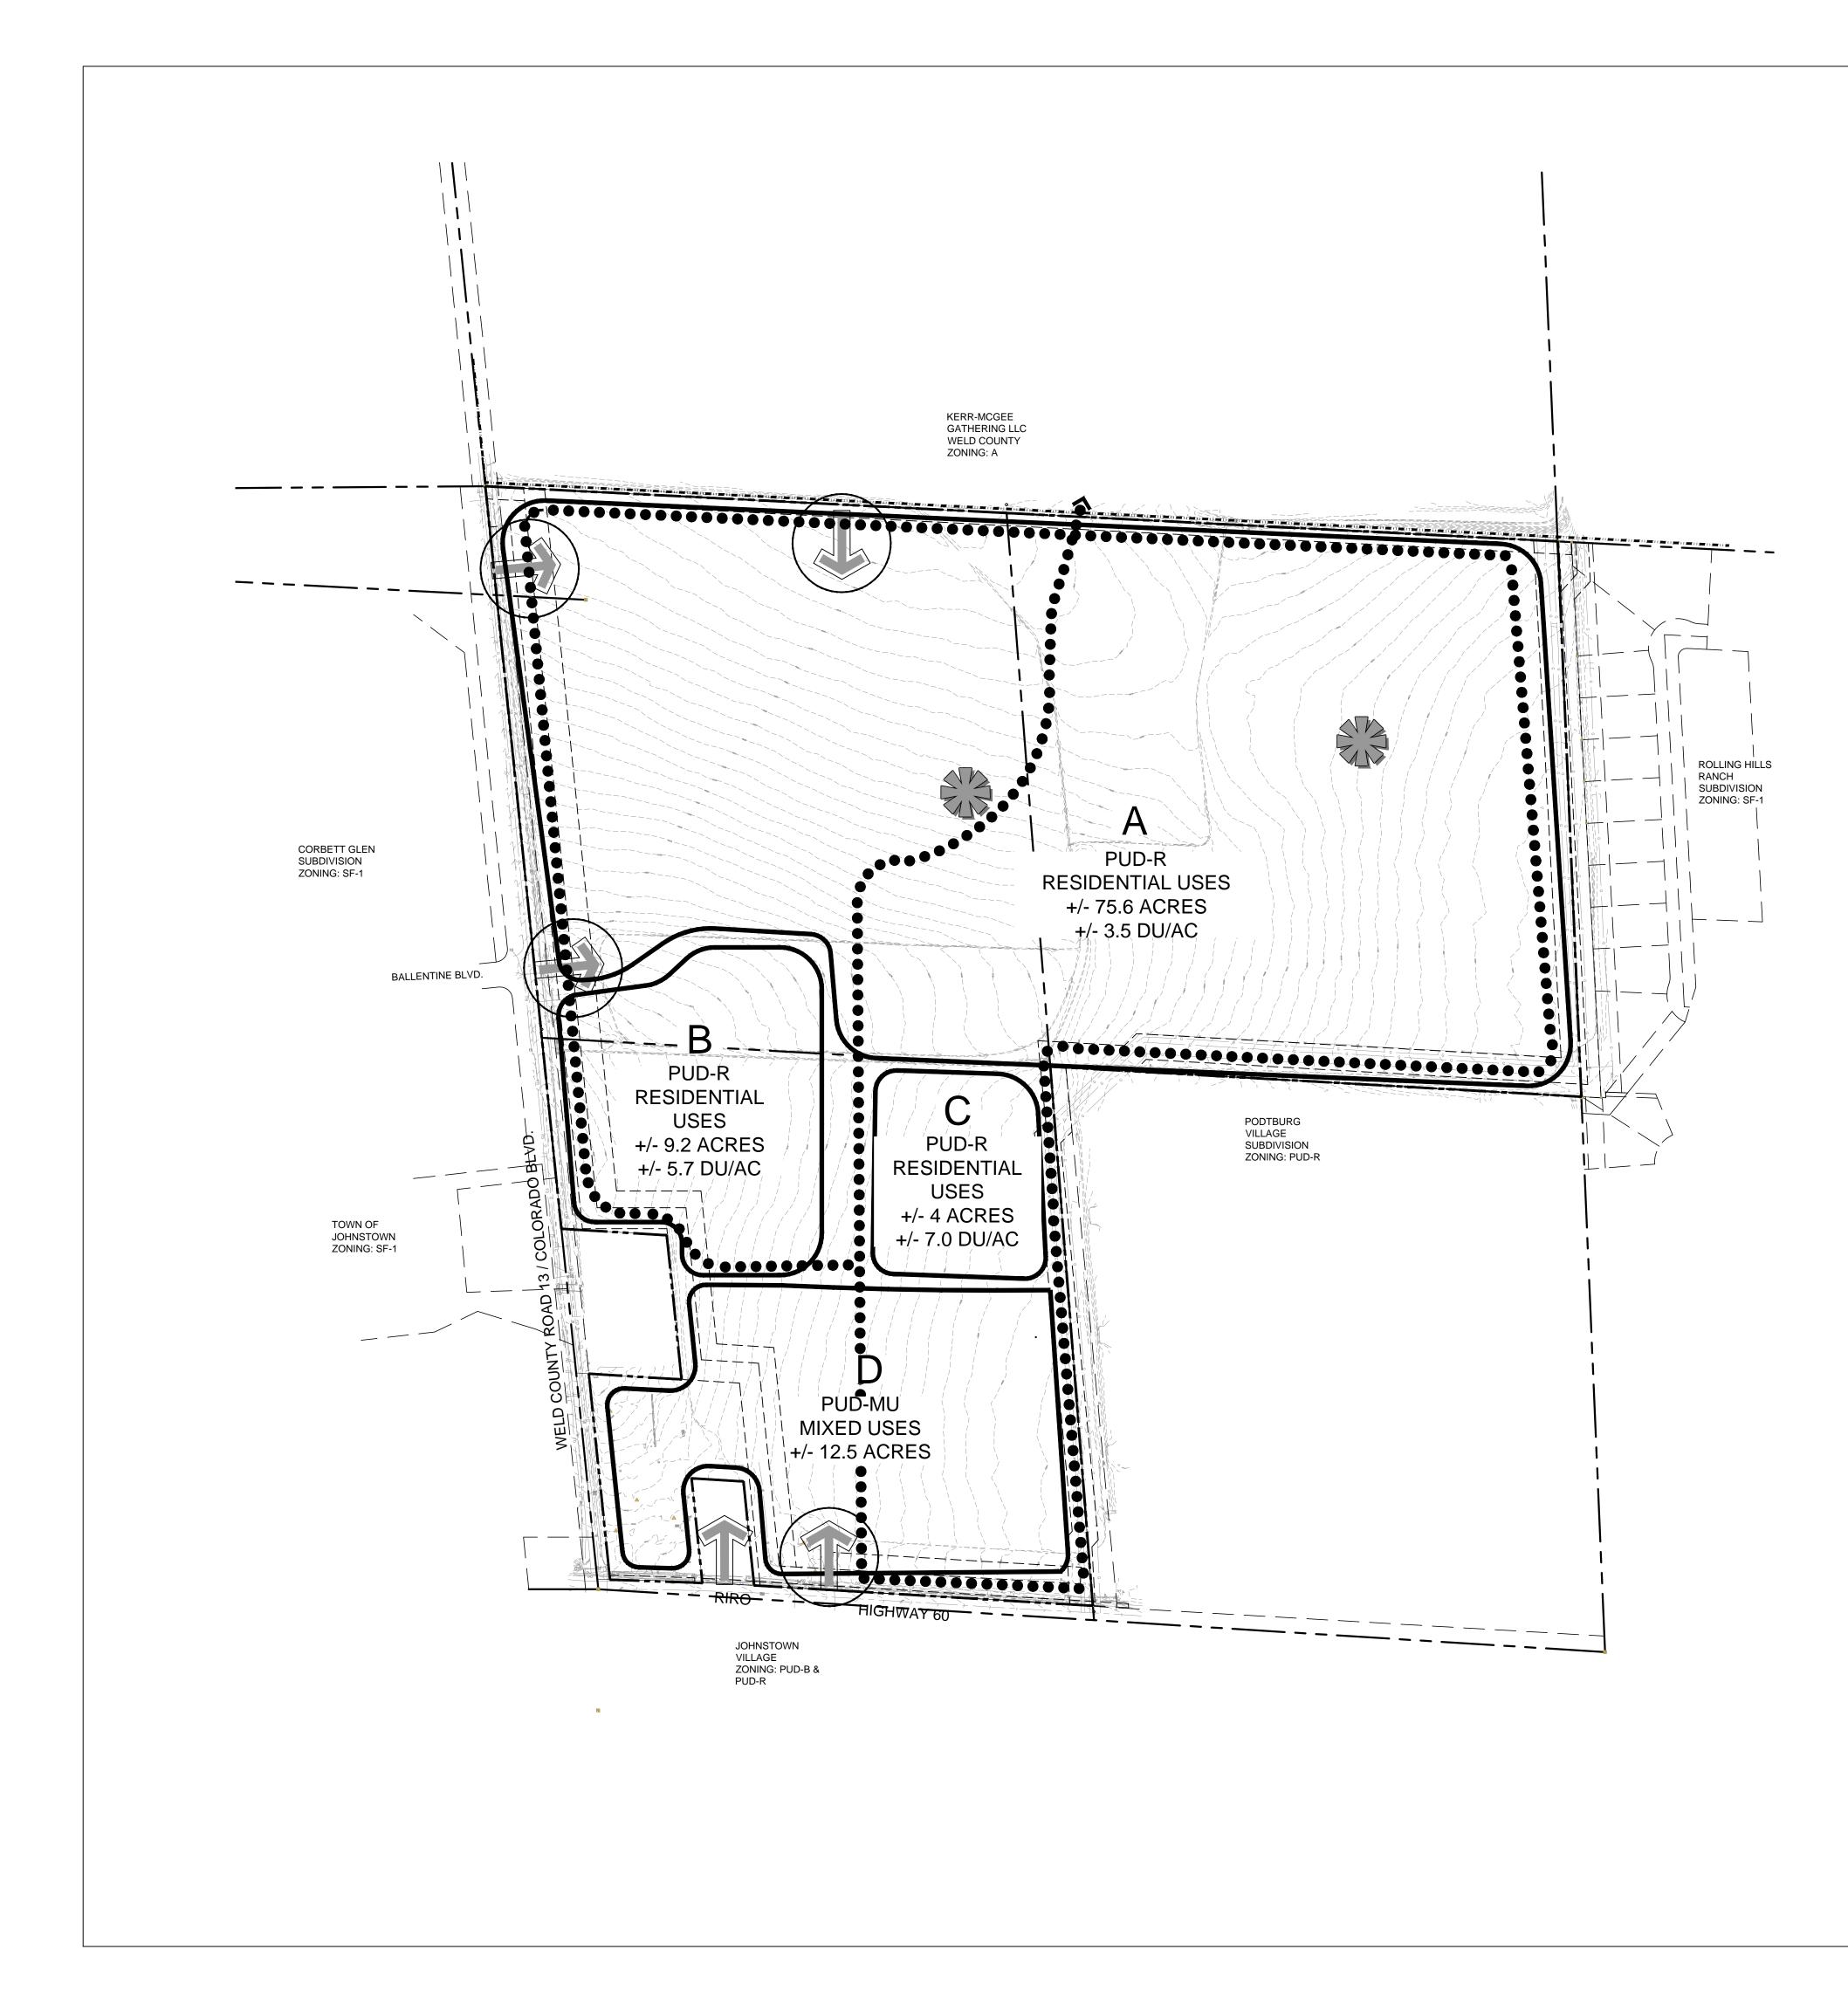

### Density:

	CIPATED RESIDE L DENSITY SHALI	-
·	PLANNING AREA AND A MAXIMUM PLANNING AREA PLANNING AREA MAXIMUM DENSI	DENSITY OF A SHALL HAV D SHALL HAV
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PLA	NNING AREA (PA)	APPROX. ACI

PLANNING AREA (PA	) APPROX. ACREAGE	ANTICIPATED USES	
PA - A	+/- 75.6 AC	RESIDENTIAL USES	
PA - B	+/- 9.2 AC	RESIDENTIAL USES	
PA - C	+/- 4.0 AC	RESIDENTIAL USES	
PA - D	+/- 12.5 AC	MIXED USES	

# Development Standards: Residential

MINIMUM LOT SIZE	4,500 SF		
MAXIMUM HEIGHT	30'		
FRONT SETBACK TO BUILDING HABITABLE SPACE	15'*		
FRONT SETBACK TO GARAGE	20'		
FRONT SETBACK TO SIDE LOADED GARAGE	10'		
SIDE YARD SETBACK	5'		
REAR YARD SETBACK (FRONT LOADED)	10'		
REAR YARD SETBACK (ALLEY LOADED)	5'		
SIDE (CORNER) SETBACK	10'		
5' ENCROACHMENT ALLOWED FOR COVERED PORCHES			
INGLE FAMILY ATTACHED (DUPLEX LOTS)			
MINIMUM LOT SIZE	3,500 SF		
MAXIMUM HEIGHT	35'		
FRONT SETBACK TO BUILDING HABITABLE SPACE	20'*		
FRONT SETBACK TO GARAGE	20'		
FRONT SETBACK TO SIDE LOADED GARAGE	10'		
SIDE YARD SETBACK	0'		
REAR YARD SETBACK (FRONT LOADED)	10'		
REAR YARD SETBACK (ALLEY LOADED)	5'		
SIDE (CORNER) SETBACK	10'		
BUILDING SEPARATION	PER TOWN BUILDING CODE		
5' ENCROACHMENT ALLOWED FOR COVERED PORCHES			
5' ENCROACHMENT ALLOWED FOR COVERED PORCHES INGLE-FAMILY ATTACHED (TOWNHOME LOTS)			
	1,950		
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INGLE-FAMILY ATTACHED (TOWNHOME LOTS) MINIMUM LOT SIZE	1,950		
INGLE-FAMILY ATTACHED (TOWNHOME LOTS) MINIMUM LOT SIZE	1,950 35' (OR 50' WITH		
INGLE-FAMILY ATTACHED (TOWNHOME LOTS) MINIMUM LOT SIZE MAXIMUM HEIGHT	1,950 35' (or 50' with Conditional use approv		
INGLE-FAMILY ATTACHED (TOWNHOME LOTS) MINIMUM LOT SIZE MAXIMUM HEIGHT FRONT SETBACK TO BUILDING HABITABLE SPACE	1,950 35' (OR 50' WITH CONDITIONAL USE APPROV 15'*		
INGLE-FAMILY ATTACHED (TOWNHOME LOTS) MINIMUM LOT SIZE MAXIMUM HEIGHT FRONT SETBACK TO BUILDING HABITABLE SPACE MINIMUM FRONT SETBACK TO GARAGE	1,950 35' (OR 50' WITH CONDITIONAL USE APPROV 15'* 15'		
INGLE-FAMILY ATTACHED (TOWNHOME LOTS) MINIMUM LOT SIZE MAXIMUM HEIGHT FRONT SETBACK TO BUILDING HABITABLE SPACE MINIMUM FRONT SETBACK TO GARAGE FRONT SETBACK TO SIDE LOADED GARAGE	1,950 35' (OR 50' WITH CONDITIONAL USE APPROV 15'* 15' 10'		
INGLE-FAMILY ATTACHED (TOWNHOME LOTS) MINIMUM LOT SIZE MAXIMUM HEIGHT FRONT SETBACK TO BUILDING HABITABLE SPACE MINIMUM FRONT SETBACK TO GARAGE FRONT SETBACK TO SIDE LOADED GARAGE REAR YARD SETBACK (FRONT LOADED)	1,950 35' (OR 50' WITH CONDITIONAL USE APPROV 15'* 15' 10' 10'		
INGLE-FAMILY ATTACHED (TOWNHOME LOTS) MINIMUM LOT SIZE MAXIMUM HEIGHT FRONT SETBACK TO BUILDING HABITABLE SPACE MINIMUM FRONT SETBACK TO GARAGE FRONT SETBACK TO SIDE LOADED GARAGE REAR YARD SETBACK (ALLEY LOADED) REAR YARD SETBACK (ALLEY LOADED)	1,950 35' (OR 50' WITH CONDITIONAL USE APPROV 15'* 15' 10' 10' 5'		
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INGLE-FAMILY ATTACHED (TOWNHOME LOTS) MINIMUM LOT SIZE MAXIMUM HEIGHT FRONT SETBACK TO BUILDING HABITABLE SPACE MINIMUM FRONT SETBACK TO GARAGE FRONT SETBACK TO SIDE LOADED GARAGE REAR YARD SETBACK (FRONT LOADED) REAR YARD SETBACK (ALLEY LOADED) SIDE (CORNER) SETBACK BUILDING SEPARATION	1,950 35' (OR 50' WITH CONDITIONAL USE APPRO' 15'* 15' 10' 10' 5' 10' PER TOWN BUILDING CODI CHES. NANCE EASEMENT AND SI NDARDS ARE REVISED, TH ANY STANDARDS NOT		

5. GARAGES AND ACCESSORY BUILDINGS SHOULD BE AN INTEGRAL PART OF BOTH THE RESIDENCE AND THE OVERALL SITE. GARAGES AND GARAGE DOORS SHOULD BE DESIGNED SO THAT THEY ARE NOT THE DOMINANT ARCHITECTURAL FEATURES OF THE RESIDENCE. DESIGNS THAT CREATE OPEN- SPACE ENCLOSURES SUCH AS COURTYARDS, ENCLOSED PATIOS, AND PARKING COURTS ARE ENCOURAGED. GARAGES AND ACCESSORY BUILDINGS SHOULD BE CONNECTED TO THE MAIN RESIDENCE THROUGH THE USE OF BREEZEWAYS, PERGOLAS, AND COVERED WALKWAYS. THERE SHALL BE A MAXIMUM OF THREE CAR SPACES IN A GARAGE THAT IS ATTACHED AND FULLY ENCLOSED.

6. THE LANDSCAPE IN COMMON AREAS THROUGHOUT THE COMMUNITY SHOULD EMPHASIZE DROUGHT-TOLERANT AND NATIVE PLANT SPECIES. HOMEOWNERS AND BUILDERS ARE ENCOURAGED TO CONTINUE THIS STYLE OF DESIGN AND USE OF PLANT MATERIALS IN THE YARDS AROUND THE HOMES. LANDSCAPE IMPROVEMENTS ARE STRONGLY ENCOURAGED TO BE DESIGNED WITH WATER EFFICIENCY AS A MAJOR GOAL. THE FOLLOWING DESIGN TREATMENTS SHOULD BE KEPT IN MIND WHEN DESIGNING A WATER EFFICIENT LANDSCAPE: APPROPRIATE TURF SELECTION USE OF MULCH TO MAINTAIN SOIL MOISTURE • ZONING OF PLANT MATERIALS ACCORDING TO THEIR LIGHT AND WATER NEEDS IMPROVEMENT OF THE SOIL WITH ORGANIC MATTER • EFFICIENT IRRIGATION SYSTEMS

• RECIRCULATION OF WATER FOR DECORATIVE WATER FEATURES 7. NO RECREATIONAL VEHICLES, CAMPERS, BOATS, TRAILERS, MOTOR HOMES SHALL BE STORED OR PARKED IN SUCH A MANNER AS TO BE VISIBLE FROM ANY OTHER PROPERTY FOR LONGER THAN 72 HOURS IN A SEVEN (7) DAY PERIOD. SUCH VEHICLES SHALL BE KEPT ONLY WITHIN GARAGES OR ENCLOSED STRUCTURES.

# PLANNING AREA D USES:

CONDITIONAL USES:

- COFFEE SHOP BANK
- VEHICLE REPAIR CHILD CARE CENTER
- LIMITED INDOOR RECREATION ESTABLISHMENT GROCERY STORE
- EQUIPMENT RENTAL ESTABLISHMENT SMALL-SCALE RECEPTION CENTER
- ENTERTAINMENT FACILITY
- RETAIL STORE WITH VEHICLE SERVICING VEHICLE MINOR REPAIR CONVENIENCE RETAIL STORE WITH FUEL SALES

# USES NOT ALLOWED:

- OUTDOOR STORAGE ENCLOSED MINI STORAGE AGRICULTURAL OPERATIONS ANIMAL AGRICULTURE PRISON OR DETENTION CENTER KENNEL, INCLUDING OUTDOOR ANIMAL USE AREAS
- RECREATIONAL VEHICLE PARK SHOOTING RANGE HEAVY MANUFACTURING
- WORKSHOPS AND CUSTOM SMALL INDUSTRY USES

TIES ARE SPECIFIED WITHIN EACH PARCEL. NED AT THE TIME OF PLATTING.	Tŀ

HALL HAVE A MINIMUM DENSITY OF 5 D.U./ACRE 10.0 D.U./ACRE. VE A MAXIMUM DENSITY OF 5.0 D.U./ACRE. AVE A MINIMUM DENSITY OF 10.0 D.U./ACRE WITH NO

PROPER MAINTENANCE AND IRRIGATION SCHEDULES

FAST FOOD RESTAURANT WITH OR WITHOUT DRIVE-THROUGH FACILITIES



# Land Use Summary:

LAND USE RESIDENTIAL DEVELOPMENT: MIXED-USE DEVELOPMENT: TOTAL

ACRES 88.8 AC 12.5 AC 108.5 AC

### Planning Area Boundaries:

PLANNING AREA ACREAGES AND BOUNDARIES ARE PRELIMINARY AND SUBJECT TO CHANGE WITH DETAILED PLANNING. PLANNING ACREAGE MAY CHANGE UP TO 30% WITHOUT A MAJOR AMENDMENT TO THIS PUD DOCUMENT.

# **Development Standards: Commercial**

MAXIMUM HEIGHT	35' (OR 50' WITH CONDITIONAL USE APPROVAL)
LOT COVERAGE	50% BUILDING
LOT COVERAGE	20% LANDSCAPING
SETBACK FROM ARTERIAL	15'
PARKING SETBACK FROM ARTERIAL	50'
NOTES:	

1. ADDITIONAL DESIGN REQUIREMENTS FOR COMMERCIAL DEVELOPMENT PER THE DESIGN GUIDELINES TO BE PRESENTED AT FINAL PLAT.

2. THE PLANNING DIRECTOR MAY APPROVE ADJUSTMENTS TO COMMERCIAL SETBACKS THAT MAY BE NECESSARY DUE TO PARCEL SIZE, CONFIGURATION OR OTHER CONSTRAINT.

#### Open Space, Parks & Walks/Trails:

OPEN SPACE 1. 30% OPEN SPACE WILL BE REQUIRED (OVERALL DEVELOPMENT) 2. PUBLIC AND/OR PRIVATELY OWNED LAND WILL BE COUNTED TOWARDS OPEN SPACE REQUIREMENTS. 3. PORTIONS OF DETENTION PONDS WILL BE COUNTED TOWARDS OPEN SPACE REQUIREMENTS AND PARK SPACE CALCULATIONS. 4. PARK SPACE WILL BE COUNTED TOWARDS THE OPEN SPACE

REQUIREMENTS. 5. OPEN SPACE MAY BE A LANDSCAPED AREA., A RECREATION AREA, SIDEWALKS AND/OR TRAILS, PLAZAS OR PLAYGROUNDS OR OTHER AREAS THAT ARE ACCESSIBLE TO THE RESIDENTS OF THE SUBDIVISION OR THE PUBLIC. OPEN SPACE AREAS LOCATED WITHIN A PRIVATE LOT WILL BE ACCESSIBLE TO THE RESIDENT OF THAT LOT ONLY.

 1. 10% PARKS WILL BE REQUIRED BASED ON THE GROSS LAND AREA.
2. PARK LOCATIONS ARE CONCEPTUAL AND WILL BE FINALIZED AT THE TIME OF SUBDIVISION PLAT. 3. PARKS MAY BE PRIVATELY OR PUBLICLY OWNED, TO BE DETERMINED AT THE TIME OF FINAL PLAT. 4. ALL PARKS AND OPEN SPACES ARE ACCESSIBLE TO ALL INDIVIDUALS, REGARDLESS OF RESIDENCE WITHIN THE PURVIS FARM ODP.

PEDESTRIAN CONNECTIVITY: 1. CONCRETE WALKS WILL BE PROVIDED ALONG ALL STREETS.

2. ADDITIONAL WALKS AND/OR TRAILS TO BE DETERMINED AT THE TIME OF MORE DETAILED DESIGN AND/OR SUBDIVISION PLATTING . 3. DEVELOPMENT SHALL INCORPORATE ELEMENTS AND CONNECTIVITY FROM PARKS AND TRAILS MASTER PLAN AND THE JOHNSTOWN COMPREHENSIVE PLAN.

## Parcel Design Intent:

#### PARCELS A, B, AND C :

THE DESIGN INTENT FOR PLANNING AREAS A, B, AND C IS TO ALLOW FOR RESIDENTIAL DEVELOPMENT. RESIDENTIAL DEVELOPMENT COULD INCLUDE SINGLE FAMILY DETACHED, SINGLE FAMILY ATTACHED, TOWNHOMES OR MIXED-USE DEVELOPMENT. OTHER RESIDENTIAL USES NOT LISTED ABOVE WILL BE CONSIDERED/APPROVED BY THE PLANNING DIRECTOR.

#### PARCEL D:

THE DESIGN INTENT FOR PLANNING AREA D IS TO ALLOW FOR A WIDE RANGE OF DEVELOPMENT USES, INCLUDING NEIGHBORHOOD SCALE COMMERCIAL, WHICH COULD INCLUDE A CONVENIENCE STORE WITH FUEL SALES, RETAIL, RESTAURANTS, NEIGHBORHOOD SERVICES. OFFICE/FLEX OR SIMILAR USES. COMMERCIAL AND/OR MIXED-USE DEVELOPMENT IS STRONGLY ENCOURAGED IN THESE PARCELS.

# Site Legend:


PROPERTY BOUNDARY
DEVELOPMENT PARCEL BUBBLES (FOR GRAPHICAL PURPOSES ONLY)
RIGHT OF WAY
CONCRETE TRAIL
POTENTIAL ACCESS POINT - FULL MOVEMENT

POTENTIAL ACCESS POINT - RIGHT ŘÍ/RO IN/RIGHT OUT



POSSIBLE PARK LOCATIONS

JOHNSTOWN TOWN LIMITS

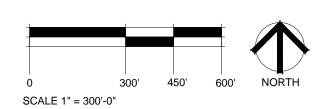



444 Mountain Ave. | TEL 970.532.5891 Berthoud,CO 80513 web TBGroup.us



# **PURVIS FARM** OUTLINE DEVELOPMENT PLAN

JOHNSTOWN, CO

PROJECT T

OWNER: JOHNSTOWN LLC

144 North Mason Street Fort Collins CO 80524

Staff Comments Staff Comments	0 <u>3.02.2</u> 1 04.12.21


REVISIONS

December 30, 2020

# OUTLINE DEVELOPMENT PLAN SHEET INFO

Sheet Number: 2

Of: 5

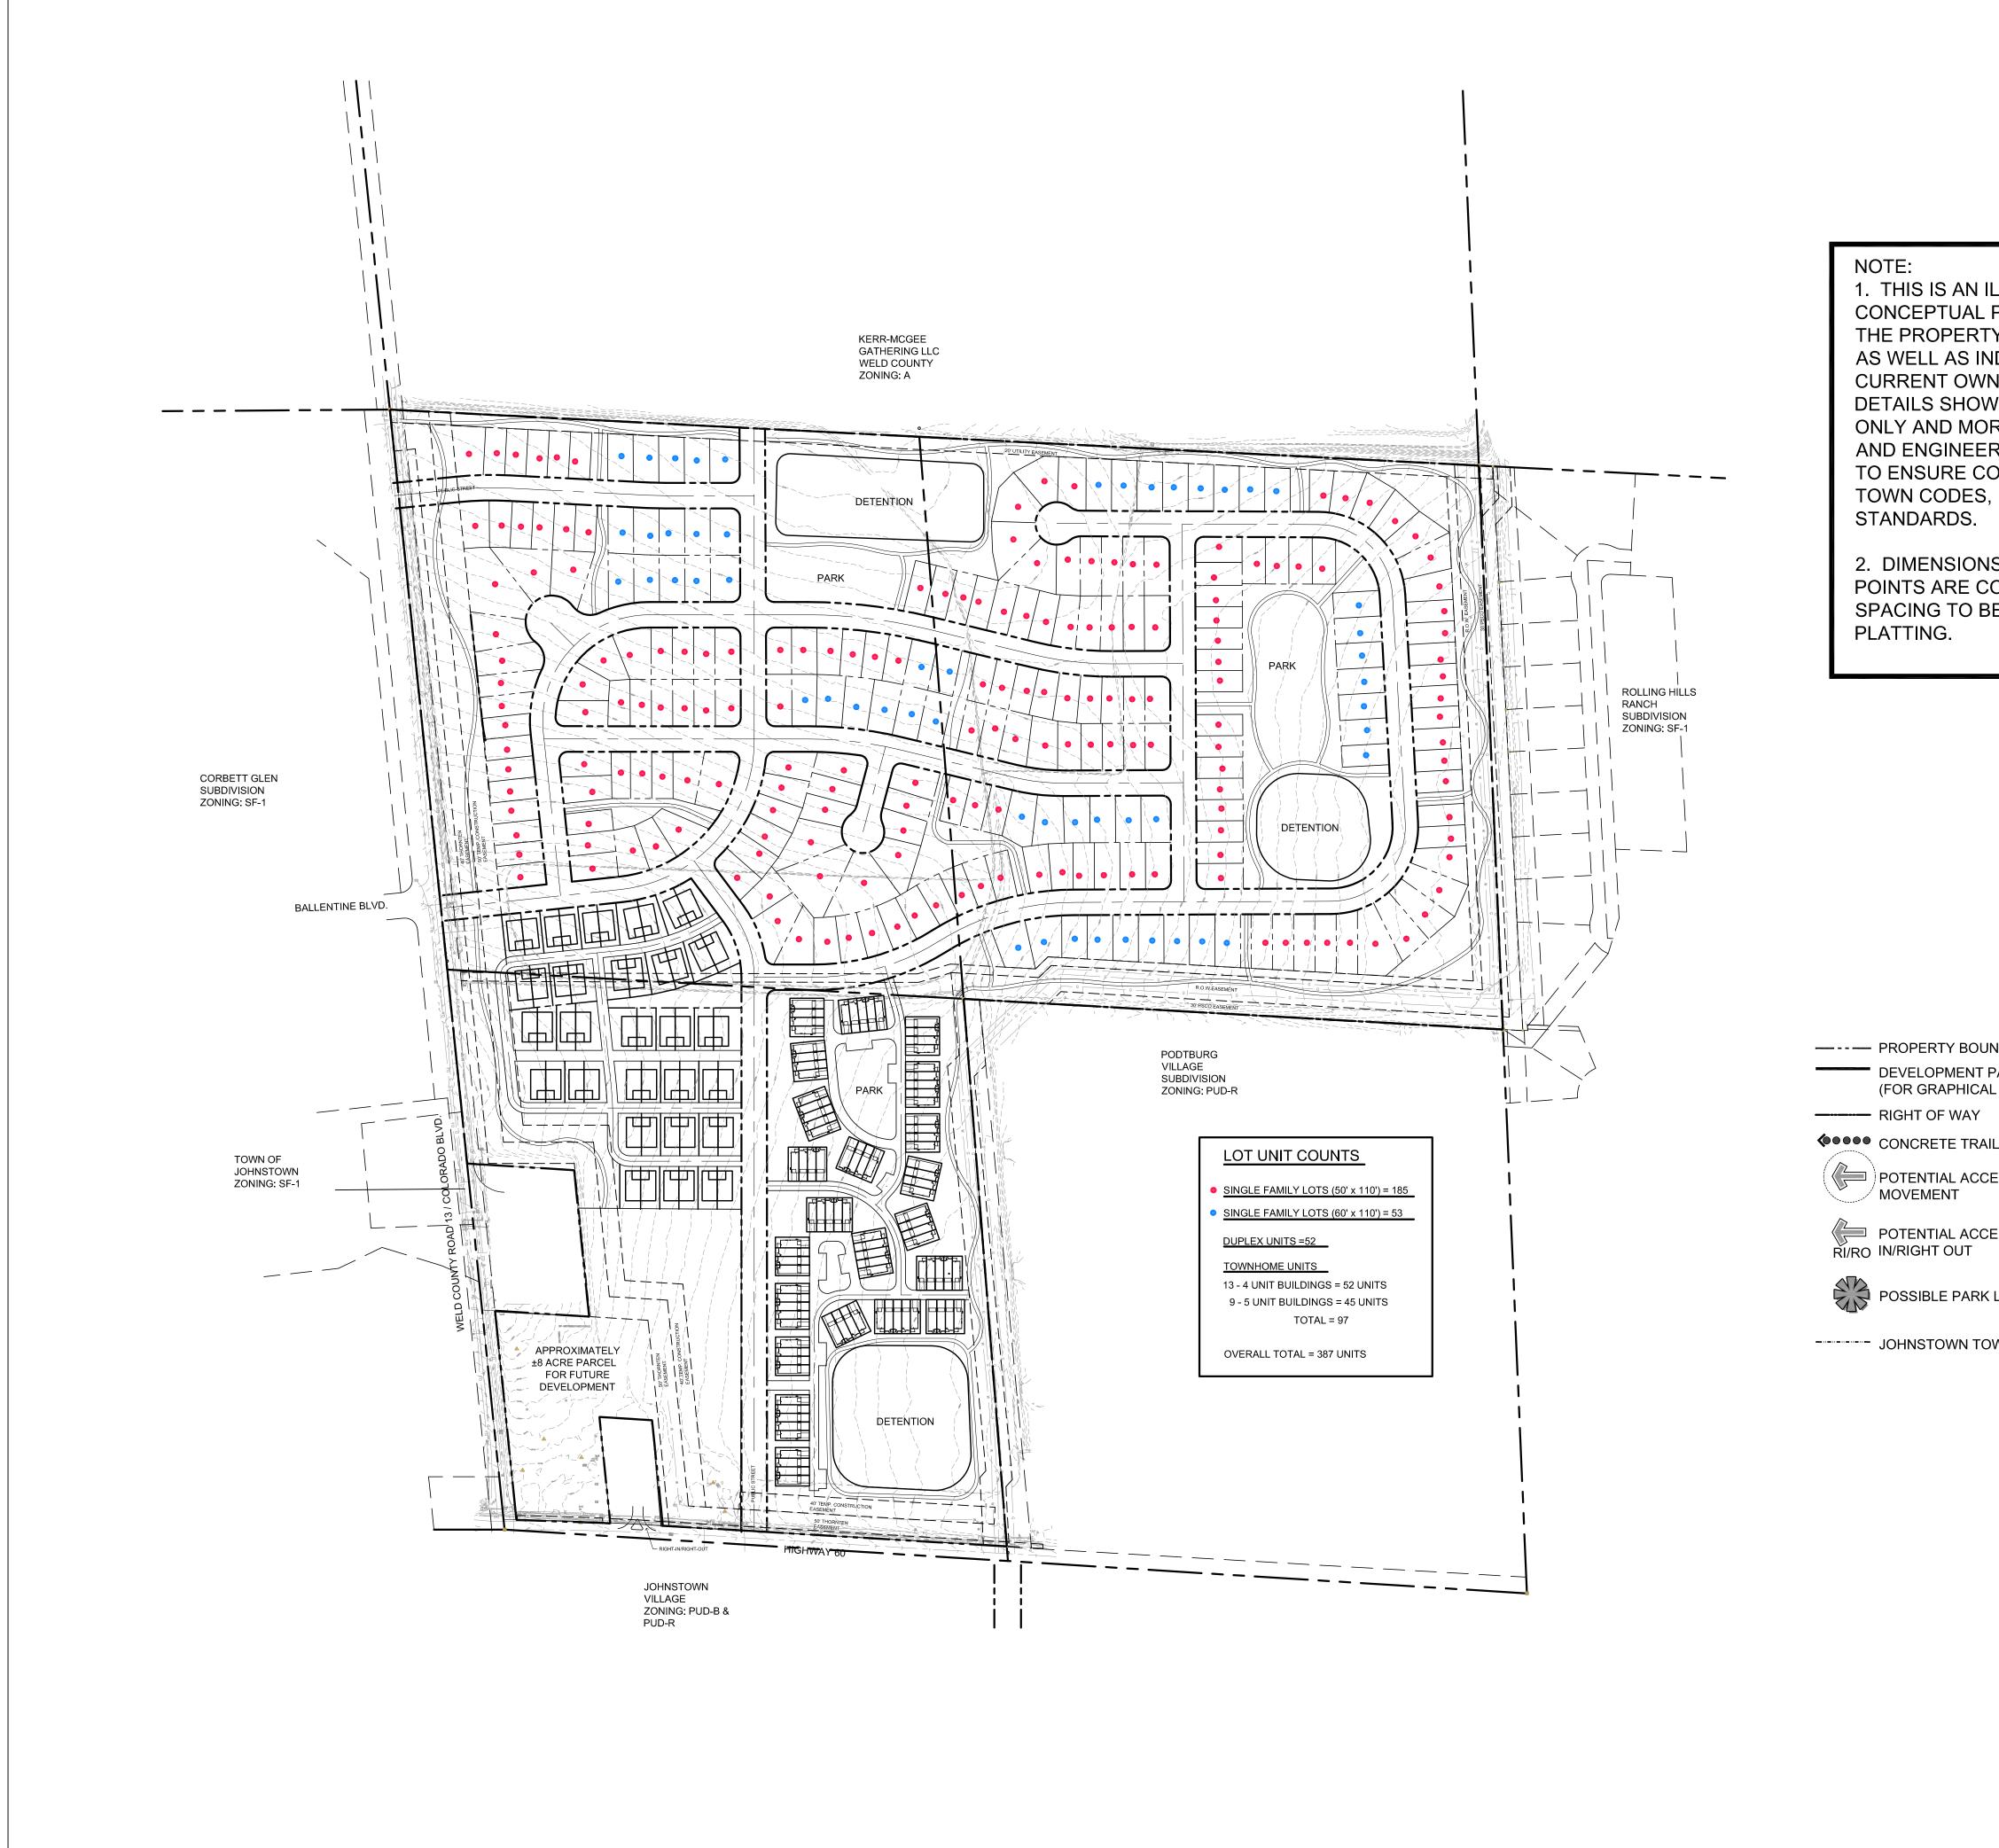

### NOTE: 1. THIS IS AN IL CONCEPTUAL THE PROPERT AS WELL AS IN CURRENT OWN DETAILS SHOW ONLY AND MOF AND ENGINEEF TO ENSURE CC TOWN CODES, STANDARDS.


2. DIMENSIONS POINTS ARE CO SPACING TO BE PLATTING.

		Berthoud,CO 80513   web TBGroup.us
		SANDERSON STEWART
LLUSTRATIVE PLAN TO SHOW HOW Y COULD DEVELOP, IDICATE THE NERS INTENT. ALL VN ARE CONCEPTUAL		PROJECT TITLE PURVIS FARM
RE DETAILED PLANS RING ARE REQUIRED OMPLIANCE WITH REGULATIONS AND		OUTLINE DEVELOPMENT PLAN
S BETWEEN ACCESS ONCEPTUAL. EXACT E DETERMINED AT		JOHNSTOWN, CO PREPARED FOR OWNER: JOHNSTOWN LLC
		144 North Mason Street Fort Collins CO 80524
NDARY		
PARCEL BUBBLES _ PURPOSES ONLY) L ESS POINT - FULL		
ESS POINT - RIGHT		
LOCATIONS WN LIMITS		REVISIONS     DATE       Staff Comments     03.02.21
		December 30, 2020
		Shoot Number: 2
	0 300' 450' 600' NORTH SCALE 1" = 300'-0"	Sheet Number: 3 Of: 5

GROUP

landscape architecture | planning | illustration

444 Mountain Ave. | те. 970.532.5891

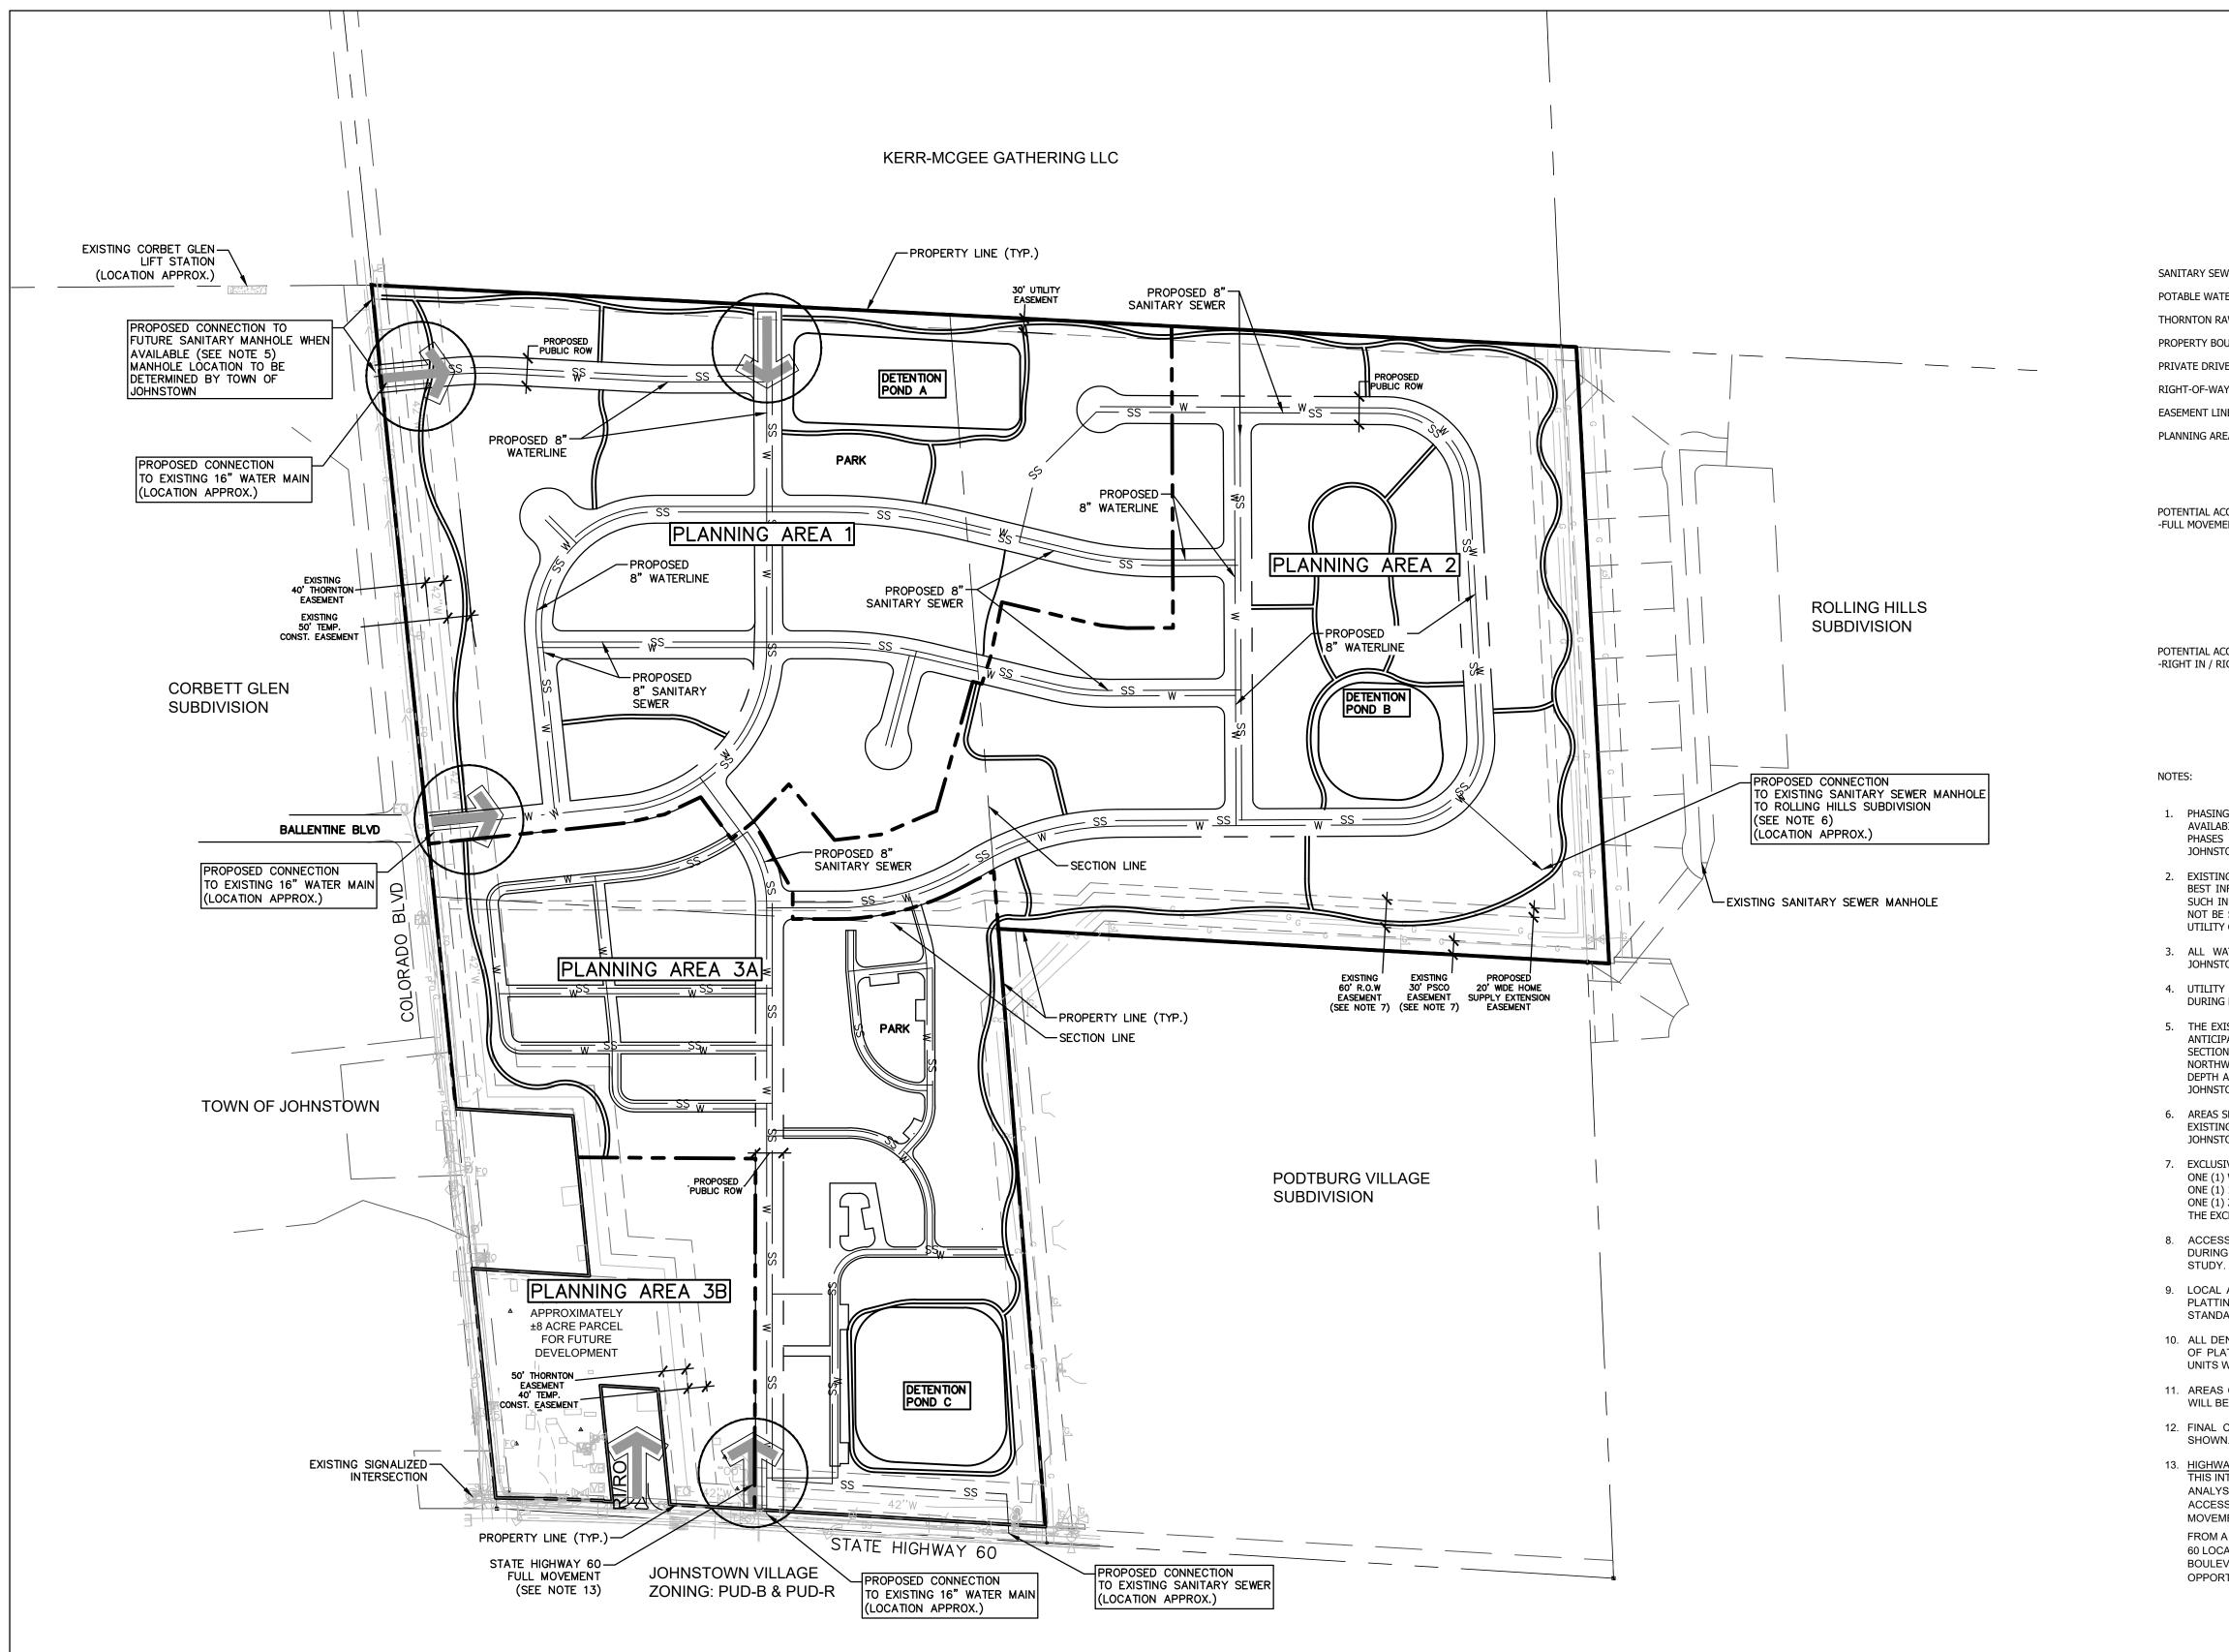

ESTIMATED WATER DEMAND						Pea	
Planning Area	Anticipated Uses	Units	Gross Area (ac)	SFE or Builidng Area (SF)	Average Day Demand (gpm)	Max Day Demand + Fire Flow	Ho Dema (gpi
1&2	Single-Family	238	N/A	238	74.4	1648.8	223
3A	Multi-Family	149	N/A	149	46.6	1593.1	139
3B	Commercial	50% Coverage	8.17	177943	24.9	1549.8	74
TOTALS					145.8	1791.7	43
Planning Area	Anticipated Uses	Units	Gross Area (ac)	SFE or Builidng Area (SF)	Average Flow (gpm)	Peak Flow (gpm)	
1 & 2	Single-Family	238	N/A	238	36.4	141.4	
3A	Multi-Family	149	N/A	149	22.8	95.4	
	Commencial	50% Coverage	8.17	177943	24.7	102.2	
3B	Commercial	John Coverage	0.11				

WASTEWATER ASSUMPTIONS: RESIDENTIAL AVERAGE FLOW (Qa) COMMERCIAL AVERAGE FLOW (Qa)

= 220 GPD/SFE = 200 GPD/1,000 SF BUILDING AREA (DENVER STANDARDS, MARCH 2008, ASSUMING OFFICE/SMALL BUSINESS/BIG BOX STORE USES)  $= 2.6 \times Q_a^{-0.16}$ 

#### WATER ASSUMPTIONS:

PEAKING FACTOR

RESIDENTIAL AVERAGE DAY DEMAND (ADD) COMMERCIAL AVERAGE DAY DEMAND (ADD)

FIRE FLOW AVAILABILITY MAXIMUM DAY DEMAND (MDD) PEAKING HOUR DEMAND

=150 GPCD (ASSUME 3 PEOPLE PER UNIT) = 201.6 GPD/1,000 SF OF BUILDING AREA (GREELEY STANDARDS, JUNE 2008, ASSUMING OFFICE/SMALL BUSINESS/BIG BOX STORE USES ) =1,500 GPM = 2 x ADD

= 1.5 x MDD

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POTENTIAL ACCESS POINT -RIGHT IN / RIGHT OUT



1. PHASING WILL OCCUR IN A LOGICAL AND COST EFFECTIVE MANNER BASED ON INFRASTRUCTURE EXTENSION, AVAILABILITY OF UTILITY SERVICE, AND MARKET CONDITIONS. THE PROJECT WILL BE BUILT IN MULTIPLE PHASES AS THE AFOREMENTIONED CONDITIONS WILL DICTATE. ALL PHASING IS SUBJECT TO TOWN OF JOHNSTOWN AND FRONT RANGE FIRE RESCUE AUTHORITY APPROVAL.

2. EXISTING UNDERGROUND INSTALLATIONS & PRIVATE UTILITIES SHOWN ARE INDICATED ACCORDING TO THE BEST INFORMATION AVAILABLE TO THE ENGINEER. THE ENGINEER DOES NOT GUARANTEE THE ACCURACY OF SUCH INFORMATION. SERVICE LINES (WATER, POWER, GAS, STORM, SEWER, TELEPHONE & TELEVISION) MAY NOT BE STRAIGHT LINES OR AS INDICATED ON THE PLANS. STATE LAW REQUIRES CONTRACTOR TO CALL ALL UTILITY COMPANIES BEFORE EXCAVATION FOR EXACT LOCATIONS.

3. ALL WATER AND WASTEWATER ESTIMATED DEMAND CALCULATIONS WERE BASED ON THE TOWN OF JOHNSTOWN'S PUBLIC IMPROVEMENT DESIGN STANDARDS UNLESS OTHERWISE NOTED.

4. UTILITY MAINS AND SERVICES ARE SHOWN SCHEMATICALLY AND FINAL LOCATIONS WILL BE DETERMINED DURING FINAL PLAT AND CONSTRUCTION DOCUMENT PROCESS THROUGH THE TOWN OF JOHNSTOWN.

5. THE EXISTING LIFT STATION ON THE NORTHWEST CORNER OF THE PROPERTY, WEST OF COLORADO BLVD, IS ANTICIPATED TO BE ABANDONED AND REPLACED WITH A MANHOLE WITHIN THE COLORADO BLVD STREET SECTION BY THE TOWN OF JOHNSTOWN. A MANHOLE DEPTH OF 15-25 FT WOULD MAKE SERVING THE NORTHWEST PORTION OF THE PURVIS FARMS PROJECT SITE FEASIBLE. THE DEVELOPER SHALL COORDINATE THE DEPTH AND LOCATION OF THE FUTURE SANITARY SEWER MAIN WITHIN COLORADO BLVD.WITH THE TOWN OF JOHNSTOWN THROUGHOUT THE PRELIMINARY AND FINAL DESIGN.

6. AREAS SERVED BY THE ROLLING HILLS SANITARY SEWER IS DEPENDENT ON THE ADDITIONAL CAPACITY OF THE EXISTING SEWER SYSTEM. PROPOSED DEMANDS ON THE EXISTING SEWER WILL MEET THE TOWN OF JOHNSTOWN STANDARDS.

7. EXCLUSIVE 60' R.O.W EASEMENT CONTAINS THE FOLLOWING UTILITIES: ONE (1) WATER MAIN (KMG)

ONE (1) 12-INCH LIQUID PÉTROLEUM LINE (WES) ONE (1) 24-INCH NATURAL GAS LINE (WES)

THE EXCLUSIVE 30' PSCO EASEMENT CONTAINS ONE (1) 16-INCH HIGH PRESSURE NATURAL GAS MAIN (XCEL) 8. ACCESS POINTS SHOWN ON THIS ODP ARE APPROXIMATE. EXACT LOCATIONS TO BE DETERMINED DURING THE PRELIMINARY AND FINAL PLATTING PROCESS BASED ON THE FINAL TRAFFIC IMPACT

9. LOCAL AND COLLECTOR STREETS MAY CHANGE LOCATION, SIZE AND CONFIGURATION AT TIME OF PLATTING. LOCAL AND COLLECTOR STREETS SHALL CONFORM TO THE TOWN OF JOHNSTOWN STREET STANDARDS AT THE TIME OF PLATTING.

10. ALL DENSITIES AND UNIT COUNTS ARE PROJECTIONS, FINAL DENSITIES TO BE DETERMINED AT TIME OF PLATTING. DENSITY OF ANY GIVEN PHASE SHALL NOT EXCEED 9 DU/AC. ACTUAL NUMBER OF UNITS WILL BE DETERMINED AT TIME OF SUBDIVISION PLATTING.

11. AREAS OF DEVELOPMENT PARCELS SHOWN ARE APPROXIMATE AND MAY VARY. EXACT LOT SIZES WILL BE DETERMINED WITH EACH PRELIMINARY AND FINAL SUBDIVISION SUBMITTAL.

12. FINAL CONFIGURATION OF PARCELS, OPEN SPACE AREAS AND STREETS MAY VARY FROM THAT SHOWN.

13. <u>HIGHWAY 60 FULL MOVEMENT</u> THIS INTERSECTION IS NOTED AS A DESIRABLE FULL MOVEMENT. OUR TRAFFIC IMPACT STUDY ANALYSIS DOES NOT SUPPORT THIS FULL MOVEMENT IN EXISTING CONDITIONS FROM A SAFETY AND ACCESS PERSPECTIVE. THE TEAM ALSO REALIZES THE ACCESS PLAN CURRENTLY ONLY SHOWS A 3/4 MOVEMENT BUT WOULD LIKE TO DISCUSS OPTIONS.

FROM A LAND DEVELOPMENT PERSPECTIVE, IT IS DESIRABLE TO ADD A FULL MOVEMENT TO HIGHWAY 60 LOCATED APPROXIMATELY 600 FEET EAST OF THE SIGNALIZED INTERSECTION OF COLORADO BOULEVARD. THE DESIGN TEAM WOULD LIKE TO WORK WITH CDOT TO REVIEW FULL MOVEMENT OPPORTUNITIES AND NECESSARY IMPROVEMENTS ALONG HWY 60 TO SUPPORT A FULL MOVEMENT.



200	100	0	200	<u>400</u>

SCALE: 1" = 200'



444 Mountain Ave. TEL 970.532.5891 Berthoud, CO 80513 web TBGroup.us



# PURVIS FARM OUTLINE DEVELOPMENT PLAN

PROJECT TITLE

JOHNSTOWN, CO

PREPARED FOR

OWNER: JOHNSTOWN LLC

144 North Mason Street Fort Collins CO 80524

REVISIONS	DATE
STAFF COMMENTS	03/02/21

DATE


DECEMBER 30, 2020

# SHEET TITLE

### MASTER UTILITY & ACCESS LOCATIONS PLAN SHEET INFORMATION

Sheet Number: 4

Of: 5

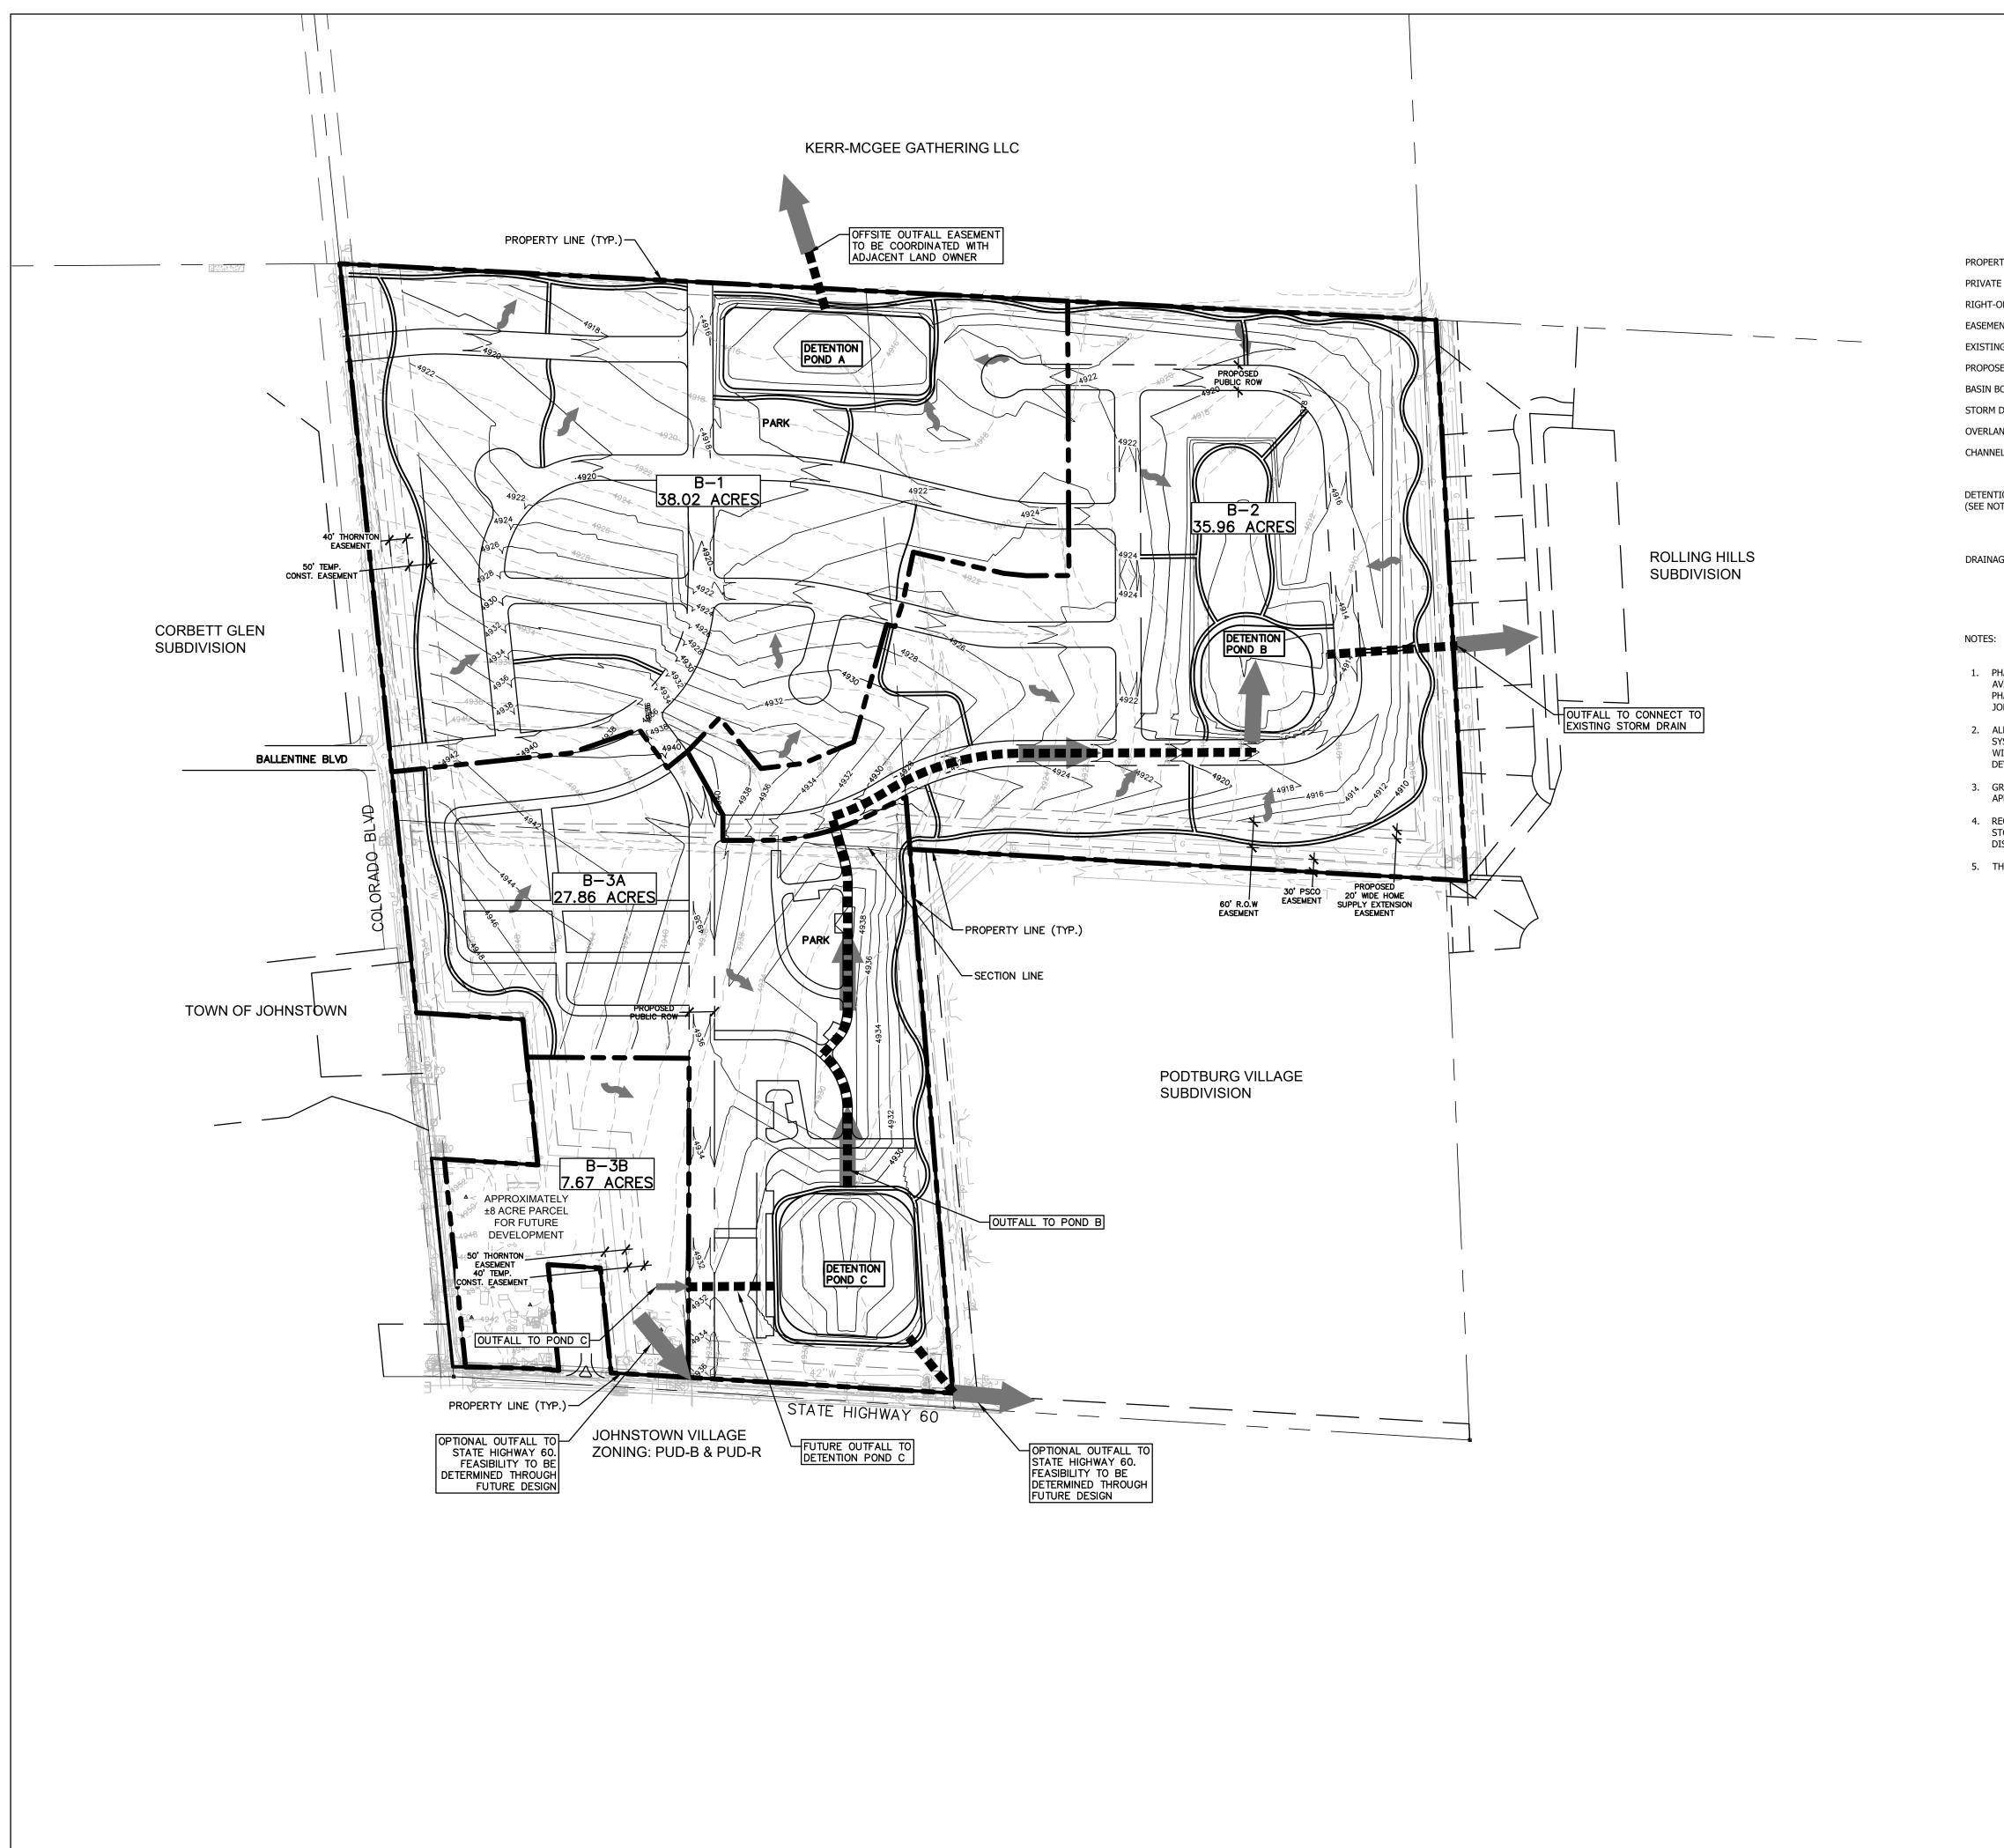

	EXISTING	LEGEND	PROPOSED	
RTY BOUNDARY				
E DRIVE				
OF-WAY				
ENT LINE				
NG 2' CONTOURS				
SED 2' CONTOURS				
BOUNDARY				
DRAIN				
and flow arrow				
ELIZED FLOW ARROW			-	
tion pond outlet Dtes Below)				
AGE BASIN LABEL			BASIN # AREA	

 PHASING WILL OCCUR IN A LOGICAL AND COST EFFECTIVE MANNER BASED ON INFRASTRUCTURE EXTENSION, AVAILABILITY OF UTILITY SERVICE, AND MARKET CONDITIONS. THE PROJECT WILL BE BUILT IN MULTIPLE PHASES AS THE AFOREMENTIONED CONDITIONS WILL DICTATE. ALL PHASING IS SUBJECT TO TOWN OF JOHNSTOWN AND FRONT RANGE FIRE RESCUE AUTHORITY APPROVAL.

2. ALL DRAINAGE ELEMENTS ARE CONCEPTUAL IN NATURE AND FINAL DETERMINATIONS OF THE DRAINAGE SYSTEM, TO INCLUDE THE PLACEMENT OF DETENTION/RETENTION PONDS, CHANNELS, AND STORM SEWER, WILL BE MADE DURING THE PRELIMINARY AND FINAL DRAINAGE REPORTS AND DURING THE PRELIMINARY DEVELOPMENT PLAN PROCESS AS PART OF THE FINAL SUBDIVISION PLATTING.

GRADING AND FINISHED GRADE CONTOURS ARE CONCEPTUAL AND GENERALLY SHOW INTENT AND APPROXIMATE FLOW PATHS. FINAL GRADING WILL BE DETERMINED DURING FINAL DESIGN.
REQUIRED DETENTION VOLUMES AND PEAK DISCHARGES WILL BE CALCULATED PER THE TOWN OF JOHNSTOWN STORM DRAINAGE CRITERIA IN CONJUNCTION WITH NOAA ATLAS 14 RAINEAU DATA & MUE HICH ELOOD

STORM DRAINAGE CRITERIA IN CONJUNCTION WITH NOAA ATLAS 14 RAINFALL DATA & MILE HIGH FLOOD DISTRICT DETENTION SOFTWARE.

5. THE SURVEY OF THE PROJECT SITE WAS COMPLETED OCTOBER 19, 2020 BY MAJESTIC SURVEYING, LLC.

# Indscape architecture | planning | illustration

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JOHNSTOWN, CO

# OWNER: JOHNSTOWN LLC

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	·
	·
	·
	·

DATE

DECEMBER 30, 2020

# SHEET TITLE

# MASTER GRADING & DRAINAGE PLAN

SHEET INFORMATION

Sheet Number: 5

NORTH

)0	100	0	

SCALE: 1" = 200'

Of: 5