### **Owner/Applicant**

**Hartford Acquisitions** 4801 Goodman Rd HARTFORD H O M E 5 970.614.4219

### Planner

russell

**Russell + Mills Studios** 506 S College Ave, Unit A **MIS** Fort Collins, CO 80524 970.484.8855

### **Civil Engineer**

Galloway Suite 210

Galloway 5265 Ronald Reagan Blvd. Johnstown, CO 80534 970.800.3300

### **Traffic Engineer**

**Rollins Consult, LLC** PO Box 1164 Fort Collins, Co 80522 970.213.2393

### **RELATIONSHIP TO TOWN CODE & DEVELOPMENT** STANDARDS

The provisions of this PUD shall prevail and govern development to the extent permitted by the Town of Johnstown municipal code. Where standards, details, and guidelines of the PUD (outline, preliminary, or final development plans) do not clearly address a specific subject or are silent, the Johnstown Municipal Code and other standards, regulations, and guidelines shall be used. All proposed development is subject to Town of Johnstown review procedures.

### GENERAL NOTES

- 1. A metro district shall be established to provide for common area maintenance and financing of the public improvements.
- 2. The site does not contain any known endangered species.
- No archaeological or historic areas have been identified on the site. 4. No floodplains, wetlands, or geologic hazards have been identified or mapped on the site.

### LEGAL DESCRIPTION


THE SOUTHEAST QUARTER OF SECTION 7, TOWNSHIP 4 NORTH, RANGE 67 WEST OF THE 6TH P.M., COUNTY OF WELD, STATE OF COLORADO EXCEPTING THEREFROM RIGHT OF WAY CONVEYED TO THE GREAT WESTERN CONSTRUCTION COMPANY BY DEED RECORDED IN BOOK 194, PAGE 290 AND RIGHT OF WAY CONVEYED TO THE GREAT WESTERN RAILWAY COMPANY BY DEED RECORDED IN BOOK 163, PAGE 246, WELD COUNTY RECORDS, ALSO EXCEPT RESERVATIONS CONTAINED IN PATENT RECORDED IN BOOK 153, PAGE 40, AND IN DEED RECORDED IN BOOK 50, PAGE 233, WELD COUNTY RECORDS.

### LAND SUMMARY

Existing zoning: PUD-R

LAND USE SUMMARY						
THE GRANARY FILING ONE						
OUTLOTS	AREA (SF)	AREA (ACRES)	OWNERSHIP	MAINTENANCE	USE	% OF TOTAL
А	44,518	1.022	METRO DISTRICT	METRO DISTRICT	PEDESTRIAN ACCESS EASEMENT AND OPEN SPACE	
В	379,604	8.715	METRO DISTRICT	METRO DISTRICT	PEDESTRIAN ACCESS, UTILITY AND DRAINAGE EASEMENT, OPEN SPACE, HILLSBOROUGH DITCH	
С	31,627	0.726	METRO DISTRICT	METRO DISTRICT	PEDESTRIAN ACCESS AND OPEN SPACE	
D	63,451	1.457	METRO DISTRICT	METRO DISTRICT	PEDESTRIAN ACCESS, UTILITY EASEMENT, PARK SPACE	
E	130,503	2.996	METRO DISTRICT	METRO DISTRICT	PEDESTRIAN ACCESS, UTILITY AND DETENTION AND DRAINAGE EASEMENT, OPEN SPACE	
F	989,834	22.723	METRO DISTRICT	METRO DISTRICT	PEDESTRIAN ACCESS AND DRAINAGE EASEMENT AND OPEN SPACE, HILLSBOROUGH DITCH	
G	40,210	0.923	METRO DISTRICT	METRO DISTRICT	PEDESTRIAN ACCESS AND DRAINAGE EASEMENT AND OPEN SPACE	
н	43,603	1.001	METRO DISTRICT	METRO DISTRICT	PEDESTRIAN ACCESS AND DRAINAGE EASEMENT AND OPEN SPACE	
I	24,707	0.567	METRO DISTRICT	METRO DISTRICT	PEDESTRIAN ACCESS EASEMENT AND OPEN SPACE	
J	7,424	0.170	METRO DISTRICT	METRO DISTRICT	PEDESTRIAN ACCESS EASEMENT AND OPEN SPACE	
K	8,068	0.185	METRO DISTRICT	METRO DISTRICT	PEDESTRIAN ACCESS AND OPEN SPACE	
L	4,254	0.098	METRO DISTRICT	METRO DISTRICT	PEDESTRIAN ACCESS AND OPEN SPACE	
М	4,231	0.097	METRO DISTRICT	METRO DISTRICT	PEDESTRIAN ACCESS AND OPEN SPACE	
N	3,484	0.080	METRO DISTRICT	METRO DISTRICT	PEDESTRIAN ACCESS AND OPEN SPACE	
OUTLOTS	1,775,519	40.760				26.18%
TRACT						
A	1,966,640	45.148	METRO DISTRICT	METRO DISTRICT	FUTURE DEVELOPMENT	29.00%
STREET RIGHT OF WAY (ALL PUBLIC ROADWAYS)						
ROAD	AREA (SF)	AREA ACRES				
ROADWAY RIGHT OF WAY	1,211,820	27.820				17.87%
SINGLE FAMILY LOTS						
LOTS	AREA (SF)	AREA ACRES	NUMBER OF LOTS			
SINGLE FAMILY LOTS	1,827,869	41.962	287			26.95%
	TOTAL AREA	155.690	TOTAL PERCENTAGE			100.00%



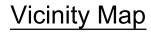




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NORTH

FINAL DEVELOPMENT PLAN

PART OF THE SOUTHEAST QUARTER OF SECTION 7, T 4 N., R. 67 W. OF THE 6TH P.M., COUNTY OF WELD, STATE OF COLORADO

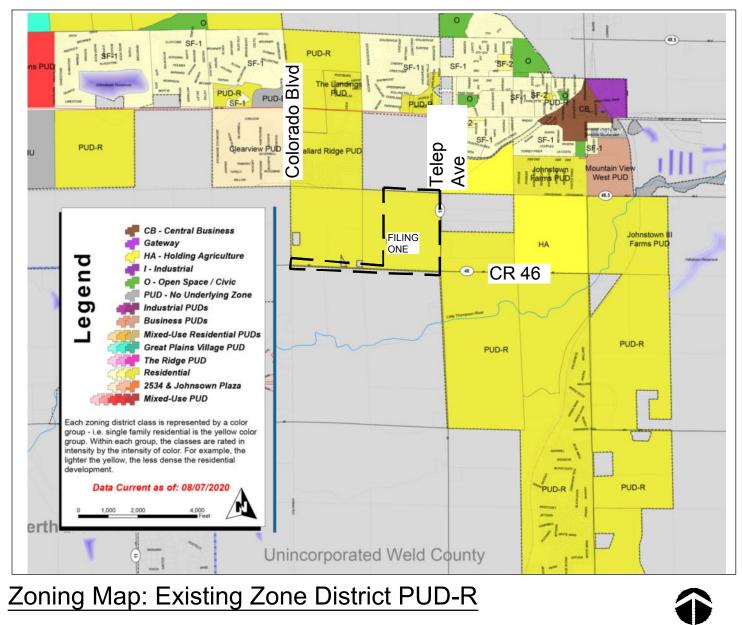

NORTH

G002 - Design G
LS100 - Lot and LS101 - Site Plan LS102 - Site Plan LS103 - Site Plan LS104 - Site Plan LS105 - Site Plan LS106 - Site Plan LS107 - Site Plan LS401 - Site Enla
LP100 - Landsca LP101 - Landsca LP102 - Landsca LP103 - Landsca LP104 - Landsca LP105 - Landsca LP106 - Landsca LP401 - Landsca LP402 - Landsca
OS100 - Open S FP101 - Fencing
FP102 - Fencing FP501 - Fencing
A200 - Building A201 - Building A202 - Building A203 - Building A204 - Building A205 - Building A206 - Building A207 - Building
A209 - Building A210 - Building A211 - Building A212 - Building A213 - Building A214 - Building A215 - Building A216 - Building A217 - Building
A218 - Building

### SHEET INDEX

G001 - Cover

G002 - Desian Guidelines

**Street Typicals** largement Plan - East Park ails ape Schedule and Notes ape Plan ape Plan ape Plan ape Plan ape Plan ape Plan cape Enlargement Plan - East Park ape Enlargement Plan - Entrances ape Details Space Plan l Plan Plan Details Elevations - Christie Farmhouse **Elevations - Christie Farmhouse Elevations - Christie Craftsman Elevations - Christie Craftsman** Elevations - Fitzgerald Farmhouse **Elevations - Fitzgerald Farmhouse** Elevations - Fitzgerald Craftsman **Elevations - Fitzgerald Craftsman Elevations - Hemingway Farmhouse Elevations - Hemingway Farmhouse** Elevations - Hemingway Craftsman Elevations - Hemingway Craftsman **Elevations - Rowling Farmhouse Elevations - Rowling Farmhouse Elevations - Rowling Craftsman Elevations - Rowling Craftsman Elevations - Twain Farmhouse Elevations - Twain Farmhouse Elevations - Twain Craftsman** A219 - Building Elevations - Twain Craftsman

> GRANARY, IS APPROVED AND ACCEPTED BY THE TOWN OF \_, PASSED AND ADOPTED ON FINAL READING MBER TOWN COUNCIL OF THE TOWN OF JOHNSTOWN, COLORADO

ATTEST:

**TOWN CLERK** 

OWN AS THE GRANARY, WAS APPROVED BY ACTION OF THE DAY OF \_\_\_\_\_, \_\_\_\_. ON THE



### NOT FOR CONSTRUCTION

REV.	COMMENT	DATE

FDP FILING ONE and FILING TWO

Date: 02.07.2022 Drawn By: SL

Checked By: CR

Sheet Name

COVER

Sheet

G001

### DESIGN GUIDELINES

### **PART 1 - INTRODUCTION**

### 1.1 STATEMENT OF INTENT

The Granary Filing One is a community in the Town of Johnstown located west of Telep Avenue and between the Great Western Railroad and Roosevelt Parkway. Filing One

### **BUILDING DESIGN STANDARDS** 1. Detached Single family lots:

- a. A minimum of 5 home floorplans/styles shall be available within the development. No one floorplan/style may comprise more than 35% of all homes. These can be modified to meet the below requirements.
- b. Similar house elevations shall not be placed within three (3) lots on either side or across the street per Town of Johnstown Design Statndards.
- c. Adjacent elevations shall have at least two distinguishing characteristics. These may include differences in exterior materials, changes in roof lines, and garage placement / orientation.
- d. Model homes shall be allowed within the PUD in the discretion of the developer; however, the architectural provisions of this PUD shall apply equally to all such model homes. Developer shall be allowed early model home(s) provided there is initial acceptance of subdivision improvements in the area of the model homes that will allow access to and of operation of said home(s). A maximum of one(1) of each model will be permitted.
- e. Sheds less than 120 SF shall be allowed on single-family lots.
- f. Minor cosmetic changes such as different paint color, reversing or creating mirror images of the exterior architectural elevations, shutters, decorative brackets, or using different brick or stone color shall not meet the intent of defining a different elevation.

### 2. Materials:

- a. Acceptable materials include vinyl, cementitious hardboard siding and shingles, stained cedar shingles, painted wood siding, and stucco. Brick and stone (including faux stone) are encouraged but not required.
- b. Siding patterns may include clapboard, shiplap, drop siding, tongue-and-groove (vertical or horizontal), board & batten, and shingle coursing. c. Exposed foundations exceeding eight-inch height on the front elevation are not permitted.
- 3. Building orientation: The primary pedestrian entry and windows shall face a street.
- 4. Front porches: Homes shall include a covered front porch associated with the entry, or other suitable covered architectural feature to accentuate the entry to the home.
- 5. Roofs: The maximum length of a continuous street facing roof ridge is 40 feet, unless the roof is punctuated by dormers or intersections with perpendicular roof systems.
- 6. Garages:
- a. The dwelling units on a block face shall have recessed garages that are a minimum of 4 feet behind either the living area of the home or the front of a covered
- b. Three-car garages, if proposed, shall be:
  - i. Third garage shall be recessed by at least two feet from the two-car garage plane; or,
  - ii. Separated by a two-foot width masonry column from the two-car garage. iii.Tandem configuration

### PARKS AND OPEN SPACE

A large portion of the PUD will be open space with a natural character and trail system for more passive recreation. The existing ditch and detention pond areas will be maintained as open space with trails along them. These areas also will provide a natural/native plant palette that will enhance views and areas of use. Three neighborhood parks will be located centrally within the full build out of the development. A playground with play areas for both 2-5 and 5-12 years, shelter, picnic tables, and turf areas will support active recreation needs within the full build out of the development. 30% open space and 10% park space is required for the project site, per Town code.

# THE GRANARY FILING ONE and FILING TWO

### FINAL DEVELOPMENT PLAN

PART OF THE SOUTHEAST QUARTER OF SECTION 7, T 4 N., R. 67 W. OF THE 6TH P.M., COUNTY OF WELD, STATE OF COLORADO

### LANDSCAPE STANDARDS

The design intent for the THE GRANARY PUD is to create a planned community that celebrates the surrounding plains ecosystem. Water conservation through appropriate landscaping techniques and plant species selection will be emphasized for the project.

### Entry Point Treatment

Entry points into the THE GRANARY PUD from the east, south and west will be emphasized with more dense landscape areas that create a visual backdrop and entry point definition. Architectural elements such as monument signage, large rock displays etc will be utilized to further define these points of access.

### Open Space / Buffer Yard Treatment

Landscape edges along arterial streets will contain a native seed mix with forbes and native perennials. Clusters of drought resistant shrubs (i.e. rabbitbrush, sages, mormon tea, etc) will create a diverse understory with deciduous and evergreen trees (i.e. hackberry, sand cherry, oaks alders, spruce, pine, etc) creating visual interest that is rooted in the context of the upland ecosystem.

### Modified Residential Collector Street Treatment

Tree lawns with shade/canopy trees at 40' o.c. shall be located along modified residential collector streets. Trees shall be a minimum 40' from all street lights. Tree lawns shall be drought tolerant species of bluegrass and fescue species.

### Single-Family Residential Lot Treatment

Individual lot landscaping will be provided by each homeowner, or the builder at the builder's discretion. Design shall be in accordance with the covenants of the community. One(1) tree per lot shall be required in the front yard, two(2) trees shall be required in the front yard of corner lots, one(1) within the front yard and one(1) in the the side yard facing public R.O.W. A minimum of 30% of each single-family lot shall consist of drip irrigated shrub beds with low to medium water use plants.

### Park Treatment

The park playground and activity node areas shall contain irrigated turf areas for field recreation and structured activity uses. Remaining areas shall be landscaped with shrub beds that contain native/drought resistant species. Large shade/canopy trees will be located around areas of congregation to provide shade and structure to the spaces.

### Detention Pond Treatment

Native seed mix with species appropriate for more moist conditions shall be utilized within detention and water channel areas. No irrigated turf lawn shall be permitted within these areas. Shrubs and trees along the edges shall be utilized at source points to filter and clean run off water. Forbays shall be created to contain sediment and create easy maintenance of these structures.

### IRRIGATION

The site will utilize irrigation through the native seed open areas for a three(3) year establishment period, depending on significant droughts. All native seed areas will have irrigation with the exception of the bottoms of the detention ponds. All trees in within native seed areas will be on a separate drip zone. Turf areas along collector street tree lawns and in park areas will have spray/rotor irrigation. All formal shrub beds within the parks will be provided with drip irrigation. Single-family lots will provide permanent irrigation for both front and rear yards.

SETBACKS Front Yard Side Yard Rear Yard

SETBACK ENCROACHMENTS Porches may extend into setback area up to 3' Window wells may extend into setback area up to 3' Roof overhangs may extend into setback area up to 3'

MAXIMUM BUILDING HEIGHT The maximum building height is 35 feet (midpoint of highest ridge and eave).

PORCHES Minimum porch depth to be 6' Minimum porch area to be 48 SF

FENCING

Fencing shall be located as per Fence Type Location Diagram. Three fencing types shall be provided as per details. Side yard Fencing shall terminate a minimum of 5' behind front elevation of house.


### SIGNAGE

A monument sign identifying the final development name shall be located at all four major development entrances. Materials and character of signage shall reflect the overall theme and character of the development. All lighting shall meet Town of Johnstown standards.

### STORAGE

Boats, campers, and trailer vehicles shall only be permitted to be stored within completely closed structures or within areas specifically designated for such storage, provided such areas are behind building setback lines.

15' Habitable Living Area / 20' to Garage 5' to interior lot line / 15' to R.O.W.

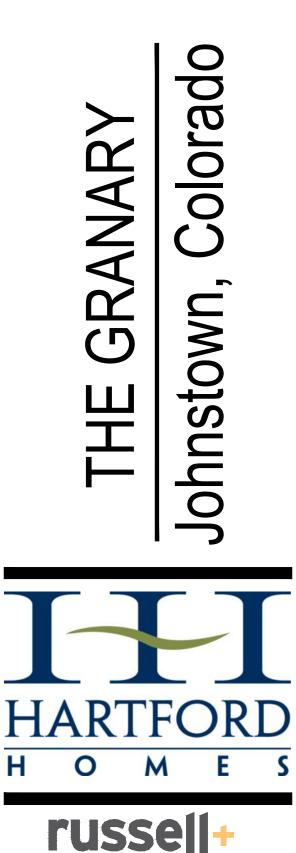



REV.	COMMENT	DATE

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Date: 02.07.2022

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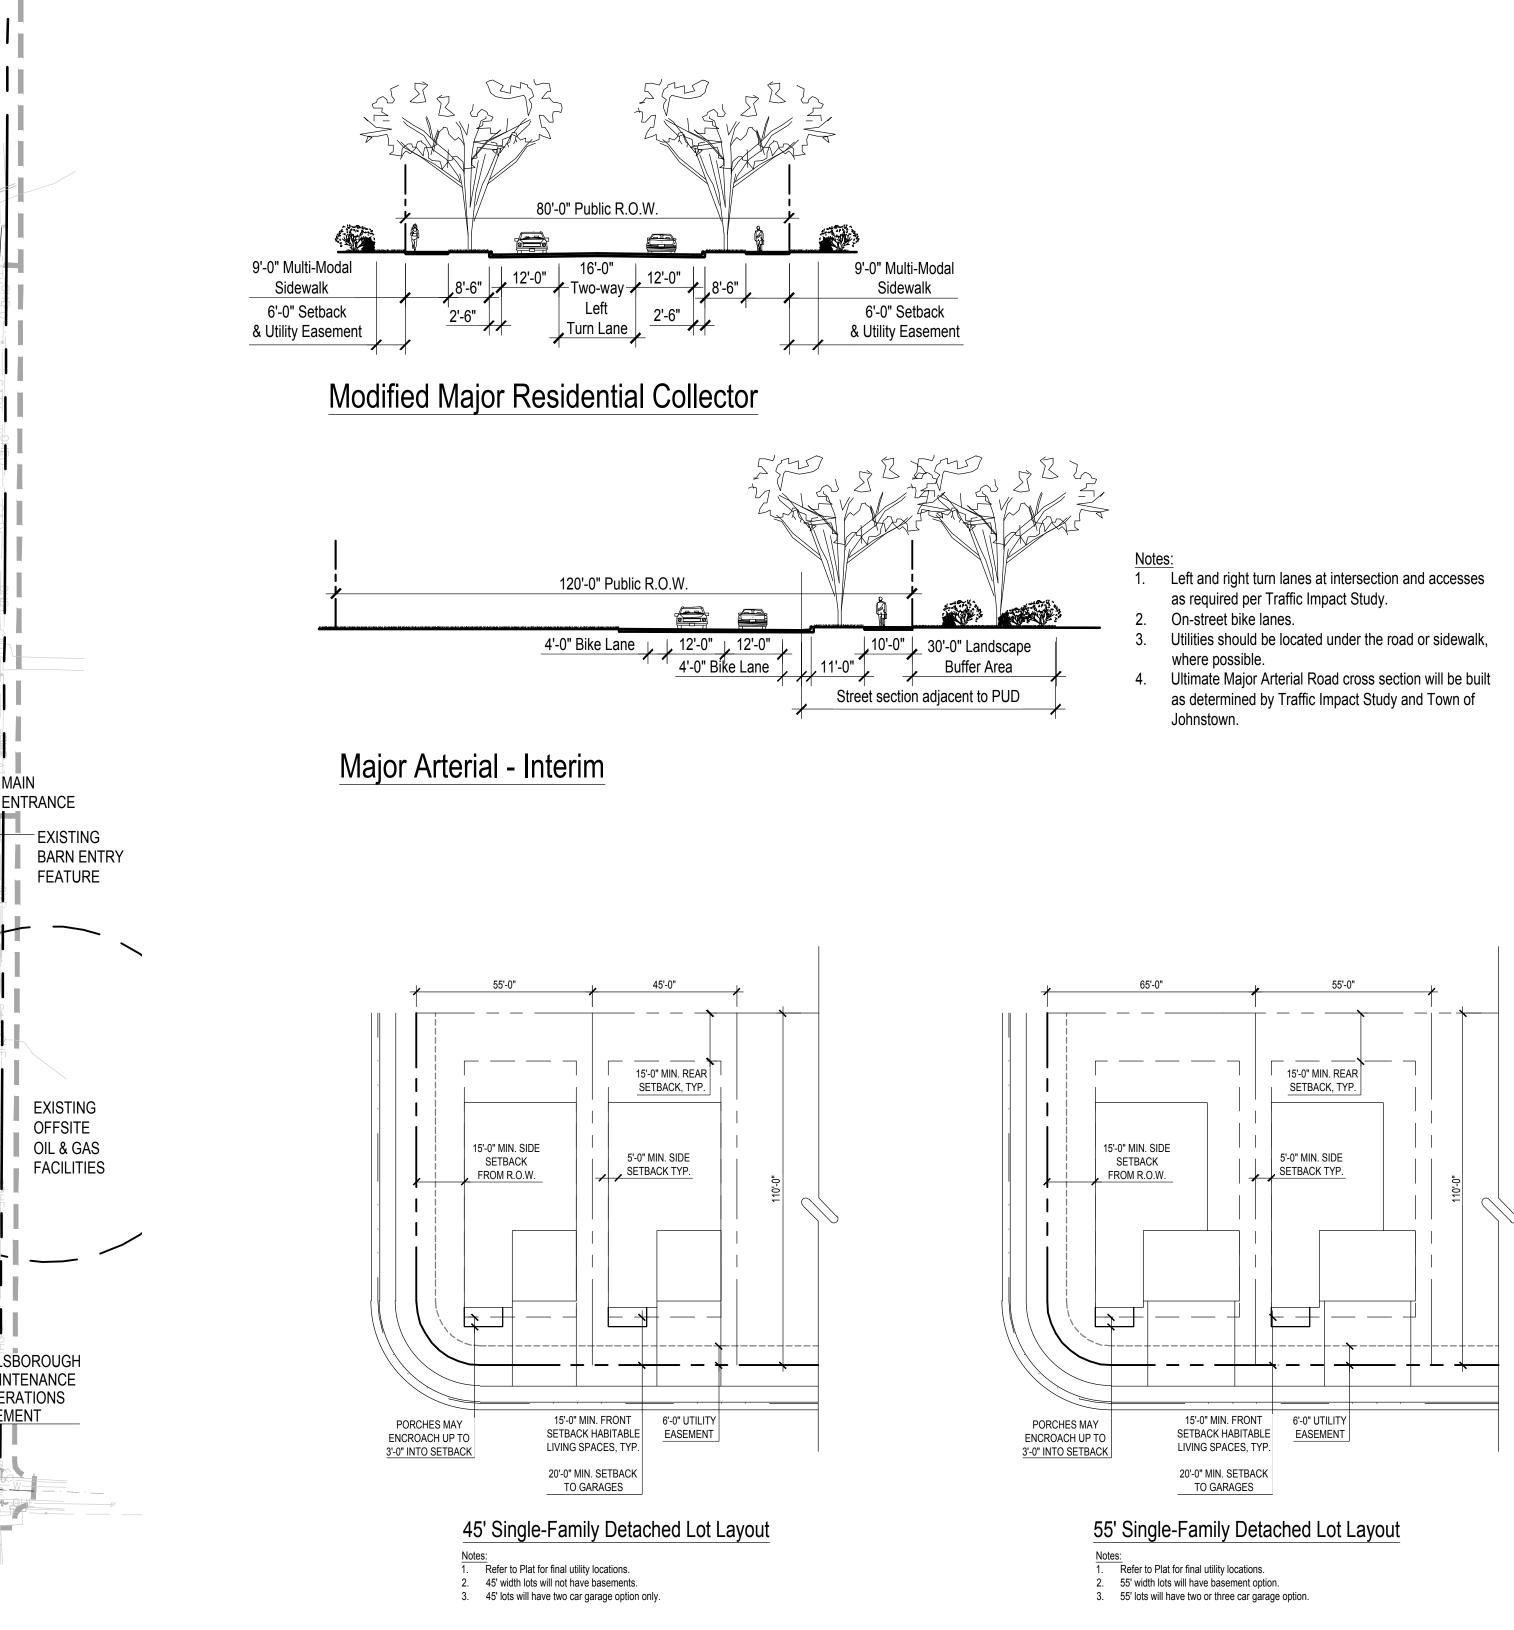
**DESIGN GUIDELINES** 

Sheet

G002

### THE GRANARY FILING ONE and FILING TWO FINAL DEVELOPMENT PLAN PART OF THE SOUTHEAST QUARTER OF SECTION 7, T 4 N., R. 67 W. OF THE 6TH P.M., COUNTY OF WELD, STATE OF COLORADO EXISTING OFFSITE OIL & GAS FACILITIES GREAT WESTERN RAILROAD 80'-0" Public R.O.W. CONSTRUCTION PHASE 1A <u> </u> OUTLOT B 9'-0" Multi-Modal 9'-0" Multi-Modal 16'-0" 12'-0" Two-way 12'-0" 8'-6" Sidewalk Sidewalk Left Turn Lane 2'-6" 6'-0" Setback 2'-6" 6'-0" Setback & Utility Easement & Utility Easement Modified Major Residential Collector ш <sub>┓</sub>∖ ━ |**━⊥**━⊥━⊥**━**| **━**| ━ | ━ | ━ | ━ | ━ | 120'-0" Public R.O.W. OUTLOT OUTI OT F NO 4'-0" Bike Lane 12'-0" 12'-0" 4'-0" Bike Lane , 11'-0" EAST PARK OUTLOT D ∎j] Major Arterial - Interim ENTRANCE OUTLOT F - EXISTING BARN ENTRY FEATURE 150'-0" SINCLAIR PIPELINE AND THORTON WATER EASEMENT B 45'-0" 55'-0" \_\_\_\_ 15'-0" MIN. REAR SETBACK, TYP. EXISTING OFFSITE OUTLOT G 💈 OIL & GAS 15'-0" MIN. SIDE SETBACK 5'-0" MIN. SIDE FACILITIES SETBACK TYP. FROM R.O.W. ,**(■†■†■†■†**■ OUTLOT -OUTLOT I 160'-0" HILLSBOROUGH DITCH MAINTENANCE OUTLOT F AND OPERATIONS -OUTLOT FASEMENT 15'-0" MIN. FRONT 6'-0" UTILITY PORCHES MAY SETBACK HABITABLE EASEMENT ENCROACH UP TO HORTON LIVING SPACES, TYP. 3'-0" INTO SETBACK PIPELINE EASEMENT 🗲 20'-0" MIN. SETBACK TO GARAGES MAIN -RELOCATED ENTRANCE CONSTRUCTION PHASE 2A SILO ENTRY 45' Single-Family Detached Lot Layout FEATURE Notes:1.Refer to Plat for final utility locations.2.45' width lots will not have basements. 3. 45' lots will have two car garage option only. HOUSING TYPE PLAN 200' 200' 400' NORTH LOT TYPE PLAN LEGEND: 45' SINGLE-FAMILY DETACHED LOT 55' SINGLE-FAMILY DETACHED LOT

PHASING LINE





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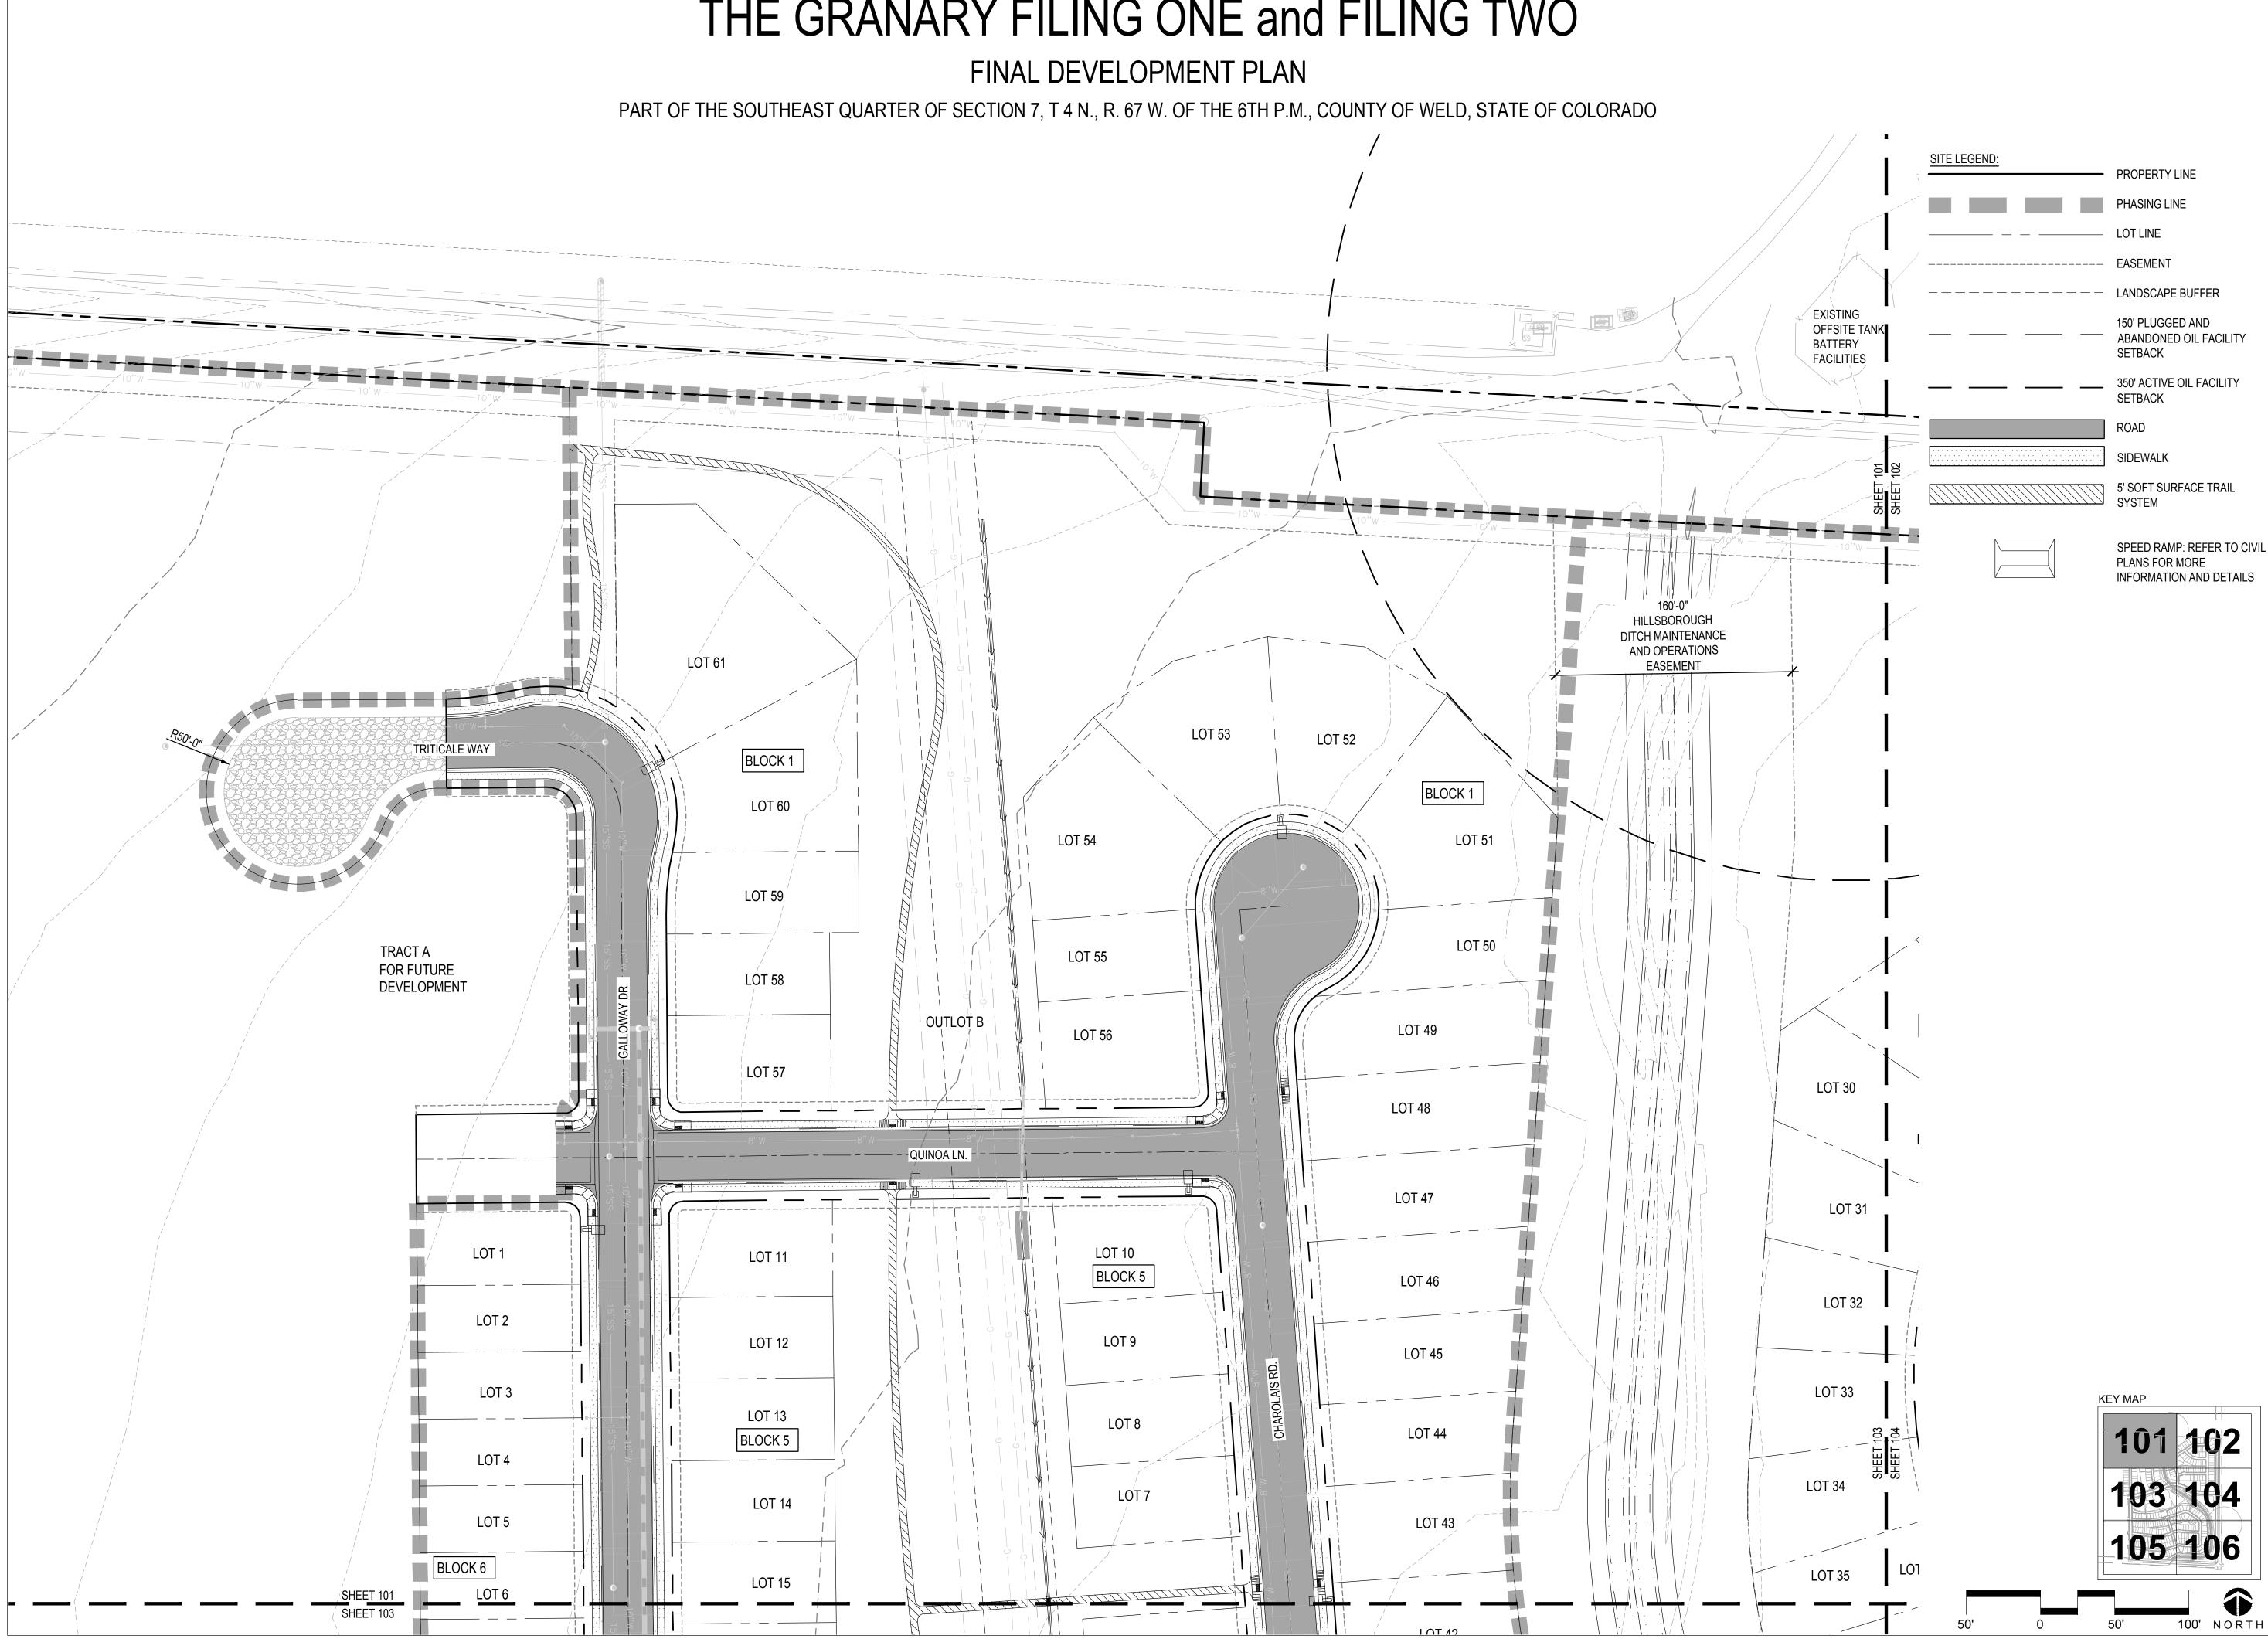
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LOT AND STREET TYPICALS

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### NOT FOR CONSTRUCTION

COMMENT	DATE

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Date: 02.07.2022 Drawn By: SL Checked By: CR

Sheet Name

SITE PLAN

Sheet



FINAL DEVELOPMENT PLAN

SITE LEGEND:	PROPERTY LINE
	PHASING LINE
	LOT LINE
	EASEMENT
	LANDSCAPE BUFFER
	150' PLUGGED AND ABANDONED OIL FACILITY SETBACK
	350' ACTIVE OIL FACILITY SETBACK
	ROAD
	SIDEWALK
	5' SOFT SURFACE TRAIL SYSTEM
	SPEED RAMP: REFER TO C

TO CIVIL PLANS FOR MORE INFORMATION AND DETAILS





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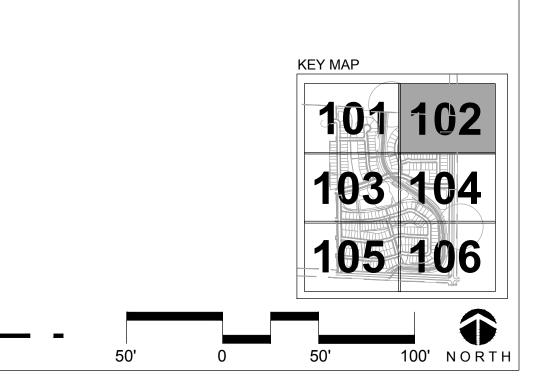
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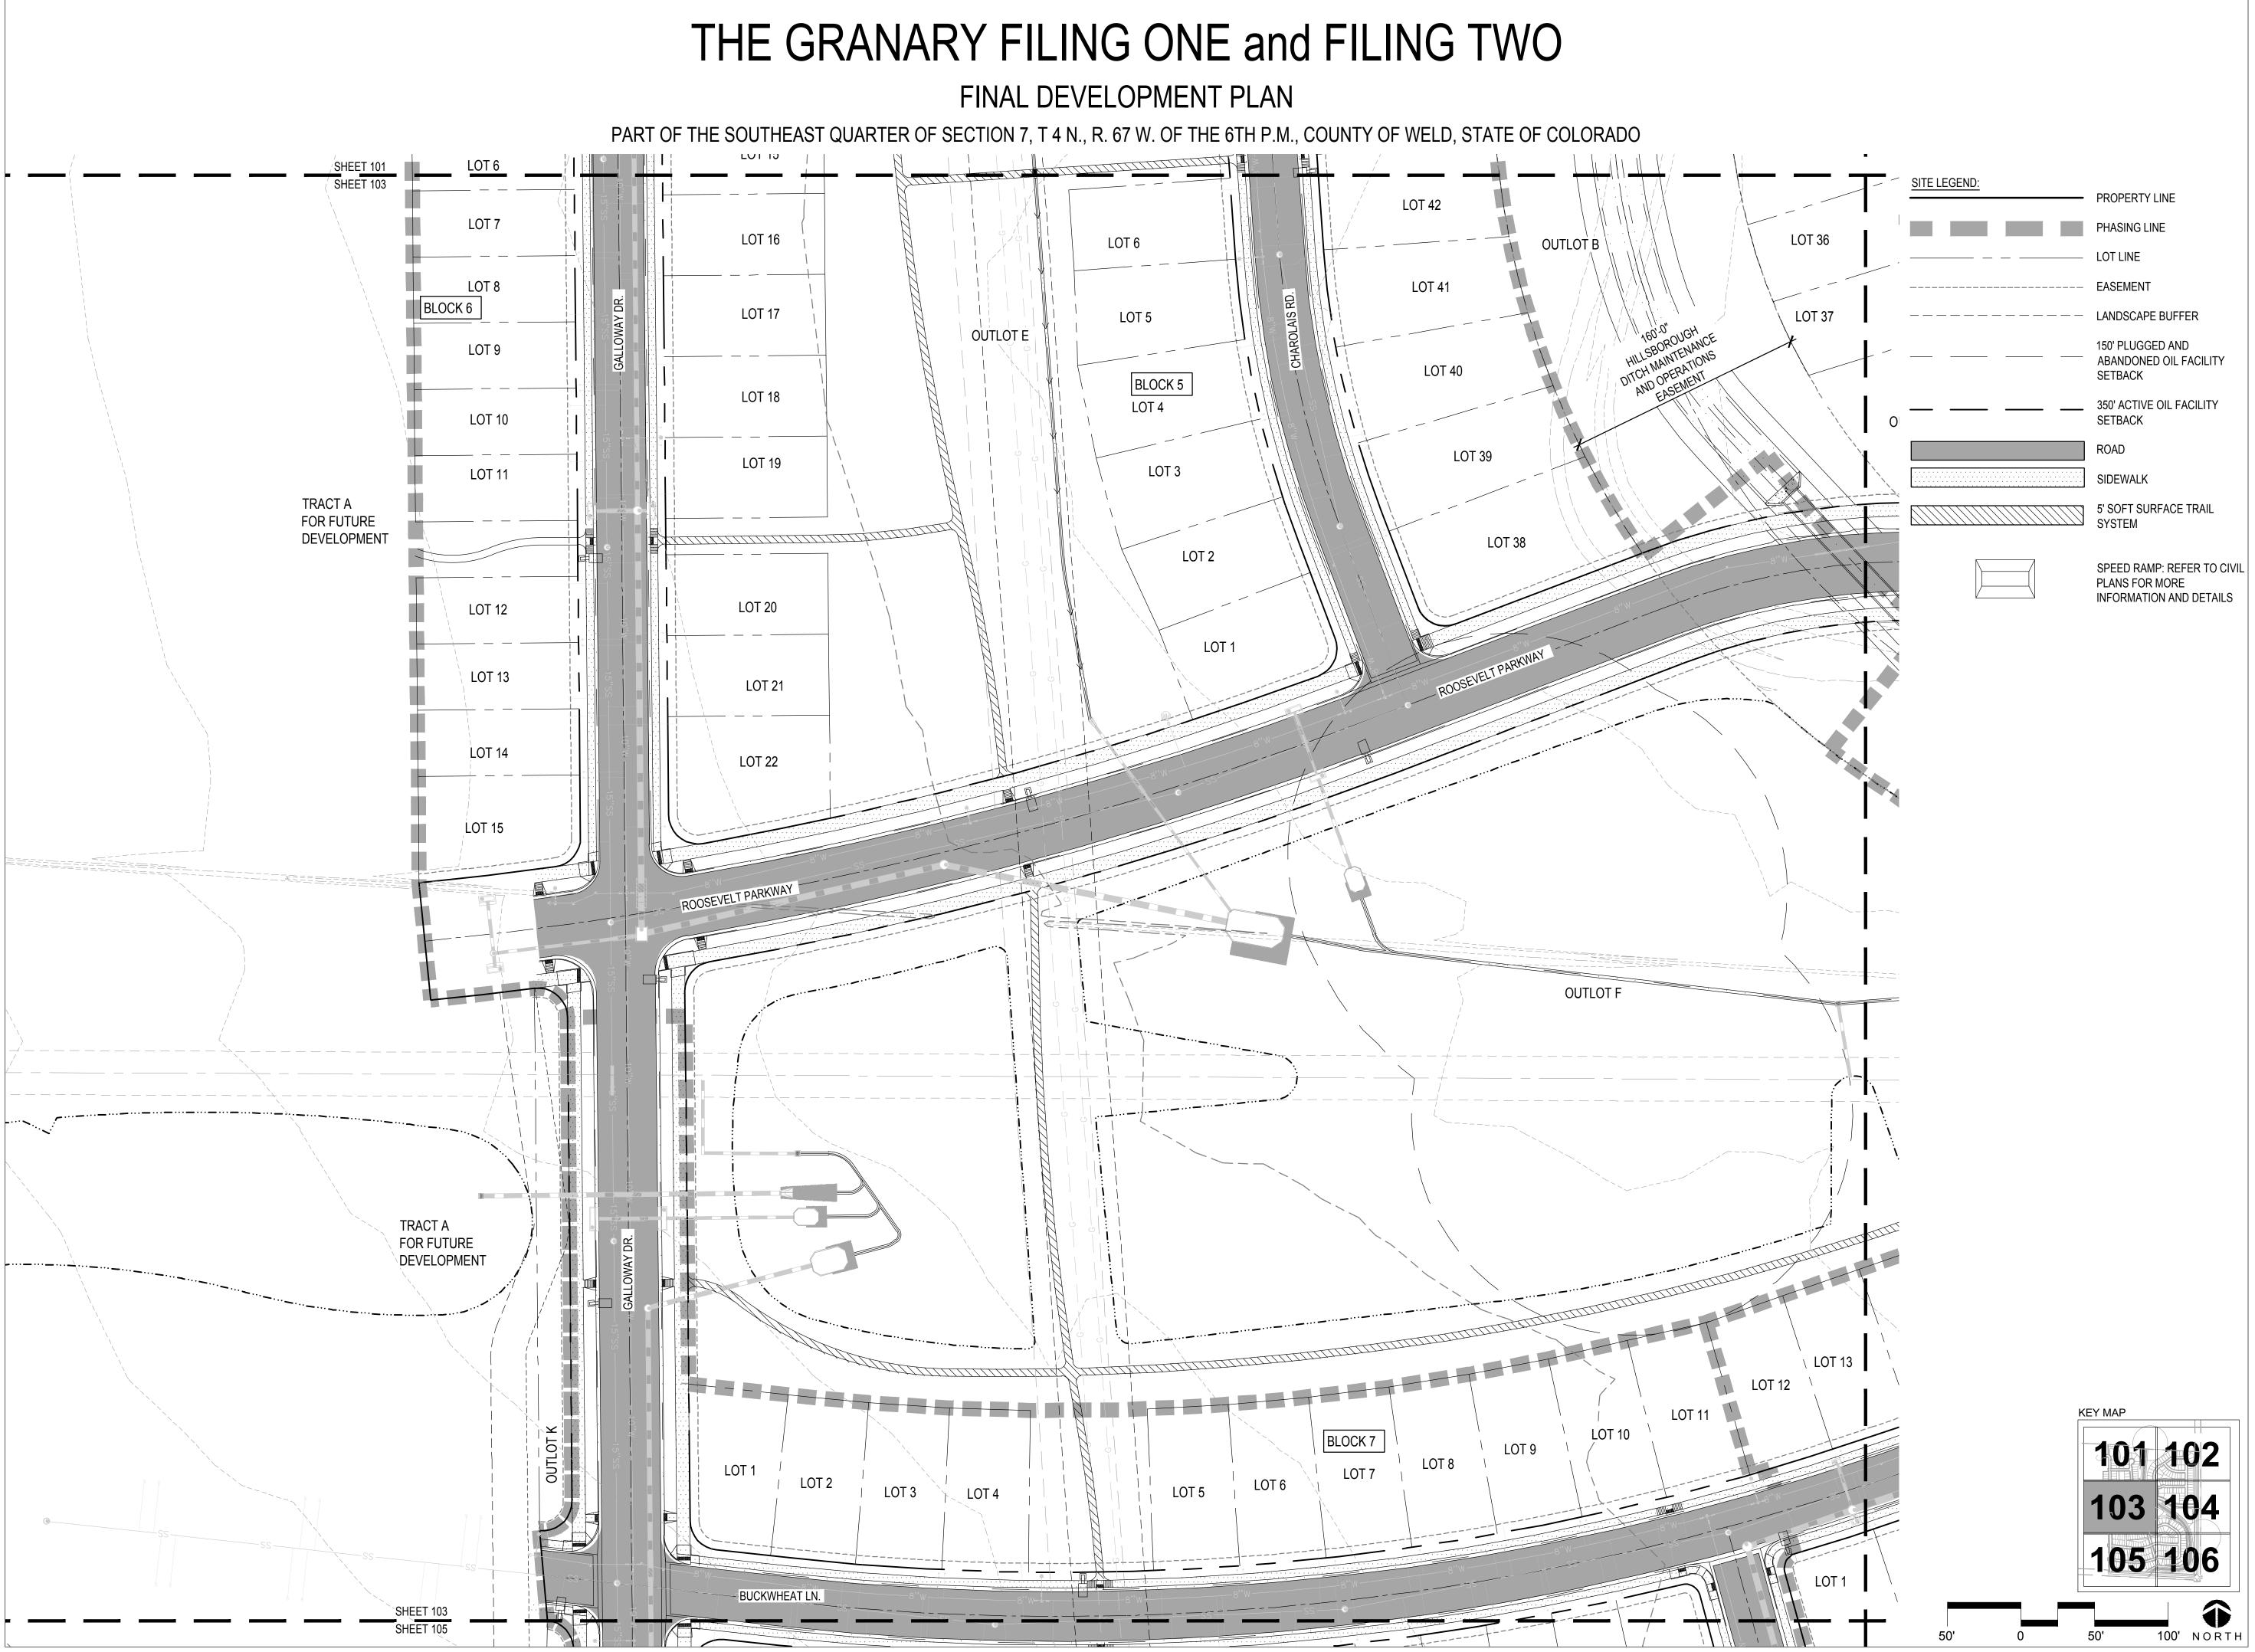
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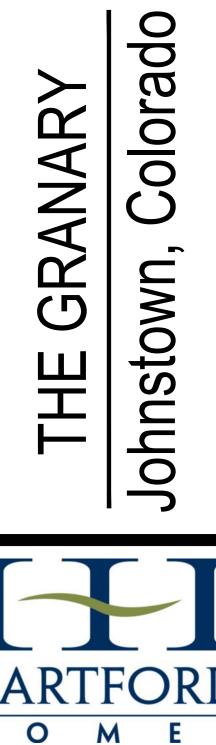
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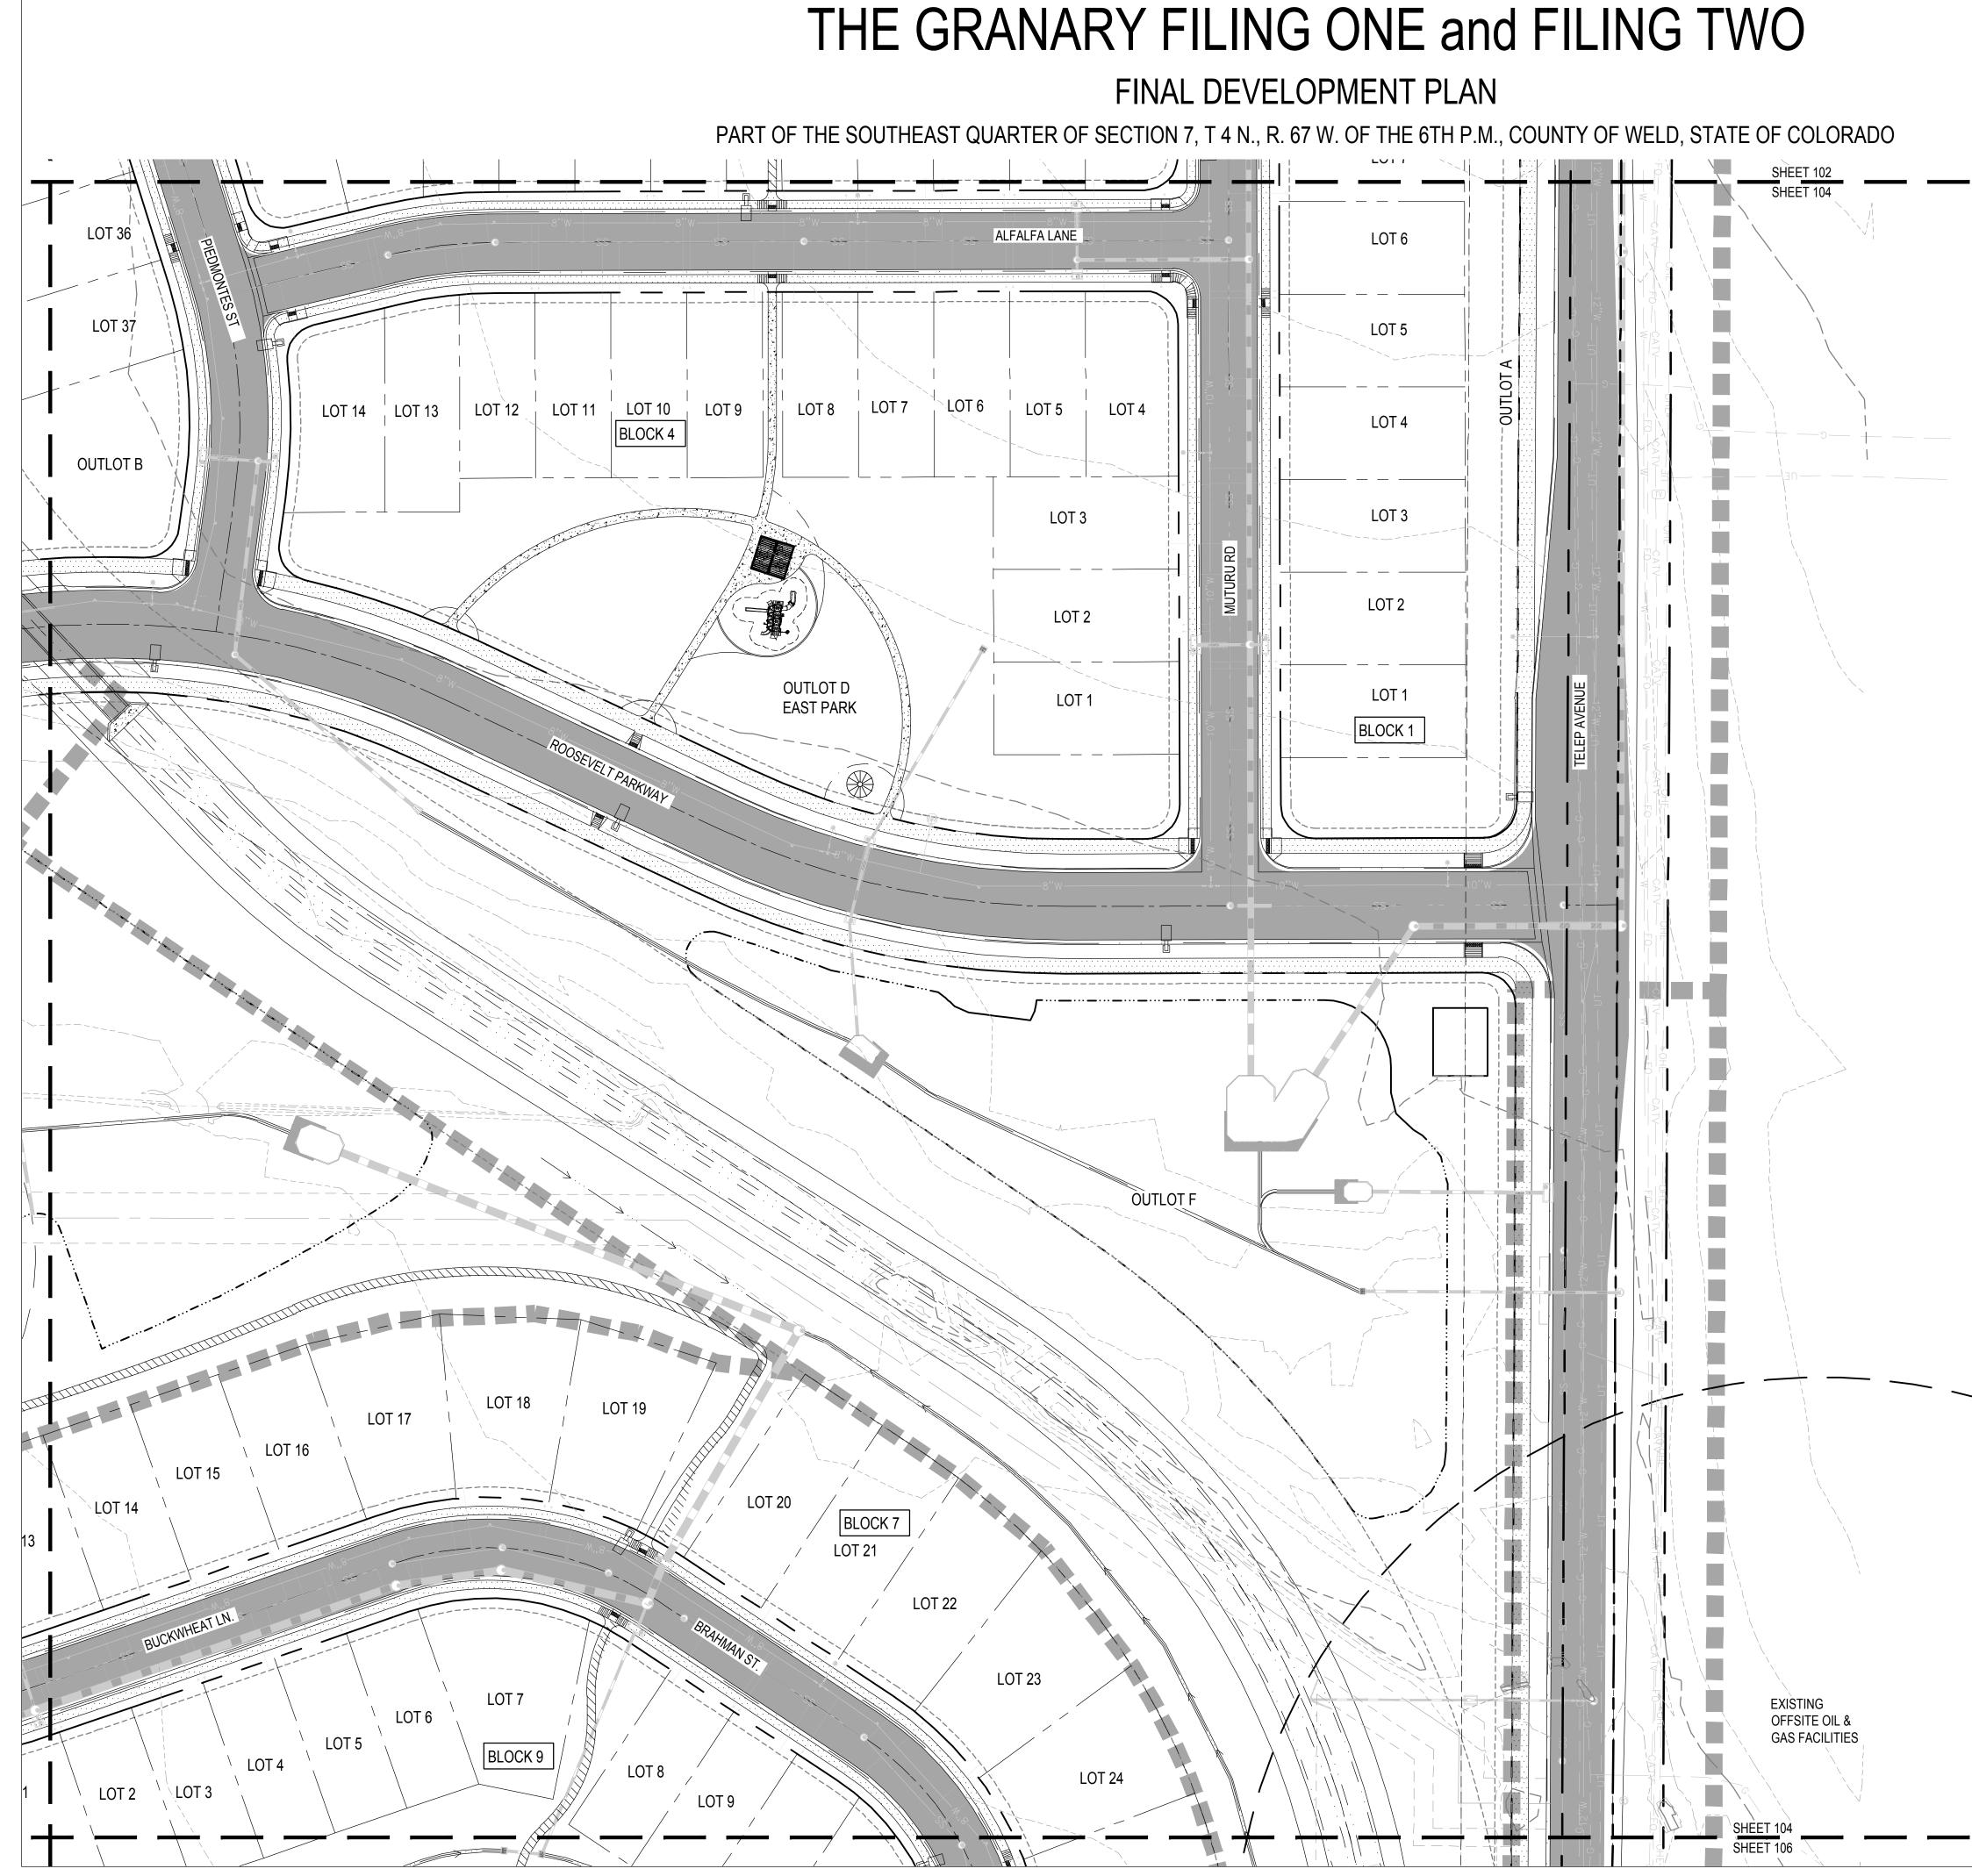
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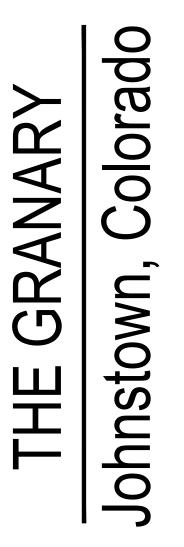
SITE PLAN

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SITE LEGEND:	
	PROPERTY LINE
	PHASING LINE
	LOT LINE
	EASEMENT
	LANDSCAPE BUFFER
	150' PLUGGED AND ABANDONED OIL FACILITY SETBACK
	350' ACTIVE OIL FACILITY SETBACK
	ROAD
	SIDEWALK
	5' SOFT SURFACE TRAIL SYSTEM
	SPEED RAMP: REFER TO CIVIL

PLANS FOR MORE INFORMATION AND DETAILS





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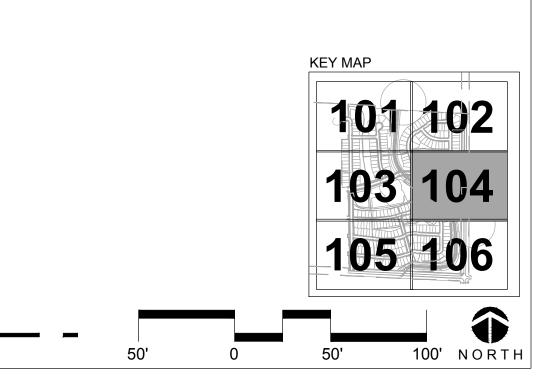
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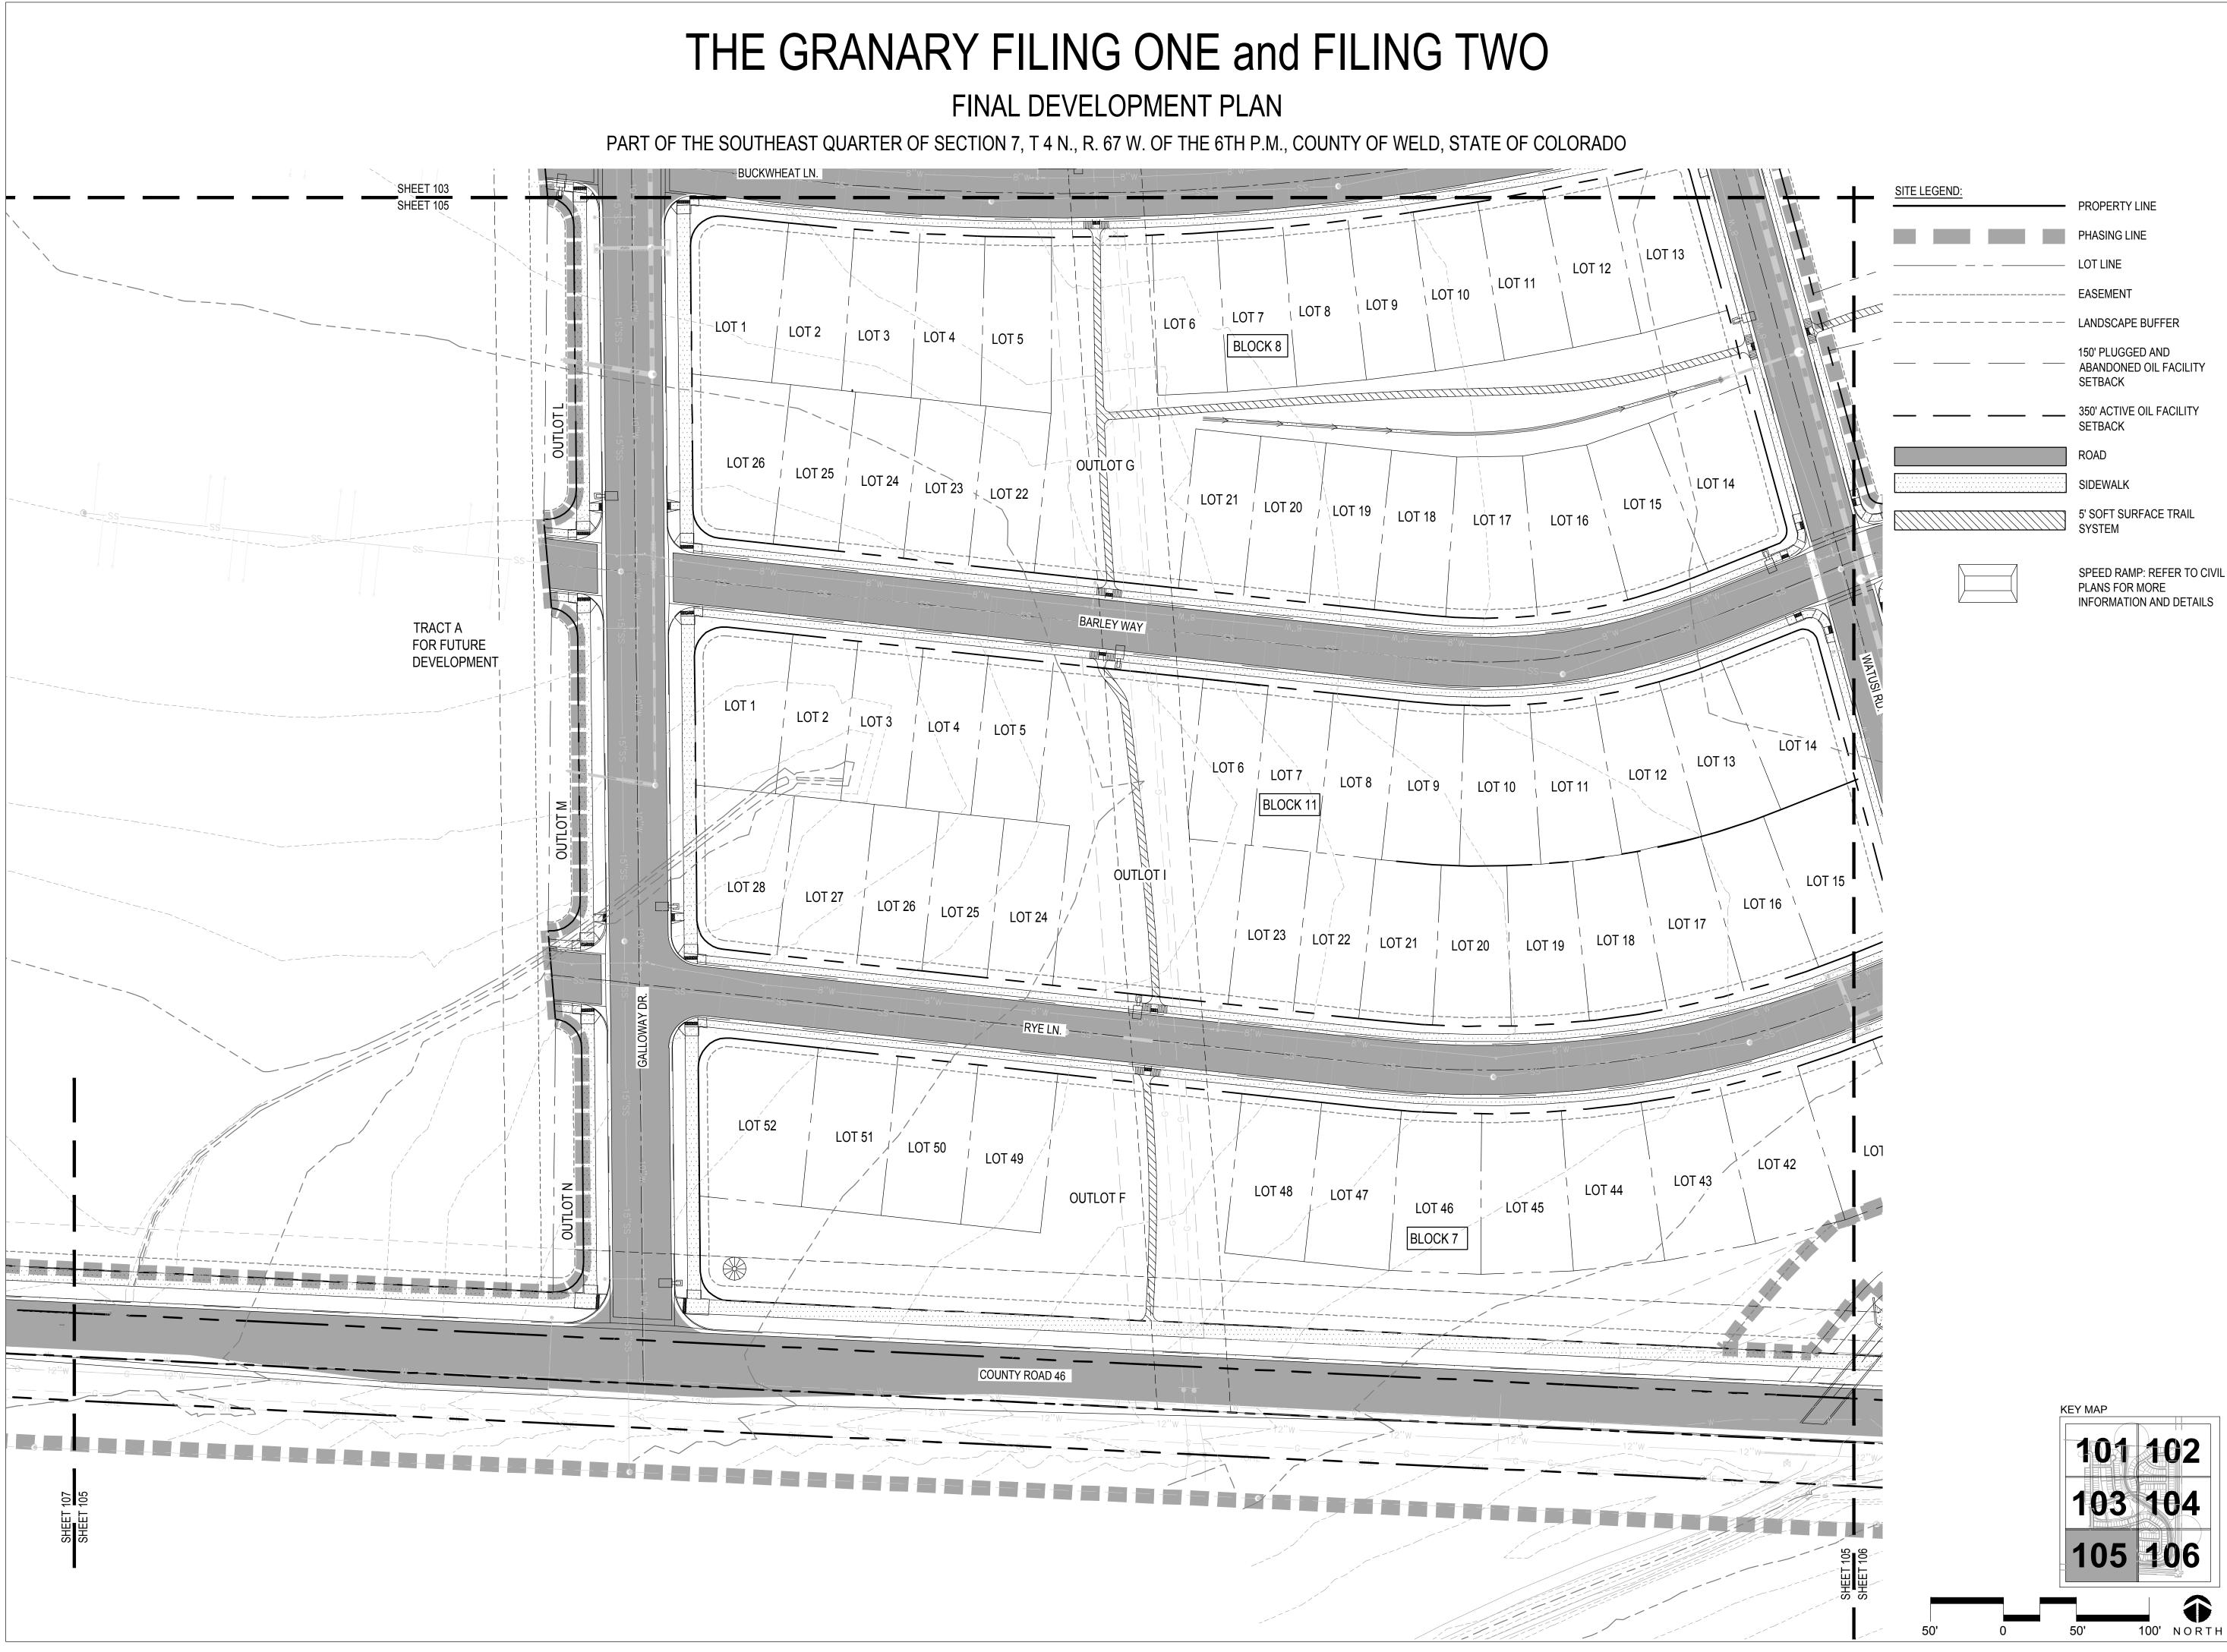
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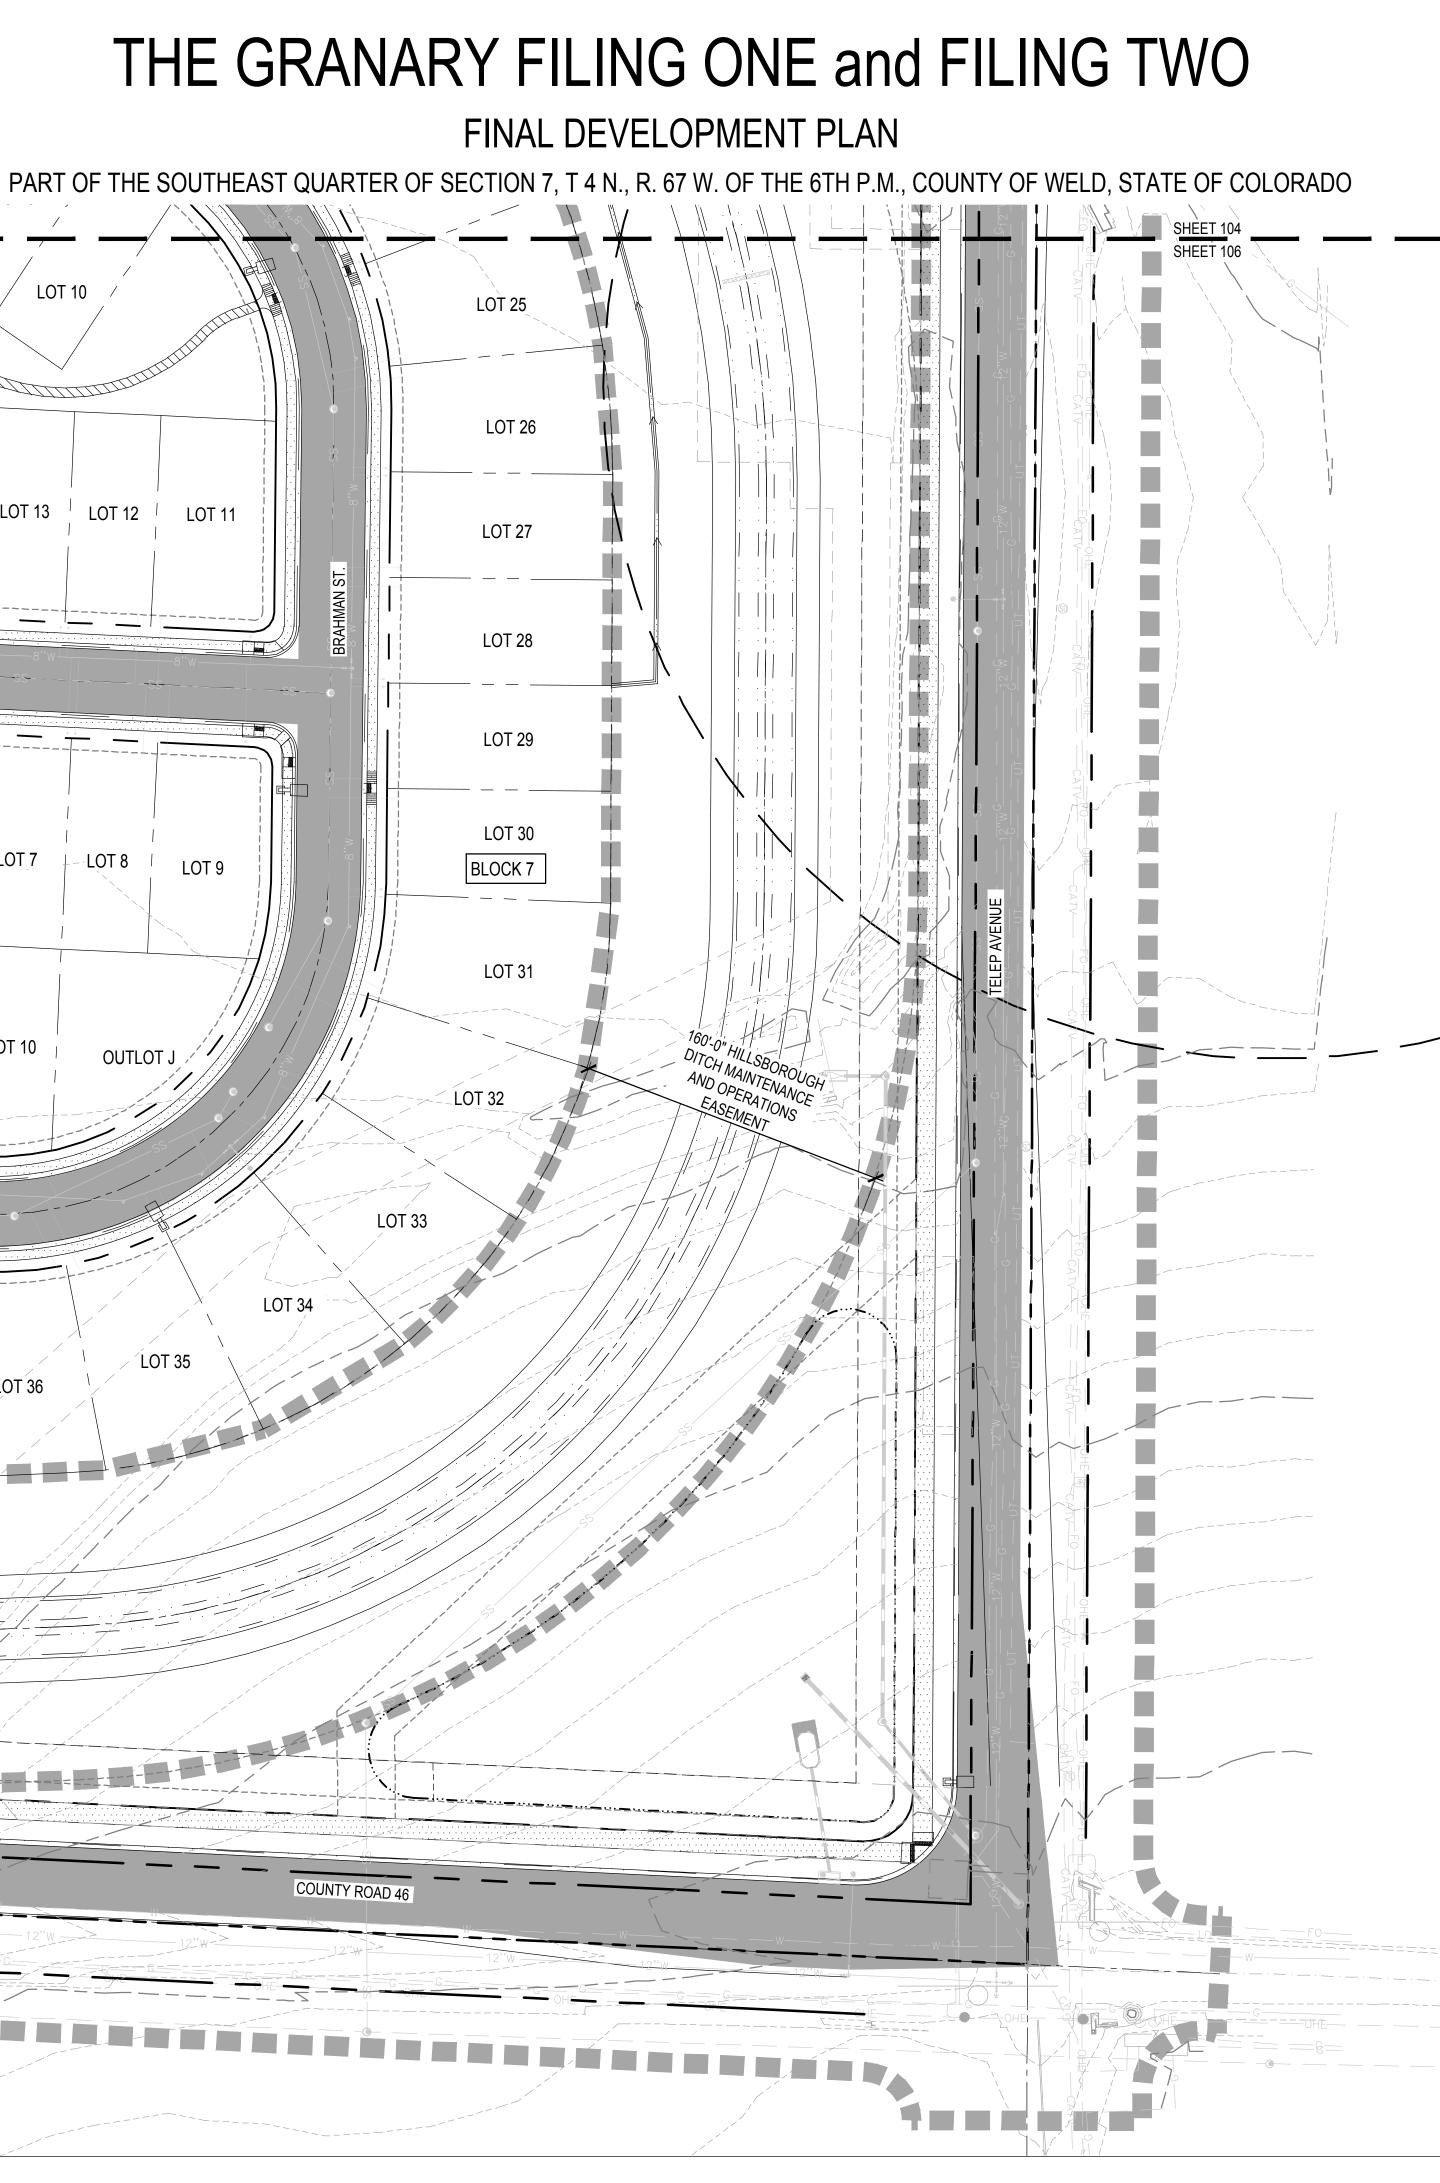
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Sheet Name

SITE PLAN

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# LOT 10 OUTLOT H BLOCK 9 LOT 19 LOT 18 LOT 17 LOT 16 LOT 15 LOT 14 LOT 13 LOT 12 LOT 11 LOT 20 BARLEY WAY LOT 2 LOT 3 LOT 4 LOT 5 LOT 6 LOT 1 LOT 9 BLOCK 10 LOT 15 LOT 14 LOT 13 LOT 12 LOT 11 LOT 10 LOT 16 $\langle \rangle$ OUTLOT J RYE LN. OUTLOT F LOT 35 LOT 38 LOT 37 LOT 36 LOT 40 LOT 41



SITE LEGEND:	PROPERTY LINE
	PHASING LINE
	LOT LINE
	EASEMENT
	LANDSCAPE BUFFER
	150' PLUGGED AND ABANDONED OIL FACILITY SETBACK
<u> </u>	350' ACTIVE OIL FACILITY SETBACK
	ROAD
	SIDEWALK
	5' SOFT SURFACE TRAIL SYSTEM
	SPEED RAMP: REFER TO CIVIL PLANS FOR MORE INFORMATION AND DETAILS

THE GRANARY Johnstown, Colorado



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REV.	COMMENT	DATE

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 02.07.2022


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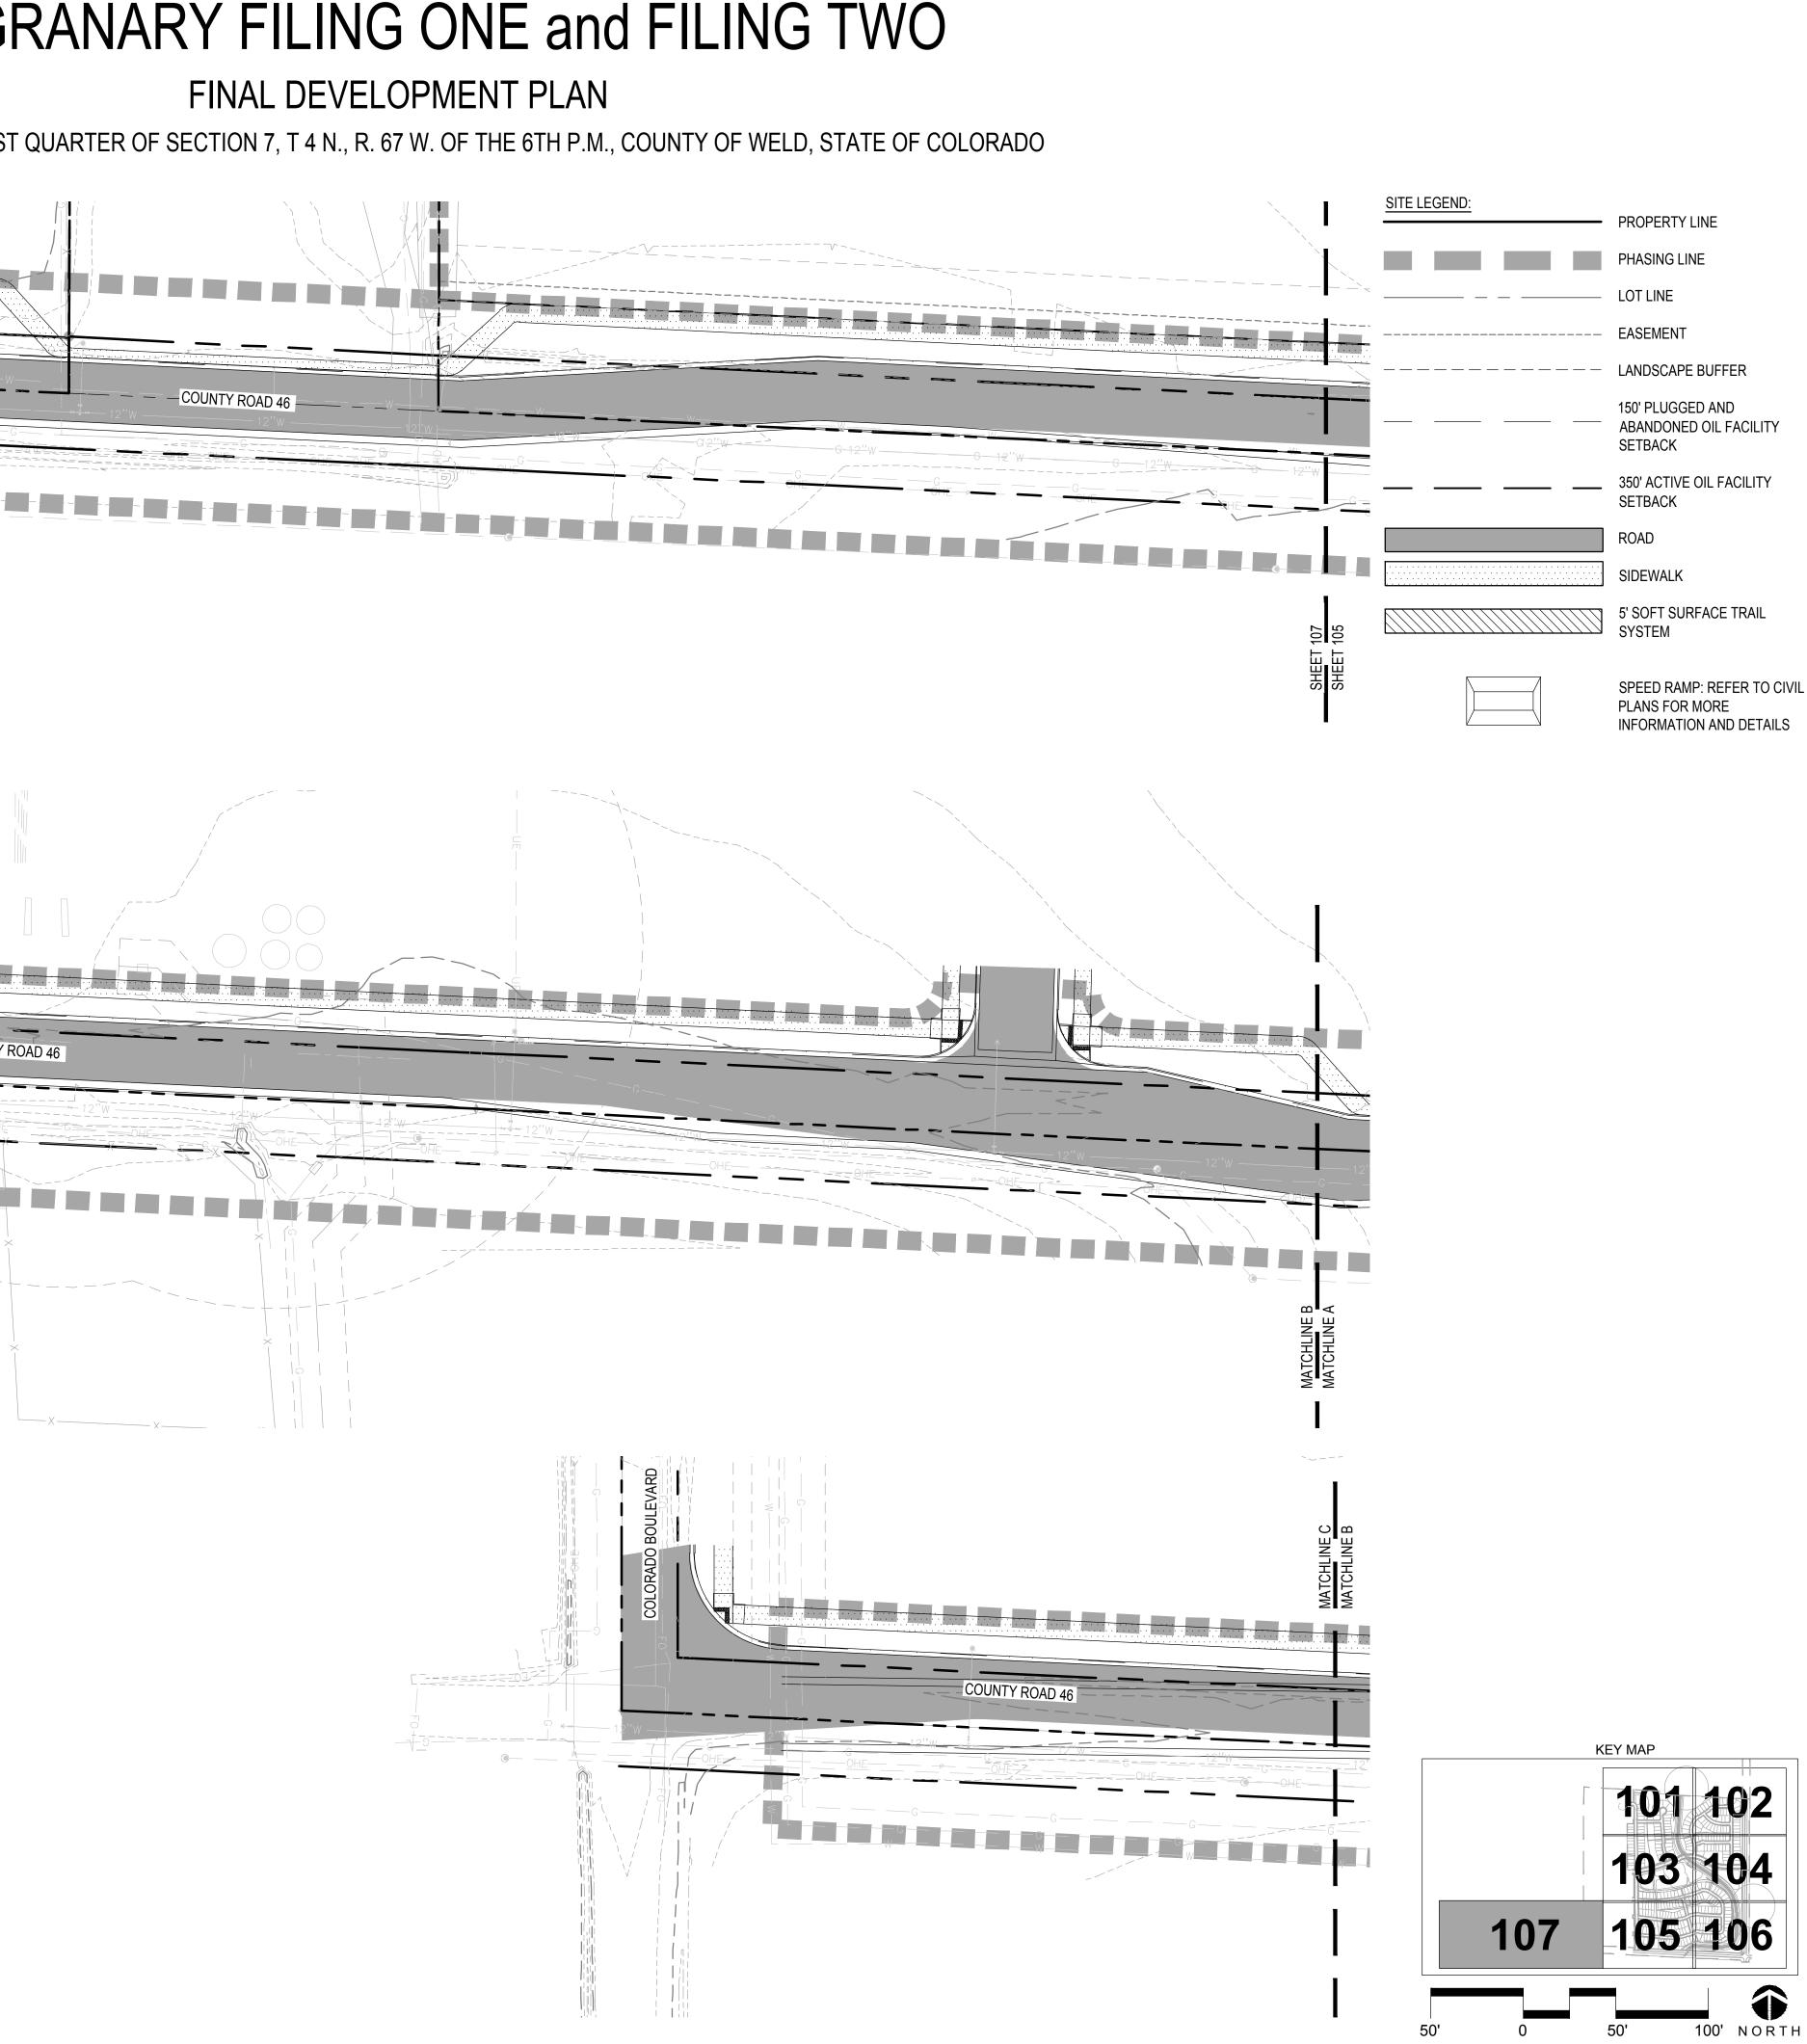
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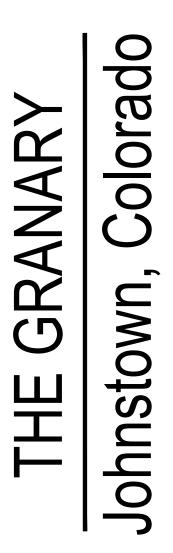
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# THE GRANARY FILING ONE and FILING TWO FINAL DEVELOPMENT PLAN PART OF THE SOUTHEAST QUARTER OF SECTION 7, T 4 N., R. 67 W. OF THE 6TH P.M., COUNTY OF WELD, STATE OF COLORADO COUNTY ROAD 46 MATCHLINE I MATCHLINE INE B 린문 COUNTY ROAD 46







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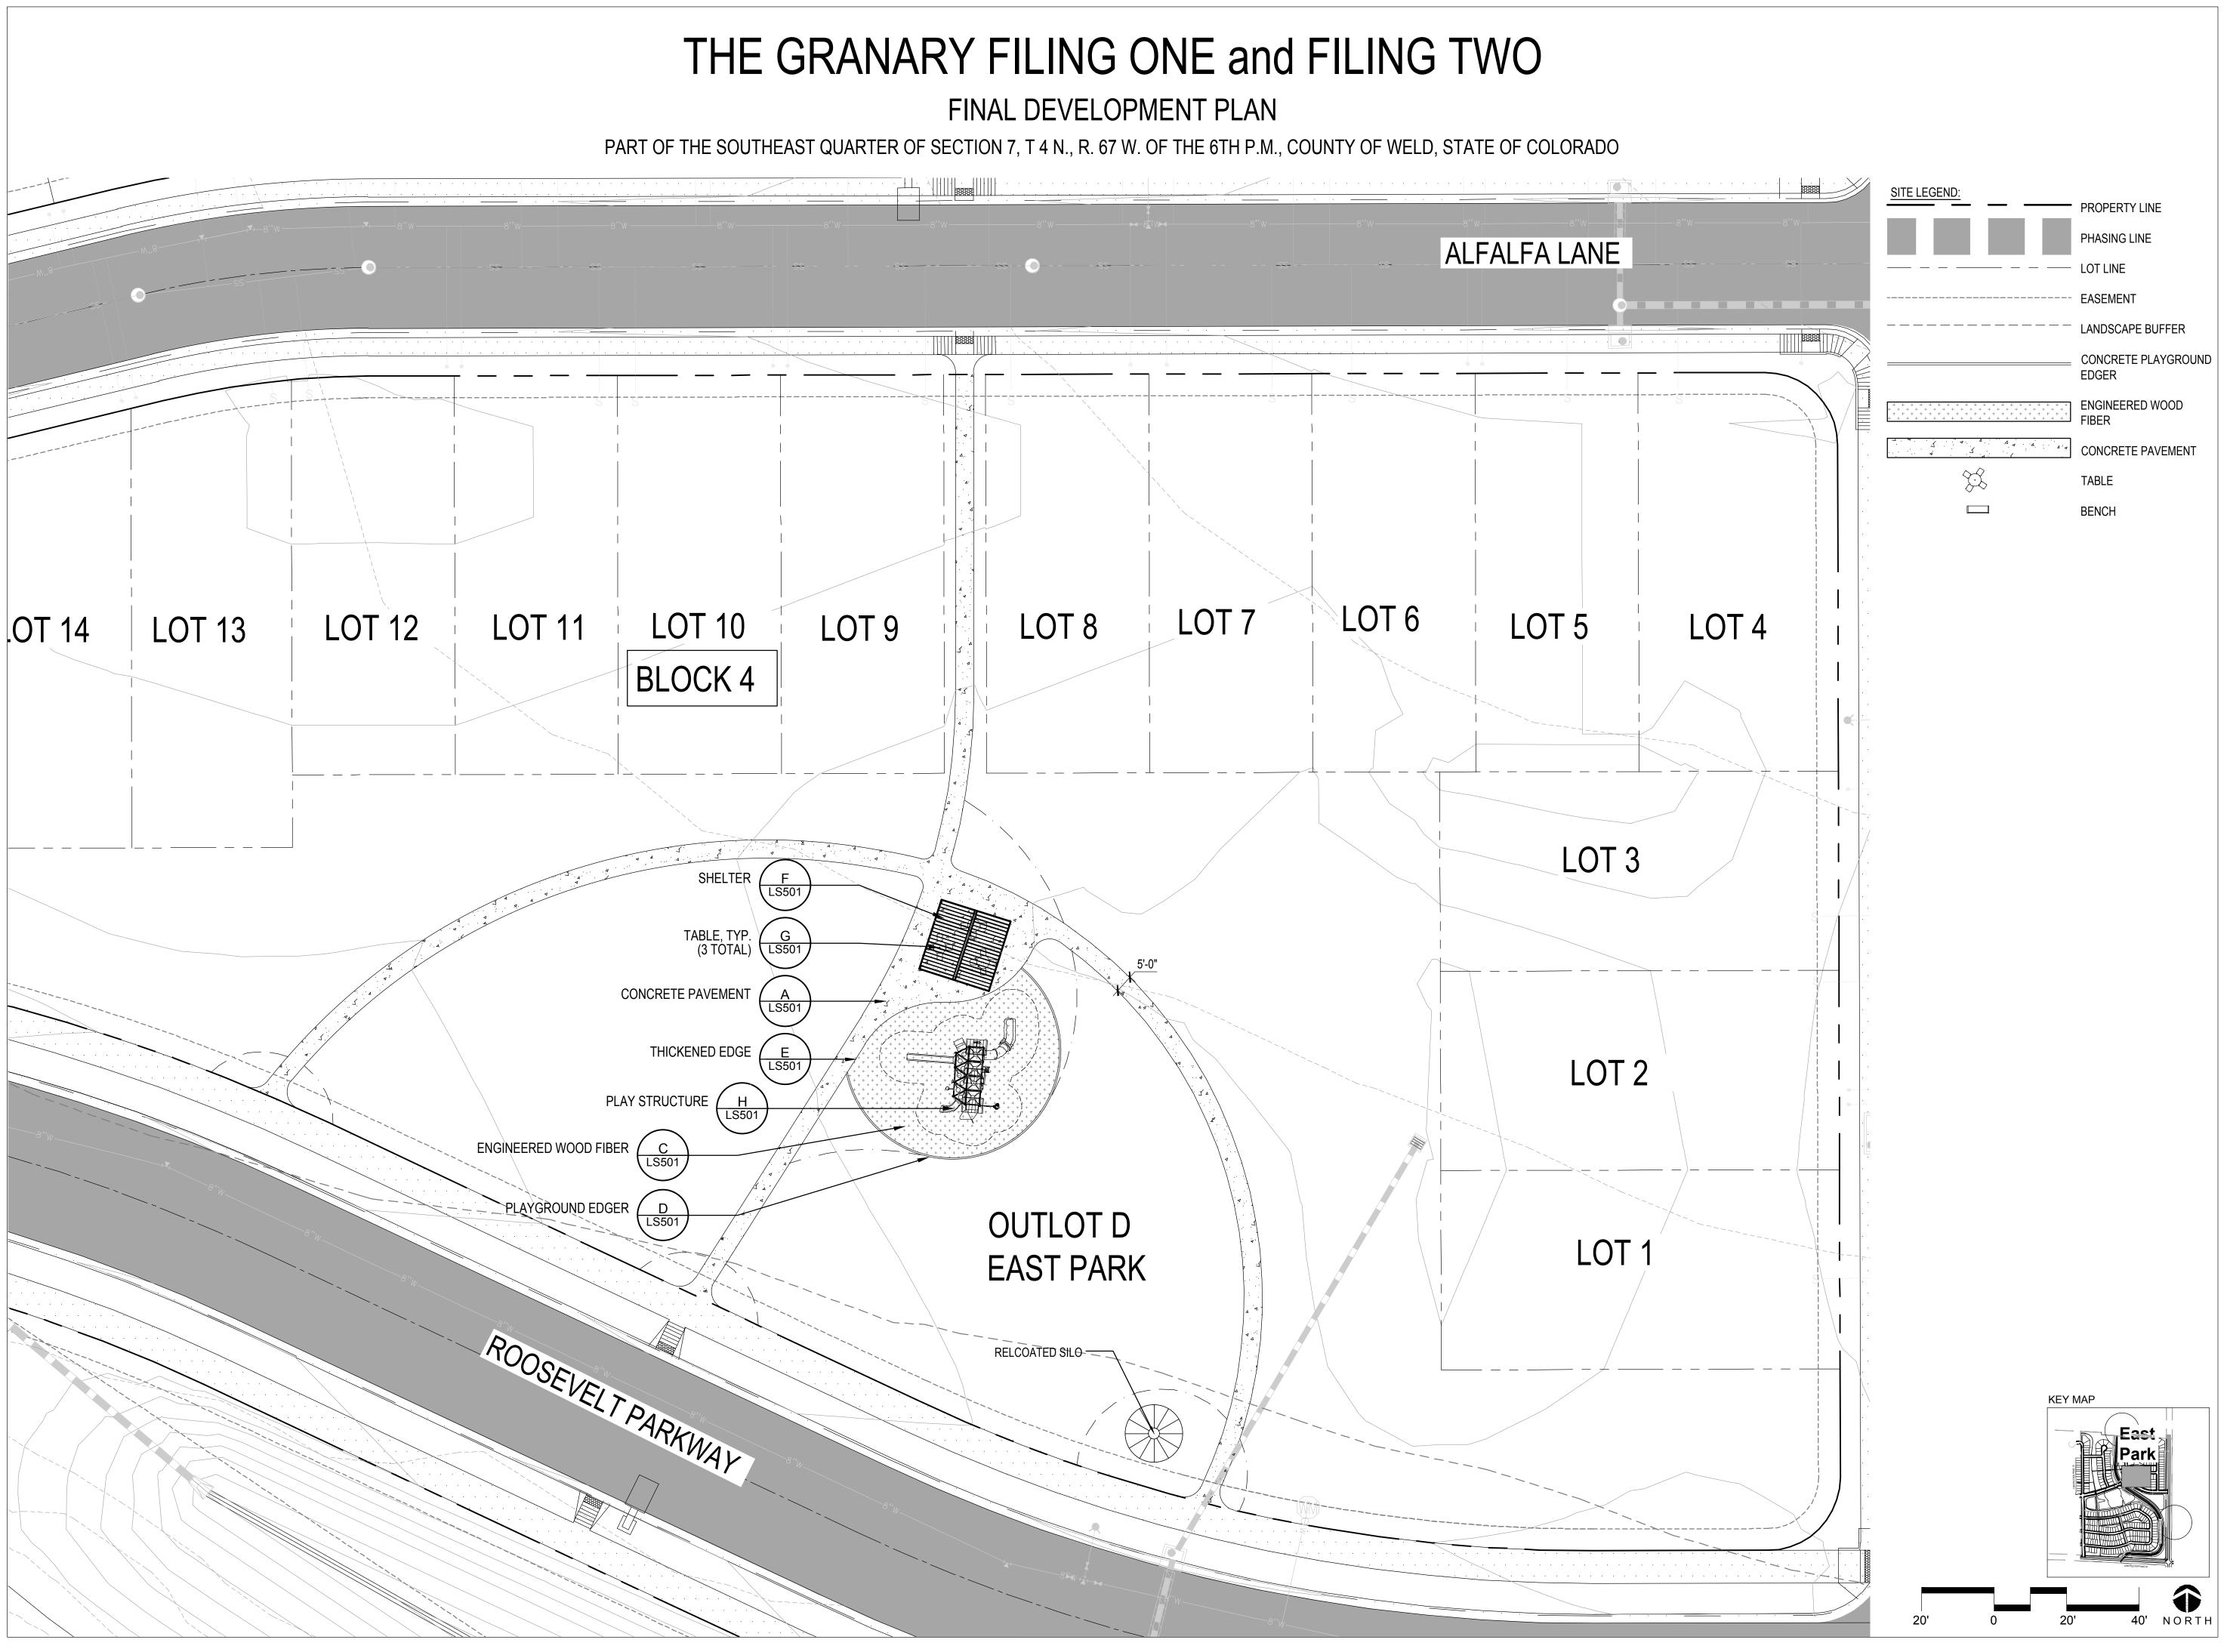
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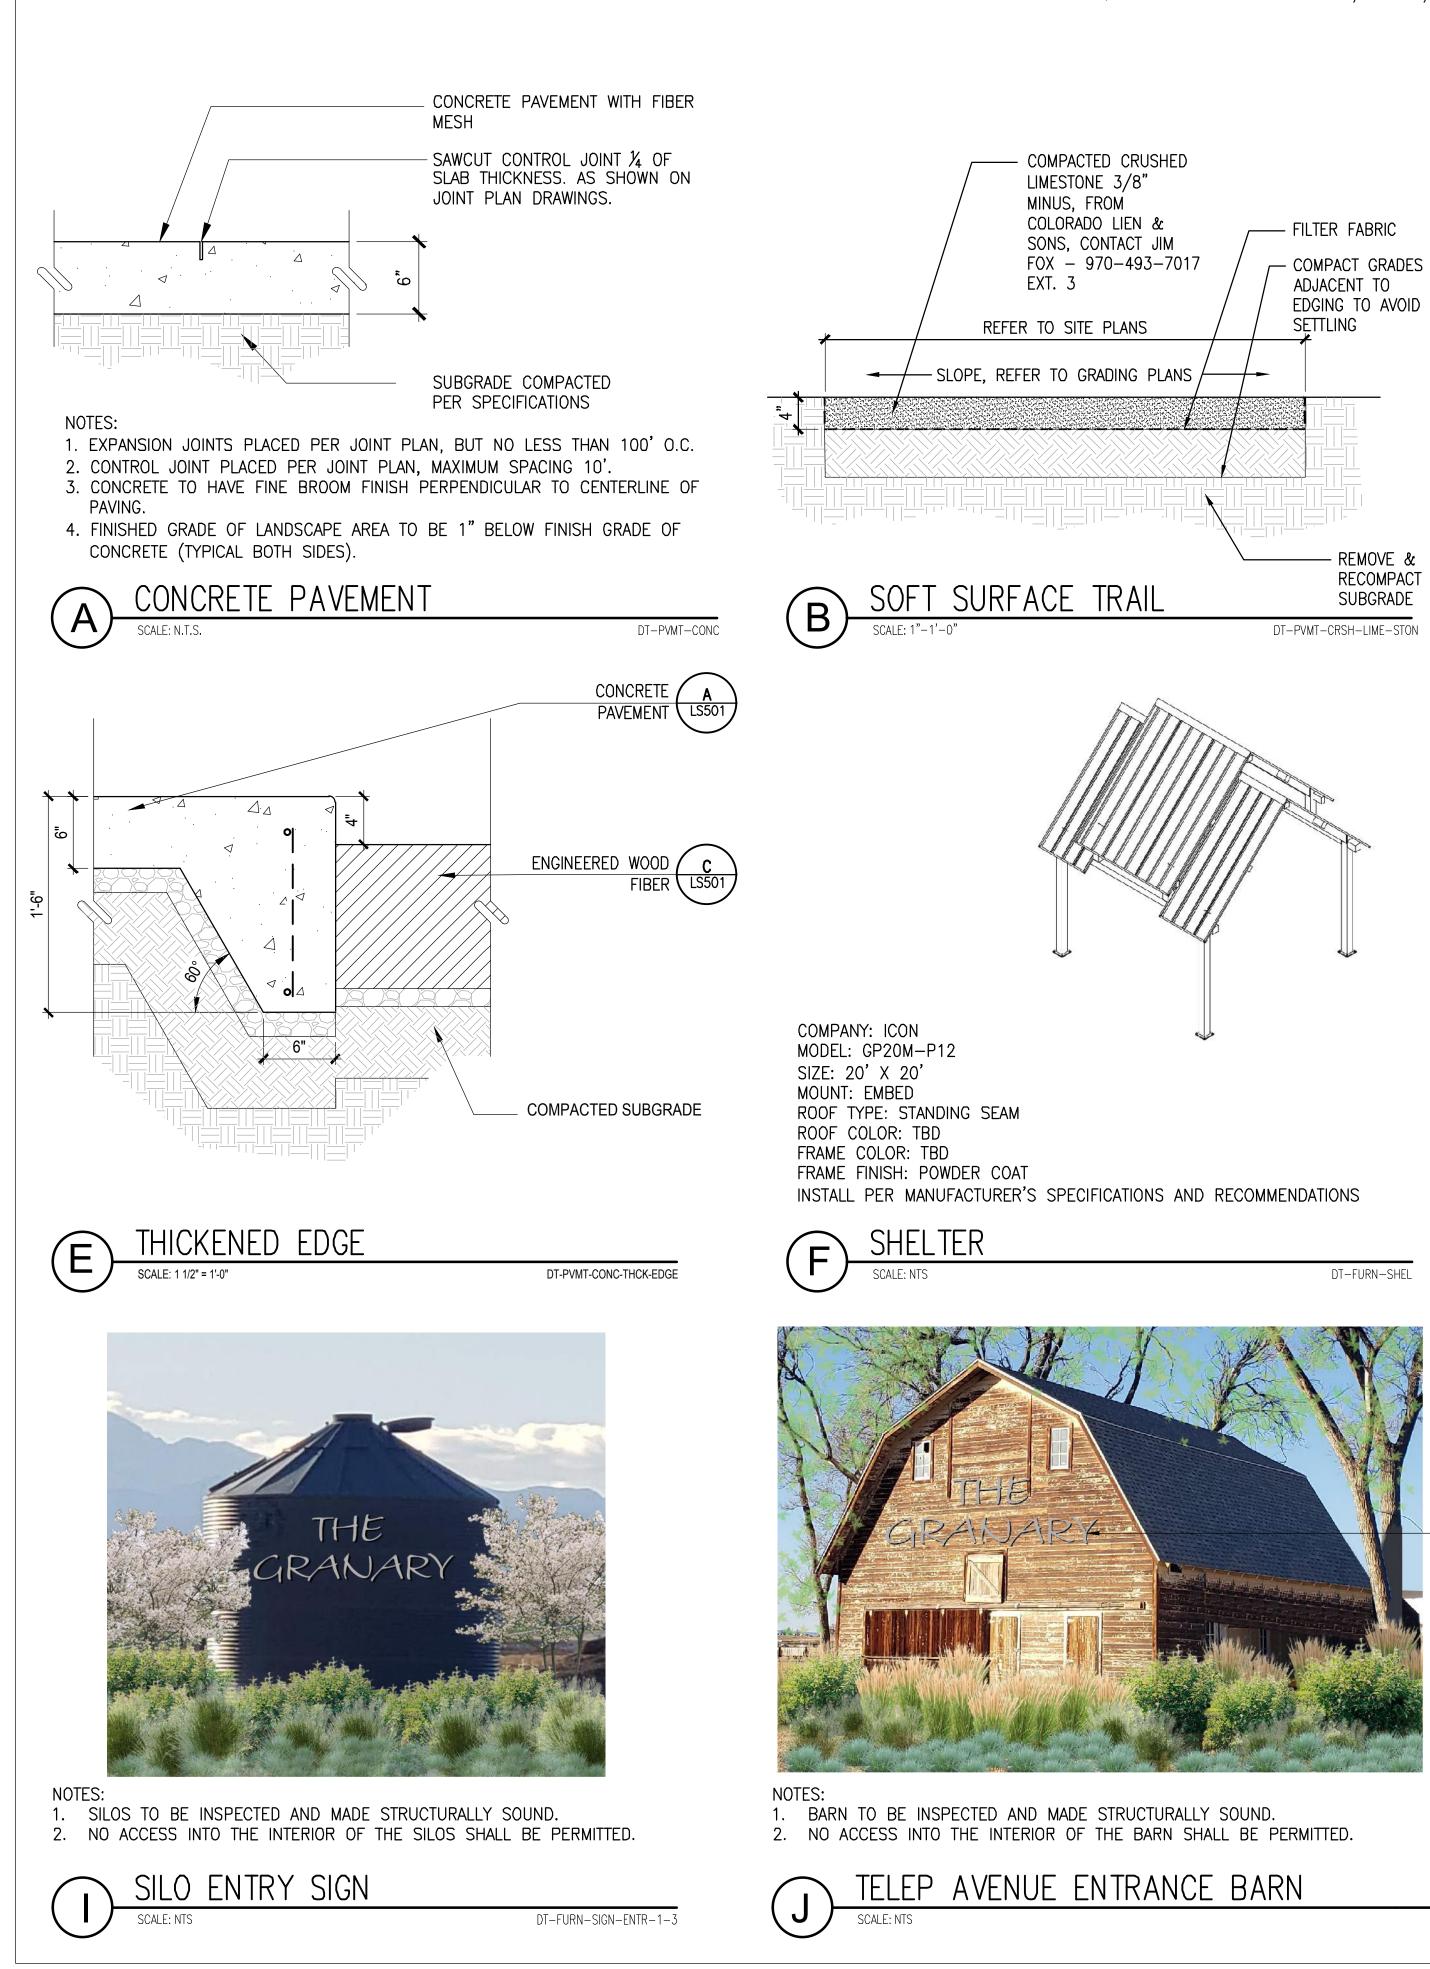
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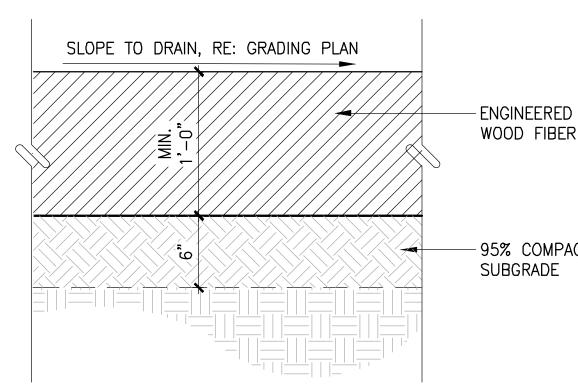
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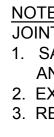
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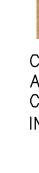


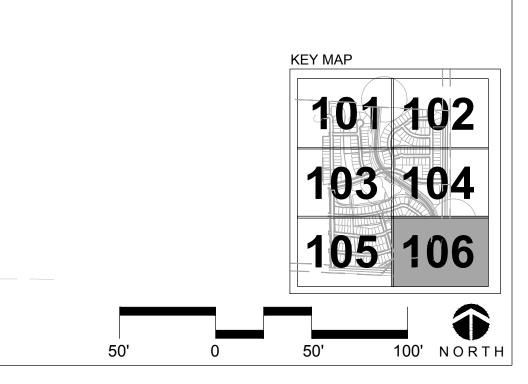











DT-FURN-TABL

LETTERS

POWDERCOATED STEEL LETTERS FONT: ALHAMBRA HEIGHT: 24" BACK LIGHT

DT-FURN-SIGN-ENTR-4

TABLE

SCALE: NTS

INSTALL PER MANUFACTURER'S SPECIFICATIONS AND RECOMMENDATIONS G

FINAL DEVELOPMENT PLAN

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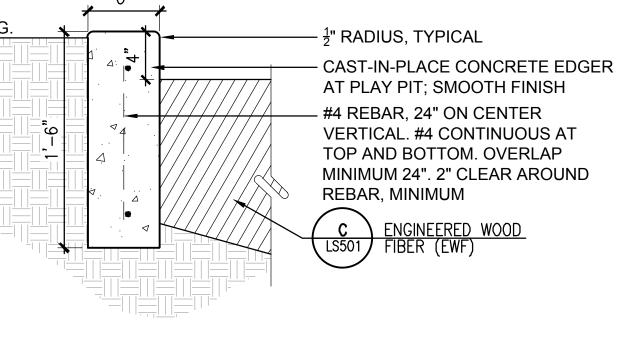
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ENGINEERED WOOD FIBER DT-PVMT-ENG-WOOD-FIBER



NOTES: JOINT SPACING AT EDGER: 1. SAW CUT CONTROL JOINTS EQUALLY SPACED AT 8' MINIMUM, 10' MAXIMUM AND CONTINUE DOWN ENTIRE FACE OF EDGER 2. EXPANSION JOINTS EQUALLY SPACED AT 80' MINIMUM, 100' MAXIMUM 3. REFER TO SPECIFICATIONS FOR ALL MATERIALS CALLED OUT IN DETAIL

PLAYGROUND EDGER

SCALE: 1 1/2" = 1'-0"



COMPANY: LITTLE TYKES COMMERCIAL (CUSTOM PIECE) AGE RANGE: EQUIPMENT FOR 5–12 YEAR OLD COLOR: TO BE DETERMINED INSTALL PER MANUFACTURER'S SPECIFICATIONS AND RECOMMENDATIONS

PLAY STRUCTURE

SCALE: NTS

DT-FURN-PLAY-STRUC-EAST

DT-CURB-PLAY

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Date: 02.07.2022

Drawn By: SL

Checked By: CR

Sheet Name

SITE DETAILS

Sheet

LANDSCAPE SCHEDULE QUANTITY SYMBOL	BOTANIC NAME	COMMON NAME	SIZE	HEIGHT	SPREAD	QTY SYMBOL	BOTANIC NAME	COMMON N		SIZE	HEIGHT	SPREAD
DECIDUOUS TREES	BOTANIC NAME		SIZE		<u> </u>	EVERGREEN TRE				SIZE		SPREAD
23 ( <u>A</u> )	CATALPA SPECIOSA	NORTHERN CATALPA	2" CAL./B&B	50-60'	30-40'	32 2 +	PICEA PUNGENS	COLORADO	BLUE SPRUCE	6' HT.	80-100'	25-30'
	CELTIS OCCINDENTALIS	HACKBERRY	2" CAL./B&B	40-60'	40-60'	34 34	PINUS EDULIS	PINYON PIN	E	6' HT.	12-20'	12-15'
7 (*	GINKGO BILOBA	GINKGO	2" CAL./B&B	25-50'	25-35'	22 Juny	PINUS FLEXILIS 'VANDERWOLF'S PYRAMID'	VANDERWO	UE'S LIMBER PINE	6' HT.	20-25'	10-15'
24	GLEDITSIA TRIACANTHOS INERMIS	THORNLESS HONEYLOCUST	2" CAL./B&B	40-50'	35-45'		C PINUS NIGRA	AUSTRIAN F	PINE	6' HT.	50-60'	20-40'
	GYMNOCLADUS DIOICA 'ESPRESSO'	ESPRESSO KENTUCKY COFFEETREE	2" CAL./B&B	50-60'	30-35'	DECIDUOUS SHRU	J <u>BS</u> CHRYSOTHAMNUS NAUSEOSUS 'GRAVEOLENS'	TALL GREEN	N RABBITBRUSH	5 GAL.	4-6'	6'
	POPULUS ANGUSTIFOLIA	NARROWLEAF COTTONWOOD	2" CAL./B&B	50'	20-30'	122 🗵 7 〇	CORNUS STOLONIFERA 'FARROW' PHYSOCARPUS MONOGYNUS	ARCTIC FIRI		5 GAL. 5 GAL.	3-4' 3-4'	3-4' 3-4'
	POPULUS SARGENTII	PLAINS COTTONWOOD	2" CAL./B&B			14	RHUS AROMATICA 'GRO-LOW'	GRO-LOW S		5 GAL.	2-3'	6-8'
						$\begin{array}{c c} 46 & ( \bullet ) \\ 35 & ( \cdot ) \end{array}$	RHUS TRILOBATA SAMBUCUS PUBENS		IBER SUMAC	5 GAL. 5 GAL.	10-14" 10-15'	6-8' 6-8'
	QUERCUS SHUMARDII	SHUMARD OAK	2" CAL./B&B	40-60'	40-60'	28	VIBURNUM LENTAGO	NANNYBERF	RY	5 GAL.	12-16'	8-12'
25	QUERCUS MACROCARPA	BUR OAK	2" CAL./B&B	50-60'	35-45'	ORNAMENTAL GR	ASSES BOUTELOUA GRACILIS 'BLOND AMBITION'	BLOND AMB	ITION BLUE GRAMA	1 GAL.	20-24"	20-24"
	QUERCUS MUEHLENBERGII	CHINKAPIN OAK	2" CAL./B&B	40-50'	40-50'	31 ③	CALAMAGROSTIS BRACHYTRICHA	KOREAN FE	ATHER REED GRASS	1 GAL.	3-4'	3'
	TILIA AMERICANA 'REDMOND'	REDMOND LINDEN	2" CAL./B&B	40-60'	25-30'	71 <sup>⑧</sup> 56 <sup>新法</sup>	HESPEROSTIPA NEOMEXICANA NASSELLA TENUISSIMA		O FEATHERGRASS EATHERGRASS	1 GAL. 1 GAL.	2-3' 18-24"	2-3' 18-24"
	ULMUS 'ACCOLADE'	ACCOLADE ELM	2" CAL./B&B	65-75'	60-70'	COMMON NAME Western wheatgrase	DETENTION BASIN SEED MIX     (Drill rate: 6-7 lbs / 1,000 SF)     SCIENTIFIC NAME     Pascopyrum smithii	Percentage 51.93%		ND SEED MIX ate: 6-7 lbs / 1 SCIENTIFIC Agropyron c	000 SF) <u>NAME P</u> e	ercentage )%
20	ULMUS DAVIDIANA VAR. JAPONICA 'DISCOVERY'	DISCOVERY ELM	2" CAL./B&B	30-40'	30-40'	Smooth brome Alkaligrass	Bromus inermis Puccinellia	38.79% 4.69%	Perennial Ryegrass Sheep Fescue Upland Bluegrass. Drayler	Lolium perer Festuca ovin Poa pratensi	nne 25 a 15	5% 5%
	ULMUS 'MORTON SELECT'	MORTON SELECT ELM	2" CAL./B&B									
ORNAMENTAL TREES												
15	ACER GRANDIDENTATUM 'ROCKY MOUNTAIN GLOW'	ROCKY MOUNTAIN BIGTOOTH GLOW MAPLE	1.5" CAL.	20-25'	12-15'							
12 $\begin{pmatrix} + \\ + \end{pmatrix}$	ACER TATARICUM 'HOT WINGS'	HOT WINGS TATARIAN MAPLE	1.5" CAL.	15-20'	12-15'							
2 +	CRATAEGUS CRUSGALLI INERMIS	THORNLESS COCKSPUR HAWTHORN	1.5" CAL.	15-20'	15-20'							
23 (+)	MALUS X 'SPRING SNOW'	SPRING SNOW CRABAPPLE	1.5" CAL.	20-25'	20'							

### FINAL DEVELOPMENT PLAN

PART OF THE SOUTHEAST QUARTER OF SECTION 7, T 4 N., R. 67 W. OF THE 6TH P.M., COUNTY OF WELD, STATE OF COLORADO

LANDSCAPE STANDARDS

THE DESIGN INTENT FOR THE GRAINARY PUD IS TO CREATE A PLANNED COMMUNITY THAT CELEBRATES THE SURROUNDING PLAINS ECOSYSTEM. WATER CONSERVATION THROUGH APPROPRIATE LANDSCAPING TECHNIQUES AND PLANT SPECIES SELECTION WILL BE EMPHASIZED FOR THE PROJECT.

SINGLE-FAMILY RESIDENTIAL LOT TREATMENT INDIVIDUAL LOT LANDSCAPING WILL BE PROVIDED BY EACH HOMEOWNER, OR THE BUILDER AT THE BUILDER'S DISCRETION. DESIGN SHALL BE IN ACCORDANCE WITH THE COVENANTS OF THE COMMUNITY. ONE(1) TREE PER LOT SHALL BE REQUIRED IN THE FRONT YARD, TWO(2) TREES SHALL BE REQUIRED IN THE FRONT YARD OF CORNER LOTS, ONE(1) WITHIN THE FRONT YARD AND ONE(1) IN THE THE SIDE YARD FACING PUBLIC R.O.W. A MINIMUM OF 30% OF EACH SINGLE-FAMILY LOT SHALL CONSIST OF DRIP IRRIGATED SHRUB BEDS WITH LOW TO MEDIUM WATER USE PLANTS.

GENERAL LANDSCAPE NOTES:

- ONE GRADE.
- 5
- WATERED TO PREVENT DEHYDRATION. 7. SOIL AMENDMENT:
  - HUNDRED (100) POUNDS NITROGEN PER ACRE.

ACCEPTABLE PRODUCT: CLASS I COMPOST. COMPOSTED MATERIAL SHALL CONSIST OF AGED ORGANIC MATTER, FREE OF WEED OR OTHER NOXIOUS PLANT SEEDS, LUMPS, STONES, OR OTHER FOREIGN CONTAMINANTS HARMFUL TO PLANT LIFE, AND HAVING THE FOLLOWING CHARACTERISTICS BASED ON A NUTRIENT TEST PERFORMED NO LONGER THAN 3 MONTHS PRIOR TO ITS INCORPORATION INTO THE PROJECT:

- A. ORGANIC MATTER: 25% MINIMUM. B. SALT CONTENT: 5.0 MMHOS/CM MAXIMUM
- C. PH: 7.5 MAXIMUM.
- D. CARBON TO NITROGEN RATIO OF 10:1 TO 20:1
- 8. SOD TO BE REPLACED OVER ALL TRENCHED IRRIGATION LINES.
- ENLARGED. MULCH TO MATCH EXISTING.
- THROUGHOUT CONSTRUCTION PERIOD.
- WHEN PLANTING IS AT FULL MATURITY.
- STORM OR SANITARY SEWER LINES.

1. ALL LANDSCAPING AND PLANTS TO BE LOCATED NOT TO INTERFERE WITH EXISTING OR PROPOSED UTILITIES CONTRACTOR SHALL VERIFY LOCATION OF ALL UNDERGROUND UTILITIES, LINES AND STRUCTURES PRIOR TO EXCAVATION OR TRENCHING. DAMAGE TO THESE UTILITIES SHALL BE REPAIRED BY THE CONTRACTOR AT NO COST TO THE OWNER OR LANDSCAPE ARCHITECT. 2. ALL PLANT MATERIALS SHALL BE IN ACCORDANCE WITH AAN (AMERICAN ASSOCIATION OF NURSERYMEN) SPECIFICATIONS FOR NUMBER

3. PLANT QUANTITIES SHOWN FOR INFORMATION PURPOSES ONLY, CONTRACTOR TO VERIFY ALL QUANTITIES. 4. ALL TREE AND SHRUB LOCATIONS SHALL BE STAKED BY CONTRACTOR AND APPROVED BY LANDSCAPE ARCHITECT. PLANT SUBSTITUTIONS WILL NOT BE PERMITTED WITHOUT APPROVAL FROM LANDSCAPE ARCHITECT. 6. PLANTS SHALL BE INSTALLED IMMEDIATELY UPON DELIVERY TO SITE, IF THIS IS NOT POSSIBLE, PLANTS SHALL BE HEELED IN AND

SOD AREAS - 4 C.Y. PER 1,000 S.F. OF COMPOST TILLED INTO 4" OF EXISTING SOIL. APPLY DIAMONIUM PHOSPHATE (18-46-0) AT ONE

SHRUB AND PLANTING BEDS - 4" OF COMPOST TILLED INTO 6" OF EXISTING SOIL.


9. INSTALL 4" OF ORGANIC WOOD MULCH IN EXISTING PLANTING BEDS AND TREE PLANTING PITS THAT HAVE BEEN DISTURBED OR

10. ALL DAMAGED OR DEAD PLANT MATERIAL TO BE REPLACED WITHIN WARRANTY PERIOD. CONTRACTOR TO PROVIDE WATER

11. NO TREES OR SHRUBS ARE TO BE PLANTED WITHIN THE HILLSBOROUGH DITCH EASEMENT.

12. ALL PLANTINGS, OTHER THAN SOD/NATIVE GRASSES, MUST PROVIDE MINIMUM CLEARANCE OF THREE (3) AROUND ANY FIRE HYDRANT,

13. NO PLANTS (TREES/SHRUBS) OVER 24" IN HEIGHT SHALL BE PLANTED WITHIN SIGHT TRIANGLES. 14. NO TREES OR LARGE SHRUBS (OVER 10' MATURE HEIGHT) SHALL BE PLANTED WITHIN 10' (TREES) / 5' (LARGE SHRUBS) OF ANY WATER,

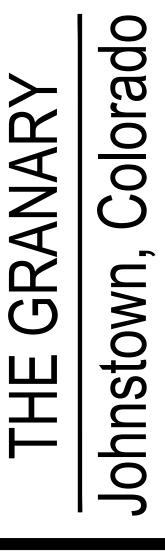



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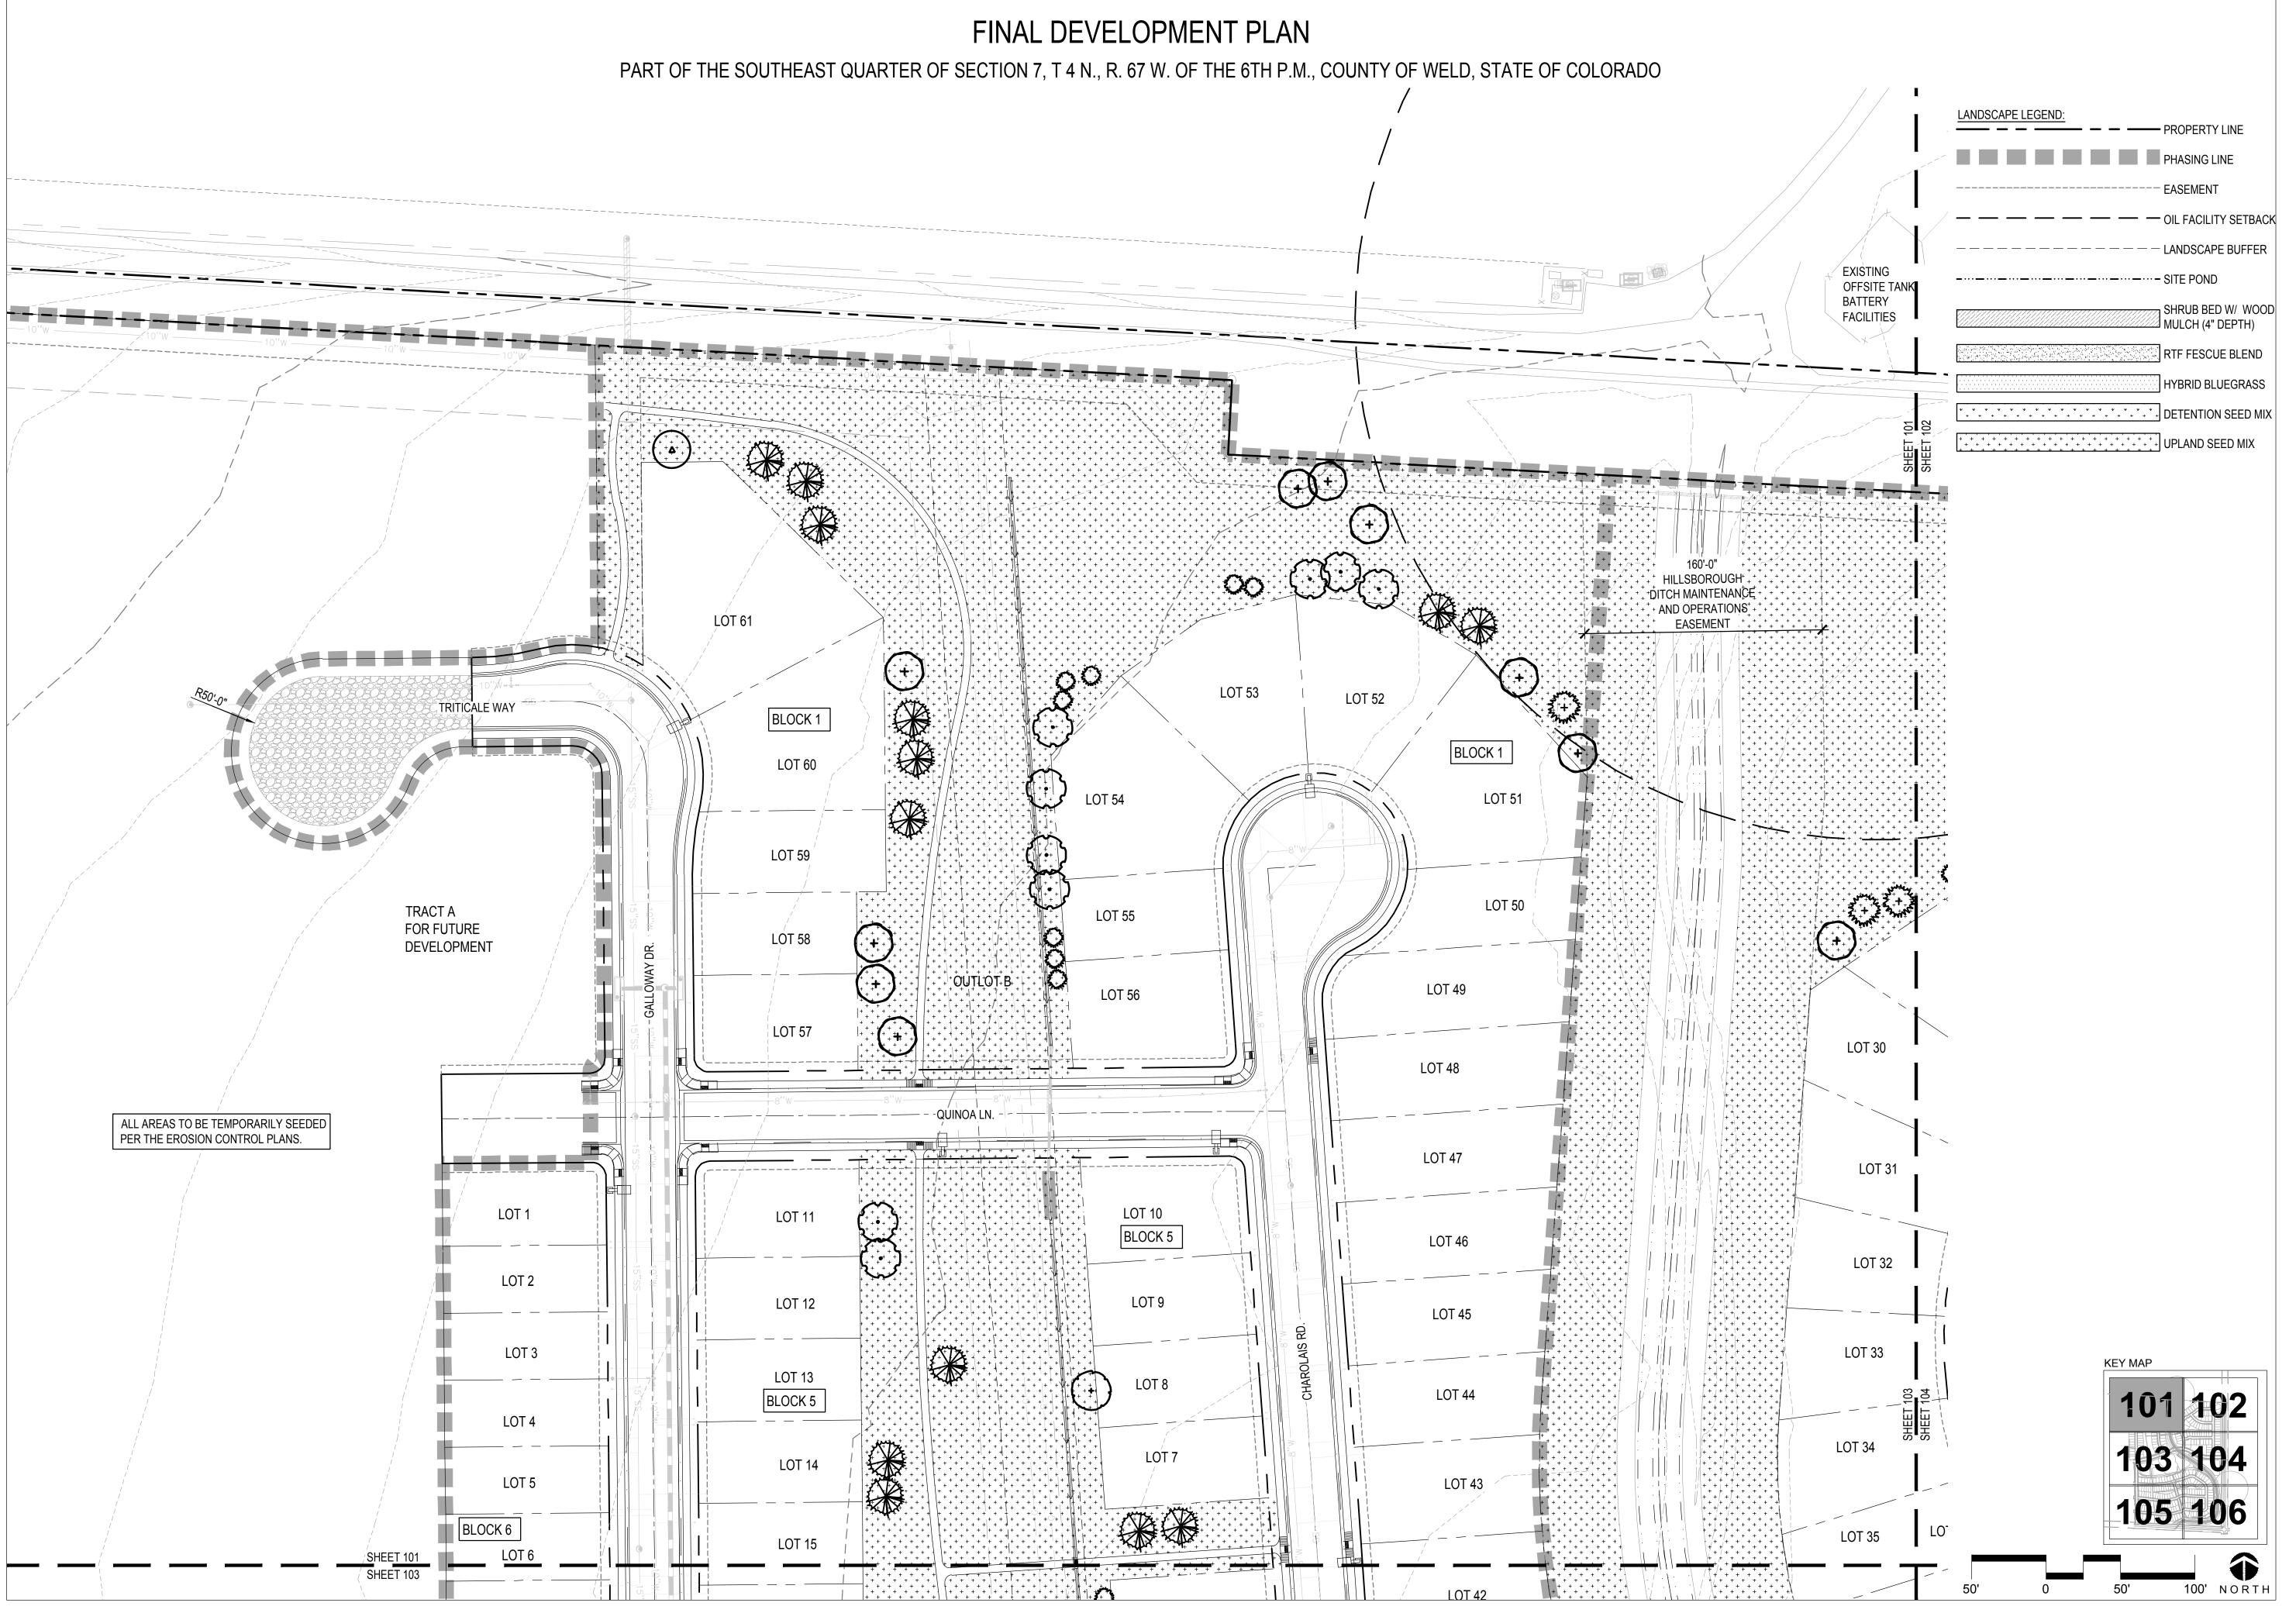
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Date: 02.07.2022

Drawn By: SL Checked By: CR

Sheet Name LANDSCAPE SCHEDULE AND NOTES

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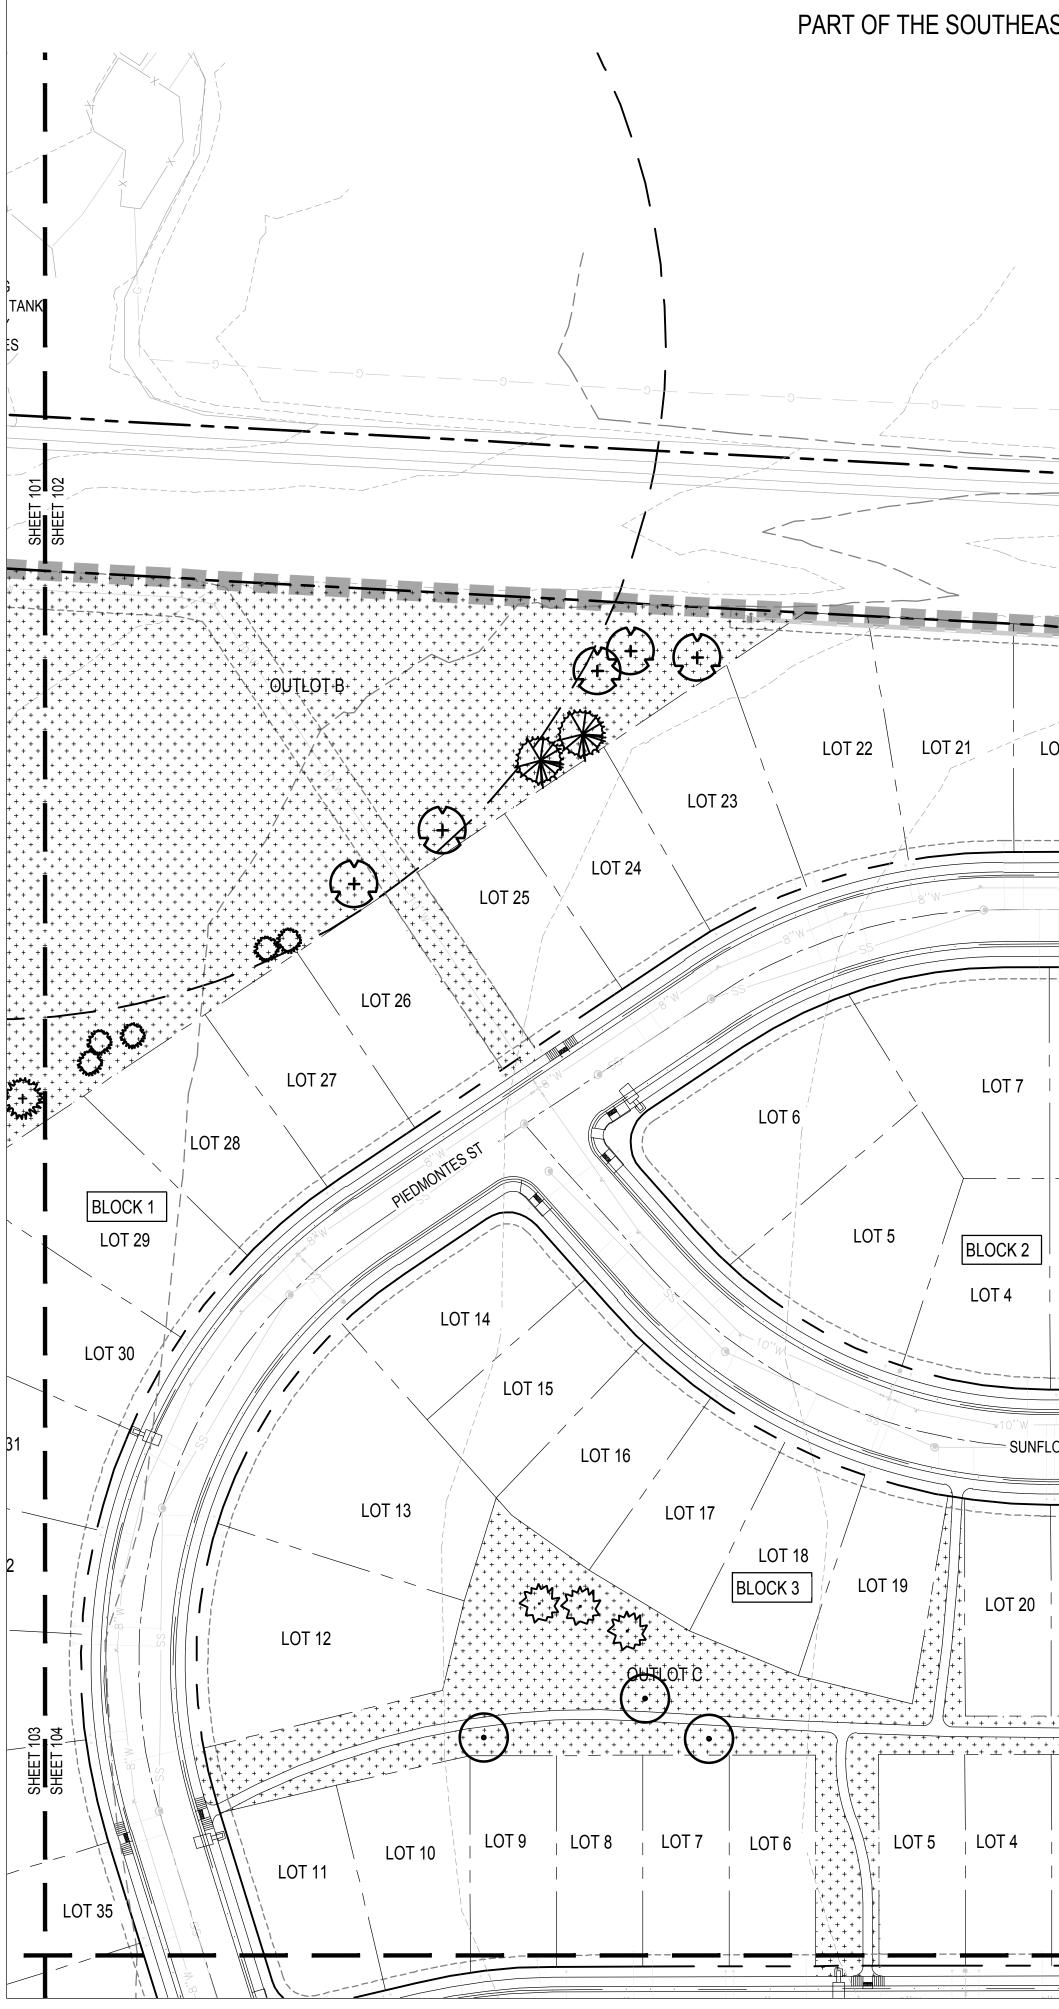
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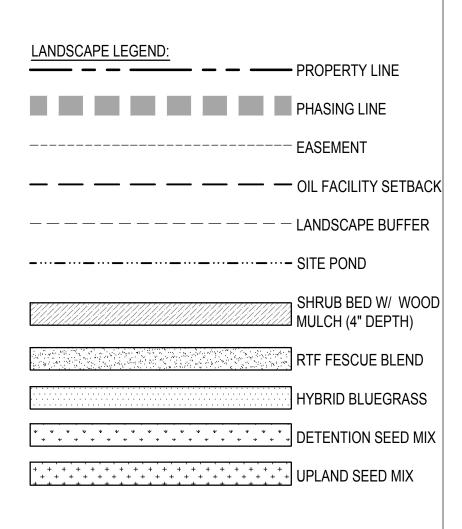
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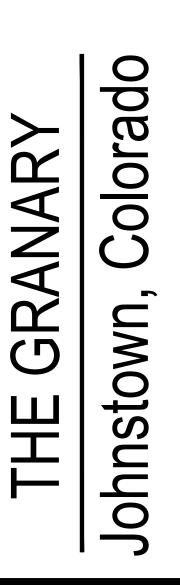
LANDSCAPE PLAN

Sheet

### THE GRANARY FILING ONE and FILING TWO FINAL DEVELOPMENT PLAN PART OF THE SOUTHEAST QUARTER OF SECTION 7, T 4 N., R. 67 W. OF THE 6TH P.M., COUNTY OF WELD, STATE OF COLORADO LOT 21 LOT 20 LOT 19 | LOT 18 LOT 17 LOT 16 LOT 15 LOT 7 | LOT 8 | LOT 9 | LOT 10 -LOT 14 25'-0" TEMPORARY EMERGENCY ACCESS EASEMENT THAT WILL BE IN PLACE UNTIL GALLOWAY DR IS CONNECTED R TO ROOSEVELT PARKWAY BLOCK 2 LOT 13 LOT 4 LOT 3 LOT 2 LOT 1 LOT 12 ζ<sup>μ</sup>ιν LOT 11 SUNFLOWER WAY LOT 10 LOT 20 LOT 21 LOT 22 LOT 23 LOT 9 ۲<sup>4</sup>4 LOT 8 BLOCK 1 LOT 2 LOT 1 LOT 4 LOT 3 LOT 7 **+**|| SHEET 102 SHEET 104









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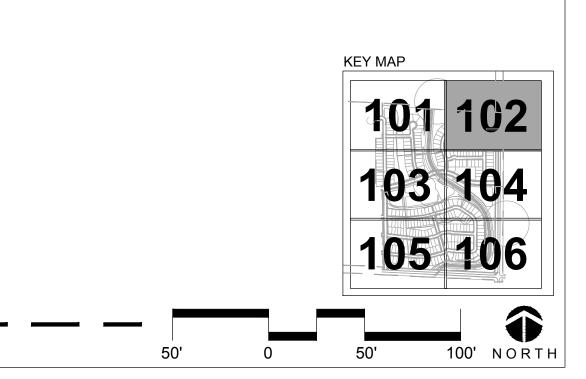
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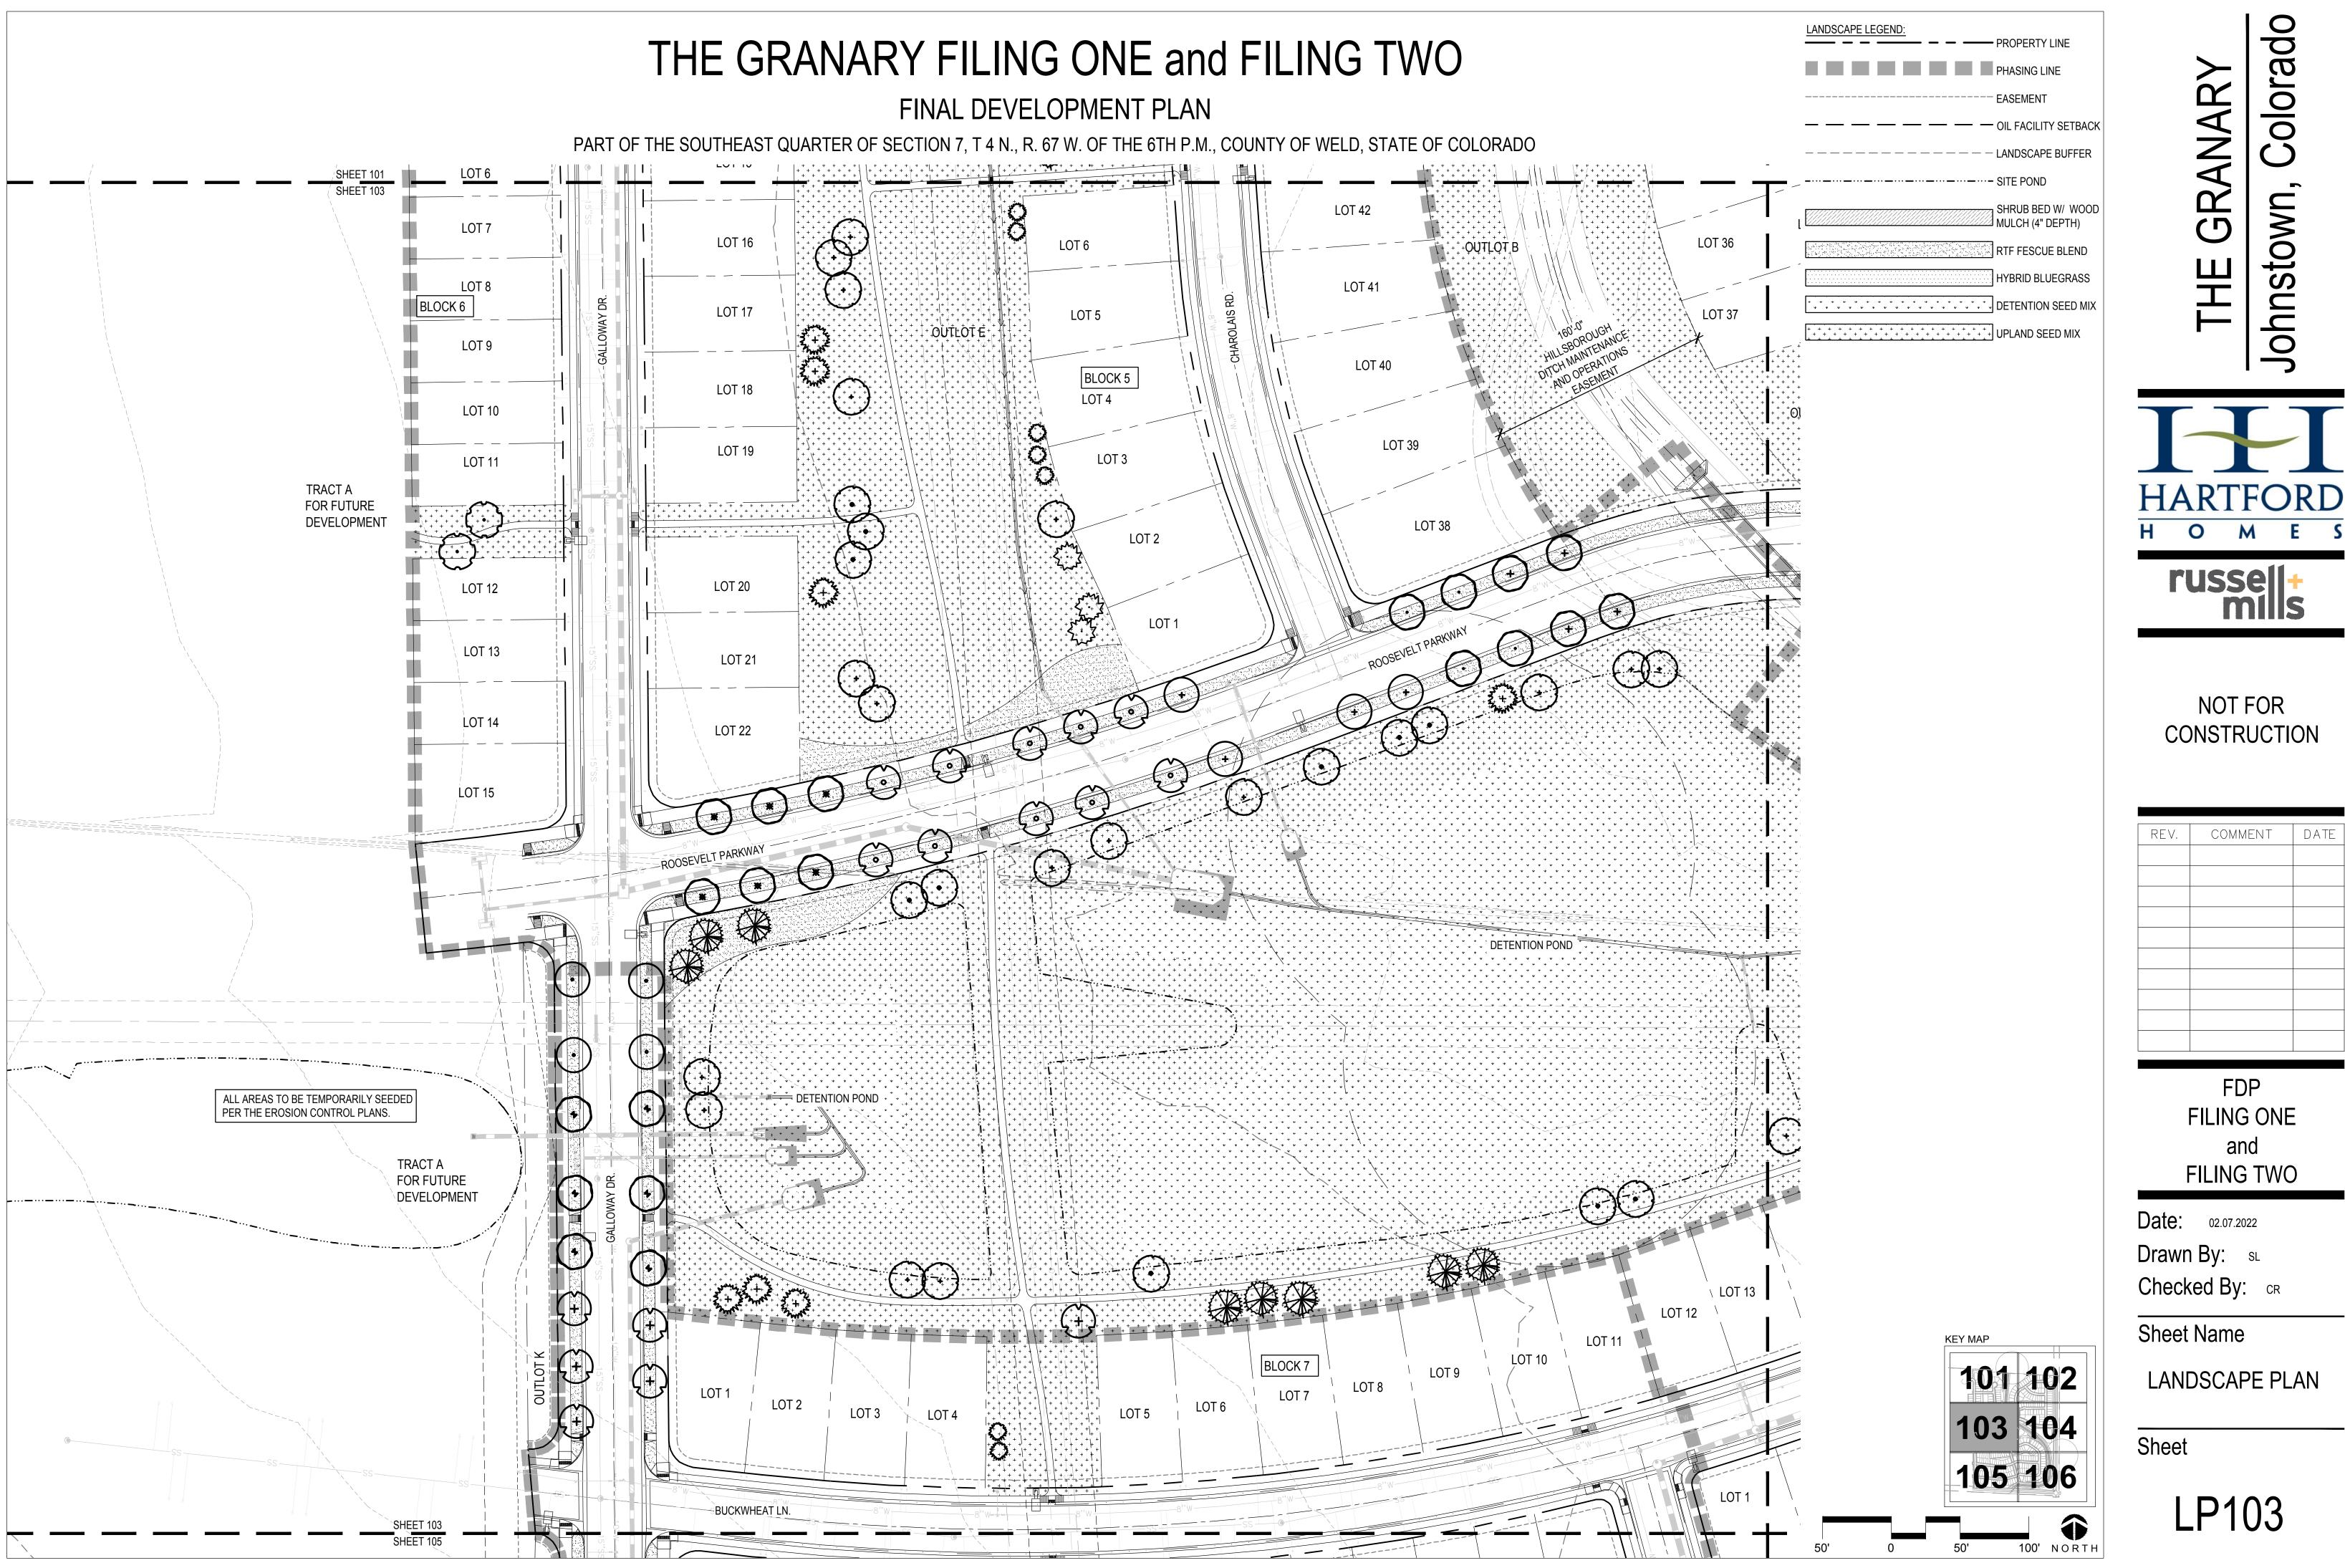
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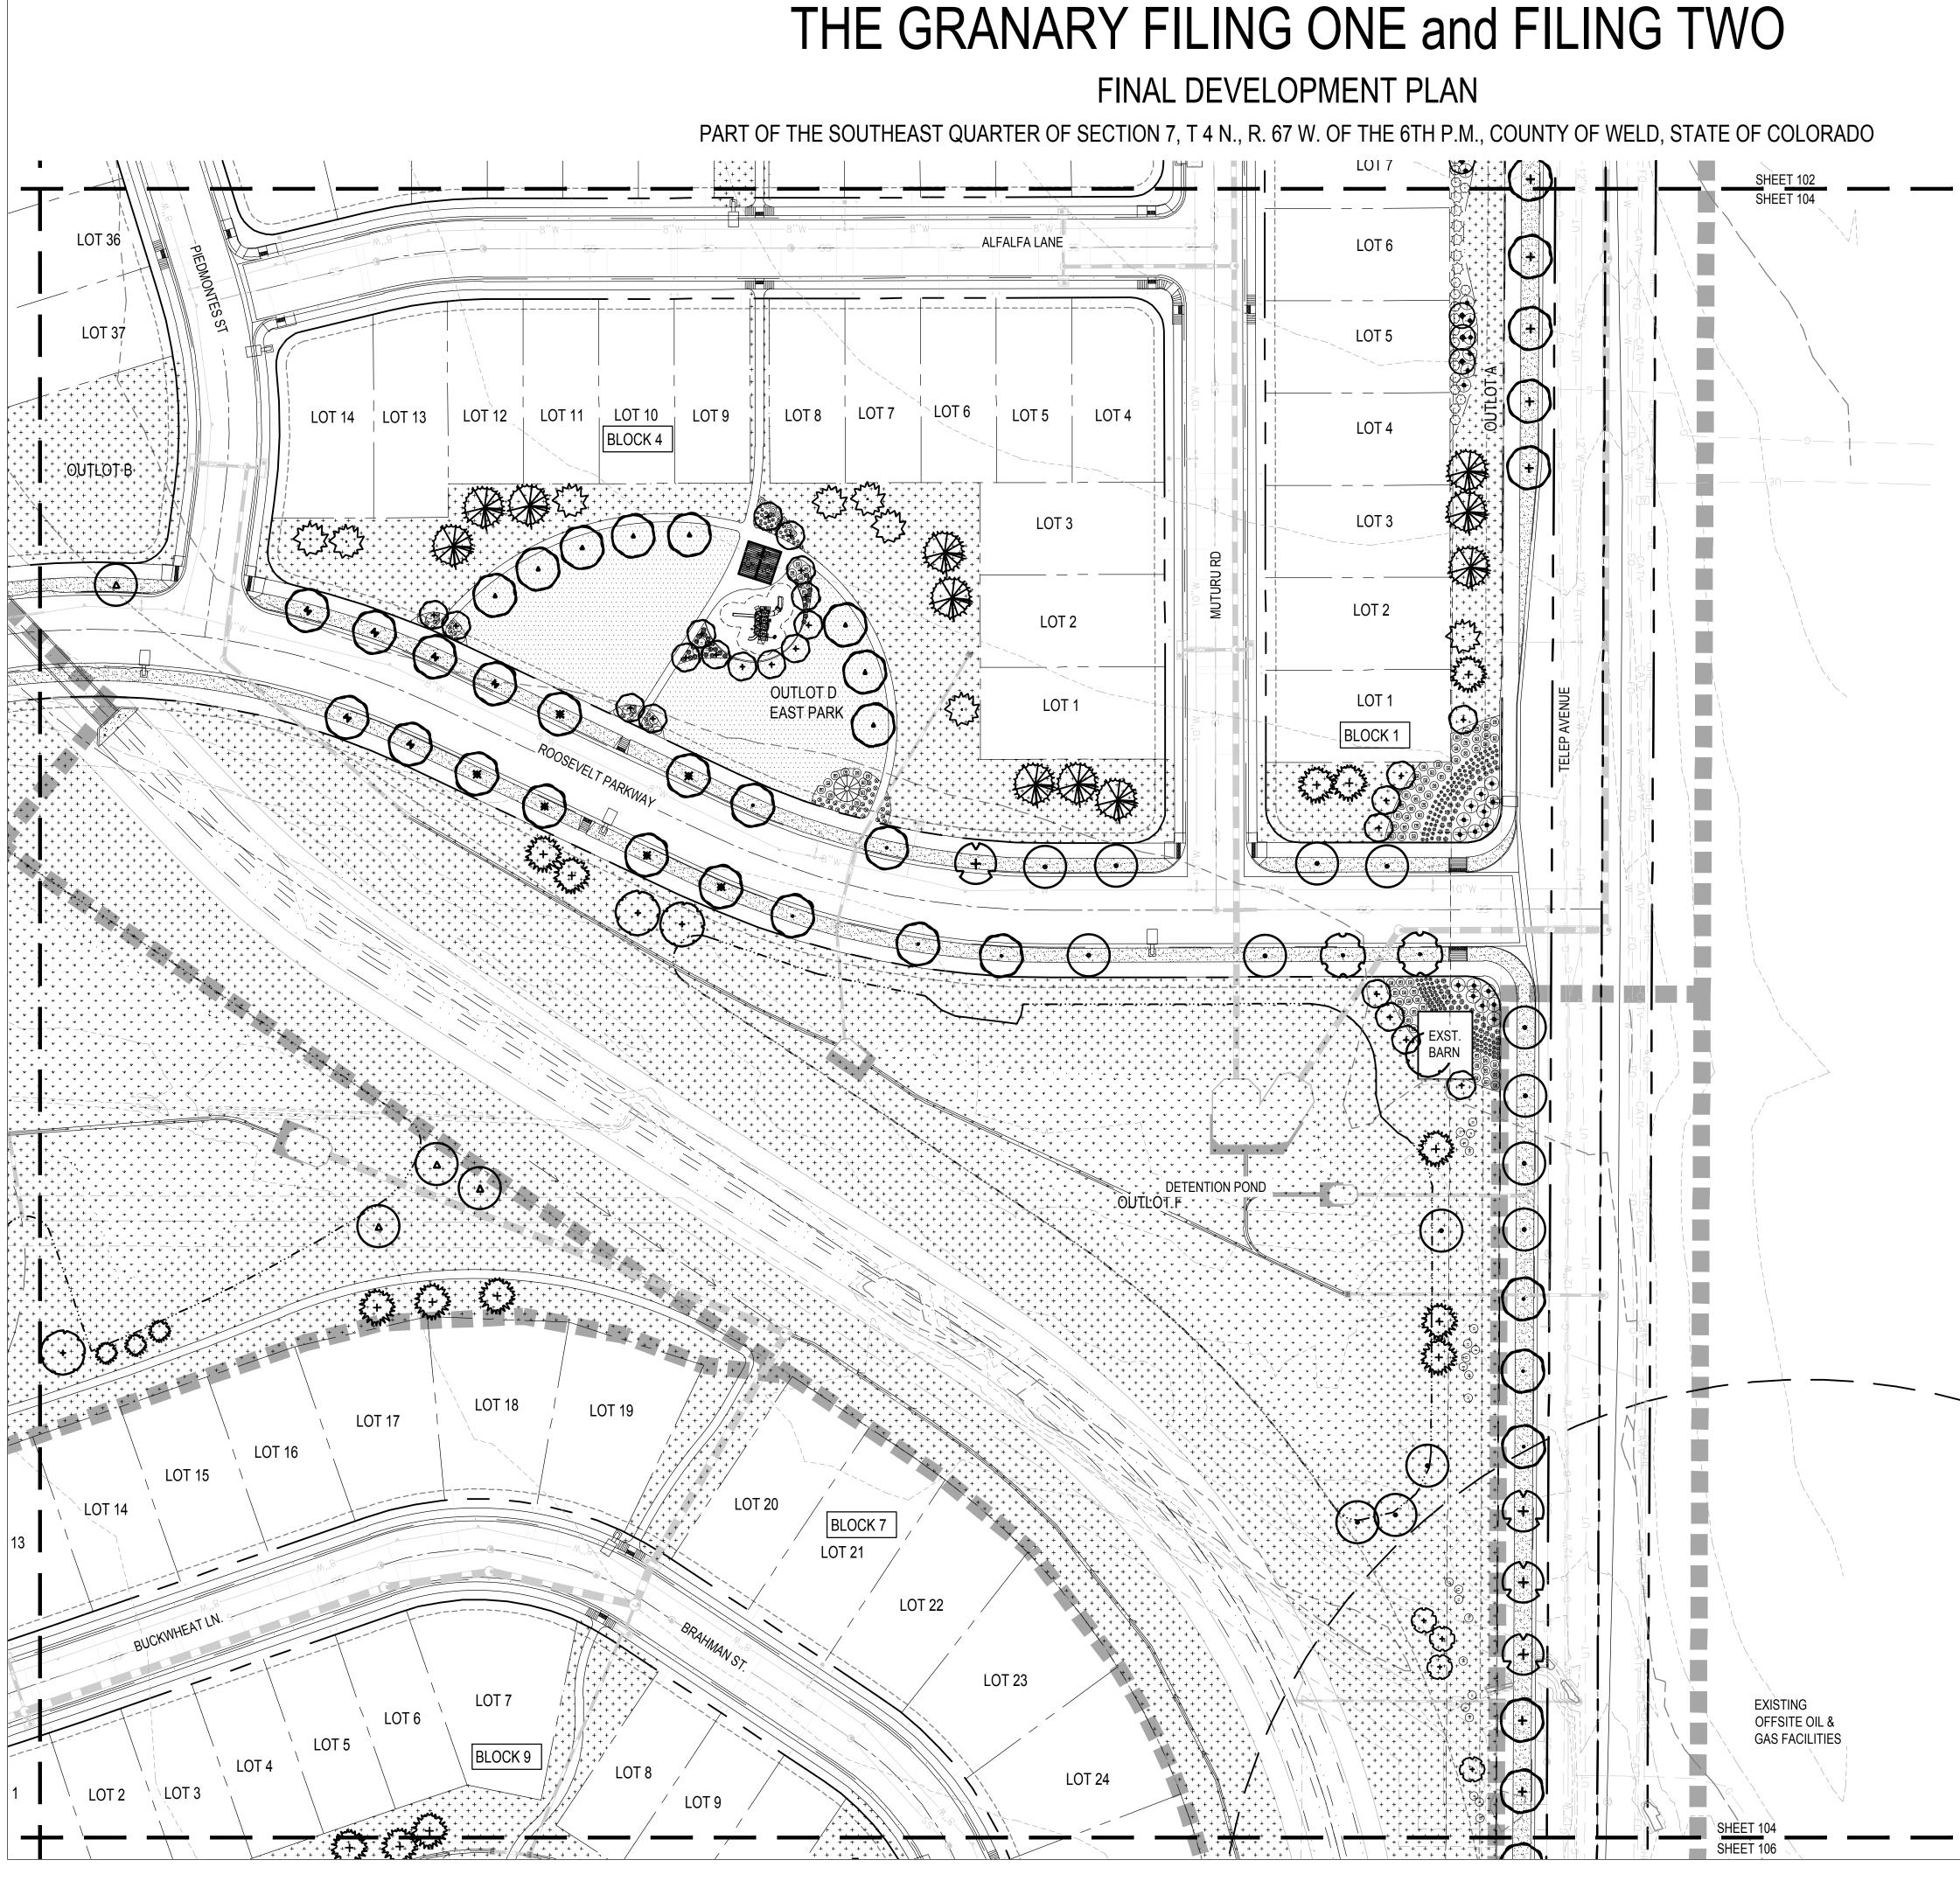
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LANDSCAPE PLAN


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LANDSCAPE LEGEND:
PHASING LINE
EASEMENT
LANDSCAPE BUFFER
SHRUB BED W/ WOOD MULCH (4" DEPTH)
RTF FESCUE BLEND
HYBRID BLUEGRASS
DETENTION SEED MIX
(+++++++++++++++++++++++++++++++++++++





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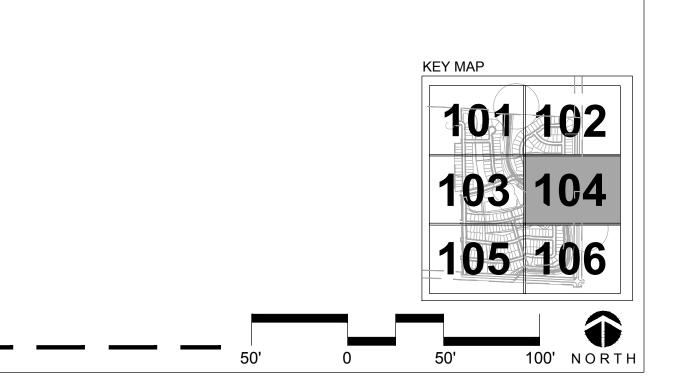
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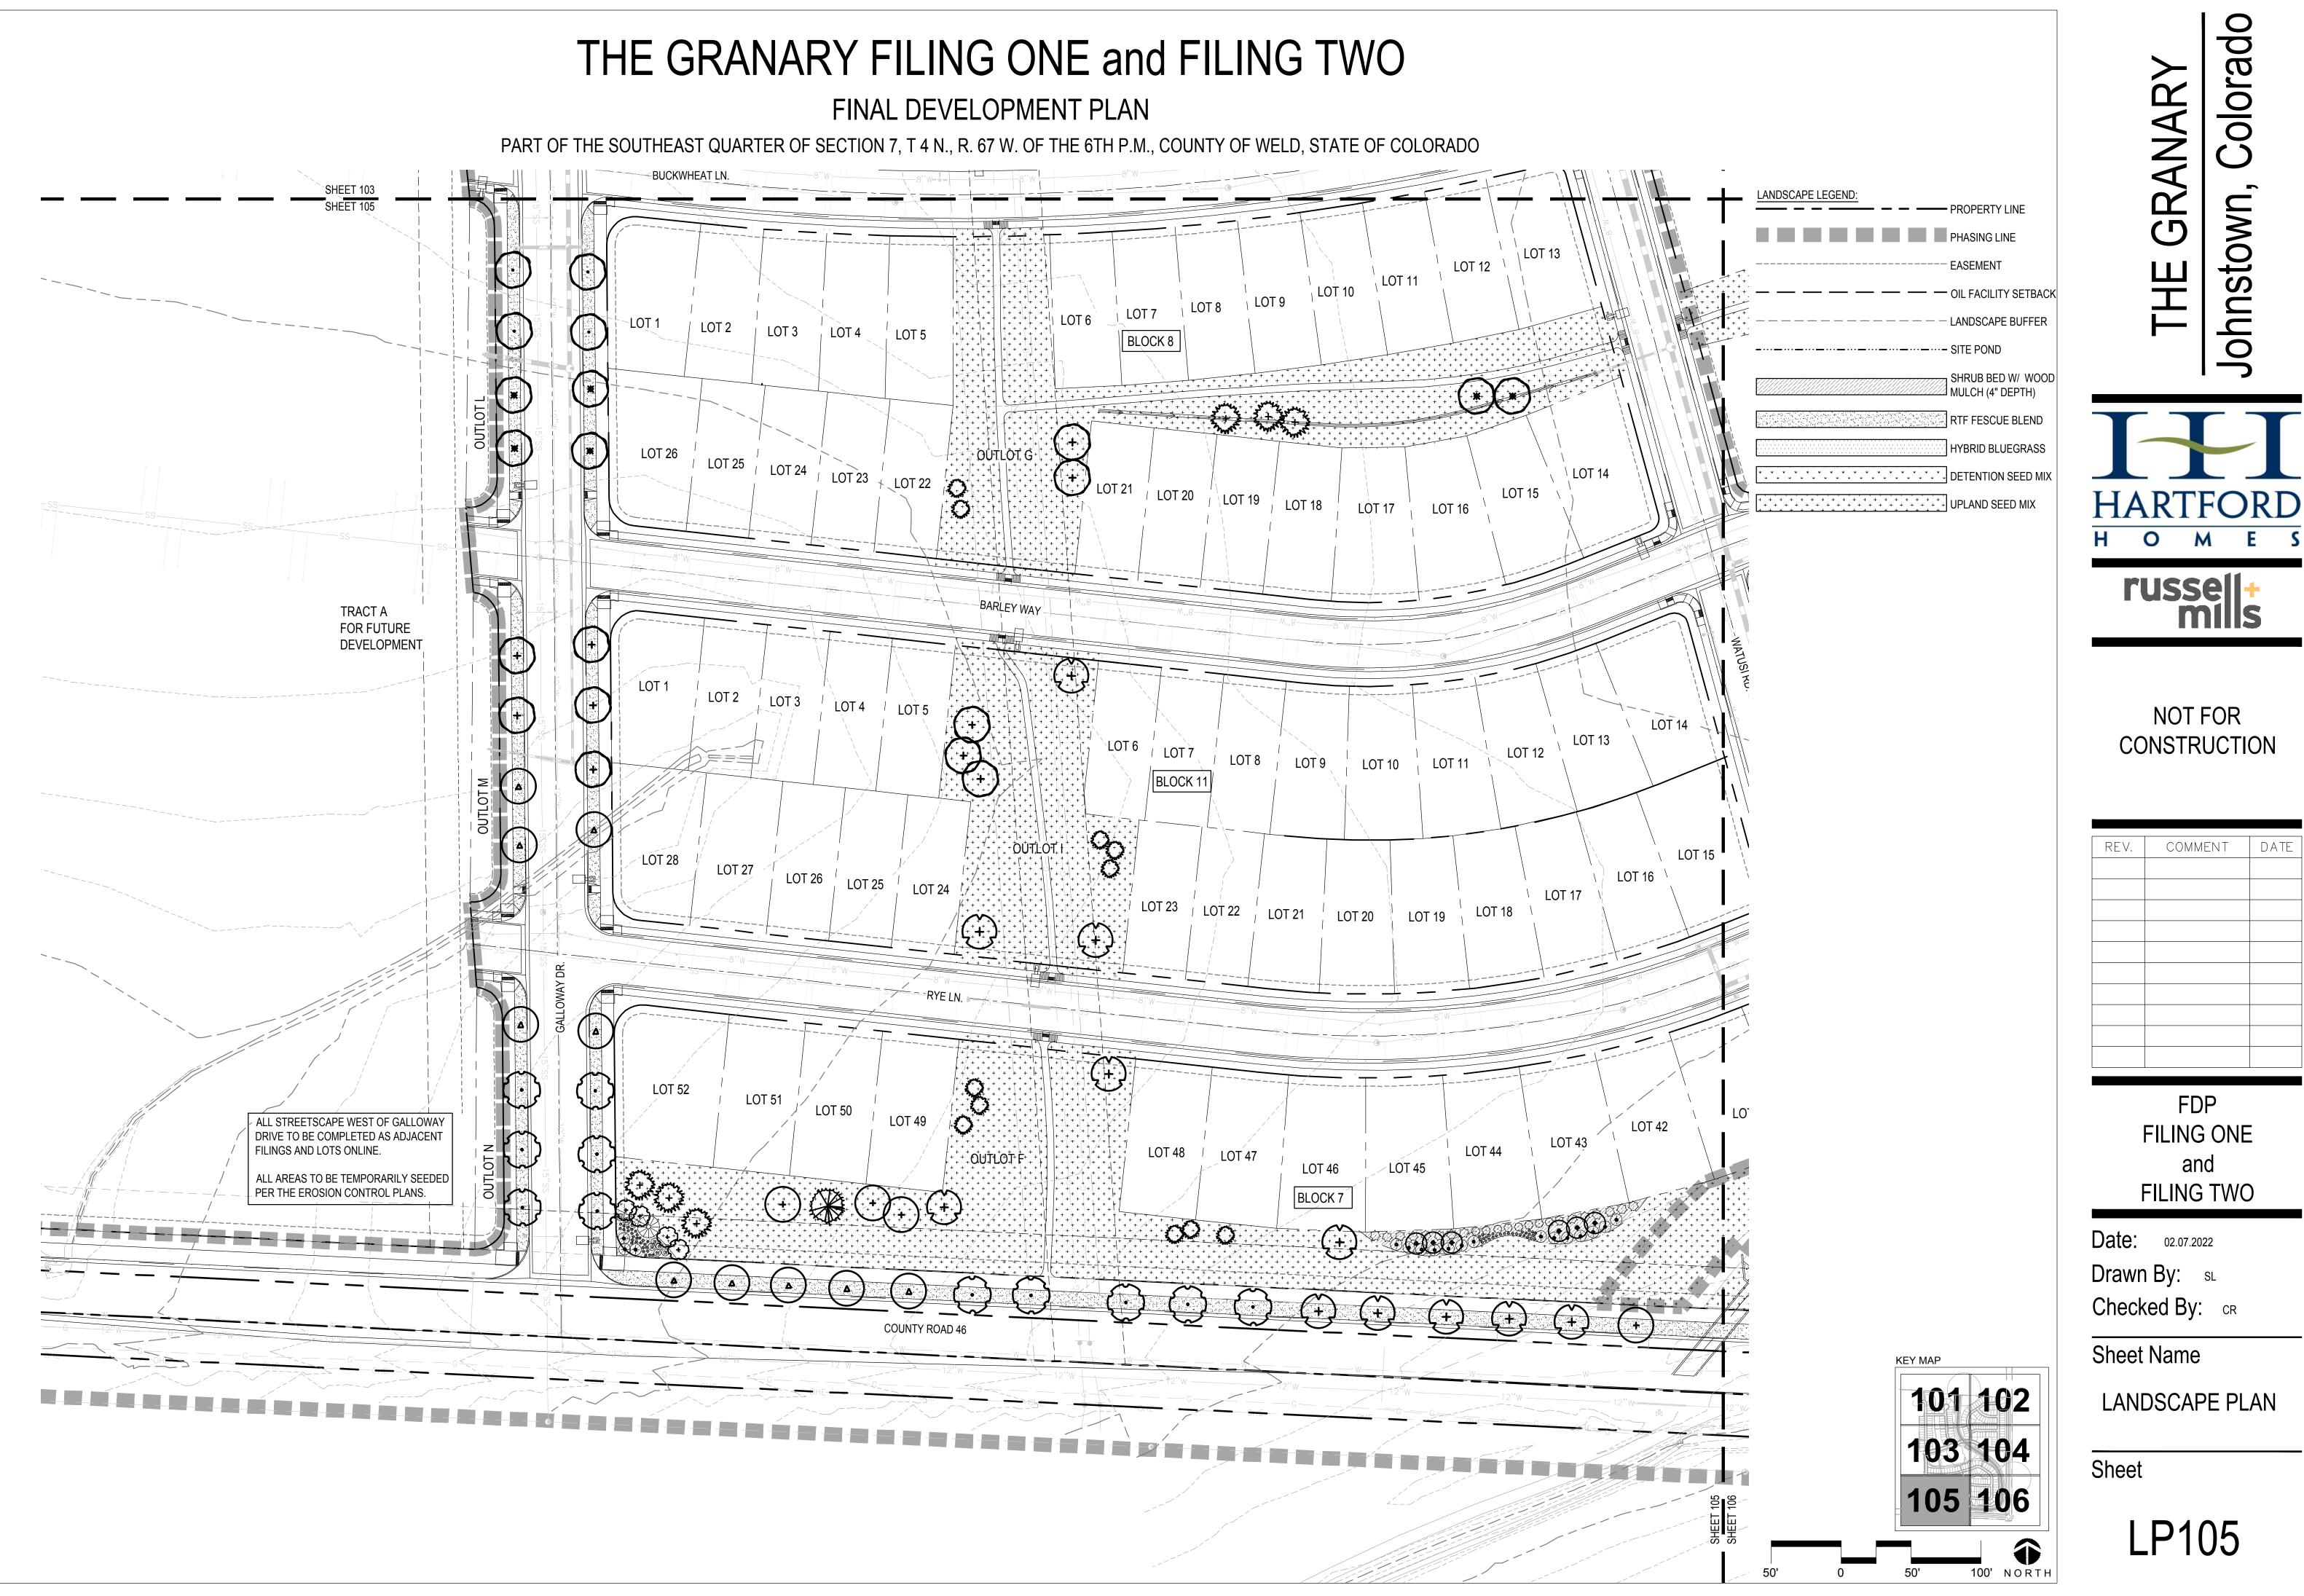
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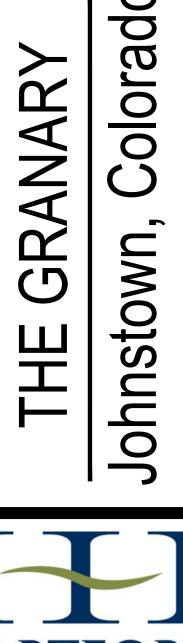
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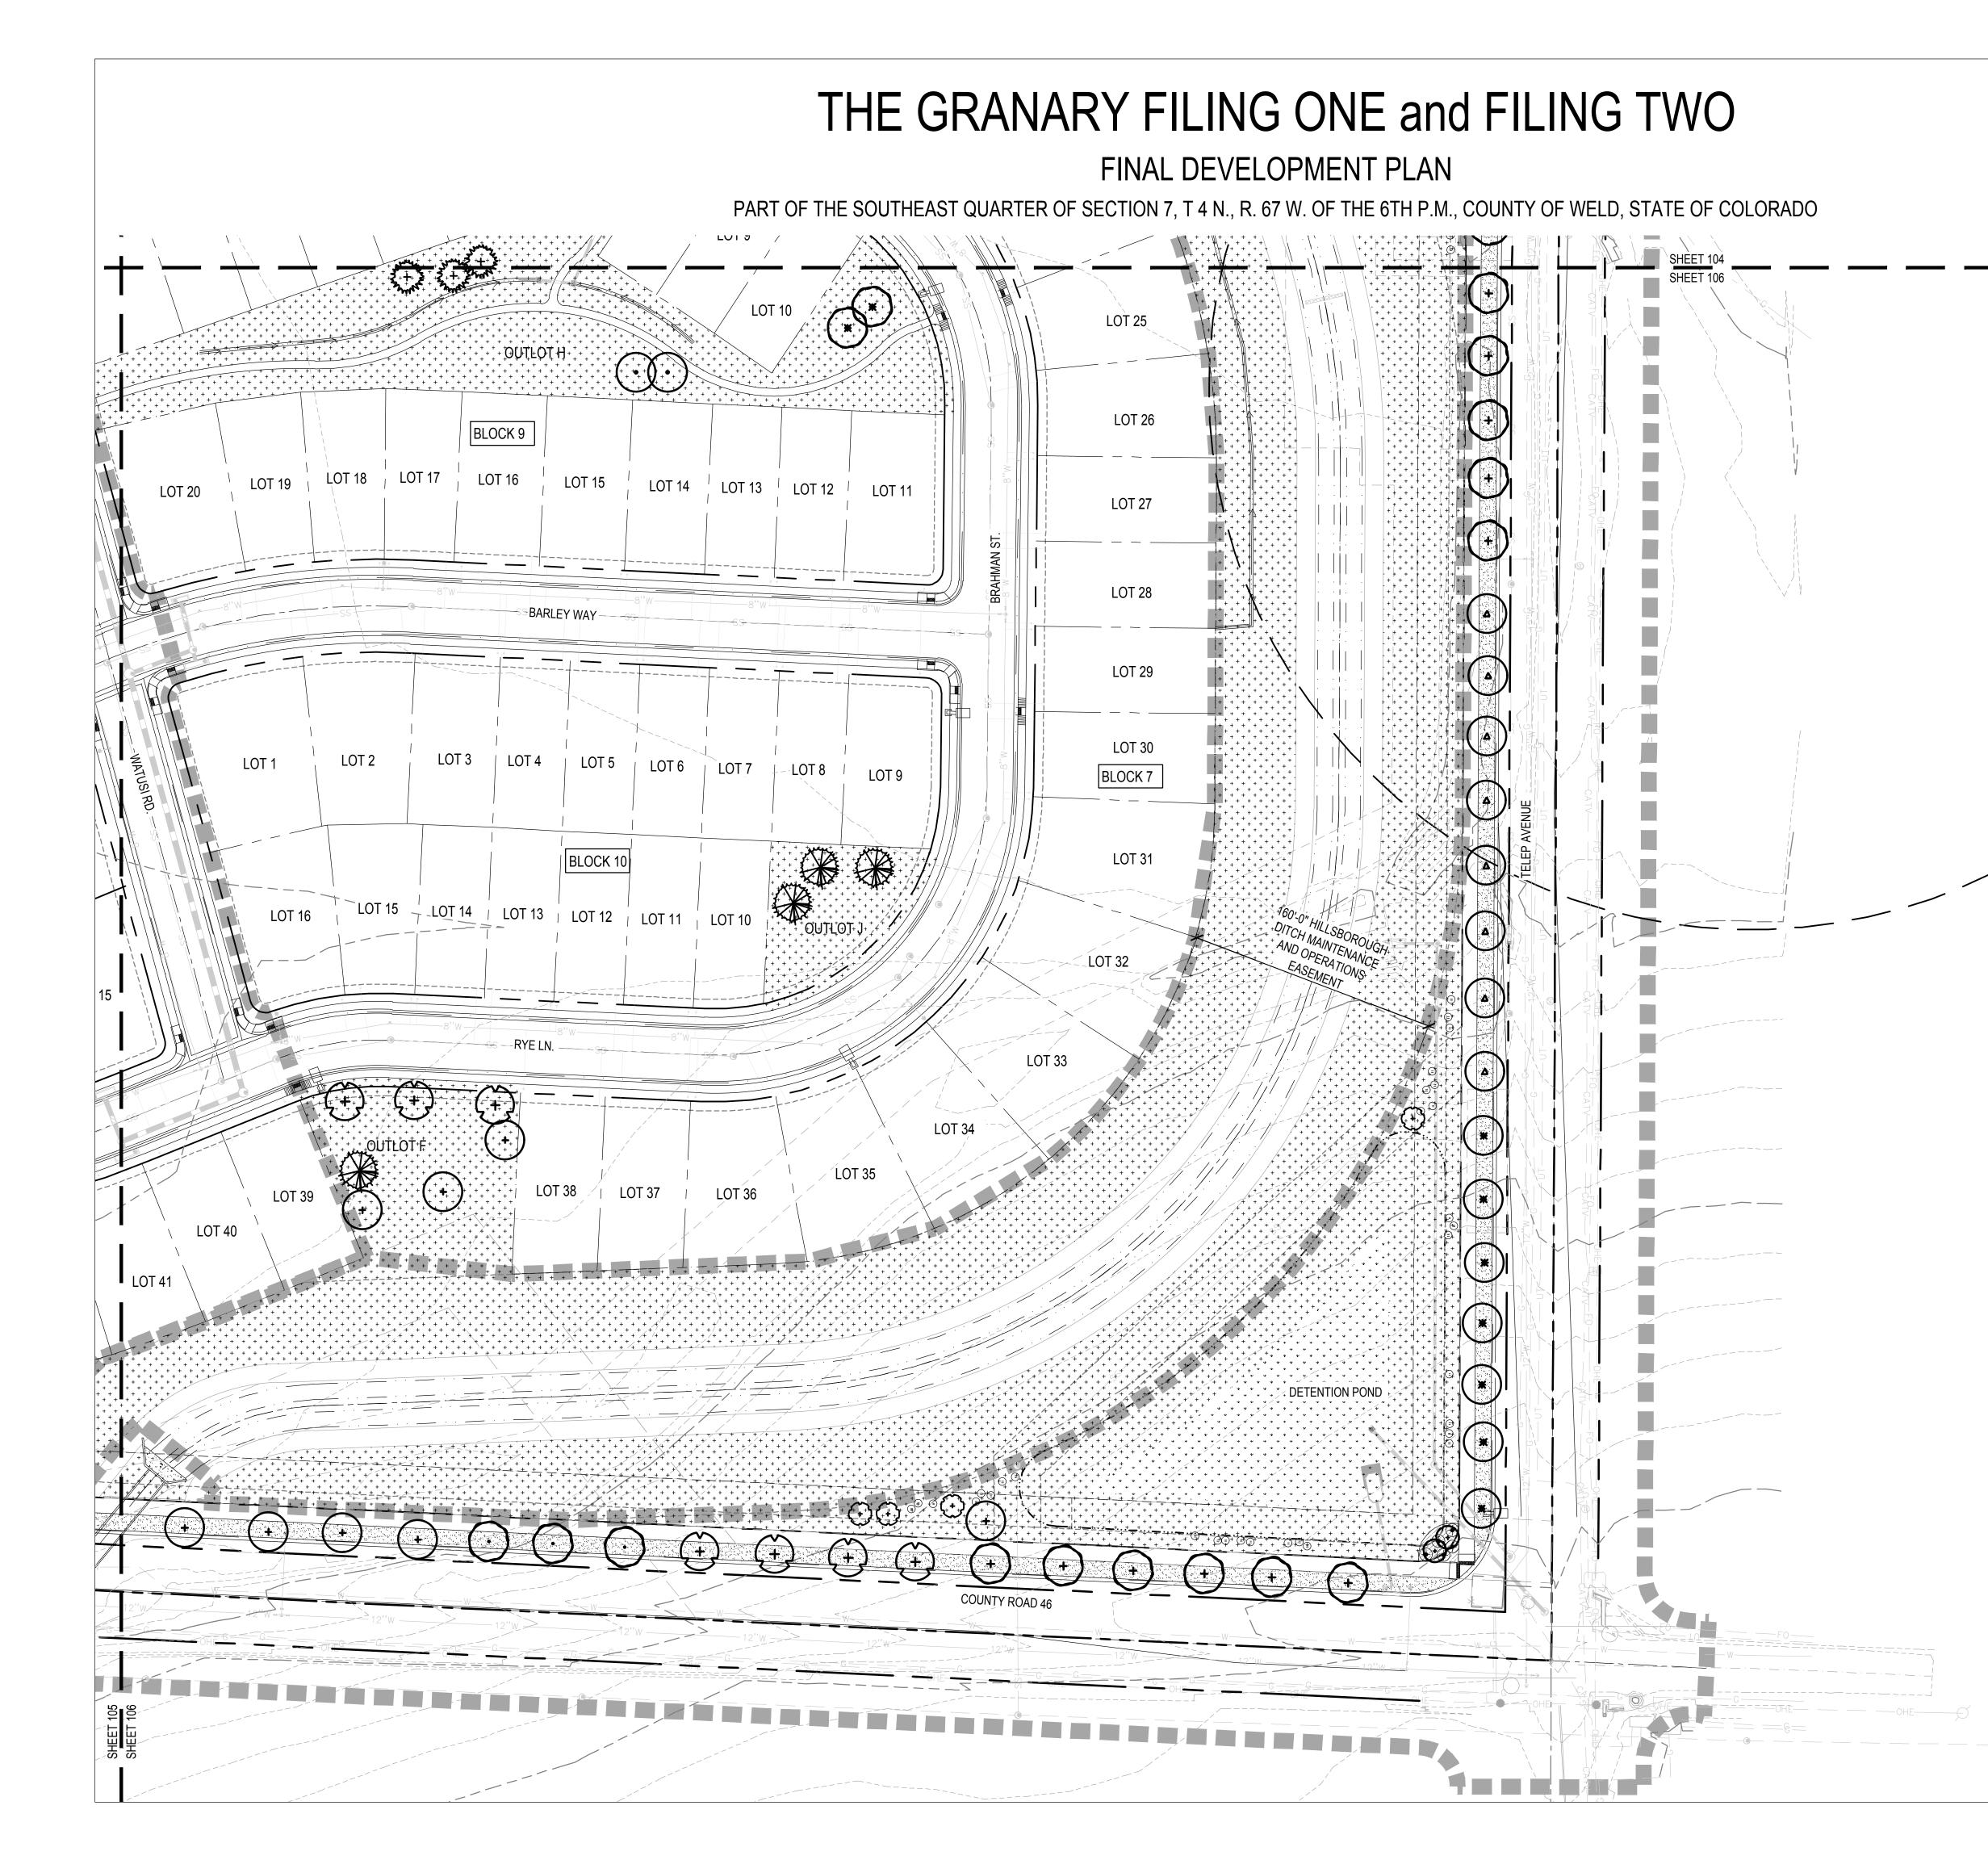
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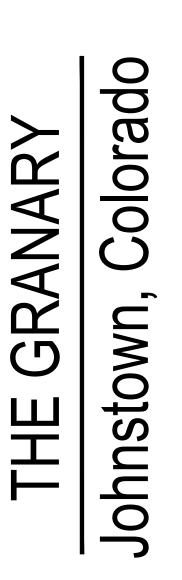


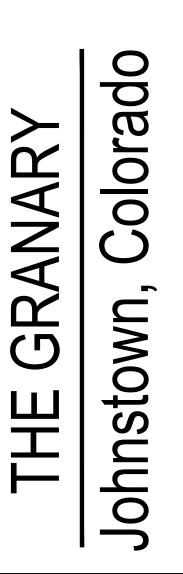

COMMENT	DATE



LANDSCAPE LEGEND:	
	PROPERTY LINE
	PHASING LINE
	EASEMENT
	OIL FACILITY SETBACK
	LANDSCAPE BUFFER
	SITE POND
- (/ ! ` / / / ! ` / / / ! ` / / / ! ` / / / ! ` / / / ! ` / / / ! ` / / / ! ` / / / ! ` / / / ! ` / / / ! ` /	Shrub Bed W/ Wood Mulch (4" Depth)
	RTF FESCUE BLEND
	HYBRID BLUEGRASS
• • • • • • • • • • • • • • • • • •	DETENTION SEED MIX
	UPLAND SEED MIX





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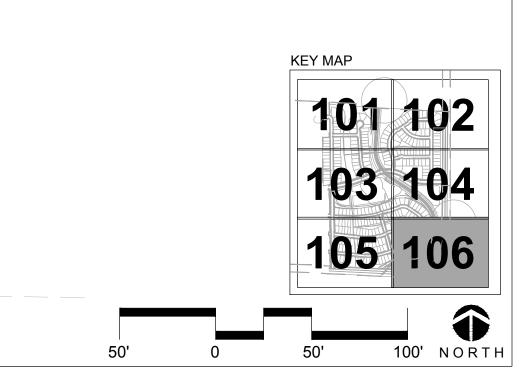
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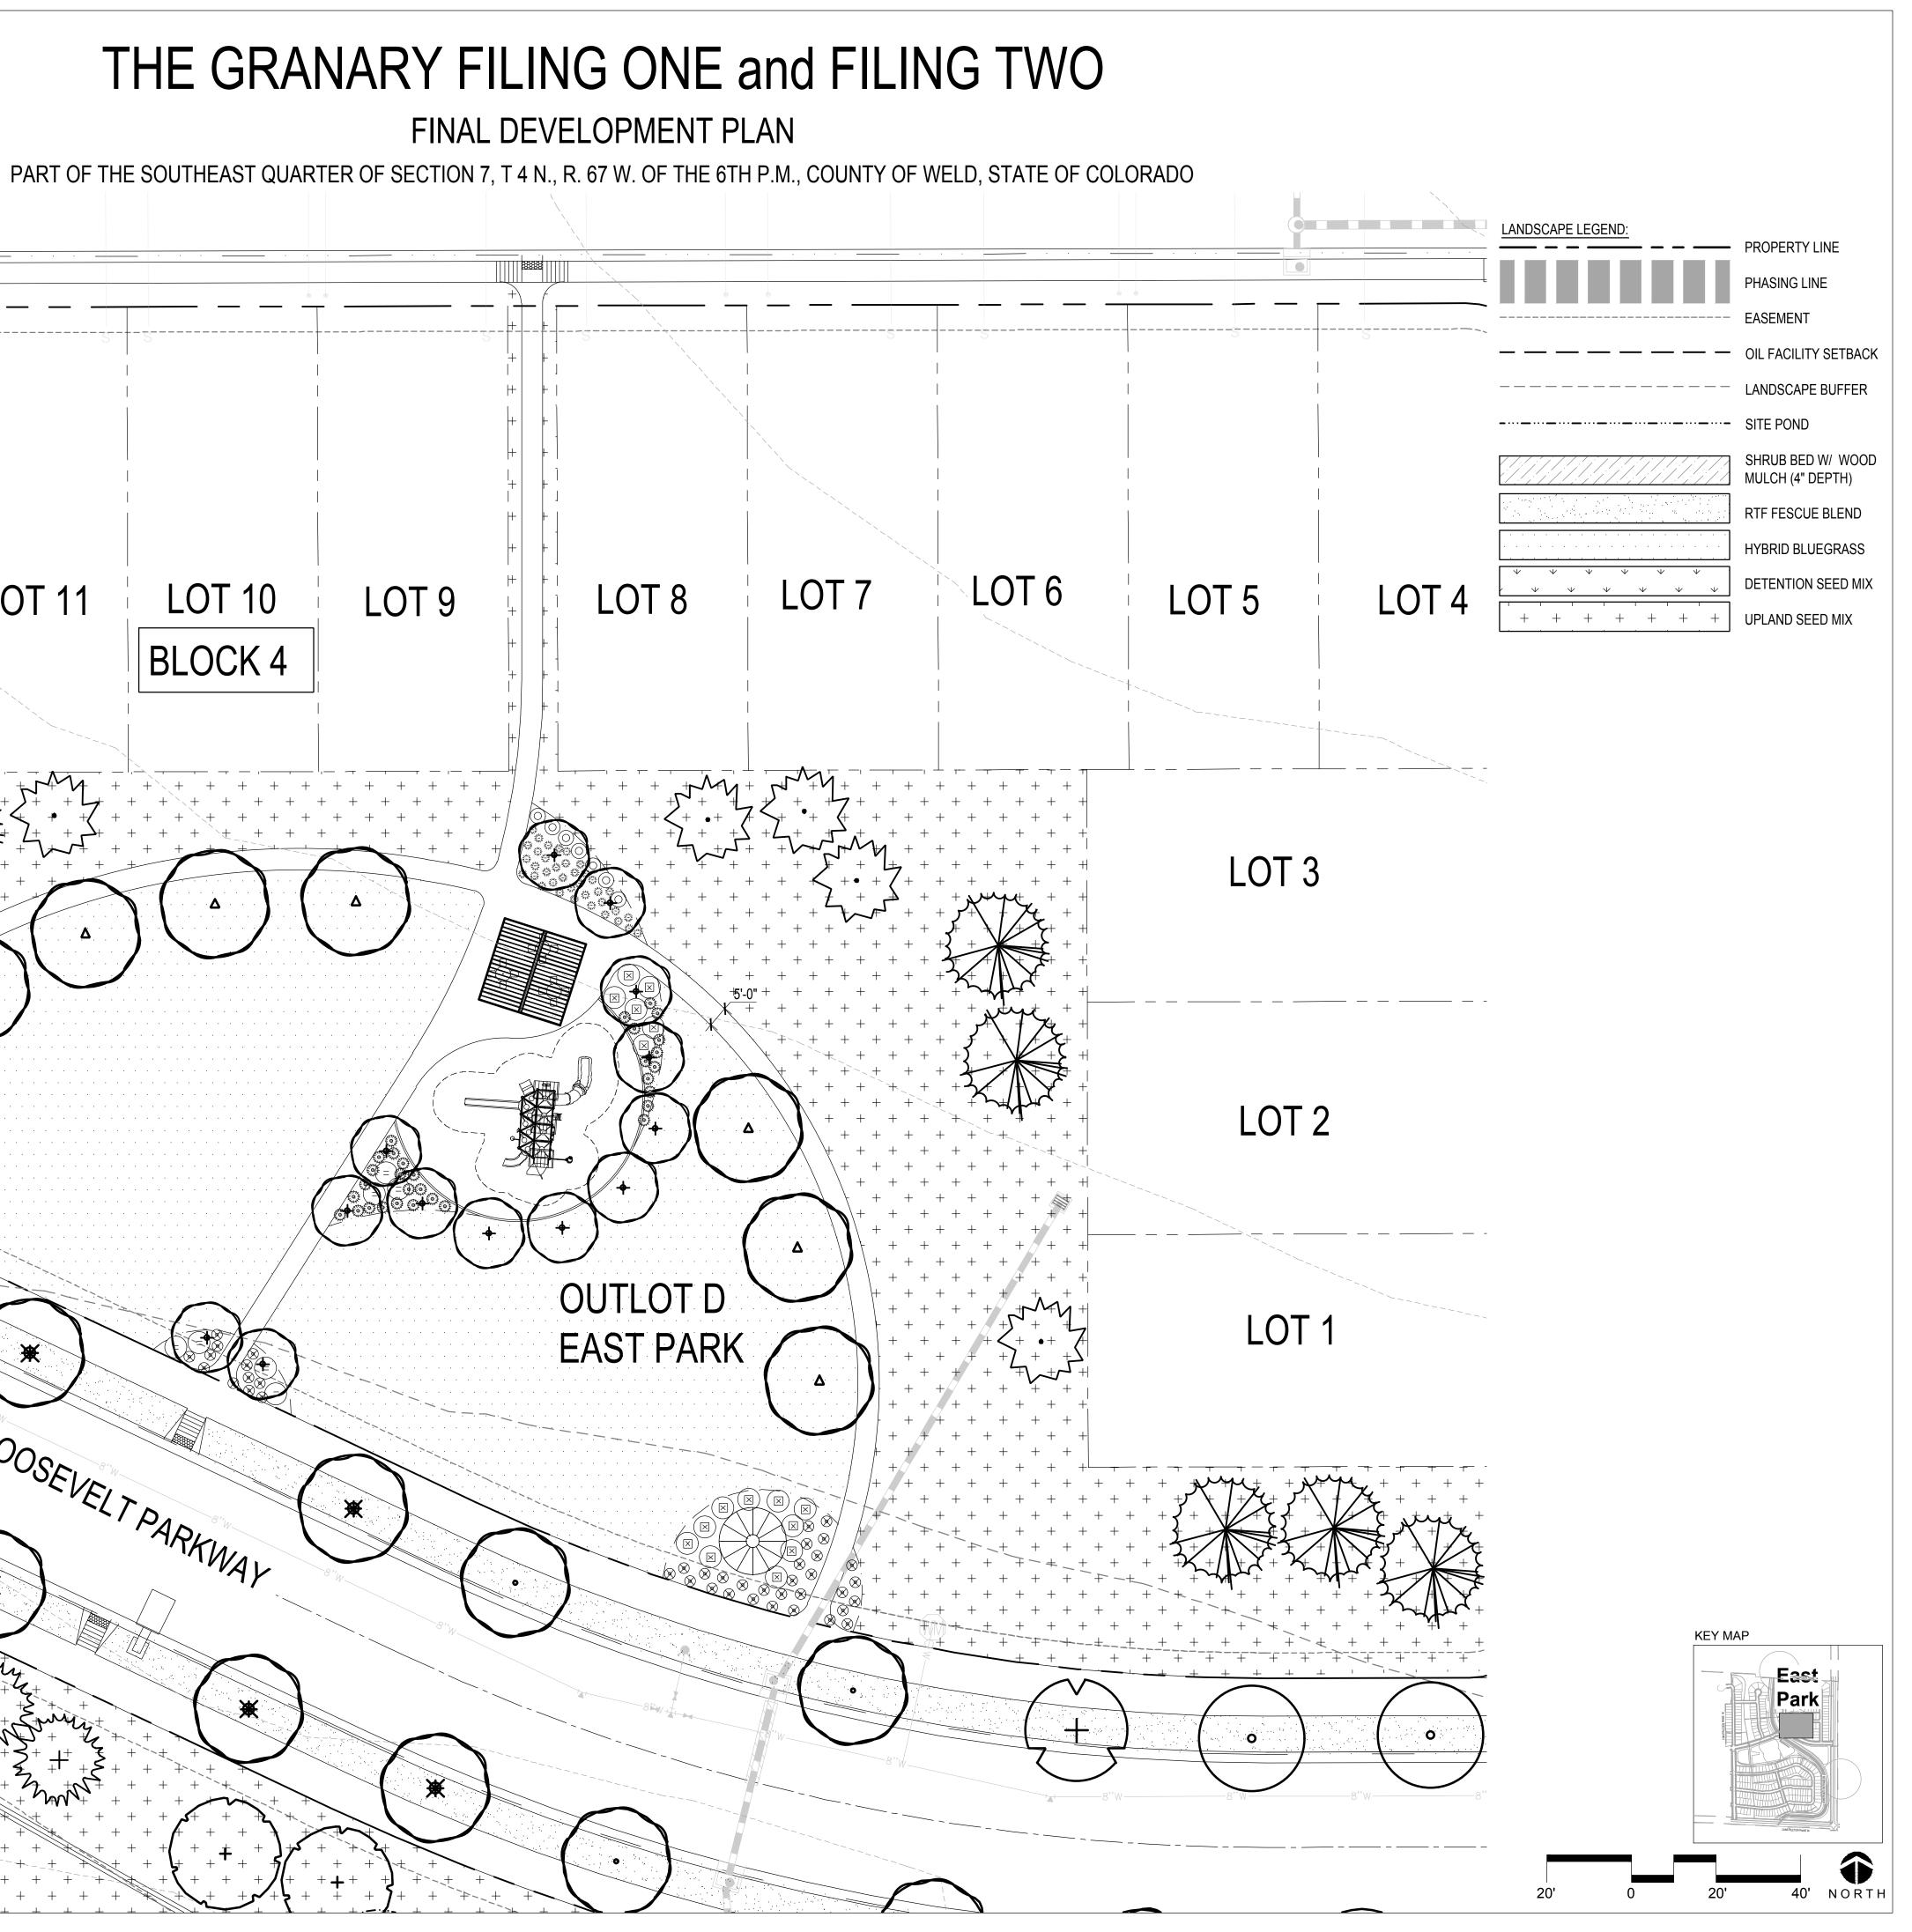
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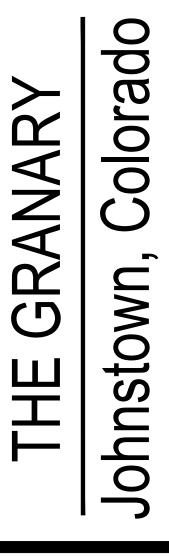
LANDSCAPE PLAN

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# LOT 10 LOT 12 LOT 11 LOT 13 LOT 14 BLOCK 4 ROOSEVELTPARKWAY 4 ₩







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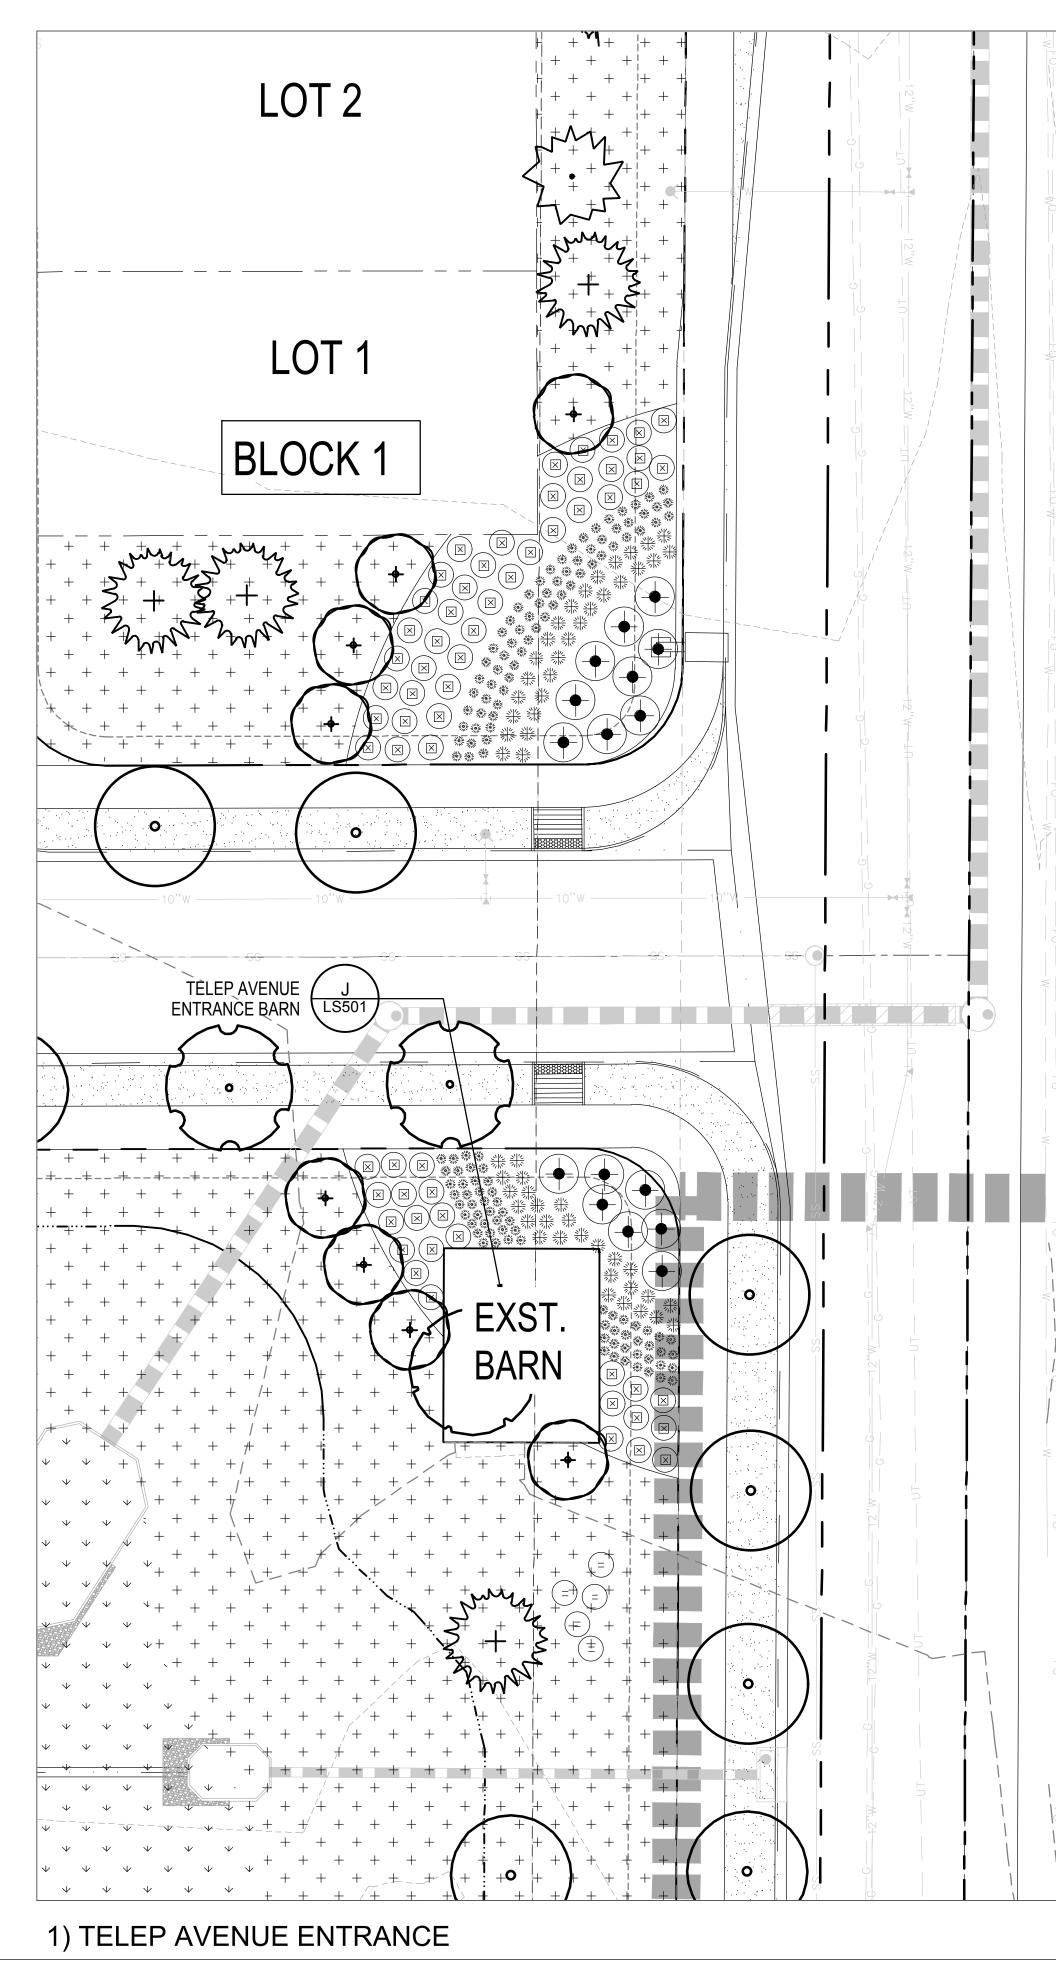
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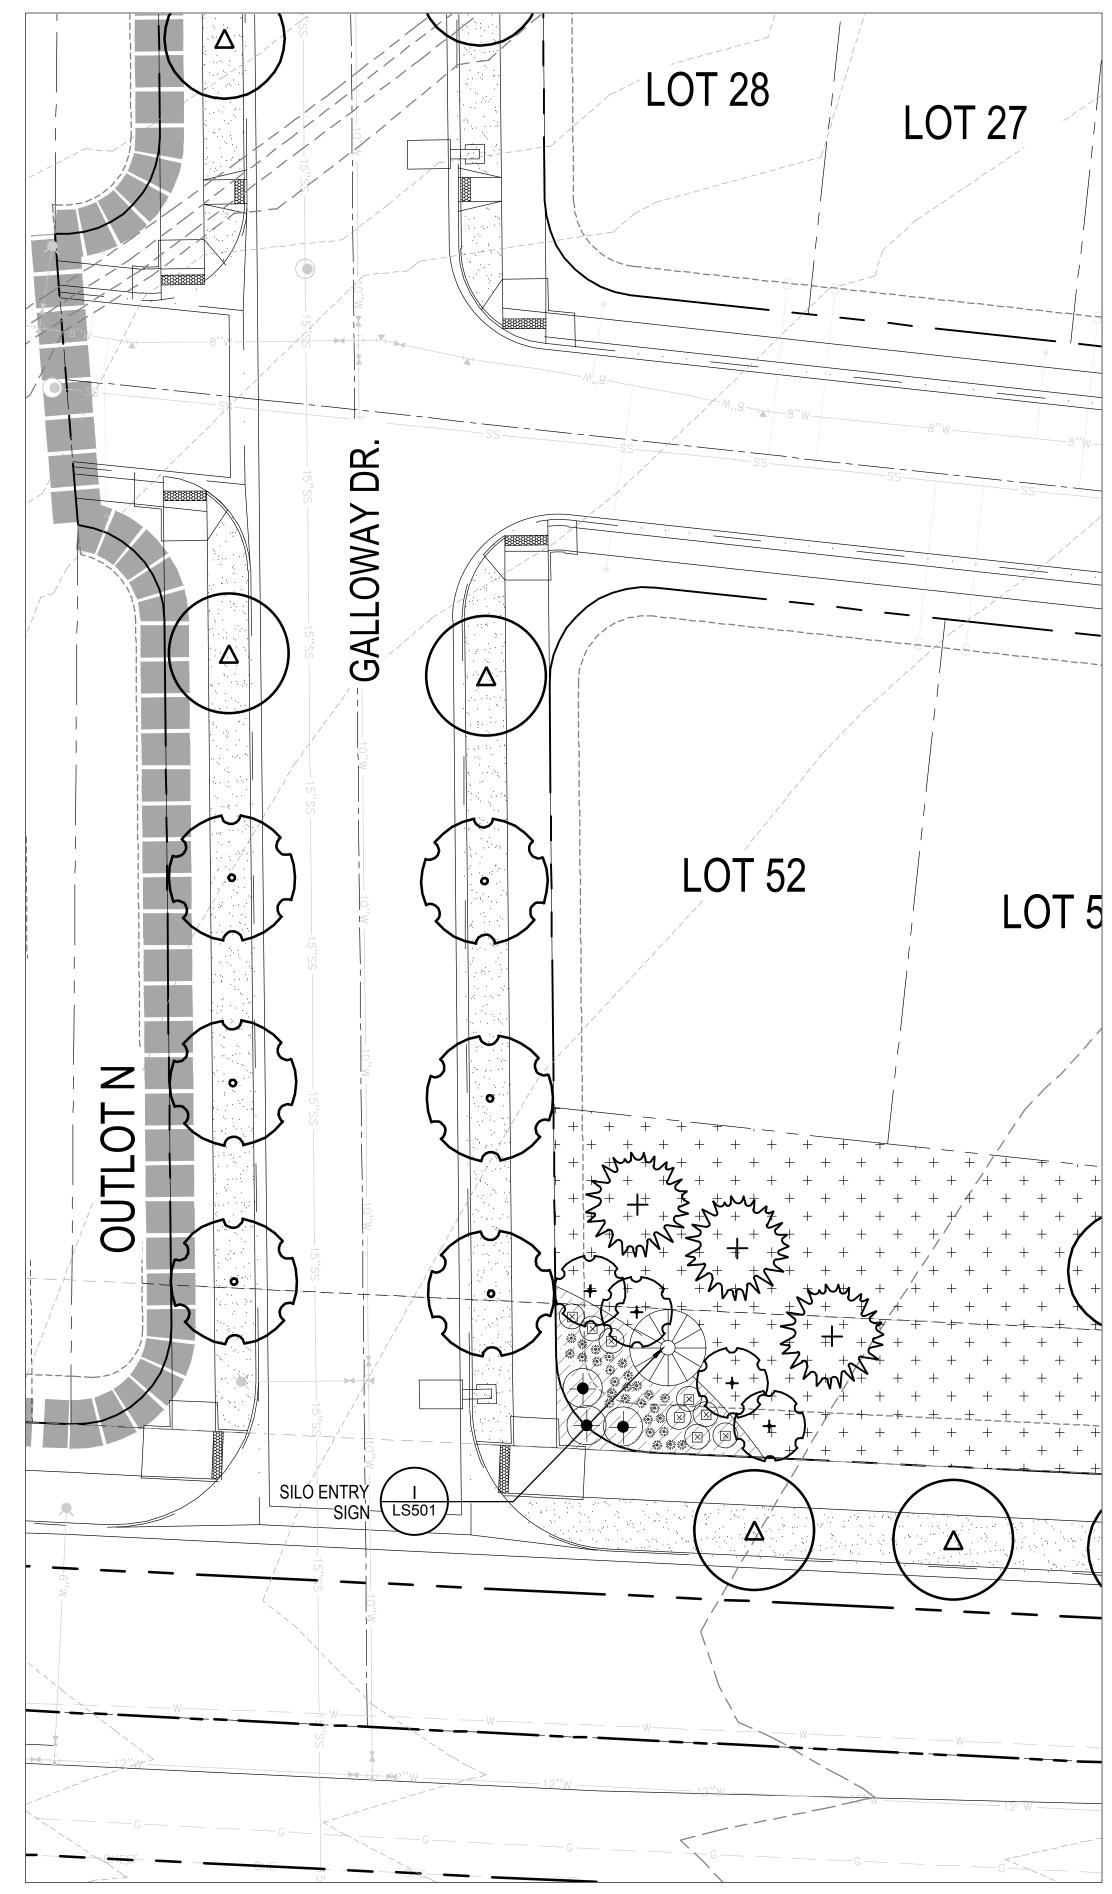
Sheet Name LANDSCAPE ENLARGEMENT -EAST PARK

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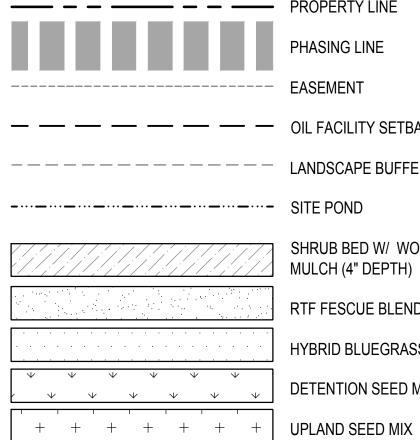
FINAL DEVELOPMENT PLAN

PART OF THE SOUTHEAST QUARTER OF SECTION 7, T 4 N., R. 67 W. OF THE 6TH P.M., COUNTY OF WELD, STATE OF COLORADO



2) EAST ROOSEVELT PARKWAY ENTRANCE

LANDSCAPE LEGEND:



PROPERTY LINE PHASING LINE EASEMENT FACILITY SETBACK ANDSCAPE BUFFER SITE POND SHRUB BED W/ WOOD MULCH (4" DEPTH) RTF FESCUE BLEND HYBRID BLUEGRASS DETENTION SEED MIX

KEY MAP  $\mathbf{\hat{1}}$ 40' NORTH 20

20'



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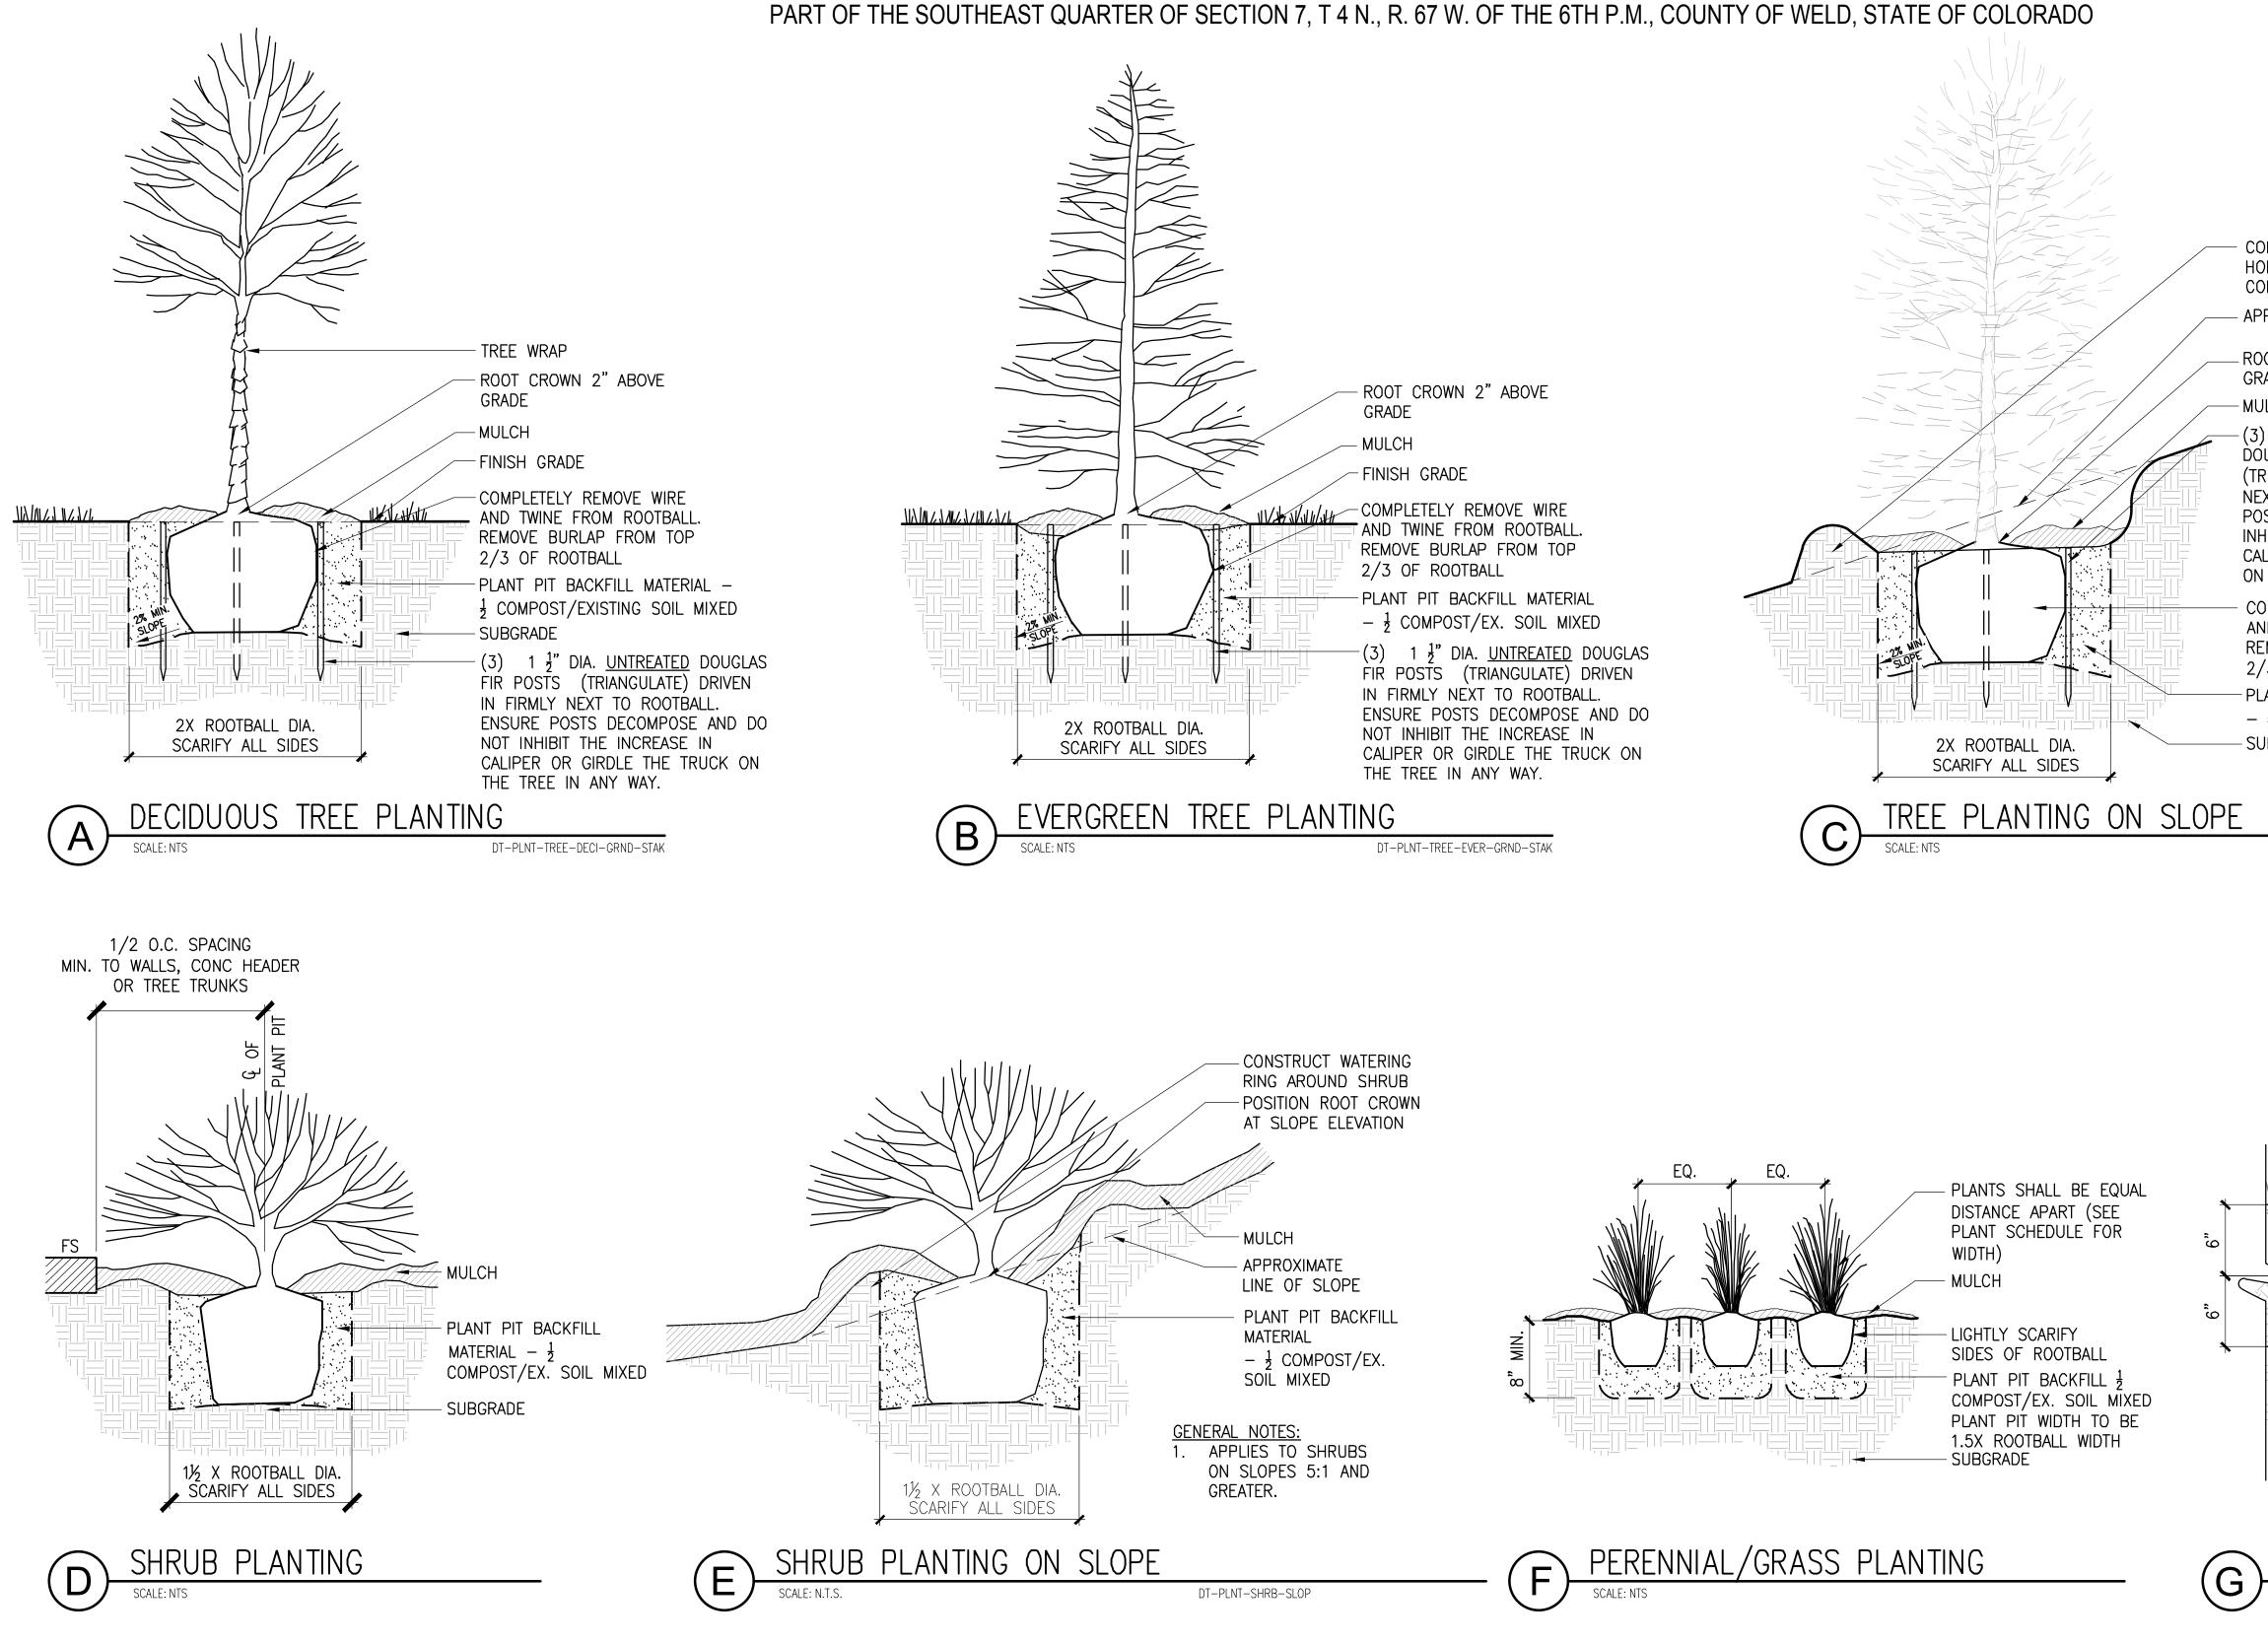
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Sheet Name LANDSCAPE ENLARGEMENT -ENTRANCES

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FINAL DEVELOPMENT PLAN



LANDSCAPE DETAILS

Sheet Name

Sheet

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REV.

SOD RE: LANDSCAPE PLAN

RE: LANDSCAPE NOTES

- NEW TOPSOIL

— TILLED SOIL

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COMMENT

DATE



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CONSTRUCT A 4" DEEP WATER

- APPROXIMATE LINE OF SLOPE

-(3) 1 ½" DIA. <u>UNTREATED</u> DOUGLAS FIR POSTS

NEXT TO ROOTBALL. ENSURE

INHIBIT THE INCREASE IN

ON THE TREE IN ANY WAY.

COMPLETELY REMOVE WIRE

AND TWINE FROM ROOTBALL

REMOVE BURLAP FROM TOP

- PLANT PIT BACKFILL MATERIAL

 $-\frac{1}{2}$  COMPOST/EX. SOIL MIXED

DT-PLNT-TREE-SLOP

SOD PLANTING SCALE: 1 1/2" = 1'-0"

2/3 OF ROOTBALL

SUBGRADE

(TRIANGULATE) DRIVEN IN FIRMLY

POSTS DECOMPOSE AND DO NOT

CALIPER OR GIRDLE THE TRUCK


HOLDING WELL FROM COMPACTED SOIL

-ROOT CROWN 2" ABOVE

GRADE

MULCH

PART OF THE SOUTHEAST QUARTER OF SECTION 7, T 4 N., R. 67 W. OF THE 6TH P.M., COUNTY OF WELD, STATE OF COLORADO

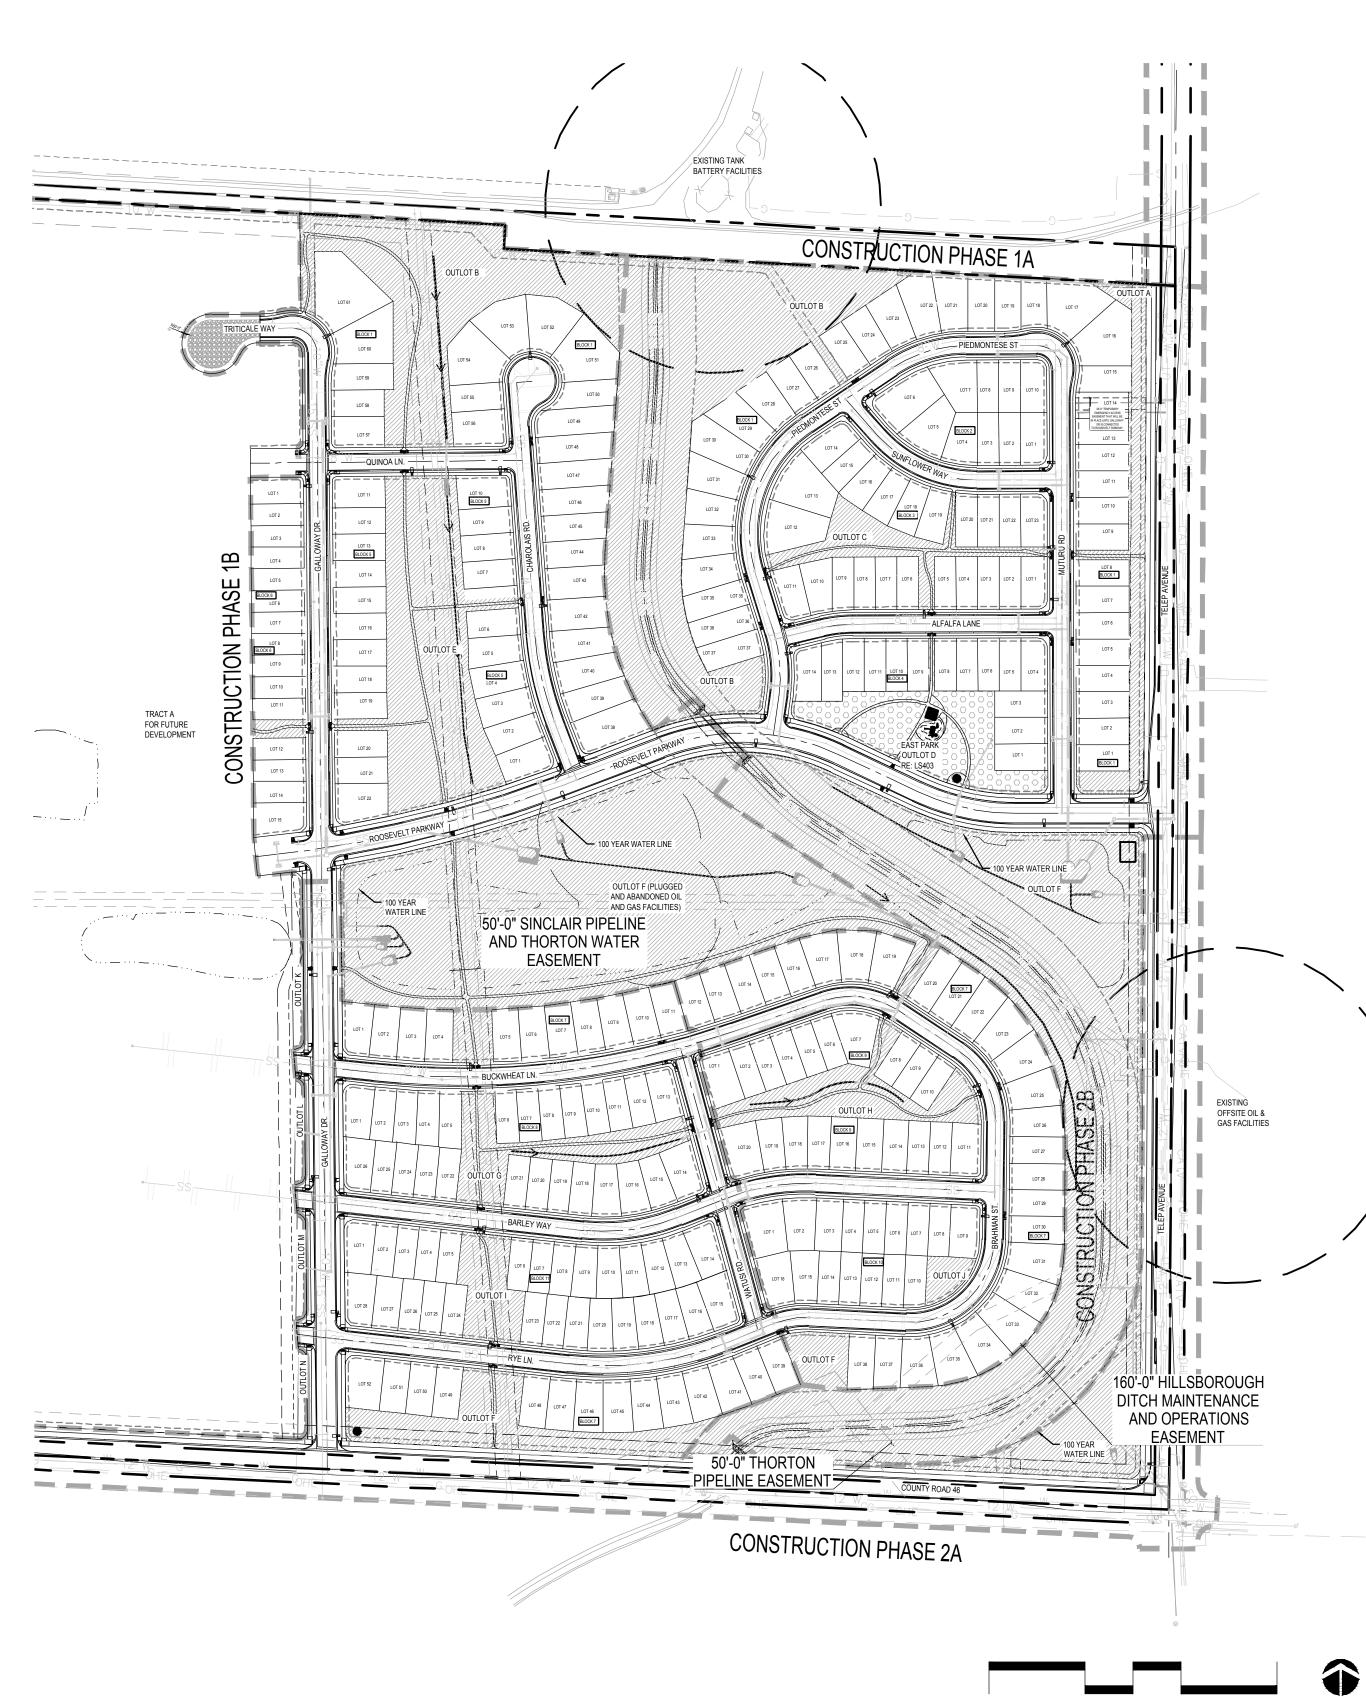

400' NORTH


200'

# THE GRANARY FILING ONE and FILING TWO

### FINAL DEVELOPMENT PLAN


### OPEN SPACE CHART

LAND USE SUMMARY						
THE GRANARY FILING ONE						
OUTLOTS	AREA (SF)	AREA (ACRES)	OWNERSHIP	MAINTENANCE	USE	% OF TOTA
Α	44,518	1.022	METRO DISTRICT	Metro district	PEDESTRIAN ACCESS EASEMENT AND OPEN SPACE	
В	379,604	8.715	METRO DISTRICT	METRO DISTRICT	PEDESTRIAN ACCESS, UTILITY AND DRAINAGE EASEMENT, OPEN SPACE, HILLSBOROUGH DITCH	
С	31,627	0.726	METRO DISTRICT	METRO DISTRICT	PEDESTRIAN ACCESS AND OPEN SPACE	
D	63,451	1.457	METRO DISTRICT	Metro district	PEDESTRIAN ACCESS, UTILITY EASEMENT, PARK SPACE	
E	130,503	2.996	METRO DISTRICT	Metro district	PEDESTRIAN ACCESS, UTILITY AND DETENTION AND DRAINAGE EASEMENT, OPEN SPACE	
F	989,834	22.723	METRO DISTRICT	Metro district	PEDESTRIAN ACCESS AND DRAINAGE EASEMENT AND OPEN SPACE, HILLSBOROUGH DITCH	
G	40,210	0.923	METRO DISTRICT	Metro district	PEDESTRIAN ACCESS AND DRAINAGE EASEMENT AND OPEN SPACE	
Н	43,603	1.001	METRO DISTRICT	Metro district	PEDESTRIAN ACCESS AND DRAINAGE EASEMENT AND OPEN SPACE	
Ι	24,707	0.567	METRO DISTRICT	Metro district	PEDESTRIAN ACCESS EASEMENT AND OPEN SPACE	
J	7,424	0.170	METRO DISTRICT	Metro district	PEDESTRIAN ACCESS EASEMENT AND OPEN SPACE	
К	8,068	0.185	METRO DISTRICT	Metro district	PEDESTRIAN ACCESS AND OPEN SPACE	
L	4,254	0.098	METRO DISTRICT	Metro district	PEDESTRIAN ACCESS AND OPEN SPACE	
М	4,231	0.097	METRO DISTRICT	METRO DISTRICT	PEDESTRIAN ACCESS AND OPEN SPACE	
Ν	3,484	0.080	METRO DISTRICT	Metro district	PEDESTRIAN ACCESS AND OPEN SPACE	
OUTLOTS	1,775,519	40.760				36.87%
TOTAL AREA		110.542	TRACT A (45.148 AC) IS NOT INCLUDED FOR OPEN SPACE CALCULATION AS THE AREA IS DESIGNATED FOR FUTURE DEVELOPMENT			

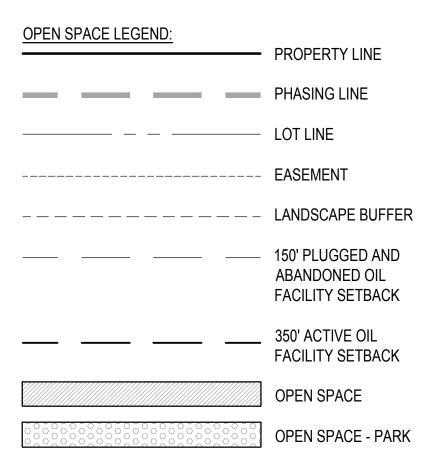

### OIL AND GAS FACILITIES INFORMATION

OUTLOT E OWNER: PDC ENERGY INC - 69175 NUMBER OF WELLS: 5 NAMES OF WELLS: 7-33 KETO, 7-43 KETO, 7-34 KETO, 7-44 KETO, 3-7J KETO TYPE OF WELL: DIRECTIONAL, PLUGGED AND ABANDONED OTHER FACILITIES ON SITE: NONE, ALL LINES REMOVED STATUS: PLUGGED AND ABANDONED

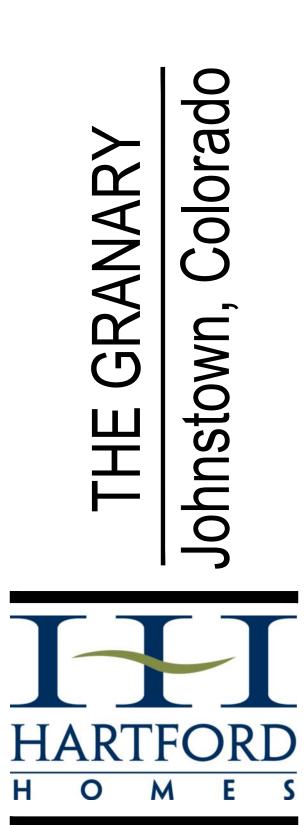



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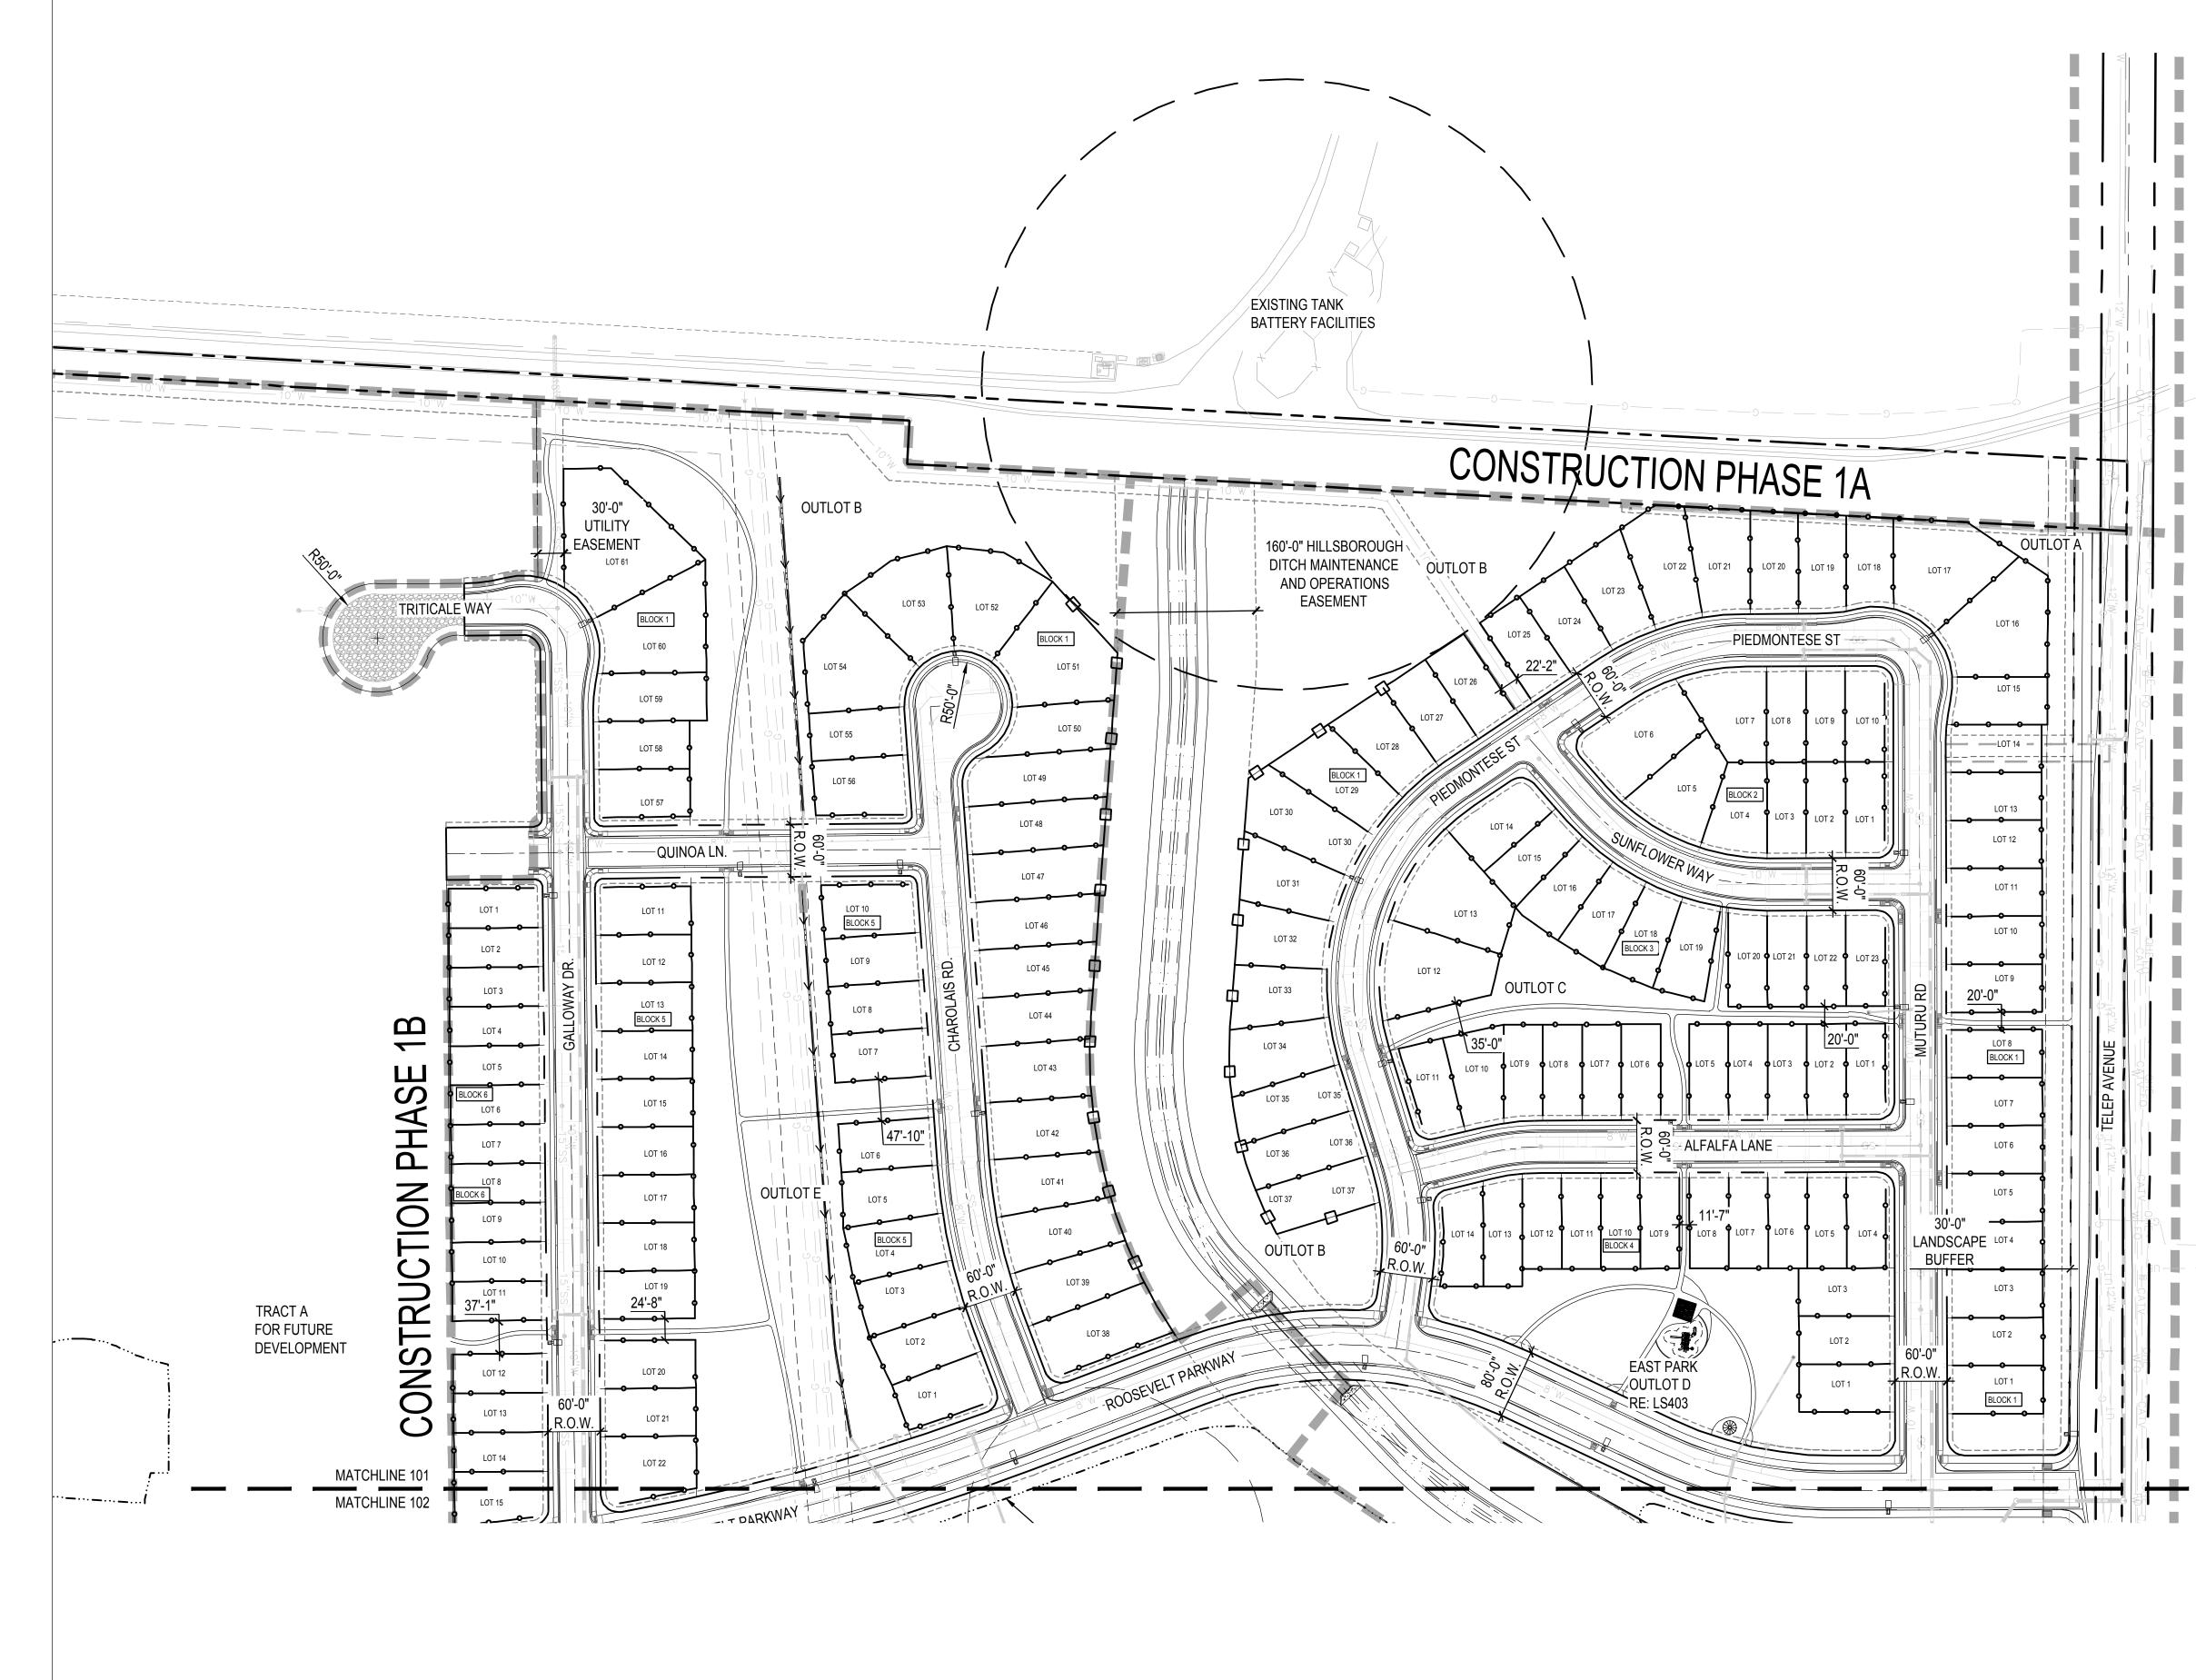
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OPEN SPACE PLAN

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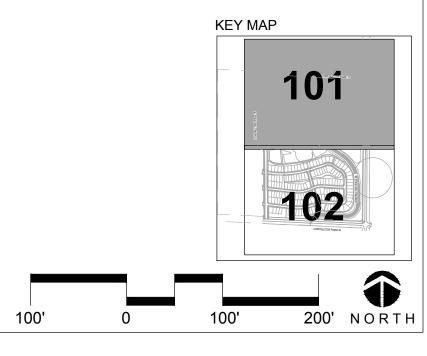
FINAL DEVELOPMENT PLAN


PART OF THE SOUTHEAST QUARTER OF SECTION 7, T 4 N., R. 67 W. OF THE 6TH P.M., COUNTY OF WELD, STATE OF COLORADO

FENCING LEGEND:	PROPERTY LINE
	PHASING LINE
	EASEMENT
	LANDSCAPE BUFFER
	150' PLUGGED AND ABANDONED OIL FACILIT SETBACK
	350' ACTIVE OIL FACILITY SETBACK
_ <del></del>	3 RAIL FENCE
<u> </u>	4 RAIL FENCE (6' HEIGHT

### FENCING NOTES:

- 3 RAIL FENCE SHALL BE PROVIDED AS PER DETAILS.
- ALL SIDE YARD FENCING SHALL TERMINATE A MINIMUM OF 5' BEHIND FRONT ELEVATION OF HOUSE.
- FENCE SHALL BE LOCATED ON PROPERTY LINES. 4. NO FENCING SHALL BE INSTALLED TO INTERFERE WITH SIGHT TRIANGLES.



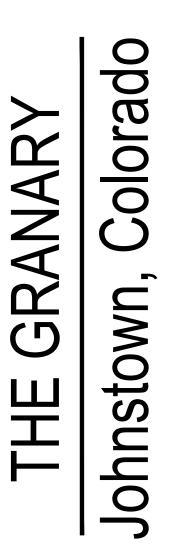



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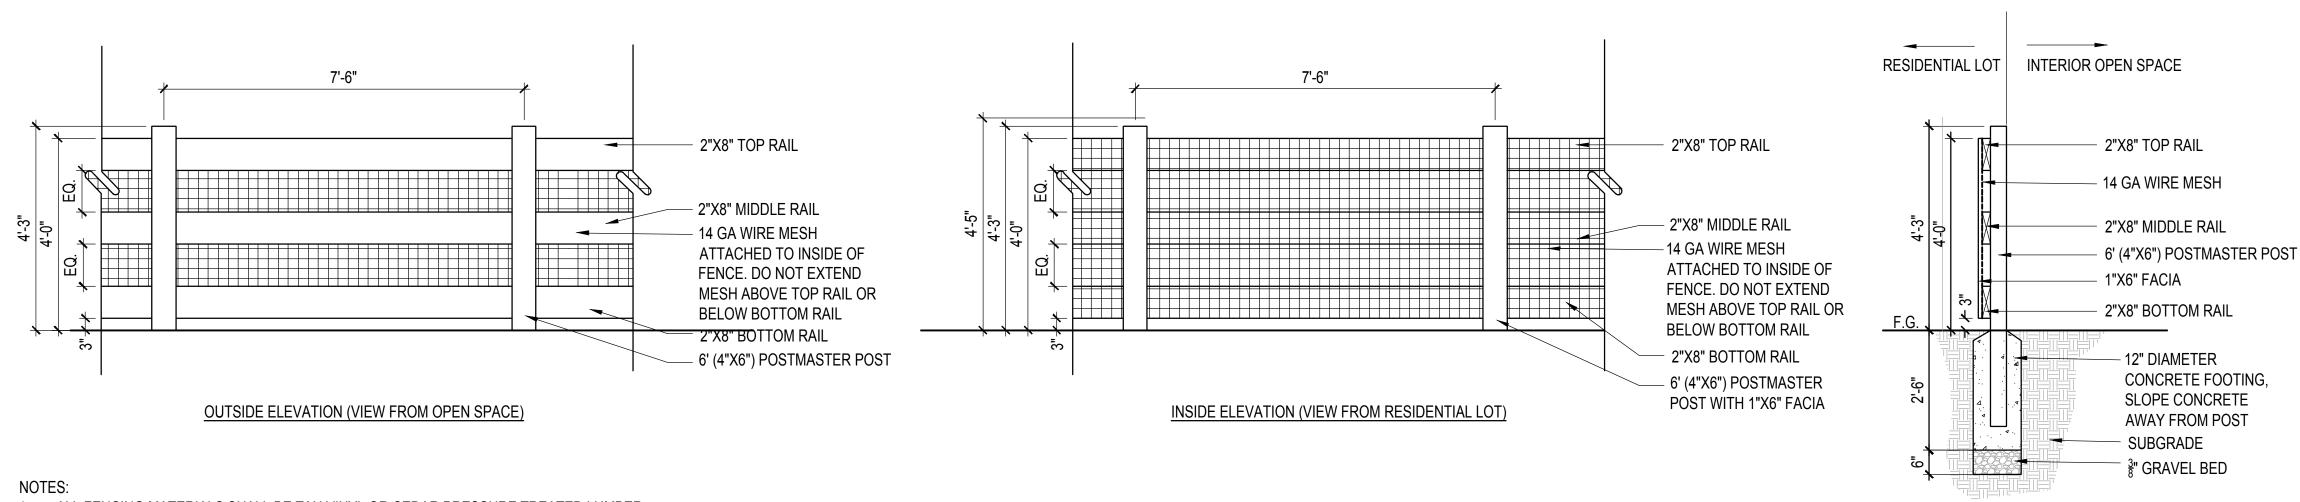
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FENCING PLAN

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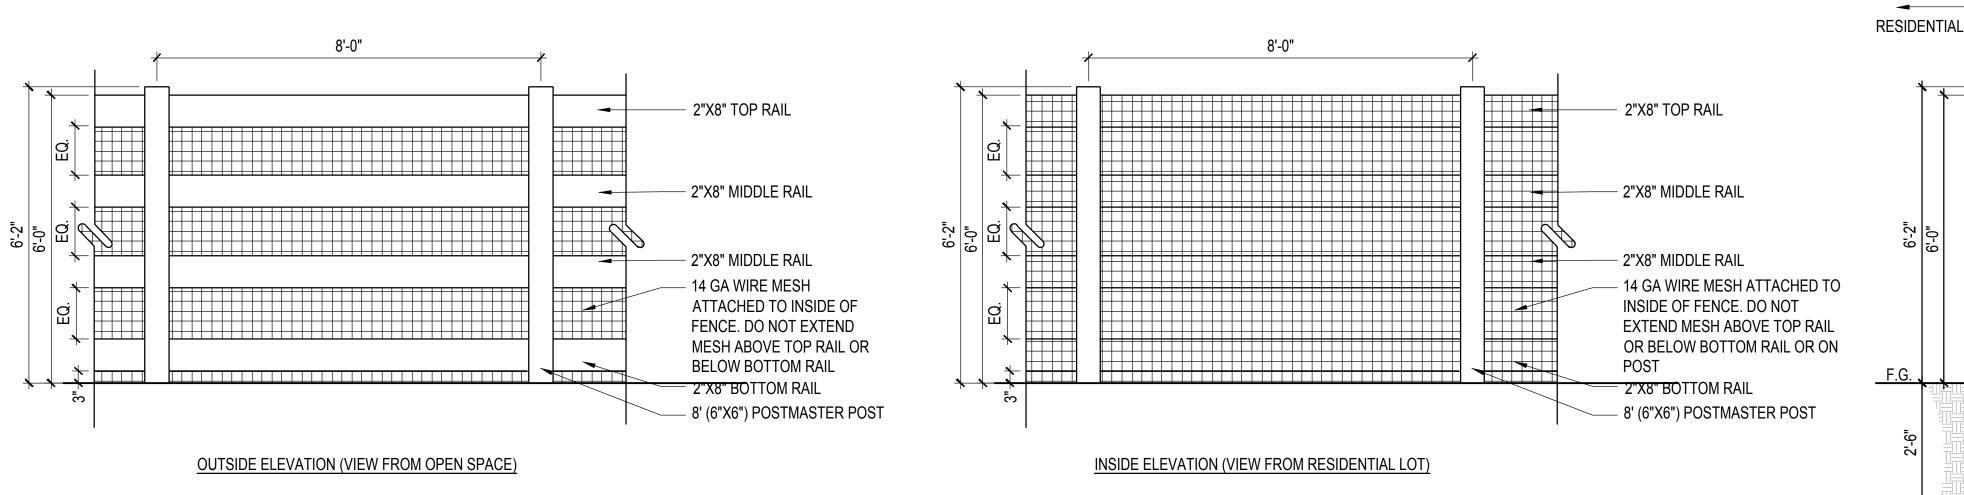
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- 1. ALL FENCING MATERIALS SHALL BE TAN VINYL OR CEDAR PRESSURE TREATED LUMBER
- #1 GRADE AS DETERMINED BY HOA.
- 2. DEVELOPER'S STRUCTURAL ENGINEER TO APPROVE ALL COLUMN FOOTINGS.





NOTES:

- 1. ALL FENCING MATERIALS SHALL BE TAN VINYL OR CEDAR PRESSURE TREATED LUMBER
  - #1 GRADE AS DETERMINED BY HOA.
- 2. DEVELOPER'S STRUCTURAL ENGINEER TO APPROVE ALL COLUMN FOOTINGS.



### FINAL DEVELOPMENT PLAN

PART OF THE SOUTHEAST QUARTER OF SECTION 7, T 4 N., R. 67 W. OF THE 6TH P.M., COUNTY OF WELD, STATE OF COLORADO



	DT-FENC-FILING ONE
	►
NTIAL LOT	INTERIOR OPEN SPACE
*	
	2"X8" TOP RAIL
	2"X8" MIDDLE RAIL
	14 GA WIRE MESH
	2"X8" MIDDLE RAIL
-     -	8' (6"X6") POSTMASTER POST
	1"X6" FACIA
ͺ ⊮–	2"X8" BOTTOM RAIL
	12" DIAMETER
	CONCRETE FOOTING,
	SLOPE CONCRETE
	AWAY FROM POST
	3" GRAVEL BED
. 1—1   1—1	
FENCE SE	ECTION

DT-FENC-FILING ONE

olorado AR Ž 4 G R S Johnstown 出



### NOT FOR CONSTRUCTION

REV.		DATE
REV.	COMMENT	DATE

FDP FILING ONE and FILING TWO


Date: 02.07.2022 Drawn By: SL Checked By: CR


Sheet Name

Fencing Details

Sheet

**FP501** 

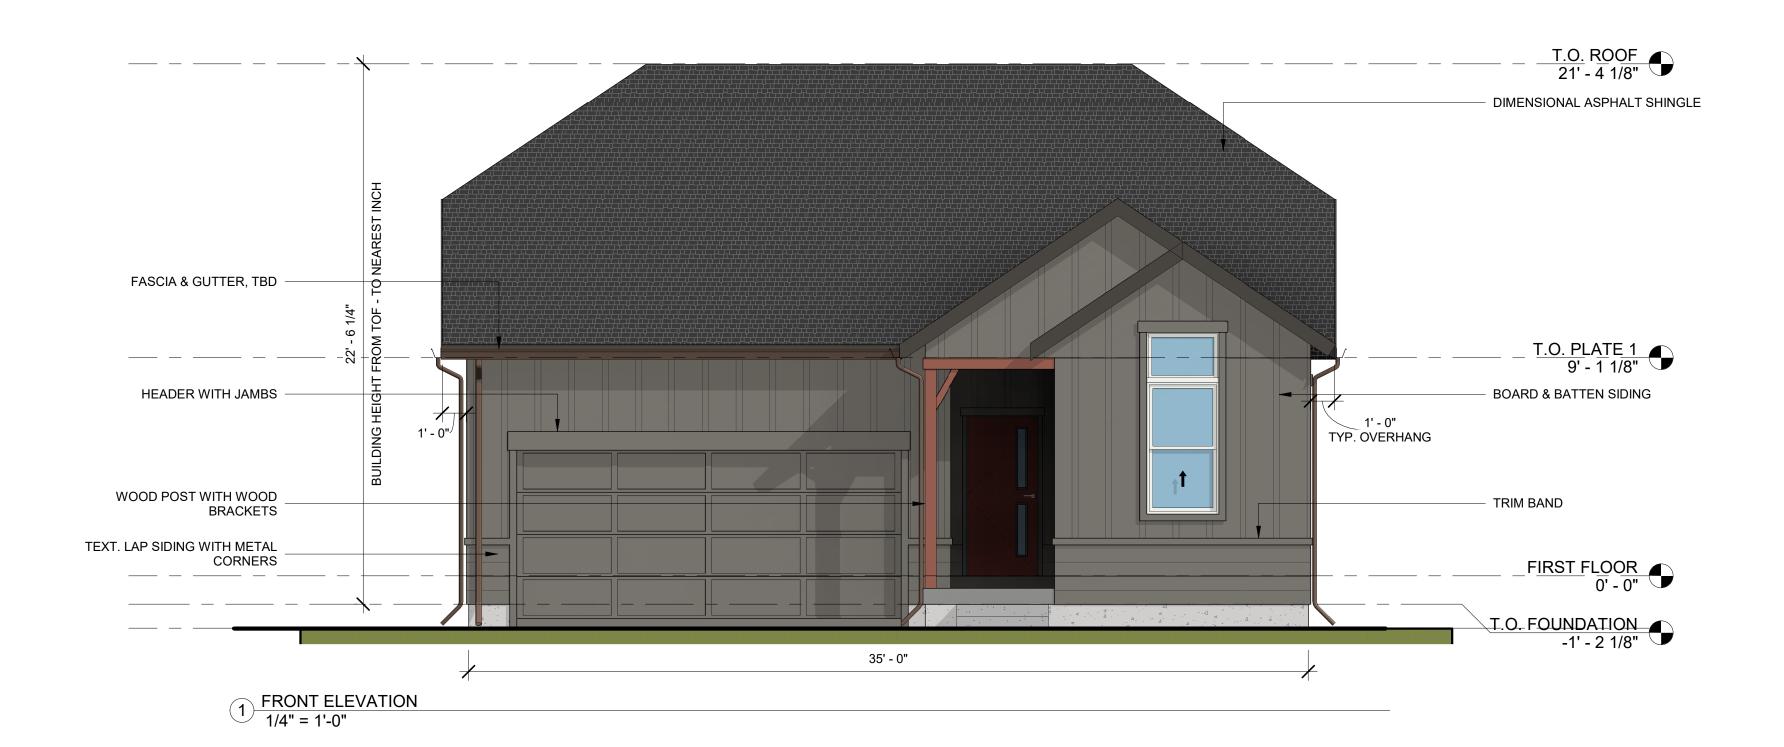

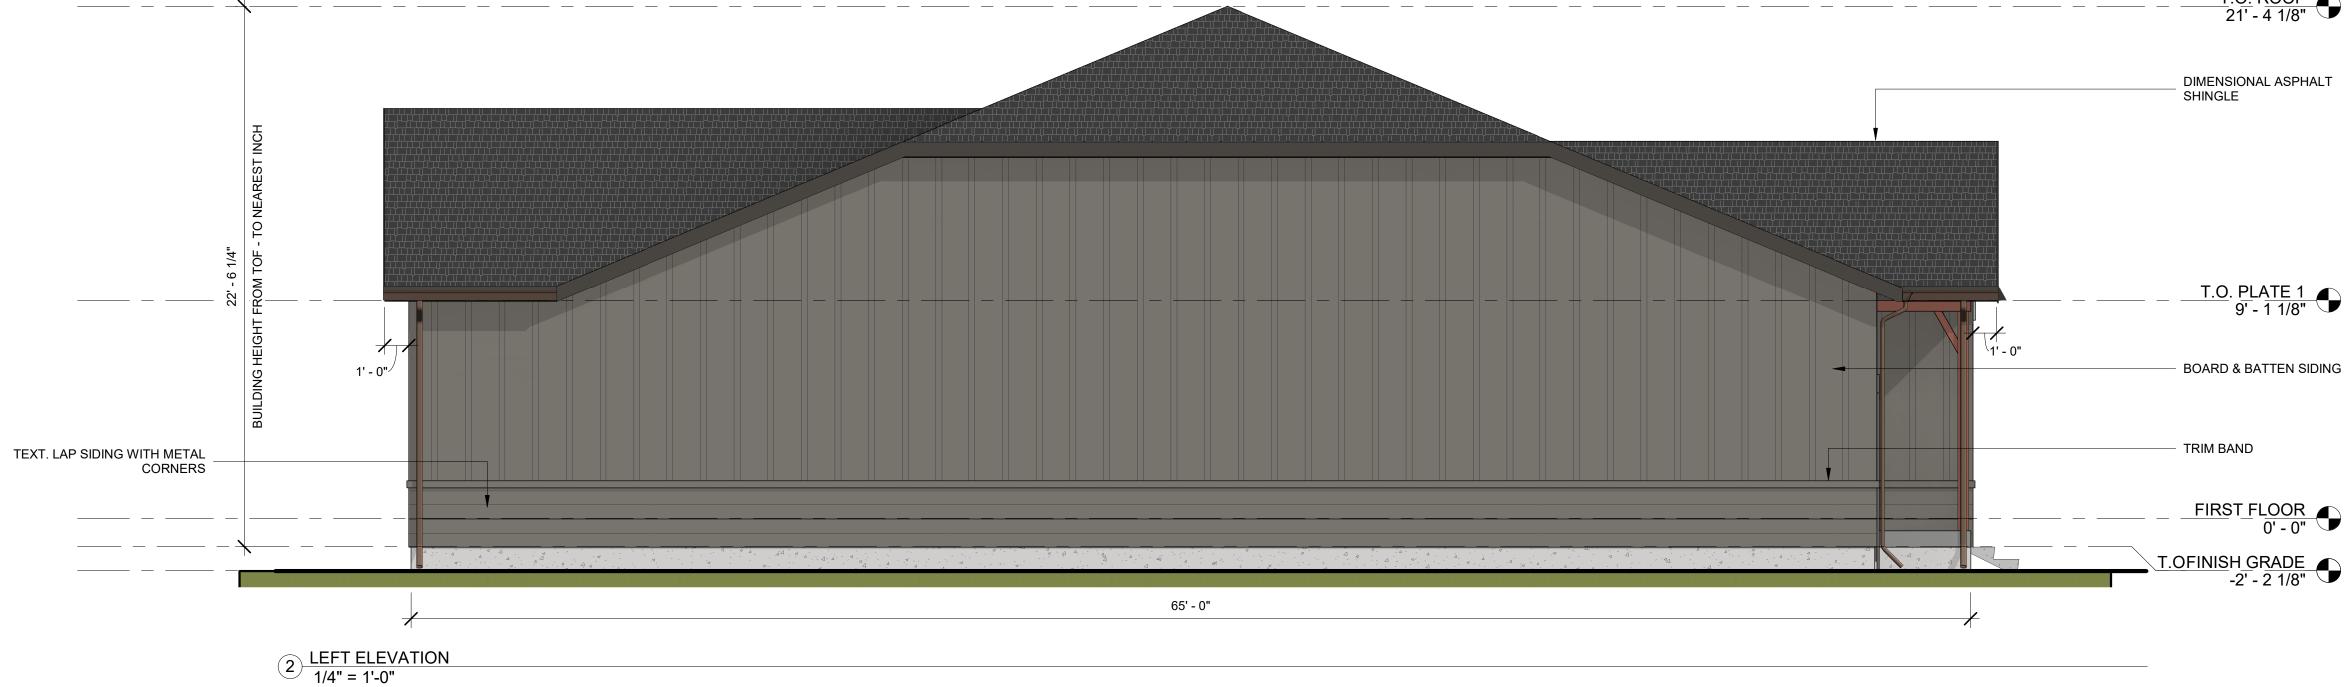



### NOTE: PRELIMINARY ARCHITECTURAL RENDERINGS -FINAL DESIGN SUBJECT TO CHANGE

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No. Description De		
No.	Description	Date

### **BUILDING ELEVATIONS -**CHRISTIE FARMHOUSE


Product Series: Date Drawn by Checked by

35 FT 10/01/2021 OS AM/DW





Scale

1/4" = 1'-0"

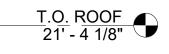



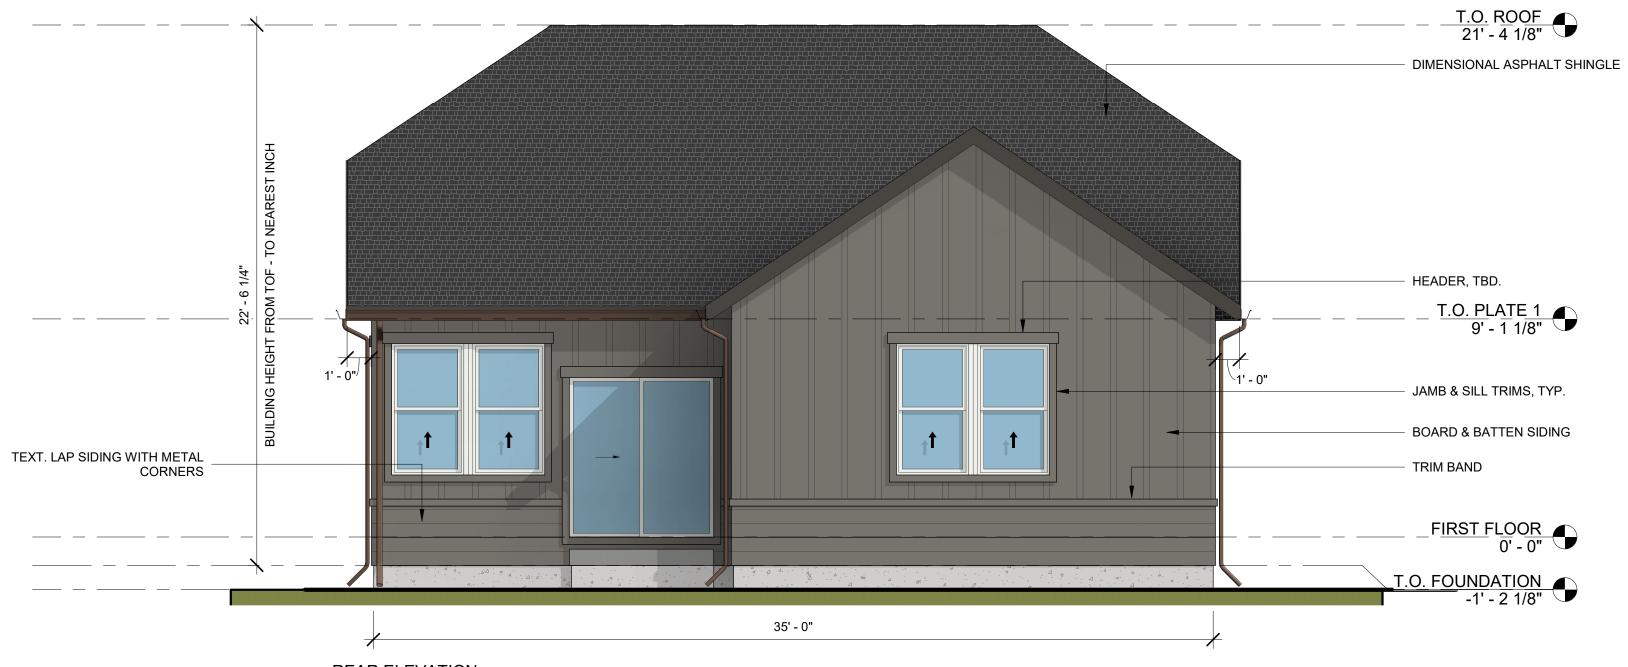

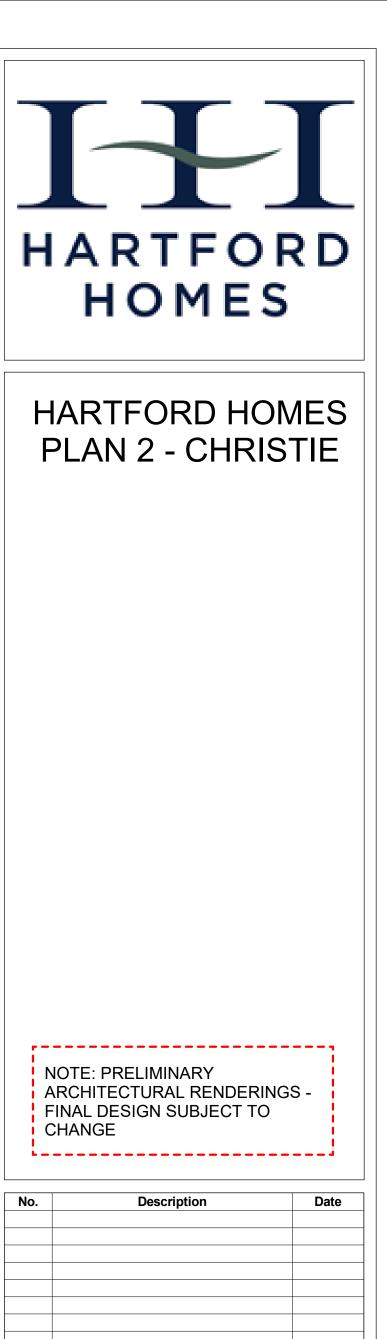



### CHRISTIE FARMHOUSE

roduct Series:	35 FT
ate	10/01/2021
rawn by	OS
hecked by	AM/DW




Scale


1/4" = 1'-0"




DIMENSIONAL ASPHALT SHINGLE



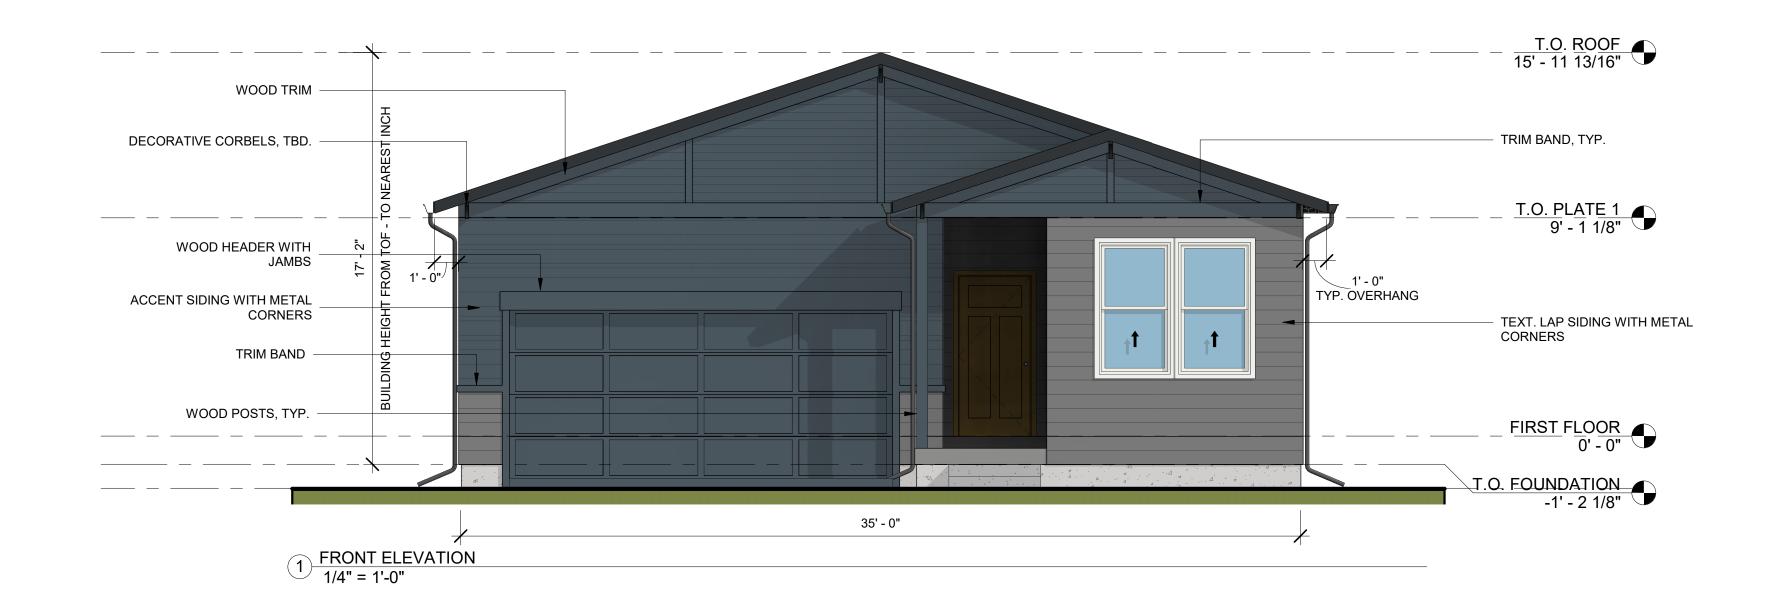

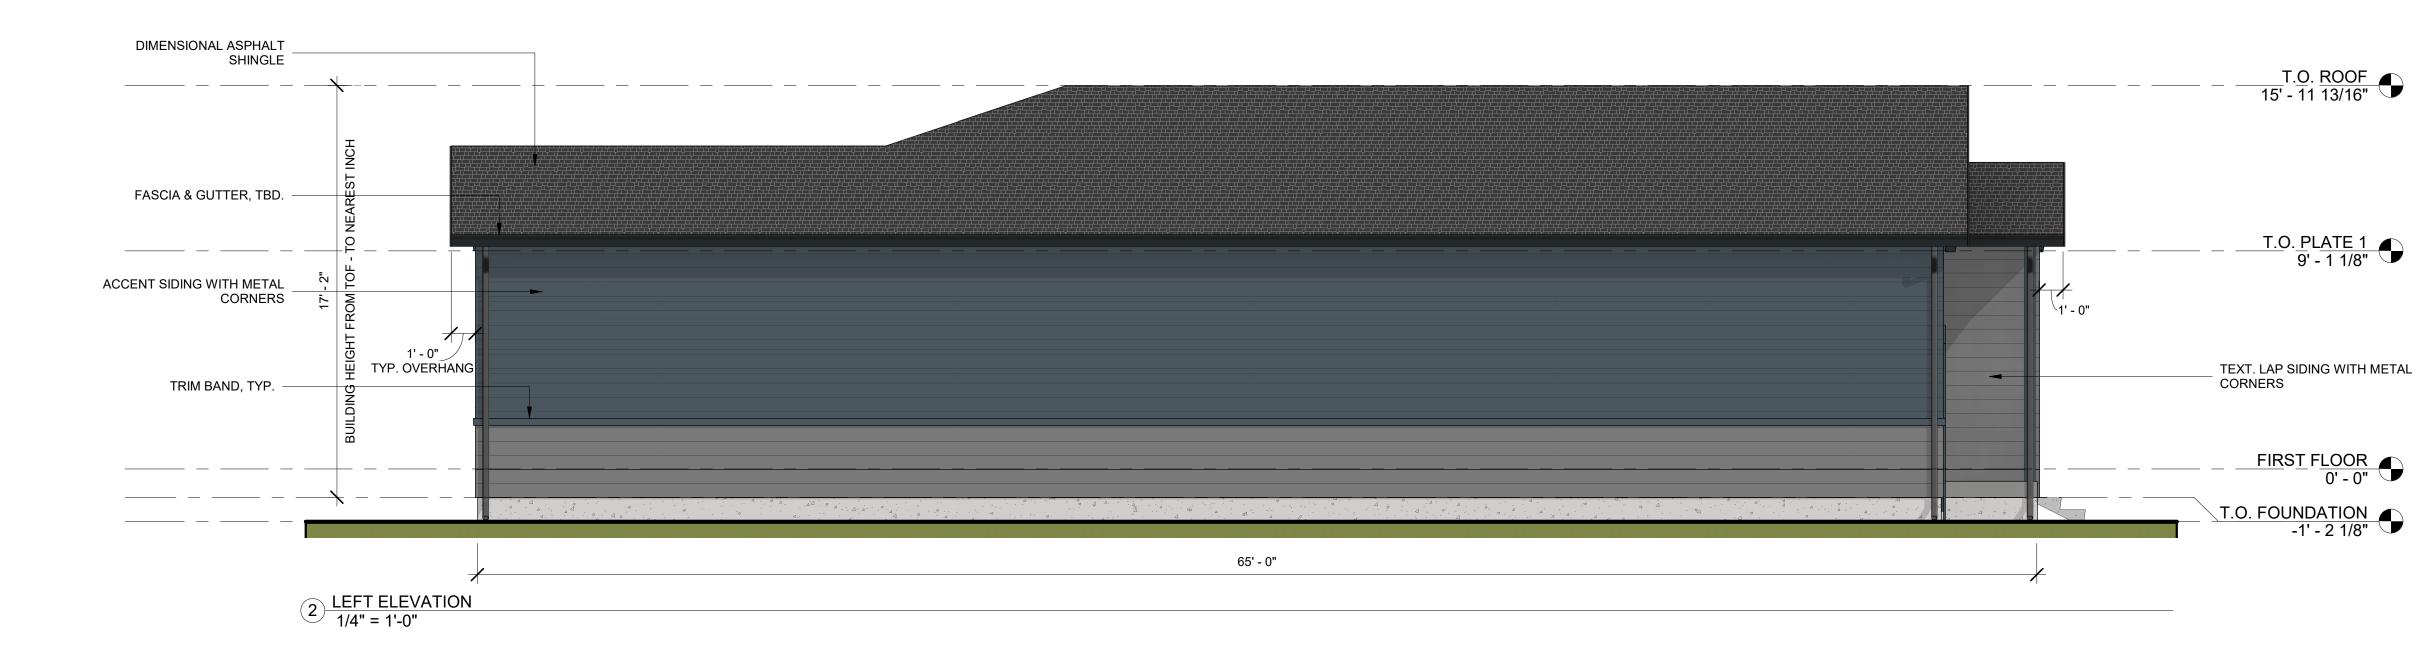

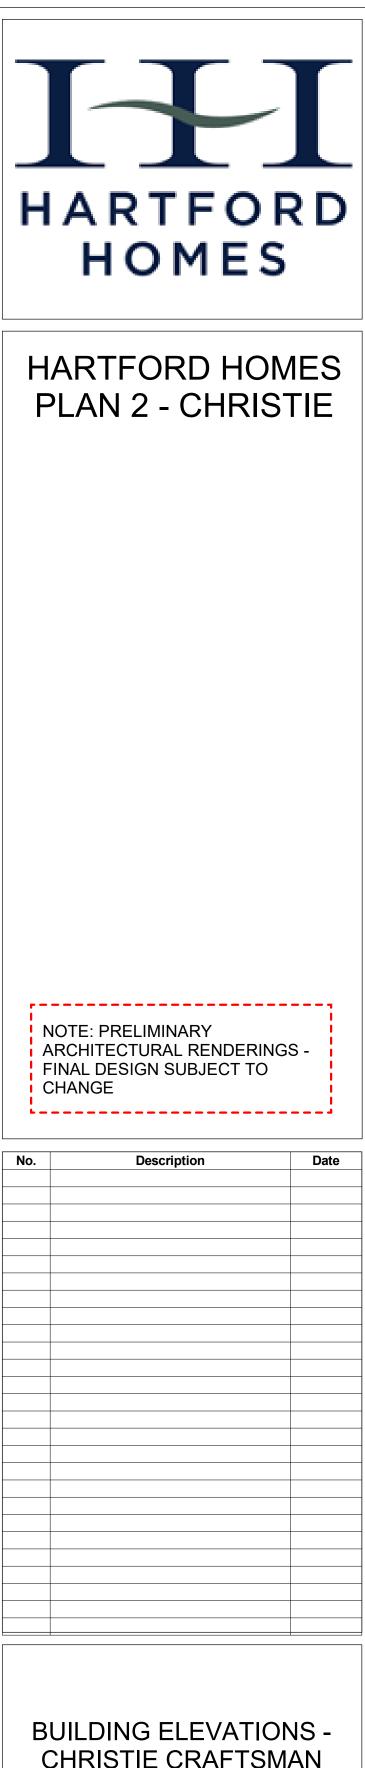


## CHRISTIE CRAFTSMAN


35 FT Product Series: 10/06/2021 Date OS Drawn by AM/DW Checked by




Scale

1/4" = 1'-0"

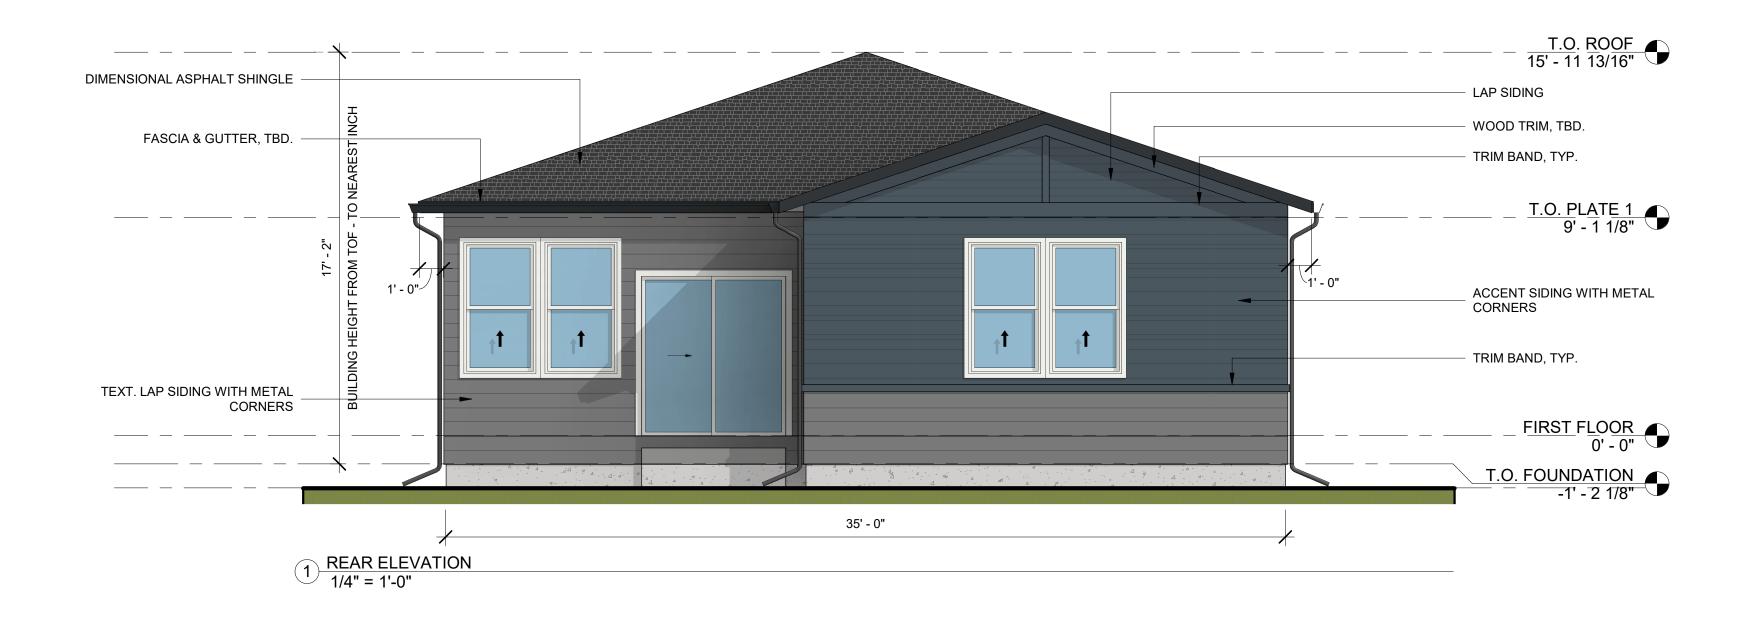

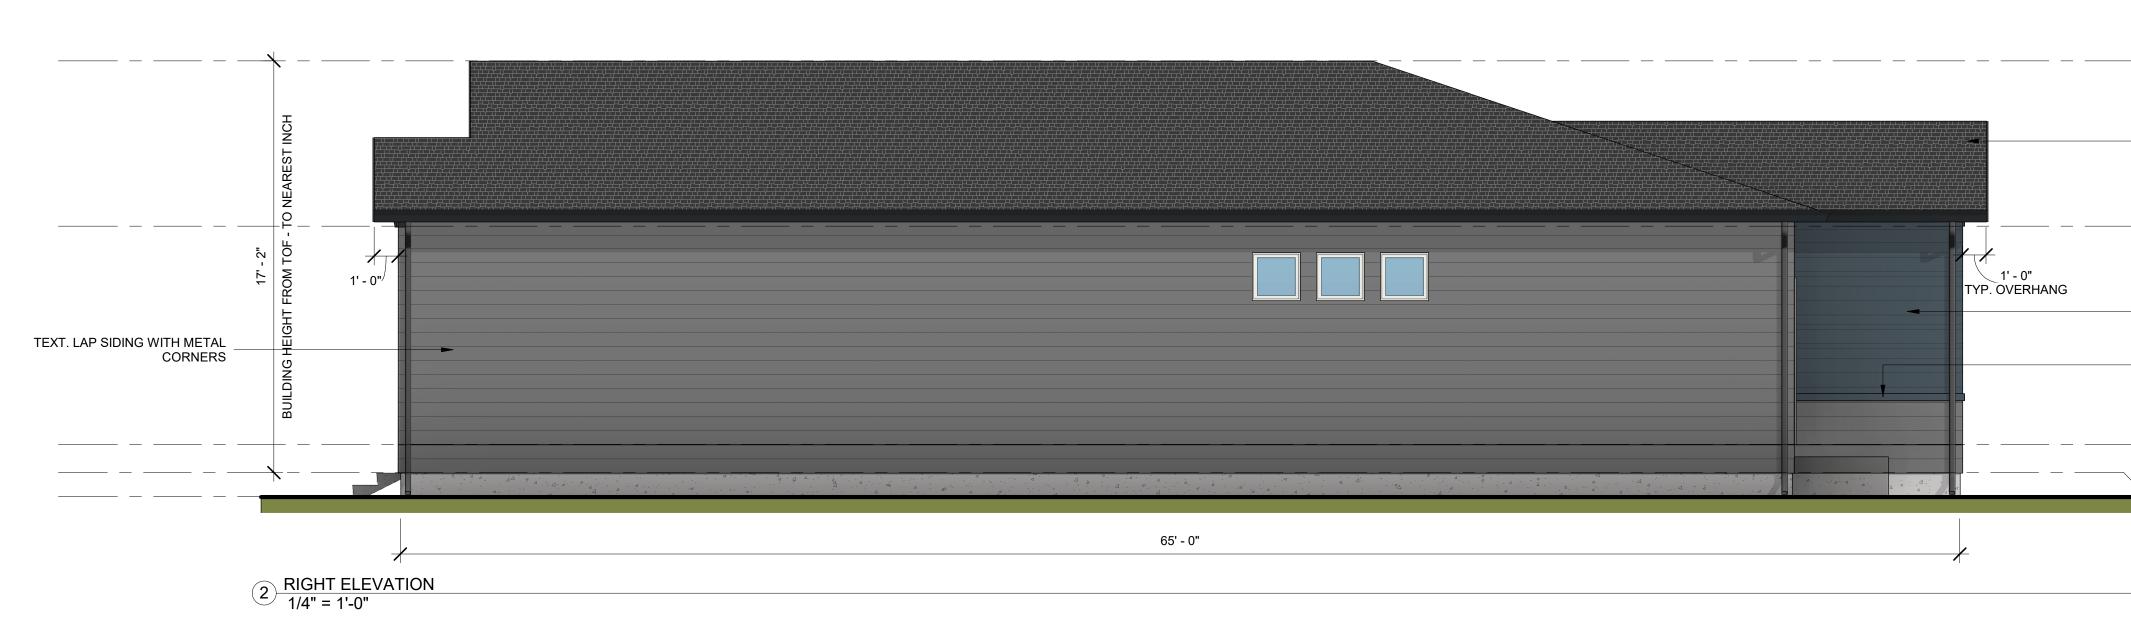

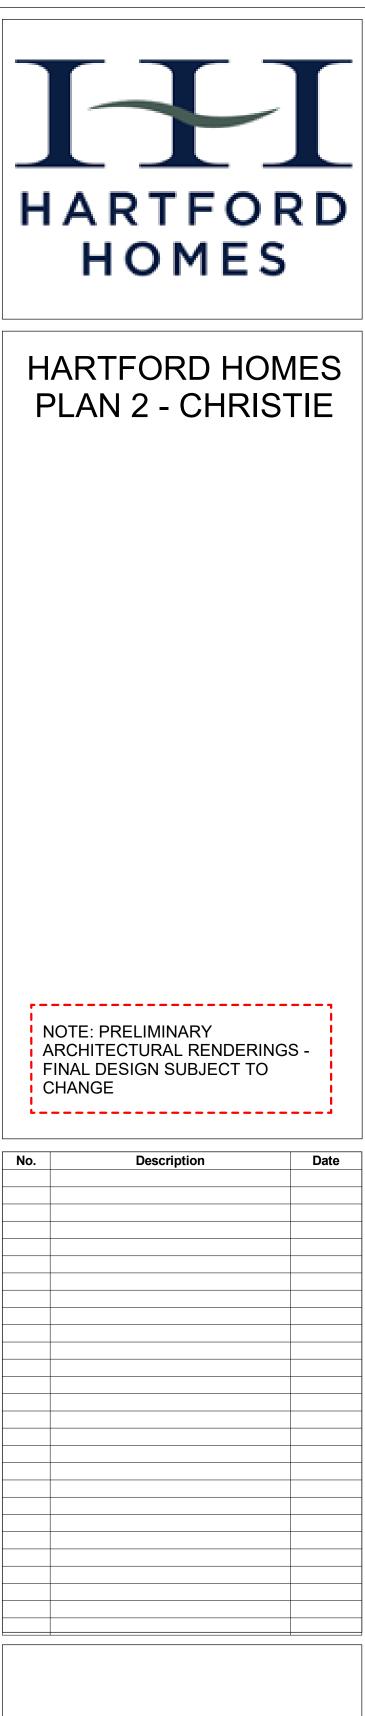

### BUILDING ELEVATIONS -CHRISTIE CRAFTSMAN


Product Series: Date 10/0 Drawn by Checked by

35 FT 10/06/2021 OS AM/DW



Scale

1/4" = 1'-0"

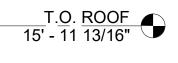



DIMENSIONAL ASPHALT SHINGLE





ACCENT SIDING WITH METAL CORNERS

TRIM BAND, TYP.

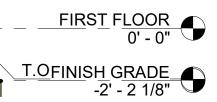


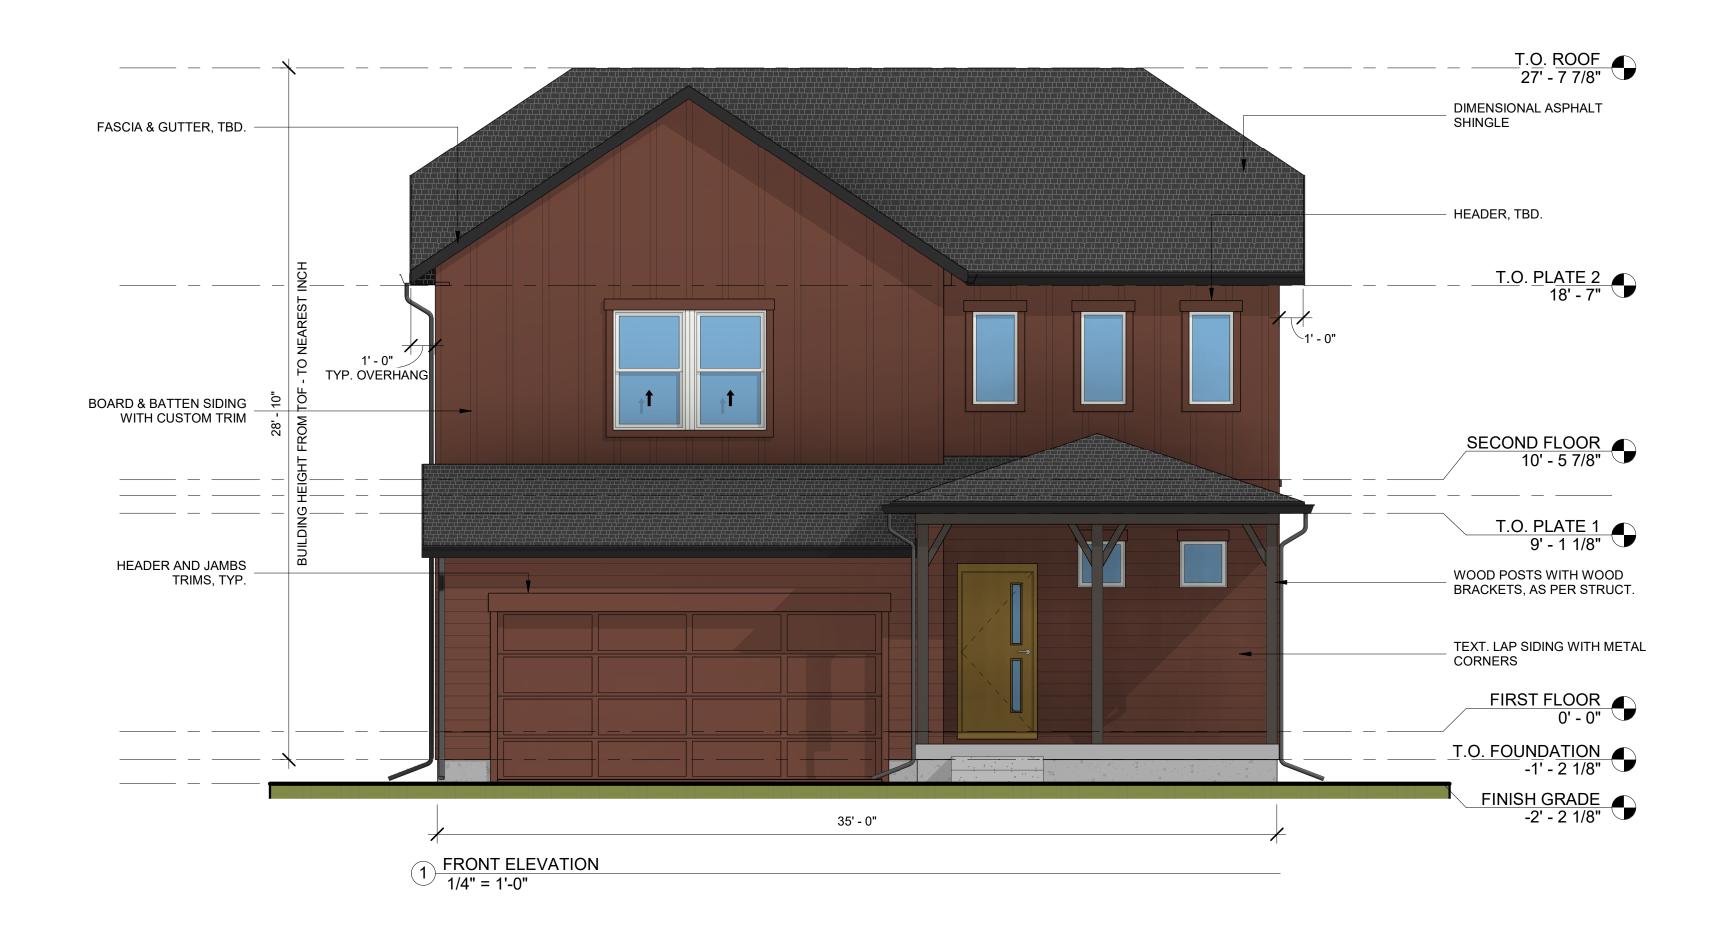


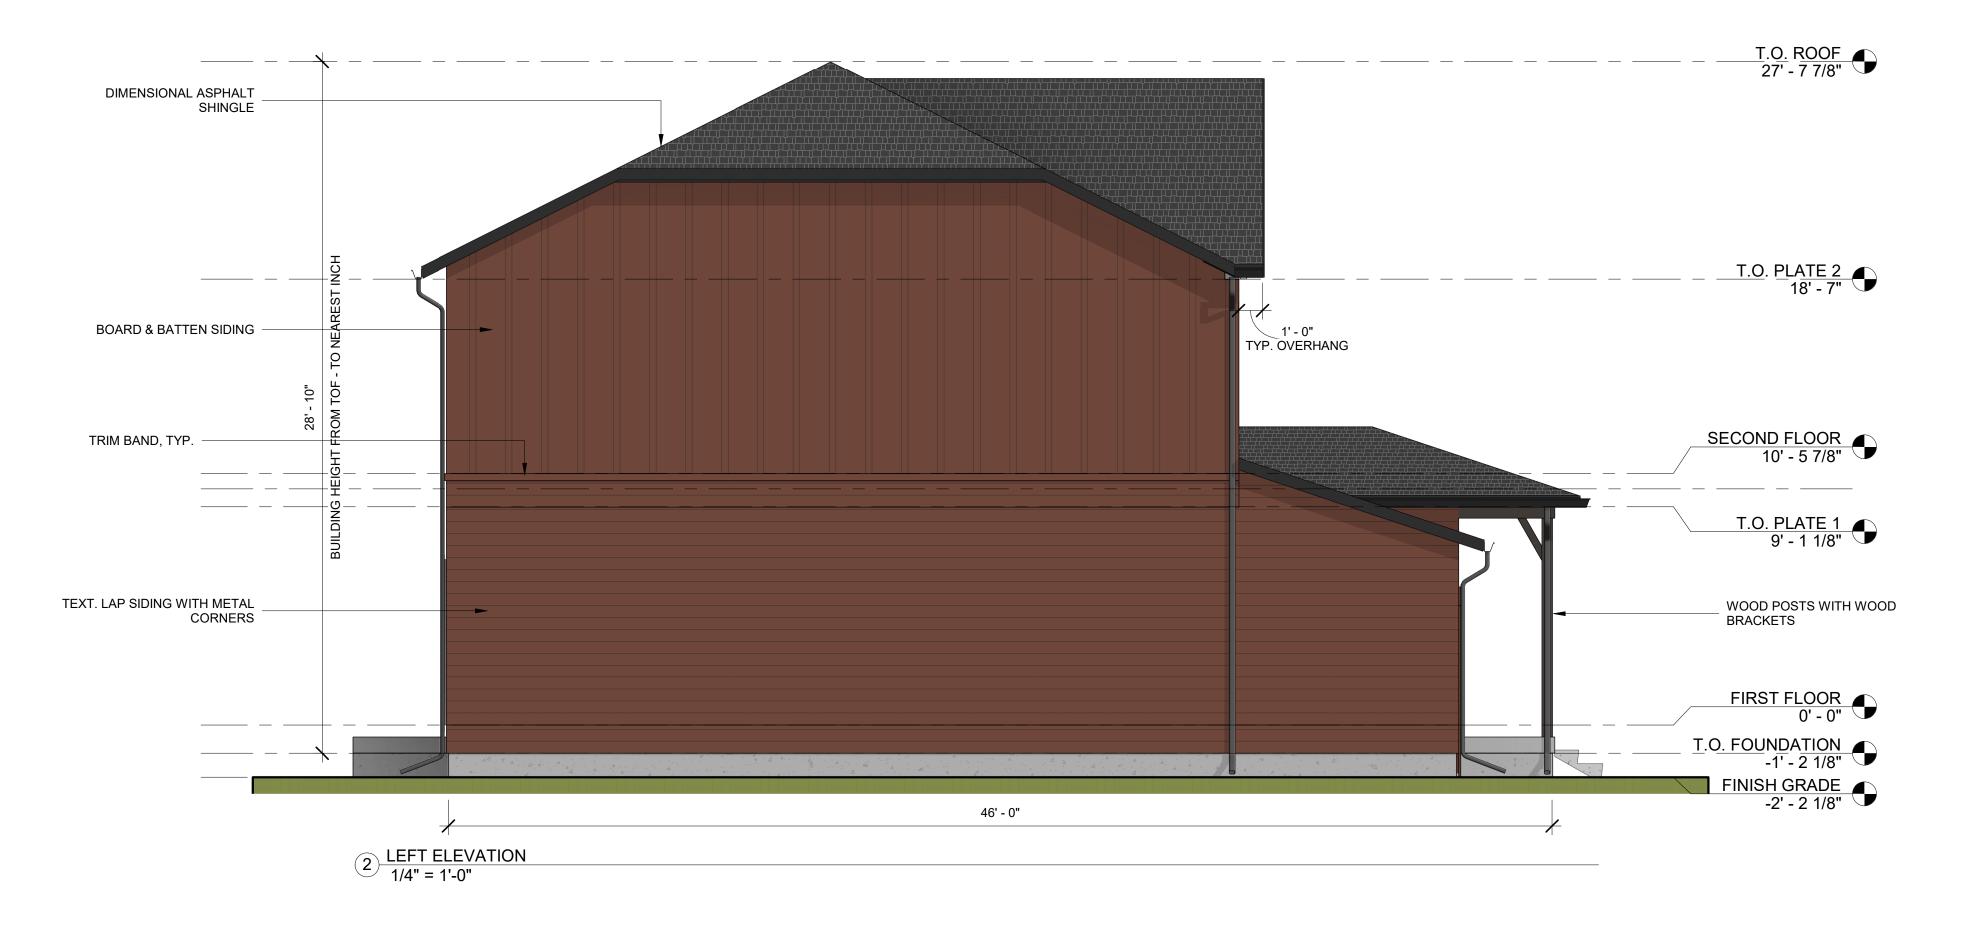


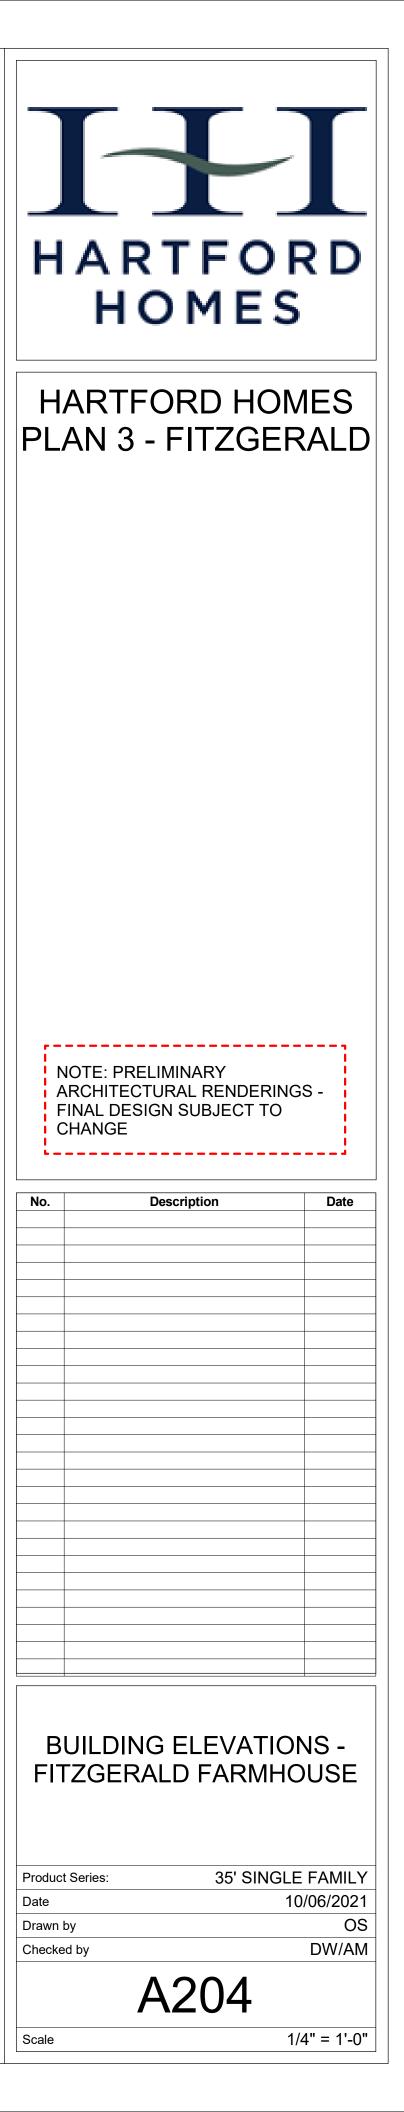




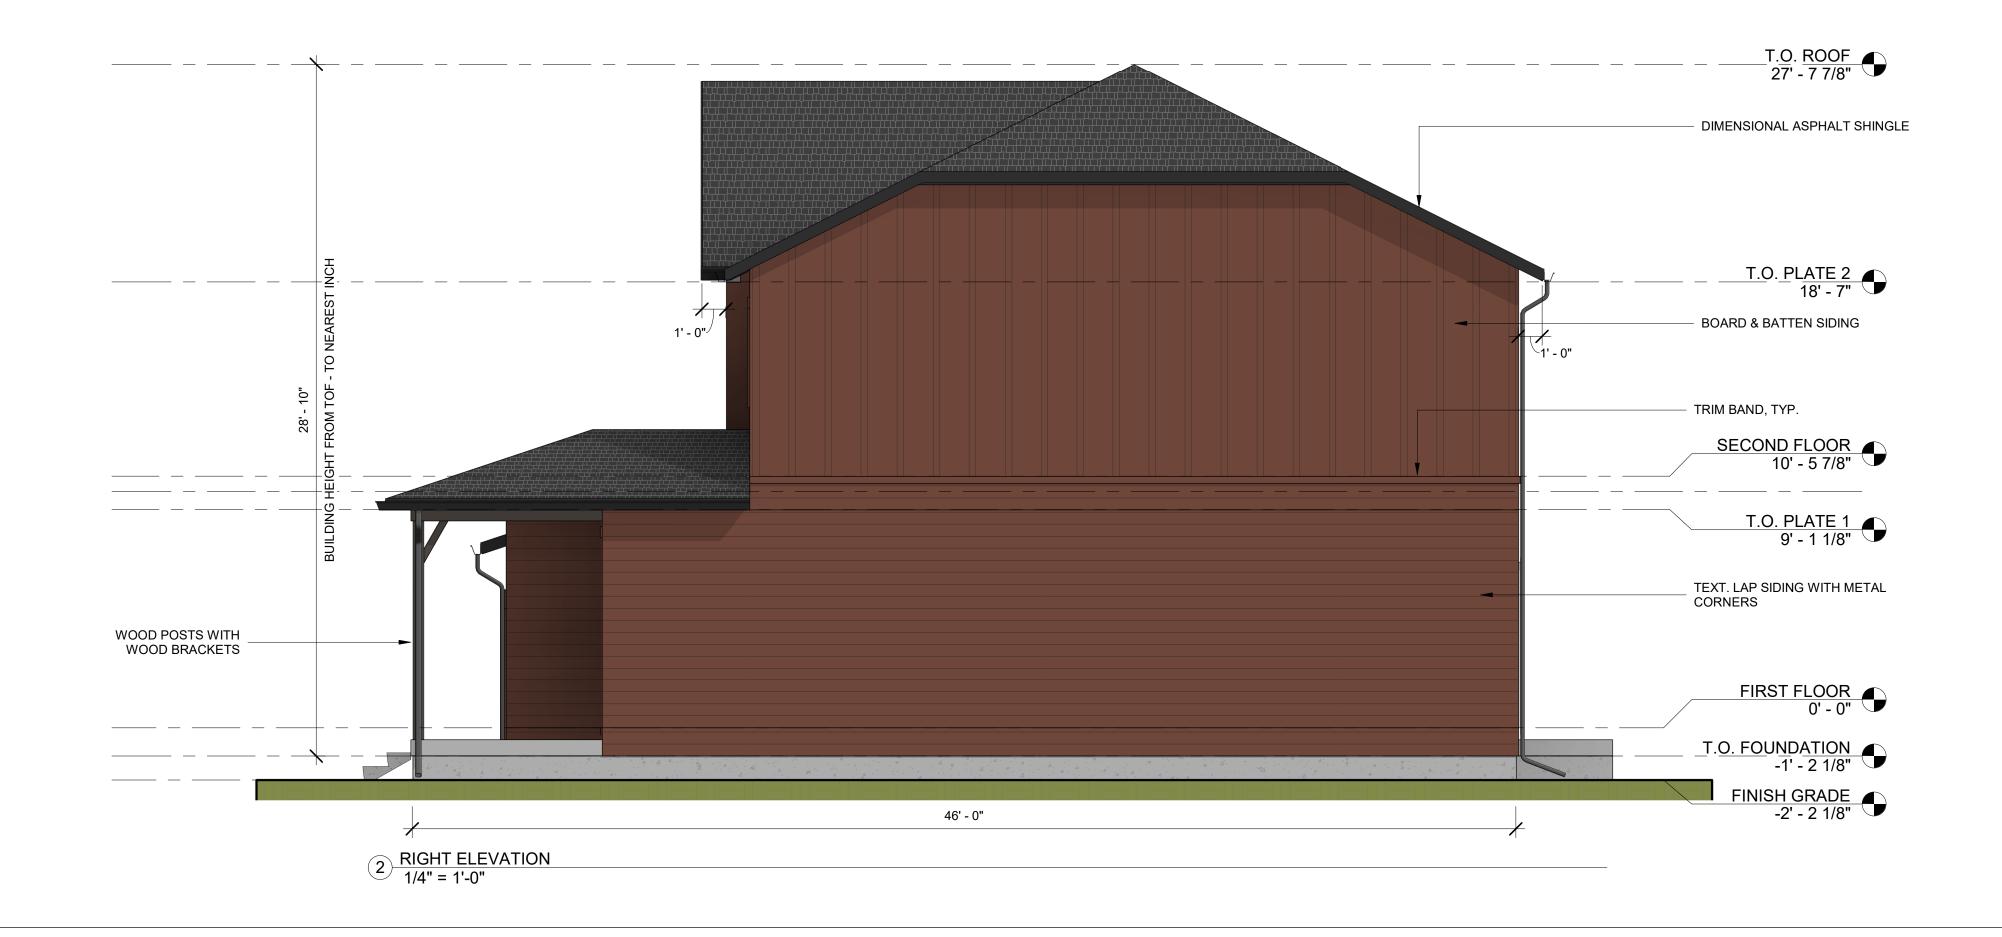


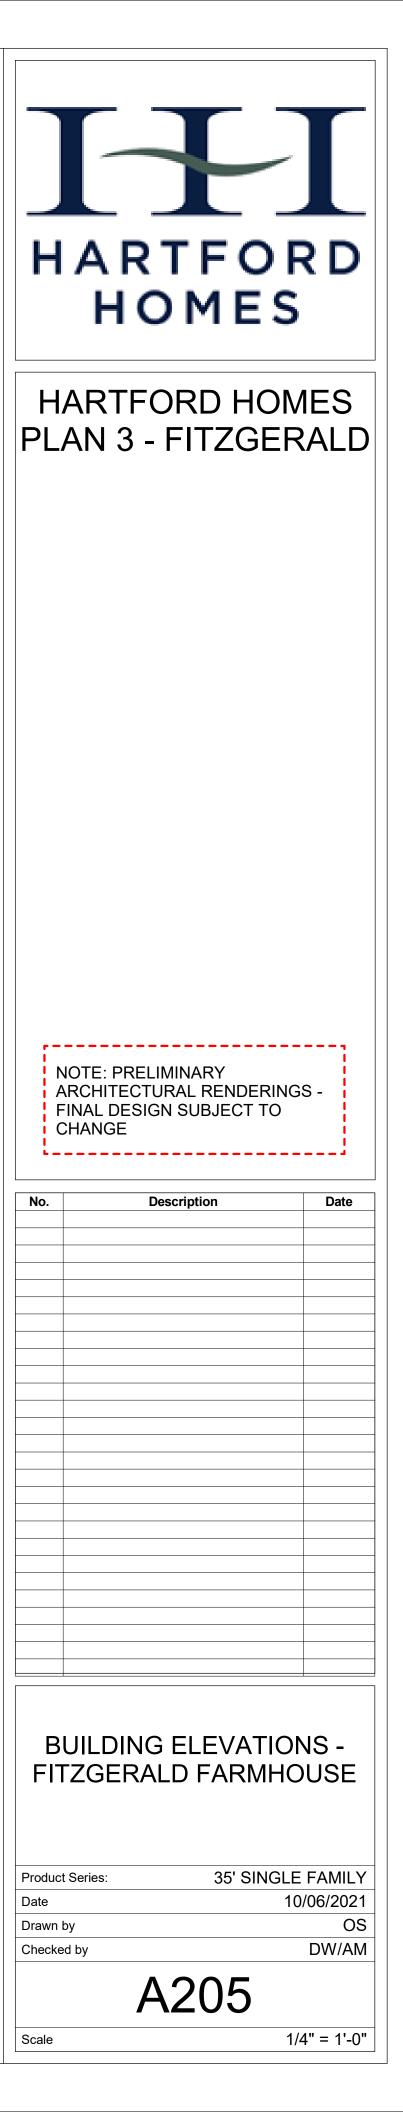

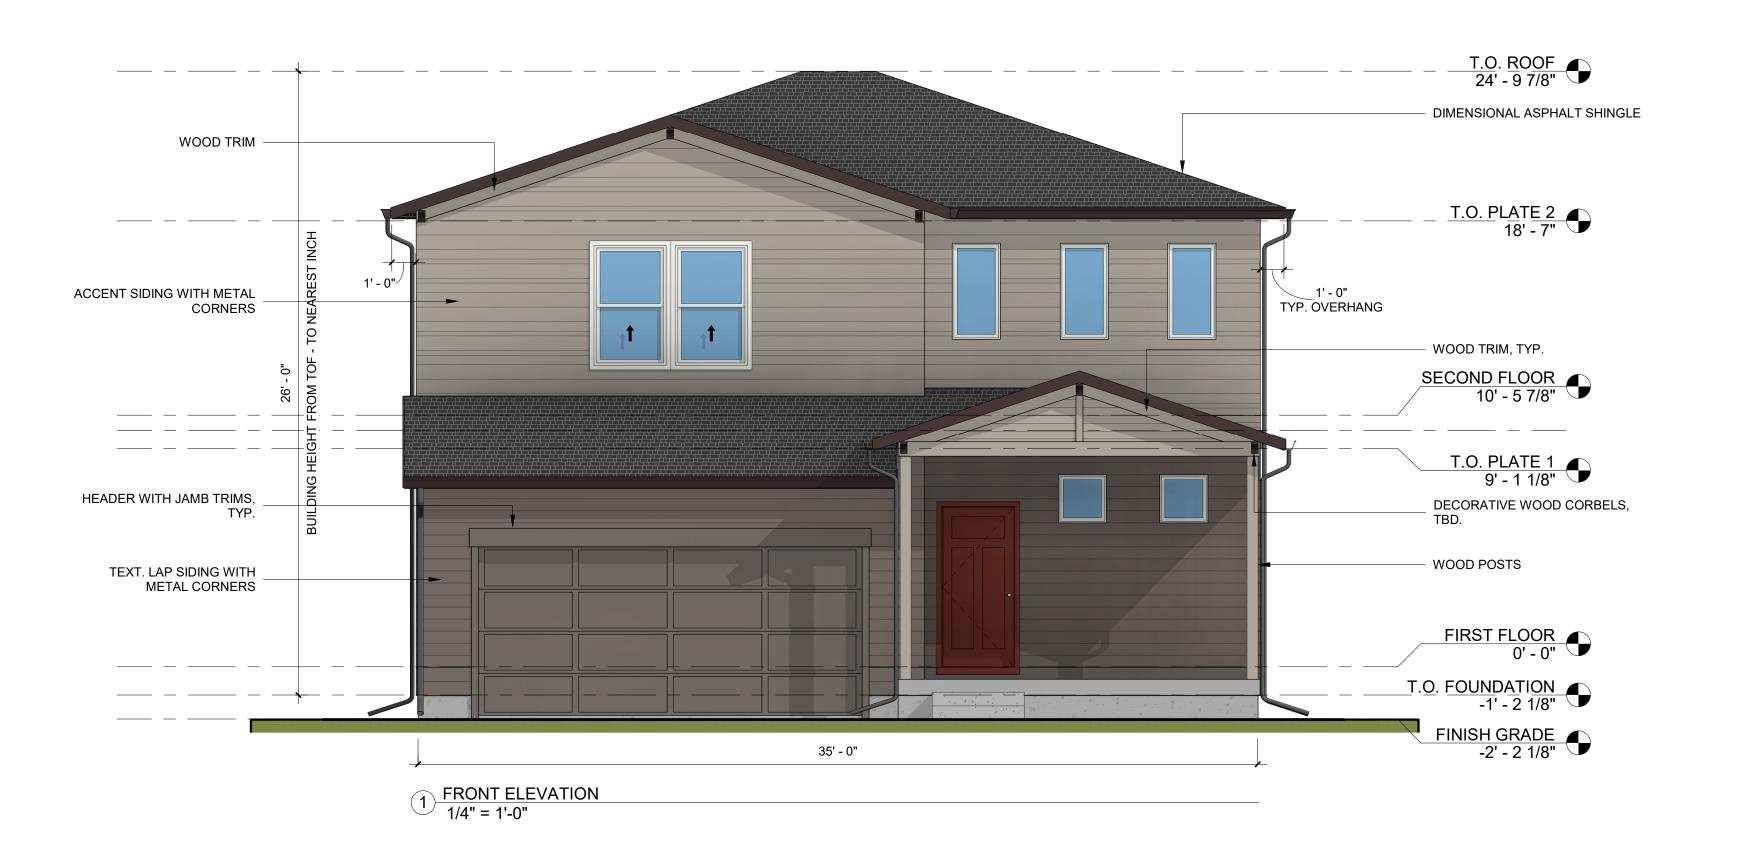

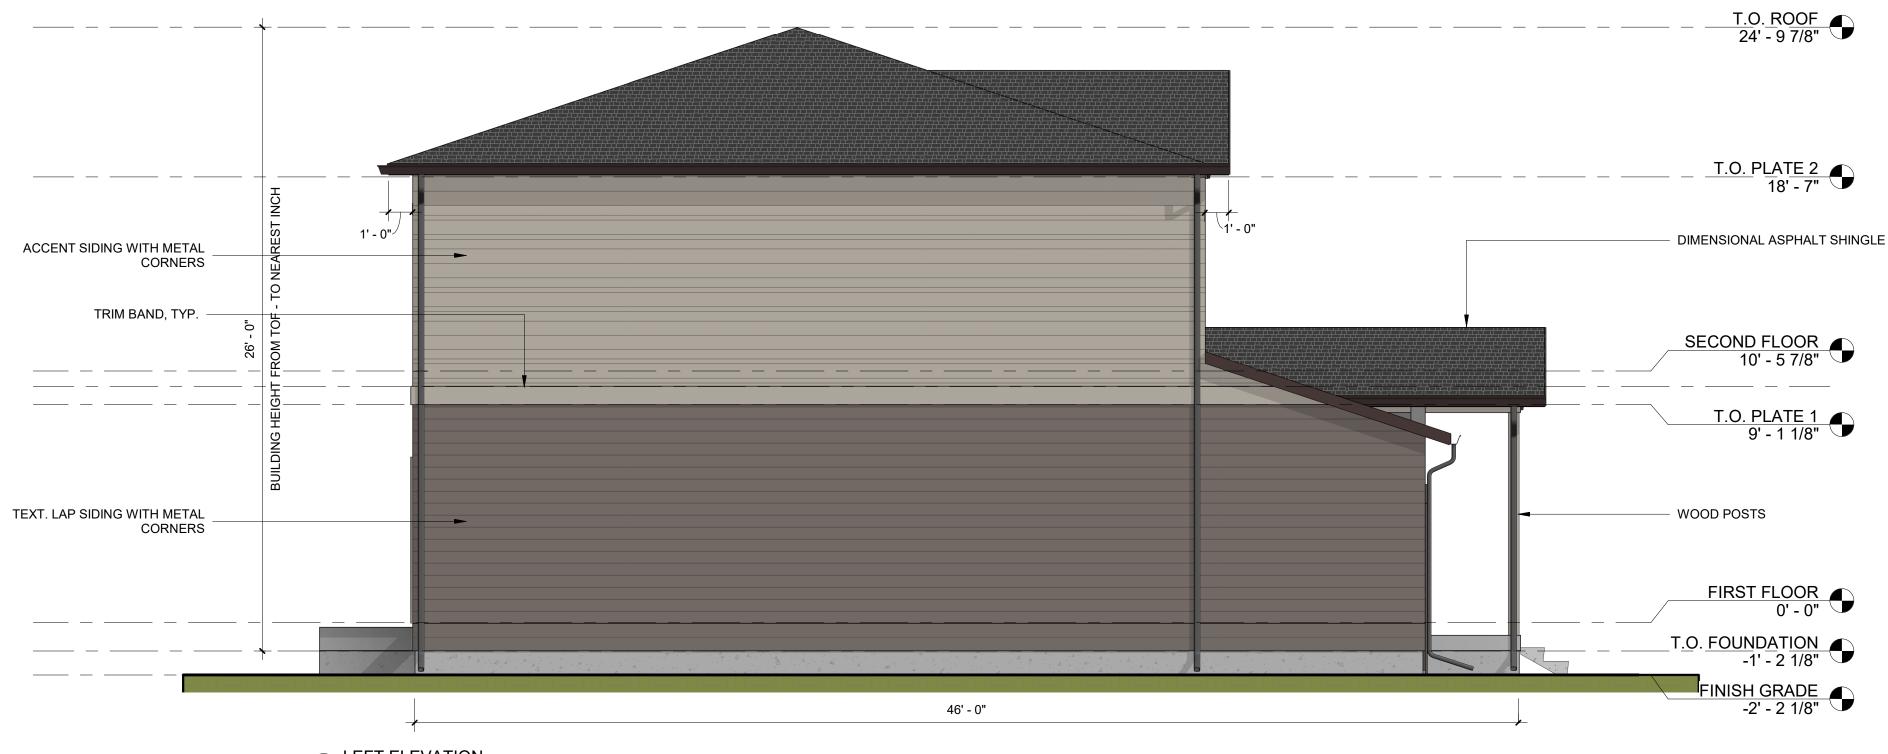


2 LEFT ELEVATION 1/4" = 1'-0"

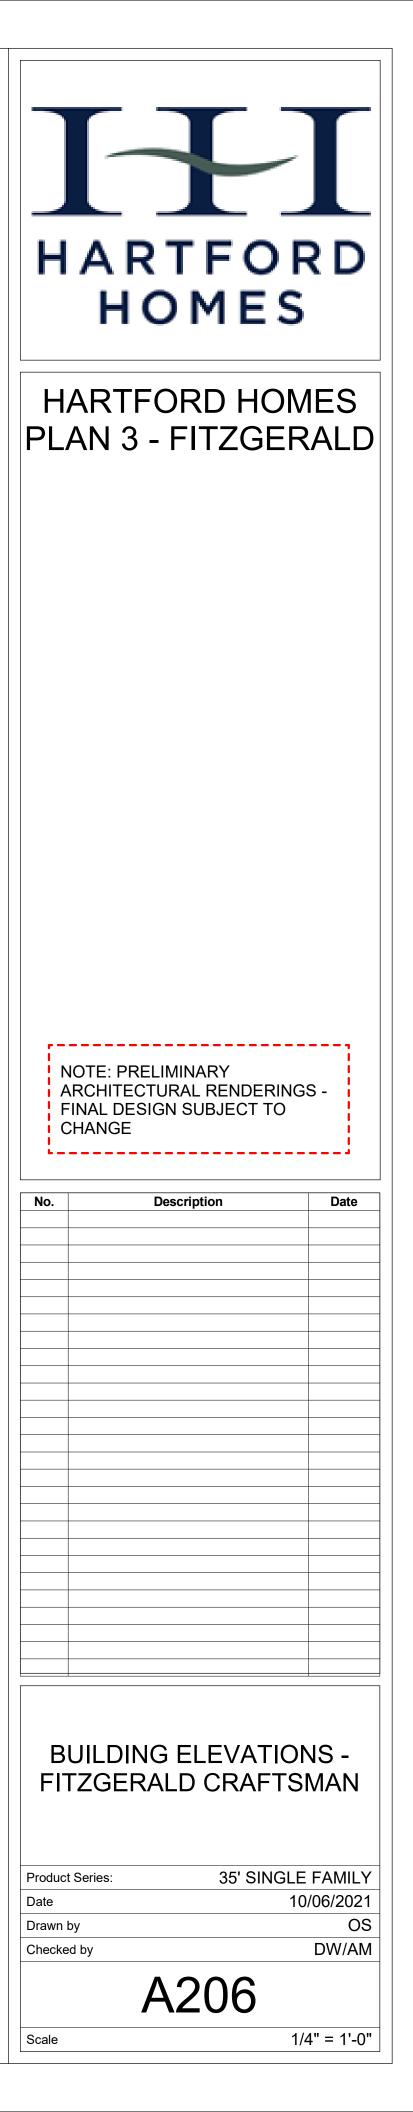







	<u>T.O. PLATE 2</u> 18' - 7"
	ACCENT SIDING WITH METAL CORNERS
	TRIM BAND, TYP.
	SECOND FLOOR 10' - 5 7/8"
	T.O. PLATE 1 9' - 1 1/8"
	TEXT. LAP SIDING WITH METAL CORNERS
	FIRST FLOOR 0' - 0"
	T.O. FOUNDATION -1' - 2 1/8"
46' - 0"	FINISH GRADE -2' - 2 1/8"

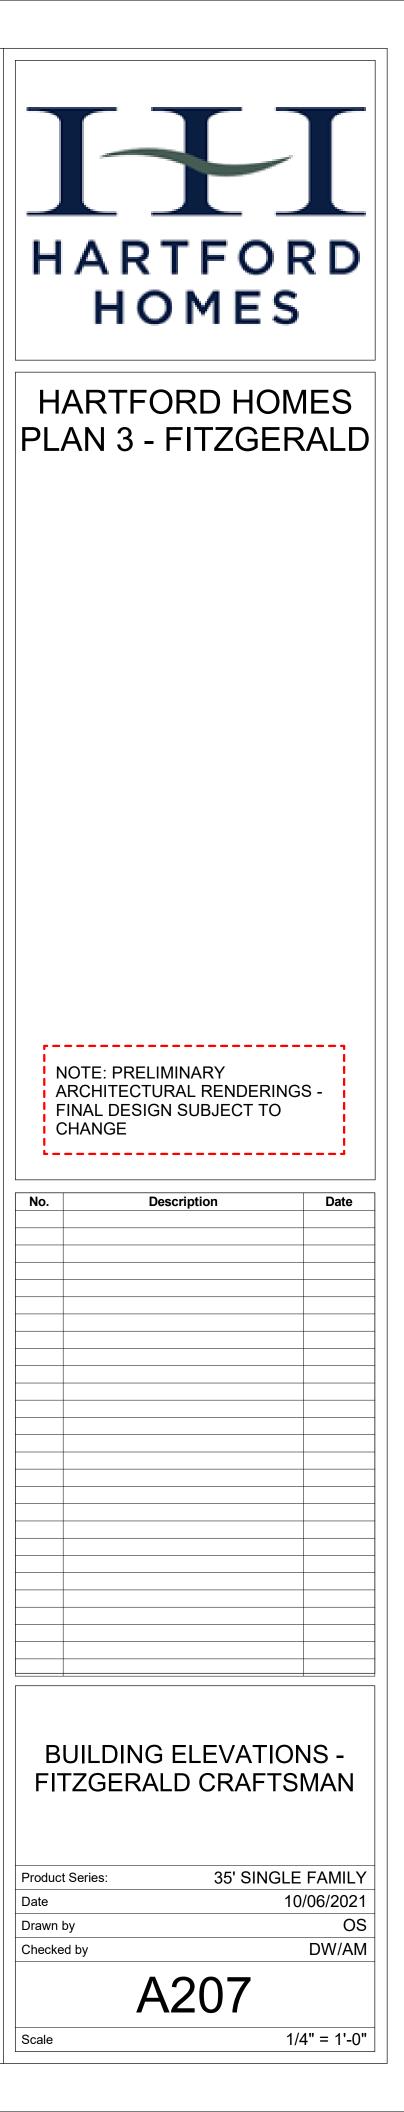

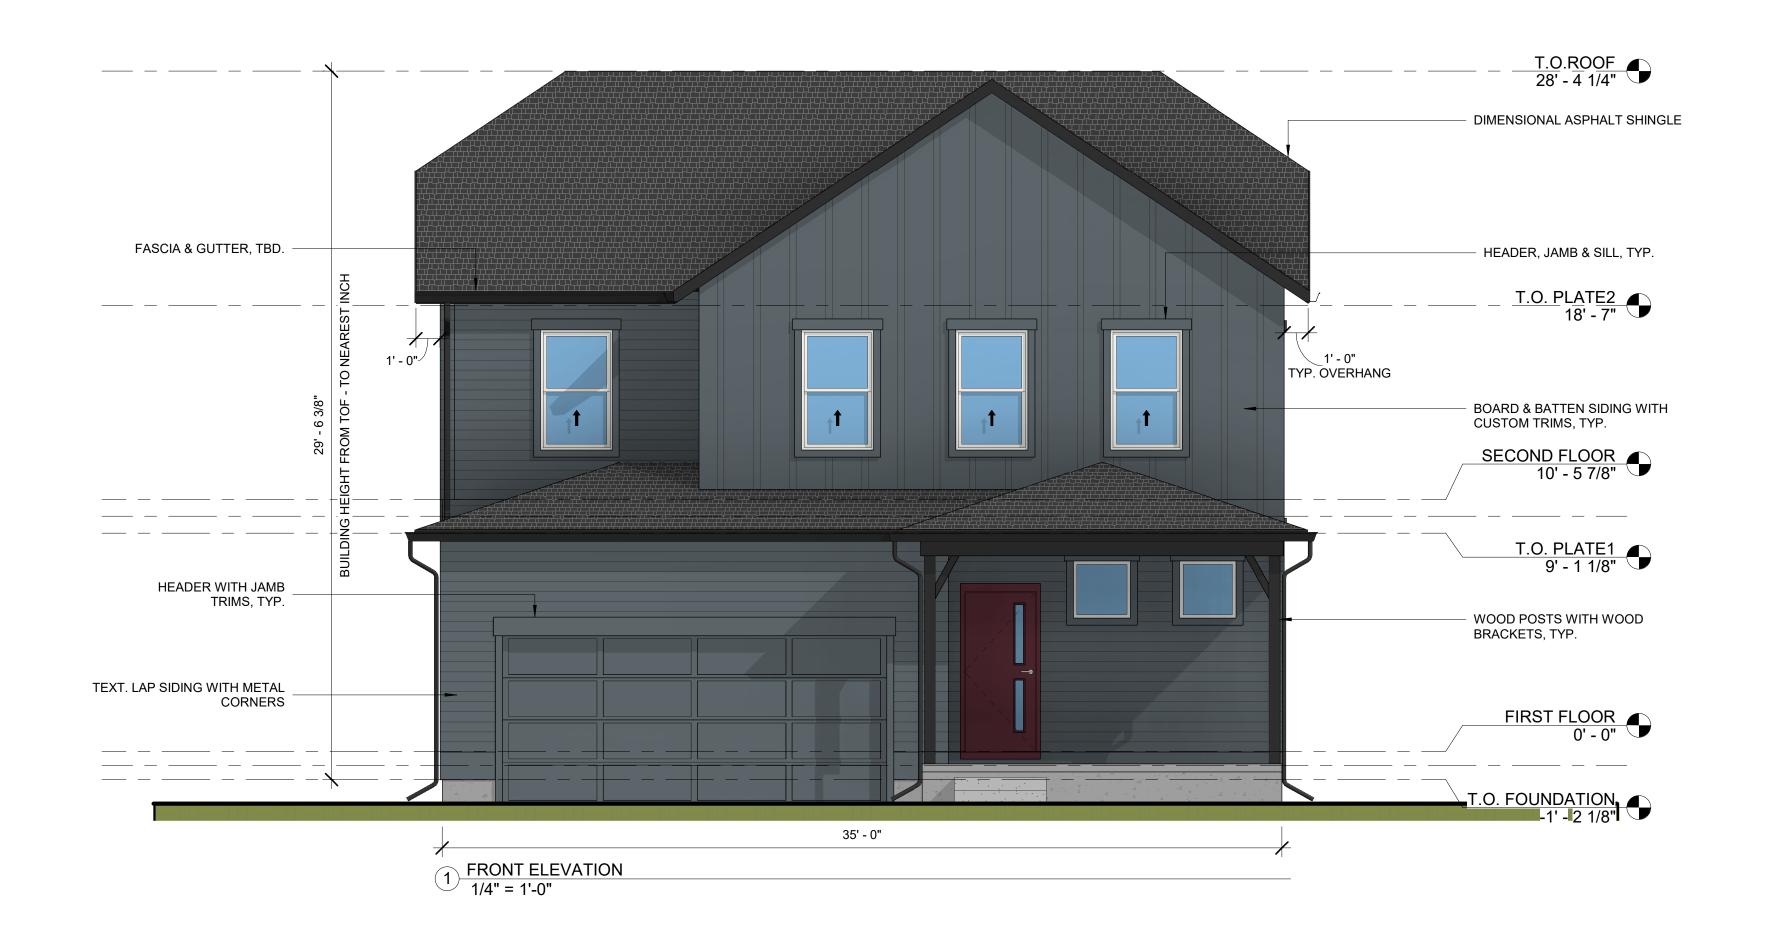




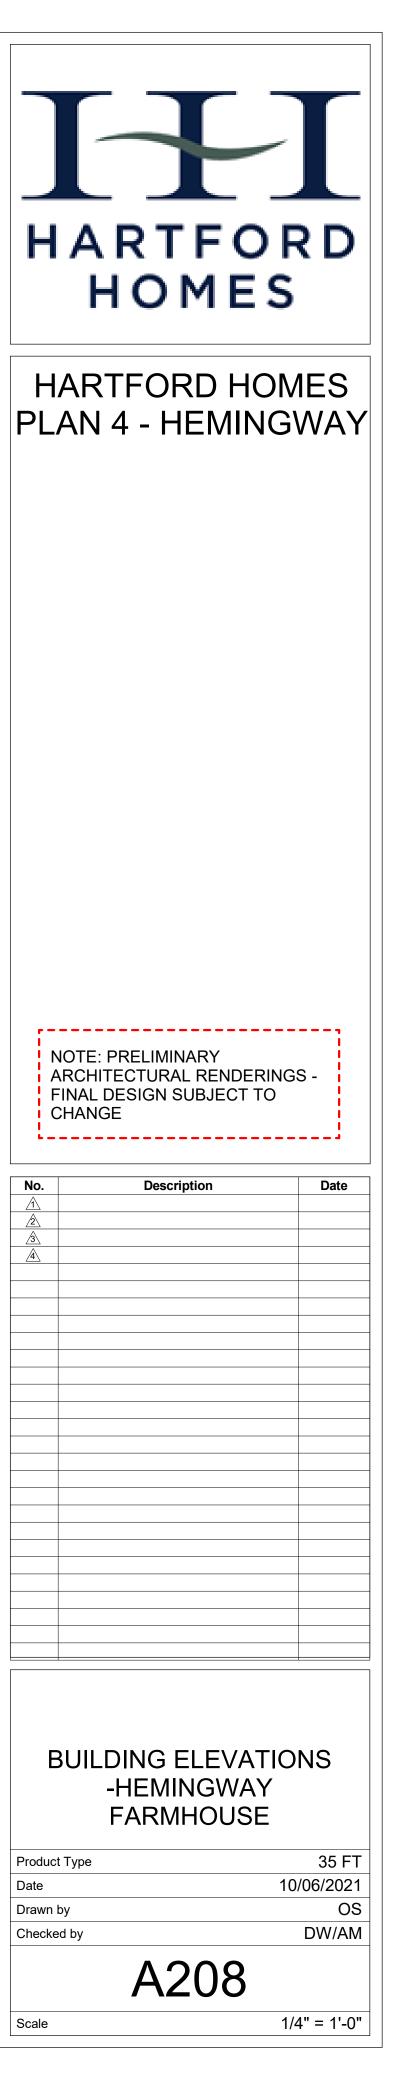






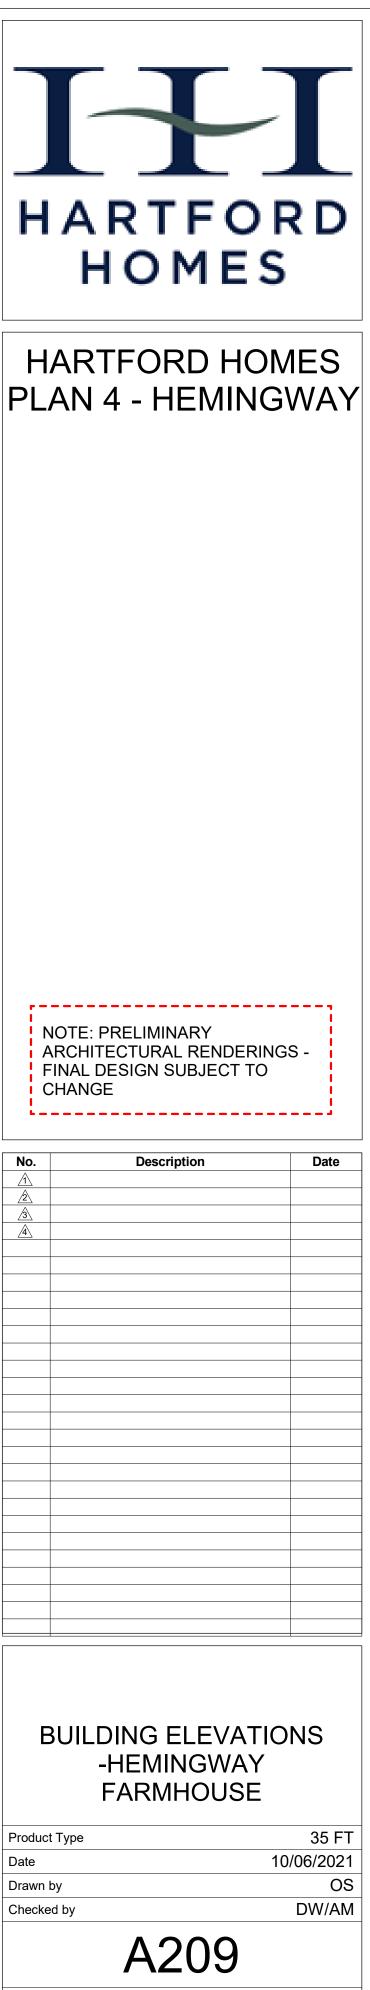


Scale


1/4" = 1'-0"




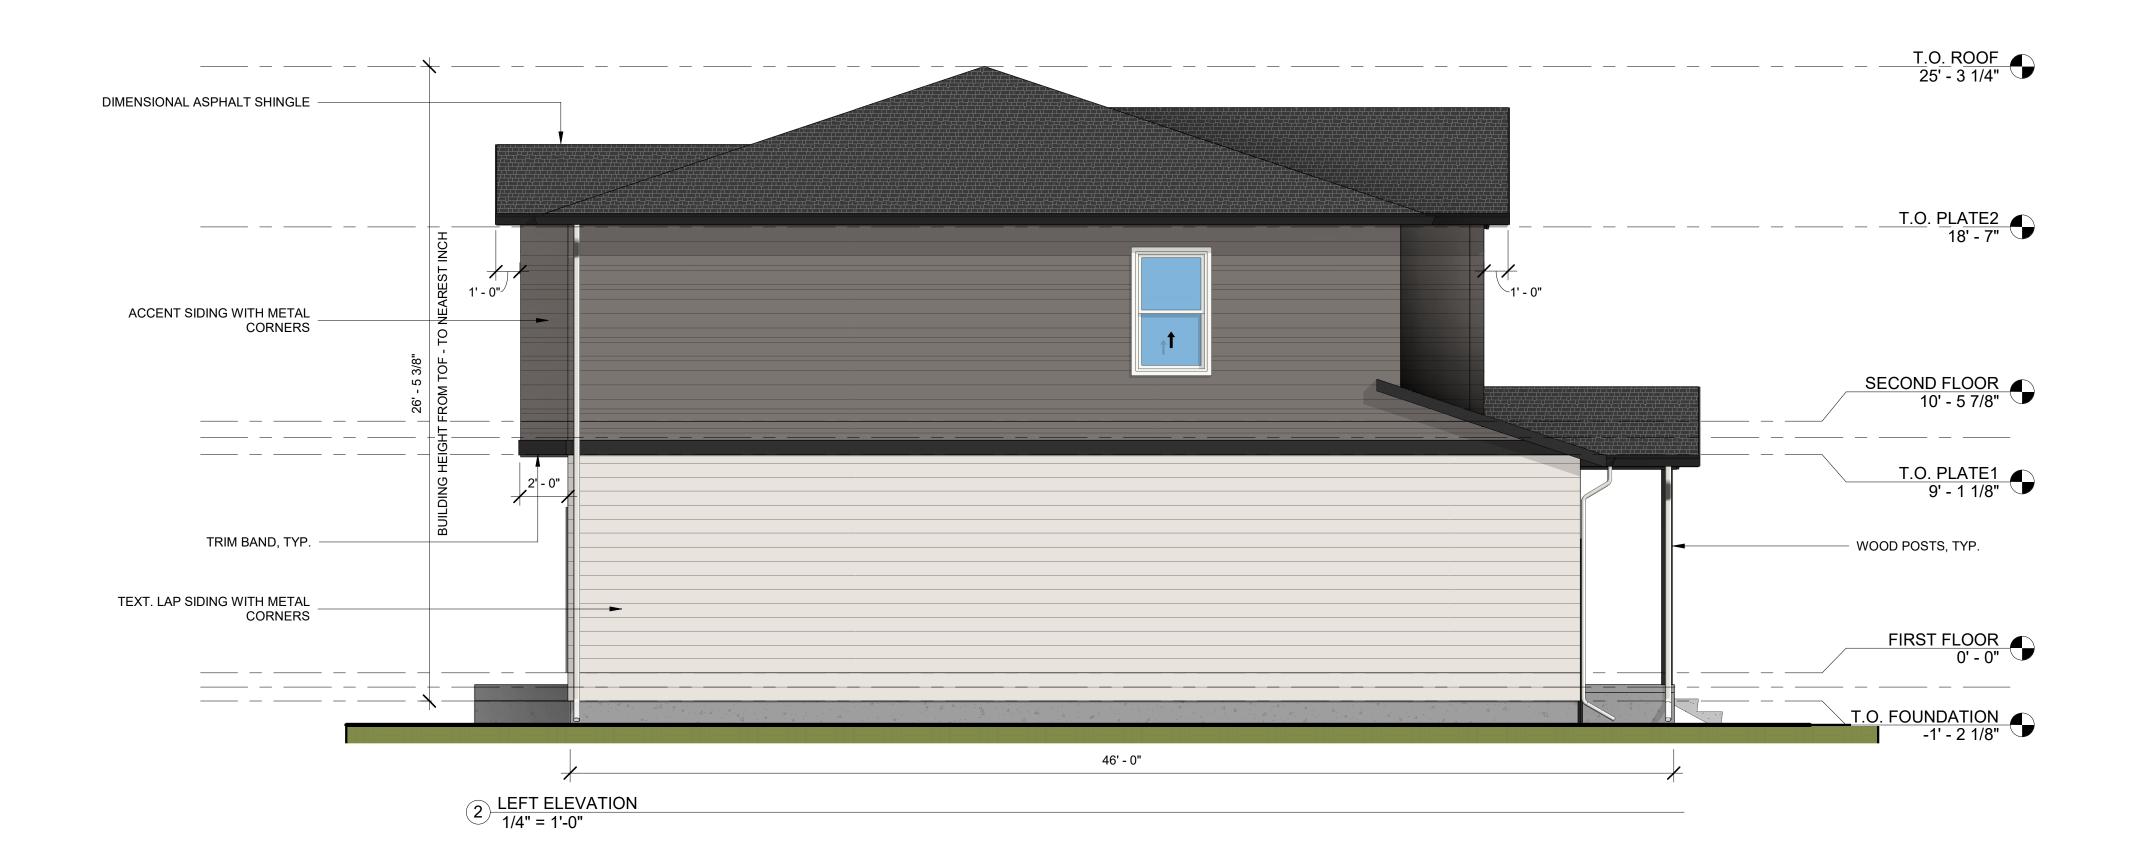


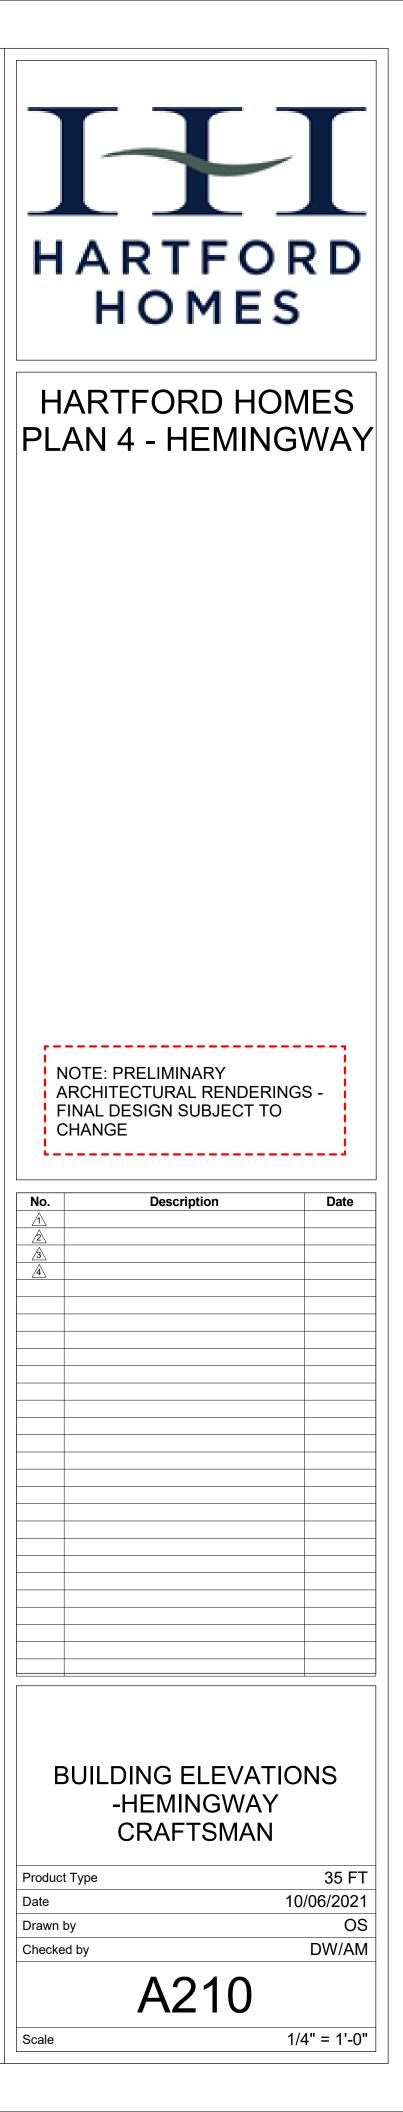




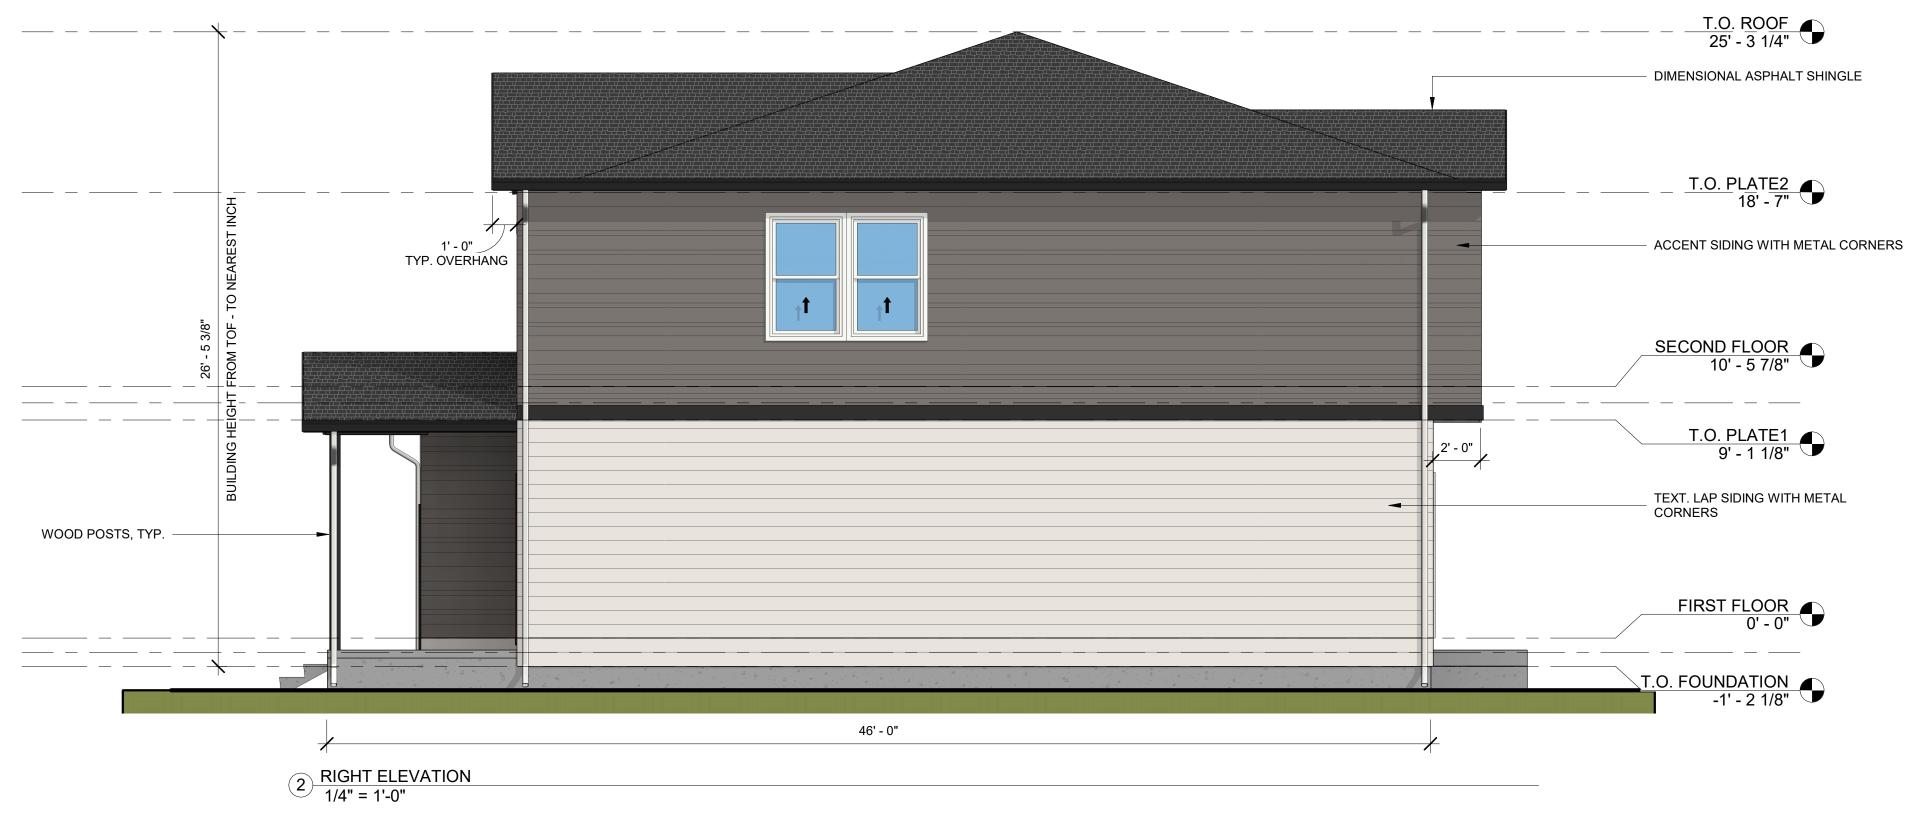

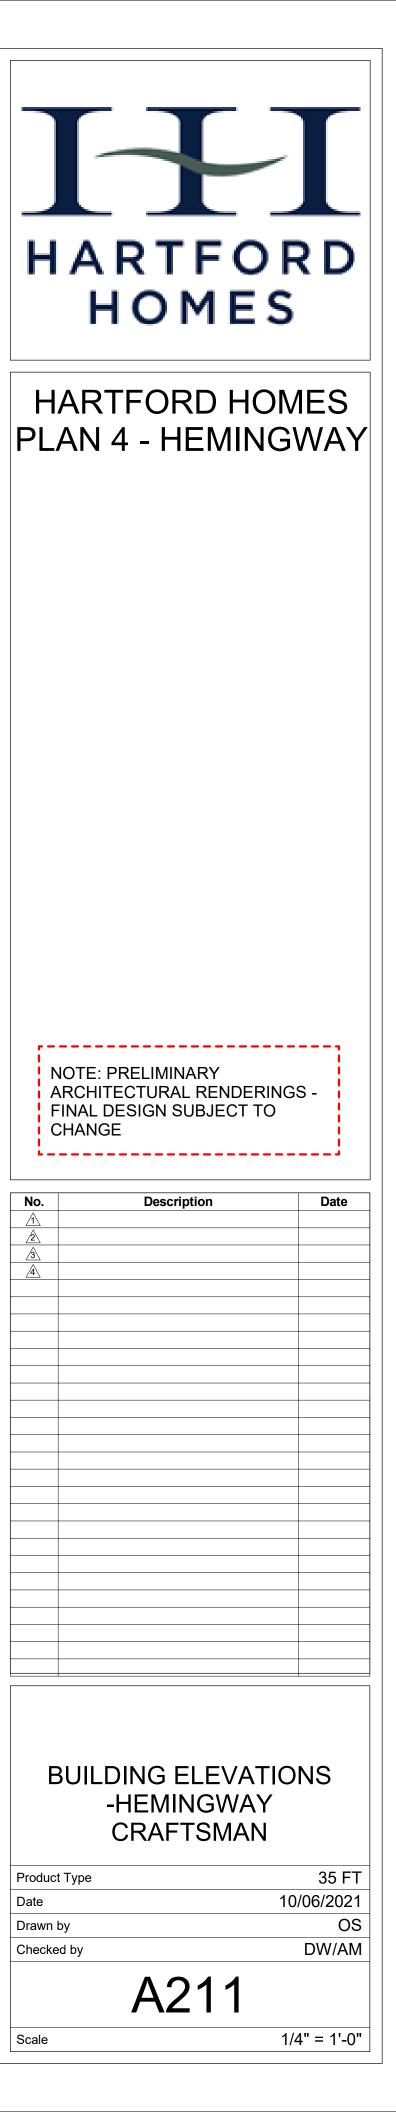

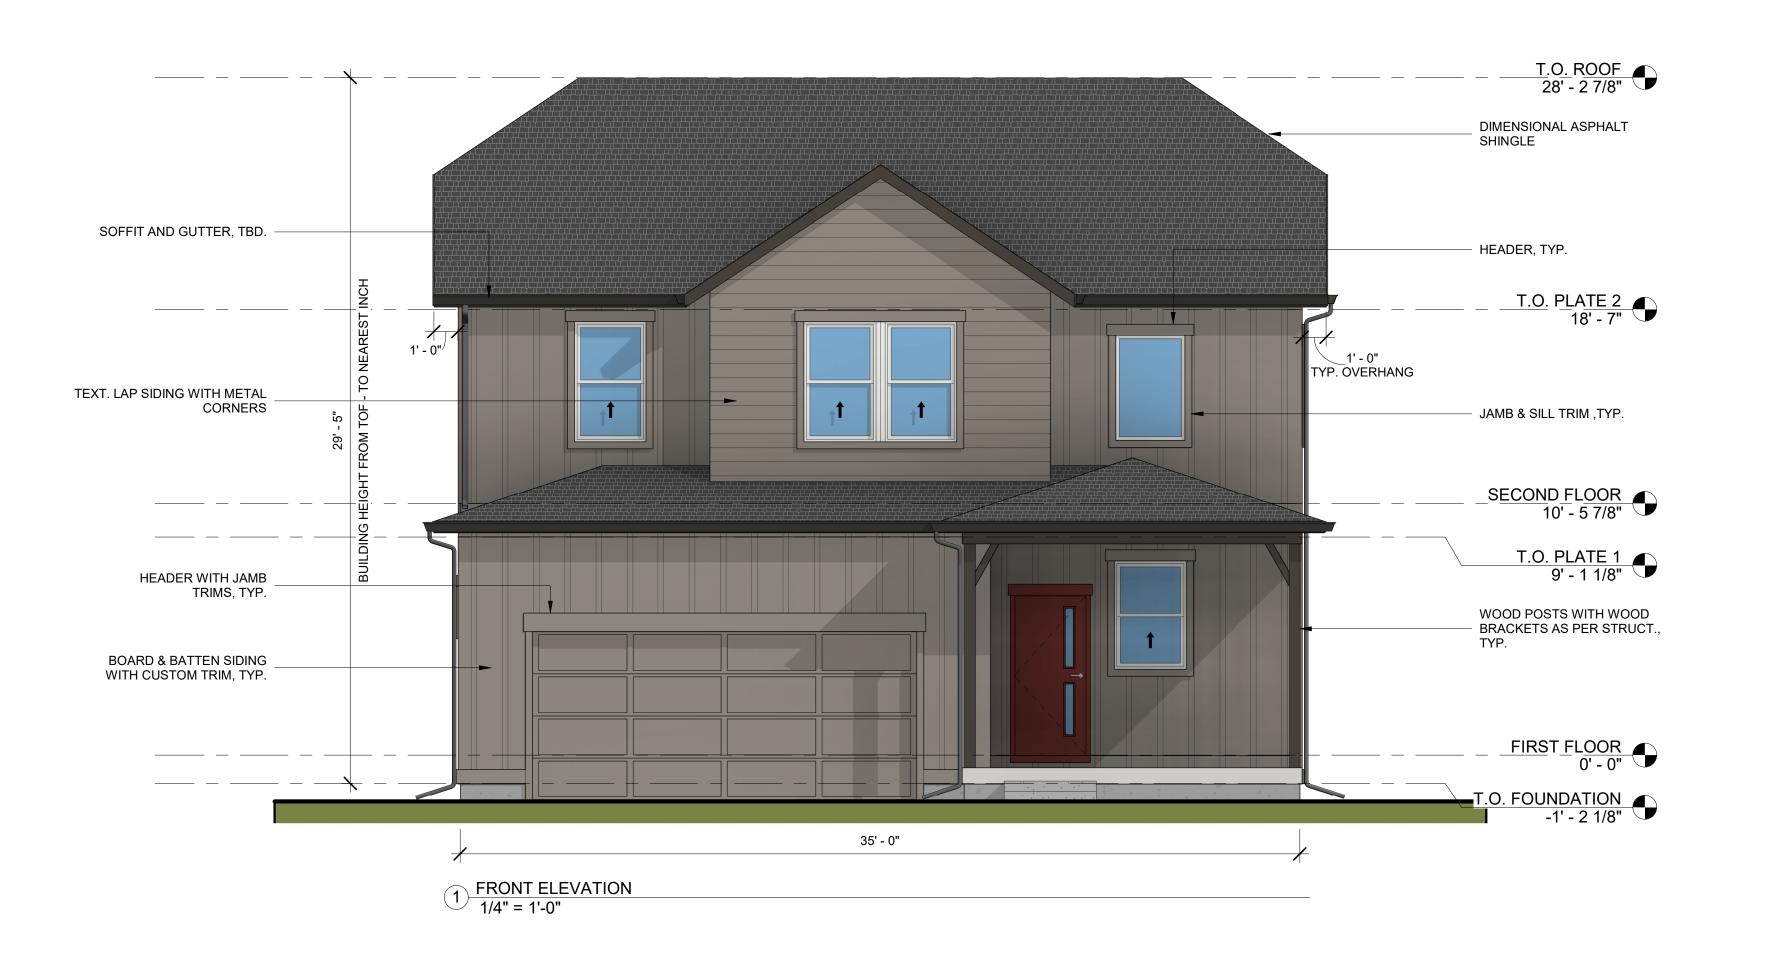

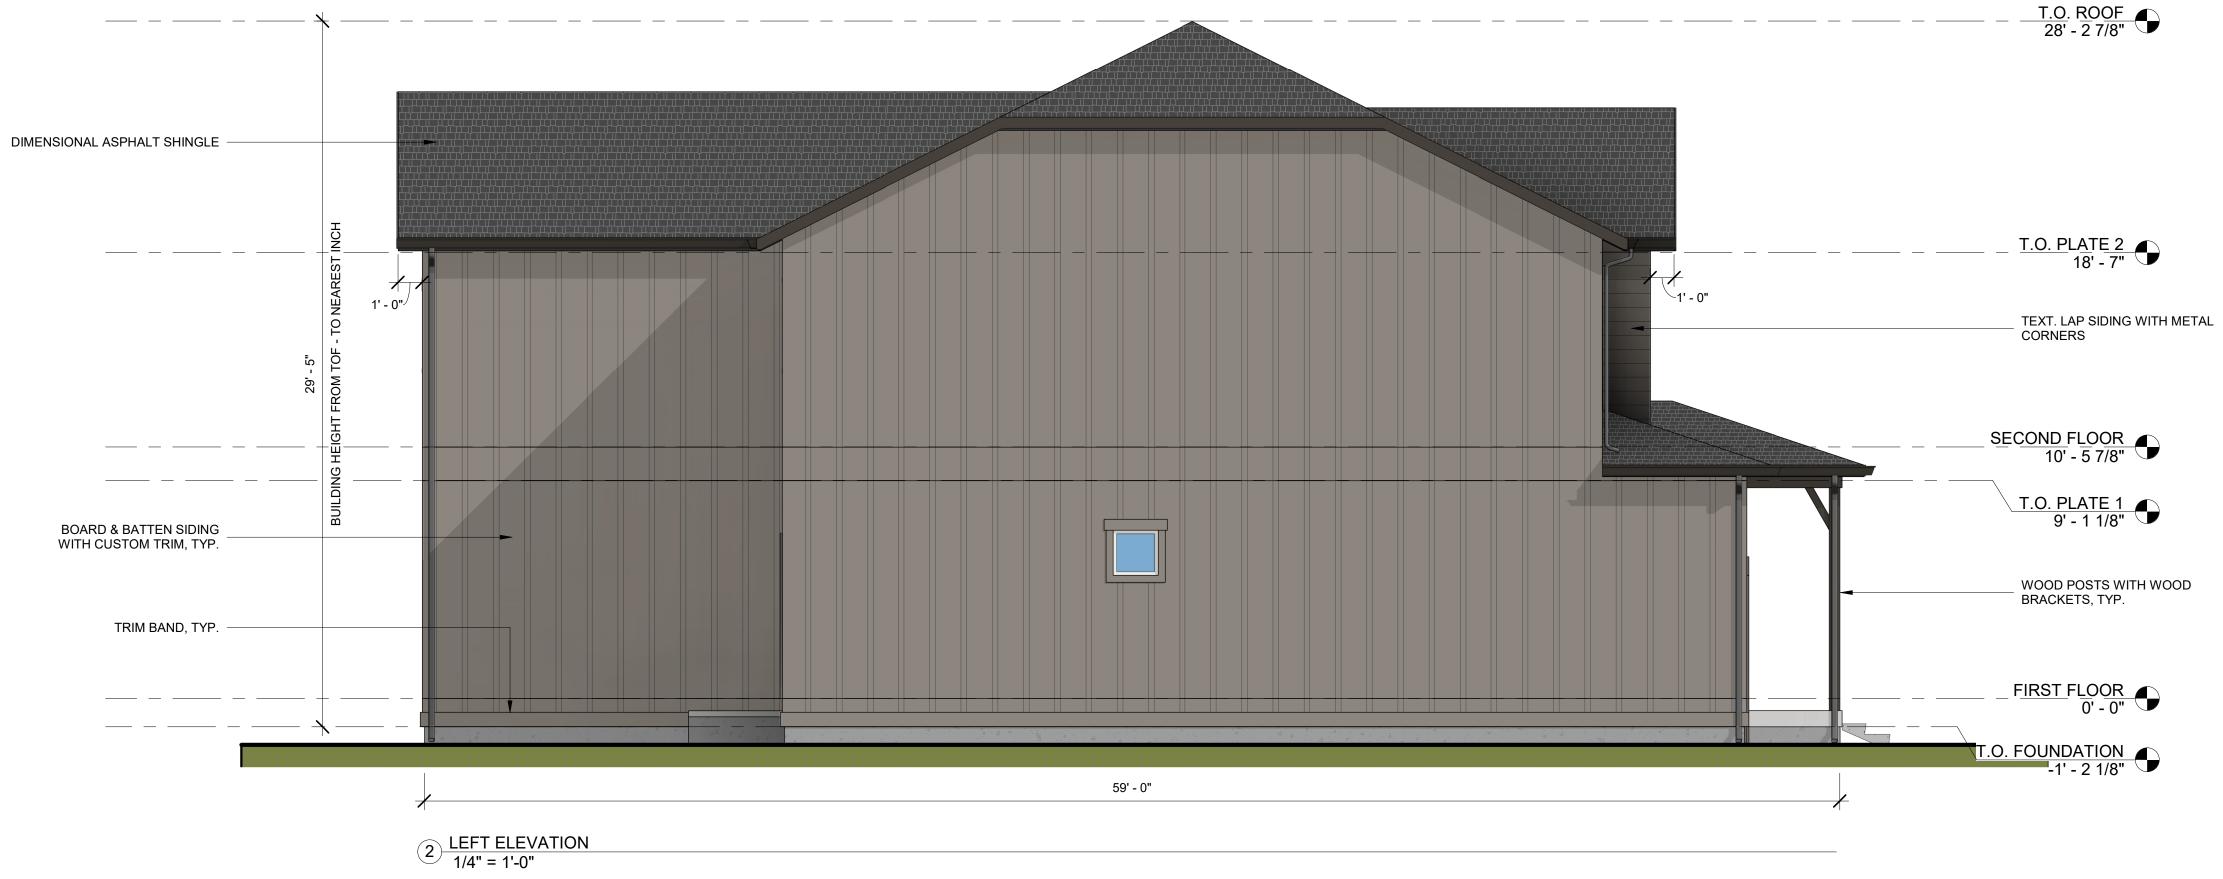



HARTFORD

NOTE: PRELIMINARY ARCHITECTURAL RENDERINGS -FINAL DESIGN SUBJECT TO CHANGE

No.	Description	Date

### **BUILDING ELEVATION** -ROWLING FARMHOUSE


Product Type Date Drawn by Checked by

35 FT 10/06/2021 O.S. AM/DW


## A212

Scale

1/4" = 1'-0"

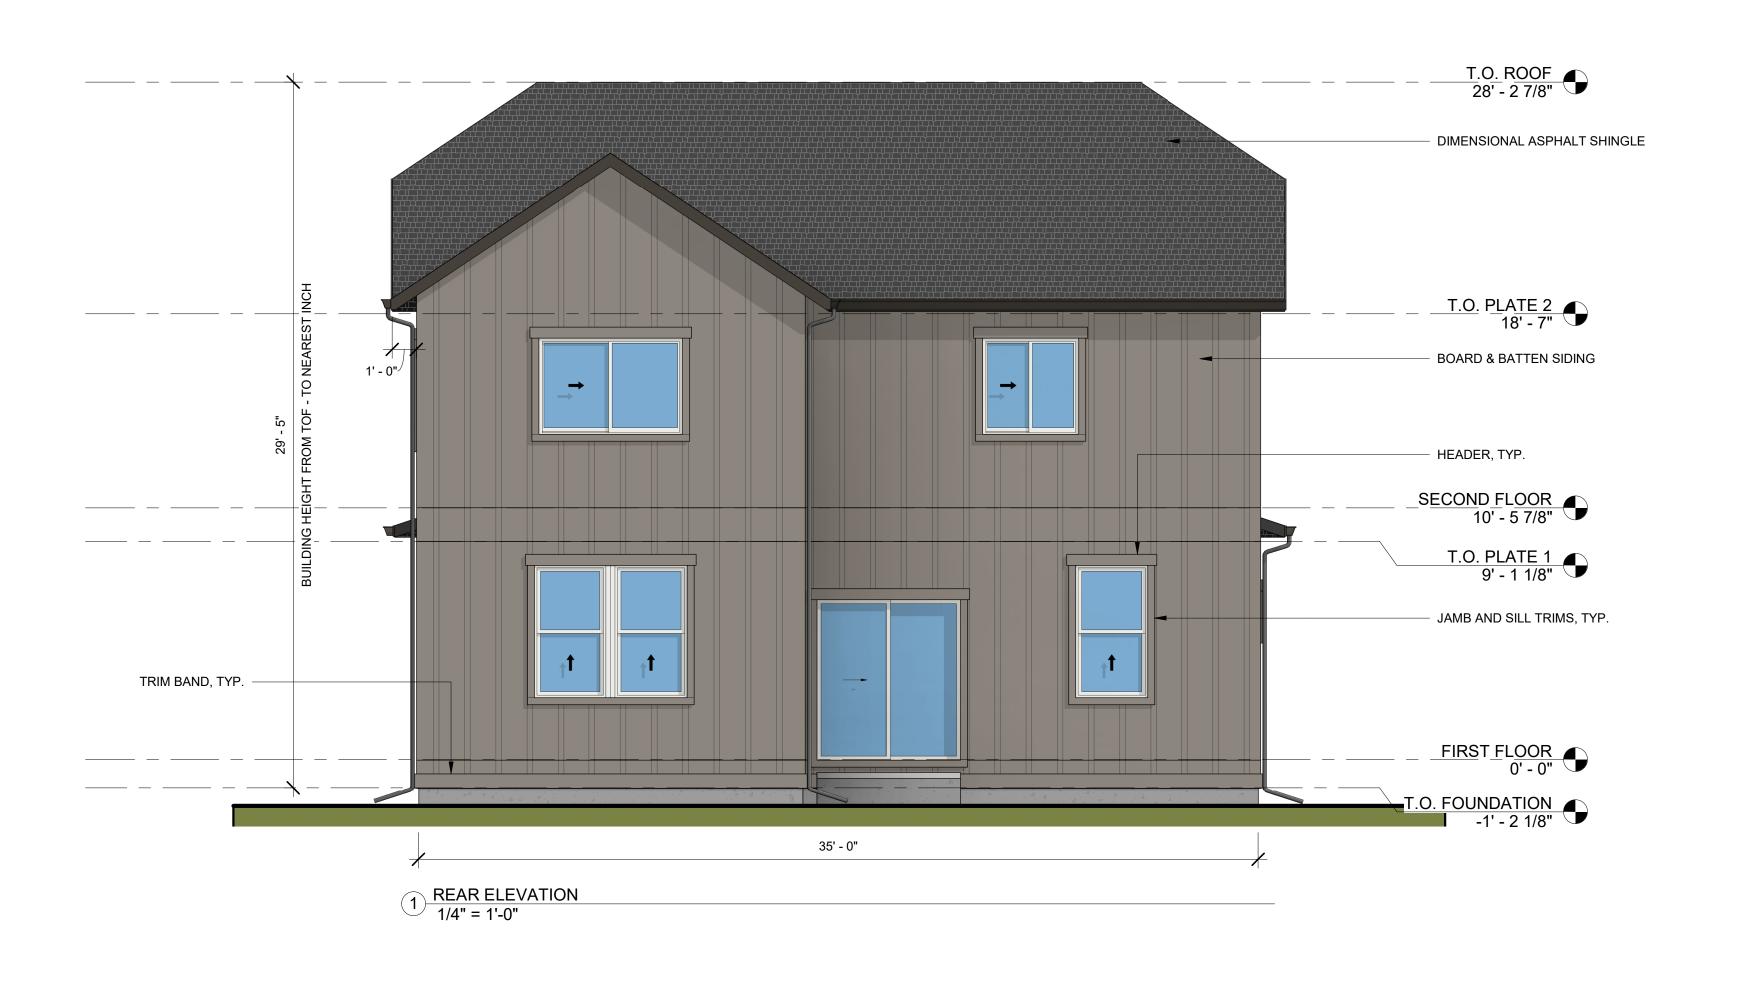



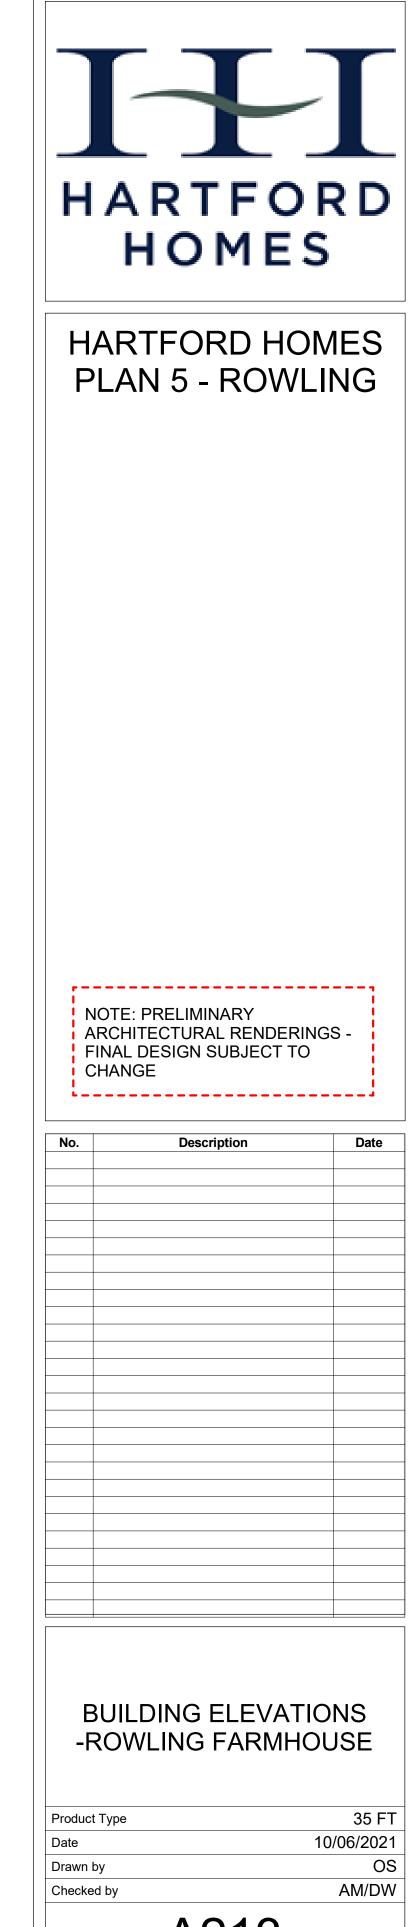

A213

Scale

1/4" = 1'-0"

T.O. ROOF 28' - 2 7/8"


<u>T.O. PLATE 2</u> 18' - 7"

SECOND FLOOR 10' - 5 7/8" <u>T.O. PLATE 1</u> 9' - 1 1/8"

FIRST FLOOR 0' - 0" T.O. FOUNDATION -1' - 2 1/8"





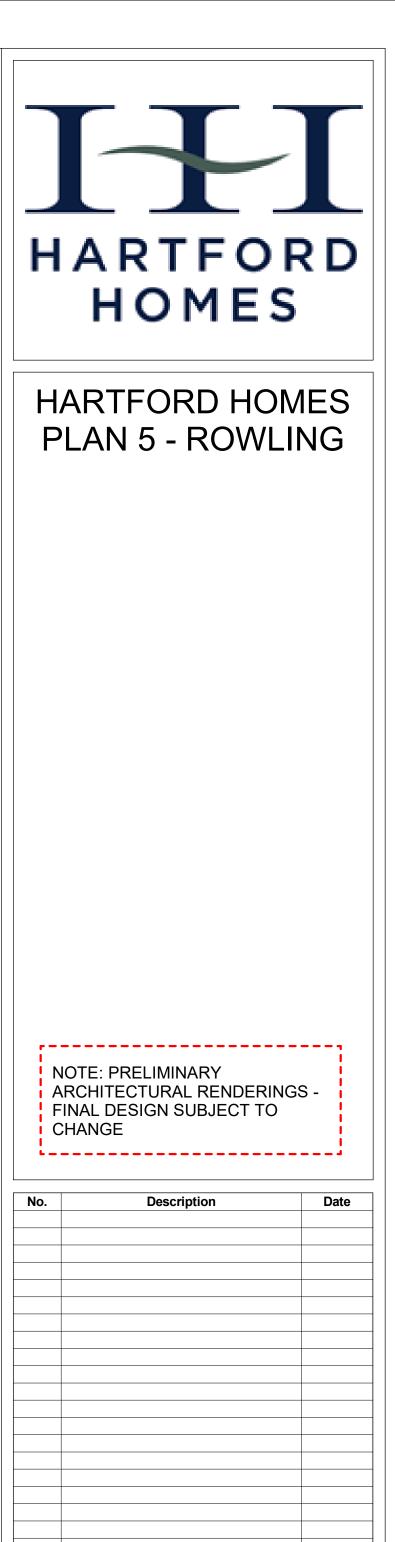

### **BUILDING ELEVATIONS** -ROWLING CRAFTSMAN

Product Type	35FT
Date	10/06/2021
Drawn by	0.S.
Checked by	AM/DW



Scale

1/4" = 1'-0"

TEXT. LAP SIDING WITH METAL CORNERS

\_ FIRST FLOOR 0' - 0" T.O. FOUNDATION -1' - 2 1/8"









### HARTFORD HOMES PLAN 5 - ROWLING

NOTE: PRELIMINARY ARCHITECTURAL RENDERINGS -FINAL DESIGN SUBJECT TO CHANGE A .....

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No.	Description	Date

### **BUILDING ELEVATIONS** -ROWLING CRAFTSMAN

Product Type Date Drawn by

Checked by


35FT 10/06/2021 O.S. AM/DW



Scale

1/4" = 1'-0"



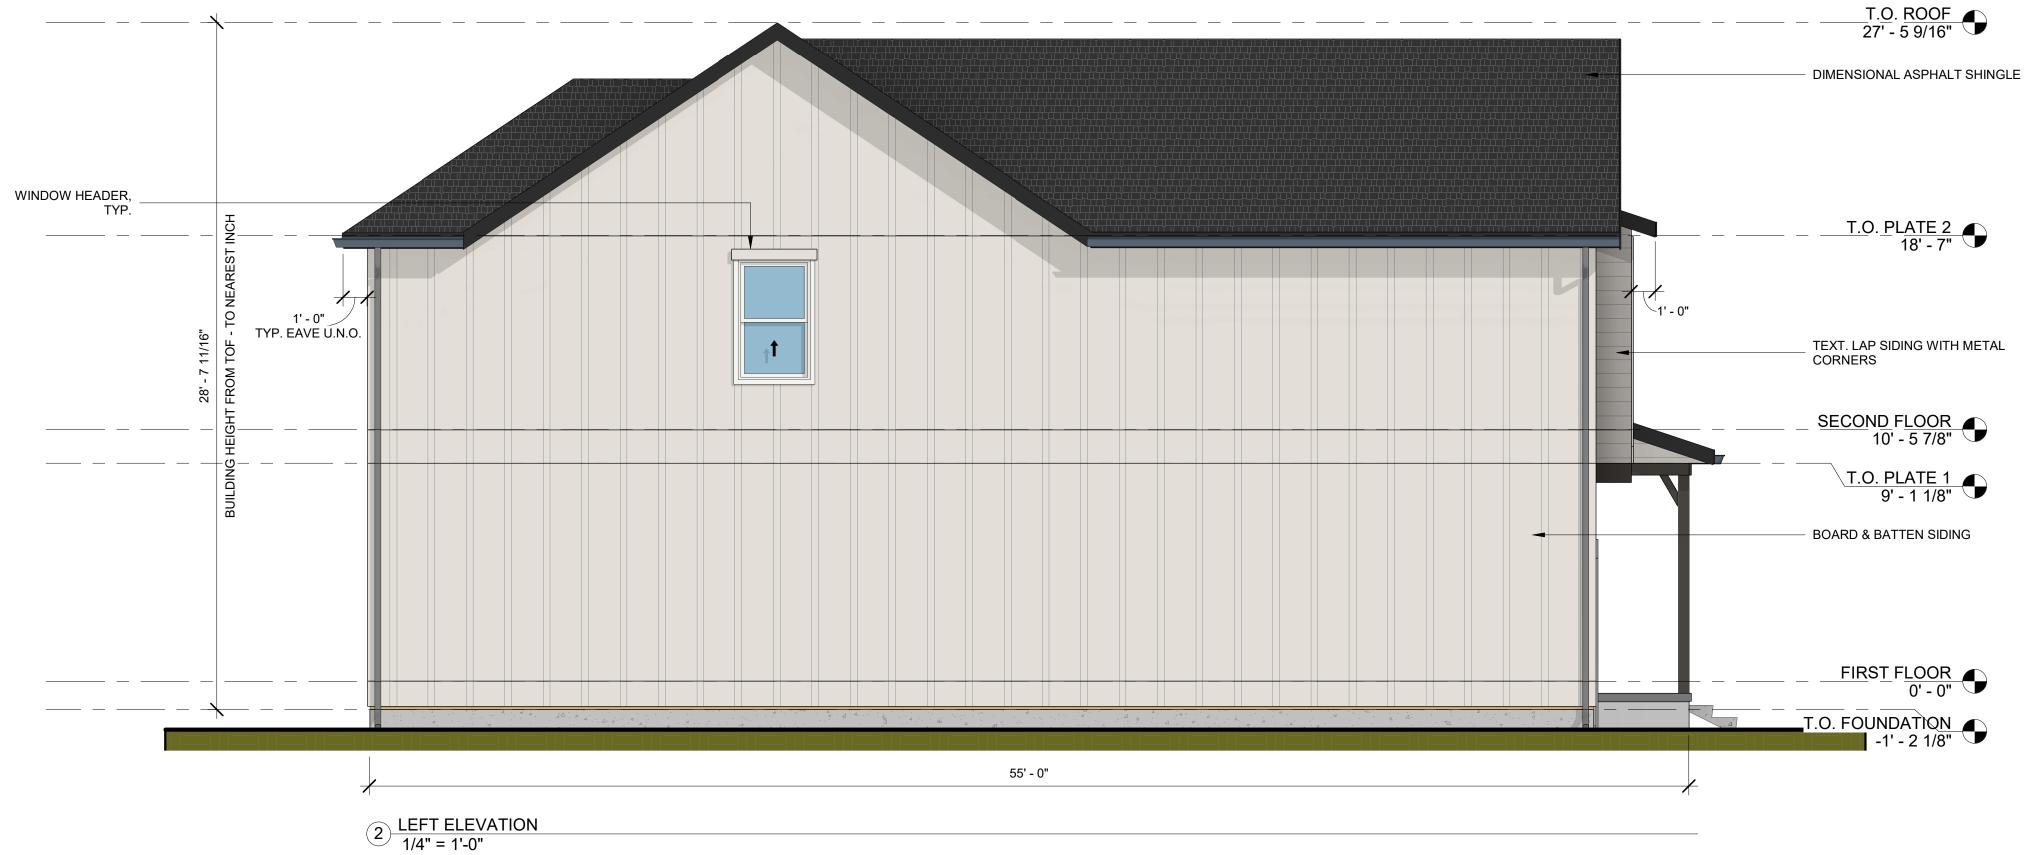





### HARTFORD HOMES PLAN 6 - TWAIN

NOTE: PRELIMINARY ARCHITECTURAL RENDERINGS -FINAL DESIGN SUBJECT TO CHANGE

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No.	Description	Date

### **BUILDING ELEVATIONS** -TWAIN FARMHOUSE

Product Type	
Date	
Drawn by	
Checked by	


35FT
10/06/2021
0.S.
AM/DW



Scale





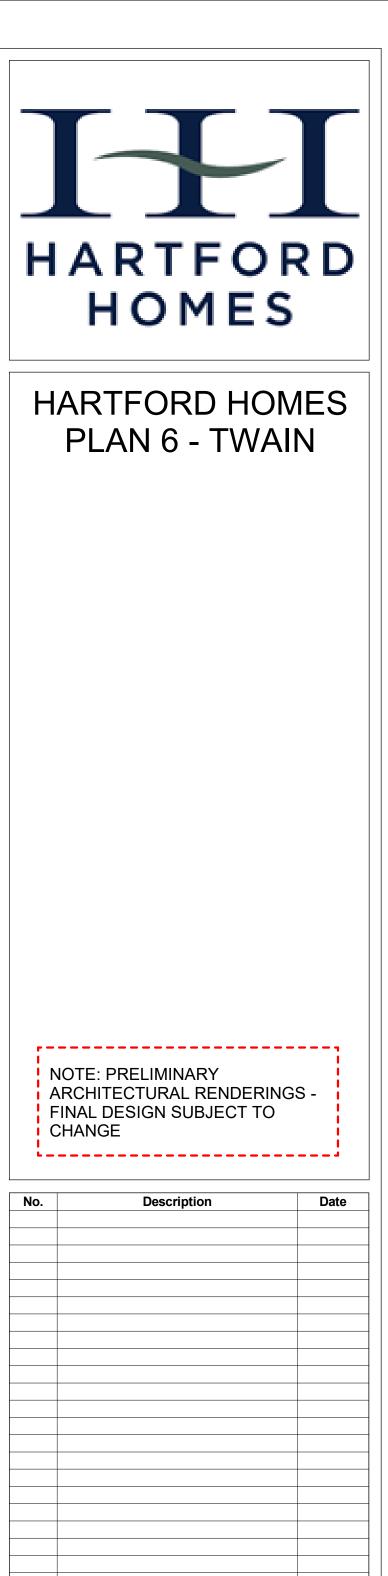


### **BUILDING ELEVATIONS** -TWAIN FARMHOUSE

Product Type	35FT
Date	10/06/2021
Drawn by	OS
Checked by	AM/DW




Scale

1/4" = 1'-0"

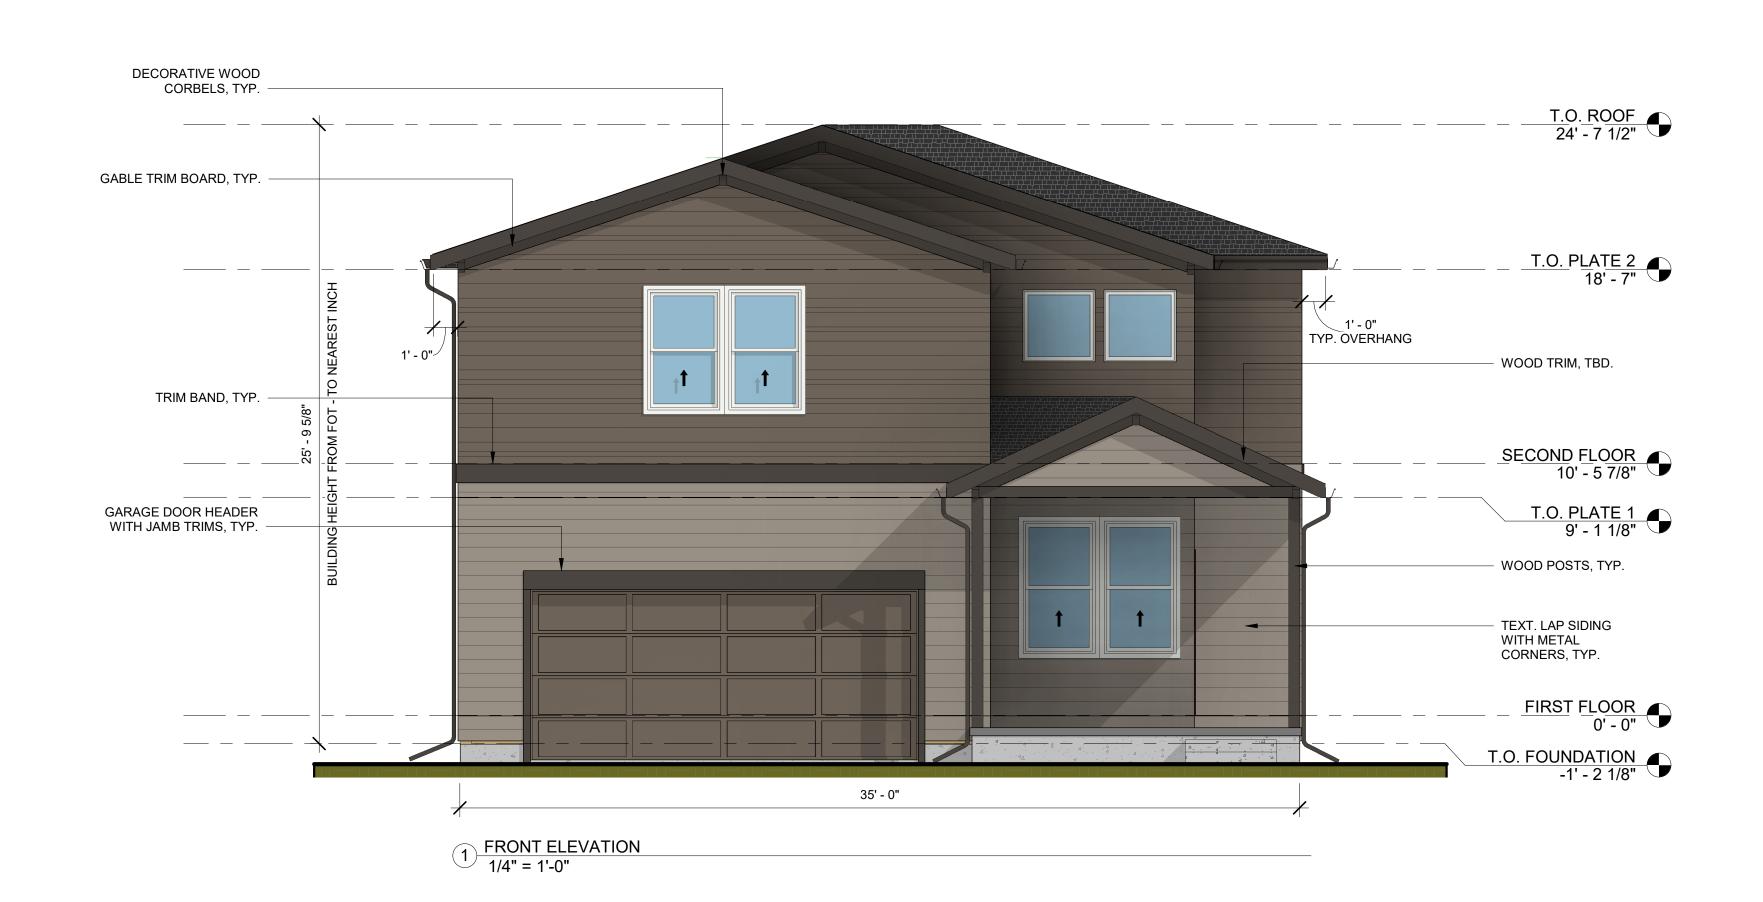



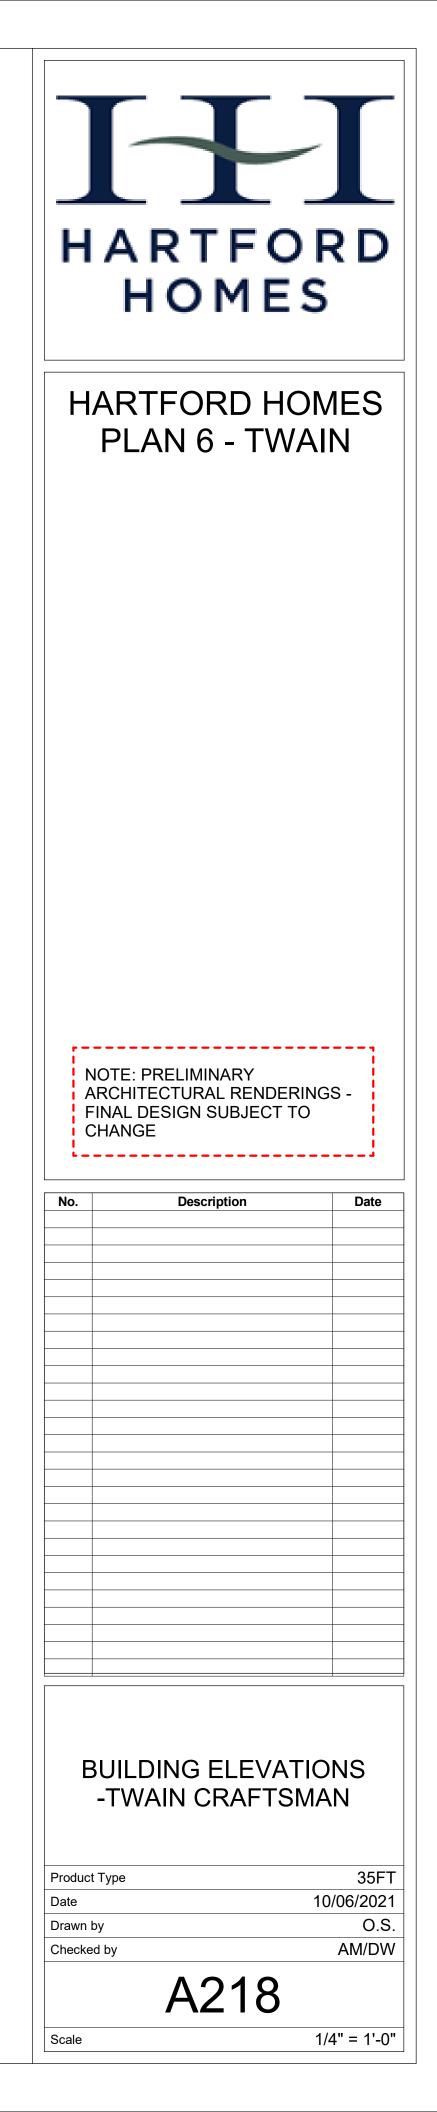

T.O. ROOF 24' - 7 1/2"

<u>T.O. PLATE 2</u> 18' - 7"

T.O. PLATE 1 9' - 1 1/8"

FIRST FLOOR 0' - 0"

