

A wide-angle, aerial photograph of a long wooden pier extending from a sandy beach into the ocean. The pier is supported by numerous vertical wooden pilings and features several small buildings with blue roofs along its length. The ocean water is a vibrant turquoise color, with white-capped waves crashing onto the shore. The sky is a dramatic mix of blue, orange, and yellow, suggesting a sunset or sunrise. The beach is mostly empty, with a few small structures and a paved walkway visible near the water's edge.

451 Ocean Drive

Building Plans





PATTY AND TOM KELLEY 451 OCEAN DRIVE, JUNO BEACH, FL 33408

SHEET	DESCRIPTION		
	COVER SHEET		
A0	SITE PLAN		
A1	FIRST FLOOR PLAN		
A2	SECOND FLOOR PLAN		
A3	ELEVATIONS		
A4	ELEVATIONS		
A5	ROOF PLAN		

BUILDING DESIGN DATA

CODES:	FLORIDA RESIDENTIAL BUILDING CODE 2023 8TH EDITION - RESIDENTIAL ENERGY CONSERVATION, PLUMBING, MECHANICAL AND ELECTRICAL NEC NATIONAL ELECTRIC CODE 2023, NFPA 70 NFPA FL. FIRE PREVENTION CODE 8th ED. CARBON MONOXIDE DETECTORS REQUIREMENTS PER FL ADMINISTRATIVE CODE RULE 9B-3.0472 ACI 318-19 ASTM 47th. ED. E1527-21
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DESIGN CRITERIA

CITY/COUNTY	JUNO BEACH, PALM BEACH, FL
OCCUPANCY GROUP	R-3
NUMBER OF STORIES	2
BUILDING CATEGORY	ENCLOSED
BASIC WIND SPEED, MPH	170
WIND IMPORTANCE FACTOR	1.0
WIND EXPOSURE FACTOR	C
INTERNAL PRESSURE COEFFICIENT	+/- .18
MINIMUM SOIL PRESSURE, PSF	2500
FLOOR LOAD, PSF	65
ROOF DEAD LOAD, PSF	25
ROOF LIVE LOAD, PSF	30
CONSTRUCTION TYPE	VB UNPROTECTED


OWNER:
PATTY AND TOM KELLEY
451 OCEAN DRIVE
JUNO BEACH, FL 33408

ARCHITECT:
ARISE ARCHITECTURE LLC
13901 US-1 #2, JUNO BEACH, FL
33408

STRUCTURAL ENGINEER:
ADAM GINSBERG, P.E.
2901 CLINT MOORE RD #237
BOCA RATON, FL 33496

CONTRACTOR:
FIRST PREMIER HOMES
725 N A1A
SUITE C111 JUPITER, FL 33477

SITE DATA TABLE

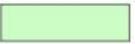SITE DATA TABLE	
BUILDING FOOTPRINT	4,262 SQ FT
1ST FLOOR AREA	3,107 SQ FT
GARAGE AREA	1,155 SQ FT
TOTAL SITE AREA	13,291 SQ FT
25% LANDSCAPE AREA = 3,323 SF PROVIDE = 3,500 SF	
LANDSCAPE AREA =	

ZONING REQUIREMENT

PER THE CITY OF JUNO BEACH

	REQUIRED	PROVIDED
MINIMUM FRONT SETBACK	25'-0"	25'-0"
MINIMUM SIDE SETBACK	10'-0"	12'-6"
MINIMUM SIDE SETBACK (OCEAN DR.)	20'-0"	22'-6"
MINIMUM REAR SETBACK	10'-0"	10'-0"
MAXIMUM HEIGHT: 2-STORIES	30'-0"	25'-10"
MAXIMUM COVERAGE	35%: 4,652 SF	4,262 SF
MAXIMUM BUILDING DIM	100'-0"	100'-0"
MINIMUM LANDSCAPE AREA	25%: 3,323 SF	3,500 SF
MINIMUM PARKING REQUIRED	2 SPACES	4 SPACES



ARISE ARCHITECTURE

www.arisearch.com

ARISE ARCHITECTURE, LLC
561.864.3719 TEL
www.arisearch.com

451 OCEAN DRIVE

PROJECT FOR:
**PATTY AND
TOM KELLEY**
451 OCEAN DRIVE, JUNO BEACH, FL
33408

SEAL/SIGNATURE/DATE:
LICENSE #: AR103314

PROJECT NUMBER: 20250501

TO THE BEST OF MY KNOWLEDGE AND BELIEF, THESE PLANS AND SPECIFICATIONS COMPLY WITH THE MINIMUM REQUIREMENTS OF THE APPROPRIATE LOCAL BUILDING STANDARDS AS DETERMINED BY LOCAL AUTHORITY IN ACCORDANCE WITH THE APPROPRIATE LOCAL BUILDING CODE AND CHAPTER 633, FLORIDA STATUTES.

TO THE BEST OF THE STRUCTURAL ENGINEERS' KNOWLEDGE, THESE PLANS AND SPECIFICATIONS COMPLY WITH THE APPLICABLE FIRE-SAFETY STANDARDS AS DETERMINED BY LOCAL FIRE AUTHORITY IN ACCORDANCE WITH CHAPTER 633, FLORIDA STATUTES.

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No. Description Date


NOT FOR CONSTRUCTION

ELEVATIONS

Date AUG 20, 2025
Drawn By MLY
Checked By CL

A3

Scale As indicated

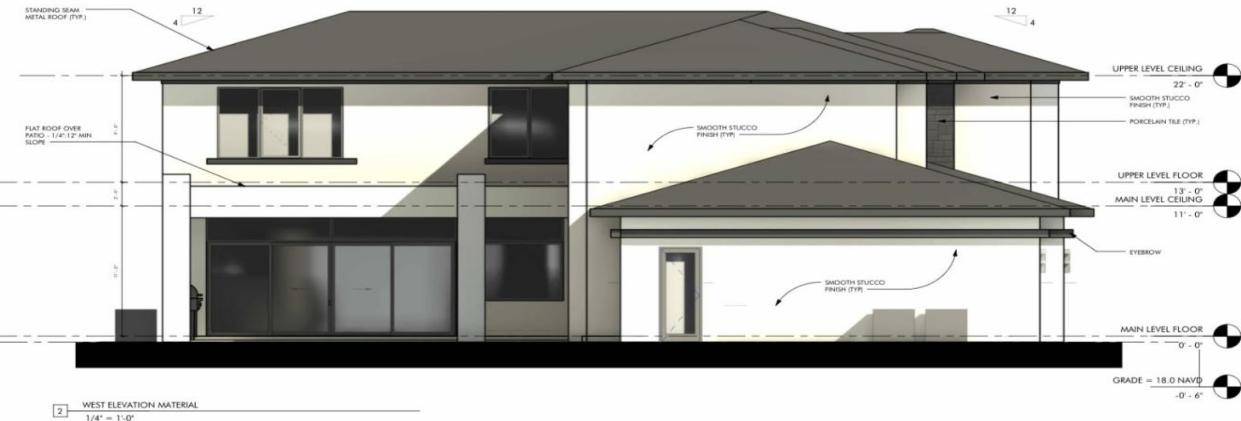



2 EAST ELEVATION MATERIAL
1/4" = 1'-0"

NOT FOR CONSTRUCTION

ELEVATIONS

Date AUG 20, 2025
Drawn By MLY

A4

As indicated



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561.866.2719 TEL
www.arisearch.com

451 OCEAN DRIVE

PROJECT FOR:

SEAL/SIGNATURE/DATE:
LICENSE #: AR103314

REPORT NUMBER: 20210201

TO THE BEST OF MY KNOWLEDGE AND BELIEF, THESE PLANS AND SPECIFICATIONS COMPLY WITH THE MINIMUM BUILDING CODES AND THE APPLICABLE FIRE-SAFETY STANDARDS AS DETERMINED BY LOCAL AUTHORITY IN ACCORDANCE WITH SECTION 110, FLORIDA BUILDING CODE AND CHAPTER 633, FLORIDA STATUTES.

TO THE BEST OF THE STRUCTURAL ENGINEERS KNOWLEDGE, THE PLANS AND SPECIFICATIONS COMPLY WITH THE APPLICABLE FIRE-SAFETY STANDARDS AS DETERMINED BY THE LOCAL AUTHORITY IN ACCORDANCE AND CHAPTER 633, FLORIDA STATUTES.

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ELEVATIONS

Date AUG 20, 2025
Drawn By MLY


A4

As indicated

A wide-angle, aerial photograph of a long wooden pier extending from a sandy beach into the ocean. The sky is filled with dramatic, colorful clouds at sunset. The water is a vibrant turquoise color. A small, white lifeguard stand is visible on the beach. The pier has several small buildings or houses on it. The overall scene is peaceful and scenic.

Landscape Plans

Designer:
Drawn:
Job
Number:
Date:
Revision:

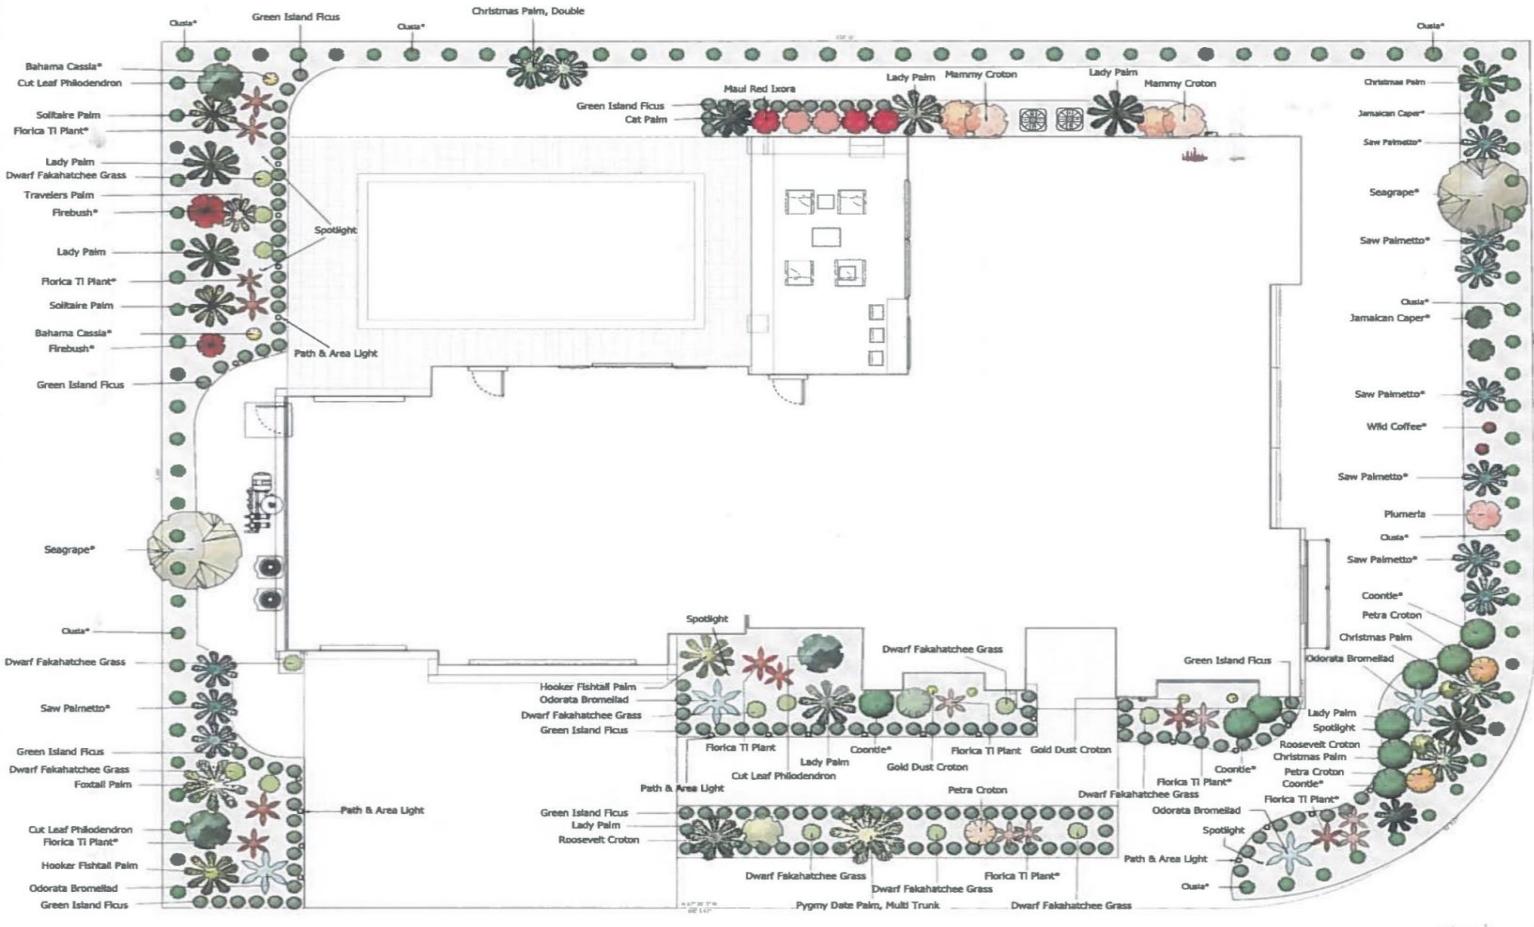

BUILD PLAN

$$\frac{3}{16}'' =$$

Native Plant Legend	
Native Plant	Non-native/Invasive
 1. Yellow Aster	Native/Invasive
 2. Purple Aster	Native/Invasive
 3. Red Aster	Native/Invasive
 4. White Aster	Native/Invasive
 5. Blue Aster	Native/Invasive
 6. Yellow Coneflower	Native/Invasive
 7. Purple Coneflower	Native/Invasive
 8. Red Coneflower	Native/Invasive
 9. White Coneflower	Native/Invasive
 10. Yellow Coreopsis	Native/Invasive
 11. Purple Coreopsis	Native/Invasive
 12. Red Coreopsis	Native/Invasive
 13. White Coreopsis	Native/Invasive
 14. Yellow Goldenrod	Native/Invasive
 15. Purple Goldenrod	Native/Invasive
 16. Red Goldenrod	Native/Invasive
 17. White Goldenrod	Native/Invasive
 18. Yellow Tickseed	Native/Invasive
 19. Purple Tickseed	Native/Invasive
 20. Red Tickseed	Native/Invasive
 21. White Tickseed	Native/Invasive

1999, the company's sales were \$1.1 billion, up 10% from 1998. The company's market share in the U.S. market is 10.5%.

Ergonomics and ergonomics training

the 1990s, the number of people in the United States with HIV/AIDS increased by 50 percent, and the number of deaths from AIDS increased by 100 percent.

Journal of Health Politics, Policy and Law, Vol. 31, No. 2, March 2006
DOI 10.1215/03616878-31-2 © 2006 by the Southern Political Science Association

1992 konstituerte sich eine Gruppe von 14 von 2000 Menschen, die in den USA lebten, die sich als "jüdisch" bezeichneten.

MEASURING GENDER INEQUALITY IN THE LABOR MARKET: THE CASE OF CHINA

THEY DON'T THINK IT'S FUN, THEY DON'T THINK IT'S FUN, THEY DON'T THINK IT'S FUN, THEY DON'T THINK IT'S FUN.

111

Environ Sci

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33405

OAK (561) 933-7446

Property Description:
PCN 00-42-47-07-16-003

-0070



Our Design Group
West Palm Beach, FL
33405

OAK
Deutsch Group

Designer:	Modi
Drewn:	ARC
Job	N/A
Number:	
Date:	8/7/25
Revision:	0


BUILD PLAN

**3/16" =
1 ft**

Property Description:
PCN 00-42-47-07-16-003
-0070


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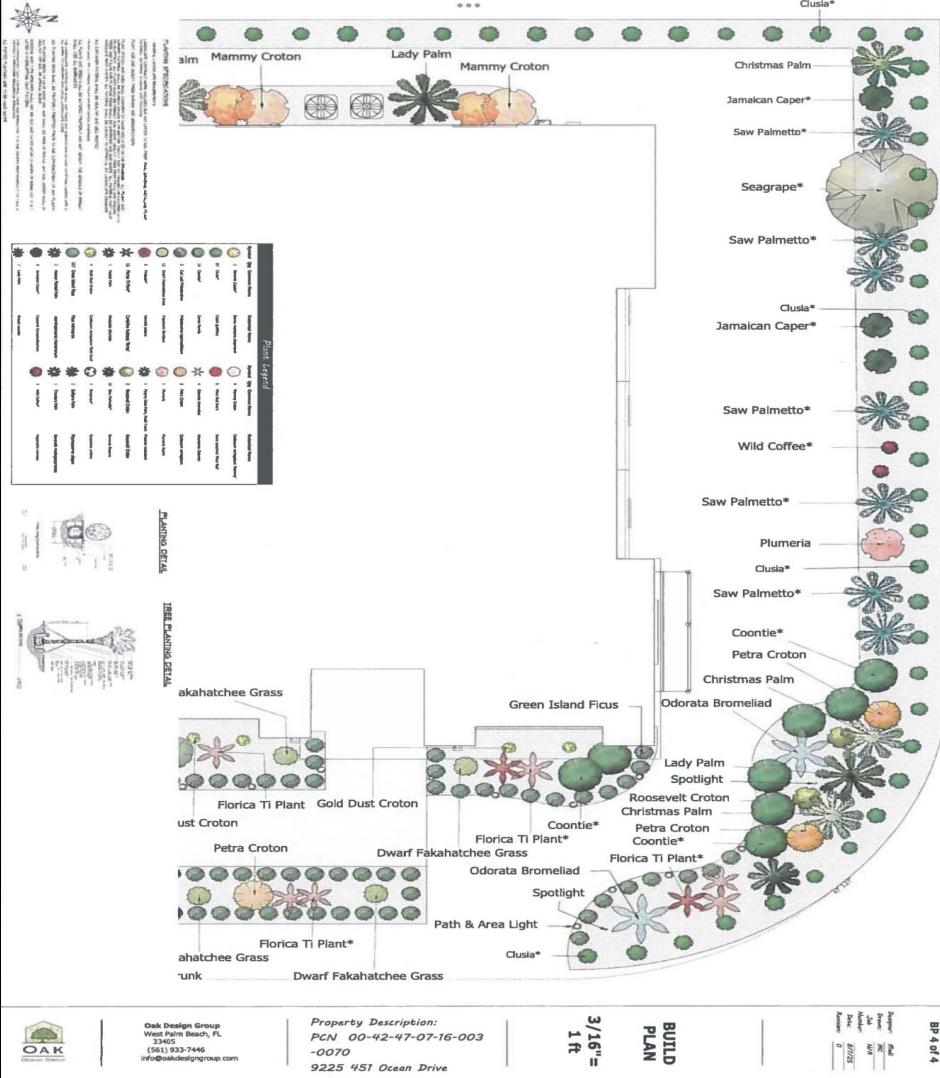
第二部分：数据挖掘与机器学习

1. 11月號 2013

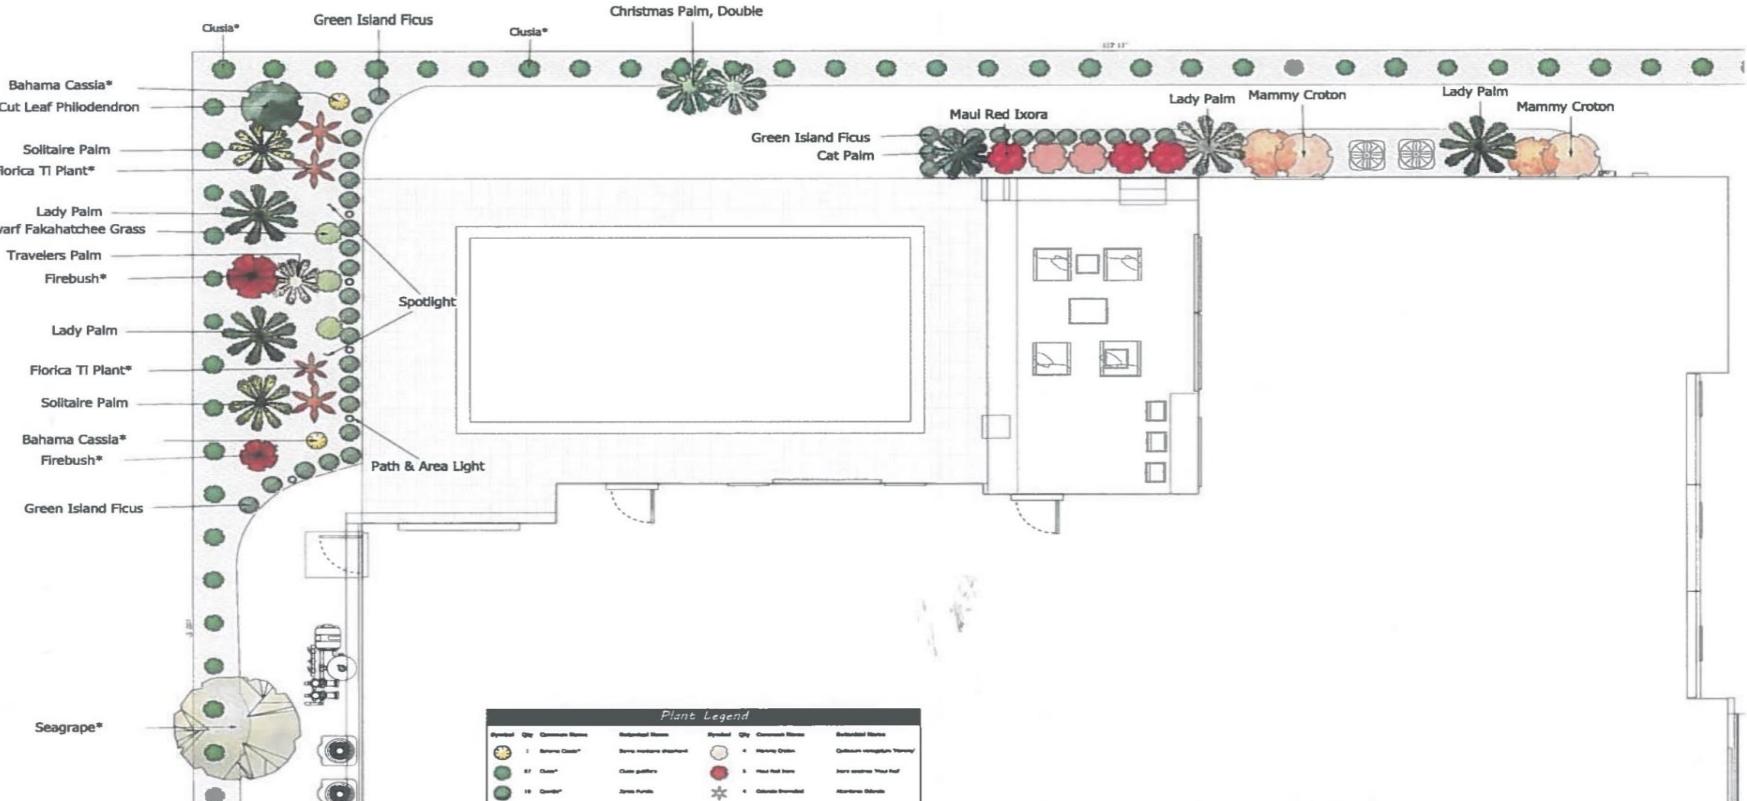

REFILLING RECIPIES



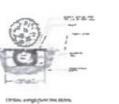

Oak Design Group
 West Palm Beach, FL
 33401
 (561) 933-7446
 info@oakdesigngroup.com

A wide-angle, aerial photograph of a coastal scene at sunset. The sky is filled with wispy, colorful clouds in shades of blue, yellow, and orange. Below, a long, wooden pier extends from a small beach area into the ocean. The ocean water is a vibrant turquoise color with white-capped waves crashing onto the shore. The beach is sandy and appears relatively empty. In the foreground, there's some green vegetation and a small, white, gabled-roof structure, possibly a lifeguard station or a small beach house. The overall atmosphere is peaceful and scenic.


Lot Considerations

- Total Proposed Building Footprint is 4,262 Square Feet
 - Equating to 32.1% lot coverage, 2.9% less than the maximum lot coverage restriction
- As seen on the previous slides, great consideration has been given to privacy to the Western and Northern Neighbors, since no neighbors are to the East.
- Decreased privacy concerns from neighboring lots by not creating a living structure above the garage on the East, eliminating any windows on the 2nd floor north side of the primary bedroom, as well as no sidewalk on the east side of the lot.
- Greatly enhancing the landscaping to provide privacy and to increase visual appeal to the community. Excess expense of \$100,000 plus.


Community Statistics



Year of the Homes the Town of Juno Beach Used as Comparables

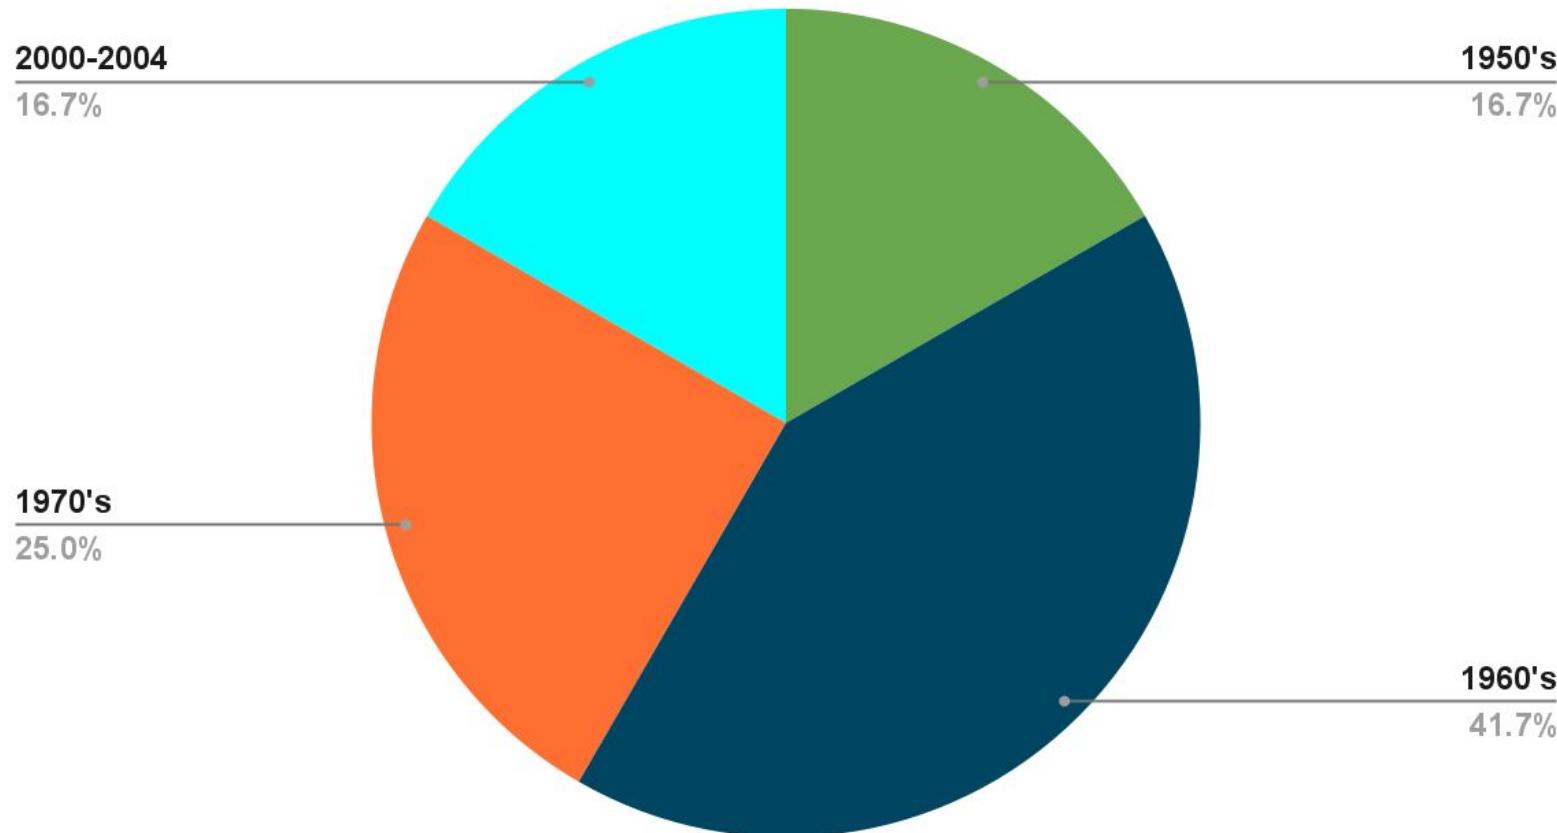

- The Majority of the homes are built between 1959-1974
- The total square foot average of the homes are 2,969 sq ft
- Homes approved to build in the comparisons from 2004-2025, excluding the subject property, are averaging 5,386 square feet.
- The newly approved to build homes are 370 Apollo at 5,255 sq ft and having a .39 FAR and 401 Diana Lane at 5,421 sq ft and having a .55 FAR.
- The homes NOT being considered as a comparable due to a zoning difference, but are of like build, are 381 Ocean Drive, total land 11,264.62 sq ft, total building sq ft of 6,715 and 571 Ocean Drive total land 10,053 sq ft, total building sq ft of 9138.

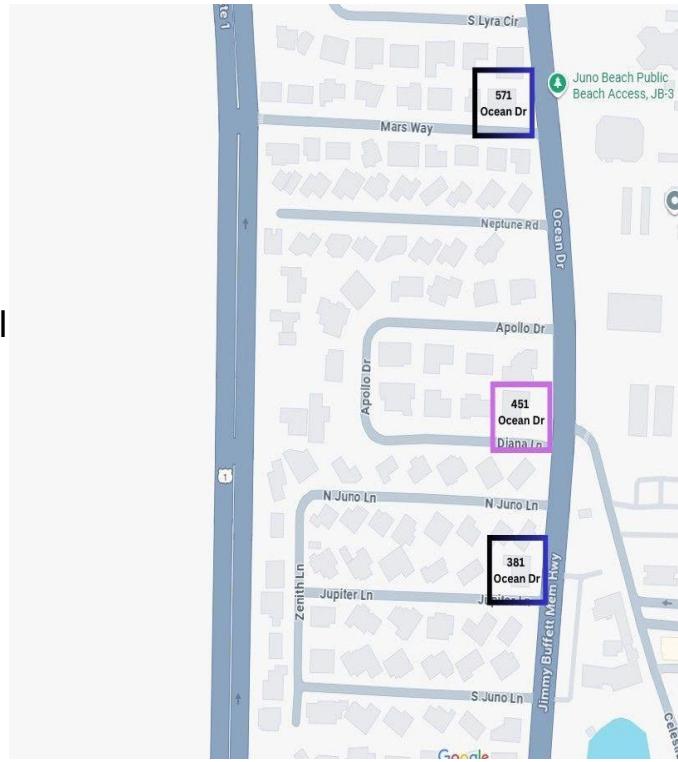

Lot Sizes of Homes Within the Proximity of the Subject Property



A wide-angle, aerial photograph of a long wooden pier extending from a sandy beach into the ocean. The pier is supported by numerous vertical wooden posts and features several small buildings or sheds along its length. The ocean water is a vibrant turquoise color, with white-capped waves crashing onto the shore. The sky is a dramatic mix of blue, orange, and yellow, suggesting a sunset or sunrise. The overall scene is peaceful and scenic.

Reasons to Approve

Testimonial From The Architect

“The Mass of this building is broken up to created a thoughtful and interesting facade.

What distinguishes this design from the large, boxy modern houses we've seen approved in the past is the way the massing has been carefully broken down into distinct, readable volumes. Rather than presenting a single monolithic block, this home is composed of interlocking forms that step forward and back, creating depth, shadow, and interest.

The garage wing, for example, is set apart and steps forward, giving hierarchy and balance while allowing the entry volume to stand as a focal point. The central two-story glass element framed by vertical columns adds proportion and anchors the composition, while the interplay of horizontal rooflines and vertical openings ensures that no single element overwhelms the whole.

Material choices further reinforce this balance. The use of lighter stucco against darker stone creates contrast that clearly defines volumes and prevents the home from reading as one large mass. This creates a relationship between the different parts of the building that is both harmonious and dynamic.

Overall, the design provides variety, articulation, and a more human scale, avoiding the flatness and bulkiness that have sometimes characterized more box-like modern houses. This approach results in a home that feels refined, approachable, and visually balanced within its setting.”

- The proposed build complies with ALL setbacks, height restrictions and lot coverage.
- Architecture and style have been carefully considered to include stone, scored stucco, banded stucco, and recessed elements.
- We have worked closely with the Town of Juno Beach Staff to outline elements and mindful changes to provide the Architectural Review Board positive consideration of the application. Such as, providing additional landscaping, mindful orientation of the second story, and diversity of building materials to provide visual interest.