
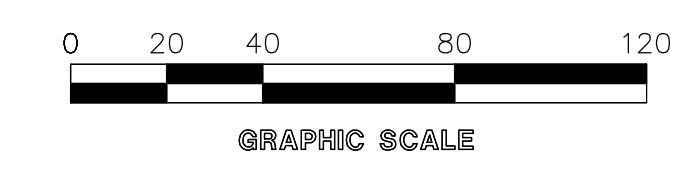
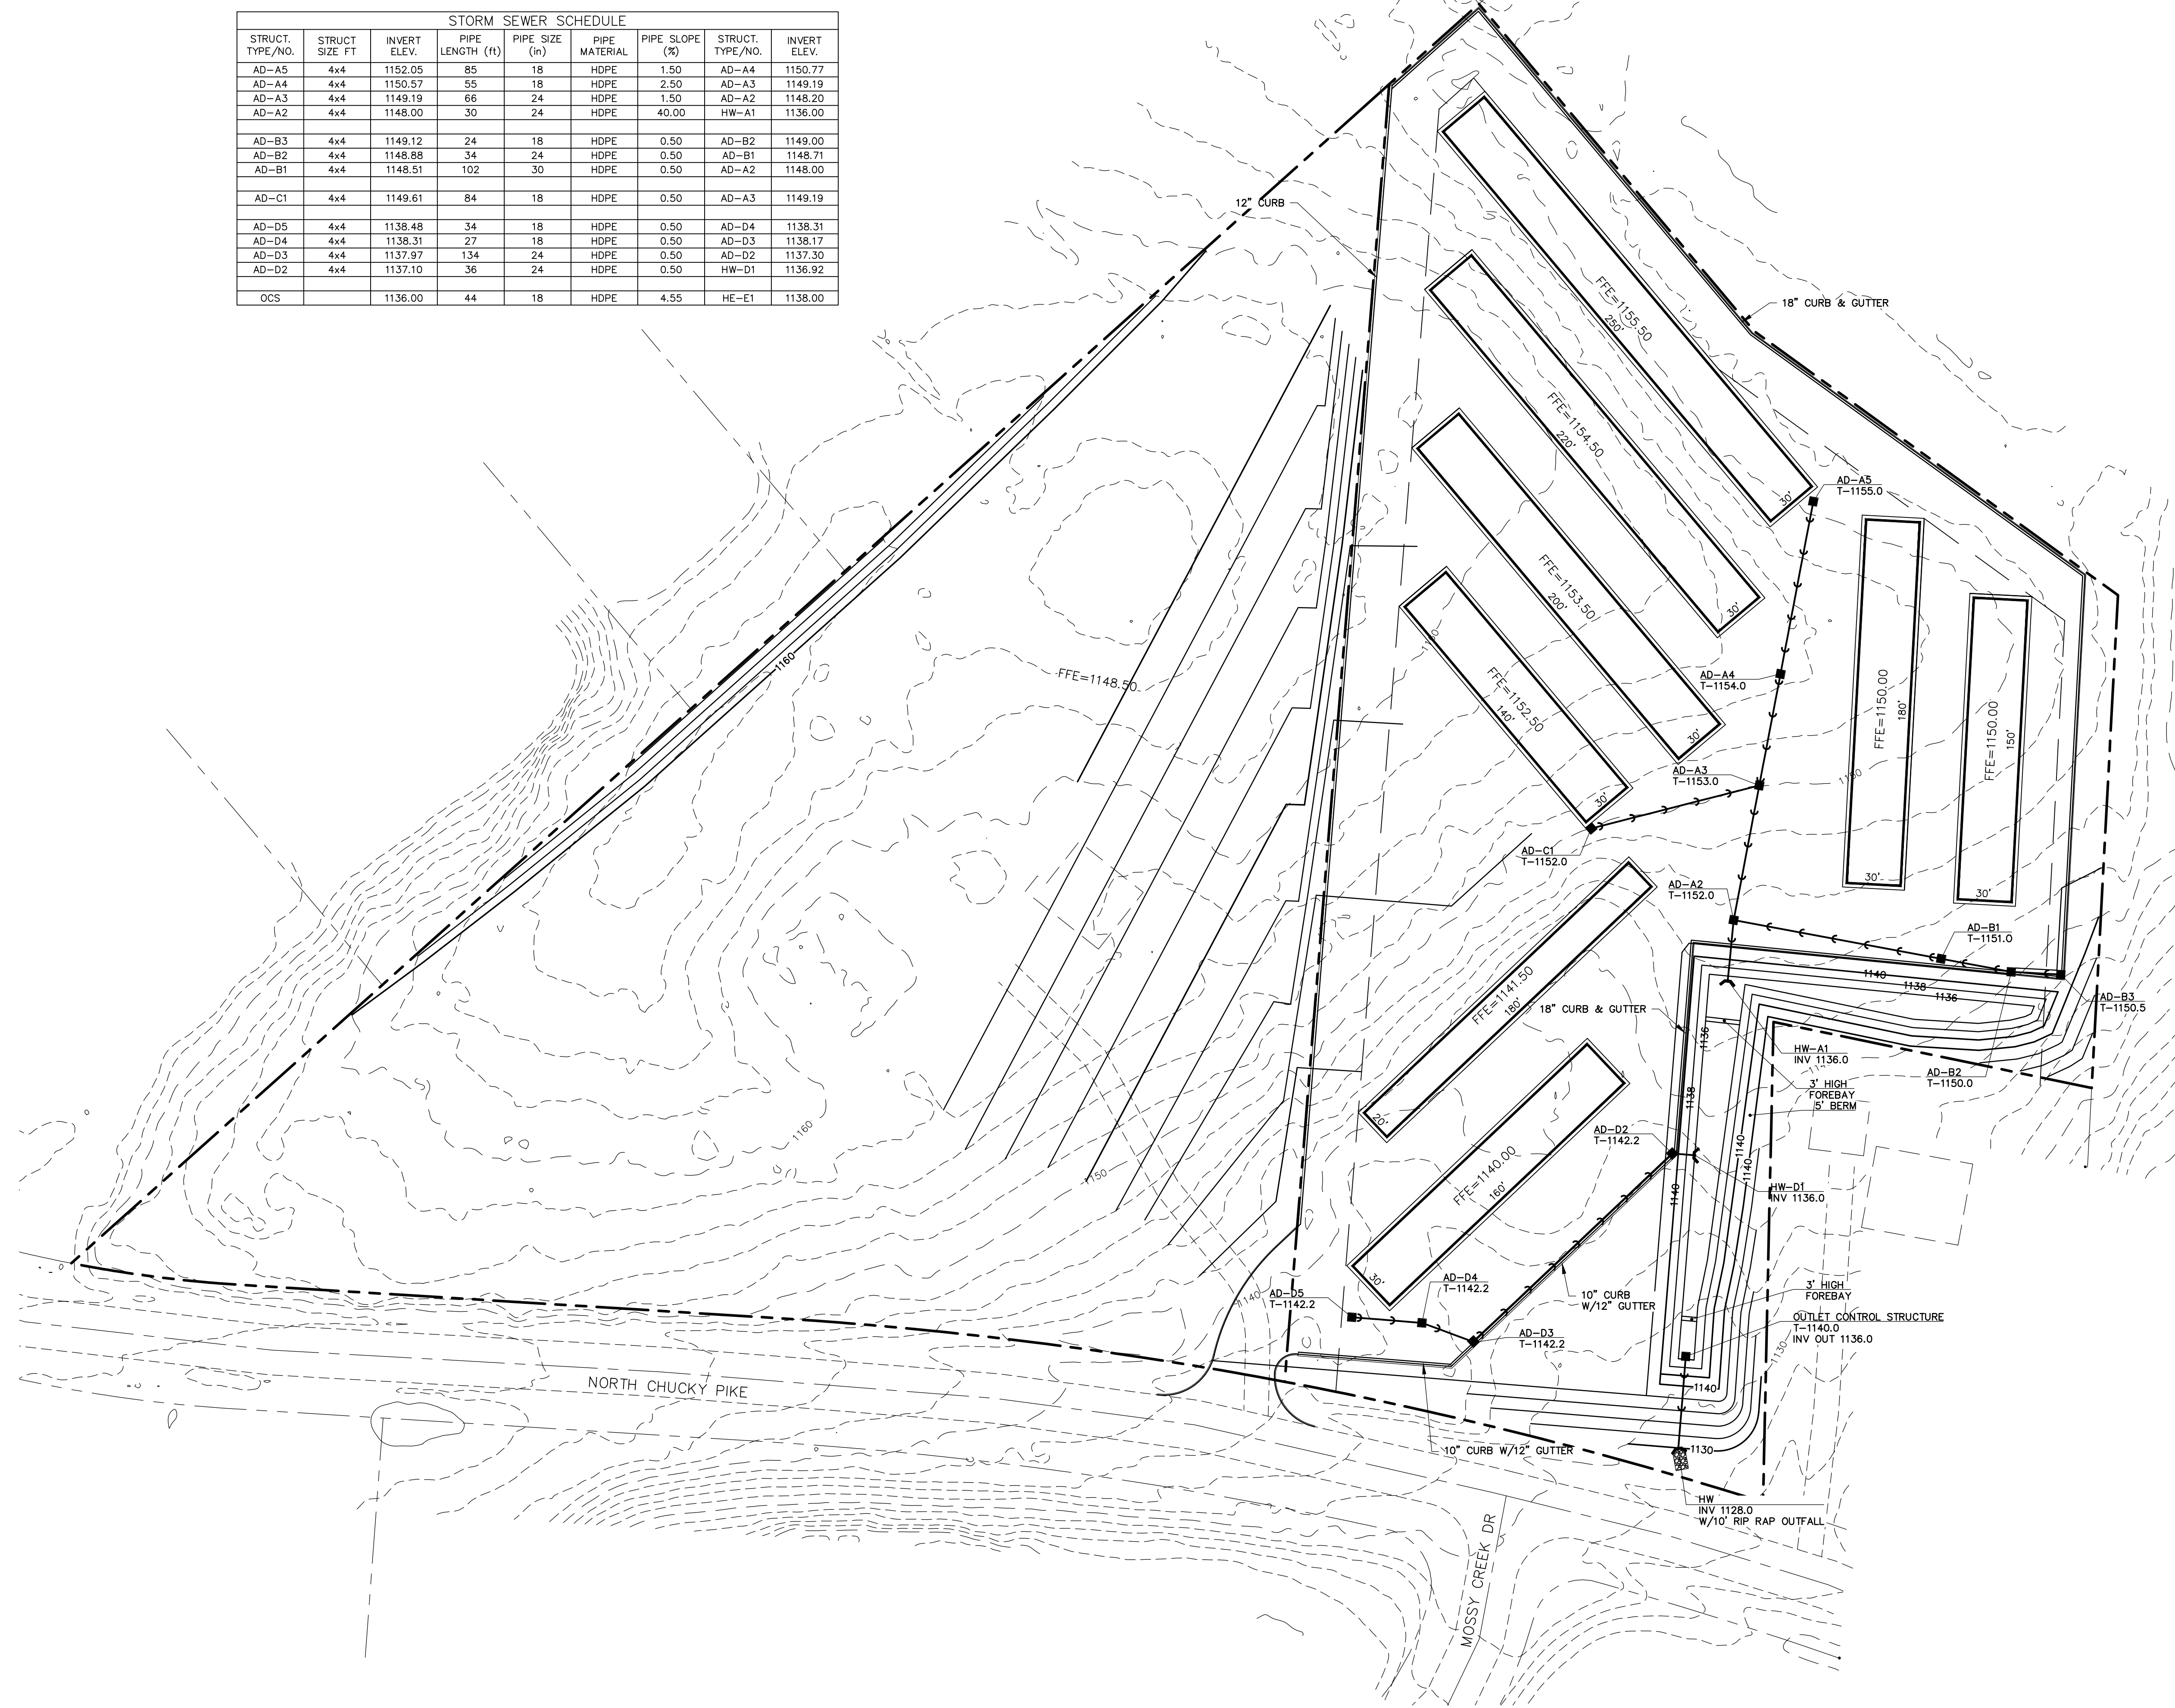



STORM SEWER SCHEDULE									
STRUCT. TYPE/NO.	STRUCT. SIZE FT	INVERT ELEV.	PIPE LENGTH (ft)	PIPE SIZE (in)	PIPE MATERIAL	PIPE SLOPE (%)	STRUCT. TYPE/NO.	INVERT ELEV.	
AD-A5	4x4	1152.05	85	18	HDPE	1.50	AD-A4	1150.77	
AD-A4	4x4	1150.57	55	18	HDPE	2.50	AD-A3	1149.19	
AD-A3	4x4	1149.19	66	24	HDPE	1.50	AD-A2	1148.20	
AD-A2	4x4	1148.00	30	24	HDPE	40.00	HW-A1	1136.00	
AD-B3	4x4	1149.12	24	18	HDPE	0.50	AD-B2	1149.00	
AD-B2	4x4	1148.88	34	24	HDPE	0.50	AD-B1	1148.71	
AD-B1	4x4	1148.51	102	30	HDPE	0.50	AD-A2	1148.00	
AD-C1	4x4	1149.61	84	18	HDPE	0.50	AD-A3	1149.19	
AD-D5	4x4	1138.48	34	18	HDPE	0.50	AD-D4	1138.31	
AD-D4	4x4	1138.31	27	18	HDPE	0.50	AD-D3	1138.17	
AD-D3	4x4	1137.97	134	24	HDPE	0.50	AD-D2	1137.30	
AD-D2	4x4	1137.10	36	24	HDPE	0.50	HW-D1	1136.92	
OCS		1136.00	44	18	HDPE	4.55	HE-E1	1138.00	

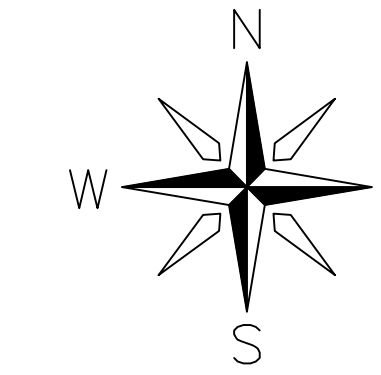

NUMBER	DESCRIPTION OF REVISION	DATE
1	REVISED GRADING PLAN	04-09-2026

**WELROC ENTERPRISES LLC**  
 Consulting · Development · Engineering  
 4944 COTTON WOOD LANE  
 MORRISTOWN, TENNESSEE, 37814

**GRADING & DRAINAGE PLAN**  
 NORTH CHUCKY PIKE  
 JEFFERSON CITY, TENNESSEE

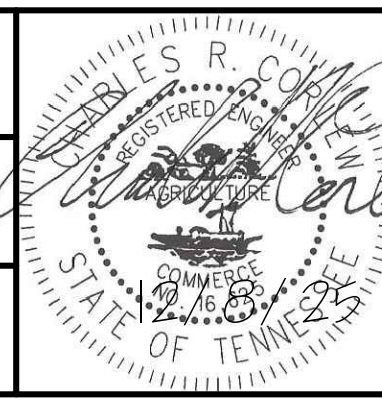

SCALE:	1" = 40'
DATE:	12/8/25
DRAWN BY:	SCH
CHECKED BY:	CRC
SHEET:	2 OF 8