D-R-HORTON® America's Builder

ORANGE COUNTY, FLORIDA

FLORIDA BUILDING CODE (FBCR) 2020 RES. 7TH EDITION

OCCUPANCY: RESIDENTIAL, R3 CONSTRUCTION TYPE: V-B UN-SPRINKLED

WIND DESIGN LOAD: 140 MPH EXP C MIN. INT. FINISH CLASS: "B"

SPECIFIC PARAMETERS FROM FBCR 2020 CH. R301 USED FOR DESIGN INCLUDE:

- CONCRETE MASONRY RESIDENTIAL CONSTRUCTION
- WOOD FRAME CONSTRUCTION MANUAL
- WOOD PRODUCTS PROMOTION COUNCIL • AMERICAN SOCIETY OF CIVIL ENGINEERS 7-16
- STATE OF FLORIDA CERTIFIED BUILDING CONTRACTOR:

•STATE OF FLORIDA PROFESSIONAL ARCHITECT:

ROLAND A. ABOUCHACRA AR NO 93723

A.B. DESIGN GROUP, INC. 1441 RONALD REAGAN NORTH LONGWOOD, FLORIDA 32750 Tel: (407) 774-6078 Fax: (407) 774-4078

GENERAL NOTES:

- ALL WORK SHALL CONFORM TO THE FLORIDA BUILDING CODE 2020 RESIDENTIAL PER SECTION R301 ASCE 7-10, BUILDING CODE AND ALL OTHER LOCAL APPLICABLE RULES AND REGULATIONS.
- . SUBCONTRACTORS SHALL VERIFY ALL CONDITIONS, DETAILS AND DIMENSIONS BEFORE PROCEEDING WITH THE WORK AND SHALL BE NOTIFIED OF ANY DISCREPANCIES.
- B. DO NOT SCALE DRAWINGS.
- . ALL WORK IN QUESTION INCLUDING MATERIALS, FINISHES AND COLORS SHALL BE COORDINATED WITH THE PROJECT
- MECHANICAL AND ELECTRICAL SUBCONTRACTORS SHALL BE RESPONSIBLE FOR SUBMITTING DRAWINGS AND OBTAINING THEIR RESPECTIVE PERMITS.
- . NUMBER SHALL BE DISPLAYED TO BE EASLIY SEEN FROM SHEET IN COLORS THAT CONTRAST TO BLDG.
- STRUCTURAL DESIGN OF BUILDING LOCATED WITHIN WIND-BORNE DEBRIS REGIONS AS PER 2020 FLORIDA BUILDING CODE, RESIDENTIAL FIGURE R301.2(4), PER SECTION R301 ASCE 7-16, BASIC WIND SPEEDS FOR 50-YEAR RECURRING INTERVAL, IS BASED ON ALL DOORS AND WINDOWS TO BE IMPACT RESISTANT MEETING THE REQUIREMENTS OF THE LARGE MISSILE TEST OF ASTM E 1996 AND OF ASTM E 1886 OR SUCH OPENINGS SHALL COMPLY WITH SECTION 1609 OF THE 2020 FLORIDA BUILDING CODE, BUILDING.

ADDRESS CRITERIA APPROVED NUMBERS OR ADDRESSES SHALL BE PROVIDED FOR ALL NEW BUILDINGS SO THAT THE NUMBER OR ADDRESS IS PLAINLY VISABLE AND LEGIBLE FROM THE STREET OR ROADWAY FRONTING THE PROPERTY. THE NUMBERS SHALL CONTRAST WITH THEIR BACKGROUND. ADDRESS NUMBERS SHALL BE ARABIC NUMERALS OR ALPHABET LETTERS. NUMERALS SHALL BE NOT LESS THAN THREE INCHES IN HEIGHT FOR RESIDENTIAL BUILDINGS, STRUCTURES, AND AT LEAST SIX INCHES IN HEIGHT FOR ALL OTHER BUILDINGS, STRUCTURES. FFPC 3-7.1

REVISIONS

REV.	DATE	DESCRIPTION	

BUILDING DESCRIPTION

OF UNITS CONFIGURED: 6 UNIT BUILDING

UNIT CONFIGURATION FROM

LEFT TO RIGHT:

UNIT "B"

UNIT "B"

UNIT "B"

UNIT "A"

STRUCTURAL LOADS:

FLOORS @ SLEEPING AREA-30PSF LIVE FLOORS @ NON-SLEEPING AREA-40PSF LIVE BALCONIES-60PSF LIVE 10PSF DEAD STAIRS-40PSF LIVE

ROOFS- W/ FIBERGLASS SHINGLES 20PSF LIVE 17PSF DEAD

ROOFS- W/ TILE 20PSF LIVE 25PSF DEAD

DESIGN CRITERIA:


- . ALLOWABLE UNIT STRESS AND DESIGN CRITERIA: A. BUILDING CODE REQUIREMENTS FOR REINFORCED CONCRETE ACI 318 B. FLORIDA BUILDING CODE 2020/RESIDENTIAL 7TH ED. AND ALL APPLICABLE LOCAL AND STATE CODES
- A. NET ALLOWABLE SOIL BEARING PRESSURE USED IN DESIGN 2000 PSF FOR CONTINUOUS WALL FOOTINGS.
- CONCRETE AND REINFORCING A. ALL CONCRETE WORK SHALL BE IN ACCORDANCE WITH ACI 318 AND WITH SPECIFICATIONS FOR STRUCTURAL CONCRETE BUILDING ACI 301.
- B. ALL CONCRETE SHALL DEVELOP MINIMUM COMPRESSIVE STRENGTH OF 3000 PSI IN 28 DAYS C. REINFORCING BARS SHALL CONFORM TO ASIM A615 A616 OR 617, GRADE 40
- A. IN ACCORDANCE WITH THE FLORIDA BUILDING CODE (FBCR) 2020/ RESIDENTIAL PER SECTION R301 ASCE 7-16 CHAPTER 16 ROOF LIVE LOADS OF 20 PSF, DEAD LOAD 17 PSF WIND LOADS IN ACCORDANCE WITH FBC, SECTION R301, 2020 EDITION FOR 140 MPH REGION, INTERIOR PARTITIONS PSF PERPENDICULAR TO WALL FACE.
- (DETERMINATION OF WIND FORCES AS PER FBCR 2020 7TH ED., SECTION R301) B. BASIC WIND SPEED MPH (M/S) = 140
- C. INTERNAL PRESSURE CO-EFFICENT=+ .18 D. BUILDING CATEGORY=II
- 5. LUMBER A. ALL STRUCTURAL LUMBER SHALL BE SOUTHERN YELLOW PINE #2 OR BETTER, UNLESS NOTED OTHERWISE. B. STRUCTURAL LUMBER CONSISTS (U.N.O) OF: RAFTERS, VERTICAL STRONGBACKS,
- LEDGERS, BEAMS, AND POSTS. C. ALL LUMBER EXPOSED TO WEATHER, OR AGAINST SOIL, CONCRETE OR MASONRY MUST BE PRESSURE TREATED.


6. TRUSSES

L. DESIGN LOADS

- A. PRE-ENGINEERED WOOD TRUSSES SHALL BE DESIGNED IN ACCORDANCE WITH FBC 2020/RESIDENTIAL 7TH EDITION. TRUSS MANUFACTURER SHALL SUBMIT SIGNED AND SEALED DRAWINGS FOR APPROVAL PRIOR TO FABRICATION. GARAGE DOOR
- A. ENGINEERED FOR 140 MPH 3 SEC. GUST MIN. WIND LOAD. B. DETAIL TO BE SUPPLIED BY GARAGE DOOR SUPPLIER C. DETAIL TO BE ATTACHED TO PERMIT PACKAGE BY BUILDER

INDEX OF DRAWINGS DESCRIPTION SHEET # CS ____ COVER SHEET ____ GENERAL NOTES F1.1 _____ FIRE PROTECTION PLAN F1.1A FIRE RATED WALL DETAILS F1.2A FIRE RATED WALL DETAILS _____ FIRST FLOOR PLAN A1A — VALE STAIR SECTION DETAILS A1B — GLEN STAIR SECTION DETAILS SECOND FLOOR PLAN BUILDING FRONT & REAR ELEVATIONS _____ BUILDING LEFT & RIGHT ELEVATIONS ____ UNIT SECTIONS _____ LONGITUDINAL CROSS SECTION ____ FIRST FLOOR ELECTRICAL PLAN _____ SECOND FLOOR ELECTRICAL PLAN _____ ELECTRICAL PANEL & RISER DIAGRAM P1 _____ FIRST FLOOR PLUMBING PLAN P3 _____ PLUMBING RISERS APPRODUCT APPROVALS PA PRODUCT APPROVALS ____ WALL SECTIONS DETAILS ____ WALL SECTIONS DETAILS DETAILS _ WALL ASSEMBLY DETAILS WALL ASSEMBLY DETAILS ____ WALL ASSEMBLY DETAILS WA4 ____ WALL ASSEMBLY DETAILS WA6 ____ WALL ASSEMBLY DETAILS S1 _____ FOUNDATION PLAN S1.1A _____ DETAILS S1.1B ____ DETAILS S1.1C ____ STEMWALL DETAILS S1.2 ____ FIRST FLOOR DOWEL PLAN S2 _____FIRST FLOOR LIFT BEAM PLAN S2.1A ____ DETAILS S2.2A ___ LINTEL SCHEDULE S3 ____ FIRST FLOOR FRAMING PLAN S3.1A ____ DETAILS S4 _____SECOND FLOOR DECK PLAN S4.2 ____ SECOND FLOOR DOWEL PLAN SECOND FLOOR LIFT BEAM PLAN ROOF FRAMING PLAN SN1 ____ DETAILS SFD1 ____ SOFFIT INFORMATION BY OTHERS SFD2 ____ SOFFIT INFORMATION BY OTHERS

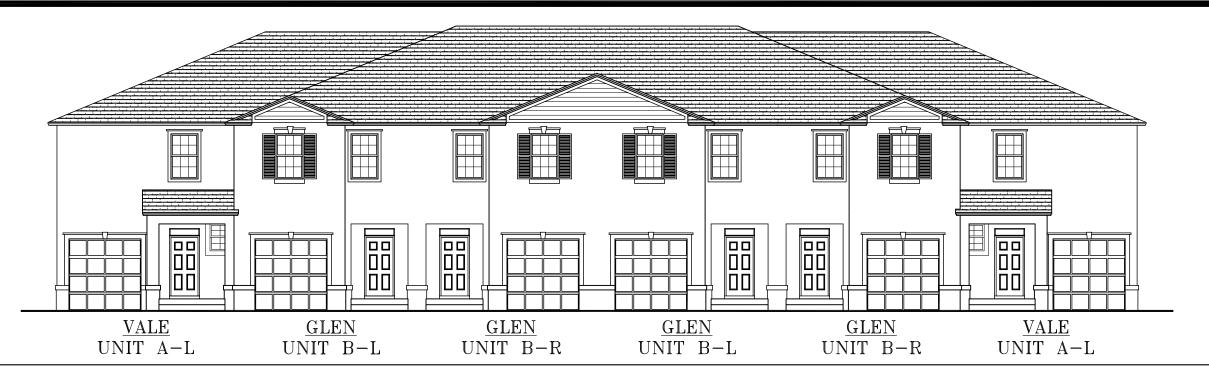

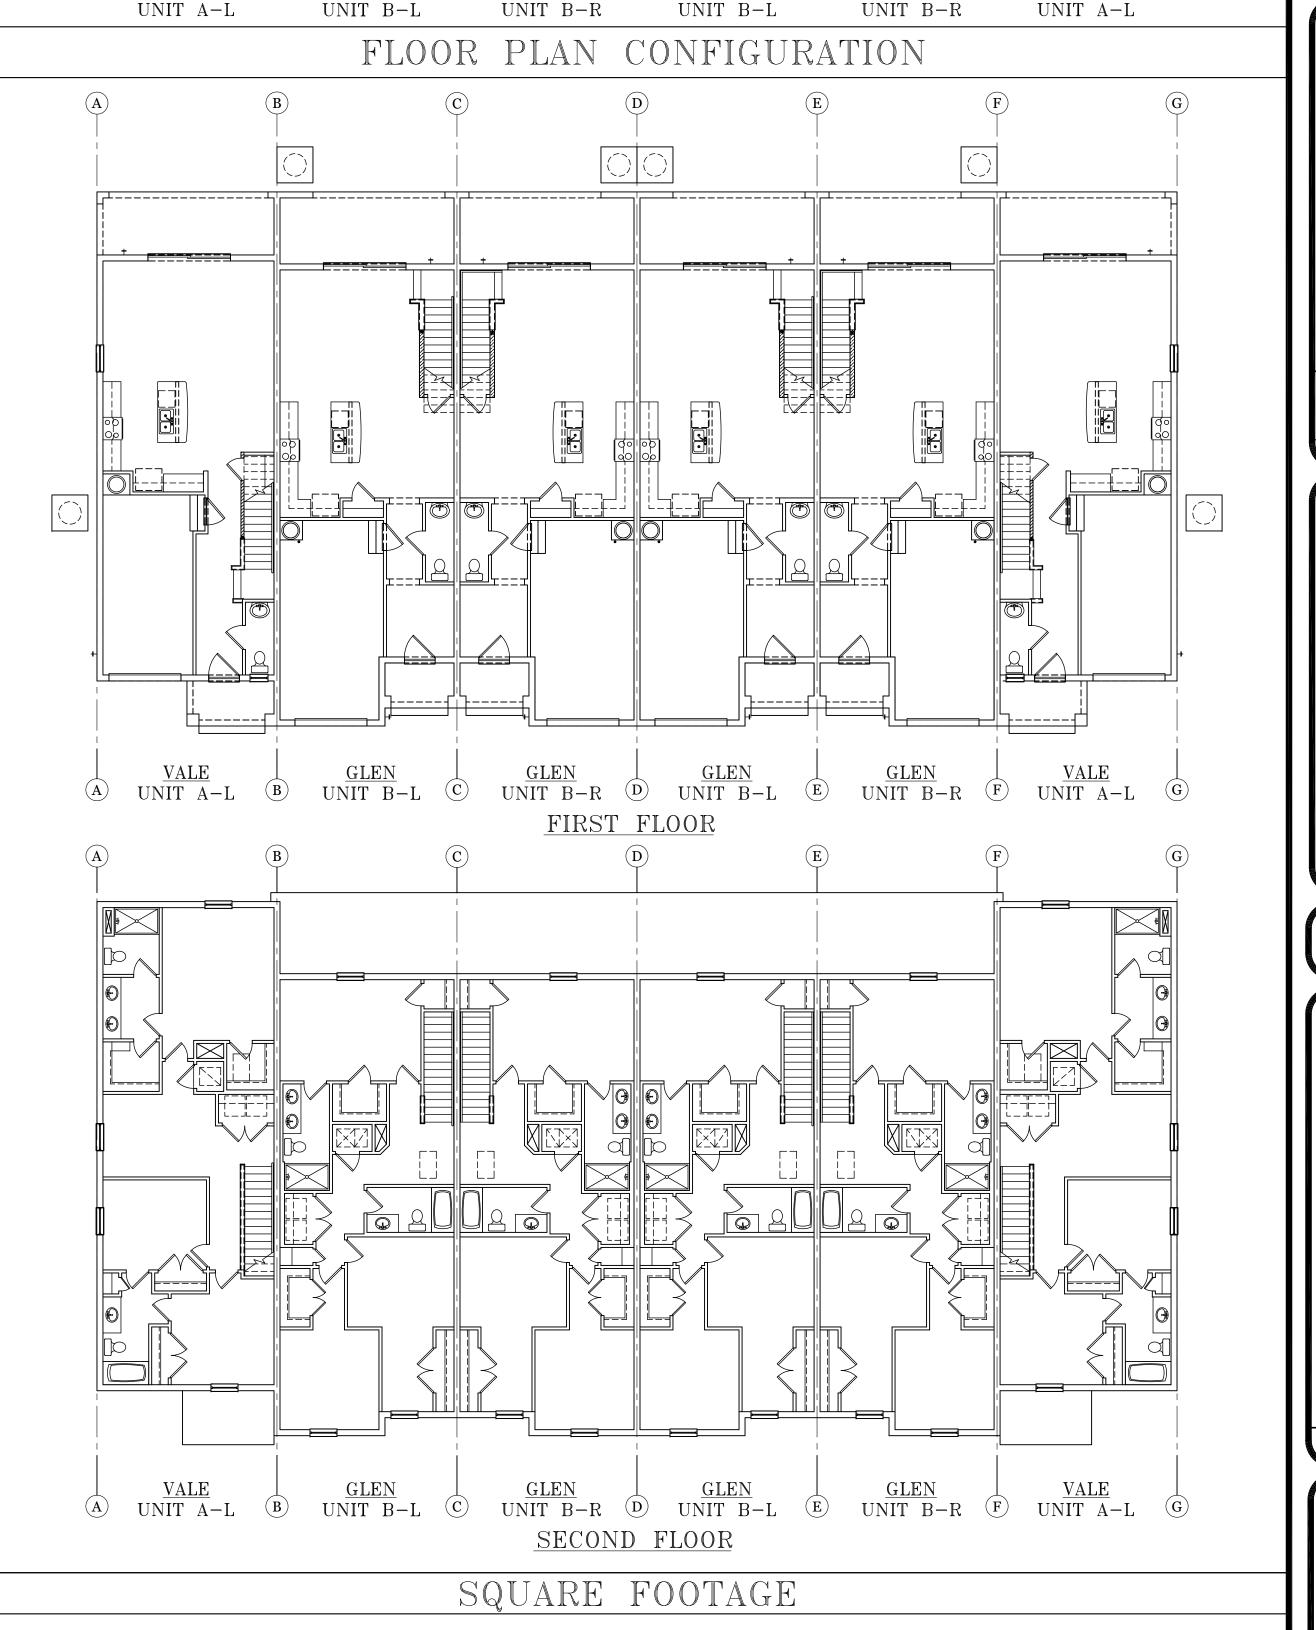

SQ.FT. CALC.'S GLEN

SQ. FT. 2142 TOTAL UNDER ROOF

SQ. FT. 972

SQ. FT. 1673

SQ. FT. 268

SQ. FT. 160

SQ. FT. 41

IST LIVING

2ND LIVING

TOTAL AC

GARAGE

LANAI

ENTRY

SQ.FT. CALC.'S VALE

TOTAL UNDER ROOF 2183 SQ. FT.

2ND LIVING TOTAL AC

GARAGE

LANAI

ENTRY

1049 SQ. FT

1758 SQ. FT

237 SQ. FT

140 SQ. FT

48 SQ. FT.



ROLAND A. ABOUCHACRA AR NO 93723

JOB # 02353.000

LONGWOOD, FL 32750

PH: 407-774-6078 FAX: 407-774-4078 www.abdesigngroup.com AA #: 0003325

 -</t

MASTER

 \mathcal{O}

DATE: 9/21/2021 SCALE: AS NOTED SHEET NO:

FOR OFF-RIDGE VENT CALCULATIONS SEE SHEET A4 (\mathbf{D}) (\mathbf{A}) 29'-11 9/16" BLDG. HGT. – 4" TRIM BOARD (TYP) 6" LAP SIDING (TYP) — SHINGLE ROOF 19'-4" 2nd FLR BRG. HGT. 18"x60"-APPLIED SHUTTERS RAISED —— KEYSTONE 10'-8" TOP OF BOND BEAM 9'-4" BRG. HGT. @ LANAI —6" RAISED BAND 0'-0" FIN. FLR. SCALE: 3/16 = 1'-0" TEXTURED FINISH NOTE: WALL FENESTRATION FLASHING AS PER FBCR 703.4 (G)(D)(B)OFF-RIDGE VENT OFF-RIDGE VENT 19'-4" 2nd FLR BRG. HGT. <u>A</u>
<u>A4</u> 10'-8' TOP OF BOND BEAM 9'-4' BRG. HGT. @ LANAI 10'-8" TOP OF BOND BEAM 9'-4" BRG. HGT. @ ENTRY 0'-0" FIN. FLR. Ø'-Ø" FIN. FLR.♠ REAR ELEVATION

SCALE: 3/16 = 1'-0"

TEXTURED FINISH

Design Group ILC.

1441 N. RONALD REAGAN BLVD. LONGWOOD, FL 32750

LONGWOOD, FL 32750 PH: 407-774-6078 FAX: 407-774-4078 www.abdesigngroup.com AA #: 0003325

HHORION

finerica's Builder

www.drhorton.com

cBC055300

MASTER

ALE AND GLEN IIT TOWNHOMES DING FRONT & RELEVATIONS

VALE AN O DOB #

JOB # 02353.000


ARCHITECT: STATE OF FLORIDA


ROLAND A. ABOUCHACRA AR NO 93723

DATE: 9/21/2021

SCALE: AS NOTED
SHEET NO:


A3

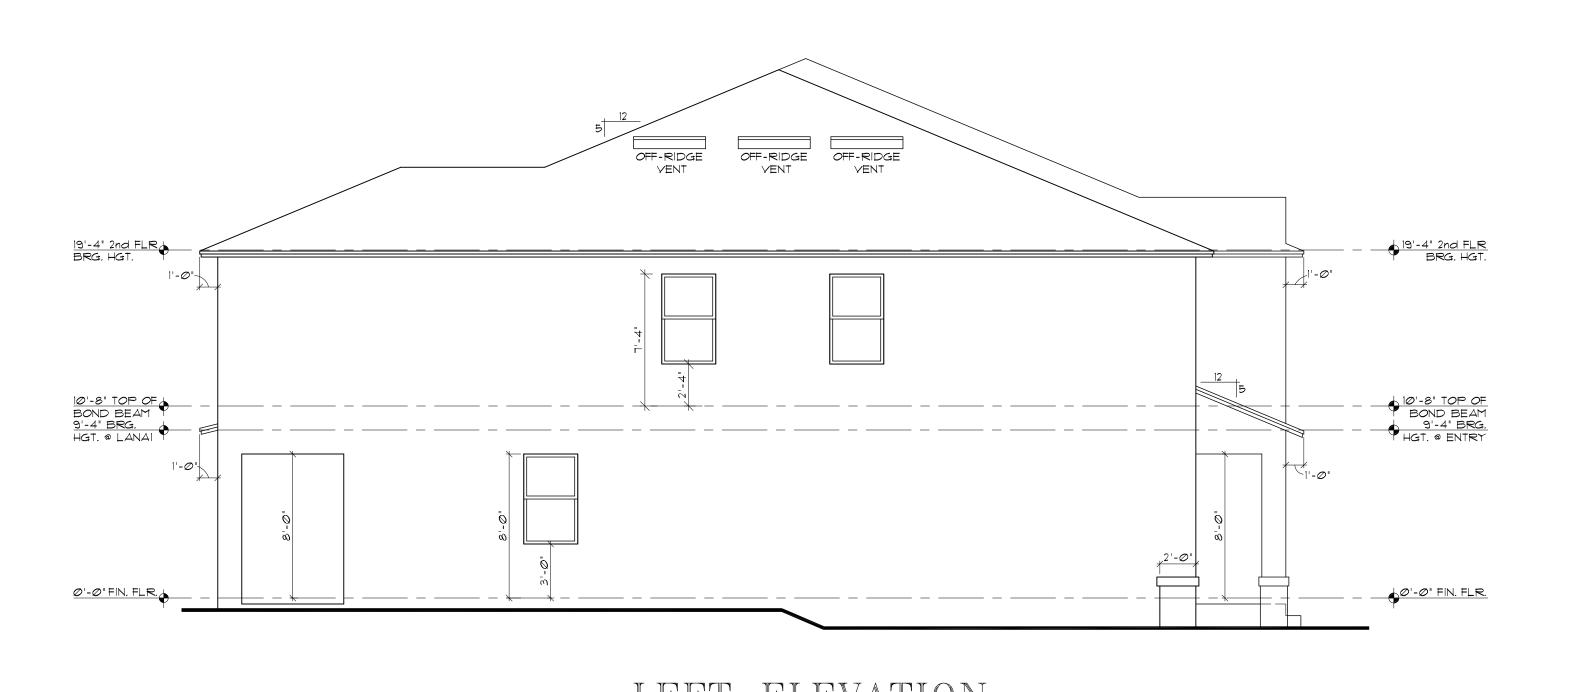


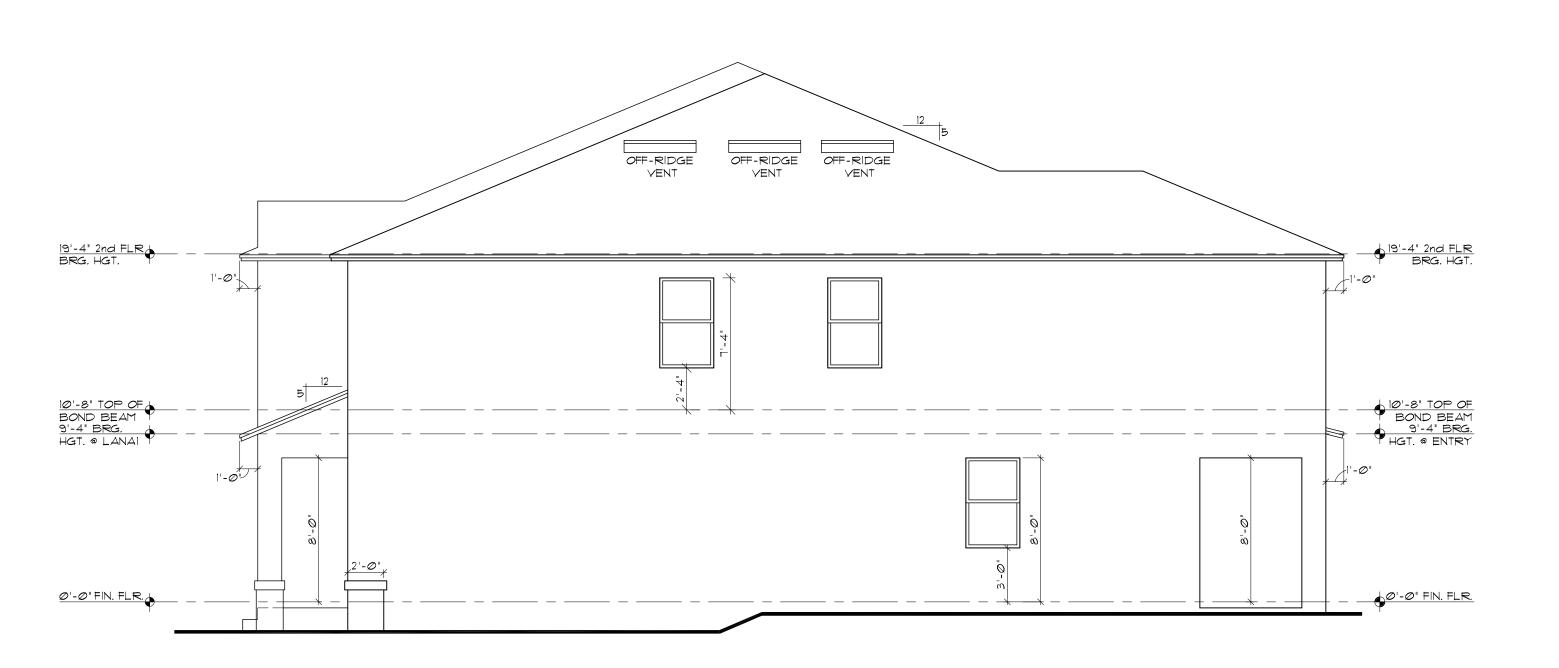


SCALE: 3/16 = 1'-0"


TEXTURED FINISH

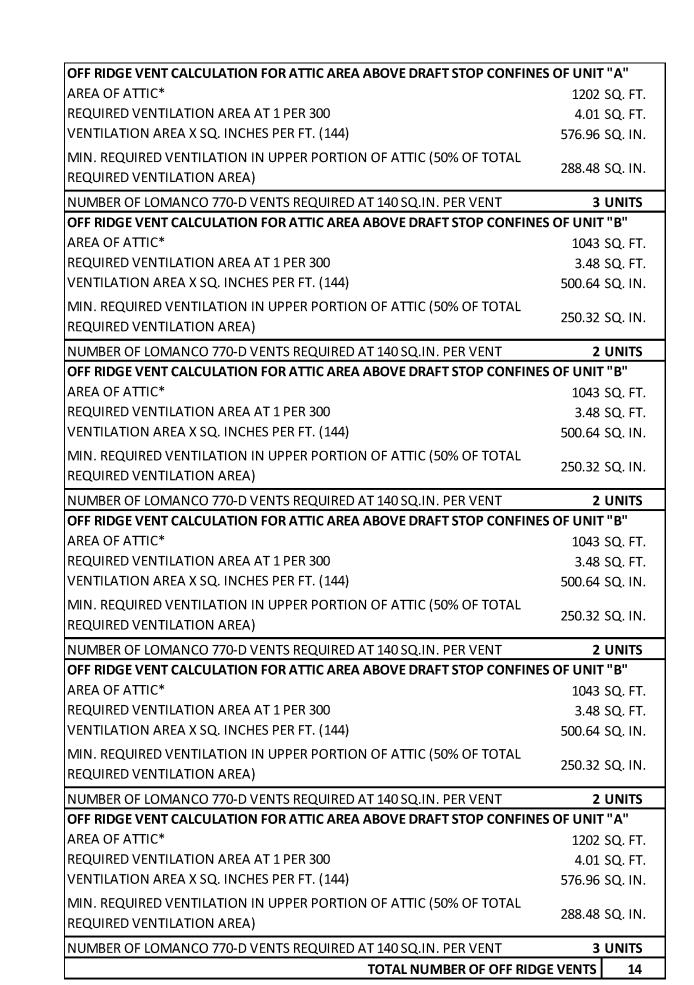

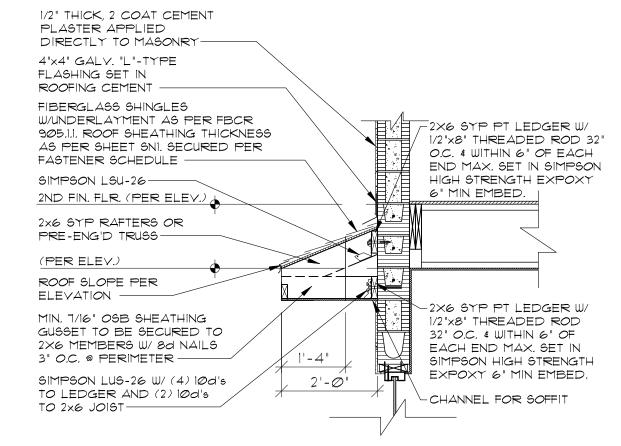



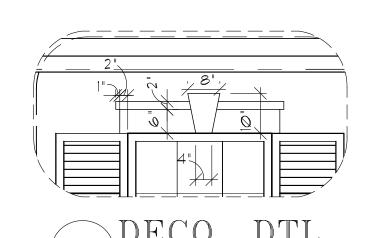

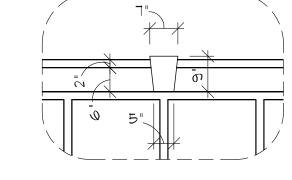

ROLAND A. ABOUCHACRA AR NO 93723

> **DATE**: 9/21/2021 SCALE: AS NOTED SHEET NO:

JOB # 02353.000

ARCHITECT: STATE OF FLORIDA

1441 N. RONALD REAGAN BLVD

LONGWOOD, FL 32750

PH: 407-774-6078

FAX: 407-774-4078

www.abdesigngroup.com

AA #: 0003325

 -</t

MASTER

BUILDING RIGHT EI

VALE UNIT