
CONSTRUCTION PLANS

FOR

Howey Self Storage

S.R. 19 HOWEY IN THE HILLS, FLORIDA

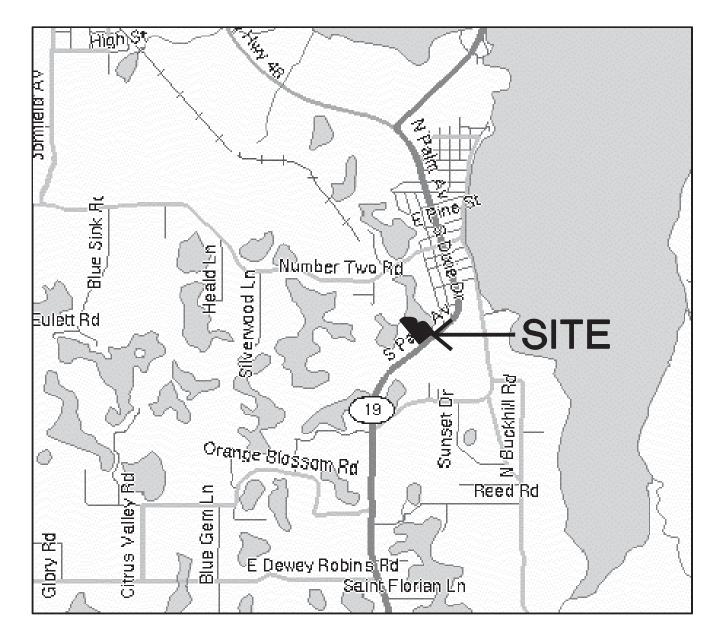

Location Map

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SHEET TITLE	No.	
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LAND DESCRIPTION (EAGLES LANDING AT OCOEE, INC. PARCEL)(VILLAGE 4 OF THE RESERVE AT HOWEY IN THE HILLS)

COMMENCE AT THE EAST 1/4 CORNER OF SECTION 35. TOWNSHIP 20 SOUTH, RANGE 25 EAST, LAKE COUNTY FLORIDA; THENCE RUN N89°21'35"W ALONG THE SOUTH LINE OF THE NORTHEAST 1/4 OF SAID SECTION 35, 1487.79 FEET TO A POINT ON THE NORTHWESTERLY RIGHT-OF-WAY LINE OF STATE ROAD NO. 19; THENCE RUN N52°07'27"E ALONG SAID NORTHWESTERLY RIGHT-OF-WAY LINE, 673.75 FEET TO THE POINT OF BEGENNING; THENCE RUN N37°53'02"W, 1008.88 FEET; THENCE RUN NO0°35'47"E, 116.78 FEET TO A POINT ON THE NORTH LINE OF THE SOUTHWEST 1/4 OF THE NORTHWEST 1/4 OF SAID SECTION 35; THENCE RUN S89°24'13"E ALONG SAID NORTH LINE, 270.08 FEET TO A POINT ON THE WEST LINE OF THE NORTHEAST 1/4 OF THE NORTHEAST 1/4 OF SAID SECTION 35; THENCE RUN NO0°35'58"E ALONG SAID WEST LINE, 256.12 FEET TO A POINT ON THE SOUTH LINE OF THE RESIDENCE OF DON WHITE; THENCE RUN S89°24'13"E ALONG SAID SOUTH LINE, 418.17 FEET; THENCE RUN S00°35'47"W, 709.10 FEET; THENCE RUN S37°52'33"E, 317.47 FEET TO A POINT ON SAID NORTHWESTERLY RIGHT-OF-WAY LINE OF STATE ROAD NO. 19; THENCE RUN S52°07'27"W ALONG SAID NORTHWESTERLY RIGHT-OF-WAY LINE, 329.54 FEET TO THE POINT OF

THE ABOVE DESCRIBED PARCEL OF LAND CONTAINS 11.978 ACRES MORE OR LESS.

LAND DESCRIPTION (HOWEY IN THE HILLS, LTD.

HOWEY FROM E 1/4 COR OF SEC 35-20-25 RUN N 89-21-35 W 1487.79 FT TO NW'LY R/W LINE OF SR 19. N 52-07-27 E ALONG SAID NW'LY R/W LINE 1003.29 FT FOR POB, RUN N 37-52-33 W 317.47 FT, N 0-35-47 E 709.10 FT, S 89-24-13 E TO NW COR OF LOT 1 BLK D-14 OF PALM GARDENS SUB, SE'LY ALONG SAID W'LY LINE OF BLK D-14 OF PALM GARDENS SUB TO NW'LY LINE OF SR 19, SW'LY ALONG SAID R/W LINE TO POB ORB 3003 PG 1362 ORB 3446


THE ABOVE DESCRIBED PARCEL OF LAND CONTAINS 11.00 ACRES MORE OF LESS.


DEVELOPER: HOWEY SELF STORAGE (407) 905-8180 C/O P.O. BOX 770609 WINTER GARDEN, FL. 34777-0609 **ENGINEER:** JUNE ENGINEERING CONSULTANTS (407) 905-8180 P.O. BOX 770609 WINTER GARDEN, FL. 34777-0609 SURVEYOR: BISHMAN SURVEYING & MAPPING (407) 905-8877 13610 GRANVILLE AVENUE CLERMONT, FL. 34711 GEOTECHNICAL YOVAISH ENGINEERING SCIENCES, INC. (407) 774-9383 ENGINEER: 953 SUNSHINE LANE ALTAMONTE SPRINGS, FL. 32714 ENVIRONMENTAL BIO-TECH CONSULTING, INC. (407) 894-5969 CONSULTANT: 2002 EAST ROBINSON STREET ORLANDO, FL. 32803


UTILITIES Water Town of Howey in the Hills Town of Howey in the Hills Sewer Telephone Centurylink Duke Energy

GENERAL NOTES

- 1. ALL CONSTRUCTION SHALL CONFORM TO THE TOWN OF HOWEY-IN-THE HILLS STANDARDS AND SPECIFICATIONS AND TO THE FLORIDA DEPARTMENT OF TRANSPORTATION STANDARD SPECIFICATIONS FOR ROAD AND BRIDGE CONSTRUCTION, MOST RECENT EDITIONS.
- ALL DISTURBED AREAS SHALL BE GRASSED UPON COMPLETION OF
- ALL LANDSCAPING SHALL CONFORM TO THE TOWN OF HOWEY-IN-THE HILLS LANDSCAPE CODE, MOST RECENT ADDITION.
- 4. ALL PROPOSED GRADES SHOWN ARE FINISHED GRADES.
- 5. THE CONTRACTOR SHALL PROVIDE POSITIVE DRAINAGE OF THE SITE TO THE SPILLWAYS AS INDICATED BY GRADES AND FLOW ARROWS.
- UTILITIES SHOWN WERE LOCATED FROM BEST AVAILABLE INFORMATION. THE CONTRACTOR SHALL BE RESPONSIBLE FOR NOTIFICATION ALL UTILITY COMPANIES AND FOR THE LOCATION AND PROTECTION OF ALL UTILITIES THAT MAY EXIST.
- 7. EXISTING ZONING OF THE SUBJECT SITE IS PCD.
- 8. THE CONTRACTOR IS RESPONSIBLE TO PROVIDE EROSION AND SEDIMENT CONTROL THROUGHOUT THE CONSTRUCTION PHASE WHICH SHALL INCLUDE. BUT NOT LIMITED TO THE PLACEMENT OF SILT FENCES. STACKED HAY BALES OR OTHER SIMILAR STRUCTURES ALONG THE PERIMETER OF THE SITE. THIS WORK SHALL CONFORM TO THE REQUIREMENTS OF THE ST. JOHNS RIVER WATER MANAGEMENT DISTRICT AND THE FLORIDA DEPARTMENT OF TRANSPORTATION AS OUTLINED IN F.D.O.T. STANDARD INDEX #102 & CITY CODE. THE CONTRACTOR SHALL PROVIDE AN EROSION PROTECTION PLAN, PRIOR TO PRE-CONSTRUCTION MEETING.
- 9. REMOVE ALL STRIPPINGS AND UNCLASSIFIED MATERIALS OFFSITE AND DISPOSE OF IN LEGAL MANNER.
- 10. FILL TO BE PLACED AND COMPACTED TO A MINIMUM 95% MAXIMUM DENSITY (PER AASHTO T-180)
- 11. JUNE ENGINEERING CONSULTANTS, INC. SHALL BE NOTIFIED IMMEDIATELY OF ANY PROBLEMS REQUIRING DEVIATION FROM THESE PLANS AND SPECIFICATIONS.
- 12. ALL PAVEMENT SHALL BE GRADED TO OBTAIN A MINIMUM GRADE OF 0.50% AND SHALL DRAIN POSITIVELY TO ALL INLETS OR
- 13. CONTRACTOR SHALL PROVIDE AND COORDINATE PLACEMENT OF ANY REQUIRED UNDERGROUND CONDUITS NECESSARY FOR PLACEMENT OF UTILITIES (TELEPHONE, ELECTRIC, CABLE.. ETC.) AND THE SPRINKLER SYSTEM.
- 14. CONTRACTOR SHALL PROVIDE JUNE ENGINEERING CONSULTANTS WITH AS-BUILT INFORMATION ON THE FOLLOWING: LOCATIONS AND INVERTS OF ALL UTILITIES AND STORM STRUCTURES; PAVEMENT LOCATIONS AND GRADES; AND POND GRADES SHOWN ON PLANS.
- 15. THE CONTRACTOR IS RESPONSIBLE FOR THE NOTIFICATION, LOCATION & PROTECTION OF ALL UTILITIES THAT MAY EXIST. WITHIN THE PROJECT

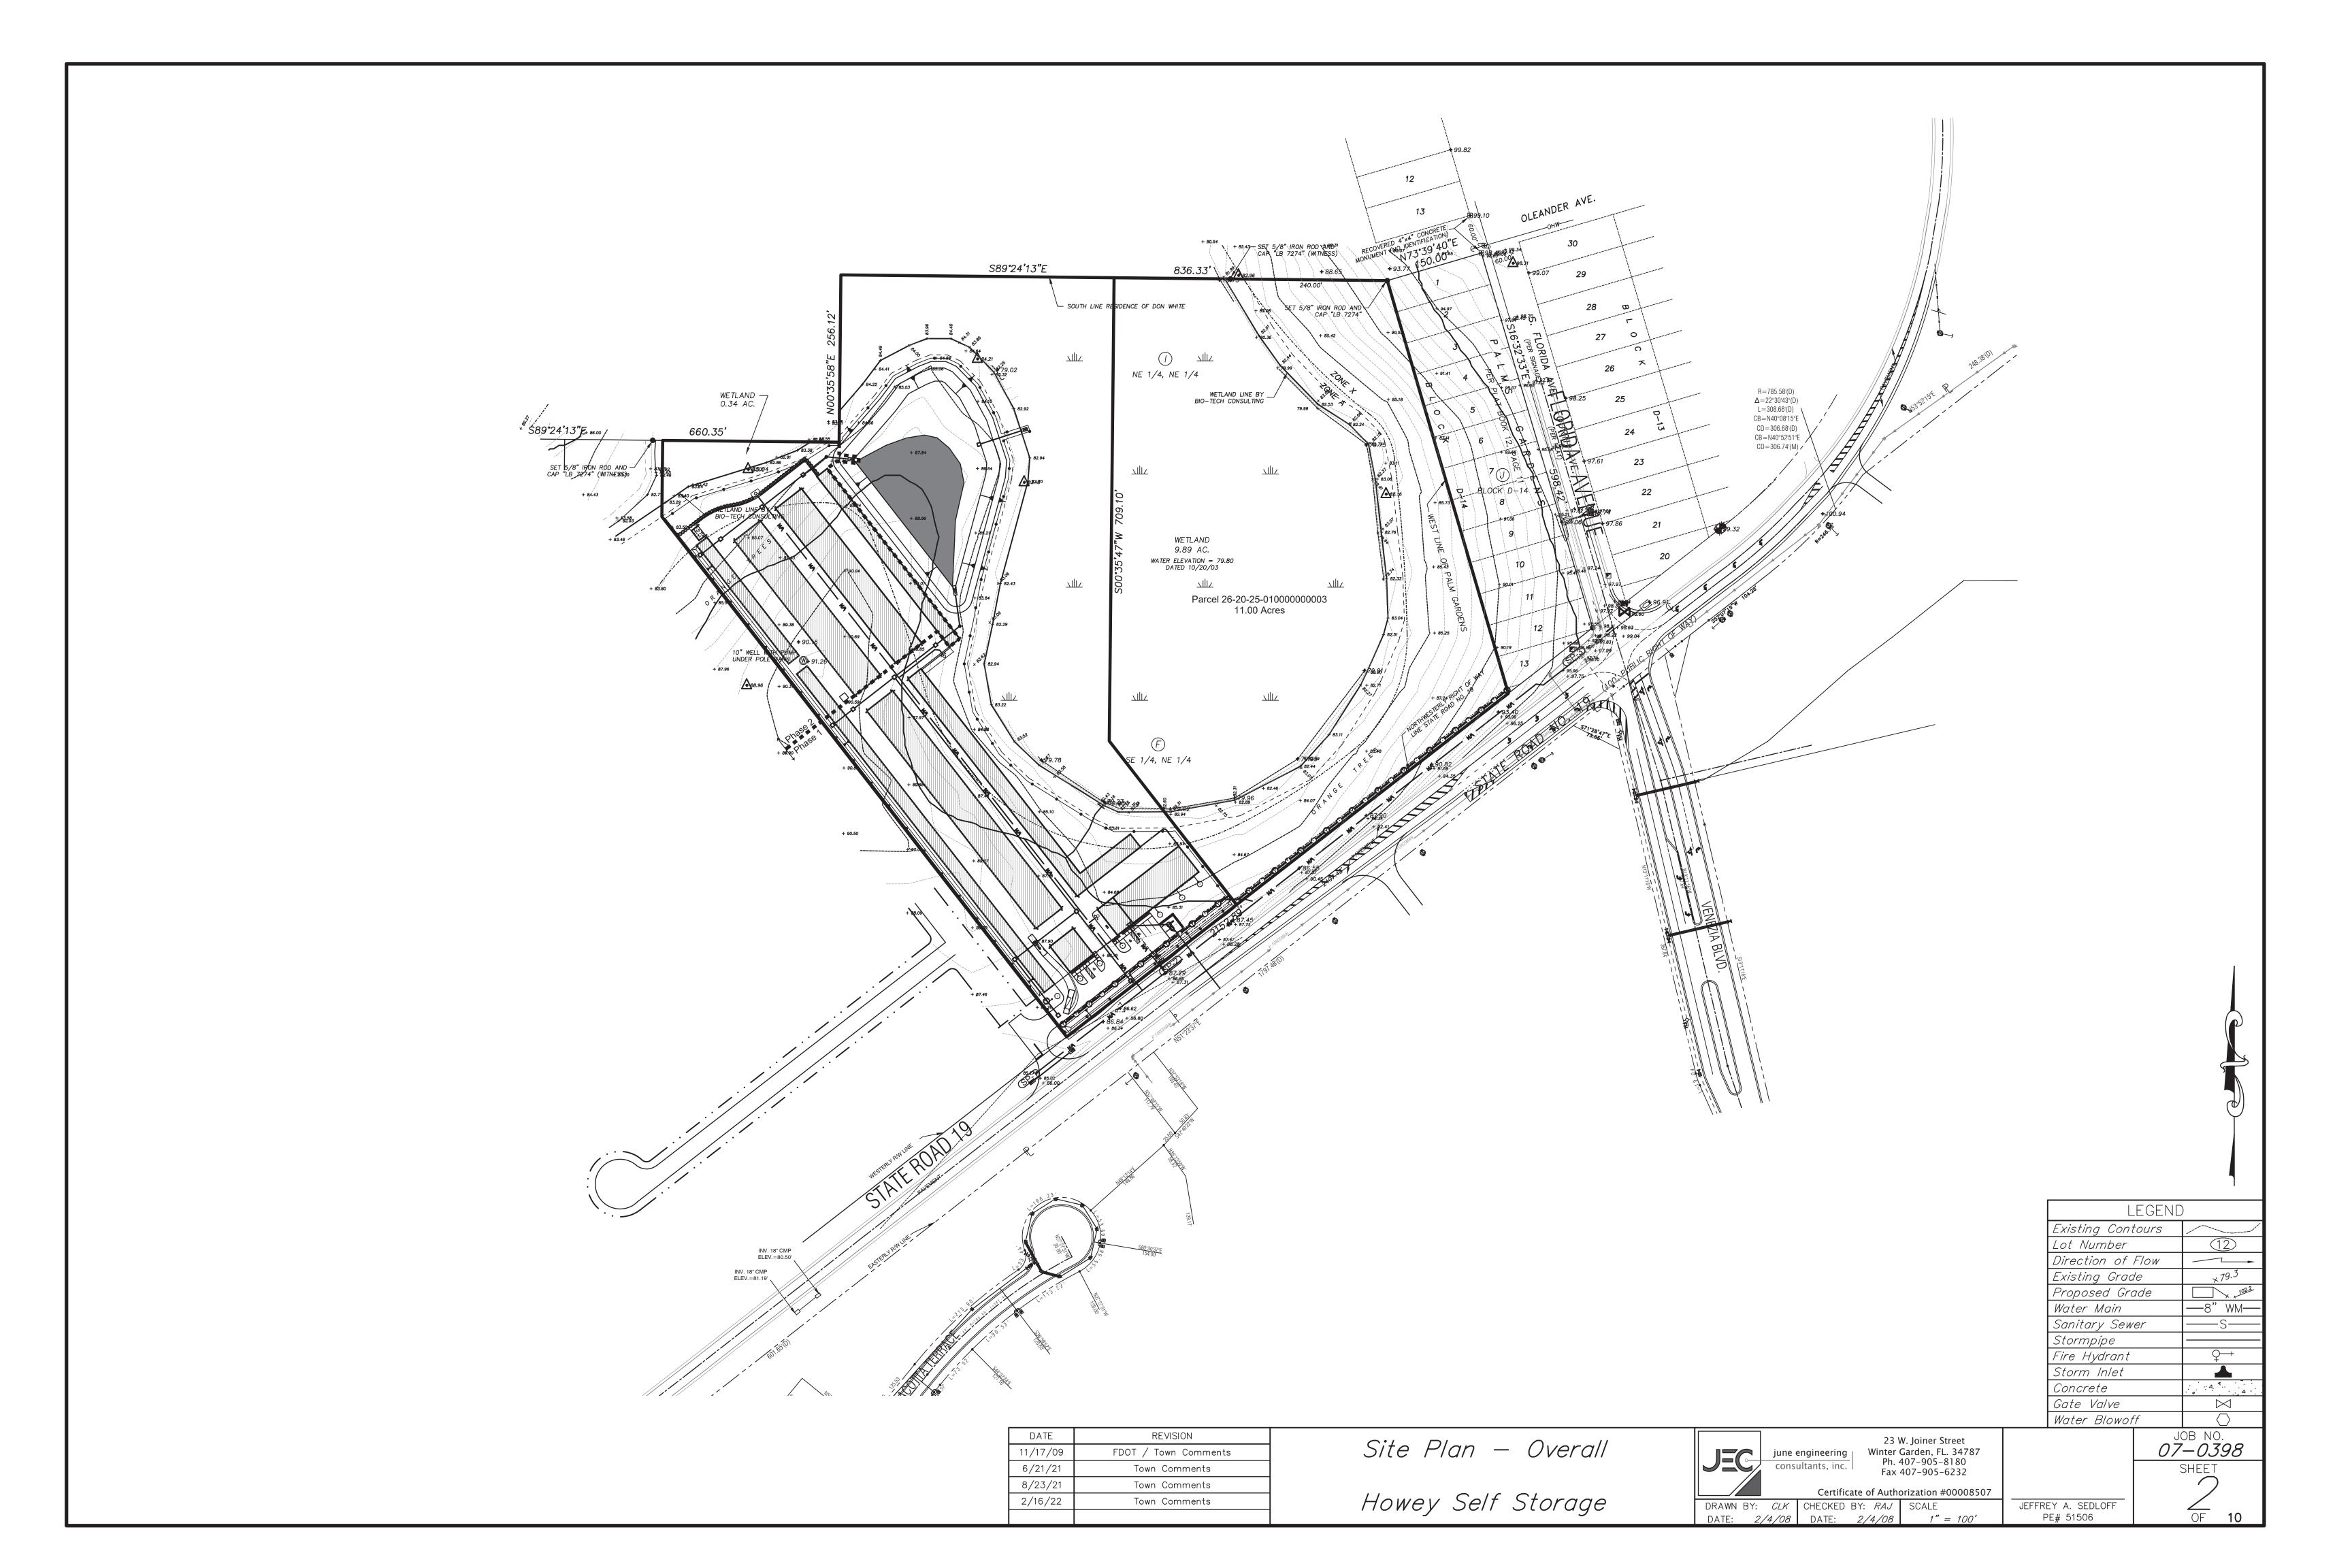

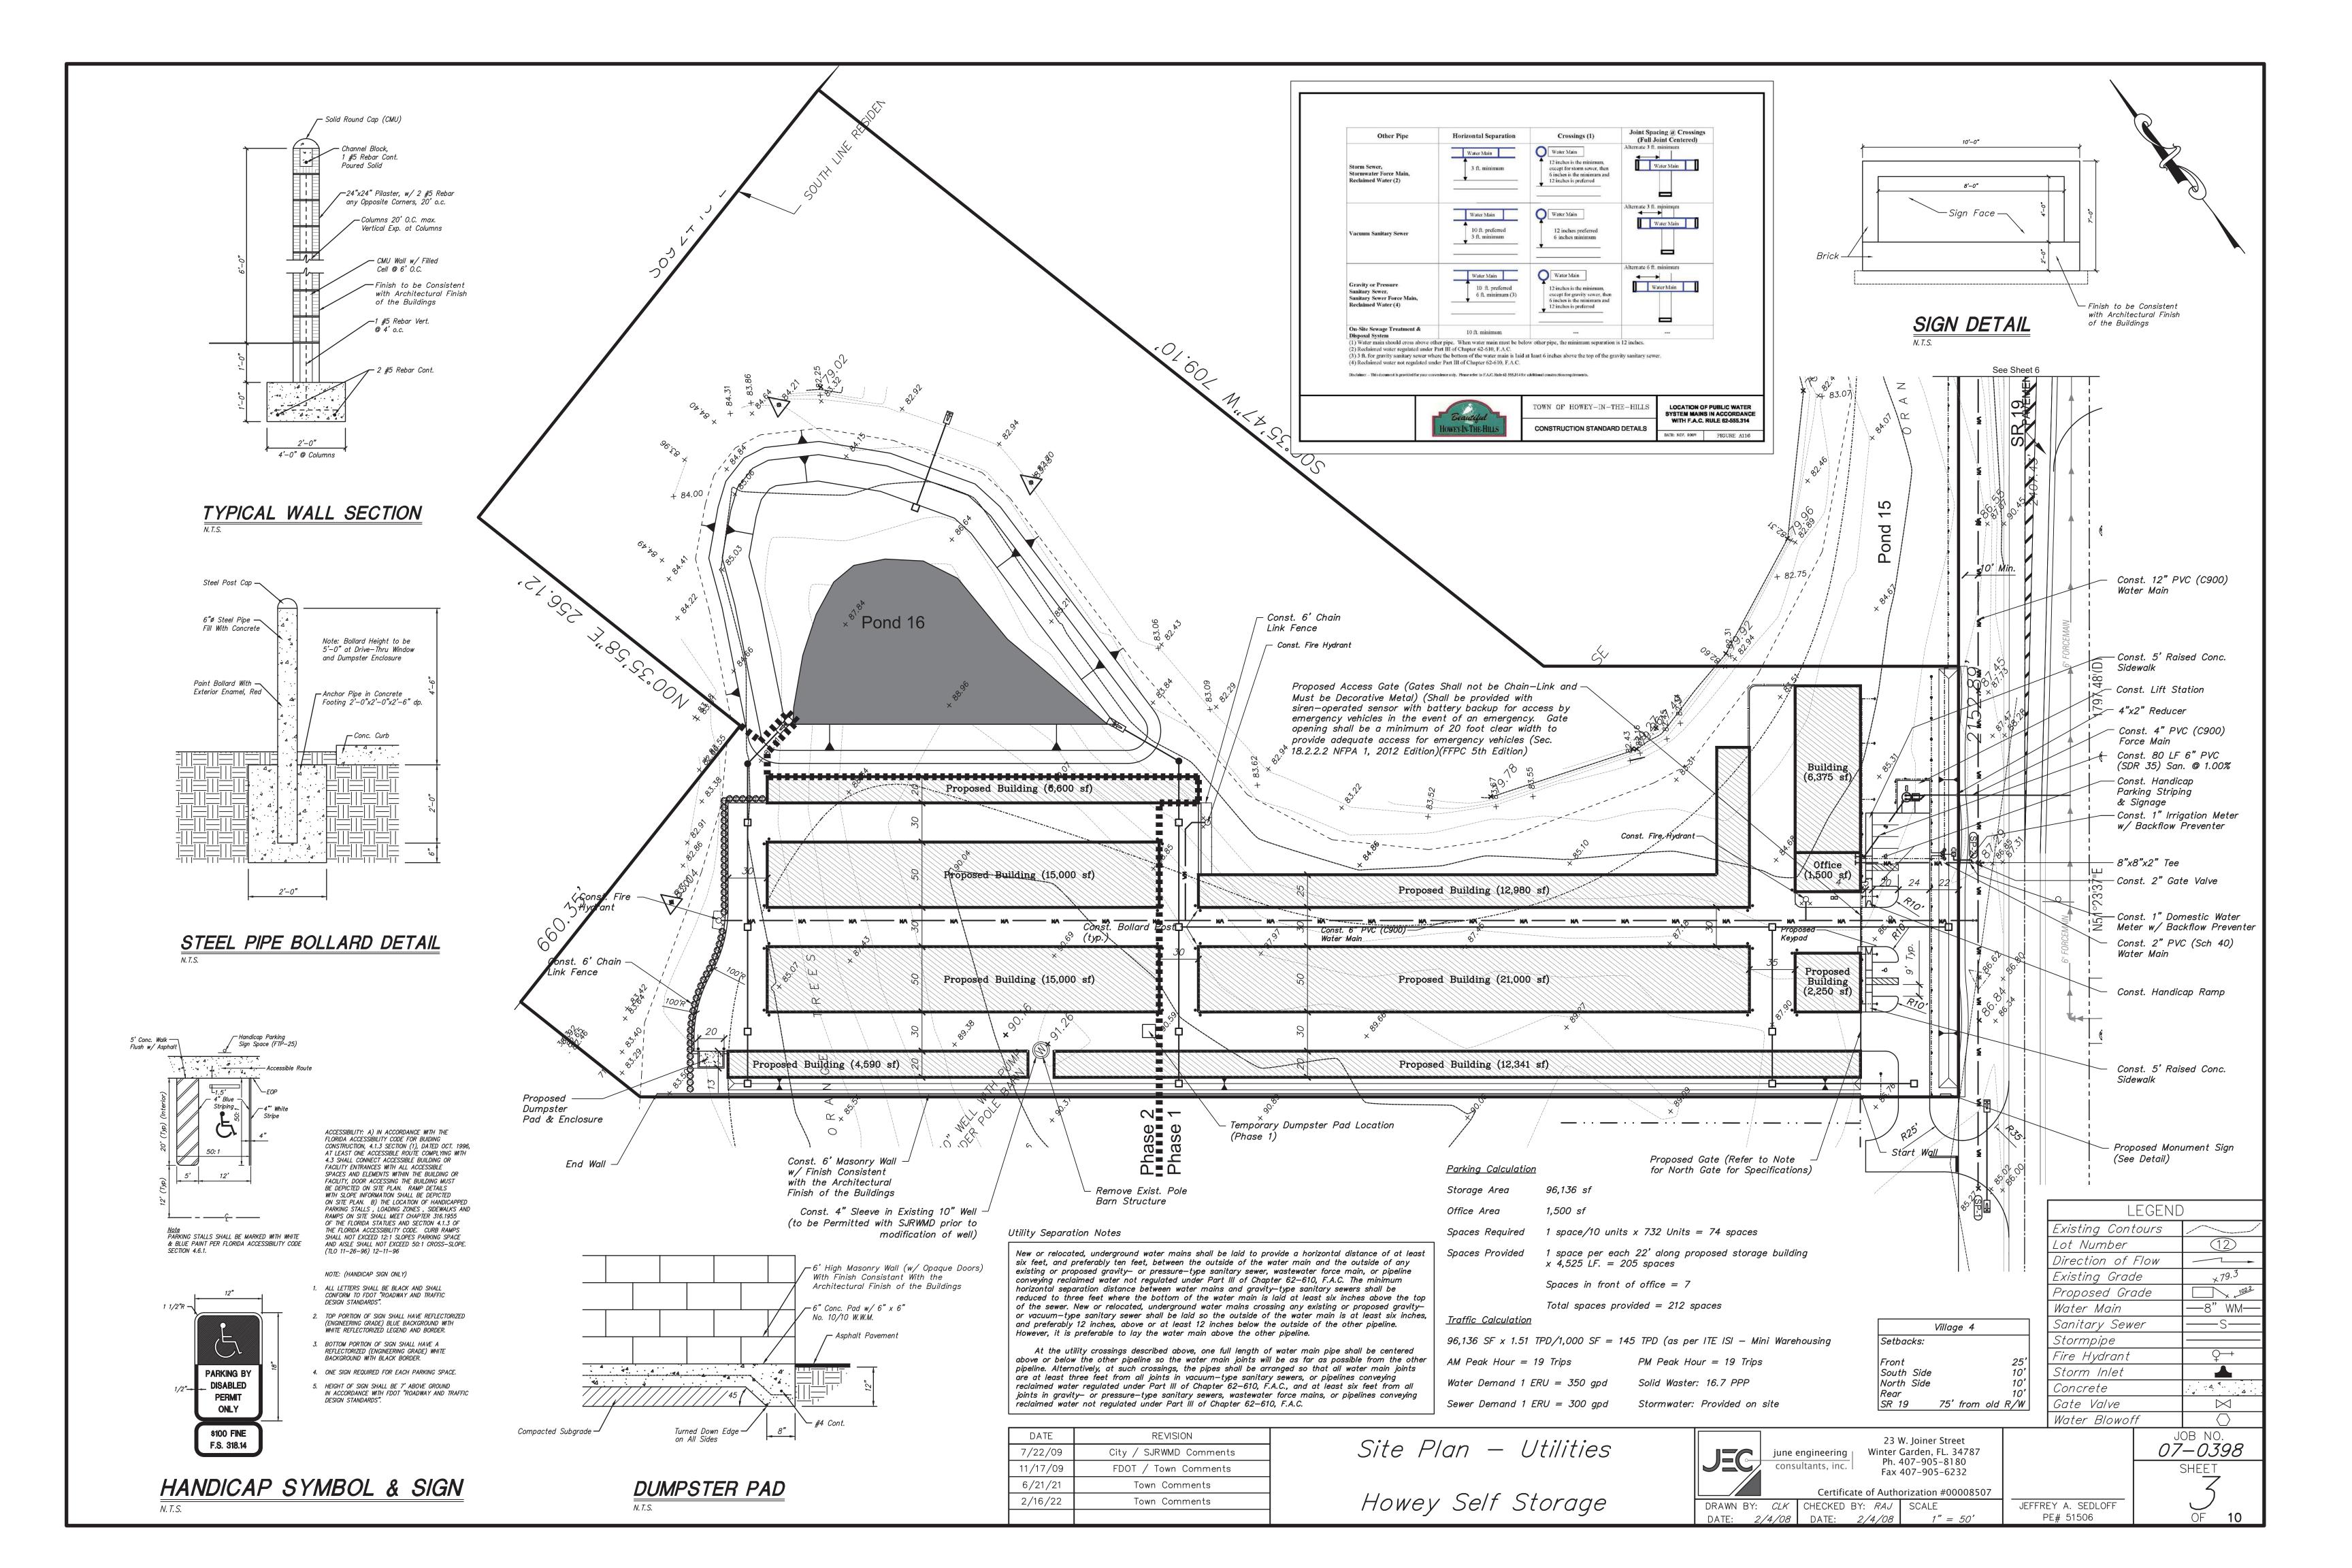

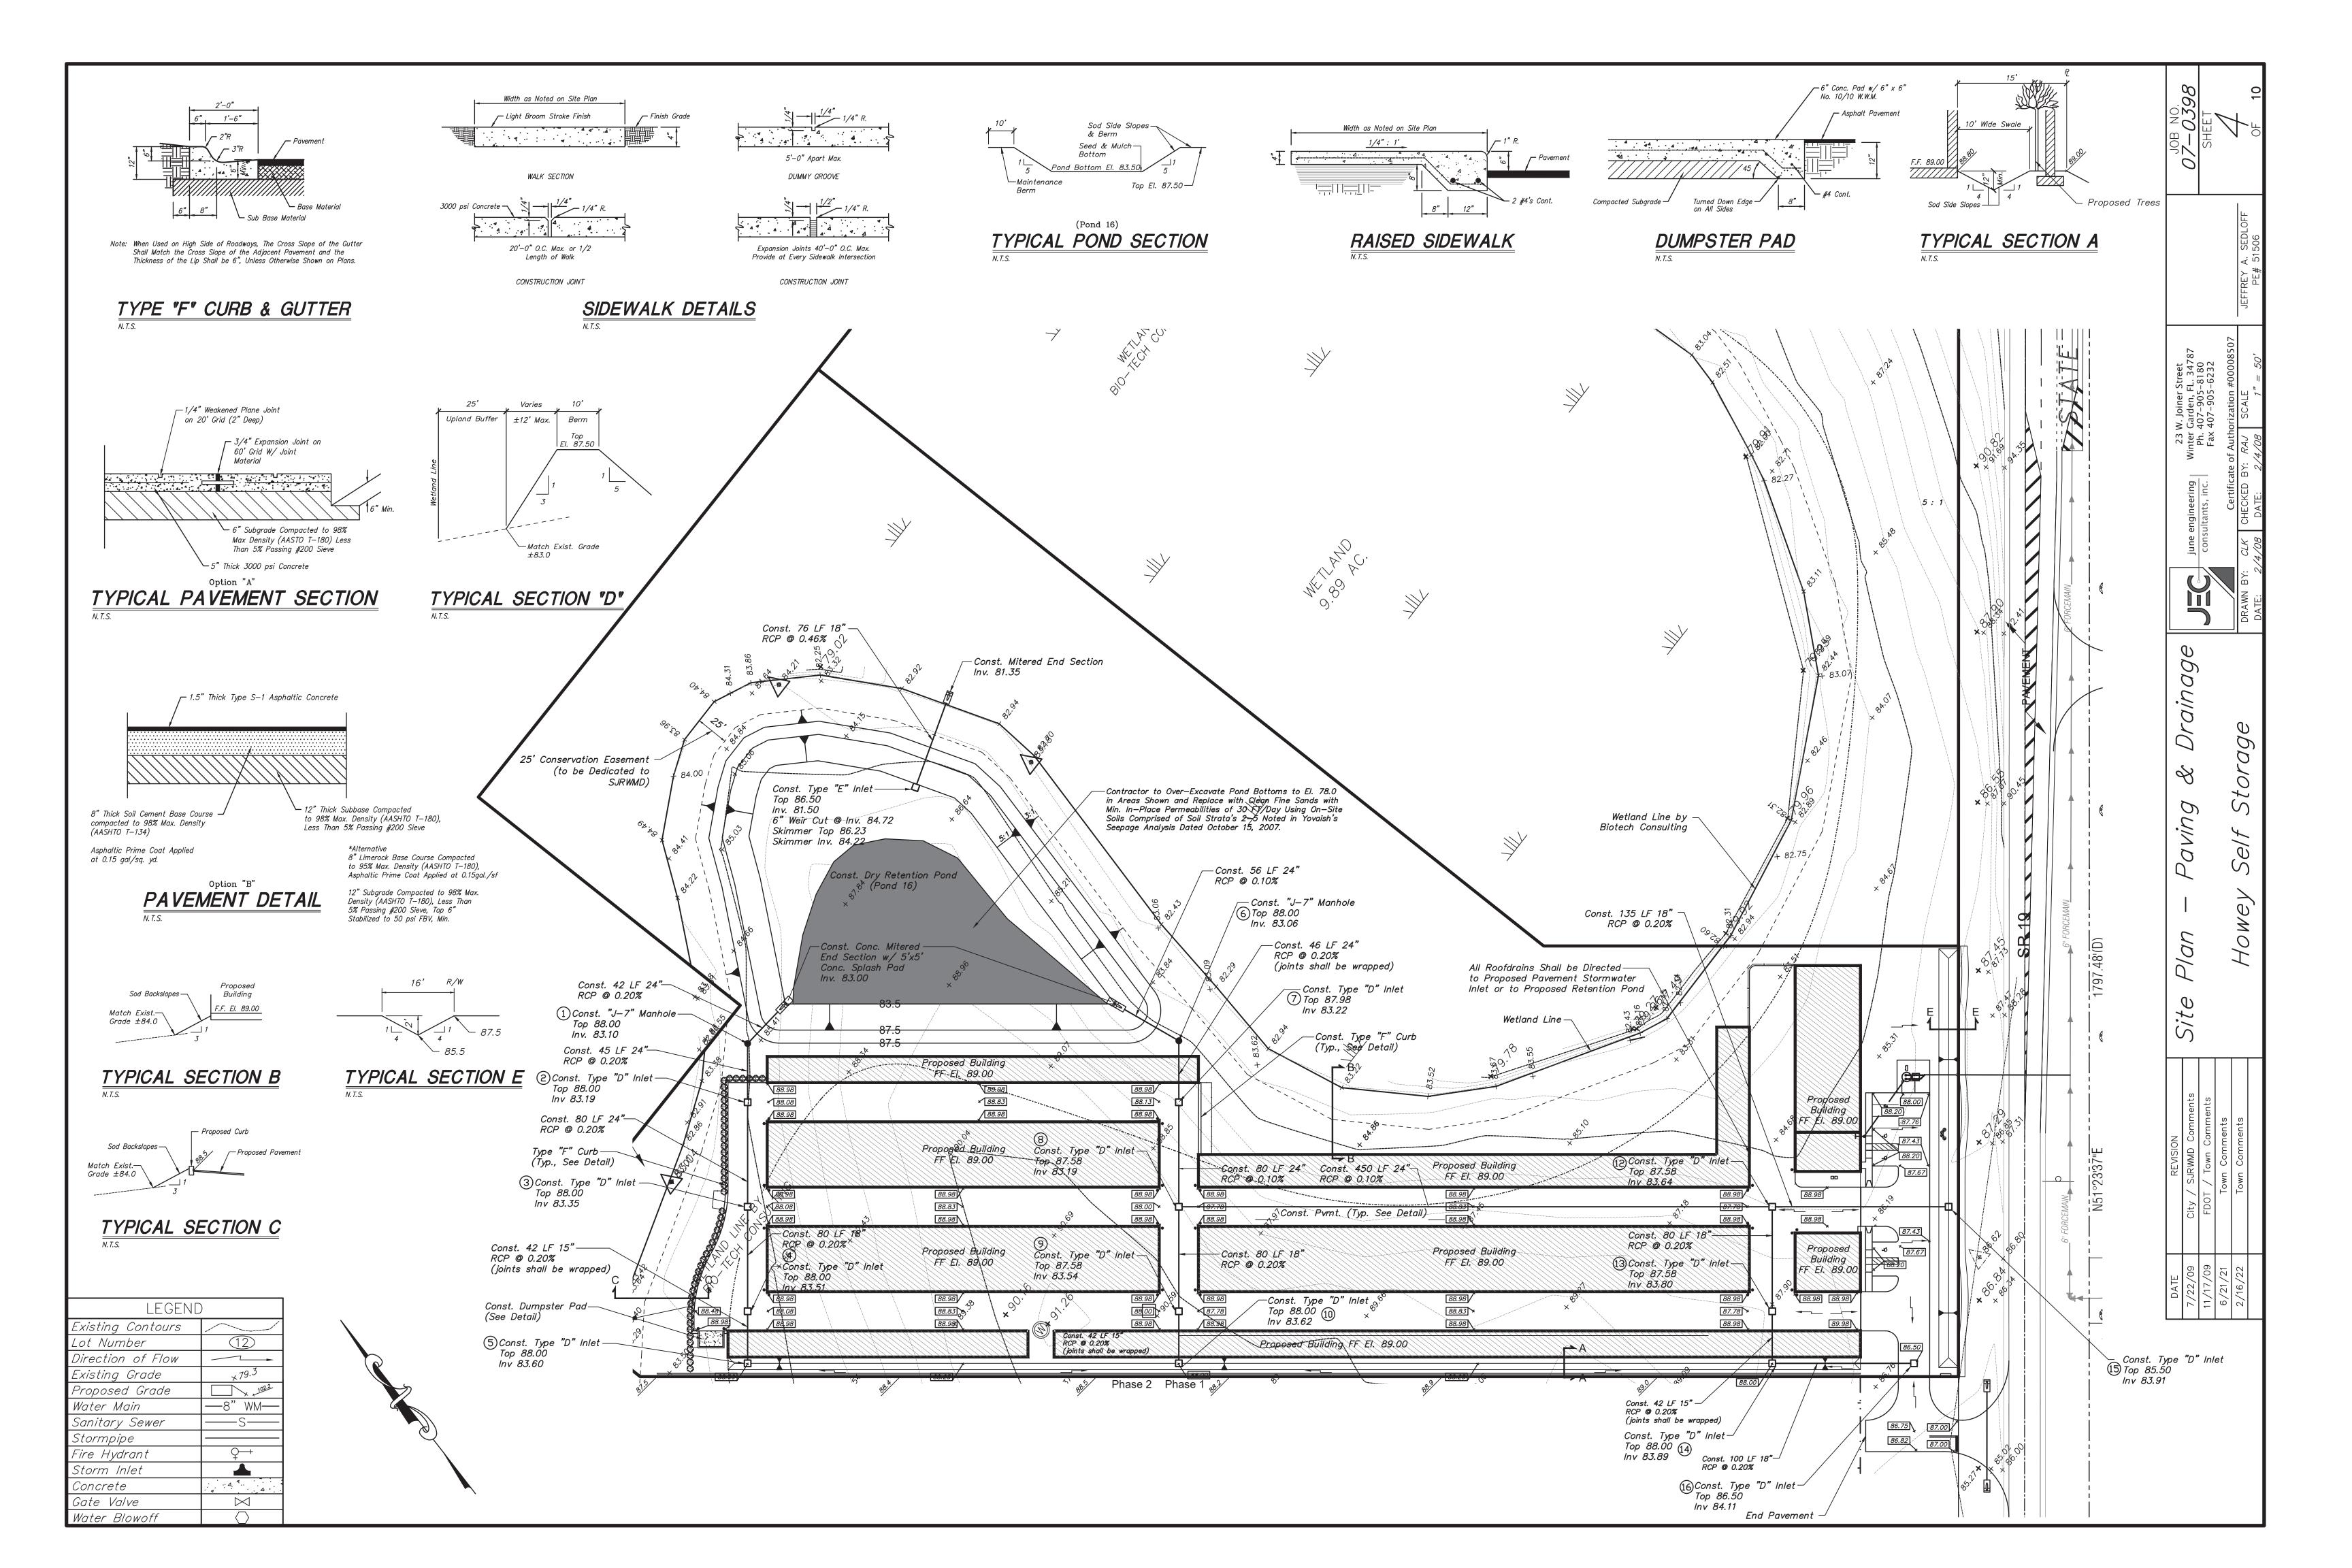

THE RESERVE AT HOWEY IN THE HILLS


SELF STORAGE FACILITY


The street frontage buildings of the facility will be modeled in the same fashion as the Village Center. The interior buildings will be low profile single story structures surrounded by the architecture on the street and a wall along the residential areas.







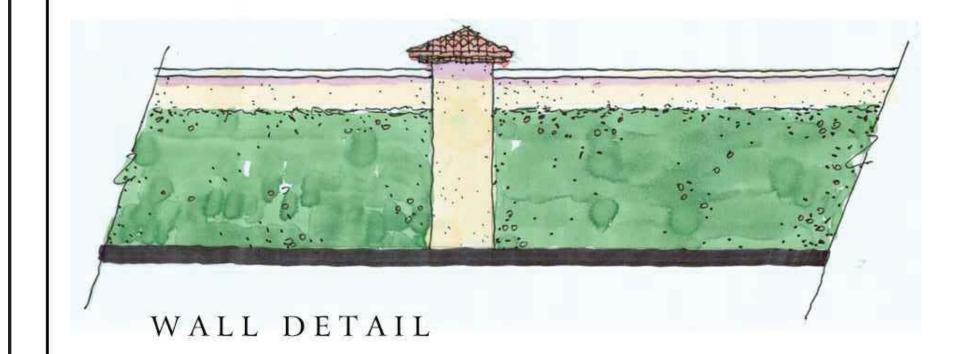

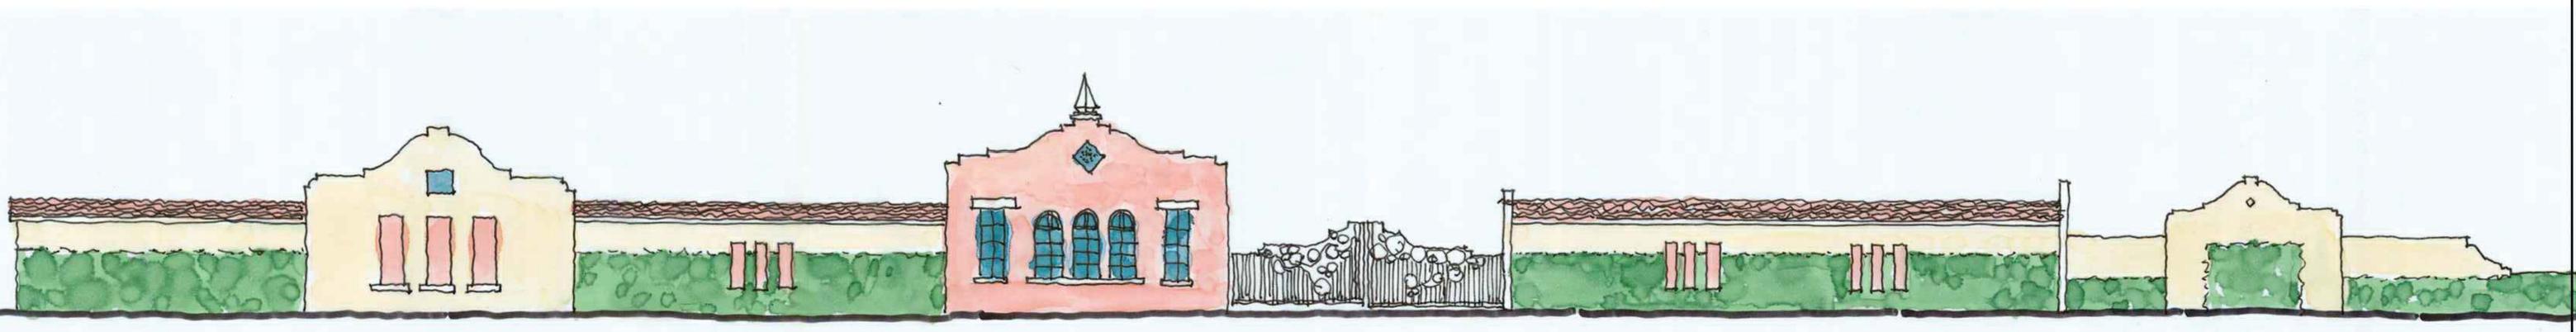

BUILDING ELEVATIONS

Morrissey design studio

DATE	REVISION	
6/21/21	Town Comments	

Design Requirements

Howey Self Storage


	JEC		june engineering consultants, inc.			23 W. Joiner Street Winter Garden, FL. 34787 Ph. 407–905–8180 Fax 407–905–6232 te of Authorization #0000850		
ĺ	DRAWN	BY:	CLK	CHECKED	BY:	RAJ	SCALE	
	DATE:	2,	/4/08	DATE:	2/	4/08	1" = 50'	


JOB NO.
07-0398


SHEET


OF 10


JEFFREY A. SEDLOFF PE# 51506

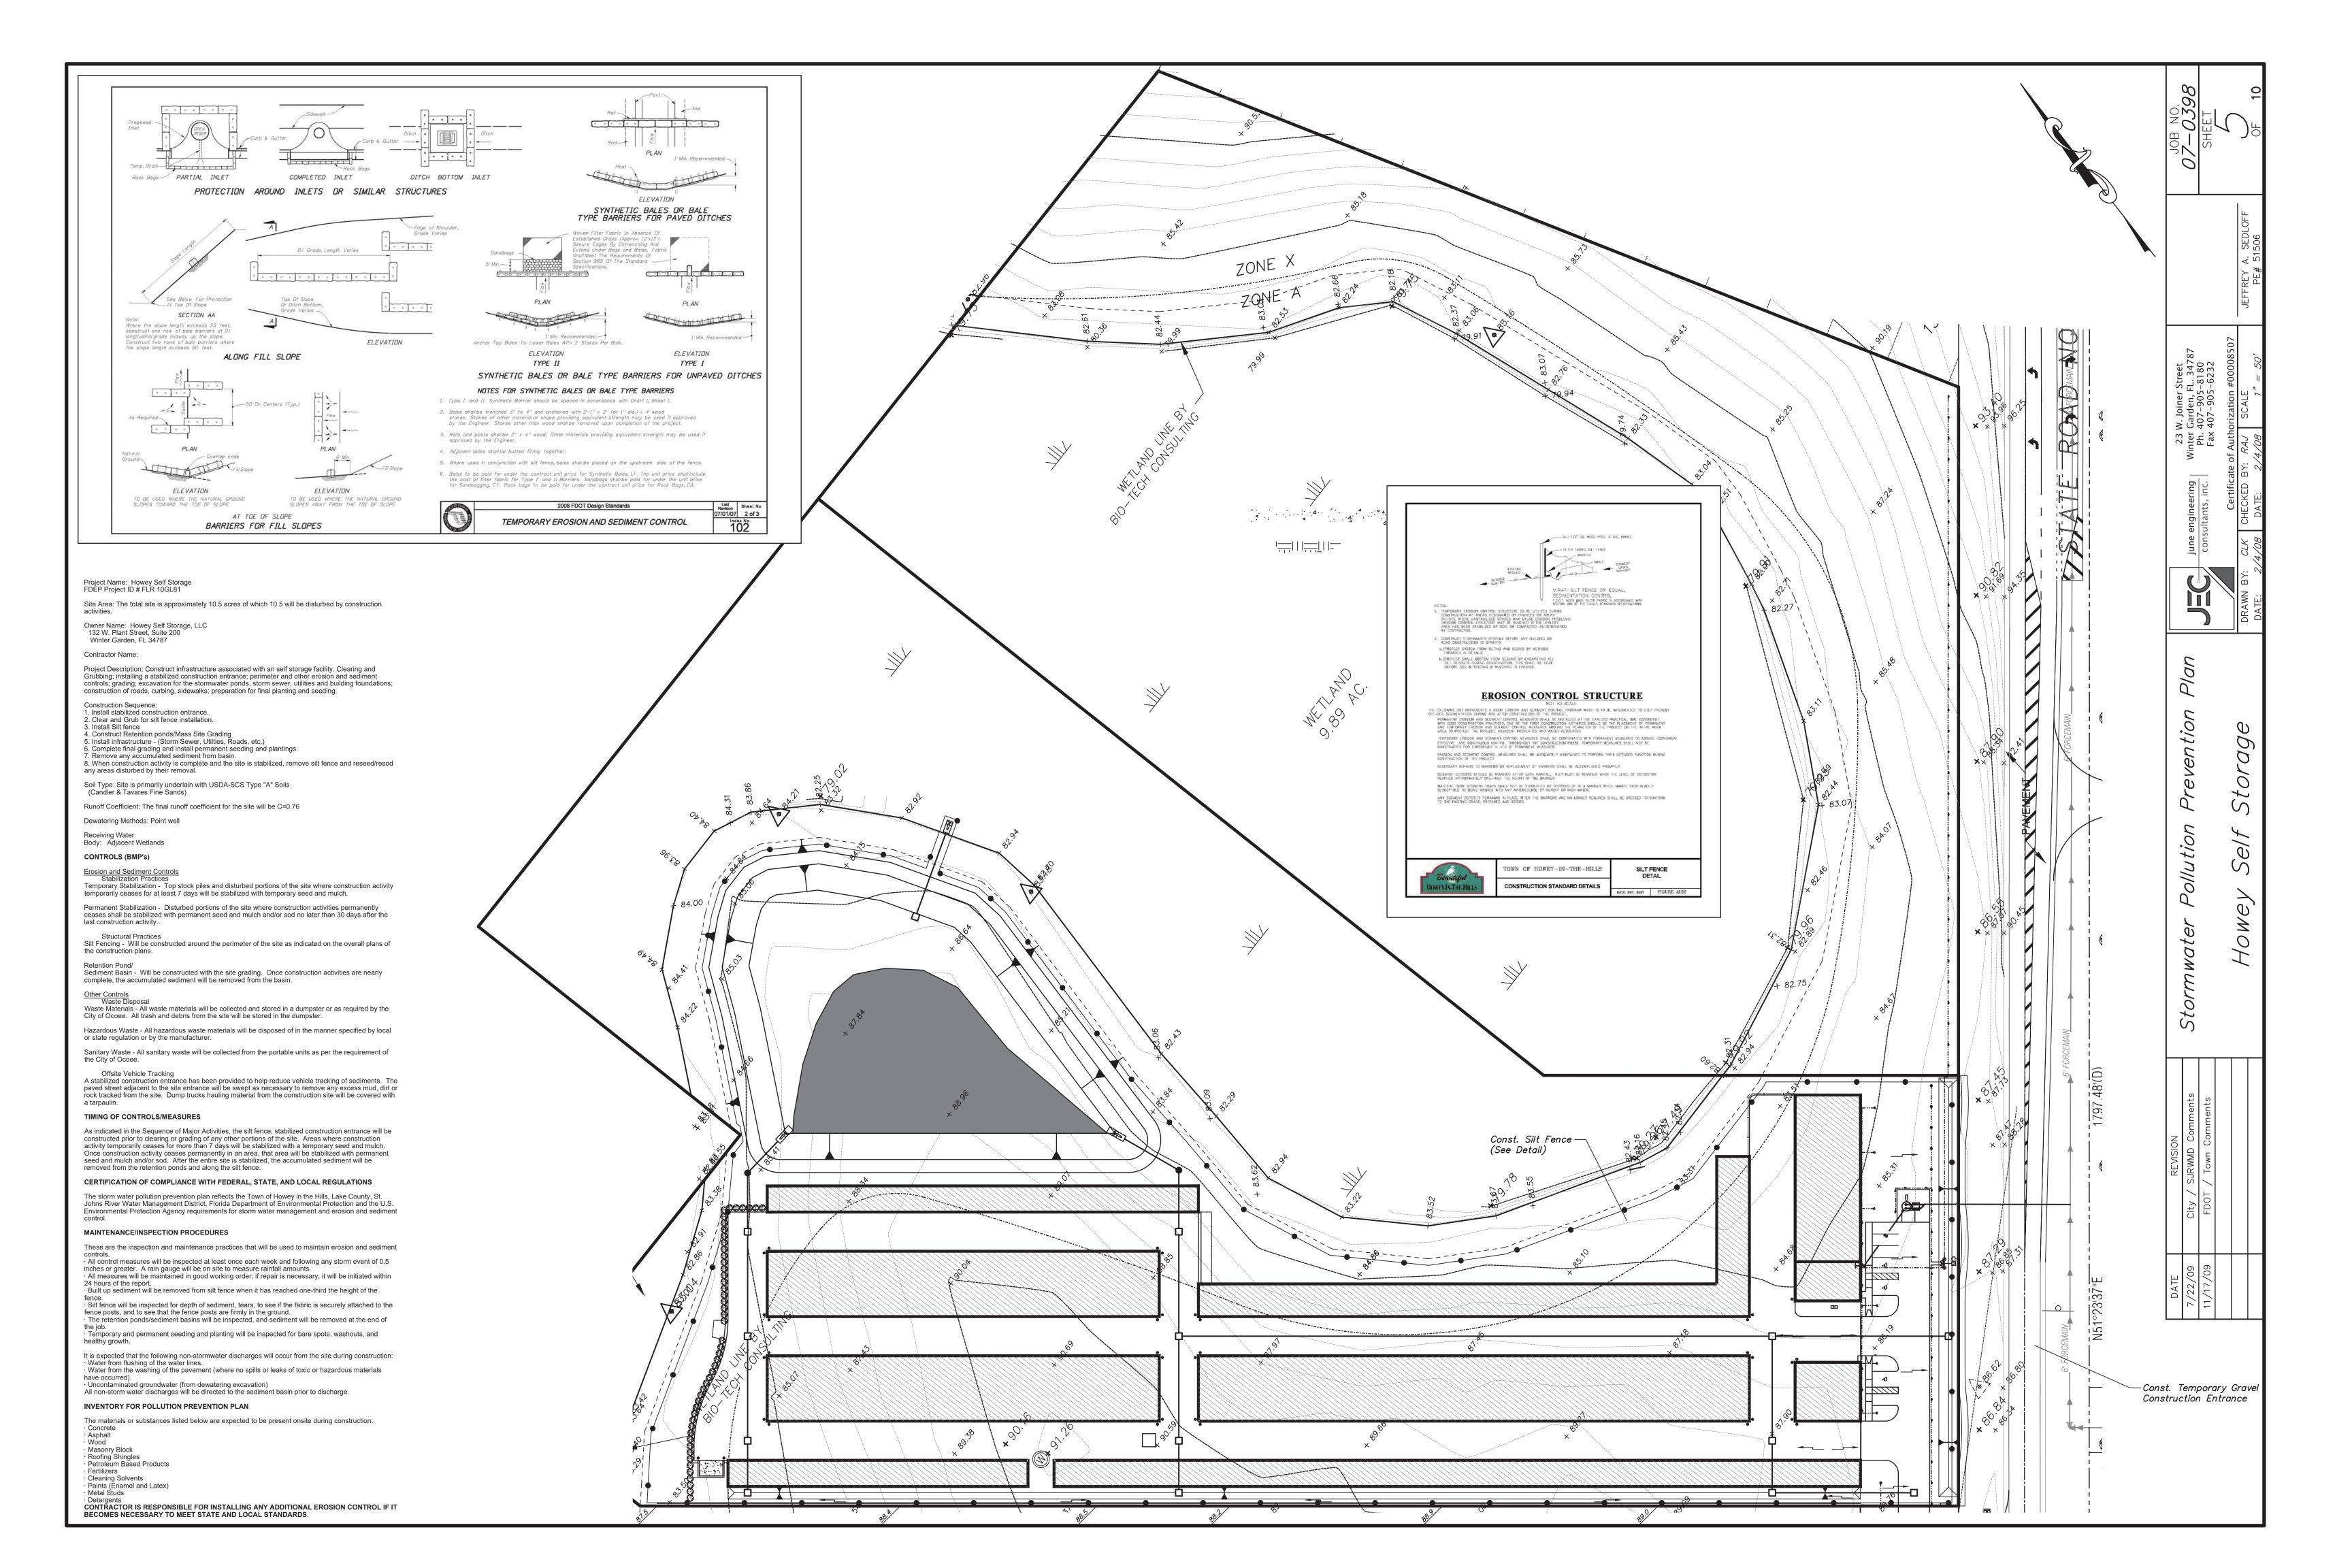


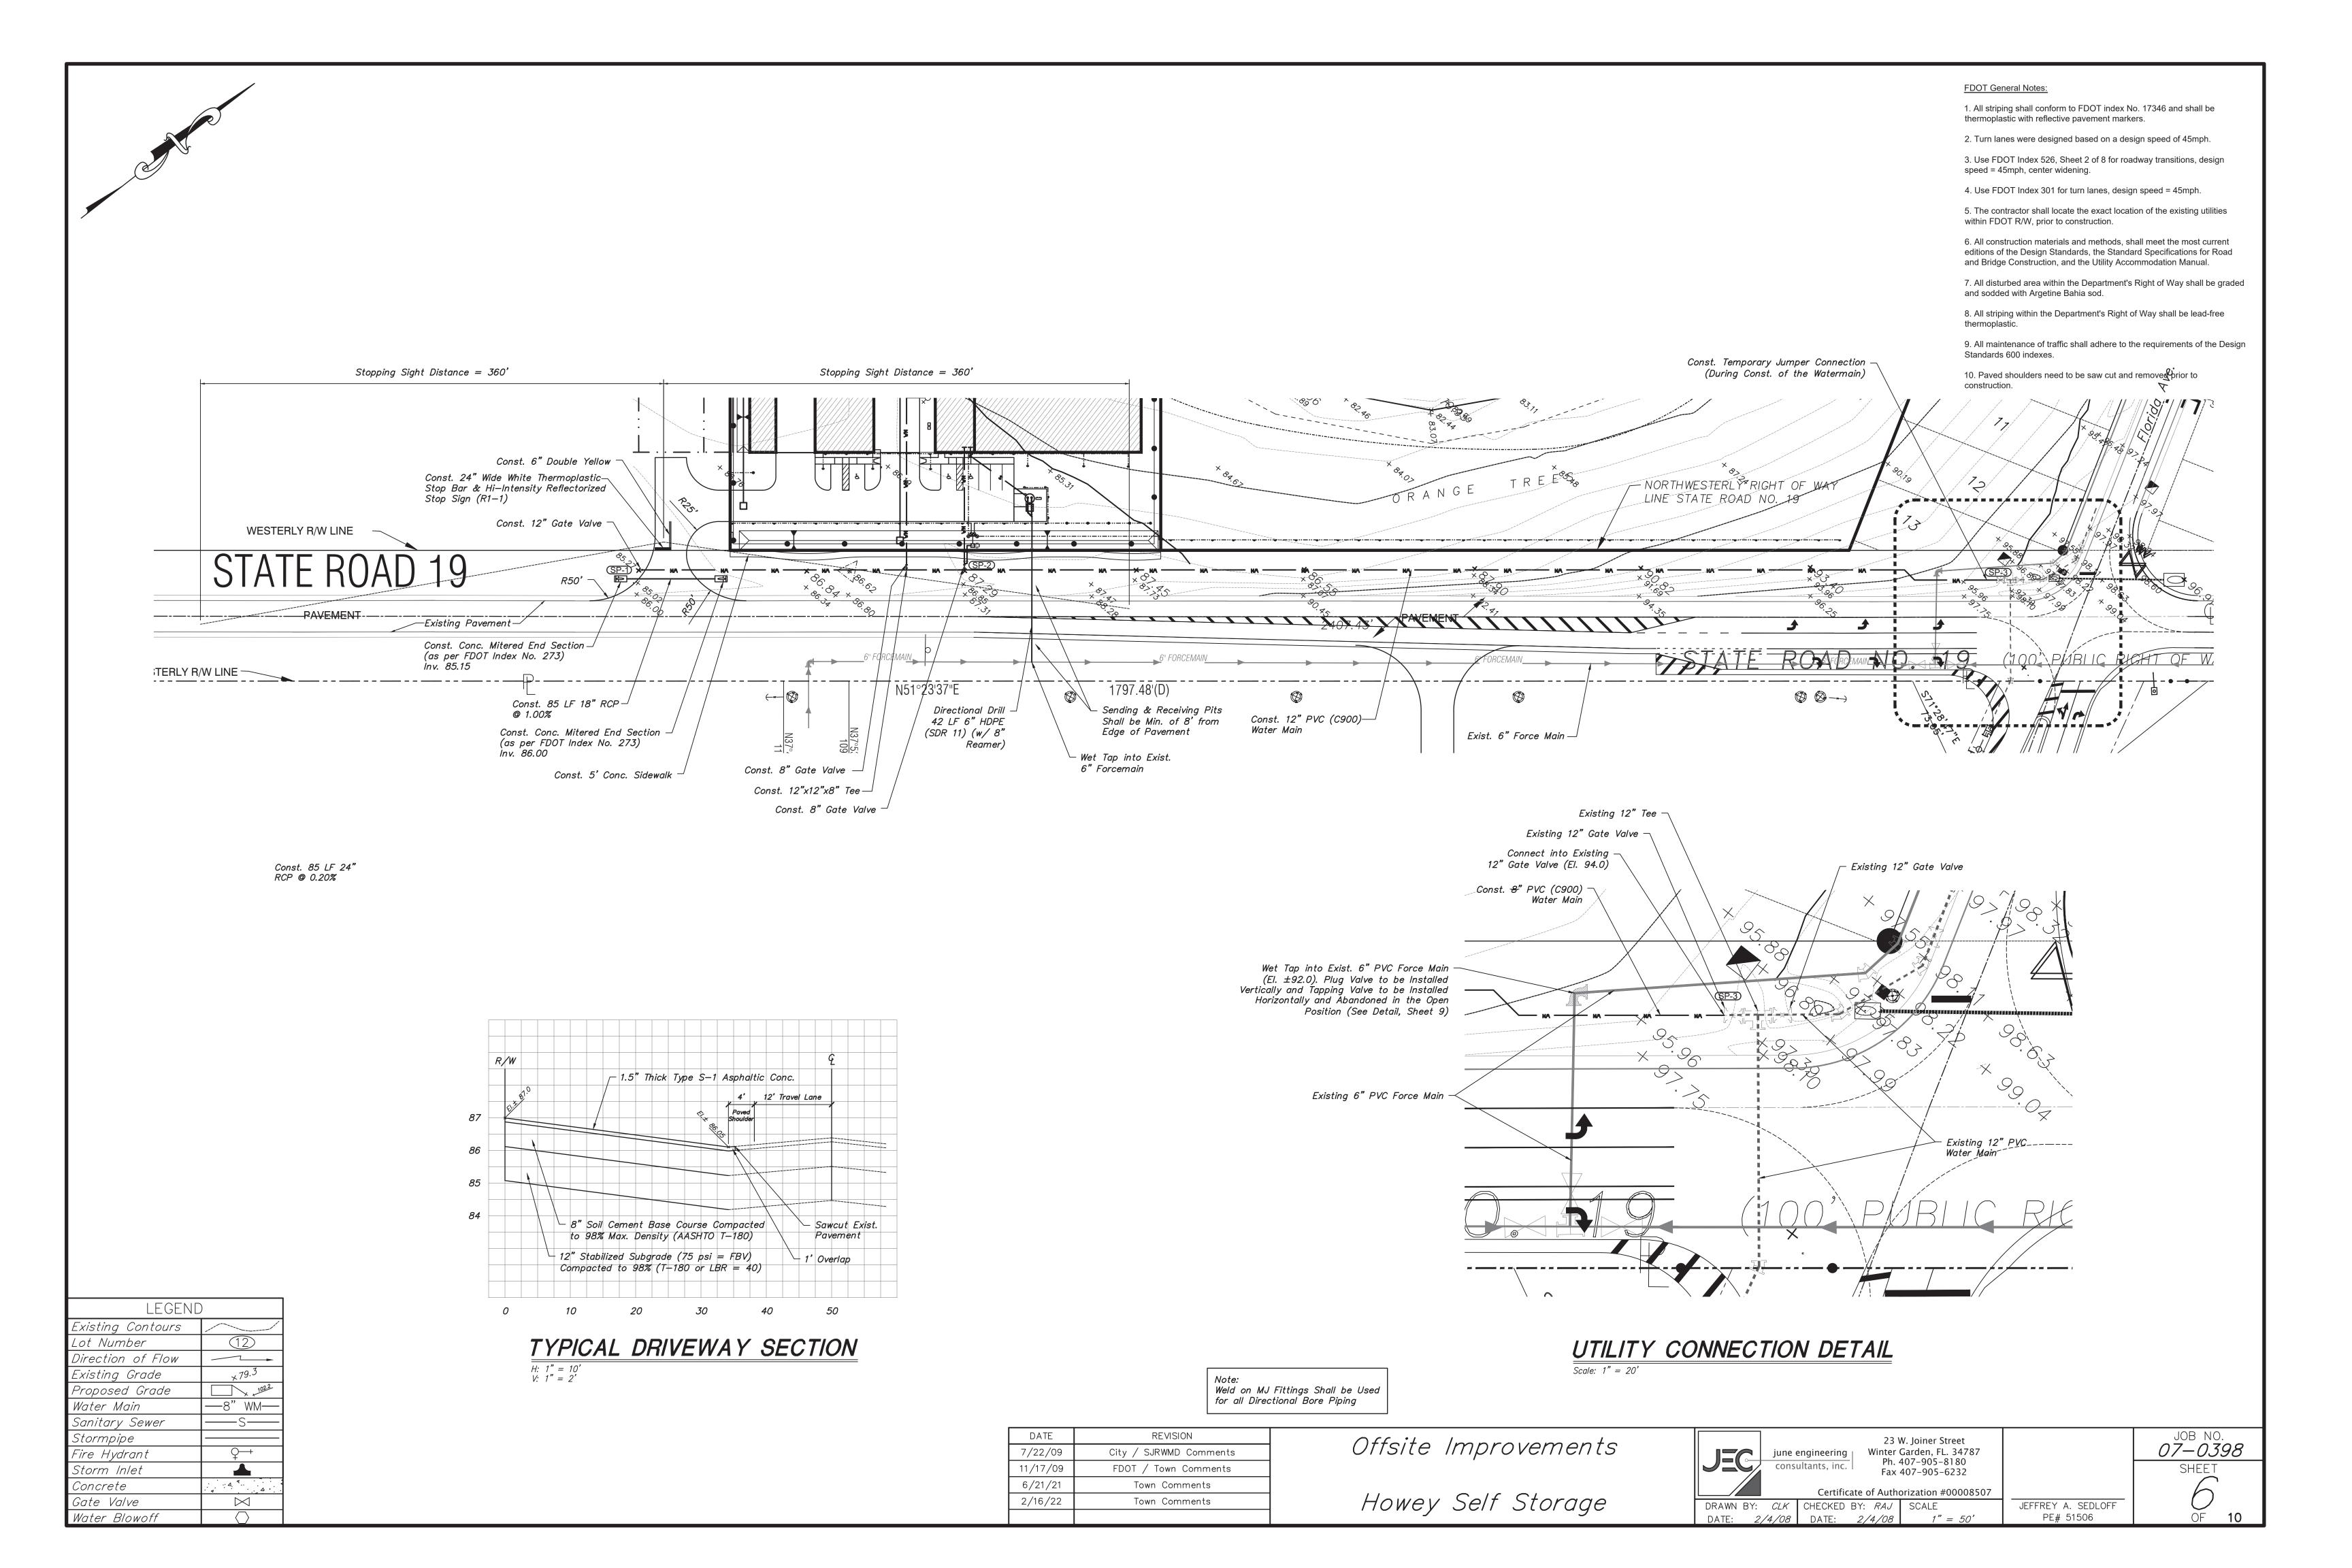


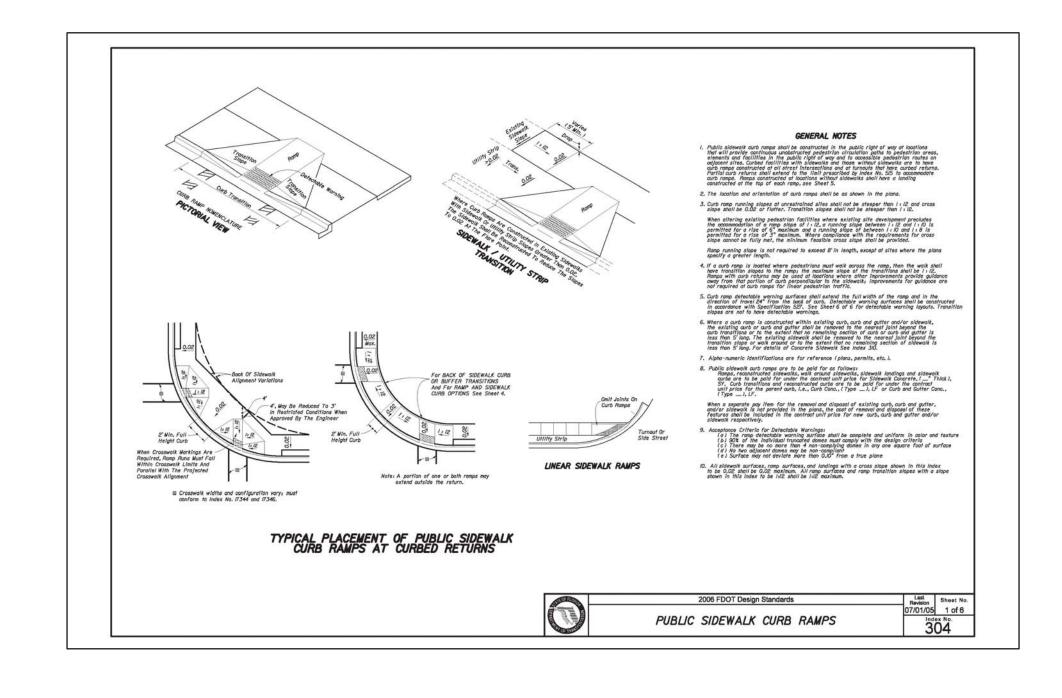


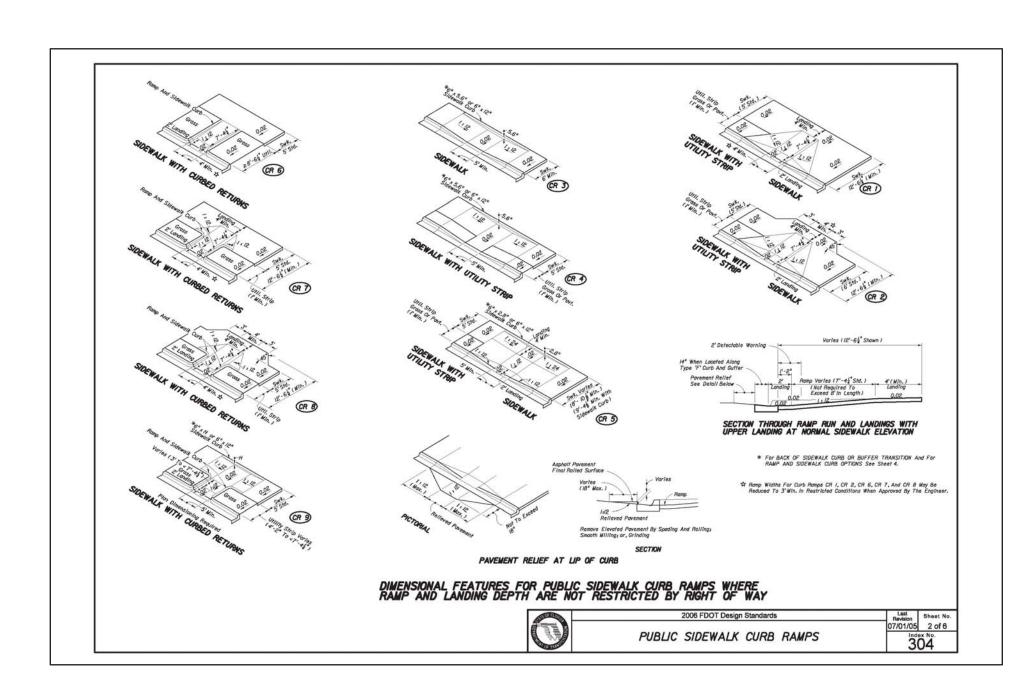

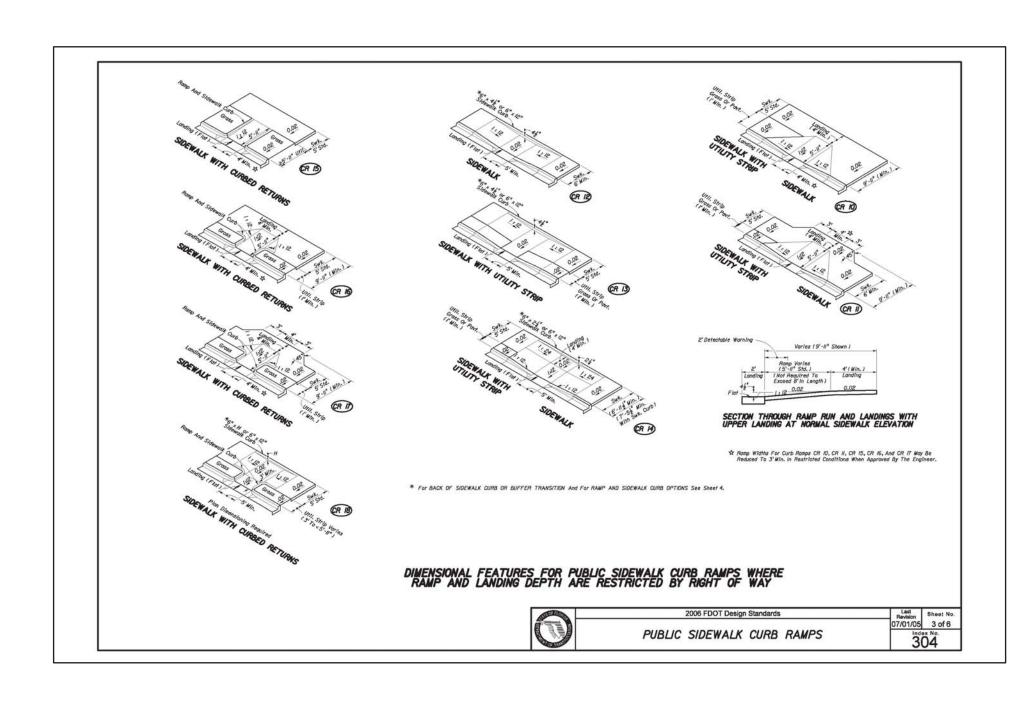

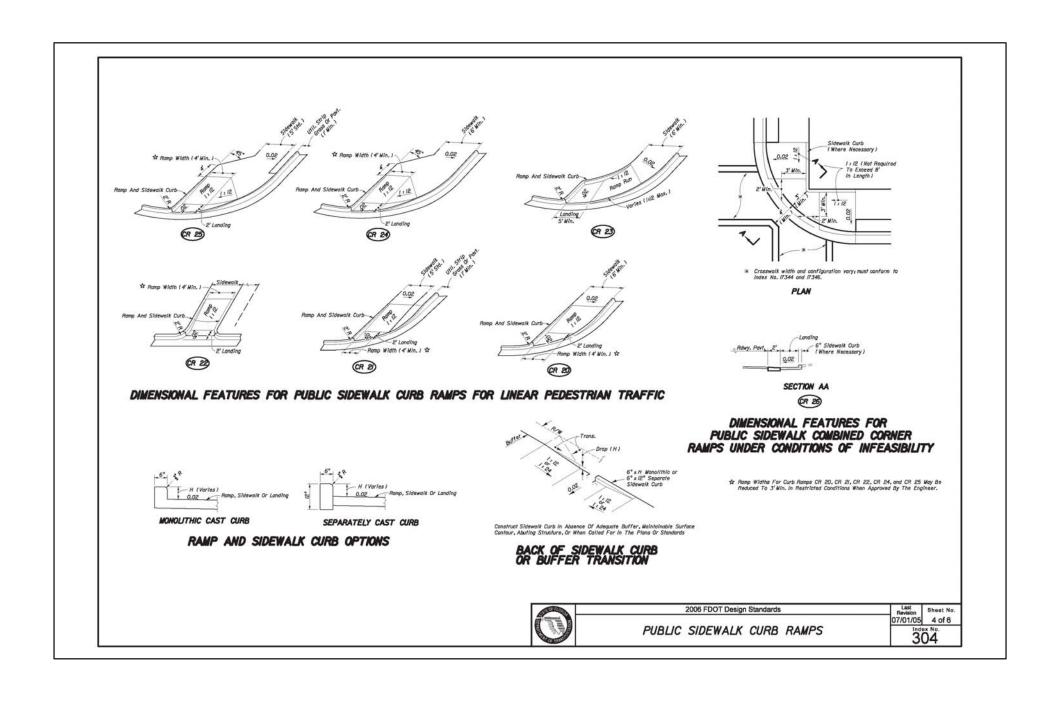

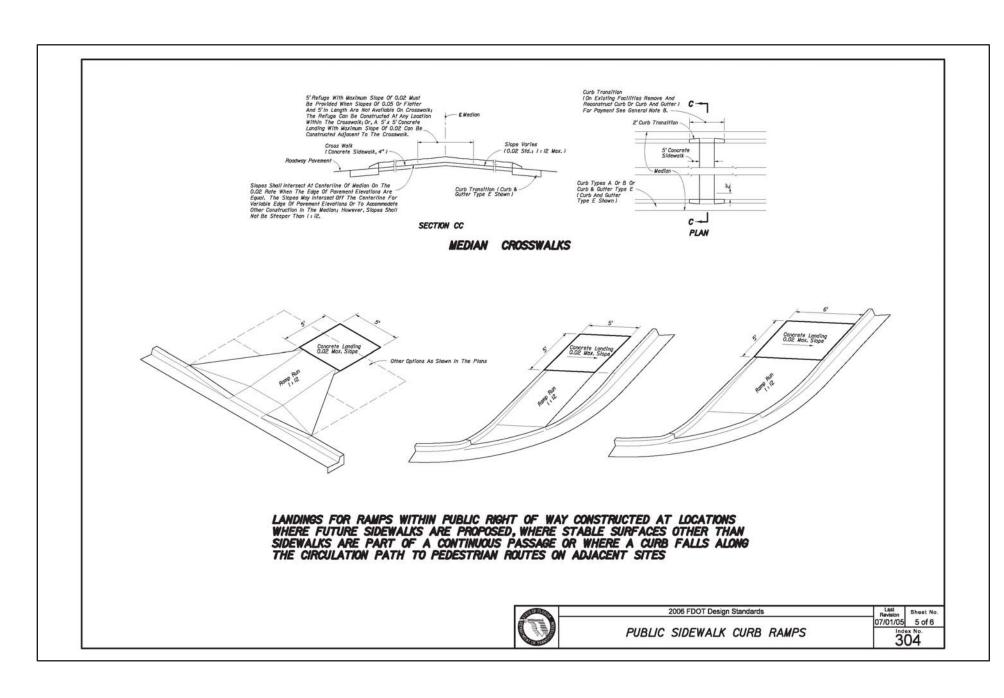


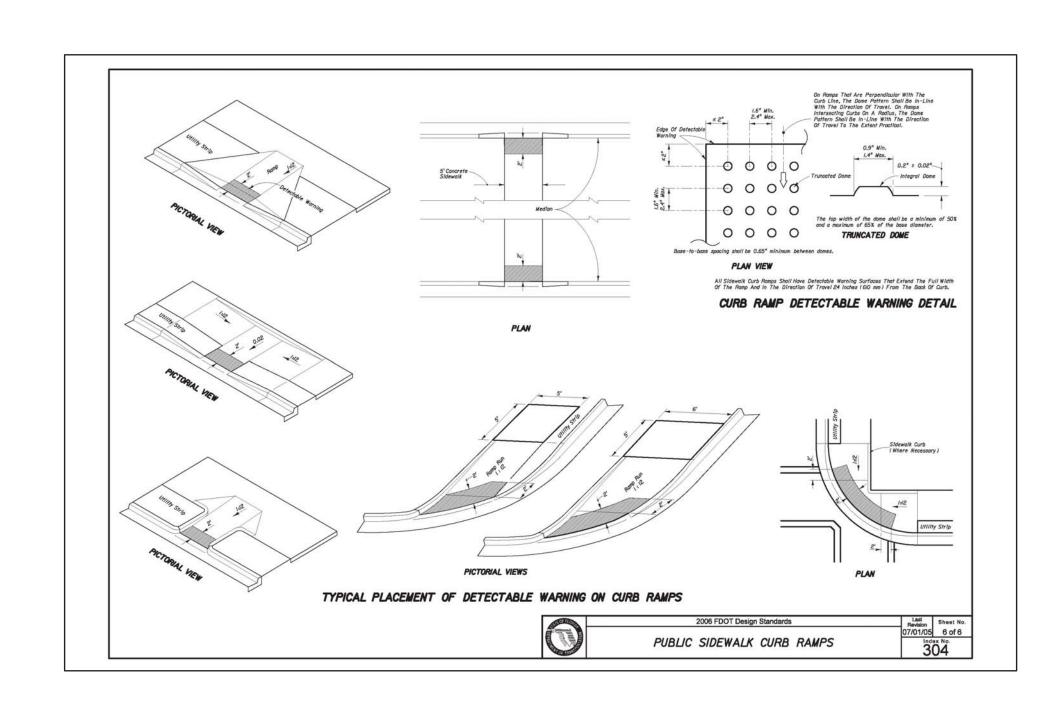

DATE	REVISION
7/22/09	City / SJRWMD Comments
11/17/09	FDOT / Town Comments
6/21/21	Town Comments

FDOT Details

Howey Self Storage

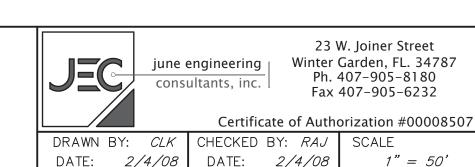


JOB NO. 07-0398

SHEET

JEFFREY A. SEDLOFF
PE# 51506

OF 10

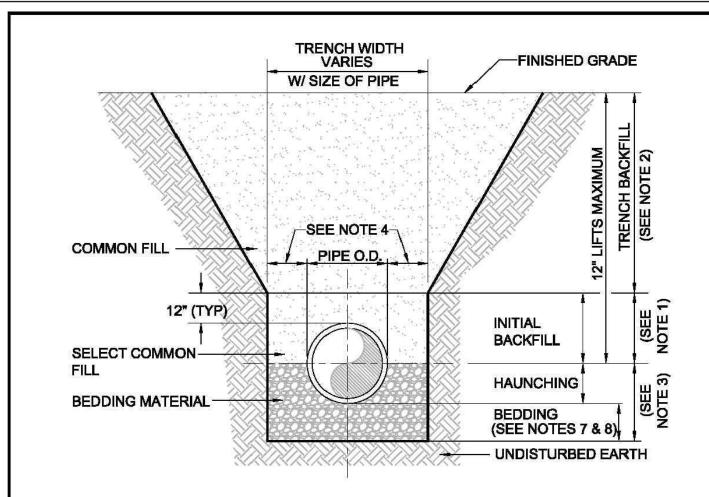

- 1. INITIAL BACKFILL: SELECT COMMON FILL COMPACTED TO 95% OF THE MAXIMUM DENSITY AS PER AASHTO T-180.
- 2. TRENCH BACKFILL: COMMON FILL COMPACTED TO 95% OF THE MAXIMUM DENSITY AS PER AASHTO T-180.
- 3. TYPE A BEDDING MATERIAL SHALL CONFORM TO FDOT NO. 57 AGGREGATE. 4. 15" MAX. (12" MIN.) FOR PIPE DIAMETER LESS THAN 24" AND 24" MAX (12" MIN) FOR PIPE
- DIAMETER 24" AND LARGER.
- 5. WATER SHALL NOT BE PERMITTED IN THE TRENCH DURING CONSTRUCTION. 6. ALL PIPE TO BE INSTALLED WITH BELL FACING UPSTREAM TO THE DIRECTION OF THE
- . BEDDING DEPTH SHALL BE 4" MINIMUM FOR PIPE DIAMETER UP TO 12" AND 6" MINIMUM FOR PIPE DIAMETER 16" AND LARGER.
- 8. DEPTH FOR REMOVAL OF UNSUITABLE MATERIAL SHALL GOVERN DEPTH OF BEDDING
- ROCK BELOW THE PIPE. UTILITIES SHALL DETERMINE IN THE FIELD REQUIRED REMOVAL OF UNSUITABLE MATERIAL TO REACH SUITABLE FOUNDATION.
- . FINAL RESTORATION IN IMPROVED AREAS SHALL BE IN COMPLIANCE WITH ALL APPLICABLE REGULATIONS OF GOVERNING AGENCIES. SURFACE RESTORATION WITHIN TOWN OF HOWEY-IN-THE-HILLS RIGHT-OF-WAY SHALL COMPLY WITH REQUIREMENTS OF R/W UTILIZATION REGULATIONS AND ROAD CONSTRUCTION SPECIFICATIONS.



SET TOP OF VALVE BOX

TO FINISHED GRADE

FINISHED GRADE—

ADJUSTABLE SCREW

TYPE DUCTILE IRON

VALVE BOX

TOWN OF HOWEY-IN-THE-HILLS CONSTRUCTION STANDARD DETAILS

BEDDING AND TRENCHING TYPE A DATE: NOV. 2007 FIGURE A101

-LOOP WIRE


-CONCRETE COLLAR


IN UNPAVED AREAS


- COMPACTED SELECT


-TEST STATION BOX


COMMON FILL

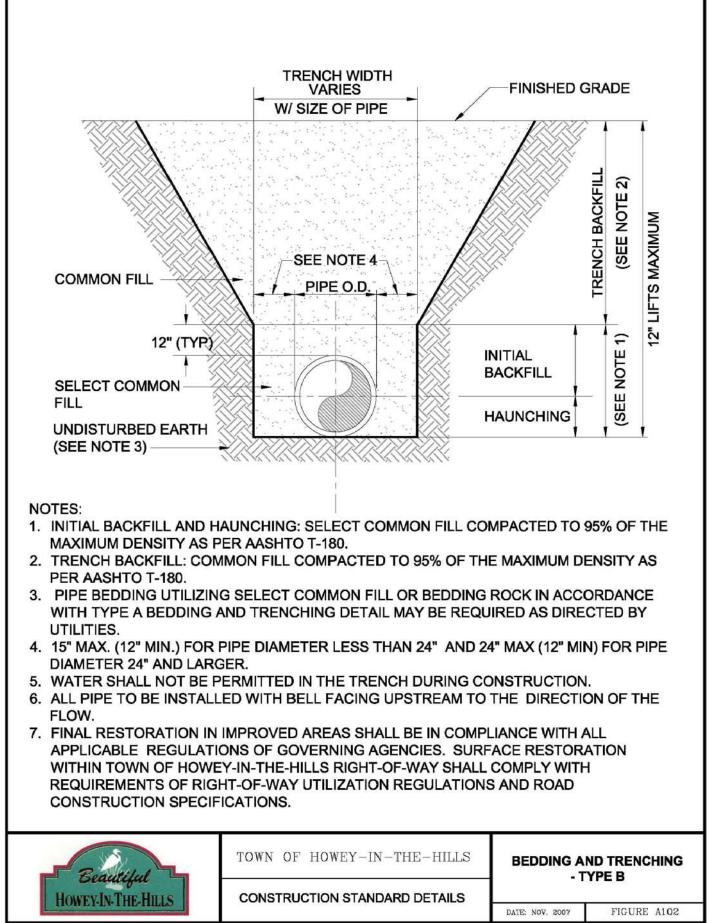


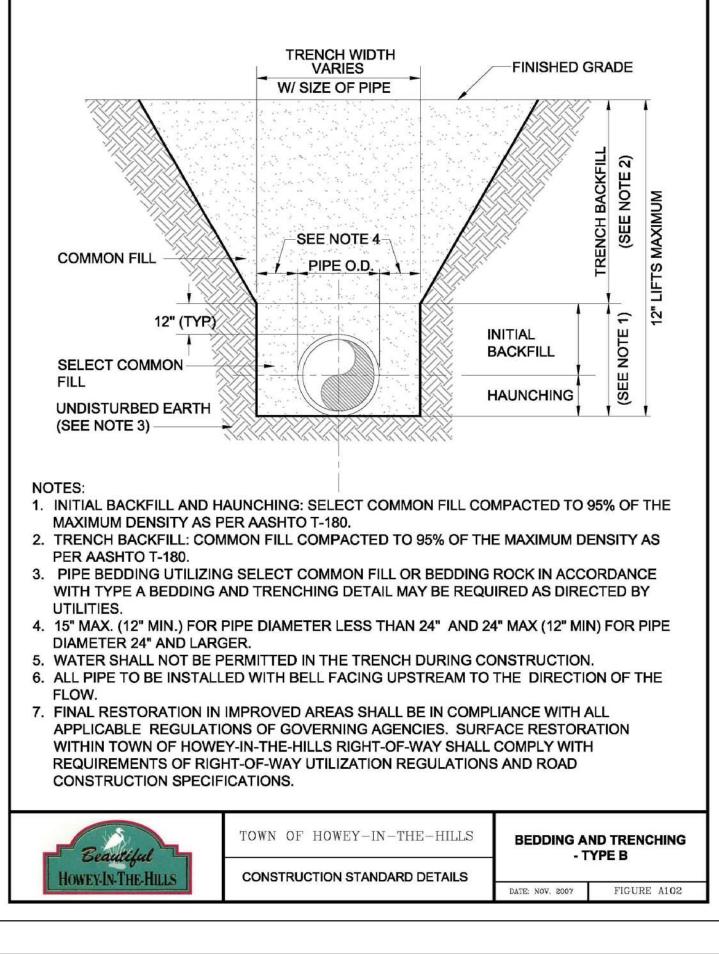


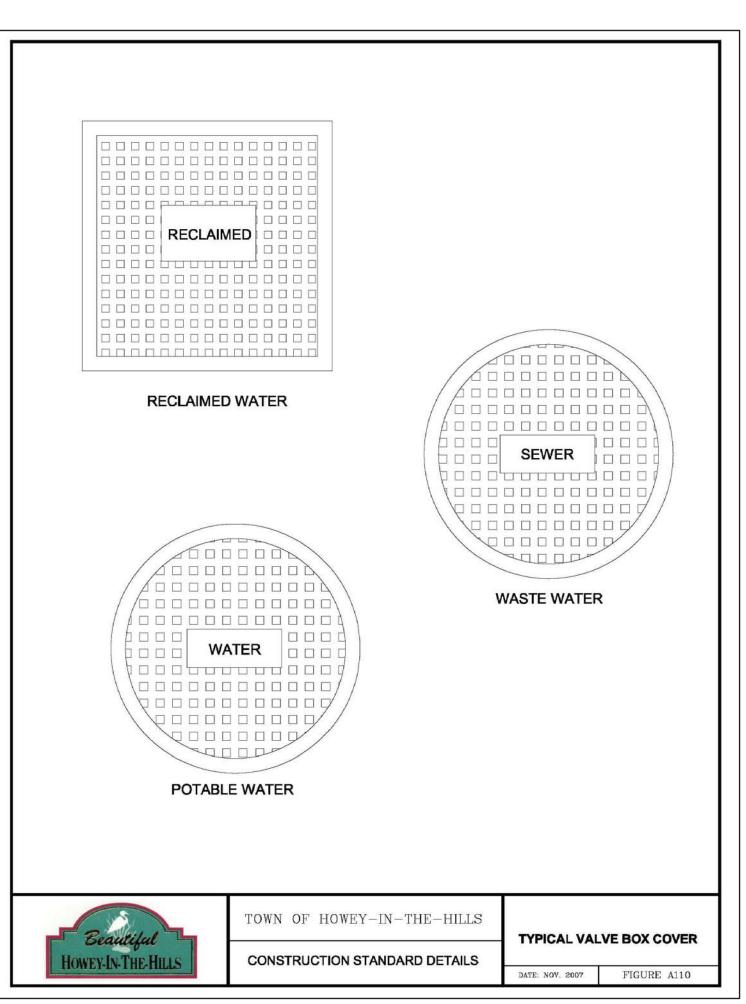

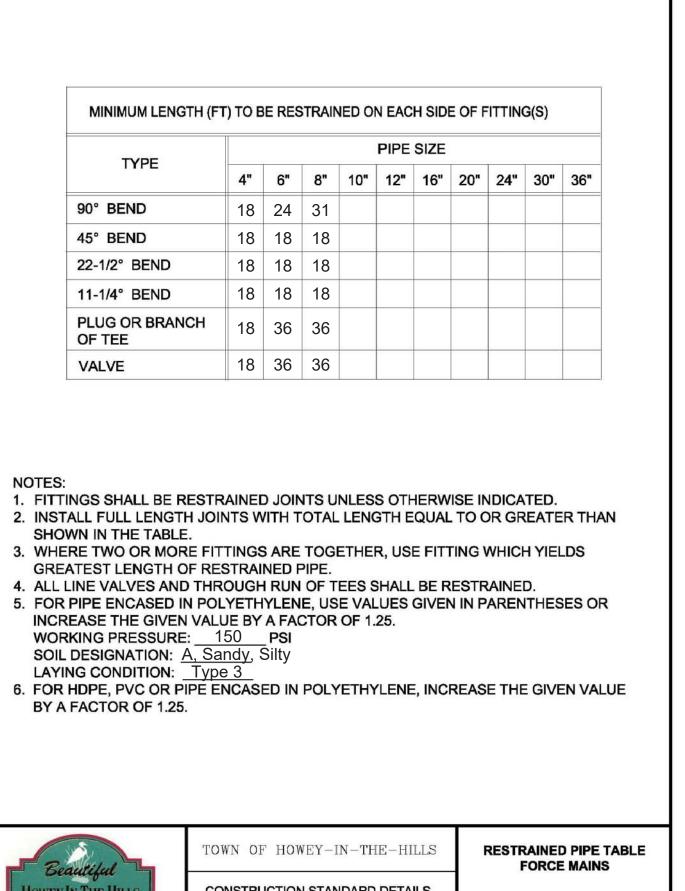


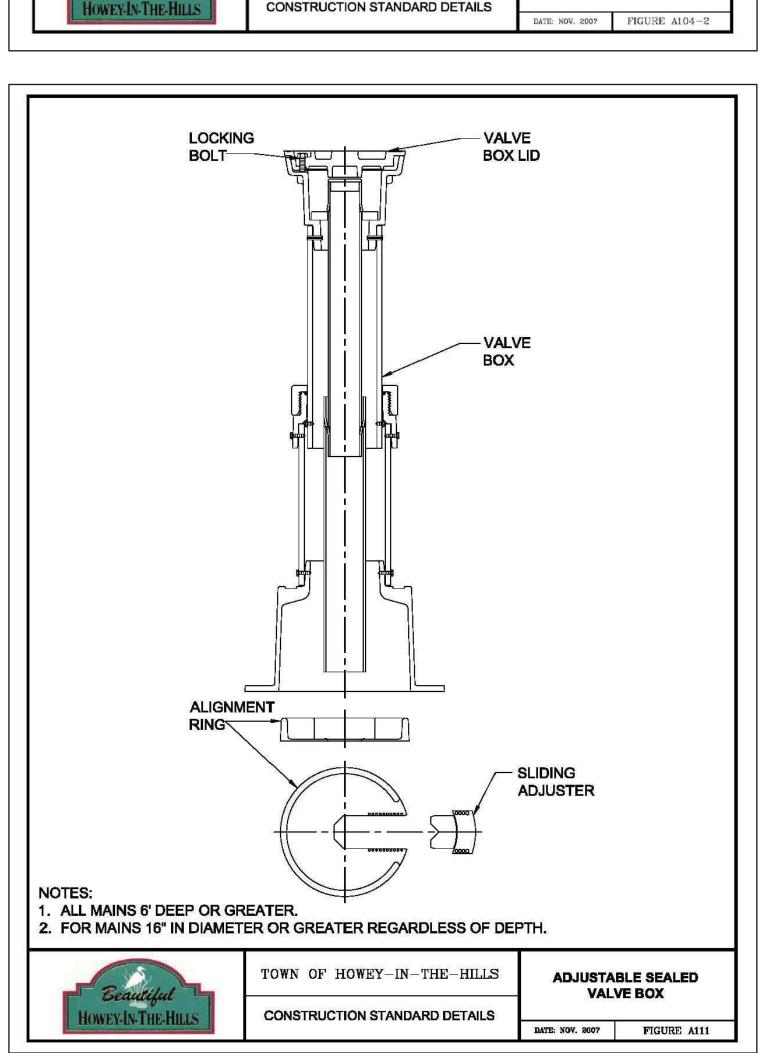


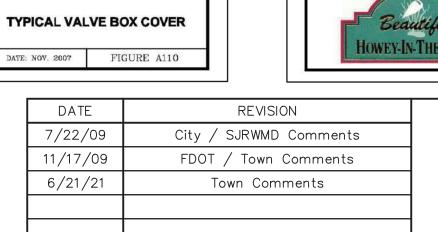


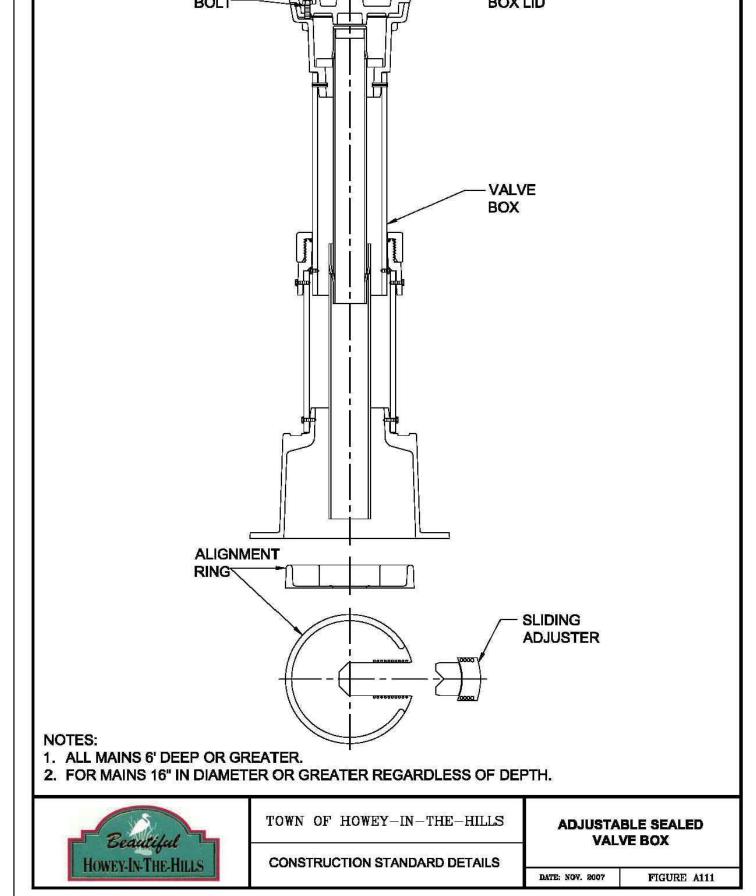





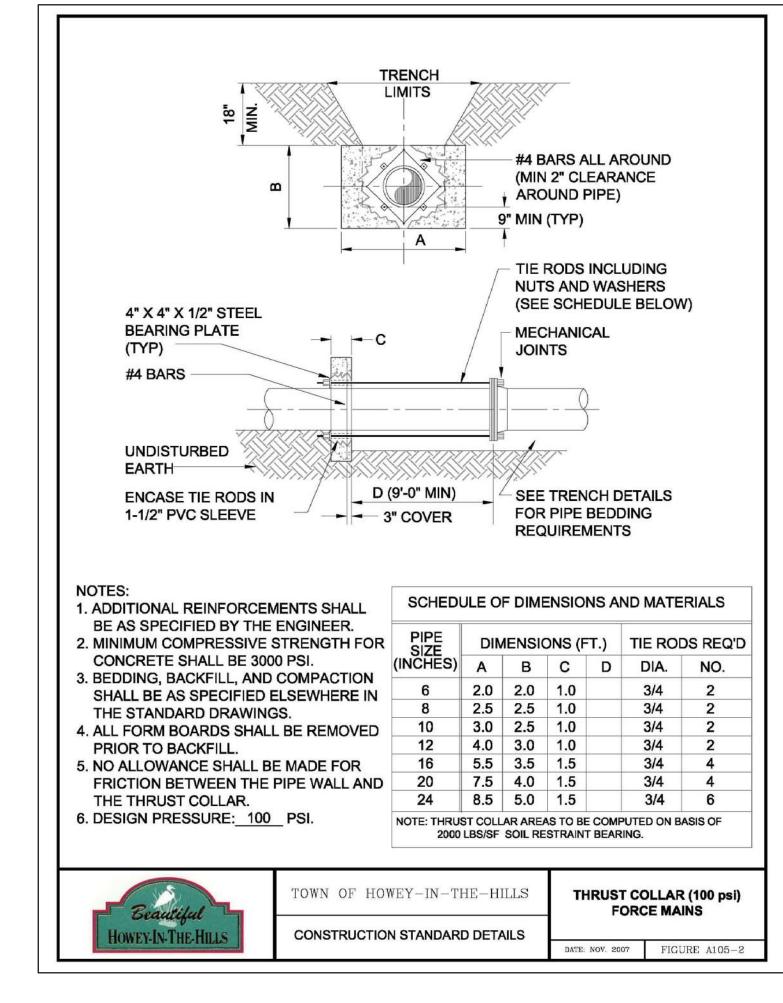


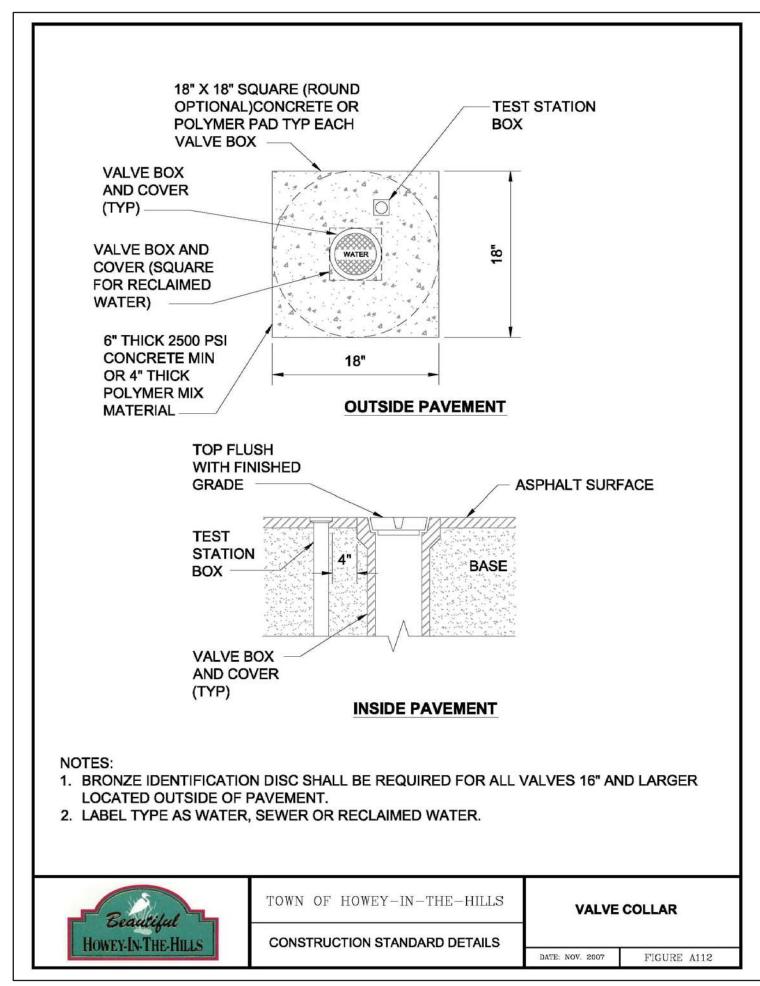


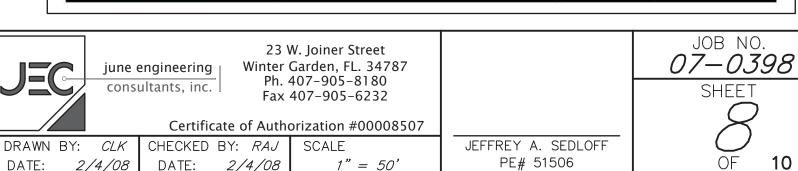


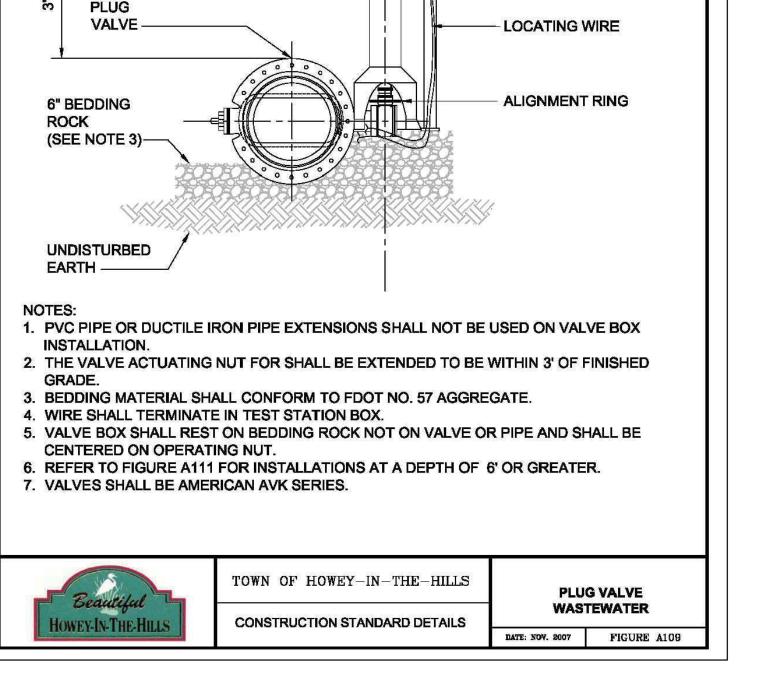

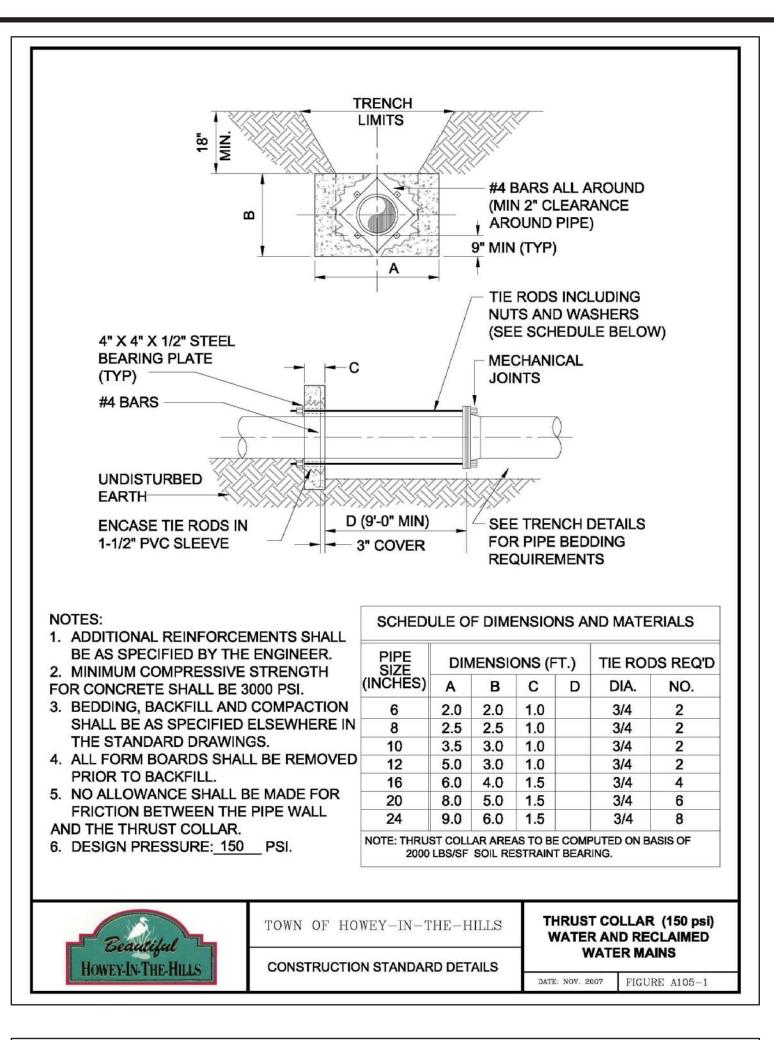

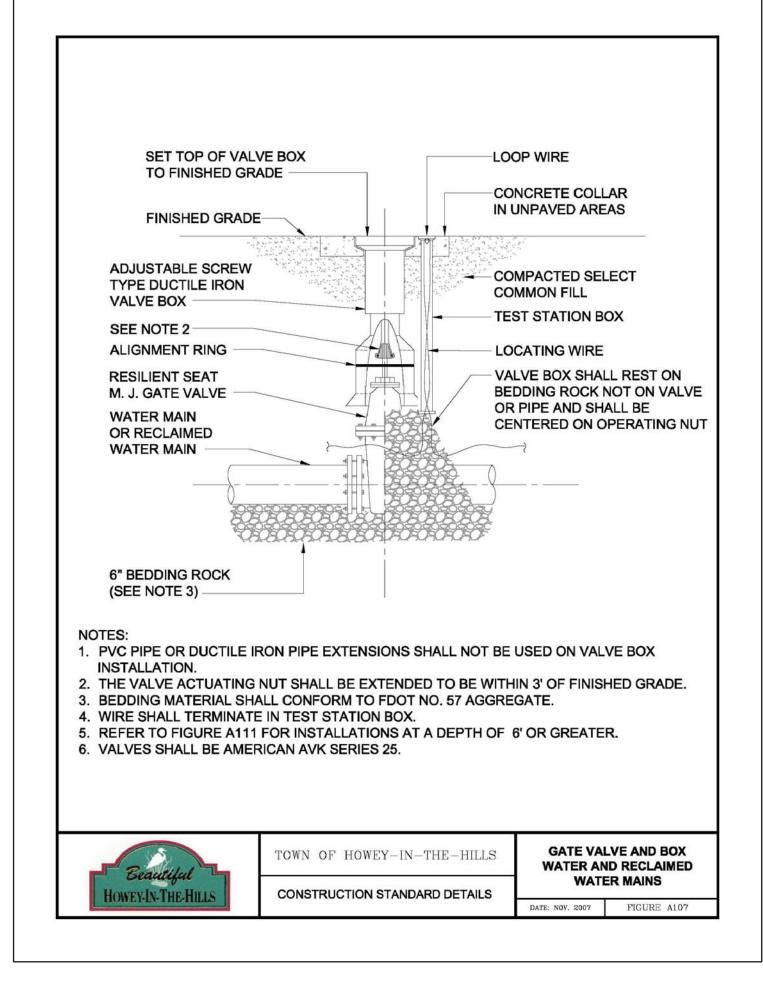

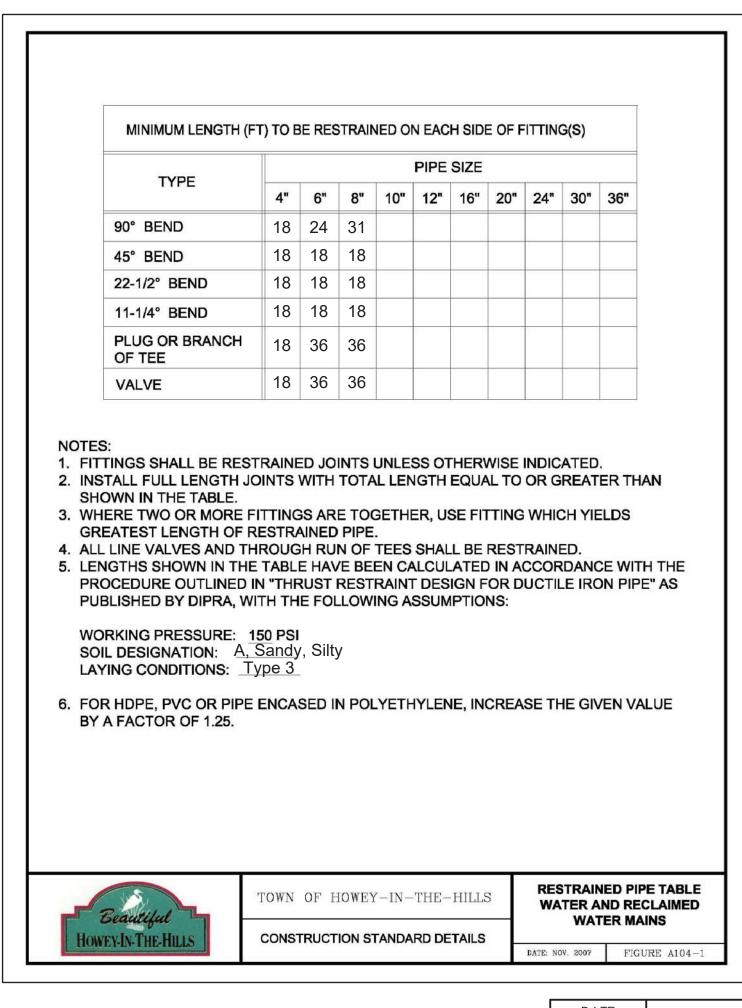

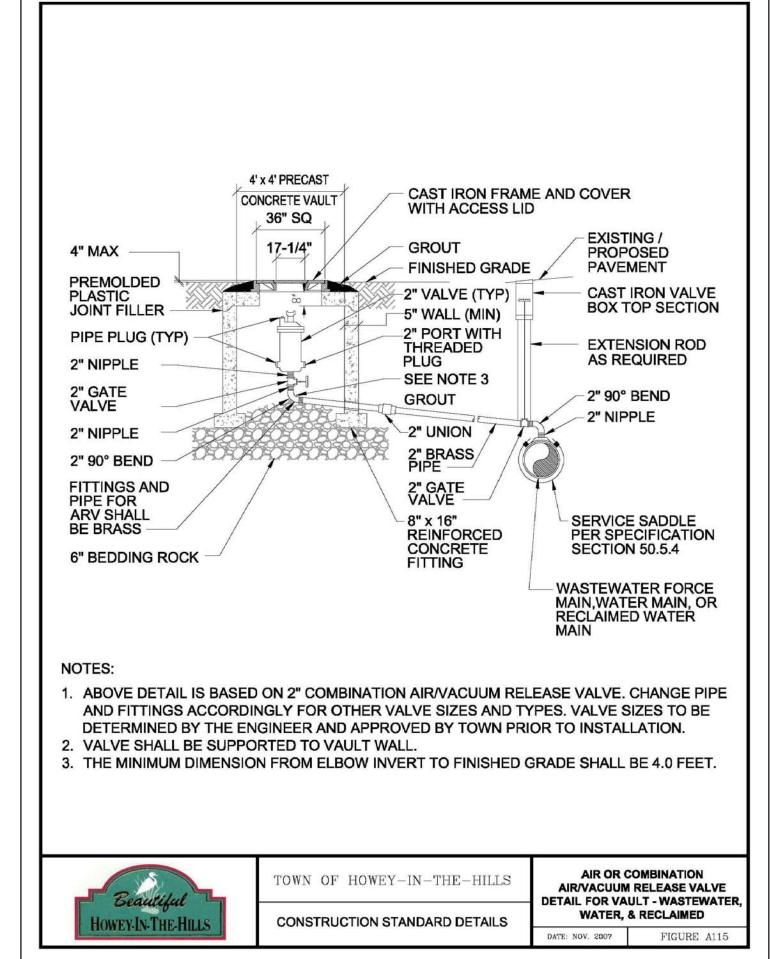

GENERAL NOTES:

LOCATIONS.

CONTRACTOR FOR PIPE EMERGENCIES.

ASSOCIATED WITH THE REPAIR.

FDEP AND UTILITIES.

AS REQUIRED.

PROTECTED AGAINST DAMAGE DURING CONSTRUCTION.

MANHOLE COVERS, ETC IN CONFLICT WITH ROADWAY.

THE CONTRACTOR SHALL EXERCISE EXTREME CAUTION WHEN EXCAVATING IN

THE PUBLIC WORKS DEPARTMENT (352) 324-2290 SHALL BE NOTIFIED BY THE

FACILITIES WITHIN THE LIMITS OF THE PROJECT SHALL BE SUPPORTED AND

PROXIMITY OF WATER MAINS, WASTEWATER FORCE MAINS, GRAVITY MAINS AND

RECLAIMED WATER MAINS. MAIN LOCATIONS SHOWN ON PLANS ARE NOT EXACT OR GUARANTEED. CONTRACTOR IS RESPONSIBLE FOR FIELD VERIFYING EXISTING UTILITY

ALL EXISTING WATER, FORCE, GRAVITY AND RECLAIMED WATER MAINS AND OTHER

CONTRACTOR SHALL ADJUST VALVE BOXES, AIR RELEASE VALVES, FIRE HYDRANTS,

THE CONTRACTOR, AT THE CONTRACTOR'S EXPENSE, SHALL IMMEDIATELY REPAIR ALL

THE PUBLIC WORKS DEPARTMENT SHALL BE NOTIFIED AT LEAST SEVEN (7) DAYS PRIOR

TIMELY MANNER, AS DETERMINED BY UTILITIES, UTILITIES MAY PERFORM REQUIRED

REPAIRS AND CLEANUP. THE CONTRACTOR WILL BE CHARGED FOR ALL EXPENSES

DAMAGES TO UTILITIES' MAINS AND FACILITIES. IF THE REPAIR IS NOT MADE IN A

ONLY UTILITIES SHALL OPERATE WATER, WASTEWATER, AND RECLAIMED WATER

THE CONTRACTOR SHALL COORDINATE ALL PUMP STATION OPERATION AND SHUT

VALVES. COORDINATE VALVE OPERATION WITH APPROPRIATE UTILITIES INSPECTOR.

DOWN CONTROL WITH A UTILITIES INSPECTOR. THE CONTRACTOR SHALL PROVIDE FOR

BYPASSING AND/OR HAULING OF WASTEWATER DURING THE INTERRUPTION OF FLOWS

ALL NEW VALVES BEING INSTALLED SHALL REMAIN CLOSED DURING CONSTRUCTION.

KEEP VALVES ON ALL WET TAPS CLOSED UNTIL CLEARED BY FDEP. DO NOT CONNECT

BOXES, AND MANHOLES SHALL BE PROTECTED AND ADJUSTED TO FINISHED GRADE AS

SHOWN ON THE DRAWINGS. ALL EXISTING ABOVE GROUND VALVES TO BE RELOCATED,

MAKE TEMPORARY CONNECTIONS TO AN EXISTING POTABLE WATER SOURCE; FLUSH

TOWN OF HOWEY-IN-THE-HILLS

CONSTRUCTION STANDARD DETAILS

OUT NEW WATER MAIN WITH POTABLE WATER (USE "JUMPER" ASSEMBLY WITH

REDUCED PRESSURE ASSEMBLY BACKFLOW PREVENTER TO MAKE TEMPORARY

ANY PROPOSED WATER MAIN TO ANY EXISTING WATER MAIN UNLESS CLEARED BY


10. ALL EXISTING AND NEW TOWN OF HOWEY-IN-THE-HILLS UTILITIES VALVES, VALVE

TO ANY CONSTRUCTION ACTIVITY WITHIN PROXIMITY OF ANY UTILITIES.

AND CONNECTIONS WITH EXISTING WASTEWATER SYSTEMS.

CONNECTIONS TO AN EXISTING WATER SOURCE).

MJ TAPPING SLEEVE —— RESTRAINED **RESILIENT SEAT EXISTING** MECHANICAL JOINT TAPPING GATE — PLUG VALVE — RESTRAINED **MECHANICAL** JOINT-PLAN

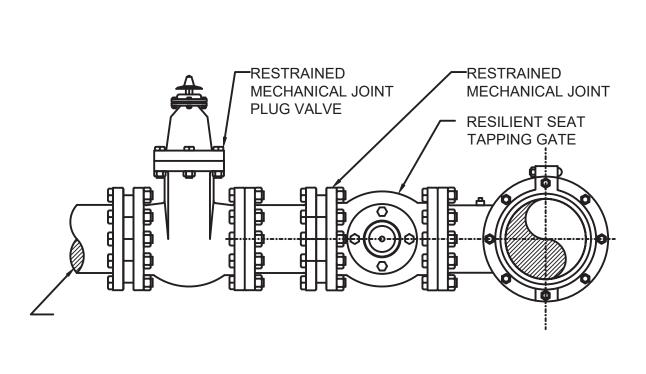

DATE REVISION City / SJRWMD Comments 7/22/09 FDOT / Town Comments 11/17/09 6/21/21 Town Comments



07-0398 SHEET


GENERAL NOTES

FIGURE A122

DATE: NOV. 2007

OF

23 W. Joiner Street Standard Details Winter Garden, FL. 34787 june engineering | Ph. 407-905-8180 Fax 407-905-6232 Certificate of Authorization #00008507 Howey Self Storage DRAWN BY: CLK CHECKED BY: RAJ SCALE JEFFREY A. SEDLOFF PE# 51506 DATE: 2/4/08 DATE: 2/4/08

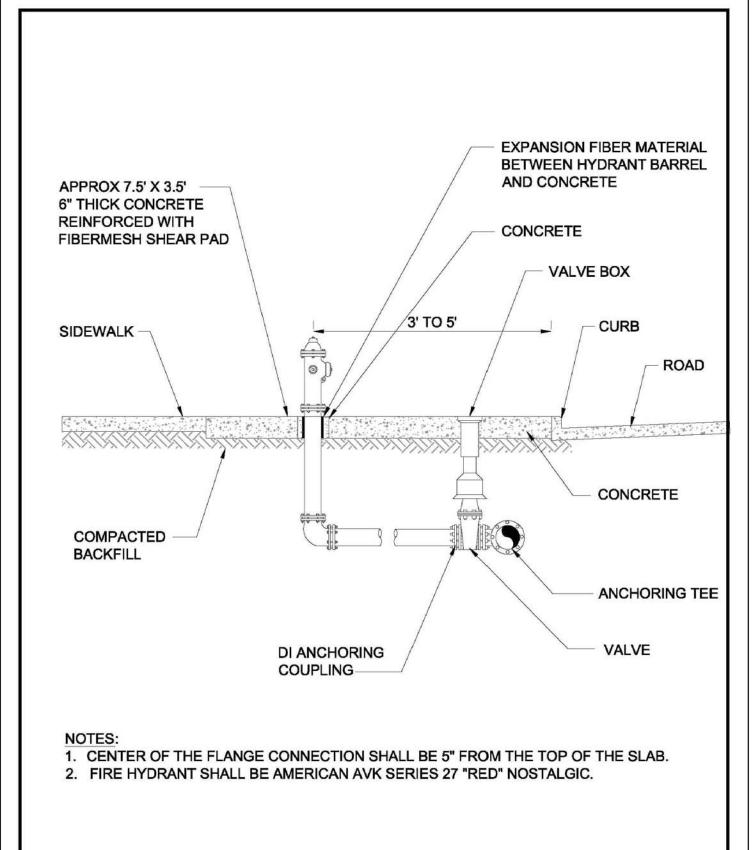

TOWN OF HOWEY-IN-THE-HILLS

CONSTRUCTION STANDARD DETAILS

STANDARD DRAWINGS

FIRE HYDRANT ASSEMBLY

DATE: NOV. 2007 FIGURE A203

RILEY & Company, Inc. (H-20 GP)

w/BATTERY BACK-UP FOR AUDIO AND VISUAL ALARMS

SCOPE: Supply one complete H-20 GP Pre-Fab Lift Station, per design.

Pumps shall be capable of grinding and pumping domestic & commercial sewage

Complete system shall be supplied by:

RILEY & Company, Inc. Sanford, FL 32773 (Ph. 407-265-9963)

NO SUBSTITUTIONS - NO ALTERNATES

The H-20 Load Rated Fiberglass Wetwell Must Be Warranted For 20 Years And Manufactured By L.F. Manufacturing, Giddings, Texas.

After the H-20 load rated wetwell has been installed, the ASTM Certification Number and Serial Tracking Number must be visible.

PUMPS: Submersible grinder pumps shall be HOMA Model GRP. The pumps shall be installed in the H-20 GP FRP wetwell utilizing a dual slide rail system. The grinder unit shall be capable of macerating materials normally found in domestic and commersial sewage into a fine slurry which will pass through the pump and the Sch.80 PVC discharge piping.

> Stator winding shall be open type with Class F insulation and shall be heatshrink fitted into the stator housing. The use of pins, bolts, or other fastening devices is not acceptable.

A heat sensor theromstat shall be attached to the top end of the motor winding and shall be connected in series with the magnetic contactor coil in the control panel to stop motor if winding temperature exceeds 140 C., but shall automatically reset when the winding temperature returns to normal. Two heat sensor thermostats shall be used on three phase motors.

The pump motor grinder shaft shall be AISI 430F SS threaded to take the pump impeller and the grinder impeller.

Upper & lower mechanical seals shall be Silicon Carbide vs Silicon Carbide.

DUPLEX CONTROL PANEL:

Control panel shall be assembled and built by a TUV (UL508A CERTIFIED) manufacturing facility.

The Enclosure shall be NEMA 4X, minimum 30" high x 30" wide x 10" deep fiberglass with padlockable draw latches.

The enclosure shall have external mounting feet to allow for wall mounting.

The following components shall be mounted through the enclosure:

- 1- ea. Red Alarm Beacon (Light) 1- ea. Alarm Horn
- 1- ea. Generator Receptacle w/ weatherproof cover
- 1- ea. Alarm Silence Pushbutton

The backpanel shall be fabricated from .125, 5052-H32 marine alloy aluminum. All components shall be mounted by machined stainless steel

The following components shall be mounted to backpanel:

- 2- ea. Motor Contactors 1- ea. Volt Monitor (Single Phase) Phase Monitor (Three Phase)
- 1- ea. Control Transformer (480 Volt Only)
- 1- ea. Silence Relay
- 1- ea. Duplex Alternator
- 1- ea. Model BOAC5AH Battery Back-Up w/ Smart Charger
- 20- ea. Terminals For Field Connections
- 6- ea. Terminals For Motor Connections (Single Phase Only)
- 3- ea. Grounding Lugs

The innerdoor shall be fabricated from .080, 5052-H32 marine alloy aluminum. The innerdoor shall have a continuous aluminum piano

The following components shall be mounted through the innerdoor:

- 1- ea. Main Circuit Breaker
- 1- ea. Emergency Circuit Breaker
- 1- ea. Mechanical Interlock For Emergency And Main Breakers 2- ea. Short Circuit Protectors
- 1- ea. Control Circuit Breaker
- 2- ea. Seal Failure Indicator Lights 1- ea. Hand-Off-Auto Selector Switches
- 2- ea. Pump Run Pilot Lights
- 1- ea. Power On Pilot Light
- 2- ea. Elapse Time Meters (Non-Resetable)
- 1- ea. GFI Duplex Convenience Outlet

COMPONENT SPECIFICATIONS:

All circuit breakers shall be molded thermal magnetic. The mechanical interlock shall prevent the normal and emergency main breakers being energized at the same

An emergency generator receptacle shall be supplied in accordance with DEP standards. The generator receptacle shall be adequately sized to meet the equipment operating

NEUTRAL TO BE SUPPLIED FOR BOTH 230V 3PHASE OR 230V SINGLE PHASE POWER

All motor short circuit protection devices must provide for undervoltage release and class 10 overload protection on all three phases. Visable trip indication, test, and reset capability must be provided without opening inner door. Open frame, across the line, contactors shall be rated per IEC standards and properly sized per the motor requirements. Contactors shall provide for safe touch power and control terminals.

Lightning Arrestor shall meet or exceed the requirements of ANSI/IEEE Std. C62.21-1984 section 8.6.1. and 8.7.3 shall be supplied by electrician and mounted on the bottom side of the switch disconnect ahead of the pump control panel. A voltage monitor shall be supplied for single phase service. A phase monitor shall be supplied for (3) phase service. A green pilot light shall be supplied for each motor. The pilot light shall illuminate each time the motor is called to run. Each pump shall have an Elapse Time Meter to record the accumulated run time. The ETM shall be 2" diameter, non-resettable, six digit, totally encapsulated unit. A Red pilot light shall be supplied for control power. The pilot light shall illuminate when the control power is available inside

the control panel. Relays shall be ice-cube plug in type. Relay contacts shall be rated 10 amp minimum. DPDT.

Twenty (20) terminals shall be supplied for field connections. The terminals shall be rated 25 amps minimum. Each motors over-temperature contact shall be connected to the terminal strip and shall open a contact to de-energize the appropriate motor upon a high temperature within the motor. A 15 Amp GFI duplex receptacle shall be supplied and

mounted on the innerdoor. Ground lugs shall be supplied and appropriately sized for each motor and for service entrance.

Nameplates for the innerdoor and back panel shall be of a graphic design, specifically depicting the intent for each device.

MISCELLANEOUS: All wiring on the backpanel shall be containted within the wiring duct. All wiring between the innerdoor and the backpanel shall be contained with in a plastic spiral wrap. Each wire shall have a wire number at each end to correspond to the as built drawing for field troubleshooting.

The control panel shall be assembled by a TUV (UL508A Certified) manufacturing facility.

PUMP DATA

PRIMARY PUMP CAPACITY

PUMP MANUFACTURER

ELECTRICAL/ VOLTS / PHASE

1. DRAWING NOT TO SCALE

PUMP DISCHARGE SIZE

IMPELLER DIAMETER

PRIMARY TDH

PUMP MODEL #

HORSEPOWER

R.P.M.

FASTNERS & APPURTANCES: All fasternes, lifting cables, float cable bracket, hinges, and appurtances shall be made of AISI

A 304SS slide/latch assembly shall be provided tor holding the doors open on the wetwell and valve box. Slide rails shall be made of SCH.40 AISI 304SS pipe. Pump lifting cables shall be made of AISI 304 SS.

H-20 LOAD RATED WETWELL WITH LIFTING LUGS:

Pump lifting bales shall be made of AISI 304 SS.

The fiberglass wetwell must be H-20 load rated with integral lifting lugs, fiberglass slope in bottom of wetwell and valve box. Certification of the H-20 load rating must be supplied at the time of submittals to Engineer.

The wetwell shall be manufactured of fiberglass reinforced polyester (FRP) of depth and diameter as shown on the lift station elevation detail. The wall thickness shall be adequate for the depth of the wetwell to maintain the H-20 LOAD RATING.

EXECUTION:

ELEVATIONS

BOTTOM OF WETWELL 79.00

83.25

83.00

82.50

81.00

TOP OF WETWELL

HIGH LEVEL ALARM

WETWELL DIAMETER

INLET INVERT

2nd PUMP ON

1st PUMP ON


PUMPS OFF

Installation shall be in strict accordance with the manufacturer's recommendations in the locations shown on the drawing.

INSPECTION & TESTING: A factory representative shall be provide for a one (1) time start-up and shall have complete knowledge of the proper operation and maintenance of complete system. Megger the motors. The pump motors shall be megged out prior to the start-up to ensure that the


insulation of the pump motor/cable is intact. The pump controls and pumps shall be checked for mechanical reliability and proper operation.

LIFT STATION SHALL BE PRIVATELY OWNED AND MAINTAINED.

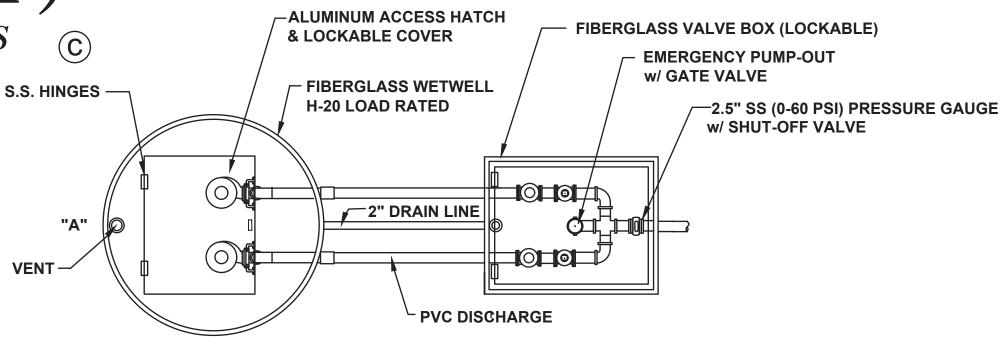


NOTE: PUMP CONTROL PANEL SHALL BE LOCATED 3 FEET FROM WETWELL PERIMETER AT POINT "A"

LIFT STATION PLAN

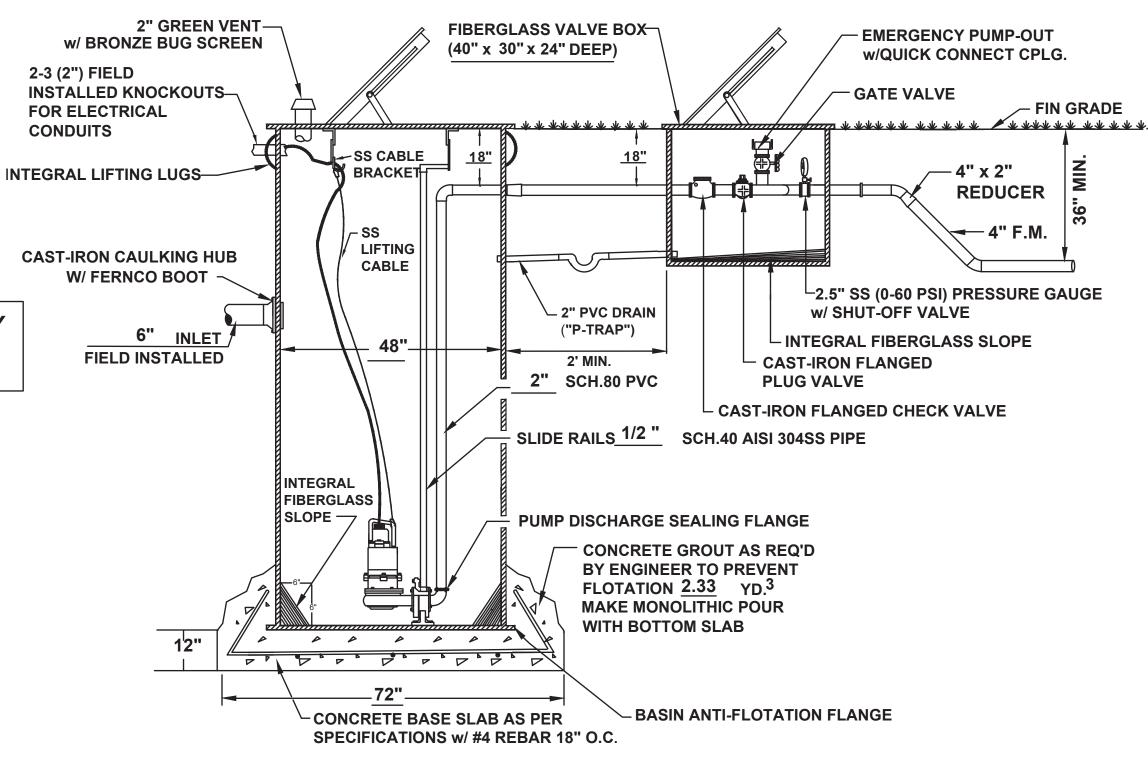

LIFT STATION SECTION

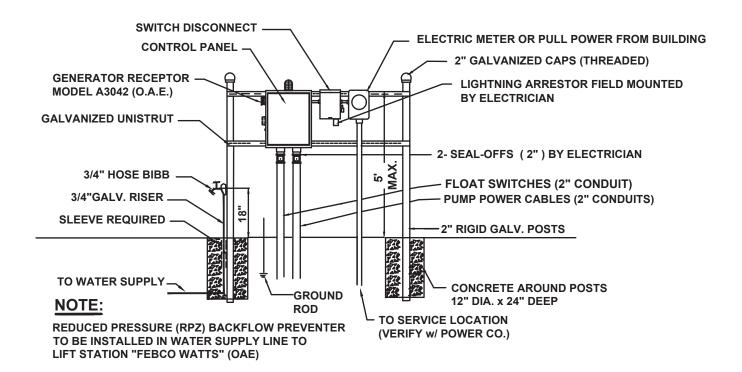

ELECTRICAL RISER

DRAWN **CHECKED** SCALE JOB NO. 10 of 10

REVISIONS

RILEY & CO. / H-20 GP 06-19-08

* 5. CONTRACTOR SHALL VERIFY POWER SOURCE PRIOR TO ORDERING EQUIPMENT * 6. NEUTRAL TO BE SUPPLIED FOR 23OV-3 PHASE OR 230V-SINGLE PHASE POWER.

* 2. ALL ELECTRICAL WORK SHALL BE IN ACCORDANCE WITH LOCAL CODES

* 4. ELECTRICIAN TO MOUNT LIGHTNING ARRESTOR AT SWITCH DISCONNECT

118.0 *GPM*

45.1 'TDH


GRP34/1/C


4.0

5 7/8"

* ELECTRICIAN NOTES:

* 3. ELECTRICIAN SHALL SEAL OFF CONDUIT RUNS

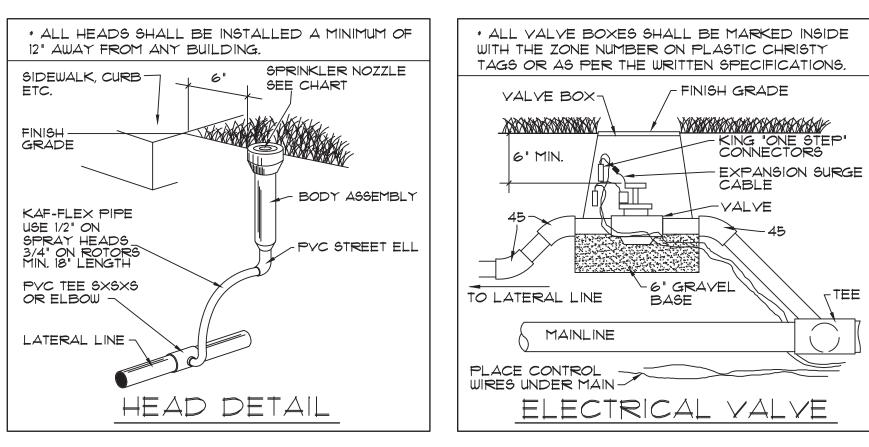

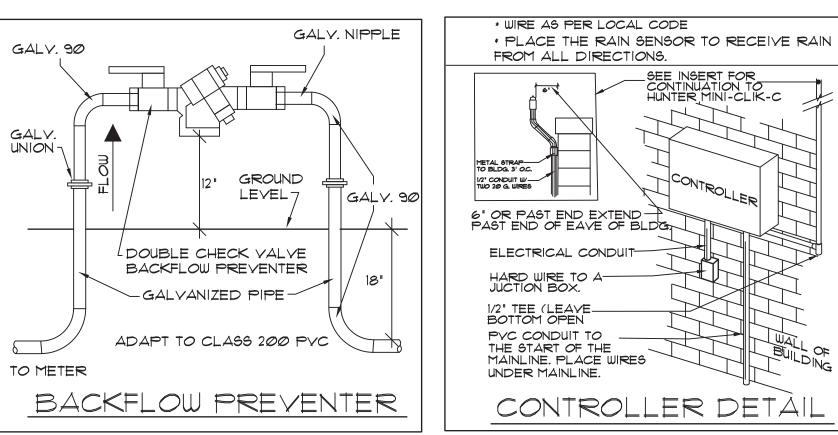

	NDZZ	LE CHART		
Symbol	Description	Pressure	Flow	Radius
А	Rain Bird SQ-HLF (Low Volume)	30 psi	0.20 gpm	4 Ft
В	Rain Bird U-8H	30 psi	0.52 gpm	8 Ft
С	Rain Bird U-8F	30 psi	1.05 gpm	8 Ft
D	Rain Bird SQ-F (Low Volume)	30 psi	0.40 gpm	4 Ft

<u>Irrigation Notes:</u>

1) REFER TO THE LANDSCAPE PLANS WHEN TRENCHING TO AVOID TREES AND SHRUBS. HAND DIG AROUND ANY EXISTING TREES.

2) ALL MAINLINE PIPING SHALL BE BURIED TO A MINIMUM DEPTH OF 18" OF COVER. ALL LATERAL PIPING SHALL BE BURIED TO A MINIMUM DEPTH OF 12" OF COVER.

3) ALL POP-UP ROTORS AND SPRAYS SHALL BE INSTALLED USING AN 18" PVC FLEX

PIPE CONNECTION. DO NOT USE POLYETHLENE PIPE.

4) ADJUST ALL NOZZLES TO REDUCE WATER WASTE ON HARD SURFACES & BLDG. WALLS. THROTTLE ALL VALVES ON SHRUB LINES AS REQUIRED TO PREVENT FOGGING. USE ADJUSTABLE NOZZLES WHERE REQUIRED TO AVOID ANY WATER ON BUILDING WINDOWS.

5) ALL VALVES, GATE VALVES AND QUICK COUPLERS SHALL BE INSTALLED IN VALVE BOXES. THE VALVE BOXES SHALL BE PURPLE WHEN USING REUSE WATER.

6) THE CONTRACTOR SHALL EXERCISE CARE SO AS NOT TO DAMAGE ANY EXISTING UTILITIES. THE CONTRACTOR SHALL BE RESPONSIBLE FOR THE IMMEDIATE REPAIRS AND COST OF ANY DAMAGE CAUSED BY THEIR WORK.

7) ALL WORK SHALL BE GUARANTEED FOR ONE YEAR FROM THE DATE OF FINAL ACCEPTANCE AGAINST ALL DEFECTS IN EQUIPMENT AND WORKMANSHIP. (OR AS OUTLINED IN THE WRITTEN SPECIFICATIONS)

8) ELECTRICAL SERVICE TO LOCATION OF THE CONTROLLER, WELL OR PUMP SHALL BE PROVIDED TO A JUNCTION BOX OR DISCONNECT AT THE EQUIPMENT LOCATION BY THE ELECTRICAL CONTRACTOR OR BY OWNER WHEN IT IS NOT PART OF THE BID PACKAGE.

9) IT SHALL BE THE RESPONSIBILITY OF THE CONTRACTOR TO SCALE THE PLAN AND CHECK NOZZLE TYPES TO DETERMINE THE CORRECT SPACING OF THE HEADS. THE CONTRACTOR SHALL NOT SPACE THE HEADS FURTHER APART OR USE LESS HEADS THAN SHOWN ON THE PLAN. ANY CHANGES TO THE HEAD SPACING OR LAYOUT, WITHOUT THE CONSENT OF THE LANDSCAPE ARCHITECT OR OWNER, SHALL HOLD THE IRRIGATION CONTRACTOR RESPONSIBLE FOR WARRANTY OF THE PLANTS AND OR SOD IN

10) 48 HOURS BEFORE DIGGING, CALL 1-800-432-4770 (SUNSHINE STATE ONE CALL CENTER)

11) IRRIGATION RISERS ARE NOT PERMITTED.12) ALL GRASS AREAS SHALL BE TRUCK IRRIGATED FOR THE FIRST 30 DAYS OR UNTIL

12) ALL GRASS AREAS SHALL BE TRUCK IRRIGATED FOR THE FIRST 30 DAYS OR UNTIL GRASS HAS BEEN ESTABLISHED. 13) ALL PLANT BEDS AND TURF AREAS NEED TO BE ON SEPARATE ZONES.

14) LOW VOLUME IRRIGATION NEEDS TO BE USED FOR PLANT BEDS, SHRUBS AND TREE IRRIGATION.


15) CONTRACTOR TO ROUTE IRRIGATION LINES AROUND EXISTING TREES SO AS NOT TO DISTURB THE ROOT SYSTEM.

	Irrigation Legend
	PVC Lateral Line — Size as Shown
	2" PVC Main Line
•	Nozzle Location — See Chart for Specifications
M	1" Irrigation Meter
(<u>C</u>)	RainBird ESP Controller (Rain Sensor at Ea. Controller)
(B)	Backflow Preventer
•	Rain Bird PGA Series Valve (Size Shown on Zone Label) Installed in Ametek 10" Round Valve Box
\oplus	Rain Bird DV Series Valve (Size Shown on Zone Label) Installed in Ametek 10" Round Valve Box (Pressure Regulating Valve)

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	Final irrigation plan approval does not provide exemption from the Town's irrigation standards. Any deviation from the Town's standards must be requested and approved in writing prior to installation.

6/21/21

Town Comments

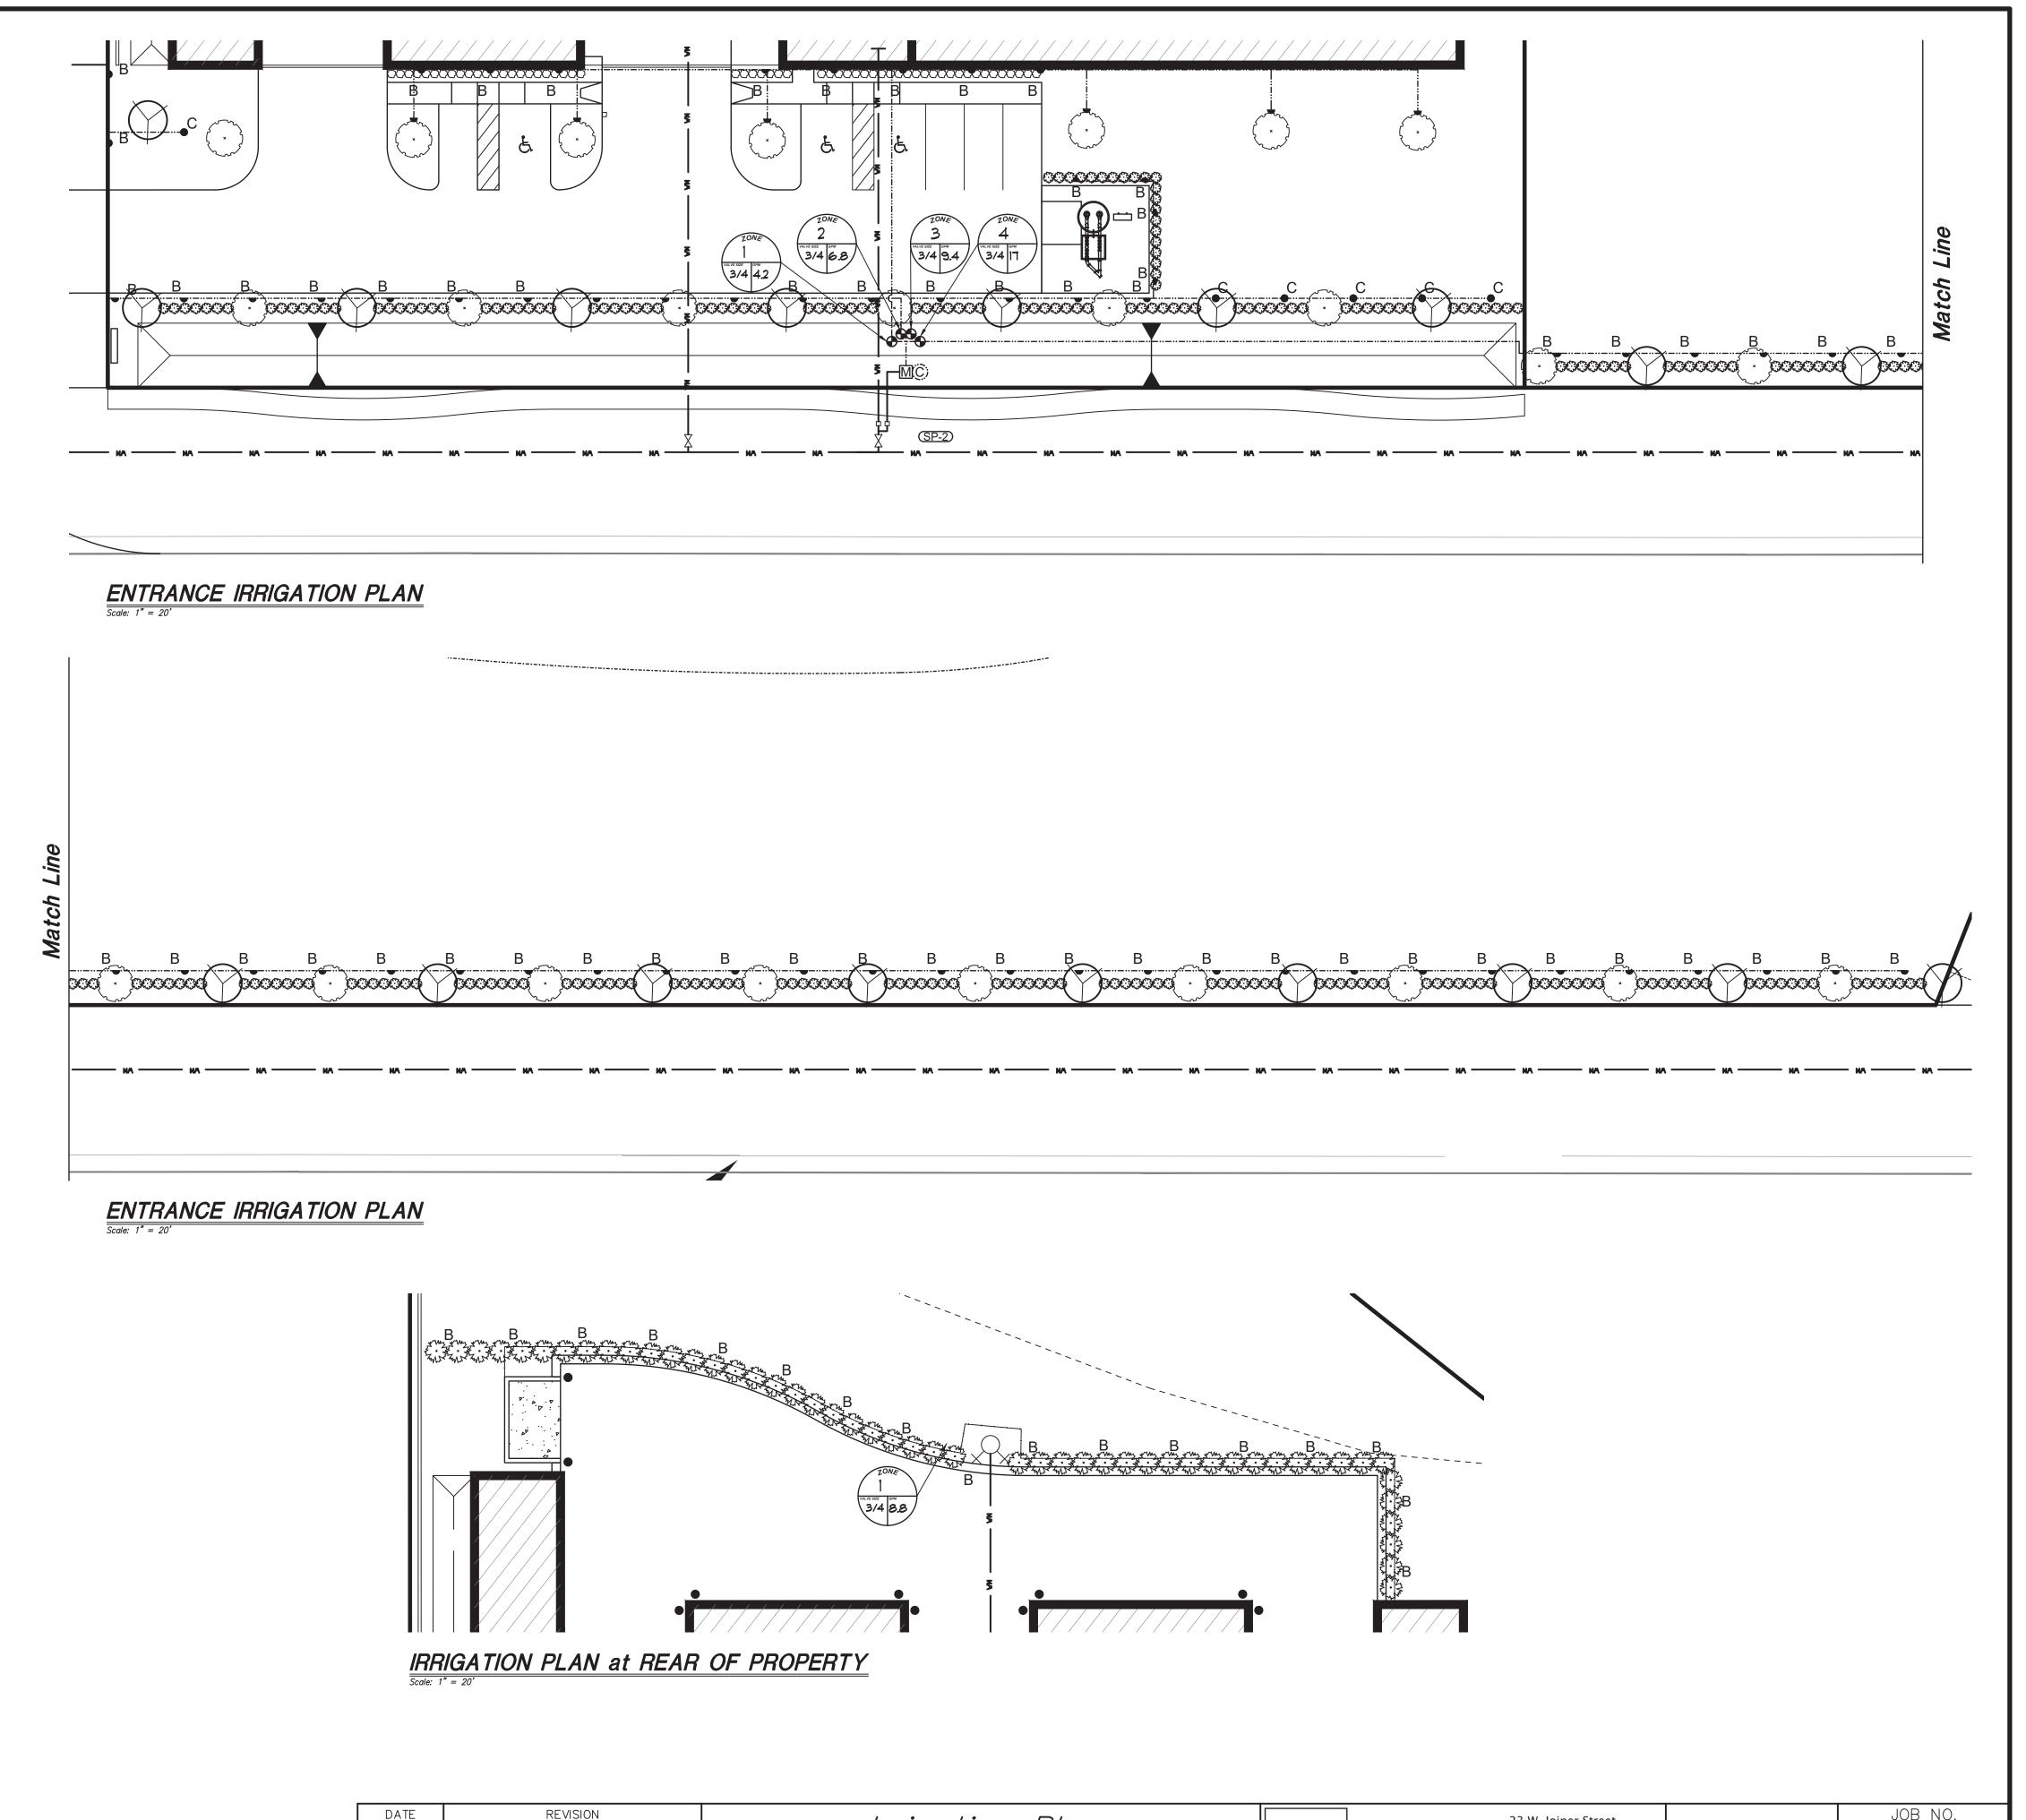

Irrigation Plan

Howey Self Storage

23 W. Joiner Street

Winter Garden, FL. 34787

Ph. 407-905-8180

Certificate of Authorization #00008507

Fax 407-905-6232

june engineering

consultants, inc.

DATE: 2/4/08 DATE: 2/4/08

DRAWN BY: CLK | CHECKED BY: RAJ | SCALE

07-0398

SHEET

OF **10**

JEFFREY A. SEDLOFF

PE# 51506

