



JANUARY 19, 2022

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JANUARY 19, 2022 JFB/LAE

2021.182

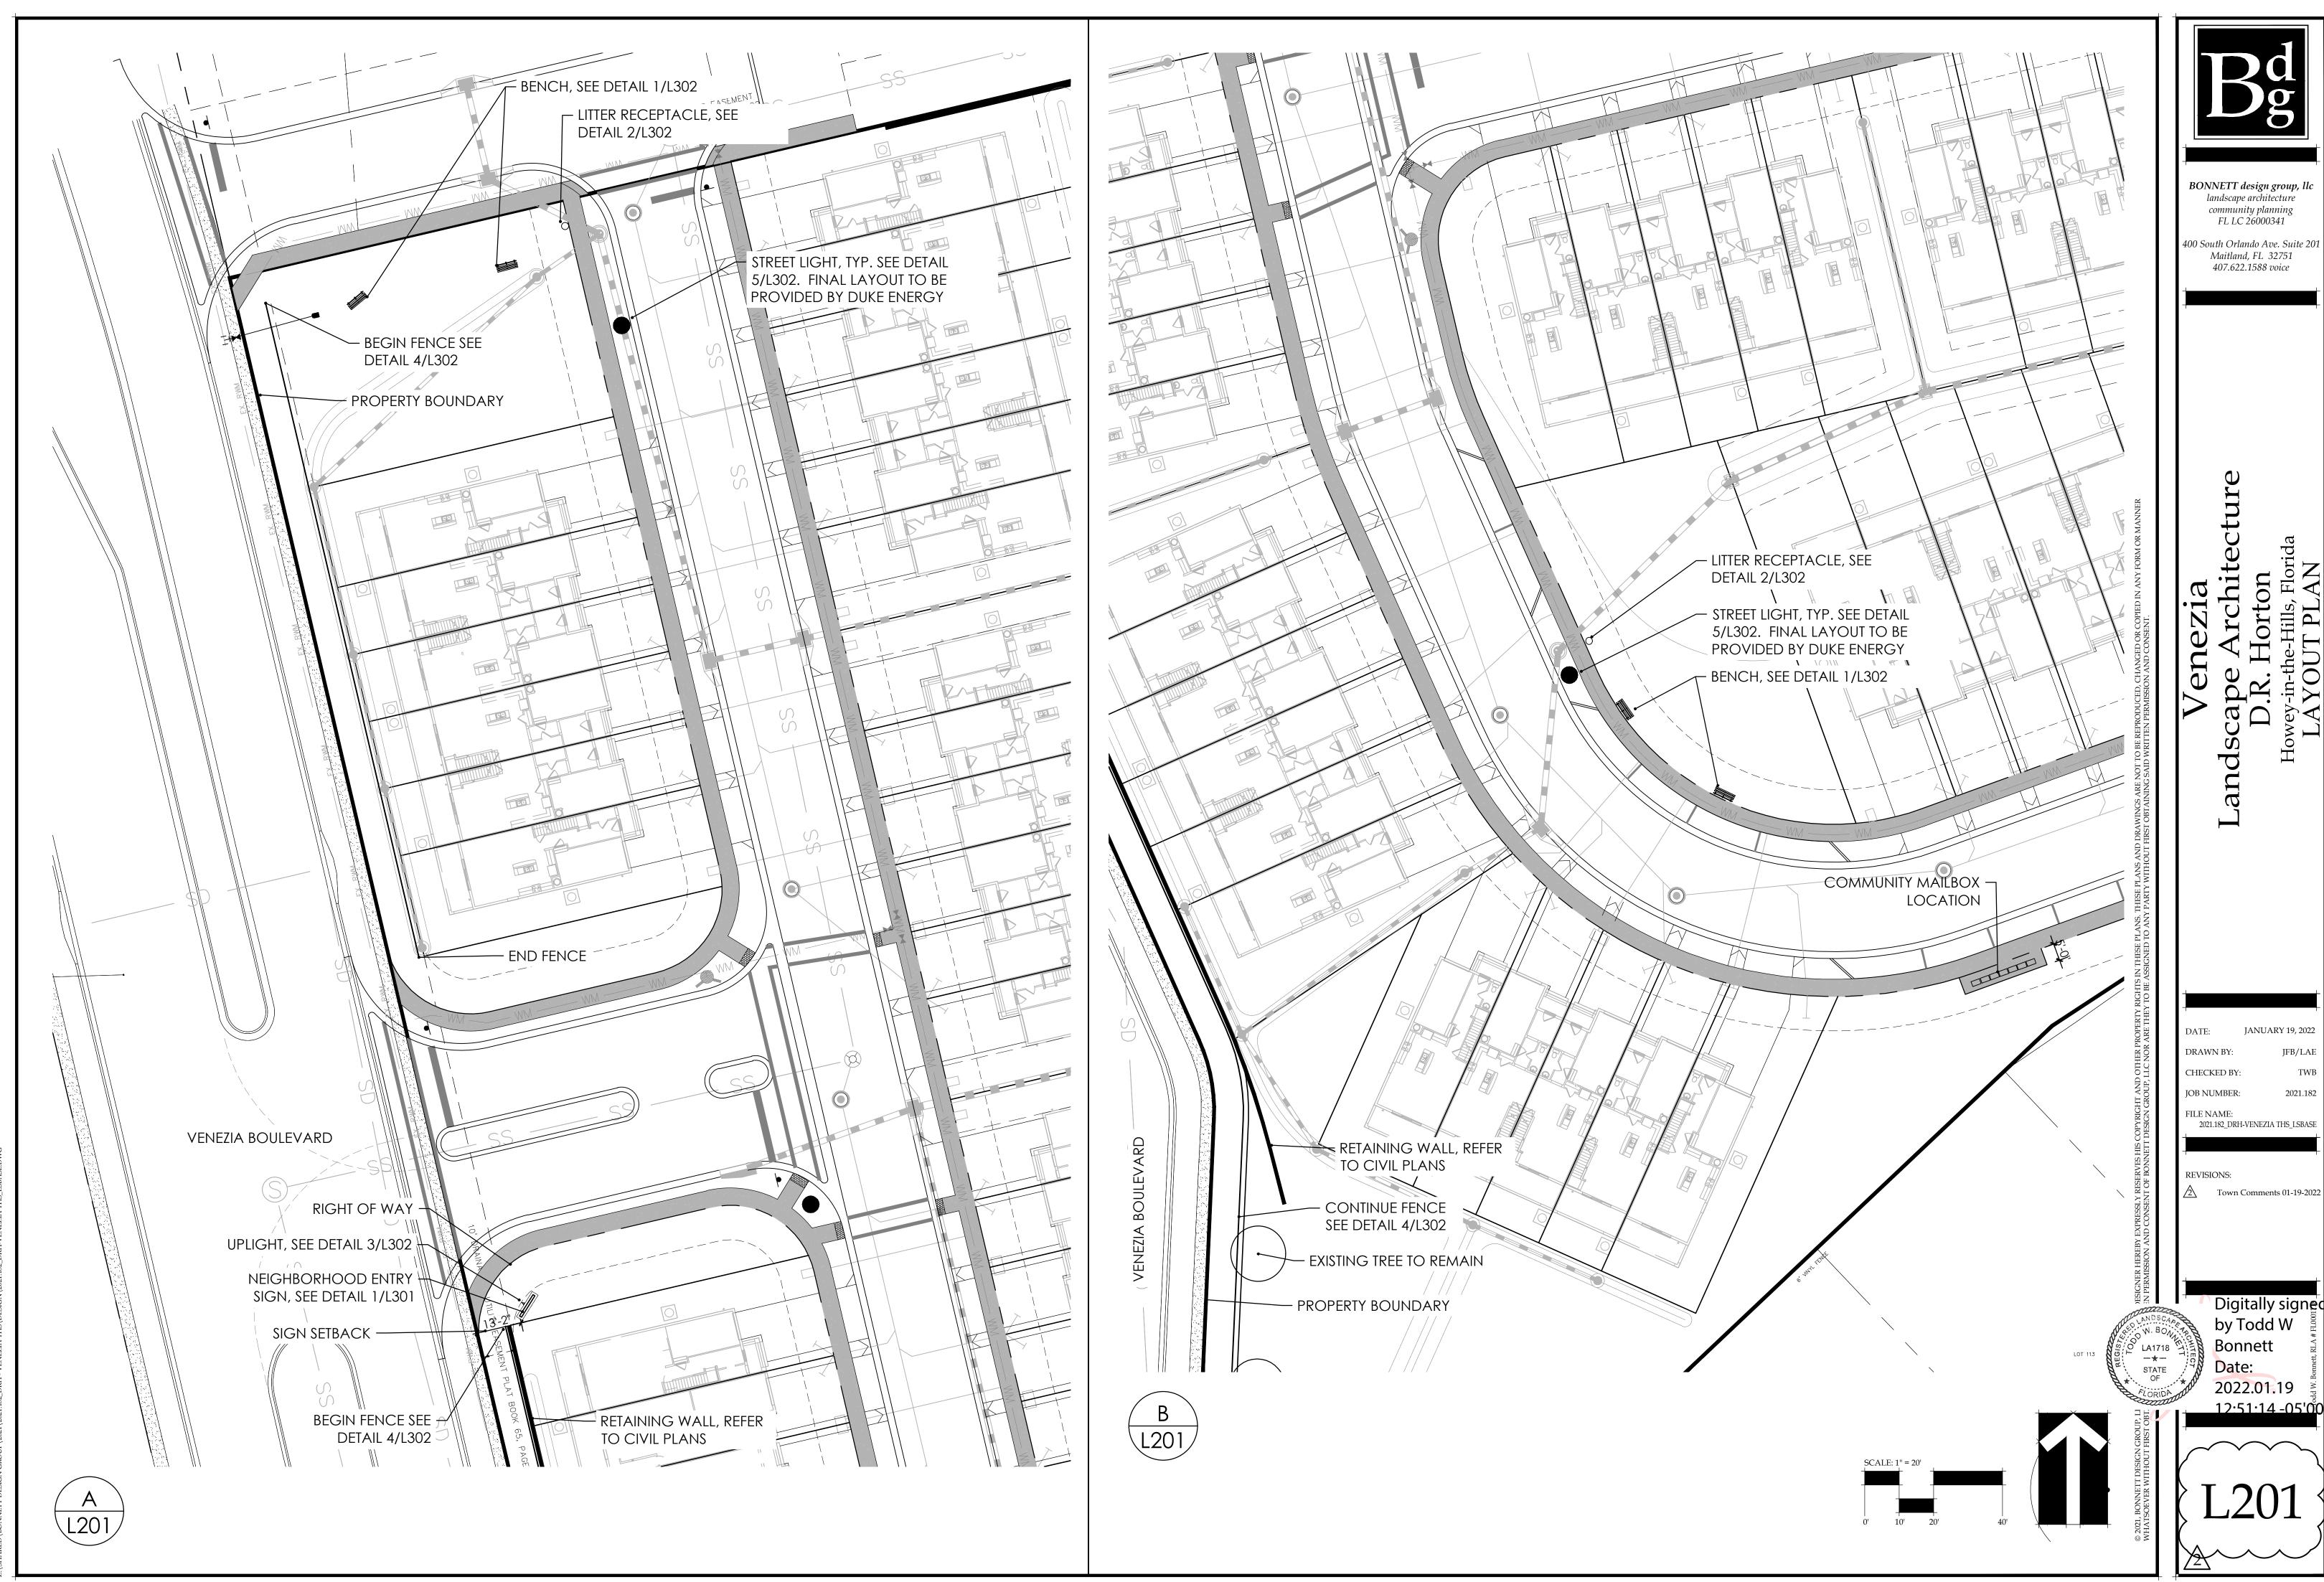



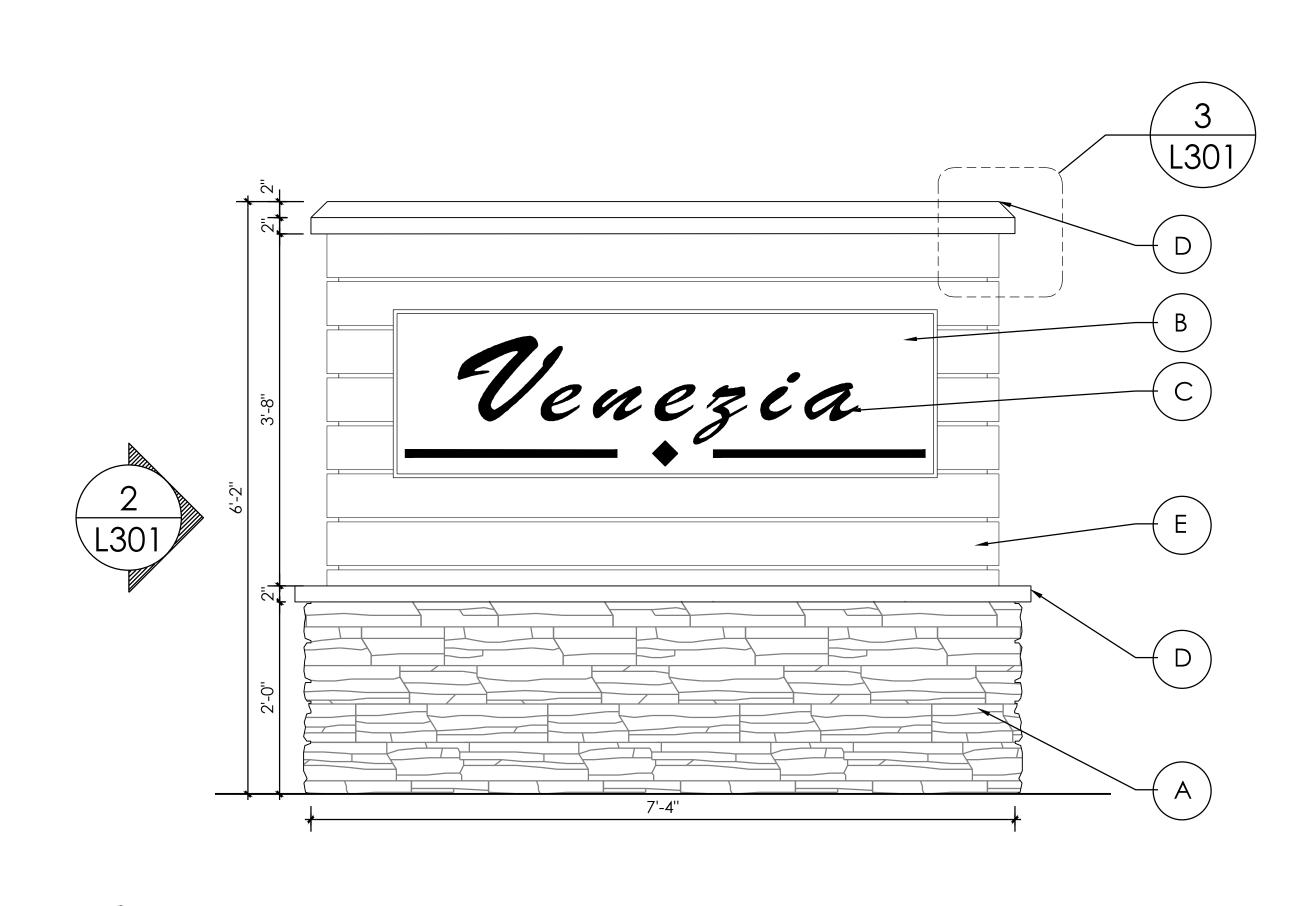
MATERIAL SCHEDULE


A STONE VENEER J&N STONE: LAYTITE COLOR: IRON SOURCE: WWW.JNSTONEVENEER.COM

COMMUNITY SIGN FRONT ELEVATION

SCALE: 1" = 1'-0"

- SIGN FACE 1/4" THICK ALUMINUM PANEL POWDER COATED
- 8"-10" HT., 1/4" THICK ALUMINUM LETTERS PINNED 1/8" OFF SIGN PANEL COLOR: RAL 9010
- PRECAST CAP COLOR: SW 7003 TOQUE WHITE
- 1. FINAL NAME TO BE PROVIDE AT TIME OF PERMIT APPLICATION.
- 2. FINAL COLORS TO BE APPROVED BY OWNER AND SUBMITTED WITH CONSTRUCTION PERMIT PLANS.

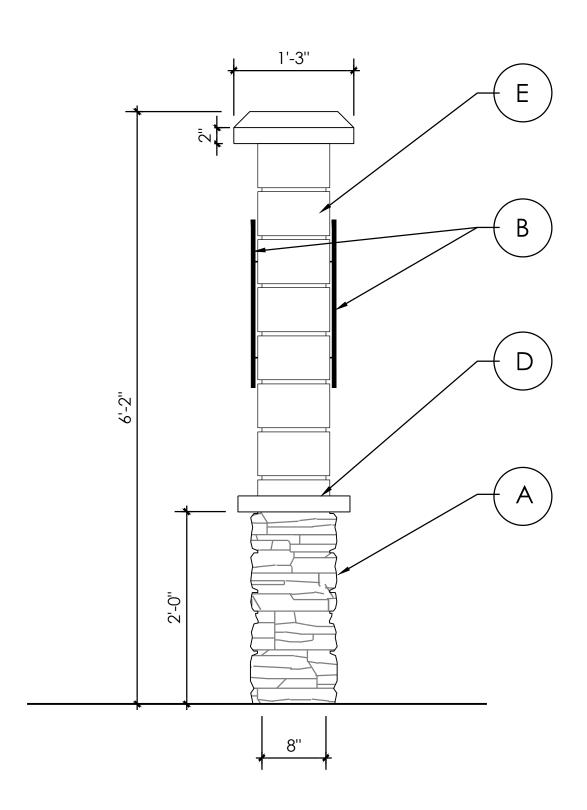

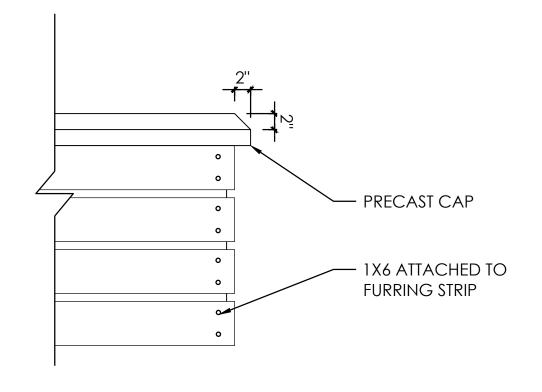

COMMUNITY SIGN SIDE ELEVATION

SCALE: 1" = 1'-0'

COMMUNITY COLUMN FRONT ELEVATION

SCALE: 1" = 1'-0"

BONNETT design group, llc landscape architecture

community planning FL LC 26000341

400 South Orlando Ave. Suite 20

Maitland, FL 32751 407.622.1588 voice

JANUARY 19, 2022 DRAWN BY: JOB NUMBER:

FILE NAME:

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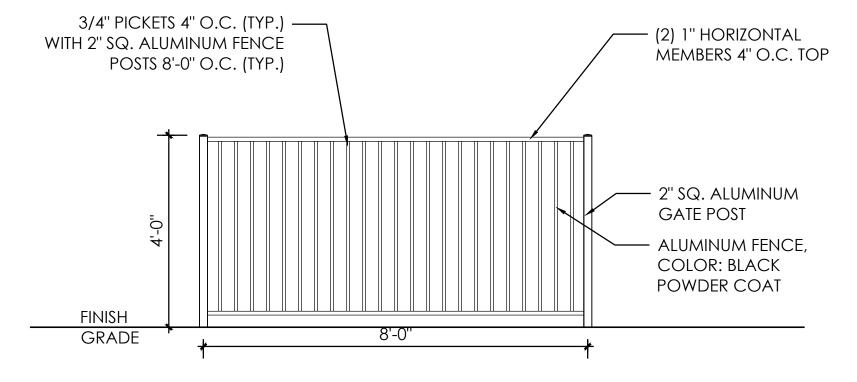
Town Comments 01-19-202

ិ Digitally signङ្कីc by Todd W Bonnett Date: 2022.01.19

12:51:55 -05'00

NOTE: HARDSCAPE DESIGN PLANS PROVIDED TO DEMONSTRATE DESIGN INTENT ONLY AND ARE NOT VALID FOR CONSTRUCTION WITHOUT FINAL STRUCTURAL & REINFORCEMENT DESIGN.





*OR OWNER APPROVED EQUAL





PRODUCT DESCRIPTION


Our ribbed steel trash receptacle offers durability and style. The slatted wave design adds a subtle and simple interest point available in a variety of colors!

- 32 gallon capacity
- 3/4 #9 expanded metal inside ribbed steel with rolled edges
- Dimensions: 2.5' H x 2' W x 2' D

https://www.byoplayground.com/products/trash-receptacle-ribbed-steel-22-gallon.html

*OR OWNER APPROVED EQUAL



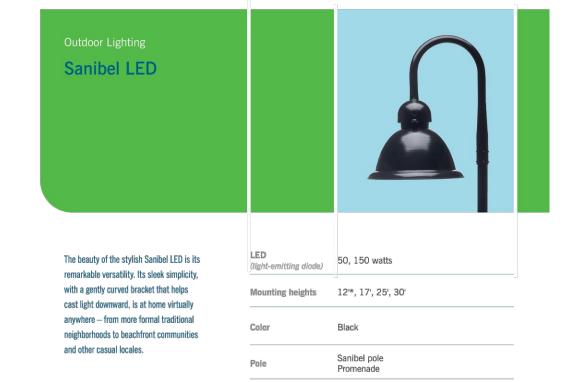



DUKE ENERGY.

Shopping centers Streets


*LIGHT FIXTURE SHALL MEET TOWN OF HOWEY IN THE HILL'S REQUIRMENTS OR TOWN/OWNER APPROVED EQUAL





Specifications
Weight: 3.0 lbs.


DIMENSIONS

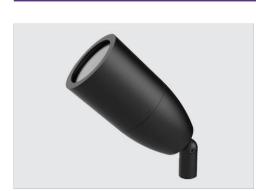

PALM 12V/120V LED


- HIGHLIGHTS
 The Palm Series accent lights are suitable for a variety of mounting applications including ground, wall, tree, sign and architectural accents
- Suitable for wet locations
 Integral driver for 120V
- Dimmable using standard TRIAC (forward-phase or leadingedge) and ELV (reverse phase or trailing-edge) dimmer for 120V and dimmable using standard MLV dimmer and magnetic transformer for 12V
- Tapered-sure lockAvailable in 80CRI and 90CRI
- 1,600lm


LUMEN PACKAGES

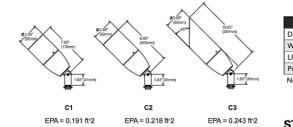

| Sobject | Sobj

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AIMING DETAILS

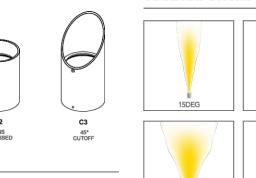N.T.S.

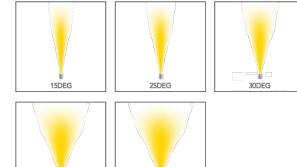Bdg

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outh Orlando Ave. Suite 20 Maitland, FL 32751 407.622.1588 voice

Venezia dscape Architecture D.R. Horton

DATE: JANUARY 19, 2022

DRAWN BY: JFB/LAE

CHECKED BY: TWB

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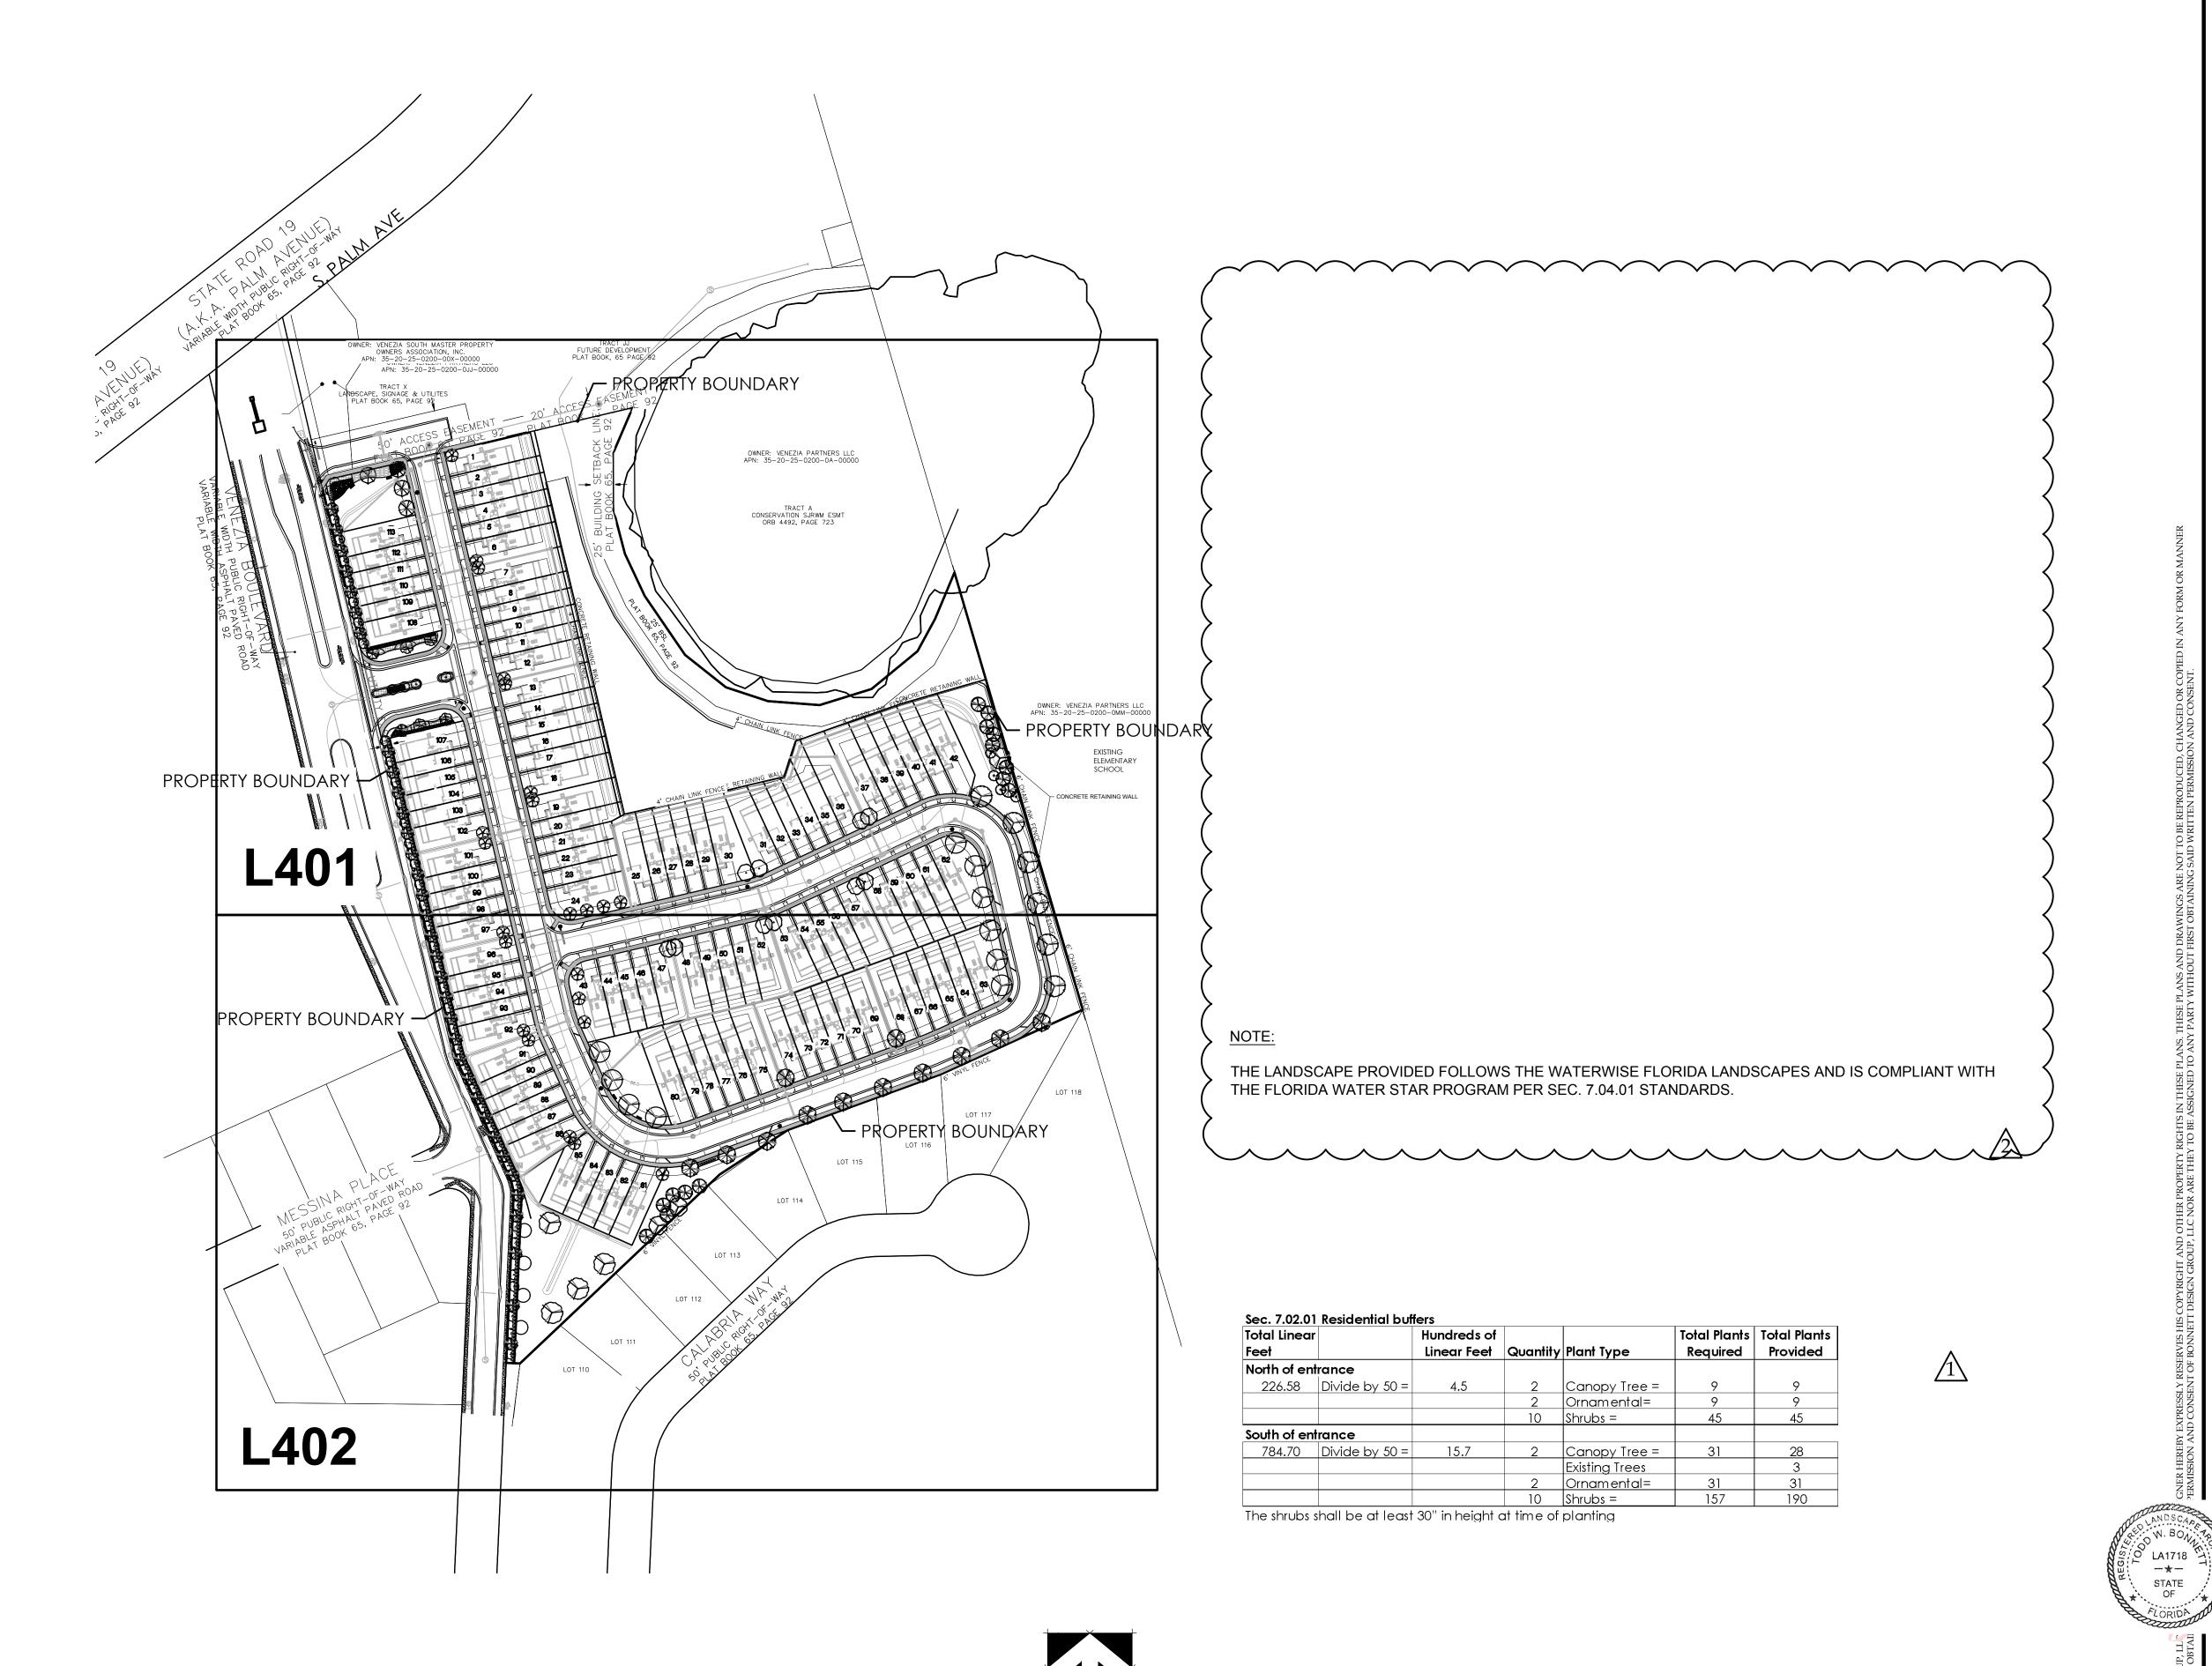
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Bonnett

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Bonnett Date: 2022.01.1



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407.622.1588 voice

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Landscape Architecture
D.R. Horton
Howey-in-the-Hills, Florida

DATE: OCTOBER 22, 2021
DRAWN BY: JFB/LAE

CHECKED BY: TWB


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FILE NAME:
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ISIONS:

Base update 12-10-2022 Town Comments 01-19-2022

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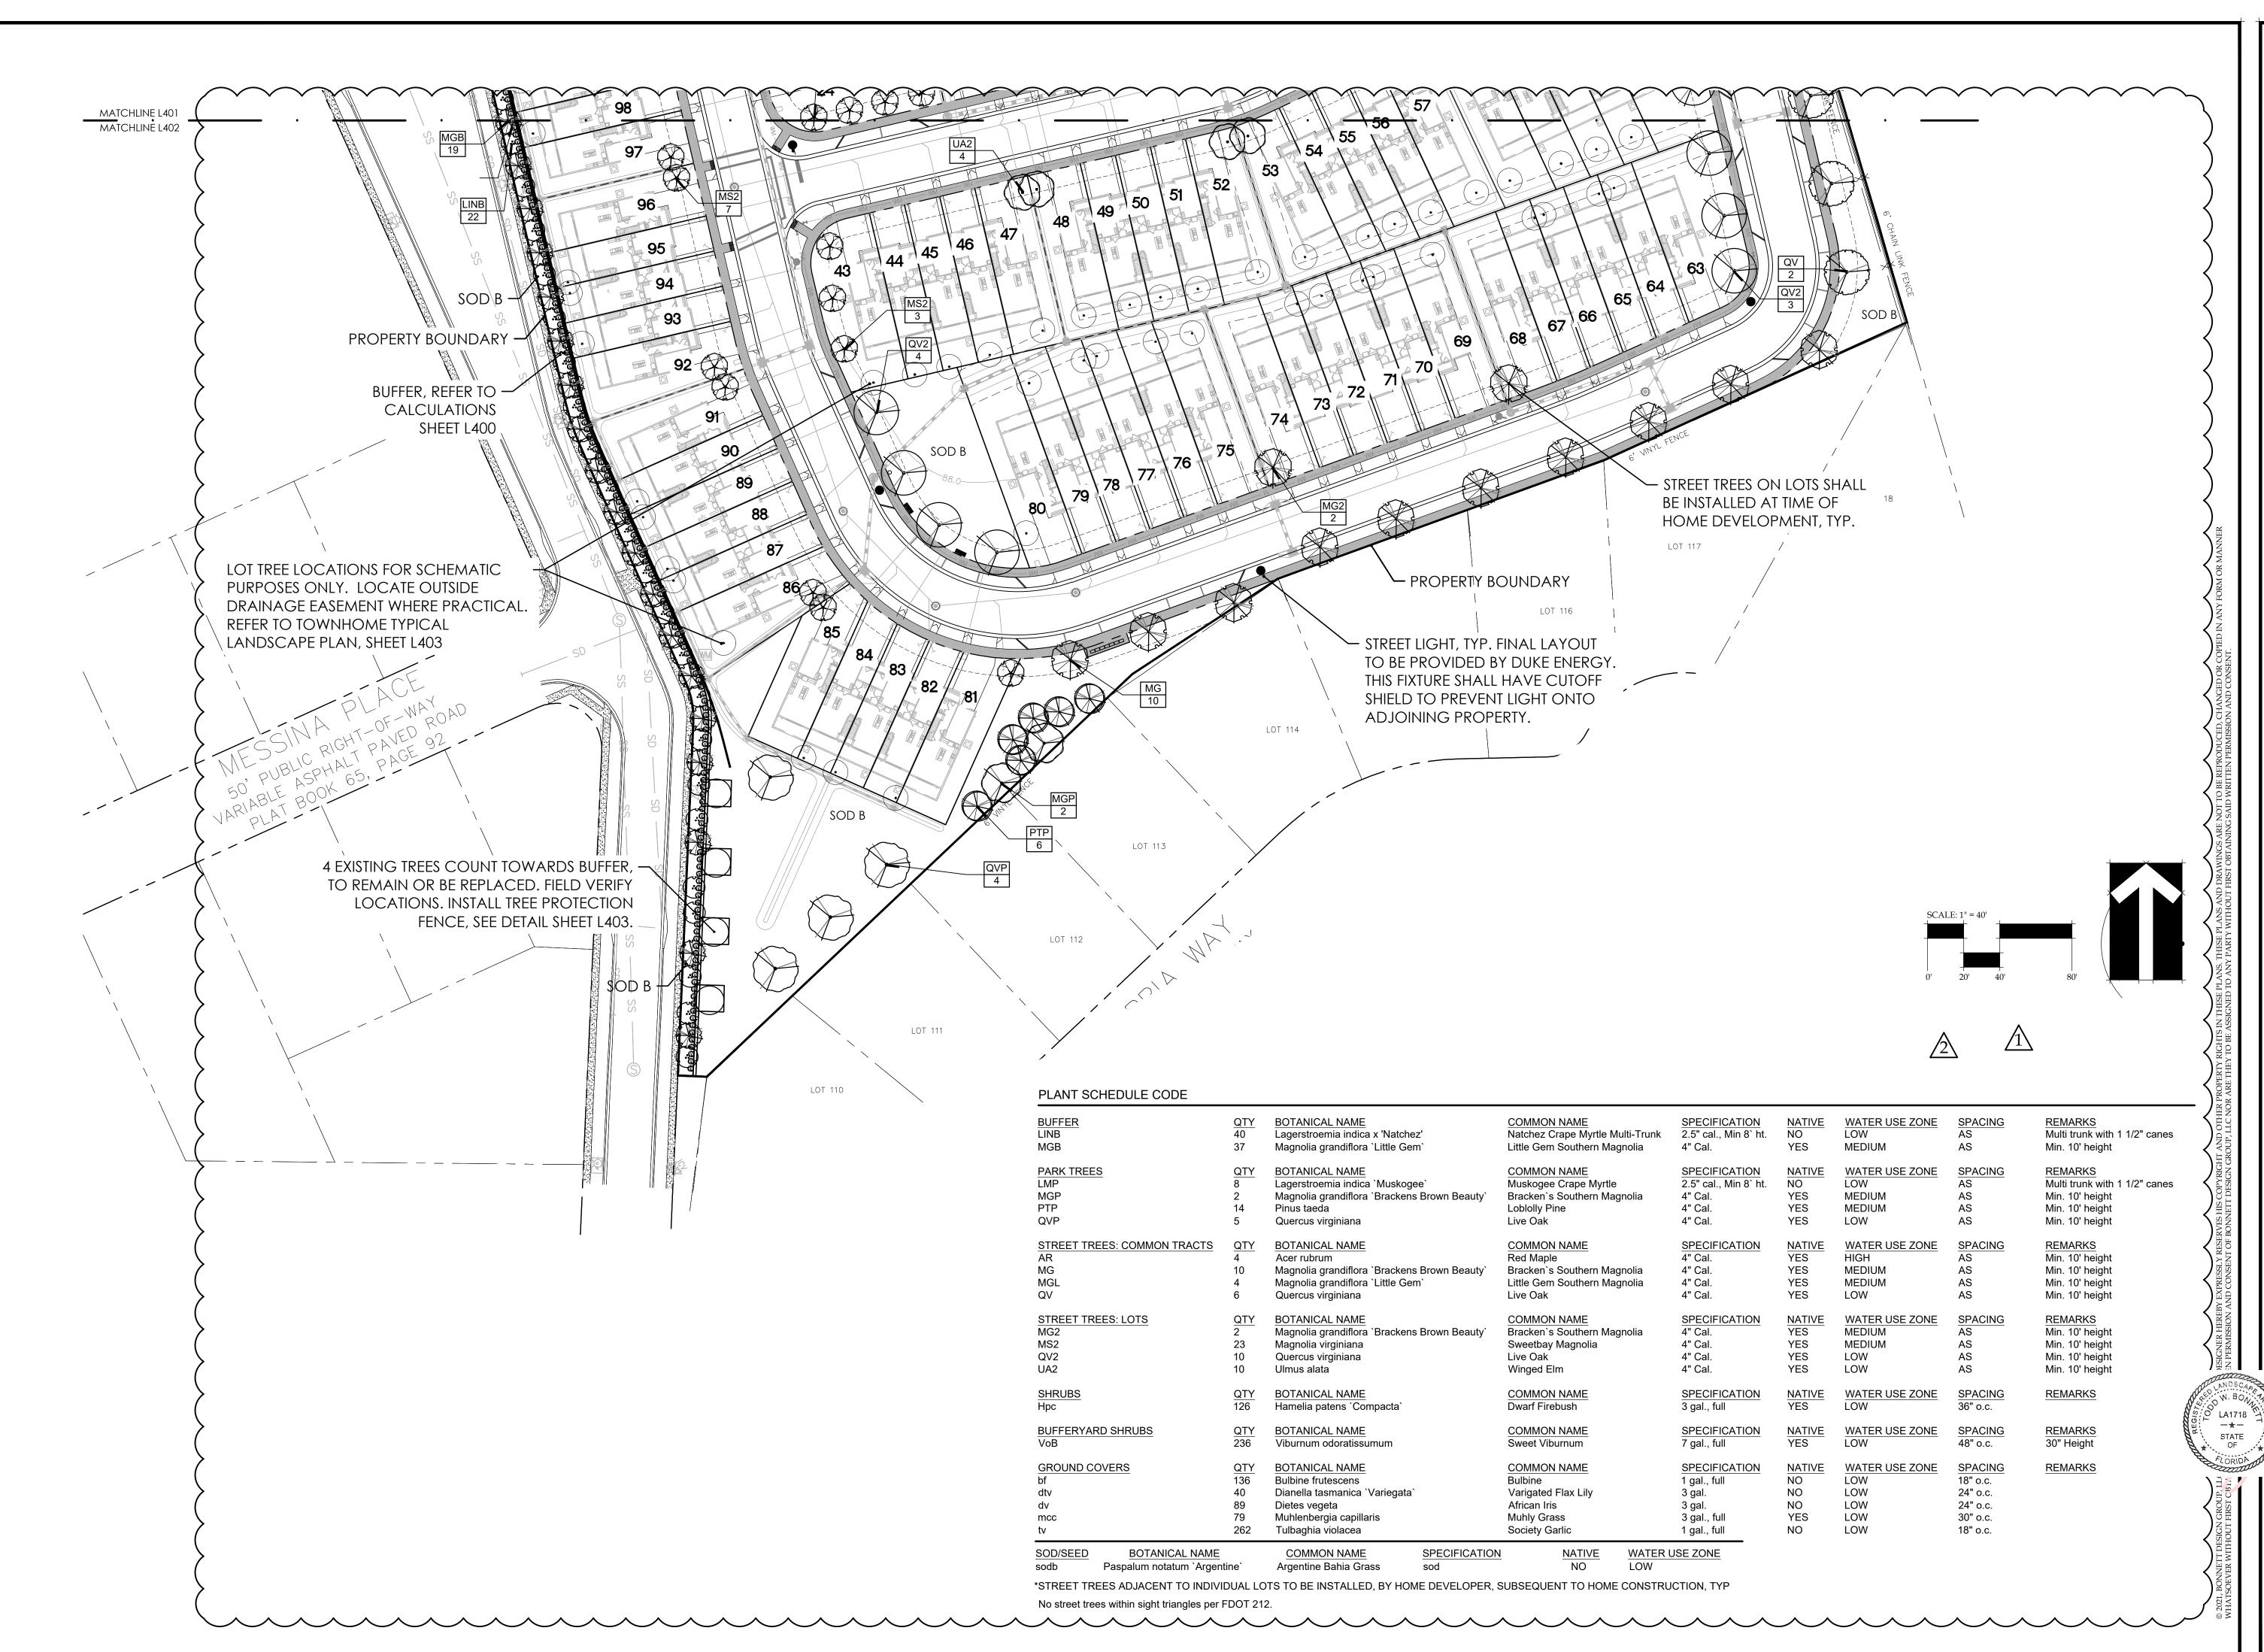
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CHECKED BY: JOB NUMBER: FILE NAME:

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Base update 12-10-202 Town Comments 01-19-2022

Digitally signed by Todब् W Bonnett Date: 2022.01.19 12:53:35 -05'00

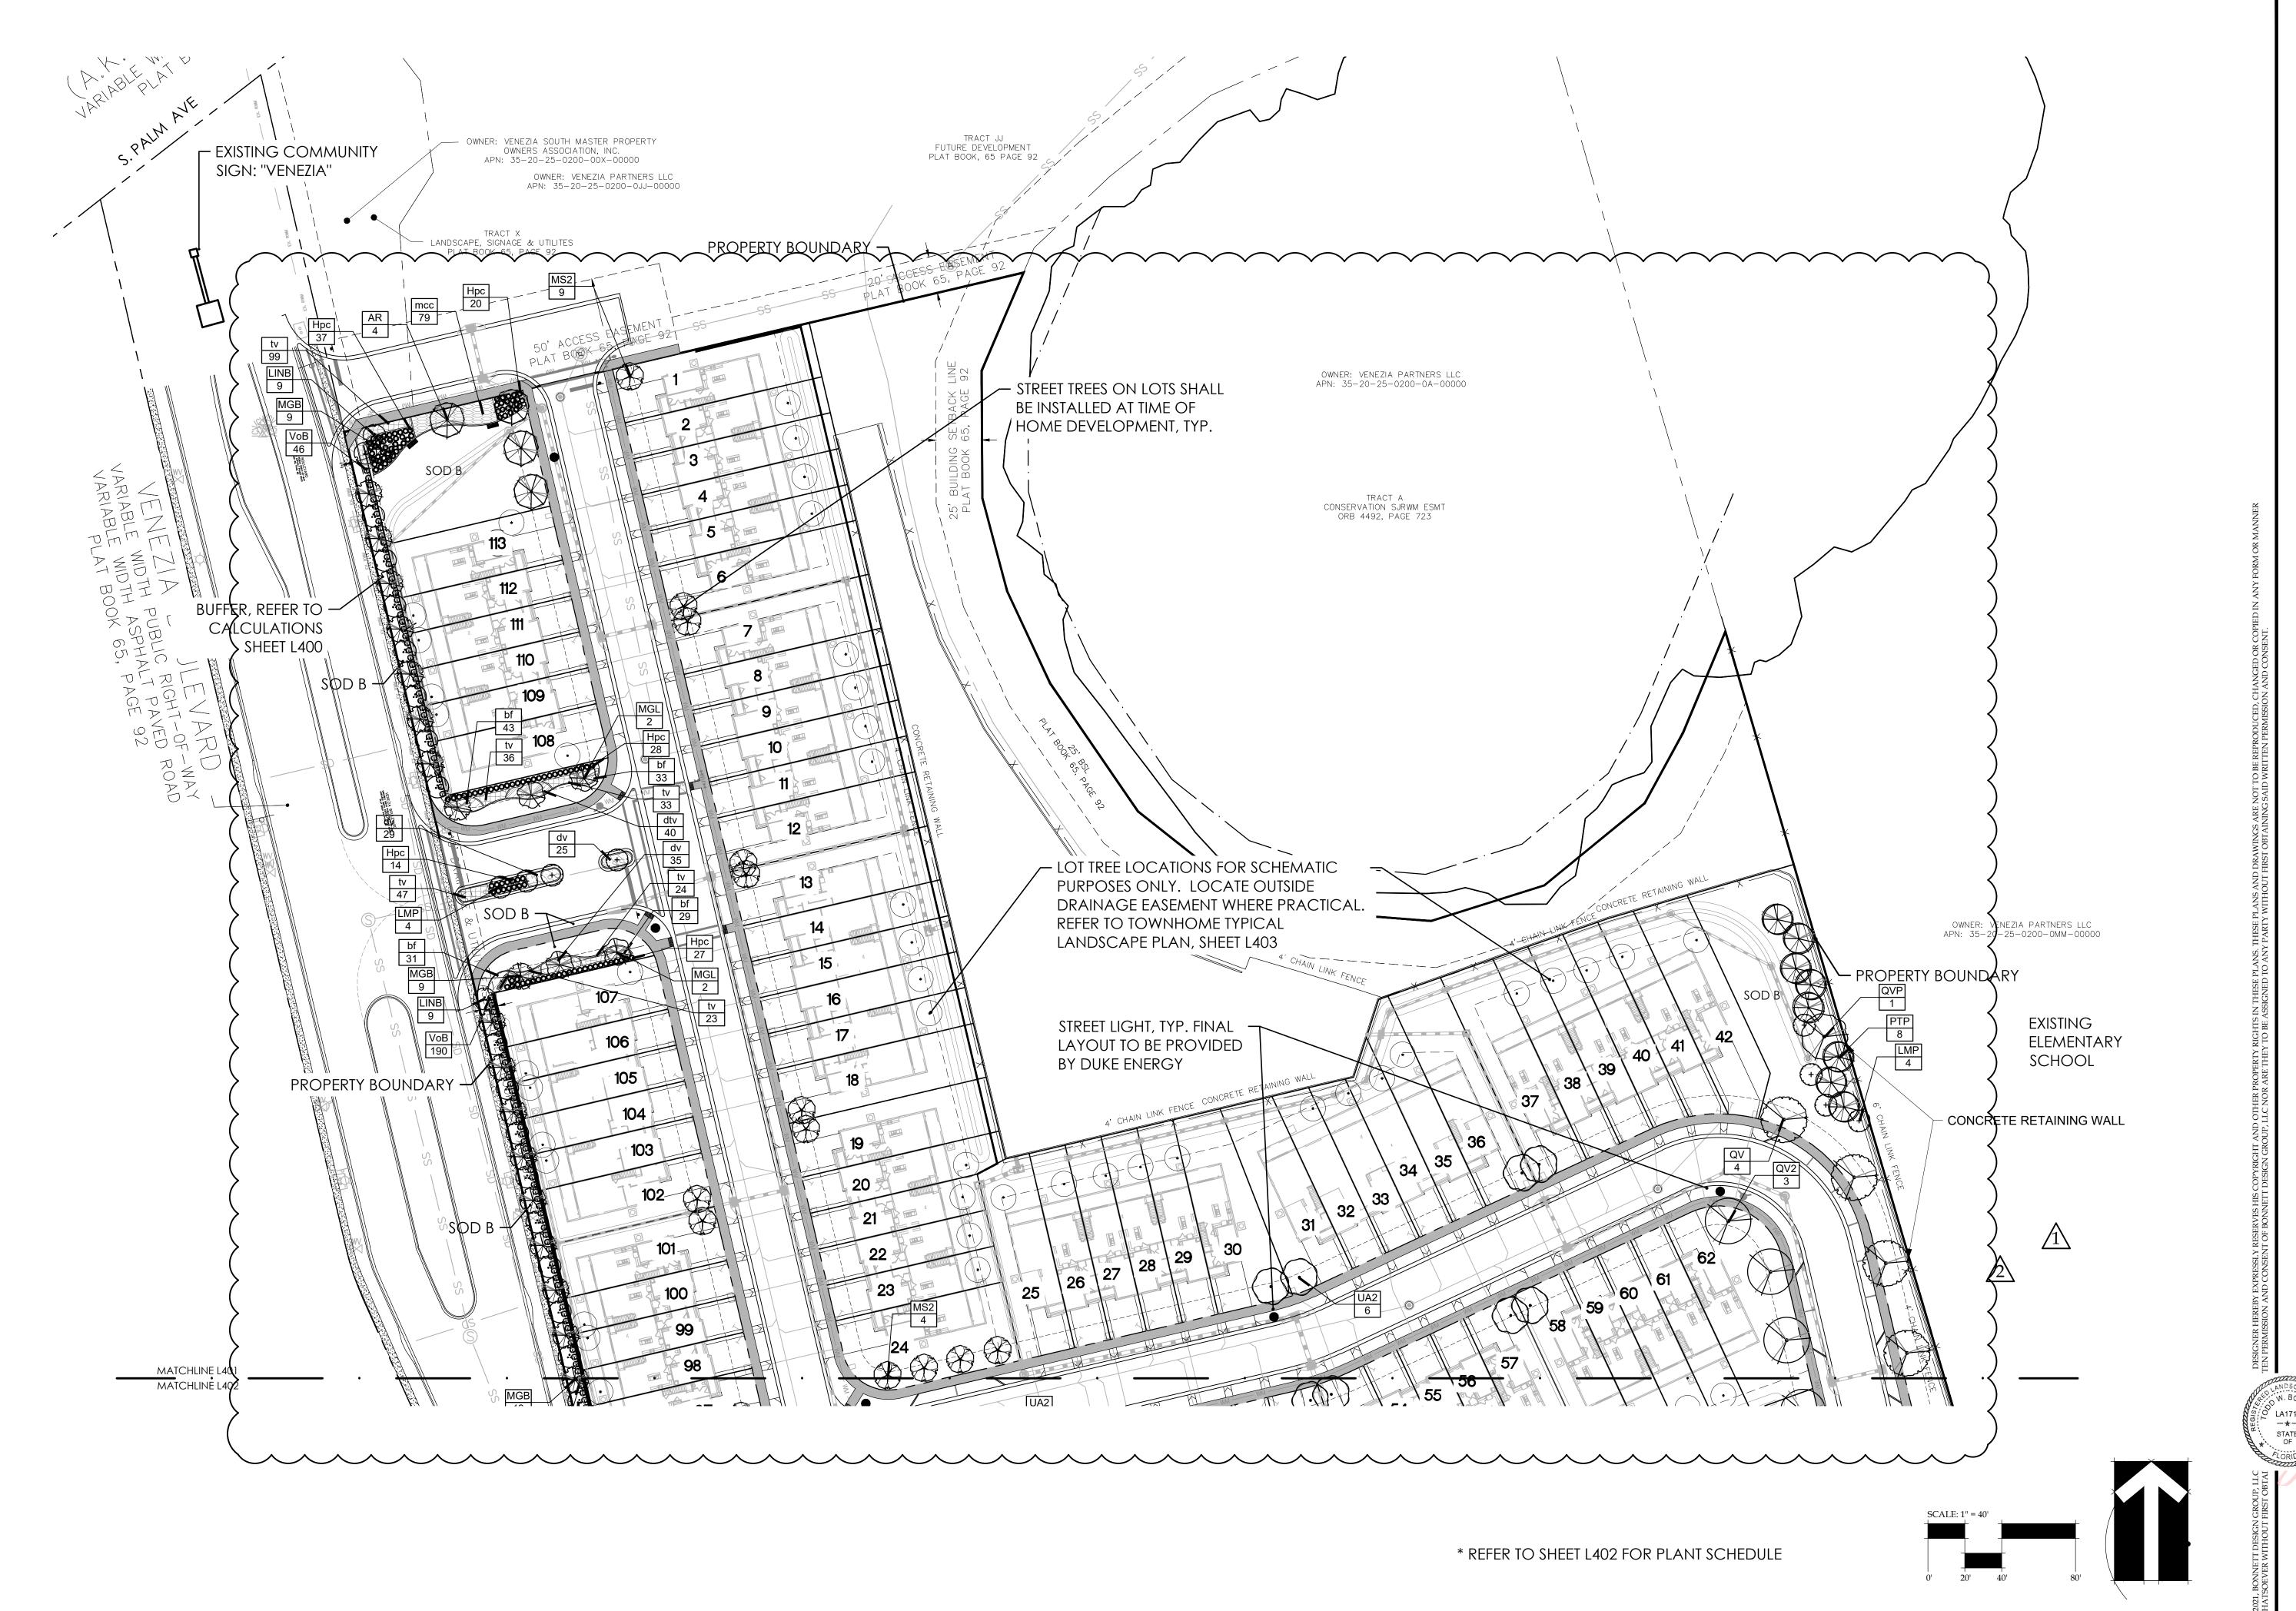



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Venezia Idscape Architecture

DATE: OCTOBER 22, 2021
DRAWN BY: JFB/LAE
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2021.182_DRH-VENEZIA THS_LSBASE

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Base update 12-10-2021 Town Comments 01-19-2022

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GENERAL REQUIREMENTS

The Landscape Contractor shall be responsible for all materials and all work as called for on the landscape plans. The list of plant quantities accompanying the plans shall be used as guide only. If a discrepancy occurs between the plans and the plant list, the plans shall control.

The Landscape Contractor shall warranty all trees for a period of one (1) year and shrubs and ground covers for a period of six (6) months from the time of final acceptance by Owner and Landscape Architect.

The Landscape Contractor shall be wholly responsible for the stability and plumb condition of all trees and shall be legally liable for any damage caused by the instability of any plant material. Staking of trees and palms, if required, shall be done utilizing a method agreed upon by the Landscape Architect.

The Landscape Contractor shall research plans and contact appropriate agencies to determine the location of any utilities and obstructions prior to commencing work. Any utilities or unanticipated obstructions shall be reported to Landscape Architect or Owner immediately.

All plant material and sodded areas shall have an automatic underground irrigation system providing 100% coverage.

Positive drainage shall be maintained away from all structures on the site.

PLANT SPECIFICATIONS

All nursery stock plant material shall be Florida #1 or better in accordance with Grades and Standards for Nursery Plants Parts I & II, latest edition as published by the Florida Department of Agriculture and Consumer Services- Division of Plant Industry.

All plant material shall be planted, fertilized and mulched as per the plant details and planting specifications noted on the plans.

All container grown material shall be healthy, vigorous, well rooted plants, and established in the container in which they are delivered to the site. The plants shall have tops which are good quality and in a healthy growing condition. Established container grown plant material shall be grown in that container sufficiently long enough for the new fibrous roots to have developed enabling the root mass to retain it's shape when removed the container. Plants which have become root bound in the container are unacceptable.

All plant material that is not container grown shall be freshly dug, sound, healthy, vigorous, well branched, and free of disease and insect eggs and larvae, and shall have adequate root systems. Where any requirements are omitted from the plant list, the plants furnished shall be normal for the variety. Plants may be pruned prior to delivery only upon the approval of the Landscape Architect.

FERTILIZER

Two fertilizers shall be used on all types of plantings, except palms. Granular fertilizer shall be uniform in composition, dry and free flowing. This fertilizer shall be delivered to the site in the original unopened bags bearing the manufacturer's statement of analysis. Granular fertilizer shall be a controlled release variety meeting the following requirements: sixteen percent (16%) nitrogen, four percent (4%) phosphorus, eight percent (8%) potassium, plus iron. tablet fertilizer ("Agriform" or approved equal) in 21 gram size shall meet the following requirements: twenty percent (20%) nitrogen, ten percent (10%) phosphorus, five percent (5%) potassium.

Application Rates:

<u>Plant size</u>	<u>16-4-8</u>	"Agriform" tablet (21 gran
1 gallon	1/4 lb.	1 tablet
3 gallon	1/3 lb.	2 tablets
7-15 gallon	1/2 lb.	4 tablets
1" - 6" caliper	2 lbs. per 1" caliper	2 tablets per 1" caliper
6" + caliper	3 lbs. per 1" caliper	2 tablets per 1" caliper

Sodded areas shall receive an application of the granular fertilizer (16-4-8) at a rate of 1/2 lb. of Nitrogen per 1,000 square feet of sod area.

"Palm Special" fertilizer shall be applied to all palms at installation at a rate of 1 1/2 lbs. per 100 square feet of canopy area. Palm fertilizer shall be a controlled release variety containing chelated micro nutrients and a ratio of N-P-K-Mg of 2:1:3:1.

SOIL

Planting soil for use in preparing the backfill material for planting pits shall be added a rate of fifty percent (50%) planting soil to fifty percent (50%) existing soil. This soil mix shall be used in all plant pits except Sabal Palms which shall be backfilled with clean sand. Planting soil shall be a fertile, friable natural topsoil of loamy character. It shall contain forty (40) to fifty (50) percent decomposed organic matter and be free of heavy clay, stones larger than 1" in diameter, noxious weeds and plants, sod, partially disintegrated debris, insects or any other undesirable material, plants or seeds that would be toxic or harmful to plant growth.

MULCH

All plant beds and tree watering basins shall be top dressed with three inches (3") of pine bark mini-nuggets mulch.

SOD

Refer to Landscape Plan for limits of sod.


All areas disturbed by construction (including material staging, equipment storage, temporary facilities, site access, construction staff parking, etc.) beyond the minimum limits of sod as shown on the Landscape Plan shall be sodded as

All lawn areas to receive sod shall be disked four (4) to six (6) inches and graded to establish a level finished grade ensuring positive drainage from all structures. All debris shall be removed from the site.

Sod shall be free of weeds and pests. It shall be laid evenly with tight fitting joints and rolled. The sod shall contain moist soil which does not fall apart or tear when lifted.

See plant list for specific sod species and locations.

See 'Fertilizer' for requirements of all sodded areas.

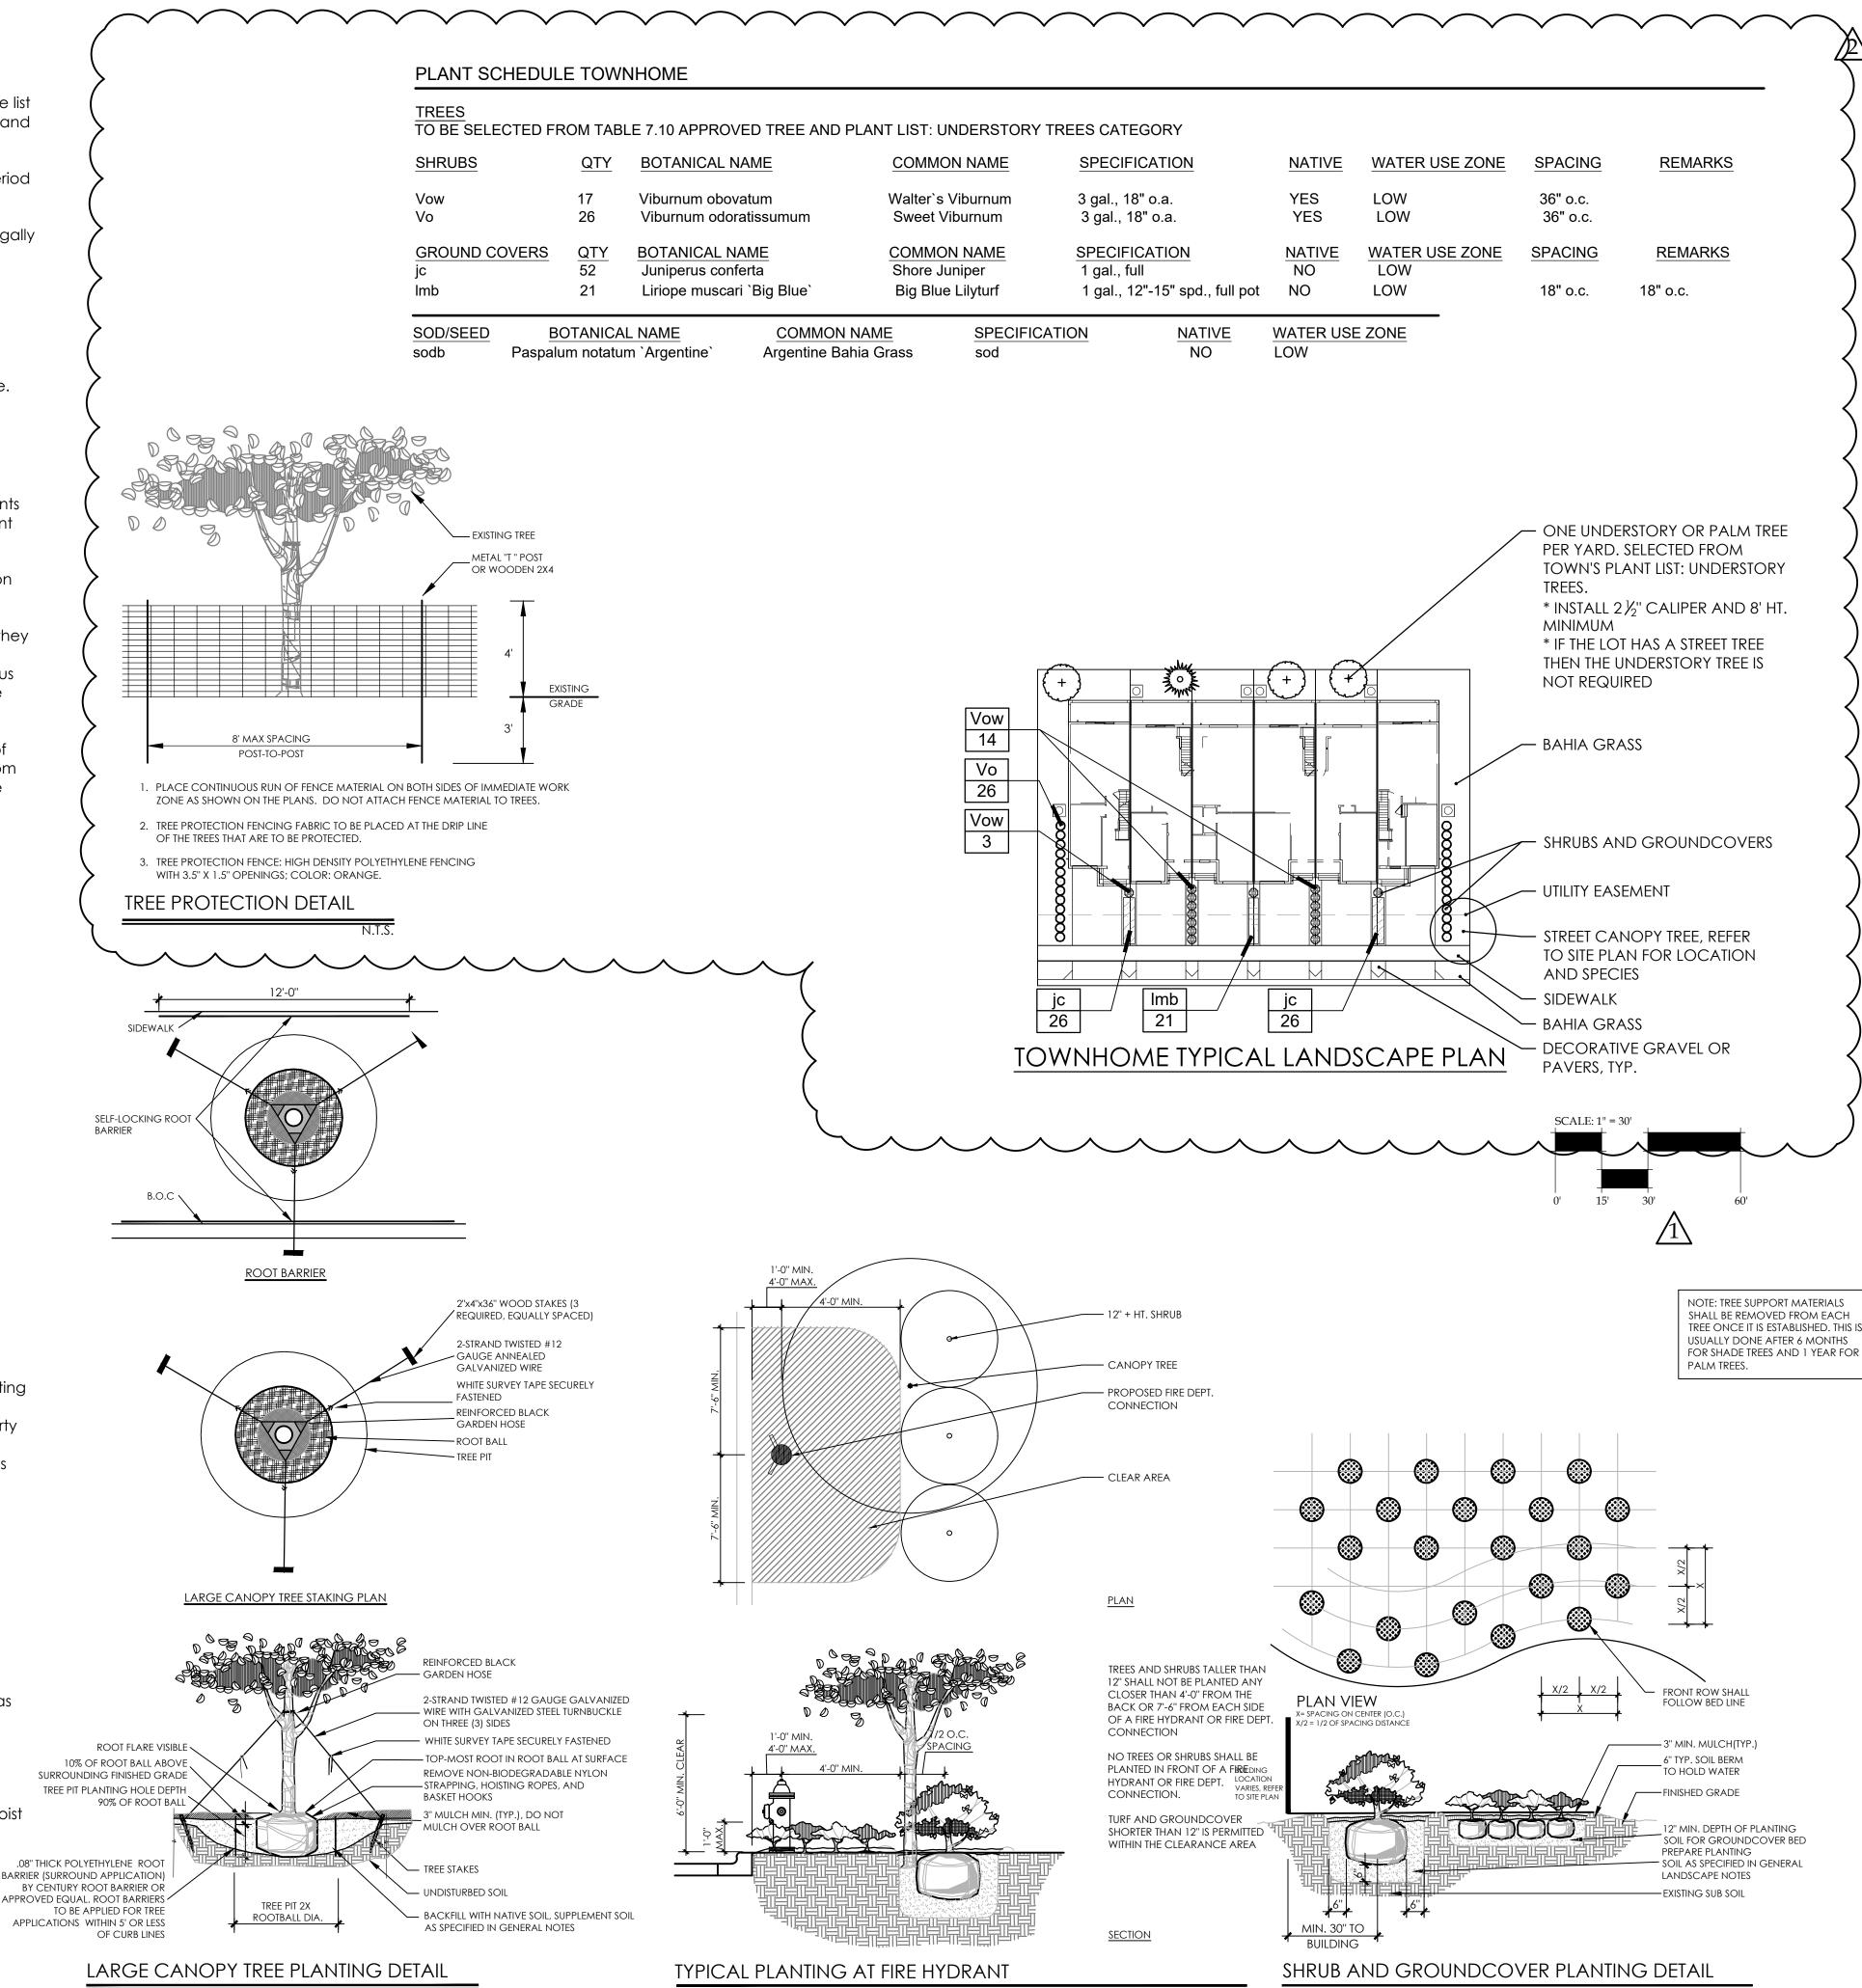

Bdg

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) South Orlando Ave. Suite 20 Maitland, FL 32751

407.622.1588 voice

Venezia Landscape Architecture D.R. Horton

DATE: OCTOBER 22, 2021

DRAWN BY: JFB/LAE

CHECKED BY: TWB

JOB NUMBER: 2021.182

FILE NAME: 2021.182_DRH-VENEZIA THS_LSBASE

EVISIONS:

Base update 12-10-202


Town Comments 01-19-202

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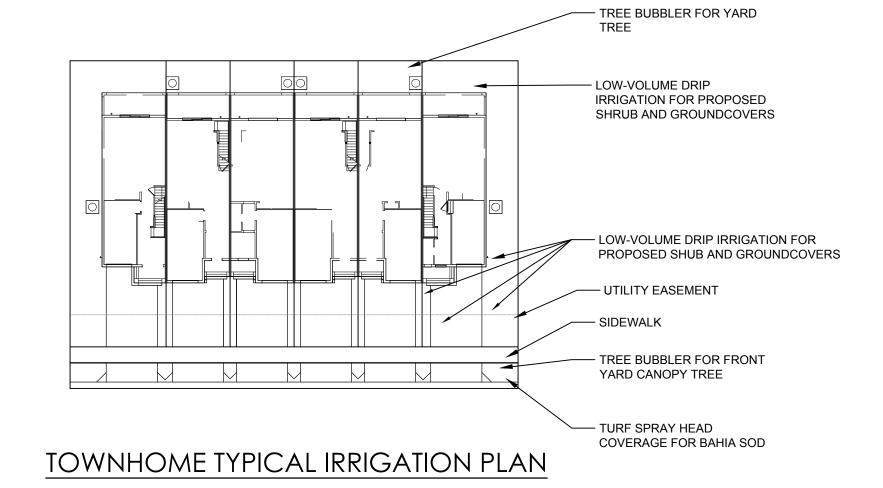
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OMISSIONS, INCONSISTENCIES, AMBIGUITIES OR CONFLICTS WHICH ARE ALLEGED.



IRRIGATION SCHEDULE

THIS SPRINKLER SYSTEM USES RECLAIMED WATER, THE IRRIGATION CONTRACTOR WILL INSTALL ALL SPRINKLER EQUIPMENT WITH

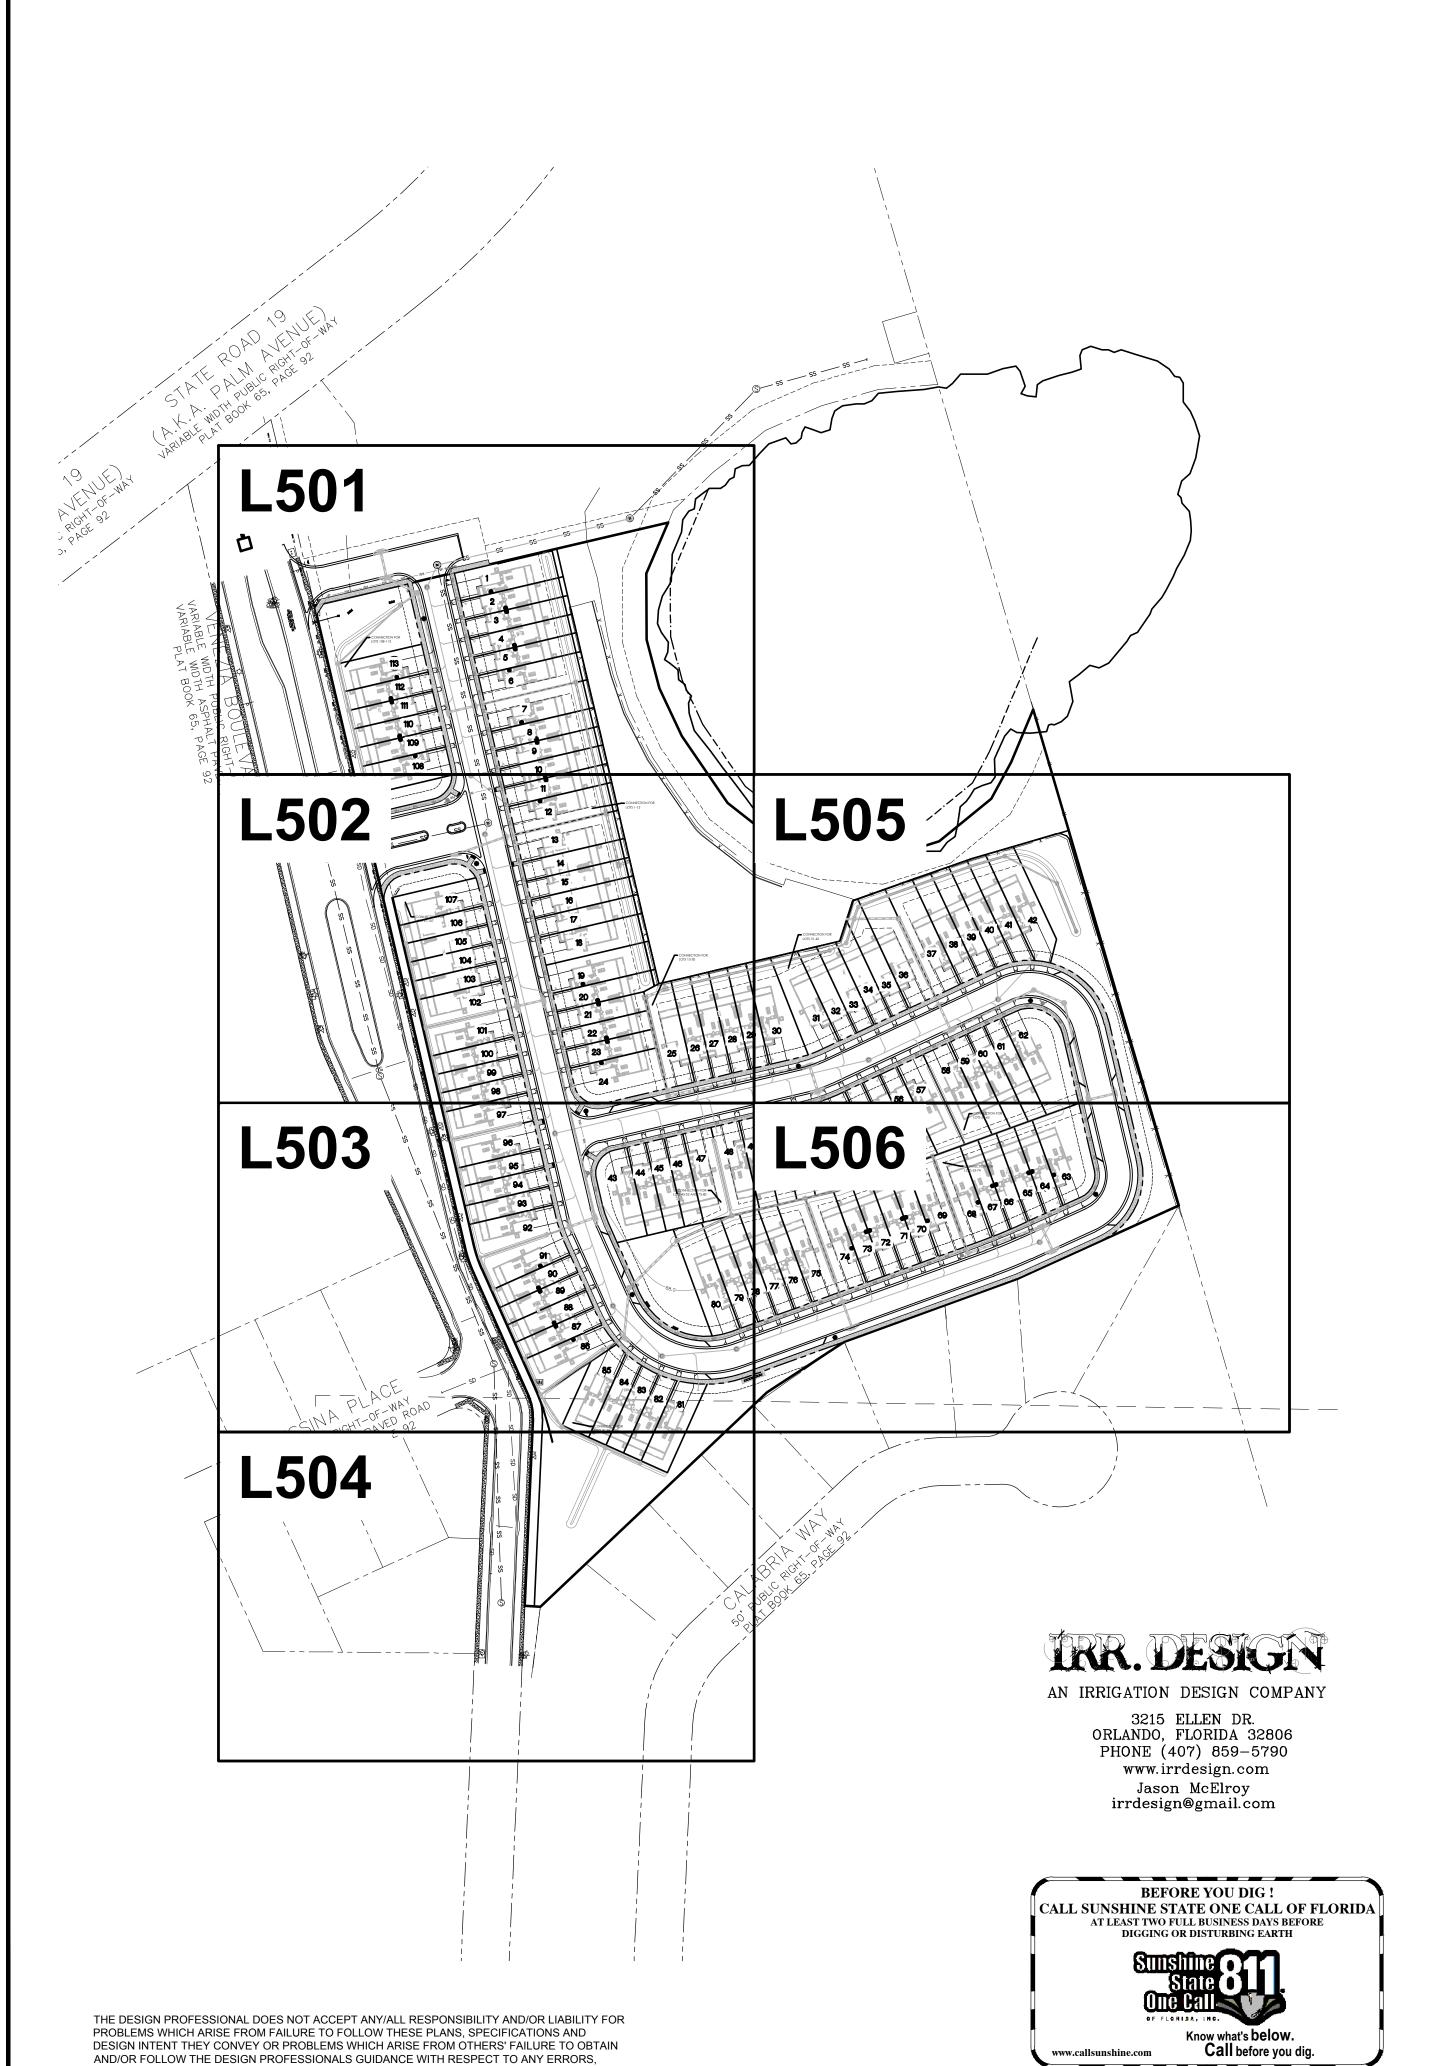PURPLE CAPS, TAGS, VALVE BOX LIDS, ETC. THE CONTRACTOR WILL POST "RECLAIMED WATER" SIGNAGE PER LOCAL CODES

CONTRACTOR TO INSTALL RECLAIM
IRRIGATION WATER NOTICE POC SIGNAGE, PER
LAKE COUNTY SPECIFICATIONS.

NOTES

SYMBOL	MANUFACTURER/MODEL/DESCRIPTION	<u>QTY</u>
	Rain Bird PESBR 1", 1-1/2", and 2" Durable Chlorine-Resistant Valves for Reclaimed Water Applications. With Scrubber Mechanism Technology, and Purple Flow Control Handle.	9 2
×	Nibco T-113-K Class 125 bronze gate shut off valve with cross handle, same size as mainline pipe diameter at valve location. Size Range - 1/4" - 3"	14
MV	Hunter ICV-G-FS-R 3" 1", 1-1/2", 2", and 3" Plastic Electric Master Valve, Globe Configuration, with NPT Threaded Inlet/Outlet, for Commercial/Municipal Use. With Filter Sentry Factory Installed Option, and Reclaimed Water ID, Purple Handle.	1
C	Hunter A2C-75D-PP 75-Station Decoder controller on a Plastic Pedestal.	1
⋄	Hunter ICD-100 Single Station Decoder w/Surge Suppression and Ground Wire. To be installed on Universal Decoder Stake Kit (DECSTAKE10).	9
∞	Hunter ICD-200 2-Station Decoder with Surge Suppression and Ground Wire. To be installed on Universal Decoder Stake Kit (DECSTAKE10).	2
S	Hunter ICD-SEN 2-input sensor decoder with surge suppression and ground wire. To be installed on Universal Decoder Stake Kit (DECSTAKE10).	1
(RS)	Hunter Solar-Sync-Sen Solar, rain freeze sensor with outdoor interface, connects to Hunter X-Core and ACC Controllers, install as noted. Includes gutter mount bracket. Wired. Module not included.	1
FS	Hunter HFS-300 Flow Sensor for use with ACC controller, 3" Schedule 40 Sensor Body, 24 VAC, 2 amp.	1
X X	Cap for future use Cap at the mainline or lateral line for future use. The pressure and flow provided to that location are indicated next to the cap symbol.	10
М	Water Meter 2" Reclaimed water meter requires 72 GPM @ 65 PSI. Irrigation contractor shall be responsible to verify the sources ability to service the systems requirements at site before starting construction.	1
	Irrigation Lateral Line: PVC Class 200 SDR 21-NP Only lateral transition pipe sizes 1" and above are indicated on the plan, with all others being 3/4" in size.Install 12" below final grade.	5,990 l.f.
	Irrigation Mainline: PVC Class 200 SDR 21-NP Pipe sizes 3" inch or smaller shall have bell and socket joints. Pipe sizes larger then than 3" inch shall have snap connections w/ rubber gasket joints, thrust blocked. Install 18" below grade.	2,715 l.f.

Pipe Sleeve: PVC Class 200 SDR 21

the Owners representative.

the Owners representative.

Valve Number

Valve Callout

Pipe Sleeve: PVC Schedule 40

Sizes shall be twice the diameter of the pipe or wire bundle 212.2 l.f.

carried. Place below all paving, hardscape etc. and as directed by

Sizes shall be twice the diameter of the pipe or wire bundle

carried. Place below all paving, hardscape etc. and as directed by

407.4 l.f.

IRRIGATION SCHEDULE

<u>SYMBOL</u>	MANUFACTURER/MODEL/DESCRIPTION	$QTY \wedge$	<u>PSI</u>	
8 08HE-VAN 12 12HE-VAN 15 15HE-VAN	Rain Bird RD-06-P30-F-NP-U HE-VAN Series Turf Spray, 6.0" Pop-Up, with 30 psi in-stem pressure regulation, (Flow-Shield Technology, and Non-Potable Cover (purple cap). 1/2" NPT female threaded inlet.	156	30	
	Hunter AFB 10 Adjustable Flow Bubbler, 1/2" FIPT, stainless steel screw adjustment.	272	20	
SYMBOL	MANUFACTURER/MODEL/DESCRIPTION	<u>QTY</u>	<u>PSI</u>	RADIL
30)	Rain Bird 5006-NP-PC,FC-MPR Turf Rotor, 6" Pop-Up, Plastic Riser, Matched Precipitation Rotor (MPR nozzle). Arc and Radius as per Symbol. 25 ft=red, 30 ft=green, 35ft=beige. With Non-Potable Purple Cover.	18	35	30'
35)	Rain Bird 5006-NP-PC,FC-MPR Turf Rotor, 6" Pop-Up, Plastic Riser, Matched Precipitation Rotor (MPR nozzle). Arc and Radius as per Symbol. 25 ft=red, 30 ft=green, 35ft=beige. With Non-Potable Purple Cover.	3	35	34'
SYMBOL	MANUFACTURER/MODEL/DESCRIPTION	<u>QTY</u>		
	Rain Bird XCZ-150-LCDR High Flow Control Zone Kit, for Large Commercial Drip Zones. 1-1/2" PESB-R Scrubber Globe Valve with single 1-1/2" Pressure Regulating (40psi) Quick-Check Basket Filters. Flow range: 15-62gpm.	3		
©	Rain Bird MDCFPCAP Dripline Flush Valve purple cap in compression fitting coupler. For non-potable water use.	6		
	Rain Bird OPERIND Drip System Operation Indicator, stem rises 6" for clear visibility when drip system is charged to a minimum of 20psi. Includes 16" of 1/4" distribution tubing with connection fitting pre-installed.	3		
	Area to Receive Dripline Rain Bird XFD-09-12-NP XFD On-Surface Pressure Compensating Landscape Dripline. 0.9 GPH emitters at 12" O.C. Dripline laterals spaced at 12" apart, with emitters offset for triangular pattern. UV Resistant. Specify XF insert fittings.	5,022 s.f.		



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December 10, 2021

Irrigation 12-10-202

Town Comments 1-19-2022

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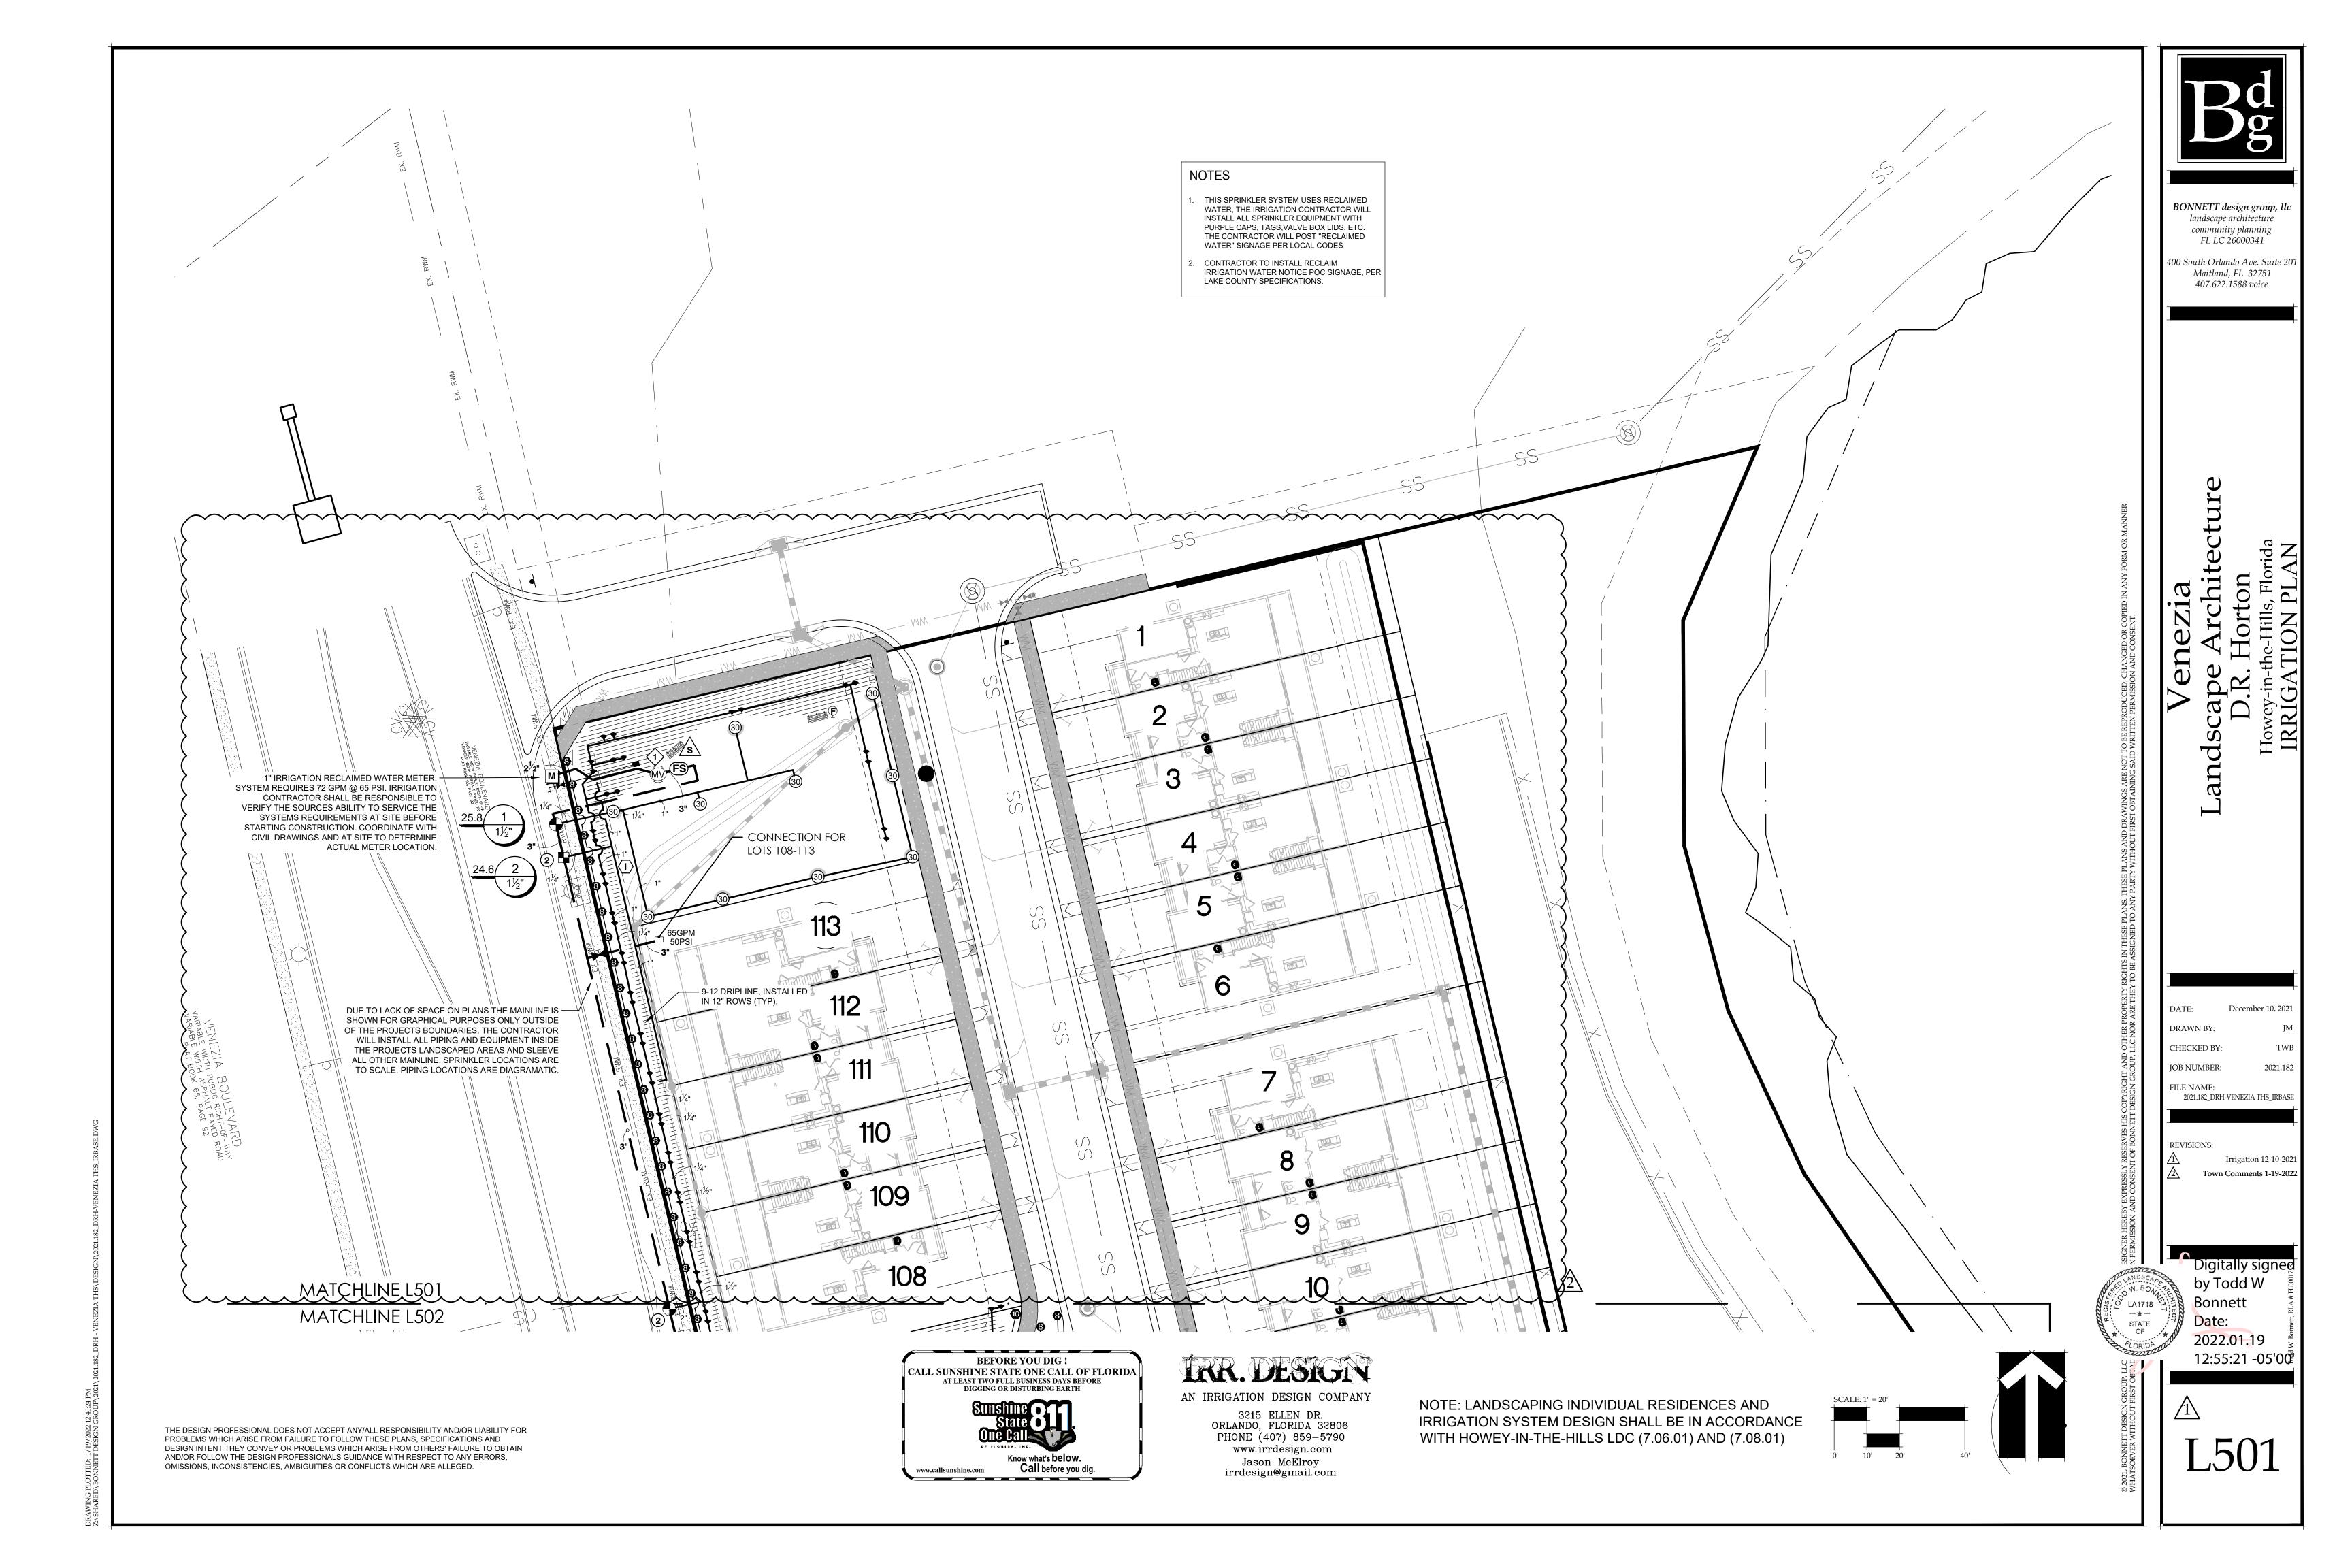
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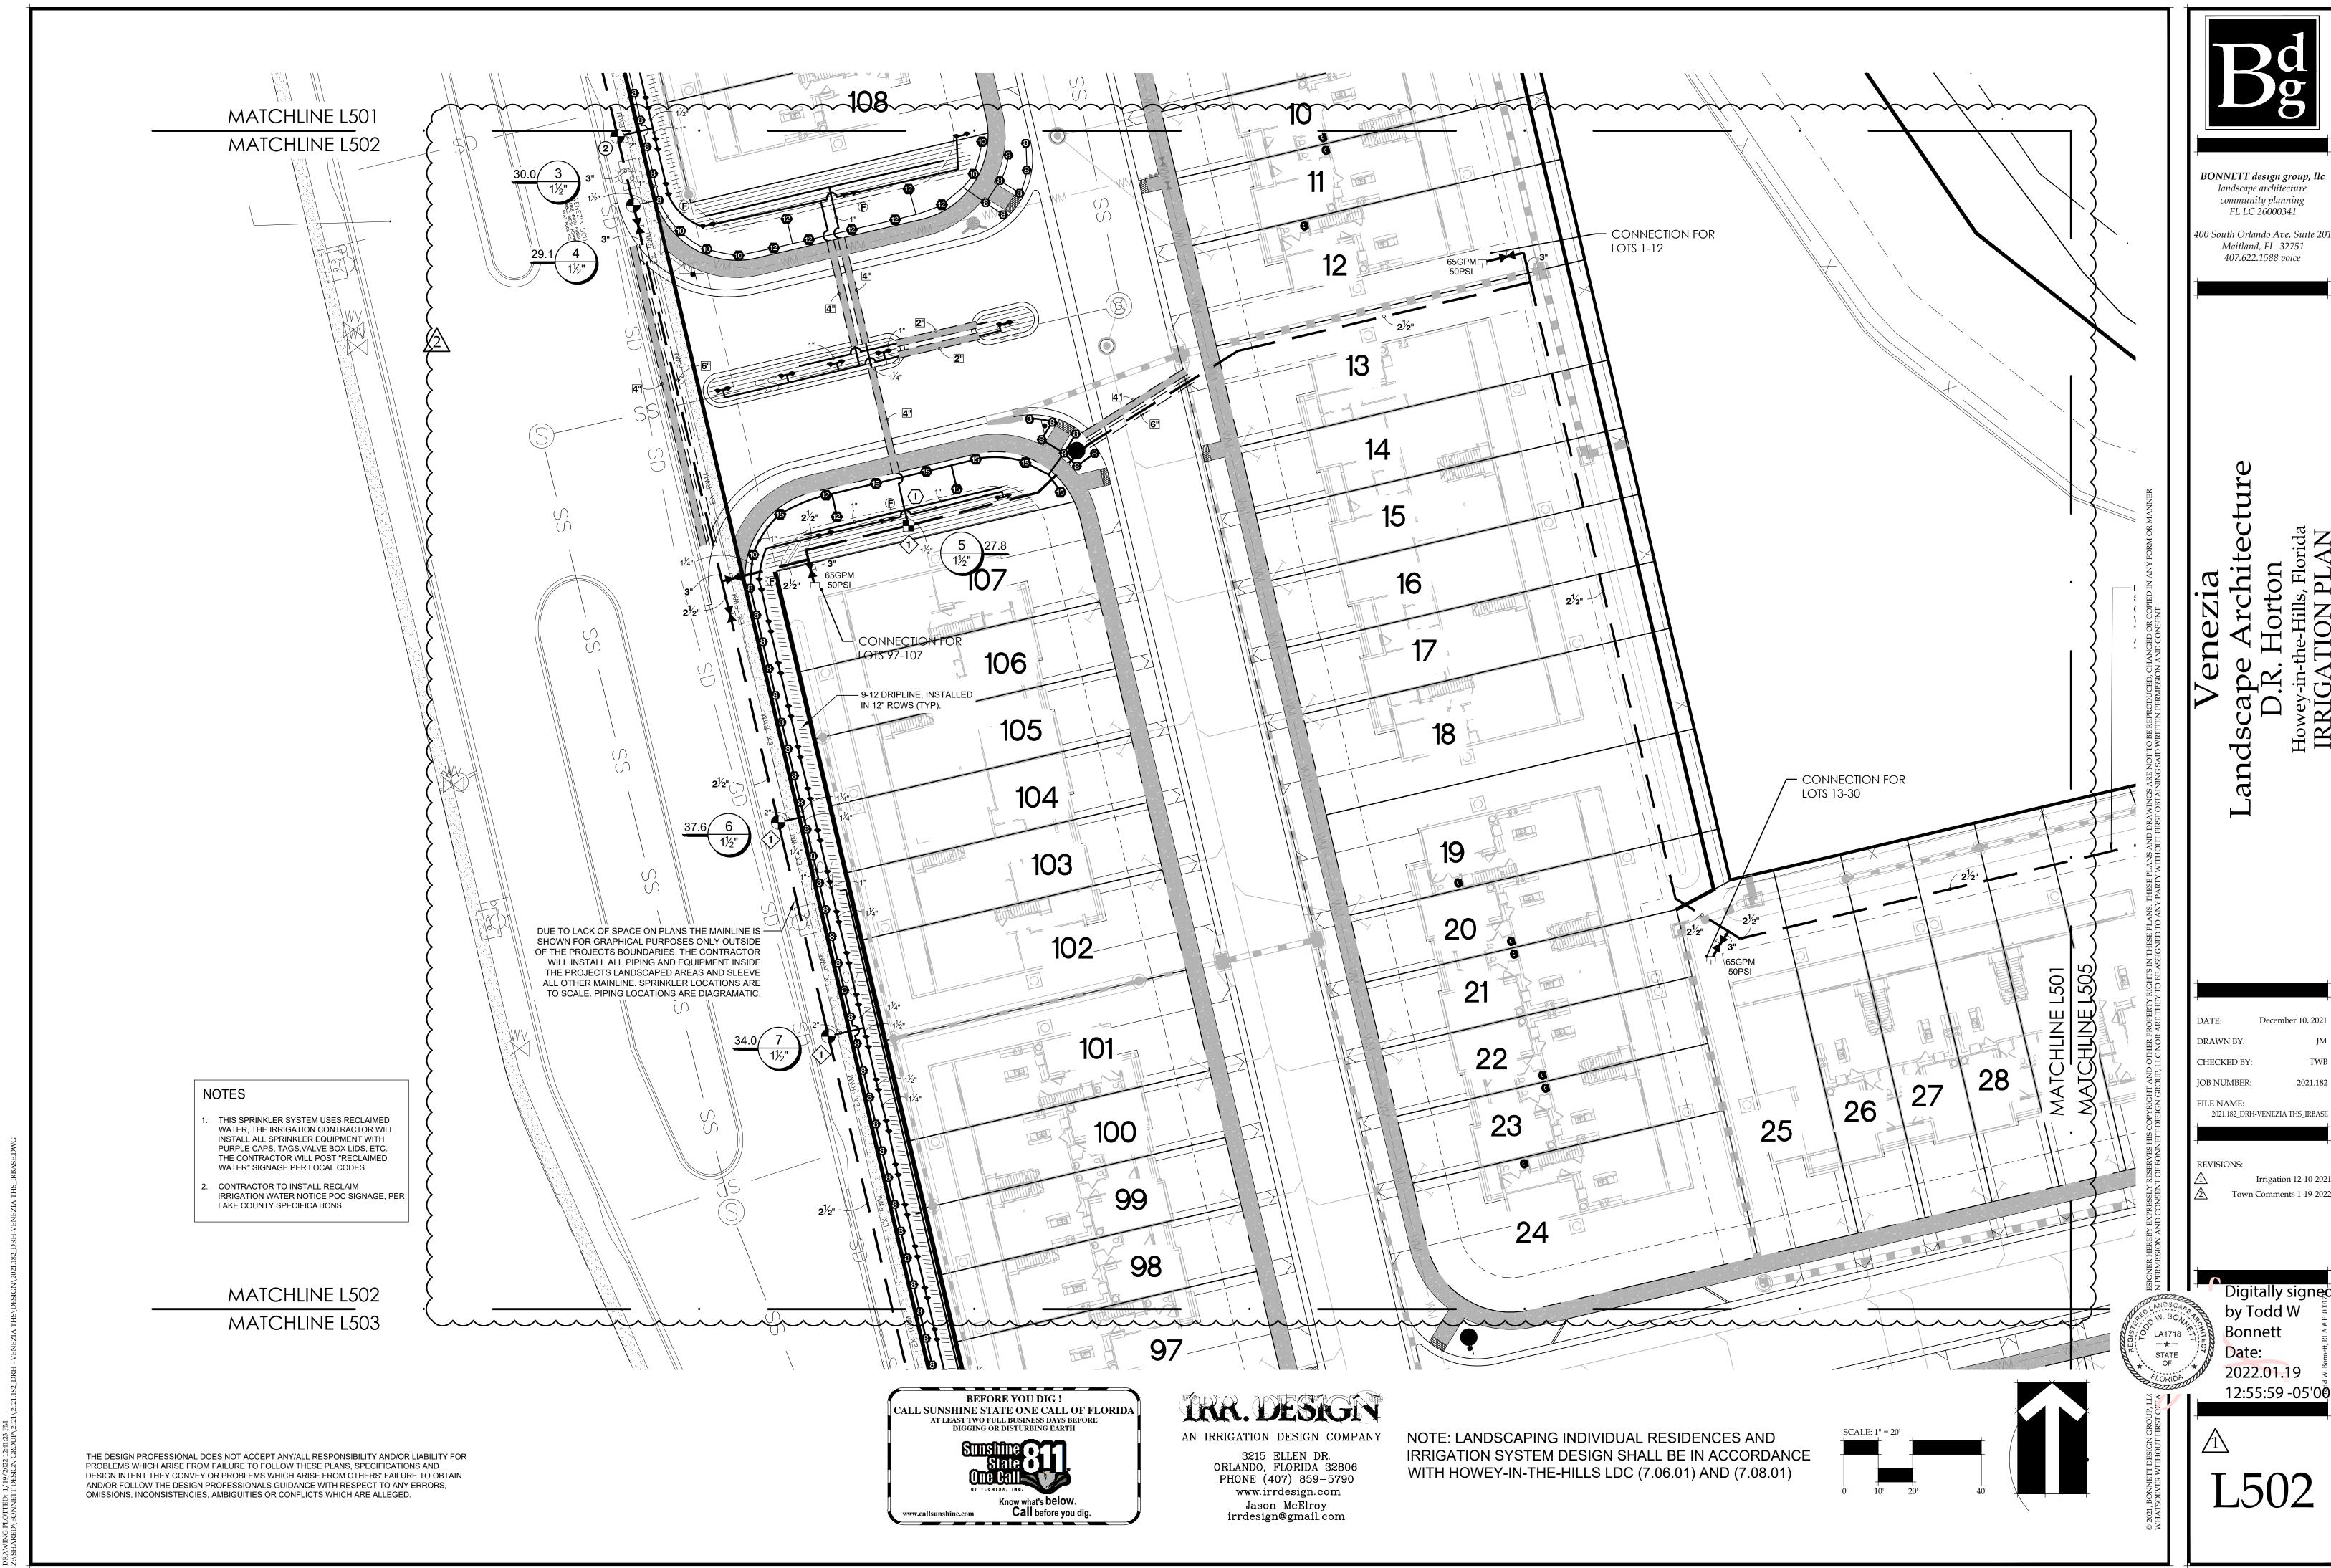
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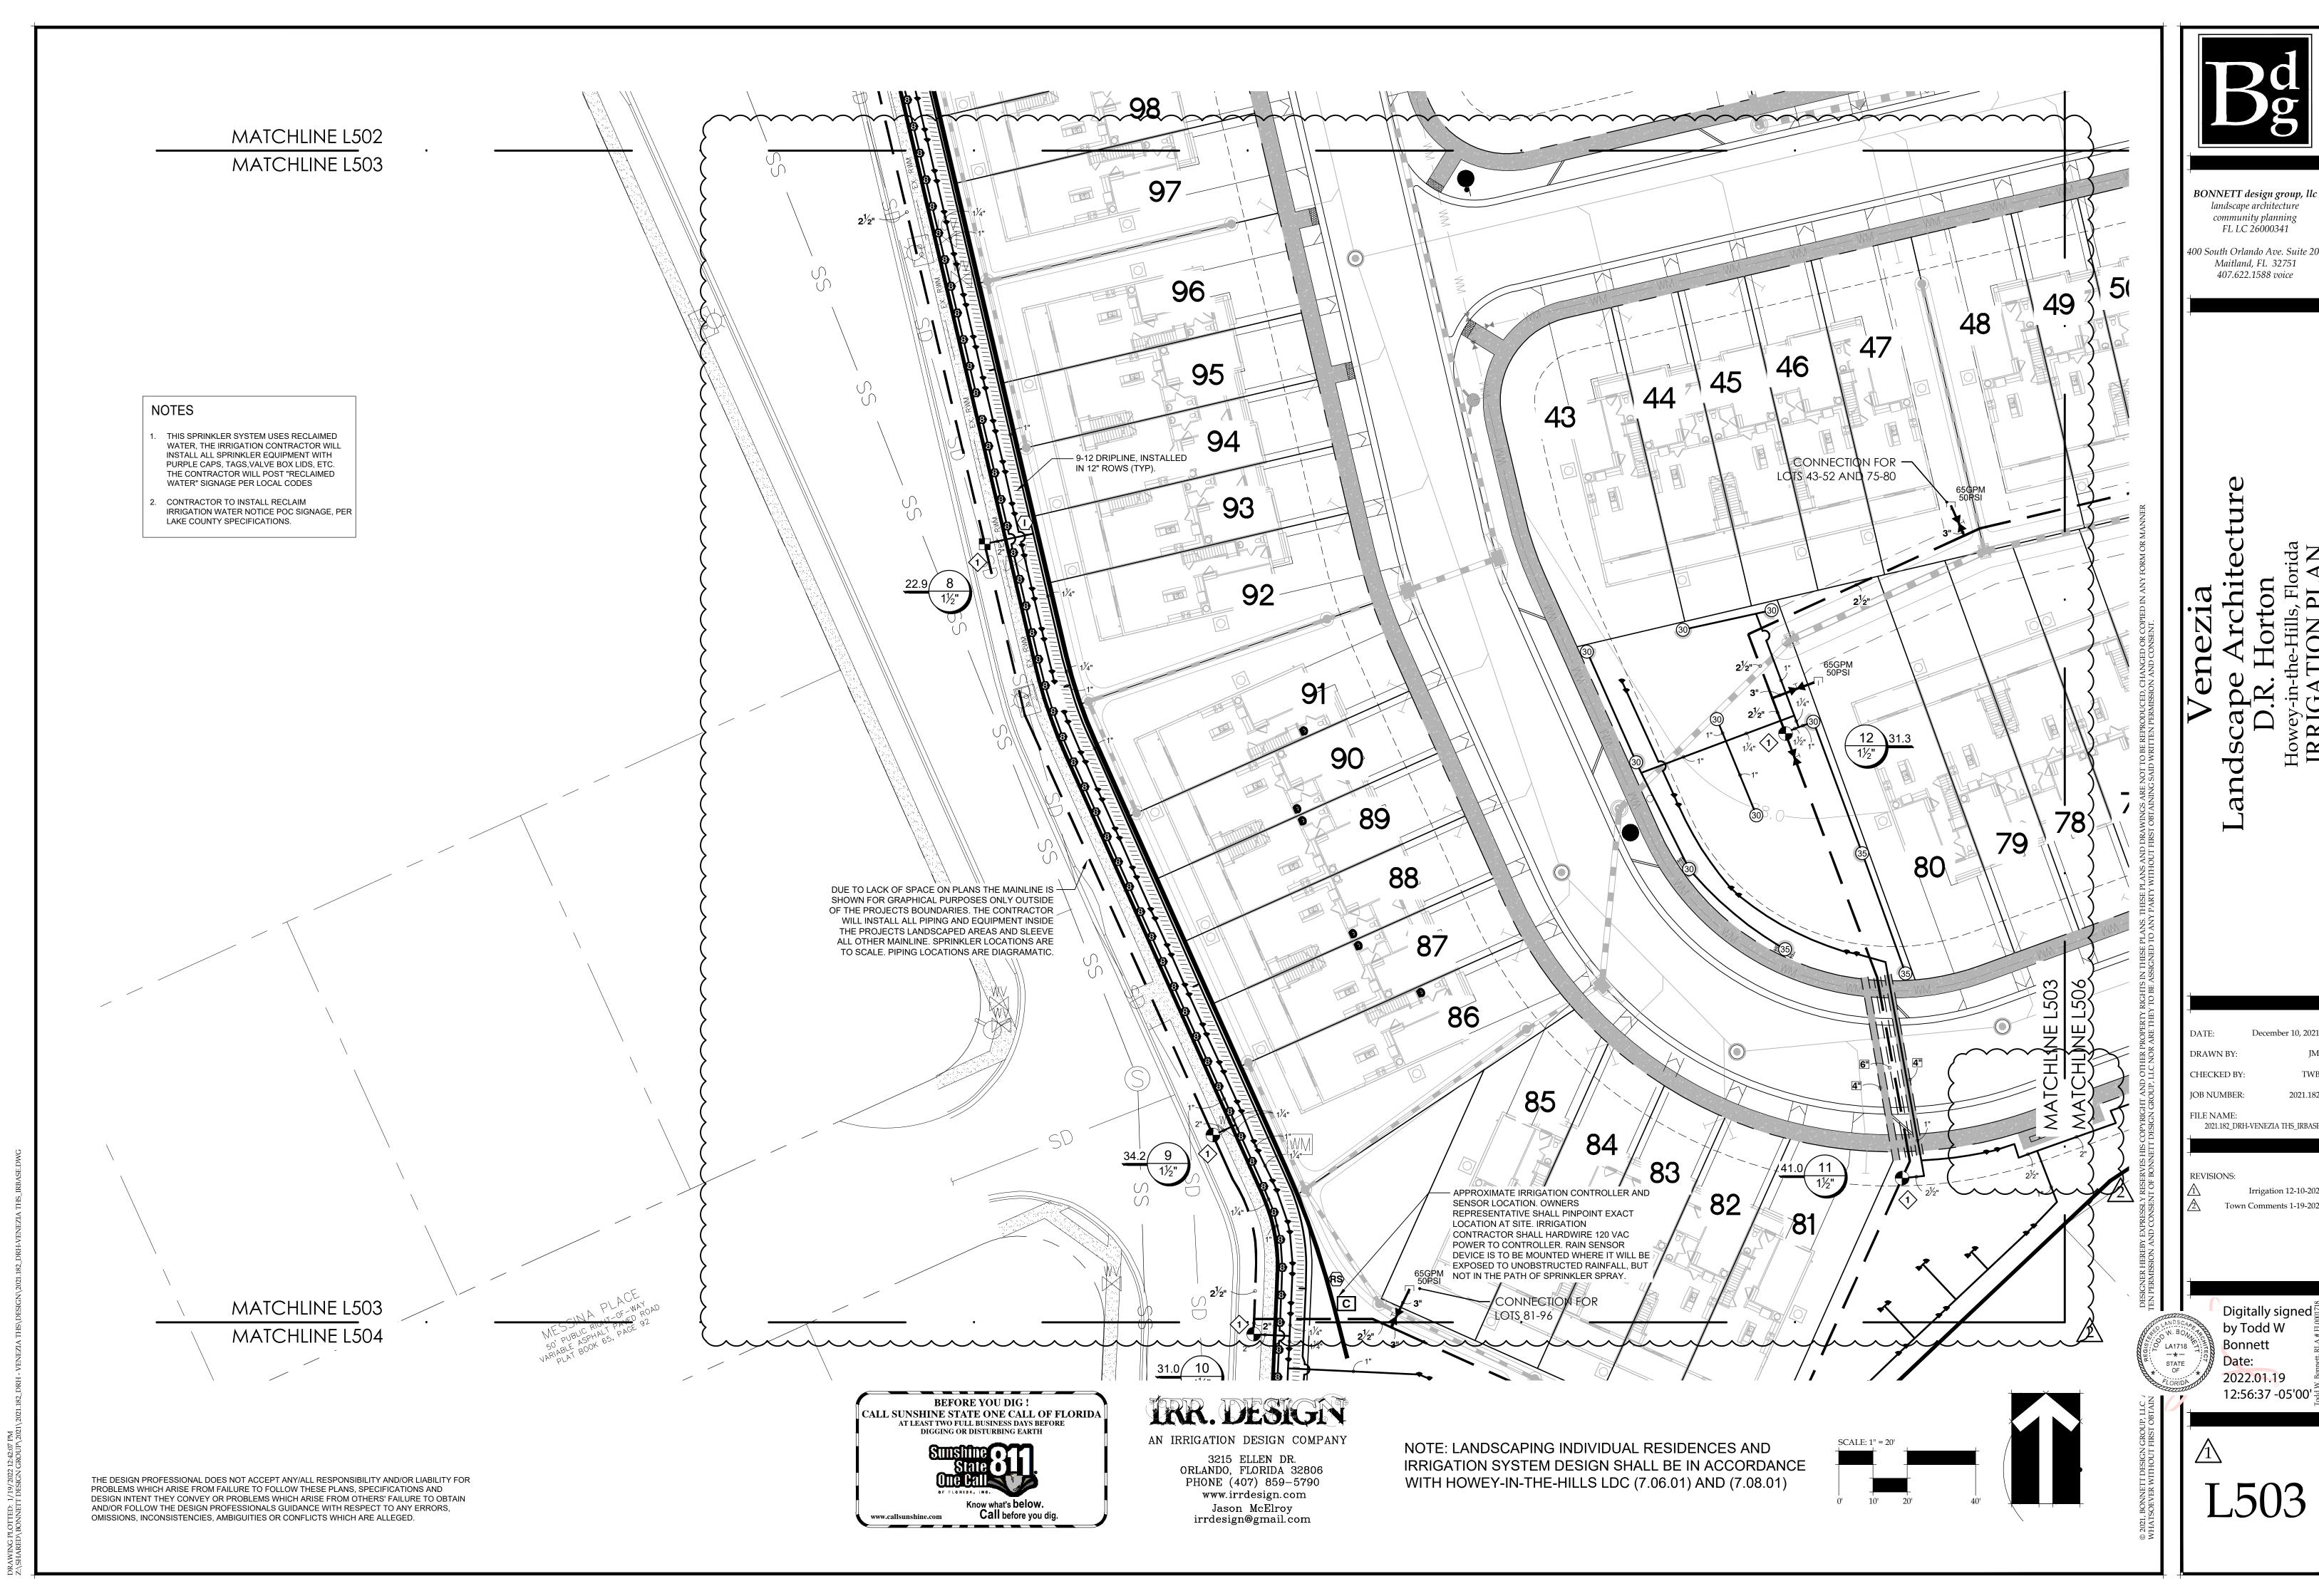




December 10, 2021


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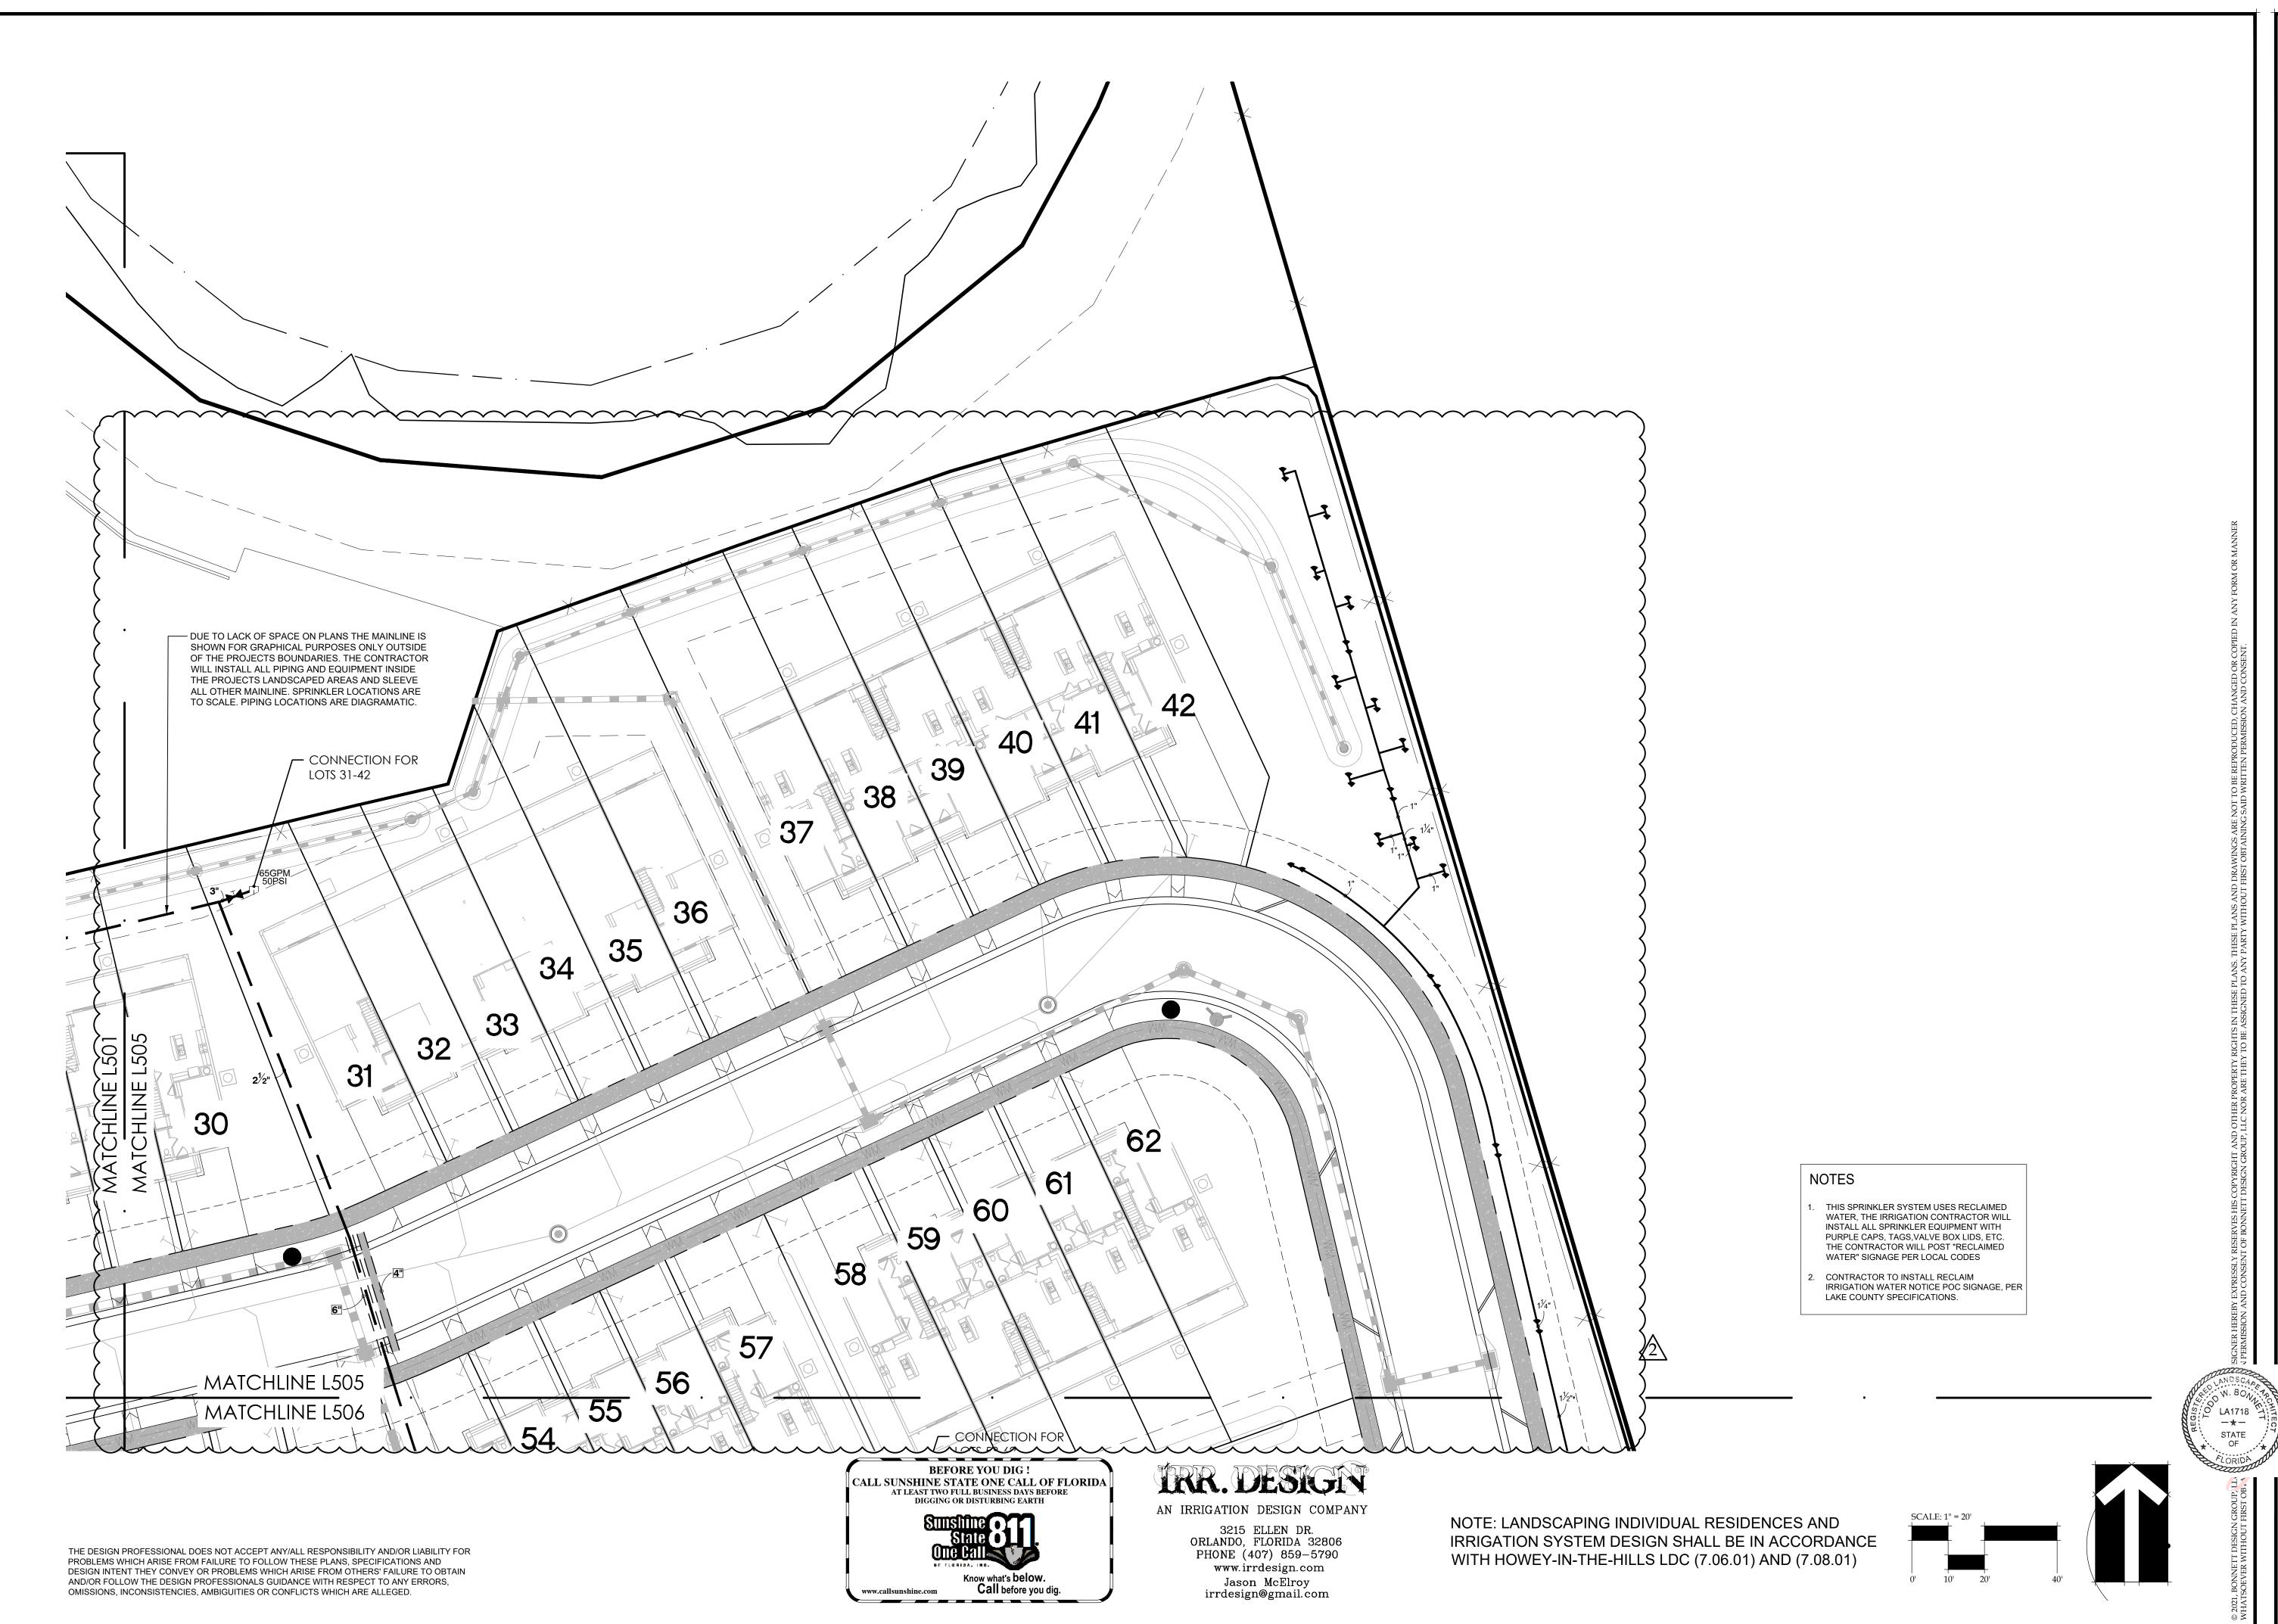
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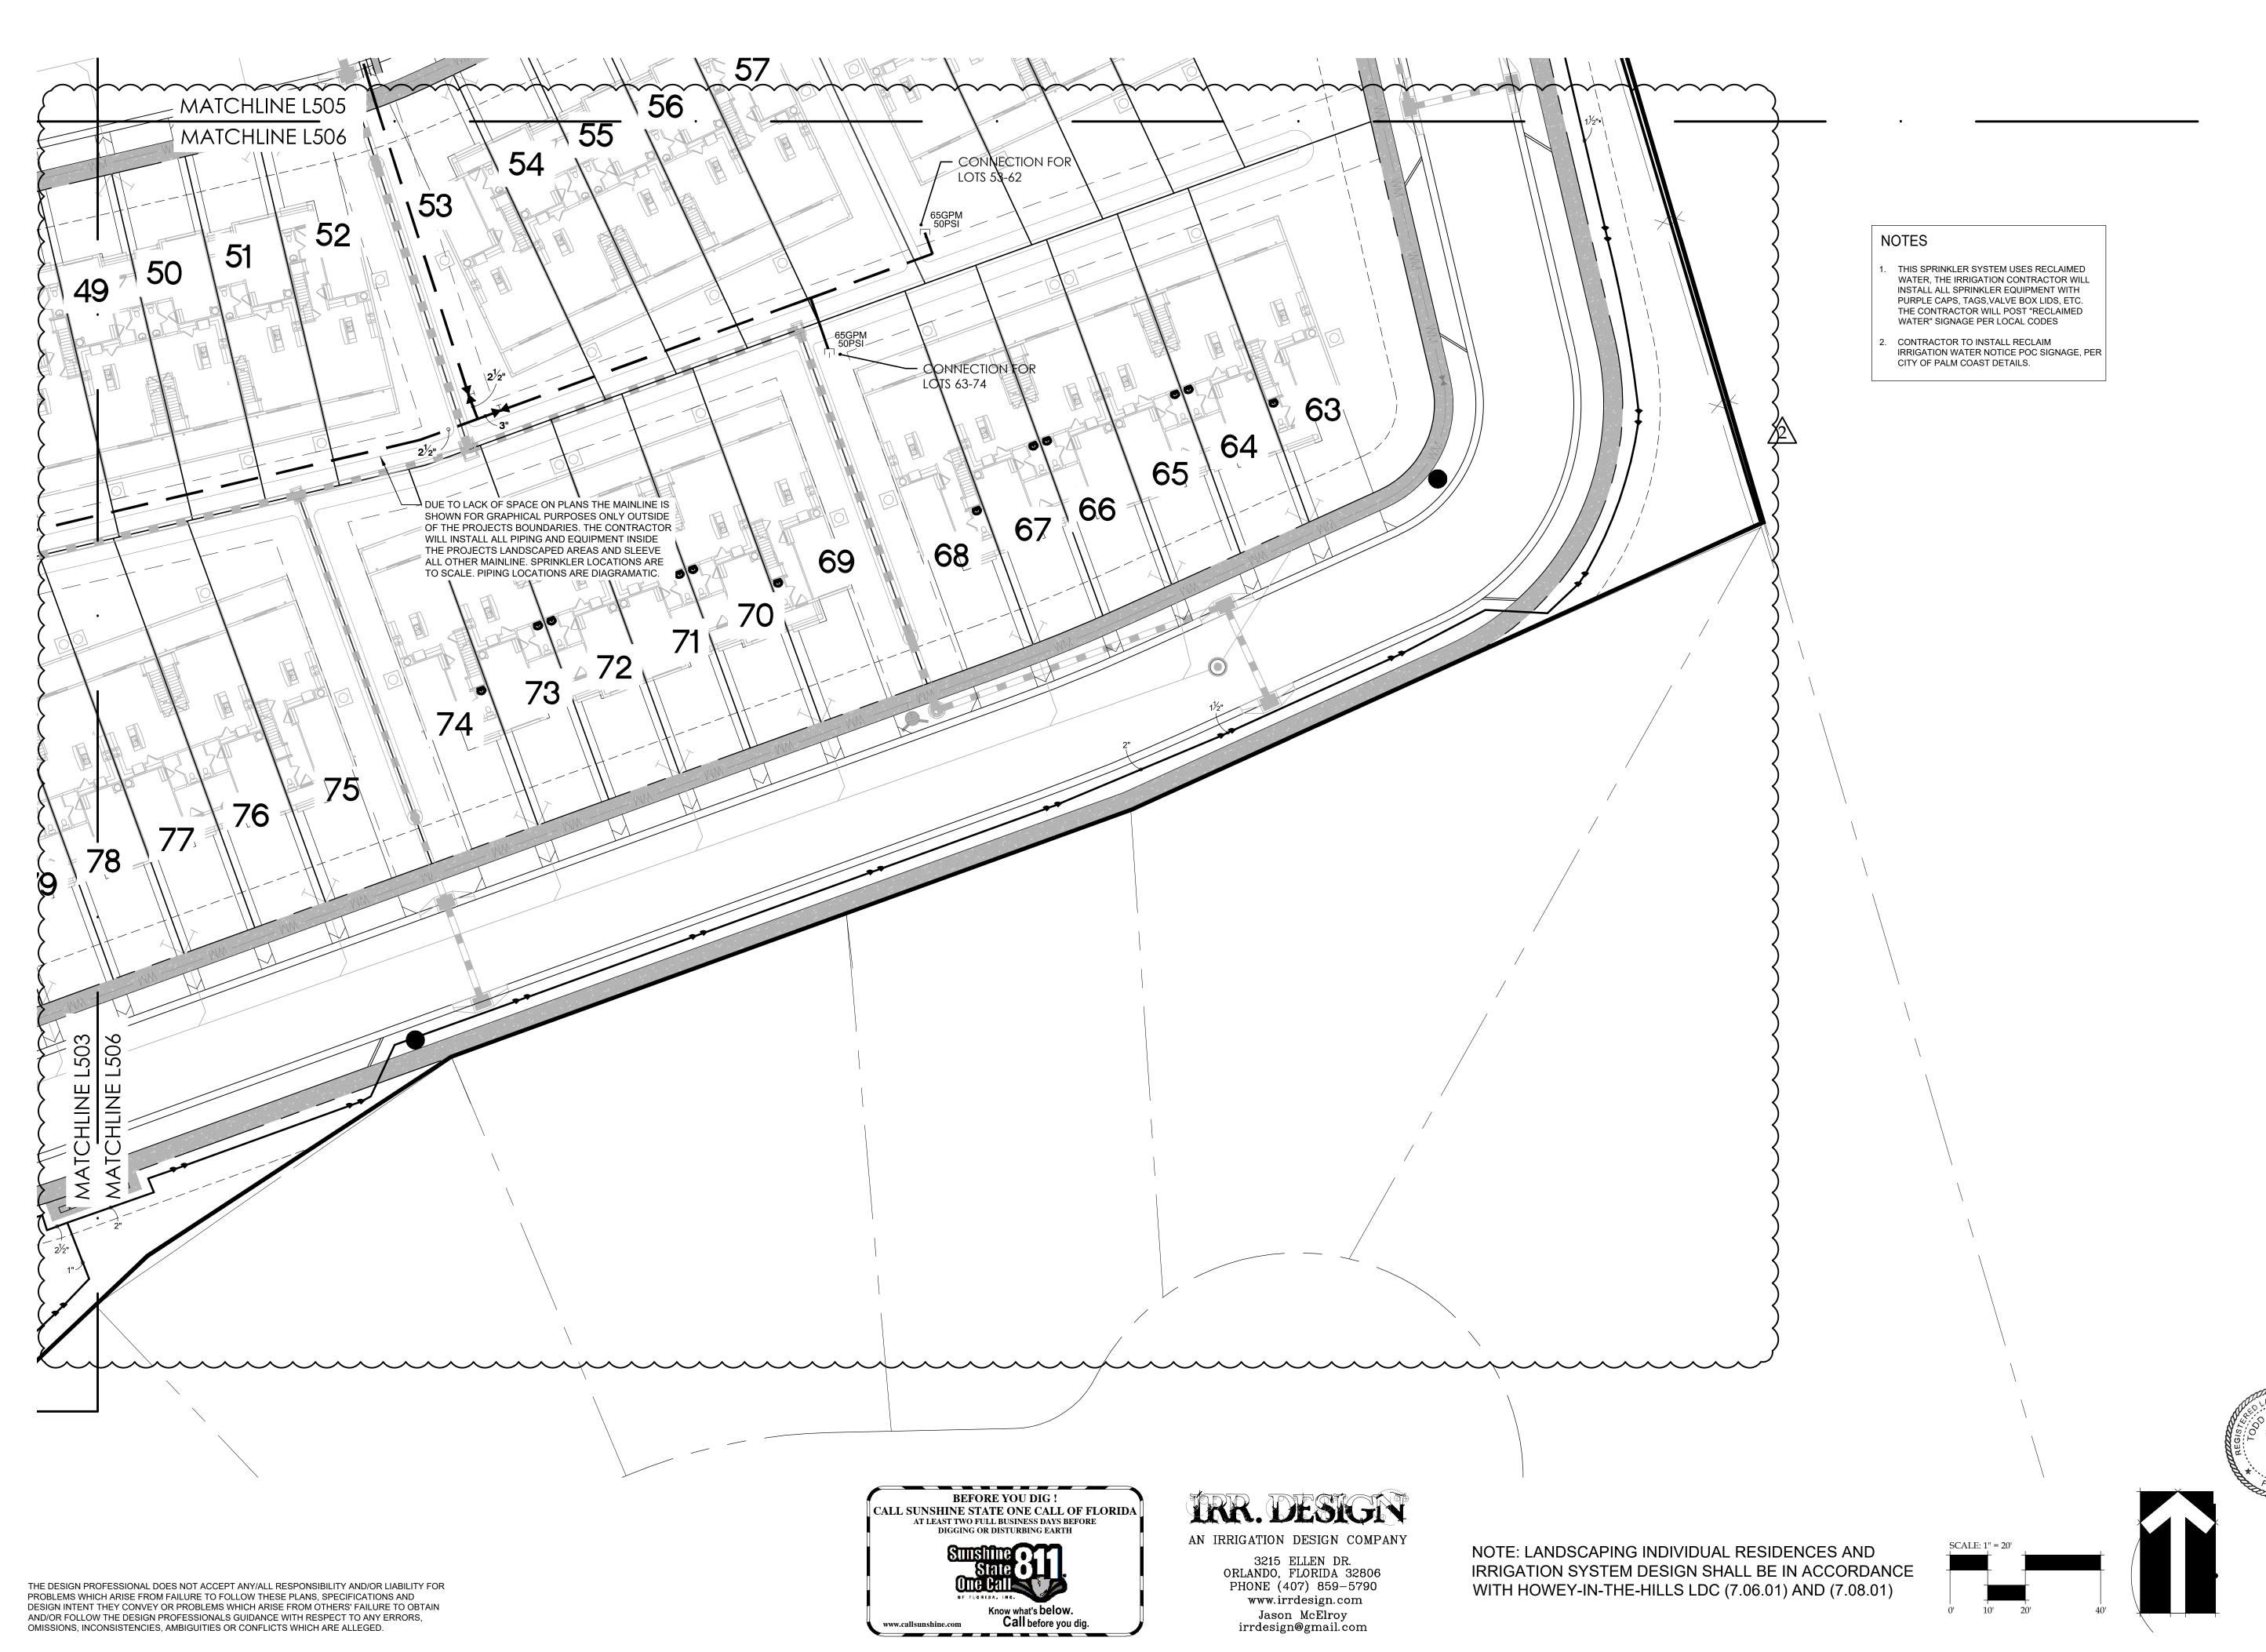
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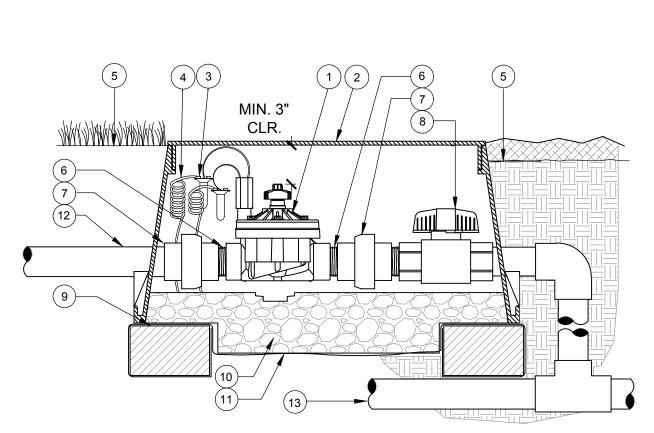
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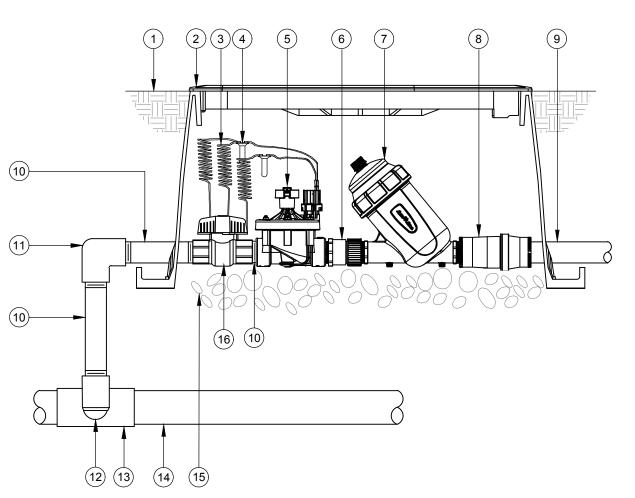
by Todd W Bonnett Date:

2022.01.19 12:58:28 -05'00'

MASTER VALVE / FLOW SENSOR ASSEMBLY



ELECTRIC REMOTE CONTROL VALVE

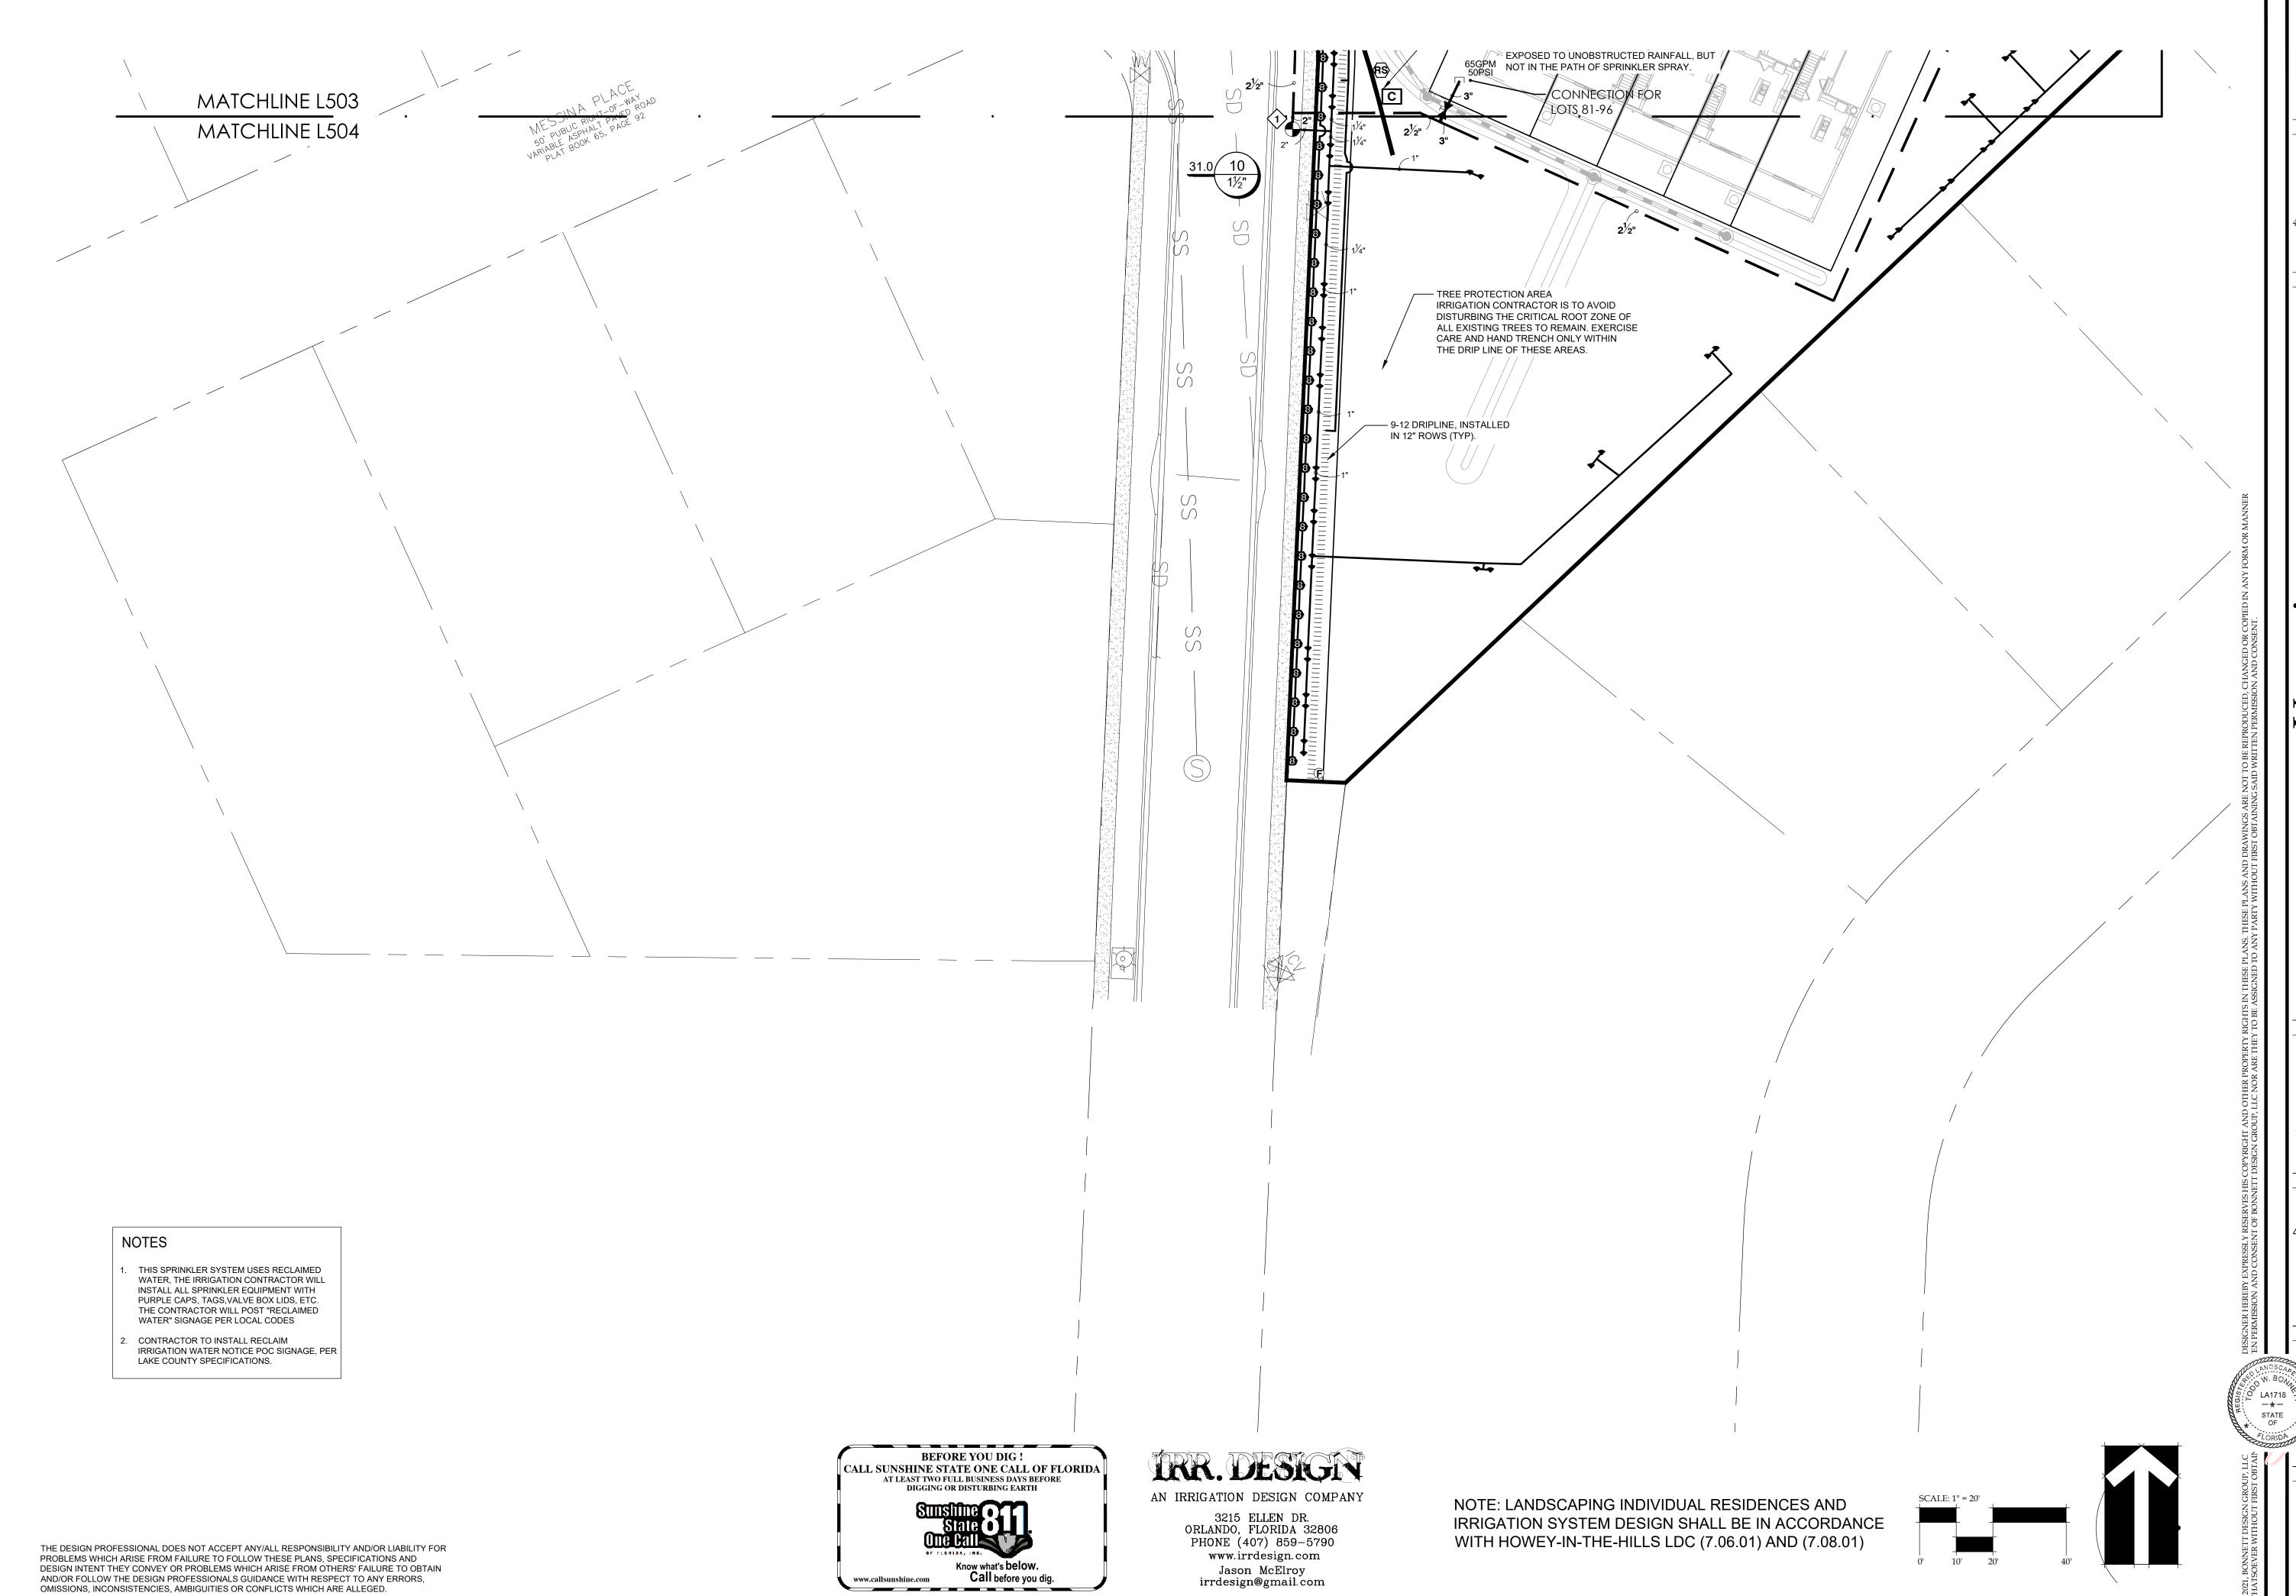

 $(\ 1 \)$ REMOTE CONTROL VALVE WITH

(2) IRRIGATION VALVE BOX: HEAT

LETTERS

FLOW CONTROL - PER PLAN

STAMP LID WITH 'RCV' IN 2"

(3) WATERPROOF CONNECTORS (2)

(4) 18"-24" COILED WIRE TO

(5) FINISH GRADE AT ADJACENT

SURFACE (TURF OR MULCH)

(6) SCH. 80 CLOSE NIPPLE, SIZE PER

(7) PVC SLIP (OR FPT) X FPT UNION

(8) ISOLATION VALVE, LINE SIZE

(10) FILTER FABRIC - WRAP TWICE AROUND BRICK SUPPORTS

(11) 3/4" WASHED GRAVEL - 4" MIN.

(9) BRICK SUPPORTS (4)

(12) IRRIGATION LATERAL

(13) MAINLINE AND FITTINGS

CONTROLLER

(1) FINISH GRADE/TOP OF MULCH (2) JUMBO VALVE BOX WITH PURPLE COVER: RAIN BIRD VBJMBPL

(3) 30-INCH LINEAR LENGTH OF WIRE, COILED (4) WATERPROOF CONNECTION:

RAIN BIRD DB SERIES (5) 1 1/2" PESB-R VALVE (INCLUDED IN XCZ-150-LCDR

(6) 1 1/2" SCH 40 ADAPTER (MALE X FEMALE) INCLUDED IN XCZ-150-LCDR KIT

(7) 1 1/2" FILTER - RAIN BIRD LARGE CAPACITY DISC FILTER (INCLUDED IN XCZ-150-LCDR KIT) (8) 1 1/2" HIGH FLOW PRESSURE REGULATOR

(INCLUDED IN XCZ-150-LCDR KIT) (9) LATERAL PIPE

(10) PVC SCH 80 NIPPLE 1 1/2" (11) PVC SCH 40 ELBOW

(12) PVC SCH 80 NIPPLE (2" LENGTH, HIDDEN) AND PVC 40 ELBOW

(13) PVC SCH 40 TEE OR ELBOW (14) MAINLINE PIPE

(15) 4" MINIMUM DEPTH OF 3/4" WASHED GRAVEL

(16) ISOLATION VALVE, LINE SIZE

RAIN BIRD XCZ-150-LCDCR 1.5" COMMERCIAL CONTROL ZONE KIT IN JUMBO VALVE BOX

SIDE VIEW

INFLUENCE.

WALK THROUGH

IRRIGATION SYSTEM PERFORMANCE NOTES

IRRIGATION SYSTEM IS DESIGNED TO OPERATE OFF A RECLAIMED WATER METER PROVIDING A MINIMUM FLOW OF 72 GPM AND A MINIMUM PRESSURE OF 65 PSI.

CONTRACTOR MUST CONTACT THE LANDSCAPE ARCHITECT PRIOR TO THE COMMENCEMENT OF ANY CONSTRUCTION IF THE AVAILABLE FLOW AND PRESSURE DEVIATES MORE THEN 5% OR WILL AFFECT THE PERFORMANCE OF THE SYSTEM.

MINIMUM PRESSURE REQUIREMENTS - 65 PSI AT THE POINT OF CONNECTION A. 35 PSI AT THE BASE OF THE POP-UP ROTOR/ROTATOR HEADS B. 30 PSI AT THE BASE OF THE POP-UP SPRAY HEADS

. HEAD LAYOUT IS BASED ON BASE INFORMATION PROVIDED. HEADS SHALL BE ADJUSTED TO ACCOMMODATE FIELD VARIATIONS WHILE MAINTAINING 100% COVERAGE AND MINIMIZING OVER-SPRAY ONTO PAVED AREAS AND BUILDINGS.

3. $\frac{1}{2}$ " PIPE SHALL NOT BE USED FOR LATERAL PIPING

DRIP TUBING NOTES

INSTALL DRIP TUBING AT GRADE AND COVER WITH MULCH. TYPICAL SPACING FOR DRIP TUBING IS 12" TO 18" ON CENTER. SPACING TO BE DETERMINED BY PLANT LAYOUT. REFER TO LANDSCAPE PLAN. ANCHOR TUBING EVERY 10' WITH 12" LONG PLASTIC TUBING STAKES. INSTALL FLUSH VALVE ASSEMBLIES AT ALL TUBING "DEAD ENDS". INSTALL AIR/VACUUM RELIEF VALVES AT "HIGH POINTS" OF EVERY SECTION.

GRID LAYOUT SHALL BE USED ON THIS PROJECT. USE CENTER GRID LAYOUT WHERE **POSSIBLE**

WHEN SLEEVING DRIPLINE, USE BLANK DRIPLINE IN SLEEVE. SLEEVE SHALL BE 2X DRIPLINE DIAMETER. NO EMITTER DRIPLINE SHALL BE PLACED IN SLEEVE. THE LENGTH OF ANY DRIPLINE LATERAL SHALL NOT BE LONGER THAN:

12" EMITTERS @ 0.9 GPH

b) @ 20 PSI = 169 FEET c) @ 30 PSI = 230 FEET

d) @ 40 PSI = 255 FEET

LATERAL DISTANCE DOUBLED WHEN CENTER FEED LAYOUT USED (SEE CENTER FEED LAYOUT DETAIL. MANUAL FLUSH VALVE SHALL BE USED & PLACED WITH A 6" X 6" SUMP. VALVES SHALL BE

OPENED EVERY WATERING DAY FOR 2 WEEKS AND THEN A MINIMUM OF 2 TIMES A YEAR TO CLEAR DRIPLINE OF DEBRIS. AIR/VACUUM RELIEF SHALL BE INSTALLED WHEN THE CHANGE IN SLOPE OCCURS 3% OR

STAPLES SHALL BE USED AT 5' O.C. AND 2 STAPLES 'X'ED OVER EACH OTHER WITH ANY CHANGE IN DIRECTION, ELBOWS, OR CROSSES.

SUPPLY, EXHAUST HEADERS AND DRIPLINE SHALL BE PLACED 2"- 4" FROM PLANTS AND PAVEMENT EDGES. . BLANK DRIPLINE SHALL BE USED FOR ALL SUPPLY AND EXHAUST HEADERS, UNLESS

OTHERWISE NOTED ON PLANS. 10. PRIOR TO COVERING DRIPLINE, DRIPLINE CIRCUIT WILL BE PRESSURIZED AND TESTED FOR PROPER OPERATION.

. DRIP LINE LATERALS SHALL BE LAID IN THE LONGEST RUN, WHETHER IT BE THE WIDTH OR LENGTH OF THE ZONE.

RECLAIMED WATER NOTES

ALL PIPE SHALL BE PURPLE WATER TYPE.

ALL MAINLINE SHALL HAVE MAGNETIC MARKER TAPE PLACED IN THE TRENCH 6" ABOVE THE

ALL SPRINKLER HEADS SHALL HAVE PURPLE RECLAIMED IDENTIFICATION. ALL MANUAL AND ELECTRIC VALVES SHALL HAVE TAGS TO INDICATE RECLAIMED WATER.

ALL VALVE BOXES SHALL HAVE PURPLE LIDS TO INDICATE THE PRESENCE OF RE-USE WATER. ALL CROSSINGS OF IRRIGATION PIPING AND POTABLE WATER LINES SHALL HAVE THE

AS-BUILT DRAWING BY DOCUMENTING THE VERTICAL MEASUREMENTS SEPARATING THE PIPES. THE VERTICAL SEPARATION BETWEEN THE POTABLE AND RECLAIMED WATER LINES SHALL BE A MINIMUM OF 18". THIS SEPARATION SHALL BE VERIFIED AND DOCUMENTED IN A SET OF AS-BUILTS DRAWINGS AS PER SPECIFICATIONS. THE HORIZONTAL SEPARATION SHALL BE 5' CENTER TO CENTER AND 3' OUTSIDE TO OUTSIDE IF VERTICAL MINIMUM OF 18" IS NOT MET. REFER TO THE SPECIFIC CODE IF THESE SEPARATIONS CANNOT BE MET.

VERTICAL CLEARANCE VISUALLY VERIFIED AND THE VERIFICATION MUST BE SHOWN ON THE

GENERAL IRRIGATION NOTES

1. ALL MAINLINES TO HAVE A MINIMUM OF 18" OF COVER. (CLASS 200 PVC PIPE).

2. ALL LATERAL AND SUB-MAIN PIPE TO HAVE A MINIMUM OF 12" OF COVER (CLASS 200 PVC PIPE). 3. NO ROCKS, BOULDER, OR OTHER EXTRANEOUS MATERIALS TO BE USED IN BACKFILLING OF TRENCH.

4. ALL PIPE TO BE INSTALLED AS PER MANUFACTURERS' SPECIFICATIONS. 5. ALL THREADED JOINTS TO BE COATED WITH TEFLON TAPE OR LIQUID TEFLON.

6. ALL LINES TO BE THOROUGHLY FLUSHED BEFORE INSTALLATION OF SPRINKLER HEADS.

7. SPRINKLER AND RELATED EQUIPMENT TO BE INSTALLED AS PER DETAILS. 8. ALL ELECTRICAL JOINTS TO BE MADE USING WATERPROOF CONNECTIONS AS SHOWN ON DETAILS. 9. ALL EQUIPMENT NOT SPECIFIED IN THE LEGEND SHALL BE DETERMINED AND FURNISHED BY THE CONTRACTOR.

10. NO ELECTRICAL CONNECTIONS SHALL BE MADE IN THE FIELD EXCEPT AT A VALVE CONTROL BOX OR ANOTHER VALVE BOX SPECIFICALLY FOR CONNECTIONS. 11. ANY DISCREPANCY BETWEEN THIS SHEET AND OTHERS IN THIS SET MUST BE REFERRED TO THE IRRIGATION

CONSULTANT BY THE CONTRACTOR FOR CLARIFICATION BEFORE PRECEDING WITH THE WORK. 12. ALL 24 VOLT WIRE SHALL BE #12 UF/UL FOR COMMON WIRE, AND #14 UF/UL FOR CONTROL WIRES, DIRECT BURIAL

13. CONTRACTOR TO BE RESPONSIBLE FOR PROPER COVERAGE OF AREAS TO BE WATERED. i.e ADJUST HEADS WITH

INSUFFICIENT COVERAGE DUE TO BLOCKAGE BY EXISTING OR PROPOSED SITE FEATURES. 14. CONTRACTOR TO REFER TO LANDSCAPE PLAN TO KEEP SPRINKLER EQUIPMENT AND ACCESSORY MATERIAL FROM INTERFERING WITH PROPER PLANTING, i.e VERIFY ROOT BALL SIZE FOR PLANTING

15. CONTRACTOR SHALL PROVIDE EXPANSION COILS AT EACH WIRE CONNECTION IN A VALVE BOX (WRAP AROUND

16. SPRINKLERS IN LOW-LYING AREAS SHALL HAVE CHECK VALVES 17. ALL SPRINKLERS TO BE MOUNTED ON FLEX PIPE - REFER TO DETAILS.

18. INSTALL DRIP LINE TUBING AND NON-PRESSURE LATERAL LEAD LINE PIPING IN LANDSCAPE AREAS AND ADJACENT TO SELECTED PLANT MATERIAL AS SHOWN IN DETAILS.

19. CONTRACTOR SHALL UTILIZE VALVE I.D. TAGS ON ALL REMOTE CONTROL VALVES.

20. 24 VOLT WIRE SHALL BE COLOR CODE; COMMON-WHITE, CONTROL-RED. 21. CONTRACTOR SHALL INSTALL MANUFACTURERS' RECOMMENDED GROUNDING EQUIPMENT FOR POWER SUPPLY

AND VALVE OUTPUT WITH (2) 5/8" COPPER CLAD GROUND RODS. 22. CONTRACTOR SHALL INSTALL MANUFACTURERS' RECOMMENDATION ON FAULT GROUND AND LIGHTNING

23. CONTROLLER GROUNDING MUST BE PER ASIC REQUIREMENTS.

24. ALL MATERIAL TO BE SUPPLIED BY CONTRACTOR TO OWNER: A. TWO WRENCHES FOR DISASSEMBLING AND ADJUSTING EACH TYPE OF SPRINKLER HEAD AND VALVE SUPPLIED.

B. TWO KEYS FOR EACH OF THE AUTOMATIC CONTROLLERS.

C. TWO QUICK COUPLER KEYS WITH MATCHING HOSE SWIVELS 26. SYSTEM IS DIAGRAMMATIC TO IMPROVE CLARITY. ALL MAINLINE PIPING, ELECTRIC VALVES AND WIRING ARE TO BE INSTALLED IN LANDSCAPED AREAS AND REFERENCE THE LANDSCAPE PLAN PRIOR TO THE INSTALLATION OF PIPING TO AVOID CONTACT WITH PLANT MATERIALS EXISTING OR NEW.

27. CONTRACTOR TO ADD EXTENSION RISERS TO POP-UP HEADS WHEN NEEDED TO PROVIDE PROPER COVERAGE. 28. CONTRACTOR SHALL INSTALL SPRINKLER EQUIPMENT 18" FROM FOUNDATIONS, ALSO INSTALL SPRINKLERS 4" FROM CURBS OR WALKS.

29. PRIOR TO BID IRRIGATION CONTRACTOR SHALL VERIFY RIGHT-OF-WAY AND BACKFLOW REQUIREMENTS NO LATER THAN FIVE DAYS BEFORE BID SUBMITTALS. CONTRACTOR SHALL NOTIFY CONSULTANT OF ANY CHANGES FROM PLANS OR SPECIFICATIONS.

30. IRRIGATION CONTRACTOR SHALL PROVIDE THE OWNER AND LANDSCAPE ARCHITECT WITH A REPRODUCIBLE AS-BUILT DRAWING OF THE INSTALLED IRRIGATION SYSTEM IN A PDF FILE FORMAT BEFORE FINAL ACCEPTANCE. PROVIDE CROSS-MEASURED LOCATIONS OF ALL VALVE LOCATIONS, CONTROLLER, WATER SOURCE, WIRE

SPLICES, SLEEVE LOCATIONS, ETC. 31. A 1-YEAR WARRANTY PERIOD SHALL BE PROVIDED FOR SYSTEM AFTER SUBSTANTIAL COMPLETION IS ACCEPTED START UP AND ADJUSTING OF SYSTEM IN SPRING TIME SHALL BE INCLUDED IN WARRANTY.

32. PRIOR TO BID, CONTRACTOR SHALL VERIFY THAT ALL MATERIAL, INSTALLATION PARAMETERS AND OPERATIONS CONFORM TO ALL APPLICABLE CODES AND ORDINANCES NO LATER THAN FIVE DAYS BEFORE BID SUBMITTALS. CONTRACTOR SHALL NOTIFY IRRIGATION CONSULTANT/DESIGNER OF ANY CHANGES REQUIRED DUE TO CURRENT CODE OR ORDINANCE DISCREPANCIES. IF CONTRACTOR DOES NOT COMPLY TO THIS NOTIFICATION, THE CONTRACTOR SHALL BE RESPONSIBLE FOR ALL NECESSARY INSTALLATION CHANGE AND REDESIGN COSTS FOR NON-COMPLIANCE.

33. UNLESS OTHERWISE NOTED, THE CONTRACTOR MUST COMPLETE TWO PRESSURE TESTS OF THE IRRIGATION SYSTEM MAINLINE(BOTH TO SHOW NO DROP IN PRESSURE DURING DURATION OF THE TEST). A. 2-HOUR PRESSURE TEST AT 1.5 TIMES THE SYSTEM STATIC PRESSURE

B. 24-HOUR PRESSURE TEST AT THE SYSTEM STATIC PRESSURE 34. IRRIGATION INSTALLATION CONTRACTOR SHALL PROVIDE THE OWNER WITH A COLOR-CODED ZONE DIAGRAM PLAN, 8-1/2"X11" LAMINATED SHEET(S) WITH AN ELECTRONIC FILE COPY TO IDENTIFY CONTROLLER STATION TO THE CONTROL VALVE NUMBER FOR EACH CONTROLLER. THE LAMINATED CHART IS TO BE LOCATED IN AN

ADHESIVE POUCH ATTACHED TO THE INSIDE OF CONTROLLER(S). 35. THE CONTROLLER(S) SHALL SCHEDULE PROGRAM "A" TO A REGULAR RUN-TIME SETTINGS FOR AFTER THE ESTABLISHMENT PERIOD OF THE PLANT MATERIAL. PROGRAM "B" SHALL BE USED DURING THE ESTABLISHMENT


PERIOD AND TURNED OFF AFTER THE 30-60 DAYS OF PLANT INSTALLATION. 36. THE IRRIGATION CONTRACTOR WILL READ ALL SPECIFICATIONS AND REVIEW ALL DETAILS AND EXAMINE THESE PLANS CAREFULLY PRIOR TO BIDDING THIS PROJECT. FAILURE TO READ THIS INFO

ACCEPTABLE REASON IF THE JOB IS UNDERBID. 37. THE PLAN MAY NOT INCLUDE ALL MATERIALS. THIS DOESN'T RELIEVE THE CONTRACTOR FROM BEING RESPONSIBLE TO PROVIDE A COMPLETE SYSTEM IN PERFECT WORKING ORDER.




INK. DESKIN AN IRRIGATION DESIGN COMPANY

3215 ELLEN DR. ORLANDO, FLORIDA 32806 PHONE (407) 859-5790 www.irrdesign.com Jason McElroy irrdesign@gmail.com

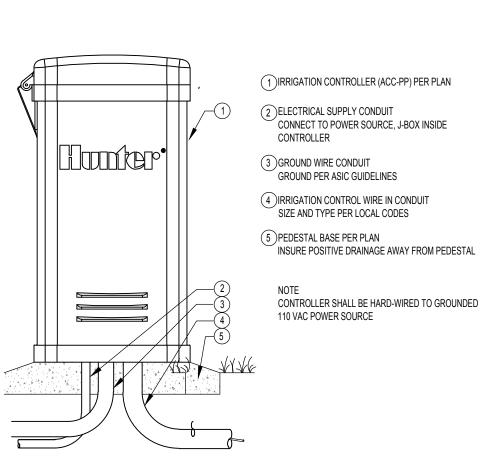

ACC - PLASTIC PEDESTAL

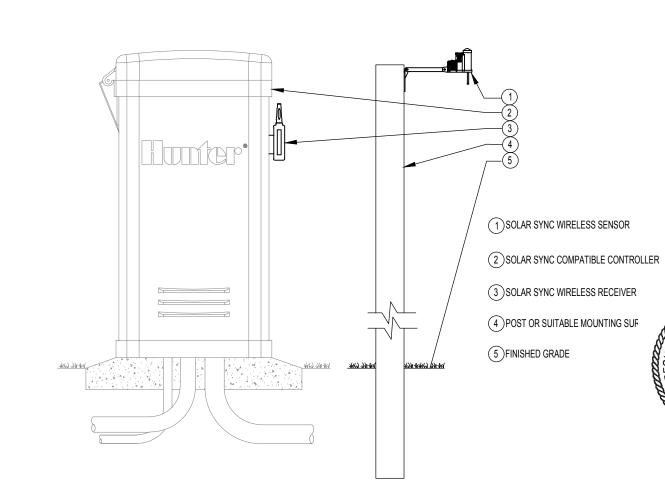

SOLAR SYNC WIRELESS WITH PEDESTAL CONTROLLER



BONNETT design group, llc landscape architecture community planning FL LC 26000341

00 South Orlando Ave. Suite 20 Maitland, FL 32751

407.622.1588 voice

December 10, 2022 DRAWN BY CHECKED BY JOB NUMBER: 2021.182

2021.182_DRH-VENEZIA THS_IRBAS

FILE NAME:

Irrigation 12-10-202

Digitally signe by Todd W Bonnett Date: 2022.01.19

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STATE

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1. DO NOT INSTALL ANY OTHER WIRE OR CABLE WITHIN THE SPHERE OF

2. INSTALL GROUNDING PLATE MINIMUM 30" BELOW FINISHED GRADE, OR

3. MEGGAR TEST GROUNDING GRID, MINIMUM 10 OHMS OR LESS REQUIRED.

CONTRACTOR TO PROVIDE ON HIS LETTER HEAD, TIME, DATE, AND TEST RESULT. SUBMIT A COPY TO OWNER OR OWNERS REP. PRIOR TO FINAL

BELOW FROSTLINE, WHICHEVER IS DEEPER.

CONTROLLER GROUNDING DETAIL

(1) FINISH GRADE

(3) CONCRETE PAD

(2) CONTROLLER OR CONTROLLER MOUNTED IN PUMP STATION

(4) 1.5" SCH-40 PVC SWEEP ELL FOR WIRE

(5) RUN 6 AWG SOLID COPPER WIRES

CONTINUOUSLY FROM GROUND ROD/PLATE TO CONTROLLER BUS BAR.

(6) COPPER GROUND PLATE (4"x96"x.0625")

MATERIAL (POWER SET BY PAIGE

EQUIPMENT OUTSIDE SPHERE OF

(8) 5/8"X8' COPPER CLAD GROUND ROD WITH

15-FEET OF #6 AWG INSULATED GREEN

WIRE PRE-WELDED TO GROUND ROD

PAIGE ELECTRIC 182000IC6).

ELECTRIC 1821991C).

WITH 25-FEET OF #6 AWG INSULATED GREEN WIRE WITH YELLOW STRIPE

PRE-WELDED TO GROUND PLATE, (PAIGE


ELECTRIC 18299IC). PROVIDE MINIMUM OF (2) 50LB BAGS OF EARTH CONTACT

SPHERE OF INFLUENCE KEEP ELECTRIC

1. DISTANCE BETWEEN LATERAL ROWS AND EMITTER SPACING TO BE BASED ON SOIL TYPE, PLANT MATERIALS AND CHANGES IN ELEVATION.

2. LENGTH OF LONGEST DRIPLINE LATERAL SHOULD NOT EXCEED THE MAXIMUM SPACING SHOWN IN THE ACCOMPANYING TABLE.


3. WHEN USING 17MM INSERT FITTINGS WITH DESIGN PRESSURE OVER 50PSI, IT IS RECOMMENDED THAT STAINLESS STEEL CLAMPS BE INSTALLED ON EACH FITTING.

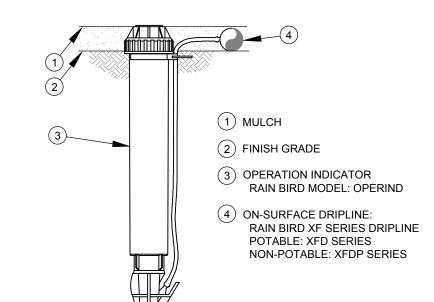

1. INSERT BARB TRANSFER FITTING DIRECTLY INTO DRIPLINE TUBING.
2. VAN NOZZLE MAY BE SET TO CLOSED, OR IF IT IS DESIRED TO SEE SPRAY FROM THE NOZZLE, SET THE ARC TO 1/4 PATTERN.

ON-SURFACE DRIPLINE OPERATIONAL INDICATOR

XFD ON-SURFACE DRIPLINE - CENTER FEED LAYOUT

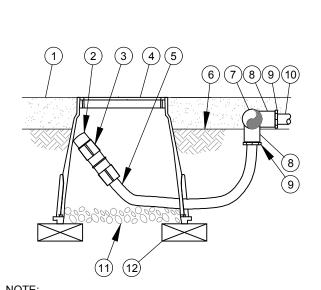

1. ALLOW A MINIMUM OF 6-INCHES OF DRIPLINE TUBING IN VALVE BOX IN ORDER TO DIRECT FLUSHED WATER OUTSIDE VALVE BOX.

10" ROUND

(1) TOP OF MULCH LAYER FLUSH CAP FOR EASY FIT COMPRESSION FITTINGS: POTABLE:RAIN BIRD MDCFCAP NON-POTABLE: RAIN BIRD MDCFPCAP 3 EASY FIT COUPLING: RAIN BIRD MDCFCOUP

1 PVC EXHAUST HEADER

BARB X MALE FITTING:

(4) FLUSH POINT (TYPICAL)

(5) **PERIMETER OF AREA**

(8) PVC SUPPLY MANIFOLD

(10) ON-SURFACE DRIPLINE:

POTABLE: XFD DRIPLINE

BARB X FEMALE FITTING:

FITTINGS. (TYPICAL)

NON-POTABLE: XFDP DRIPLINE

RAIN BIRD XFD-TFA-075 FITTING

(12) 3/4" PVC NIPPLE, LENGTH AS NECESSARY

2) PVC SCH 40 TEE OR EL (TYPICAL)

RAIN BIRD XFF-MA FITTING (TYPICAL)

FROM PERIMETER OF AREA

(7) PVC SUPPLY PIPE FROM RAIN BIRD CONTROL

(9) CONNECTION FROM SUPPLY MANIFOLD TO

DRIPLINE (TYPICAL)- SEE INSET A

RAIN BIRD XF SERIES DRIPLINE(TYPICAL)

RAINBIRD TDS-050 TIE DOWN STAKE, STAGGER 3' APART ALONG DRIP LINE AND AT AND AT

SEE RAIN BIRD DETAIL "XFD FLUSH POINT"

PERIMETER DRIPLINE PIPE TO BE INSTALLED 2"-4"

ZONE KIT (SIZED TO MEET LATERAL FLOW

SUBTERRANEAN EMITTER BOX: SUBTERMAINLAIN L......
RAIN BIRD SEB 7XB

5 RAIN BIRD XF BLANK TUBING 6 FINISH GRADE

7 PVC EXHAUST HEADER (8) PVC SCH 40 TEE OR EL


BARB X MALE FITTING: RAIN BIRD XFF-MA FITTING (TYPICAL)

ON-SURFACE DRIPLINE: RAIN BIRD XF SERIES DRIPLINE POTABLE: XFD DRIPLINE NON-POTABLE: XFDP DRIPLINE

3-INCH MINIMUM DEPTH OF 3/4" WASHED GRAVEL

(12) BRICK (1 OF 2)

XFD ON-SURFACE DRIPLINE FLUSH POINT

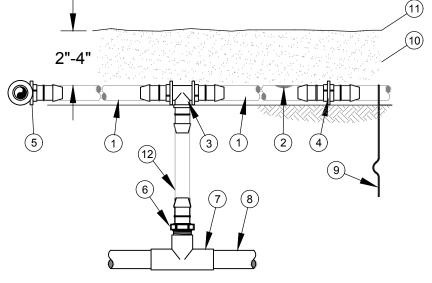

1. PLACE TIE DOWN STAKES EVERY THREE FEET IN SAND, FOUR FEET IN LOAM, AND FIVE FEET IN CLAY. 2. AT FITTINGS WHERE THERE IS A CHANGE OF DIRECTION SUCH AS TEES OR ELBOWS, USE TIE-DOWN STAKES ON EACH LEG OF THE CHANGE OF DIRECTION.

(1) ON-SURFACE DRIPLINE: RAIN BIRD XF SERIES DRIPLINE POTABLE: XFD DRIPLINE NON-POTABLE: XFDP DRIPLINE

INLINE DRIP EMITTER OUTLET, SEE PLANS FOR DRIPLINE OUTLET SPACING.


17mm X 3/4" MPT

(9) TIE DOWN STAKE: RAIN BIRD TDS-050 WITH BEND (TYP)

(11) FINISH GRADE

RAIN BIRD XF SERIES BLANK TUBING LENGTH AS REQUIRED

XFD ON-SURFACE DRIPLINE RISER ASSEMBLY

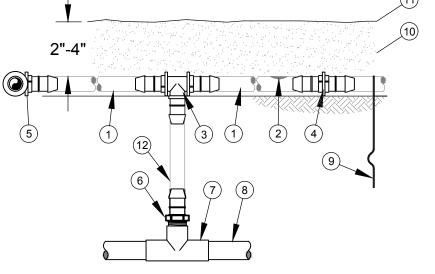


(3) BARB TEE 17x17x17mm RAIN BIRD XFF-TEE BARB COUPLING 17x17mm RAIN BIRD XFF-COUP BARB ELBOW 17x17mm RAIN BIRD XFF-ELBOW BARB MALE ADAPTER 17mm X 1/2" MPT RAIN BIRD XFF-MA-050

> 7 PVC TEE SxSxT (8) PVC LATERAL SUPPLY HEADER

(10) MULCH

2. DELETE DAILY IRRIGATION WHEN PLANTING IN WINTER.

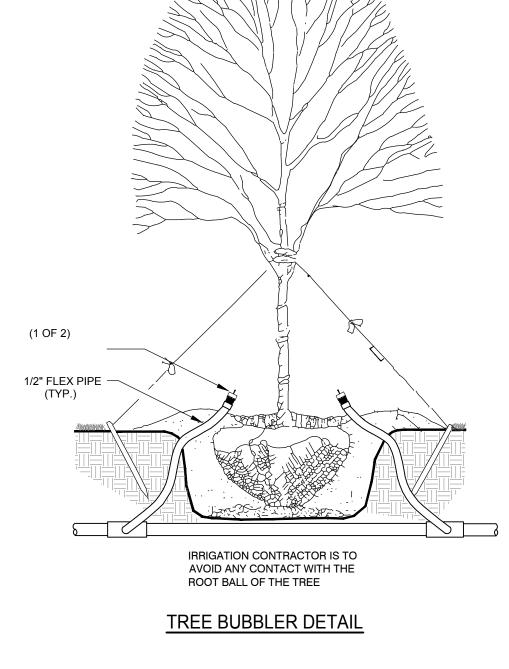

TREE IRRIGATION AFTER PLANTING **DURING ESTABLISHMENT**

SIZE OF NURSERY STOCK	IRRIGATION SCHEDULE FOR VITALITY
LESS THAN 2" CALIPER	DAILY FOR TWO WEEKS, EVERY OTHER DAY FOR TWO MONTHS, WEEKLY UNTIL ESTABLISHED
2"-4" CALIPER	DAILY FOR ONE MONTH, EVERY OTHER DAY FOR THREE MONTHS, WEEKLY UNTIL ESTABLISHED.
GREATER THAN 4" CALIPER	DAILY FOR SIX WEEKS, EVERY OTHER DAY FOR FIVE MONTHS, WEEKLY UNTIL ESTABLISHED

1. AT EACH IRRIGATION, APPLY TWO TO THREE GALLONS PER INCH TRUNK CALIPER AT THE ROOT BALL SURFACE. APPLY IT IN A MANNER SO ALL WATER SOAKS THE ENTIRE ROOT BALL. DO NOT WATER IF THE ROOT BALL IS WET/SATURATED ON THE IRRIGATION DAY

ESTABLISHMENT TAKES THREE (HARDINESS ZONE 10-11) TO FOUR (HARDINESS ZONE 8-9) MONTHS PER INCH TRUNK CALIPER. NEVER APPLY IRRIGATION IF THE SOIL IS SATURATED.


INNER PIPE



INC. DESIGN AN IRRIGATION DESIGN COMPANY


3215 ELLEN DR. ORLANDO, FLORIDA 32806 PHONE (407) 859-5790 www.irrdesign.com Jason McElroy

irrdesign@gmail.com

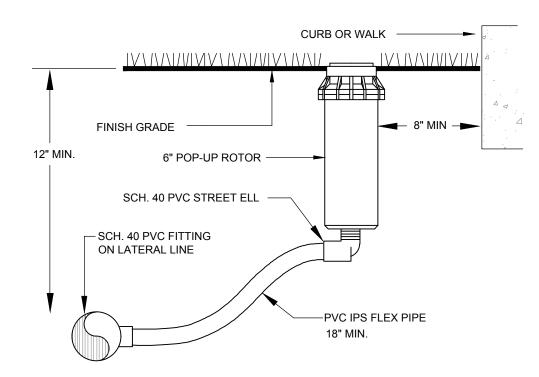


TURF ROTOR HEAD



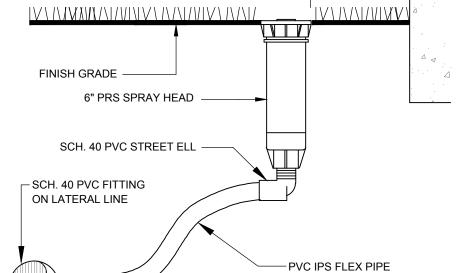

12" MIN.

6" POP-UP SPRAY HEAD DETAIL

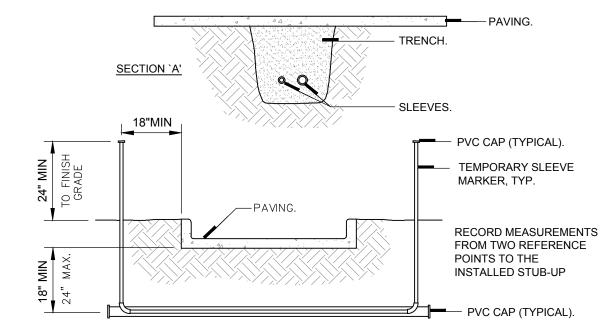

NOTES

1. IRRIGATION SLEEVES SHALL BE CLASS 200 PIPE FOR 4" AND LARGER AND SCHEDULE

40 PVC FOR 3" AND SMALLER. 2. ALL JOINTS TO BE SOLVENT WELDED AND WATERTIGHT 3. WHERE THERE IS MORE THAN ONE SLEEVE, EXTEND THE SMALLER SLEEVE TO 24-INCHES MINIMUM ABOVE FINISH GRADE AND MARK ALL SLEEVE LOCATIONS.

REMOVE EXTENSION WHEN SLEEVE IS UTILIZED. 4. MECHANICALLY TAMP TO 95% PROCTOR. 5. SLEEVE SHALL BE TWO (2) TIMES DIAMETER OF NOMINAL SIZE OF PIPE WITHIN SLEEVE.

IRRIGATION SLEEVE DETAIL

BONNETT design group, lle

landscape architecture

community planning

FL LC 26000341

00 South Orlando Ave. Suite 20

Maitland, FL 32751

407.622.1588 voice

December 10, 2022 DRAWN BY CHECKED BY JOB NUMBER: 2021.182

FILE NAME:

REVISIONS: Irrigation 12-10-202

2021.182_DRH-VENEZIA THS_IRBASE

signed by Todd W Bonnett Date: 2022.01.19

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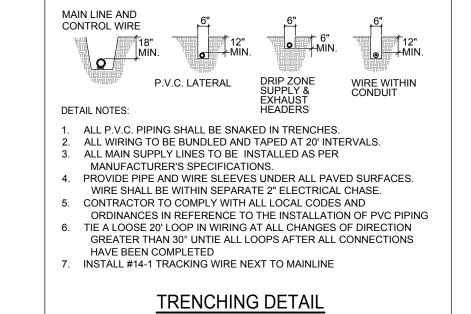
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VALVE PIT FINISH GRADE GATE VALVE 10" PVC SLEEVE SCH. 40 PVC MALE ADAPTER PVC MAIN LINE - 3" GRAVEL SUMP

ISOLATION GATE VALVE





SCH.40 SOLVENT-WELD PVC (REQUIREMENTS VARY - CHECK LOCAL CODES FIRST) ROUGH IN SLEEVING DETAIL

CAP ENDS & STAKE THE STUB-UP

BACK OF -

CURB

TAPE END

OF SLEEVE

RECORD MEASUREMENTS

FROM TWO REFERENCE

POINTS TO THE

INSTALLED STUB-UP

THE DESIGN PROFESSIONAL DOES NOT ACCEPT ANY/ALL RESPONSIBILITY AND/OR LIABILITY FOR PROBLEMS WHICH ARISE FROM FAILURE TO FOLLOW THESE PLANS, SPECIFICATIONS AND DESIGN INTENT THEY CONVEY OR PROBLEMS WHICH ARISE FROM OTHERS' FAILURE TO OBTAIN AND/OR FOLLOW THE DESIGN PROFESSIONALS GUIDANCE WITH RESPECT TO ANY ERRORS, OMISSIONS, INCONSISTENCIES, AMBIGUITIES OR CONFLICTS WHICH ARE ALLEGED.

ICD SENSOR DECODER

ICD-100 DECODER

EARTH GROUND TO BE A MINIMUM OF 8' AWAY FROM

TO THE TWO WIRE PATH

NOTE: All ICD 100 DECODERS SHALL HAVE

THE FOLLOWING ADDRESS AND

ADDRESS 1 = Black

DUAL-S AND AT A RIGHT ANGLE

ID WIRE PATH TWISTED TO

NEXT DECODER

TWO BLACK WIRES TO

ICD-100 DECODER

SOLENOID/UP TO 150FT

JACKETED ID WIRE PATH

FROM CONTROLLER ALLOW 5

EITHER SIDE OF DECODER

DECODERS OR EVERY 500ft.

TO EARTH GROUND

INSTALLED PER ASIC

GUIDELINES. 1 PER 8

ft SLACK PER DECODER 1/2 ON

(2) DBY (2)

TWO-WIRE DECODER CONTROL SYSTEM NOTES

- THE DECODERS MAY BE LABELED AND PROGRAMMED AT THE CONTROLLER PRIOR TO INSTALLATION.
- DO NOT CREATE DUPLICATE STATION ADDRESSES FOR DECODERS. A ICD-SEN SENSOR DECODER SHALL BE USED TO ACCEPT INPUTS FROM SENSORS. EACH ICD-SEN ALSO HAS 2 COLOR-CODED LOOPS CALLED "PORTS".
- HFS FLOW SENSORS CAN ONLY BE CONNECTED TO "PORT A" OF THE ICD-SEN. THE TWO WIRE CABLE SHALL BE A SOLID-CORE, COLOR-CODED, TWISTED-PAIR CABLE.
- GROUND ONE DECODER AT THE END OF THE WIRE PATH AND ONE DECODER GROUNDED EVERY 500' OR 8TH DECODER WHICHEVER IS SHORTER. BOTH THE CONTROLLER AND DECODER ARE TO BE GROUNDED TO GROUND RODS OR PLATES WITH
- LESS THAN 10 OHMS RESISTANCE. ALL TWO-WIRE SYSTEM COMPONENTS ARE TO BE INSTALLED PER THE HUNTER ACC/ACC DECODER
- ALL CONNECTIONS AND SPLICES IN THE TWO-WIRE PATH MUST BE MADE WITH DBRY-6 OR EQUAL WATERPROOF CONNECTORS.
- ALL T-SPLICES MUST BE MADE IN VALVE BOXES WITH DBRY-6 OR EQUAL WATERPROOF CONNECTIONS. 11. INSTALL THE GROUNDING WIRE AND EARTH GROUND HARDWARE AT RIGHT ANGLES TO THE RUN OF THE TWO-WIRE PATH.
- 12. FROM THE DECODER OUTPUTS TO INDIVIDUAL SOLENOIDS, USE STANDARD IRRIGATION WIRE SIZED FOR THE LENGTH OF THE RUN. 13. WIRING FROM THE DECODER TO THE SOLENOID SHOULD NOT EXCEED 150 FT.
- 14. WHEN DOUBLING SOLENOIDS ON A DECODER OUTPUT, WIRE THE SOLENOIDS IN PARALLEL RATHER
- 15. TWO-WIRE DECODER CABLE SHALL BE INSTALLED WITHIN A 1" CONDUIT UTILIZING SWEEPS INSTEAD

NOTE: All ICD-200 DECODERS SHALL HAVE THE EARTH GROUND TO BE A FOLLOWING ADDRESS AND CORRESPONDING COLOR MINIMUM OF 8' AWAY FROM ADDRESS 1 = Black DUAL-S AND AT A RIGHT ANGLE ADDRESS 2 = Yellow TO THE TWO WIRE PATH VALVE

ICD-200 DECODER

(1) DECODER TO SOLENOID MAX RUN 150 ft.

(2) ID WIRE PATH TWISTED TO NEXT DECODER

(3) DBY (4)

(3) COLOR CODED VALVE WIRES. SEE LEGEND FOR COLOR AND

ICD-200 DECODER

JACKETED ID WIRE PATH FROM CONTROLLER ALLOW 5 ft SLACK PER DECODER - 1/2 ON EITHER SIDE OF DECODER

TO EARTH GROUND INSTALLED PER ASIC GUIDELINES. 1 PER 8 DECODERS OR EVERY 500ft.

NOMINAL STUB SIZE.

PLAN NOTES: HUNTER ACC2 DECODER CONTROLLER

DECODERS: The controller shall interface to Hunter ICD decoders capable of controlling 1, 2, 4 or 6 valves per unit (ICD-100, ICD0200, ICD400 and ICD-600). Provide an ICD-SEN sensor decoder for the flow sensors and Clik sensors. Maximum distance from decoder output to solenoid under normal conditions is 150 ft. Integrated surge protection shall eliminate the need for extra surge protection devices.

WIRE: The Hunter ACC2 Decoder Controller requires twisted wire meeting their specification on all paths of the ACC2 Decoder Controller (Hunter IDWIRE, Paige Electric P7354D or equal). IDWIRE1 (14 AWG) is recommended for wire path length up to 10,000 ft and IDWIRE2 (12 AWG) for wire path length up to 15,000 ft. The controller allows up to 3 two-wire paths per output module. The jacket colors shall be such to facilitate the identification of various wire path zones. Looping a two-wire path from one output to another (back to the controller) is not recommended. Provide an additional 36-inch of loose wire (measured from top of valve box), rolled up to the side in all splice boxes and valve boxes. All connections and splices in the red/blue two-wire path must be made with DBRY-6 or equal waterproof connectors and installed in a valve box. IT IS ESSENTIAL THAT ALL CONNECTIONS BE ABSOLUTELY WATERTIGHT WITH NO LEAKAGE TO GROUND NOR SHORTING BETWEEN CONDUCTORS.


GROUNDING: All grounding and installation of equipment specified, shall be installed in strict compliance with the Manufacturer's recommendations and in accordance with Local, State and Federal requirements. Both the controller and the decoders shall be grounded to ground rods or plates with less than 10 Ohms resistance. At a minimum, earth ground should be connected at the first decoder, every 12th valve/decoder, or 1,000 ft of wire run (whichever is shorter) and at the last valve/decoder in any wire run. The solid copper grounding plate shall have a pre-welded #6 AWG insulated green-yellow wire, and Power Set Earth Contact Material. The ground plates are to be installed to a minimum depth of 30". Keep electronic equipment, underground wires, and cables outside of the sphere of influence. Ground plates shall be made of a copper alloy intended for grounding applications and have minimum dimensions as follows:

a. For grounding controllers - 4" x 8' x 0.0625" solid copper grounding plate, a 25-foot continuous length of 6 AWG, green insulated, with extruded yellow stripe, solid bare copper wire welded to the plate (Paige Electric 182199IC) and two 50lb bags of Power Set Earth Contact Material.

b. For grounding decoders - 4" x 3' x 0.0625" solid copper grounding plate, a 15-foot continuous length of 10 AWG, green insulated, with extruded yellow stripe, solid bare copper wire is welded to the plate (Paige Electric 182201IC) and one 50lb bag of Power Set Earth Contact Material.

When using ground rods, provide 5/8" diameter x 8' long copper clad steel ground rods with 15' pre-welded #6 AWG insulated green-yellow wire (Paige Electric part # 1820007IC6). The rods are to be driven into the ground in a vertical position or an oblique angle not to exceed 45 degrees at a location 10 feet from the electronic equipment, the ground plate, or the wires and cables connected to said equipment. The grounding rods shall be covered by a valve box. Install all grounding circuit components in straight lines. Reference the Grounding Details and/or Paige Electric Wiring Guide https://www.paigewire.com

LIGHTNING ARRESTOR: Protect the controller from surges coming from the 120 or 240 Vac wires by installing Paige Electric 250090LED lightening arrestor. This arrester incorporates a visible green LED to indicate that the unit is ready to fire in case of a power or lightning surge. Reference Paige Electric Wiring Guide https://www.paigewire.com

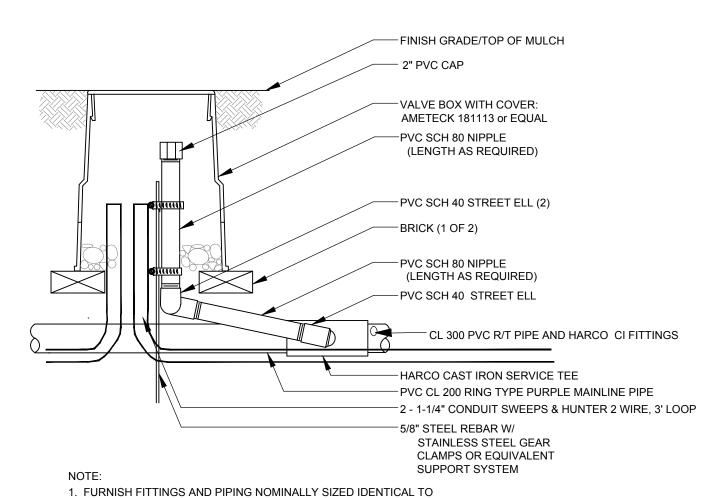

3" STUB FOR FUTURE CONNECTION

WATERING SCHEDULE VALVE SCHEDULE GAL./WEEK <u>PIPE 1 1/4"</u> <u>PIPE 1 1/2"</u> <u>PIPE 2"</u> <u>PIPE 2 1/2"</u> Turf Rotor Rain Bird PESBR 1-1/2" 25.83 254.5 40.29 0.61 in/h Rain Bird PESBR Turf Rotor 0.61 in/h Rain Bird XCZ-150-LCDR 1-1/2" 95.4 26.75 Rain Bird XCZ-150-LCDR Area for Dripline 24.65 1,643 l.f. 15.1 4.79 33.4 1.44 in/h Area for Dripline 1.44 in/h 1.035 Rain Bird PESBR 1-1/2" Bubbler 30.00 60 493.6 84.7 34.0 10.5 3.1 24.96 32.24 2.1 in/h Rain Bird PESBR Bubbler 2.1 in/h 870 1-1/2" Turf Spray 29.14 44 390.5 42.57 0.99 in/h Rain Bird PESBR Turf Spray 0.99 in/h 1,778 Rain Bird PESBR 7.6 3.13 35.23 Rain Bird XCZ-150-LCDR 1-1/2" Area for Dripline 27.83 1,855 l.f. 234.3 47.6 4.7 5.13 26.96 35.5 1.44 in/h Rain Bird XCZ-150-LCDR Area for Dripline 1.44 in/h 1,169 1-1/2" Turf Spray 38.08 386.2 2.45 35.34 43.92 0.96 in/h Rain Bird PESBR Turf Spray 0.96 in/h 2,399 Rain Bird PESBR 91.8 Rain Bird PESBR 121.4 18.7 2.78 24.77 33.54 1-1/2" 34.00 68 321.9 2.1 in/h Rain Bird PESBR 2.1 in/h 986 Bubbler Rain Bird XCZ-150-LCDR 1-1/2" 22.86 1,524 l.f. 26.77 36.17 960.1 539.4 45.6 4.26 1.44 in/h Rain Bird XCZ-150-LCDR Area for Dripline 1.44 in/h Area for Dripline Rain Bird PESBR 1-1/2" Turf Spray 34.24 58 424.0 32.4 7.3 2.76 35.59 45.59 0.92 in/h Rain Bird PESBR Turf Spray 0.92 in/h 2,260 Rain Bird PESBR 1-1/2" 473.1 97.9 3.02 24.53 34.73 31.00 62 10.5 2.08 in/h Rain Bird PESBR 2.08 in/h Bubbler Bubbler 899 152.0 1,189 Rain Bird PESBR 1-1/2" Bubbler 41.00 82 558.7 251.9 2.28 27.91 38.76 340.8 2.12 in/h Bubbler 2.12 in/h Rain Bird PESBR 29 314.3 25.0 0.57 in/h Turf Rotor Rain Bird PESBR 1-1/2" Turf Rotor 31.31 11 4.2 39.12 50.22 Rain Bird PESBR 0.57 in/h 105 3,288

- WATER APPLICATION(S) TO COMPLY WITH ALL APPLICABLE LOCAL, STATE, AND/OR WATER MANAGEMENT DISTRICT RULES & REGULATIONS. WATERING SCHEDULE IS BASED ON A ONE (1) DAY APPLICATION TO PROVIDE A ONE (1) ACRE INCH VOLUME OF WATER PER WEEK.
- DURATION OF WATERING TIMES SHALL BE ADJUSTED FOR MULTIPLE WATERING DAYS, IF ALLOWED. (I.E. ONE-HALF OF THE RECOMMENDED TIME IS
- REQUIRED FOR A TWO (2) DAY PER WEEK SCHEDULE. WATERING SCHEDULE IS PROVIDED FOR PURPOSES OF ASCERTAINING WATER VOLUME REQUIREMENTS FROM AVAILABLE WATER SOURCE ONLY AND
- SHALL NOT CONSTRUCTED AS PRESCRIPTION FOR WATERING APPLICATION FOR SPECIFIC TREES, SHRUBS, GROUND COVERS OR SOD. FINAL WATER APPLICATION AS NEEDED FOR PLANTS, TREES, AND SOD SHALL BE RESPONSIBILITY OF THE OWNER.



IN. DESIGN

AN IRRIGATION DESIGN COMPANY

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December 10, 2022 DRAWN BY

CHECKED BY JOB NUMBER: 2021.182 FILE NAME:

2021.182_DRH-VENEZIA THS_IRBAS REVISIONS:

> Irrigation 12-10-202 Town Comments 1-19-202

Digitally signed by Todd W Bonnett Date:

LA1718

STATE OF

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THE DESIGN PROFESSIONAL DOES NOT ACCEPT ANY/ALL RESPONSIBILITY AND/OR LIABILITY FOR PROBLEMS WHICH ARISE FROM FAILURE TO FOLLOW THESE PLANS. SPECIFICATIONS AND DESIGN INTENT THEY CONVEY OR PROBLEMS WHICH ARISE FROM OTHERS' FAILURE TO OBTAIN AND/OR FOLLOW THE DESIGN PROFESSIONALS GUIDANCE WITH RESPECT TO ANY ERRORS, OMISSIONS, INCONSISTENCIES, AMBIGUITIES OR CONFLICTS WHICH ARE ALLEGED.