


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USE:	RESIDENTIAL NEW CONSTRUCTION
PLAN:	SITE PLAN
DRAWN BY: RC PLANS	RC PLANS
DATE:	11/06/2024
SCALE:	1" = 20'-0"

TROUT DR. HUTCHINS, TX 75141

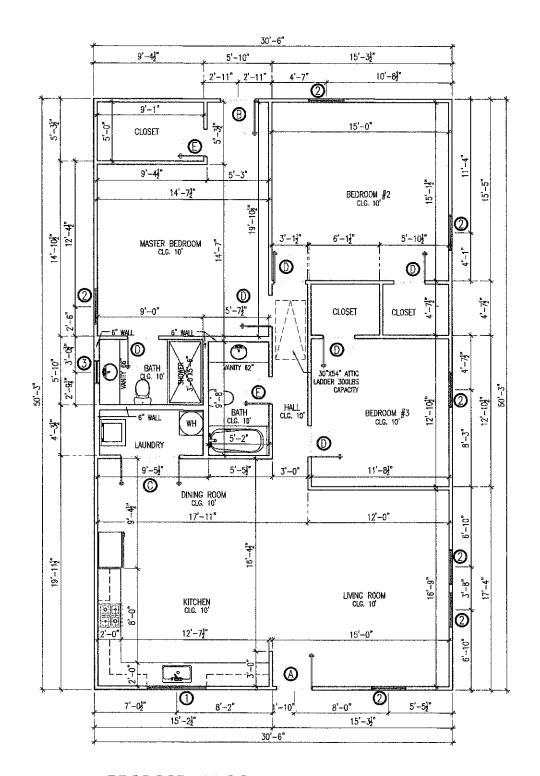

PROPOSED FLOOR PLAN

WIND	OWS SC	HEDULE	
ITEM	SIZE	QUANTITY	TYPE
1	5'-0" X 4'-0"	1	SH
2	3'-0" X 5'-0"	7	SH
3	2'-0" X 3'-0"	1	SH

= SINGLE HUNG

DOC	ORS SCH	EDULE	
ITEM	SIZE	QUANTITY	TYPE
A	3'-0" X 8'-0"	1	SHS
В	3'-0" X 8'-0"	1	SHS/GLS
С	5'-0" X 6'-8"	1	FR
D	2'-8" X 6'-8"	6	SHH
E	2'-4" X 6'-8"	2	SHH

CURRENT CITY CODES:

SINGLE HINGED SOLID CORE SINGLE HINGED HOLLOW CORE

GLASS PANEL FRENCH

2018 International Building Code

 2018 International Residential Code 2018 International Energy Conversational Code

2018 International Fuel Gas Code

2018 International Mechanical Code

2018 International Plumbing Code

2018 International Existing Building Code

2018 International Fire Code

2017 National Electrical Code

AREA	
DESCRIPTION	AREA
PROPOSED LIVING AREA	1,533 SQ.FT.

IECC 2018 GREEN/ENERGY CODE COMPLIANCE FOR HOME

ALL GREEN/ENERGY SYSTEMS MUST MEET THE REQUIREMENTS FROM THE CHAPTER 4 OF THE INTERNATIONAL ENERGY CONSERVATION CODE, REFERED TO RESIDENTIAL ENERGY EFFICIENCY. IF ANY ITEM IS NOT LISTED BELOW REFER TO THE MENTIONED CHAPTER.

1.1.70% OF NON-ROOF AREA HAS VEGETATIVE LANDSCAPE, PERMEABLE PAVING OR SLOPED FOR RUNOFF TO A PERMANENT FILTRATION FEATURE.

2. <u>Water efficiency:</u>
2.1.Lavatory faucets must have an average flow rate of 2.0 gallons per minute or

2.2. SHOWERS HEADS MUST HAVE AN AVERAGE FLOW RATE OF 2.0 GALLONS PER MINUTE OR

2.3. TOILETS MUST HAVE AN AVERAGE FLOW RATE OF:

2.3.1. LESS THAN OR EQUAL TO 1.3 GALLONS PER FLUSH. 2.3.2. DUAL FLUSH COMPLYING WITH ASME A 112.19.14. COMPLY WITH US EPA WATER SENSE.

2.4. ENERGY STAR DISHWASHER.

2.5. ENERGY STAR CLOTHES WASHER

3. HEAT ISLAND MITIGATION:

3.1. ENERGY STAR QUALIFIED ROOF SYSTEM FOR ROOF WITH SLOPE OF 2:12 OR GREATER.

3.2. RADIANT BARRIER IN ATTIC WITH CONVENTIONAL SHINGLES.

3.3. ENCAPSULATED FOAM INSULATION BETWEEN THE ROOF RAFTERS (R-22 OR GREATER).

3.4. WINDOWS AND DOORS MUST BE SEALED WITH FOAM OR CAULK.

3.5. SILL PLATE MUST BE SEALED ON THE INSIDE WITH FOAM OR CAULK. 3.6. ALL WALL PENETRATIONS TO THE EXTERIOR MUST BE SEALED WITH FOAM OR CALLIK

3.7. BLOWER DOOR TESTING IS MANDATORY, NOT TO EXCEED 4 AIR CHANGES PER HOUR AT 50 PASCALS.

4. <u>Ducts and air sealing</u>
4.1. Ducts must be tested and verified to have total leakage of no more than 4 FT/MIN PER 100 SQUARE FOOT (OR 3 CFM IF AIR HANDLER IS NOT INSTALLED), EXCEPT WHERE AIR HANDLER AND ALL DUCTS ARE LOCATED INSIDE CONDITIONED SPACE, AIR HANDLERS AND FILTER BOXES MUST ALSO BE PROPERLY SEALED.

4.2. HVAC AND DUCTWORK LOCATED OUTSIDE OF FIRE RATED ENVELOPE OF GARAGE. 4.3. THE BUILDING ENVELOPE IS REQUIRED TO BE PROPERLY SEALED AND TESTED, AND VERIFIED

AS HAVING AN AIR LEAKEAGE RATE NO HIGHER THAN 3 ACH AT 0.20 INCH W.G. (50 PASCALS).
4.4. SUPPLY AND RETURN DUCTS IN ATTICS SHALL BE SEALD AND INSULATED WITH R-8 WHEN DUCTS IS 3" OR GREATER, R-6 WHEN 3" OR LESS AND EXEMPT WHEN COMPLETELY INSIDE CONDITIONED SPACE

5. INSULATION:

5.1. ALL WINDOWS FENESTRATION U-FACTOR FOR CITY MUST BE 0.35, SKYLIGHT U-FACTOR 0.55 AND GLAZED FENESTRATION SHGC 0.25.

5.2. CEILINGS MUST BE INSULATED WITH R-38, IF NO ATTIC SPACE R-30, THIS REDUCTION IS LIMITED TO 500 SQUARE FEET (46 M2) OR 20% OF THE TOTAL INSULATED CEILING AREA, WHICHEVER IS LESS.

5.3. ATTIC ACCESS LADDERS AND OR HATCHES, MUST BE INSULATED THE SAME AS THE ATTIC AND HAVE A WEATHER SEAL

5.4. ALL EXTERIOR WALLS MUST BE INSULATED WITH R-20 CANITY OR R-13 CANITY WITH R-5 CONTINIOUS INSULATION OR HIGHER 5.5. CRAWL SPACE WALLS MUST BE INSULATED WITH T-5 CONTINIOUS OR R-13 CAVITY

INSULATION, WITH VAPOR BARRIER OVER EXPOSED EARTH.

5.6. PIER AND BEAM OR ANY OTHER RAISED FLOOR SYSTEM MUST BE INSULATED WITH R-19

INSULATION OR HIGHER.

6. <u>HVAC SYSTEMS</u>
6.1. TEMPERATURE CONTROLS MUST BE INSTALLED, INCLUDING A PROGRAMMABLE THERMOSTAT CONTROLLING THE PRIMARY HEATING AOD COOLING SYSTEM.

MECHANICAL SYSTEM PIPING MUST BE INSULATED TO A MINIMUM OF R-3. HOT WATER PIPING * IN DIAMETER OR LARGER AND ALL HOT WATER PIPING IN CERTAIN APPLICATIONS MUST BE

6.2. PIPES CARRYING FLUID OVER 104" OR BELOW 55" MUST BE INSULATED WITH R-13.

6.4. A MINIMUN OF 75% OF LAMPS IN PERMANENTLY INSTALLED FIXTURES MUST BE HIGH-EFFICACY AS DEFINED IN THE IECC.



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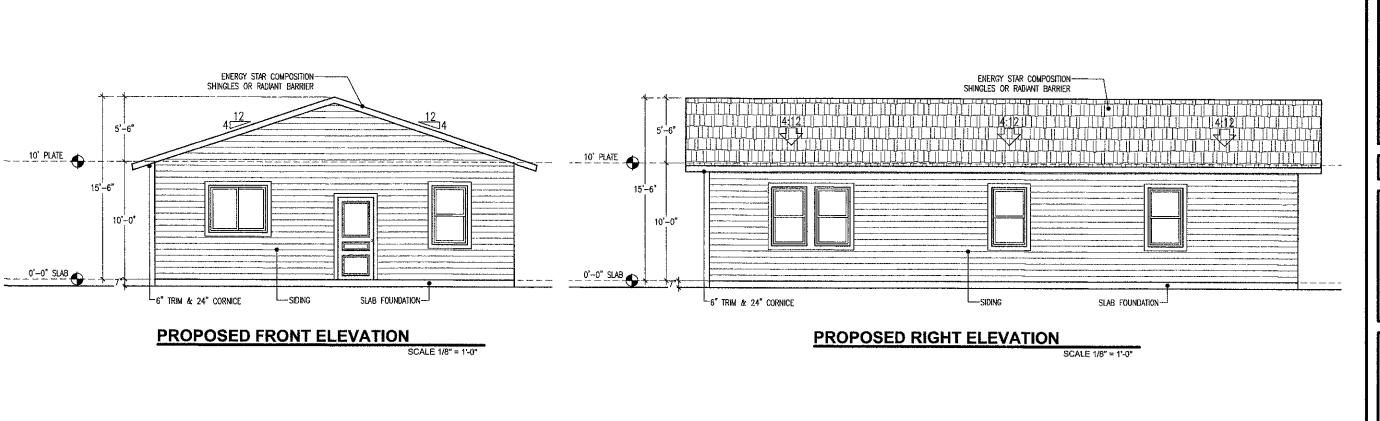
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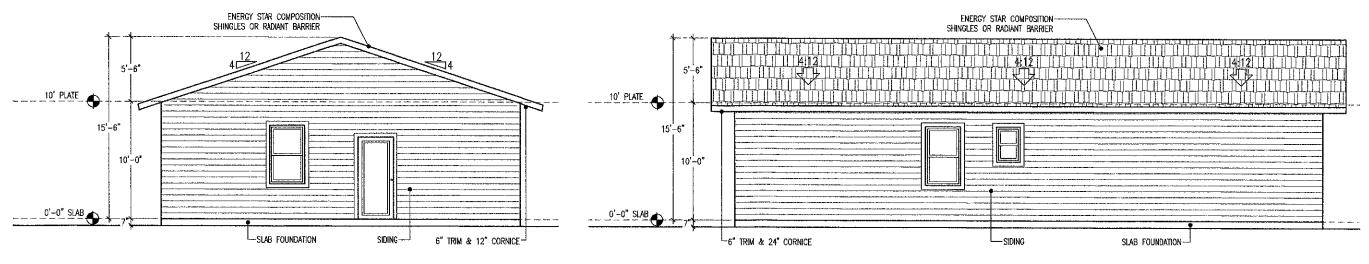
USE:	RESIDENTIAL NEW CONSTRUCTION
PLAN:	FLOOR PLAN
DRAWN BY: RC PLANS	RC PLANS
DATE:	11/06/2024
SCALE:	1/8" = 1'-0"

ADDRESS:

1528 TROUT DR. HUTCHINS. TX 75141

PAGE NUMBER:





PROPOSED REAR ELEVATION

SCALE 1/8" = 1'-0"

PROPOSED LEFT ELEVATION

SCALE 1/8" = 1'-0"



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USE:	RESIDENTIAL NEW CONSTRUCTION
PLAN:	ELEVATIONS PLAN
DRAWN BY:	RC PLANS
DATE:	11/06/2024
SCALE	1/8" = 1'-0"

ADDRESS:

1528 TROUT DR, HUTCHINS, TX 75141

PAGE NUMBER:

02