


7 11 - 11 - 11	APPEARANCE REVIEW
VILLAGE OF HOMEWOOD	2020 Chestnut Road, Homewood, IL 60430
PROPERTY INFORMATION	Zoning District:
Street Address: 3233 183rd Street	□ R-1 □ R-2 □ R-3 □ R-4 pmewood, IL 60430 □ R-1 □ R-2 □ R-3 □ R-4
Property Index Number(s): 32-02-201-039-0000	□ B-1 □ B-2 □ B-3 □ B-4 □ M-1 □ M-2 □ PL-1 □ PL-2
Application Request  Select all applicable boxes for Appearance Commission requests below  □ New Construction, including:  □ Building Elevations  □ Landscape Plan  □ Lighting, Photometric Plan  □ Signage  □ Sign Variance	Automobile Dealership, including Sitework.
APPLICANT	PROPERTY OWNER
Name Marc Smith	Name Steve Phillipos
Company E. Anthony, Inc.	Company Homewood Ford, LLC
Address 18521 Spring Creek Drive, Unit F	Address 3233 183rd Street
Tinley Park, Illinois 60477	Homewood, Illinois 60430
Phone 708-802-8230	Phone 708-798-1668
Email ms@eanthonyinc.com	Email sphillipos@homewoodford.com
Role Sr. Project Manager	☐ Check box if the applicant is the property owner
I acknowledge and attest that:	

- » All the information and exhibits submitted with this application are true and accurate to the best of my knowledge;
- » Village representatives are permitted to make reasonable inspections of the subject property necessary to process this application;
- » I agree to pay all required fees;

and Ordinances.		
Marc Smith	Mail Amith	07/10/2024
Applicant Name	Applicant Signature	Date

» No work may be done without first obtaining a Building Permit. All work shall be completed in accordance with Village Codes

Staff Notes				Do	not write below this line			
CASE NO:		Fee:	🗆 Paid	Date Received: _				
Request:	Action:	Comments/C	onditions:		Date:			
This application	has zoning approvals and t	may proceed to obtain Buil	ding Dormits or	a Cartificate of Occu	Inancy			
This application has zoning approvals and may proceed to obtain Building Permits or a Certificate of Occupancy.								
Name:		Signature:		Date:_				

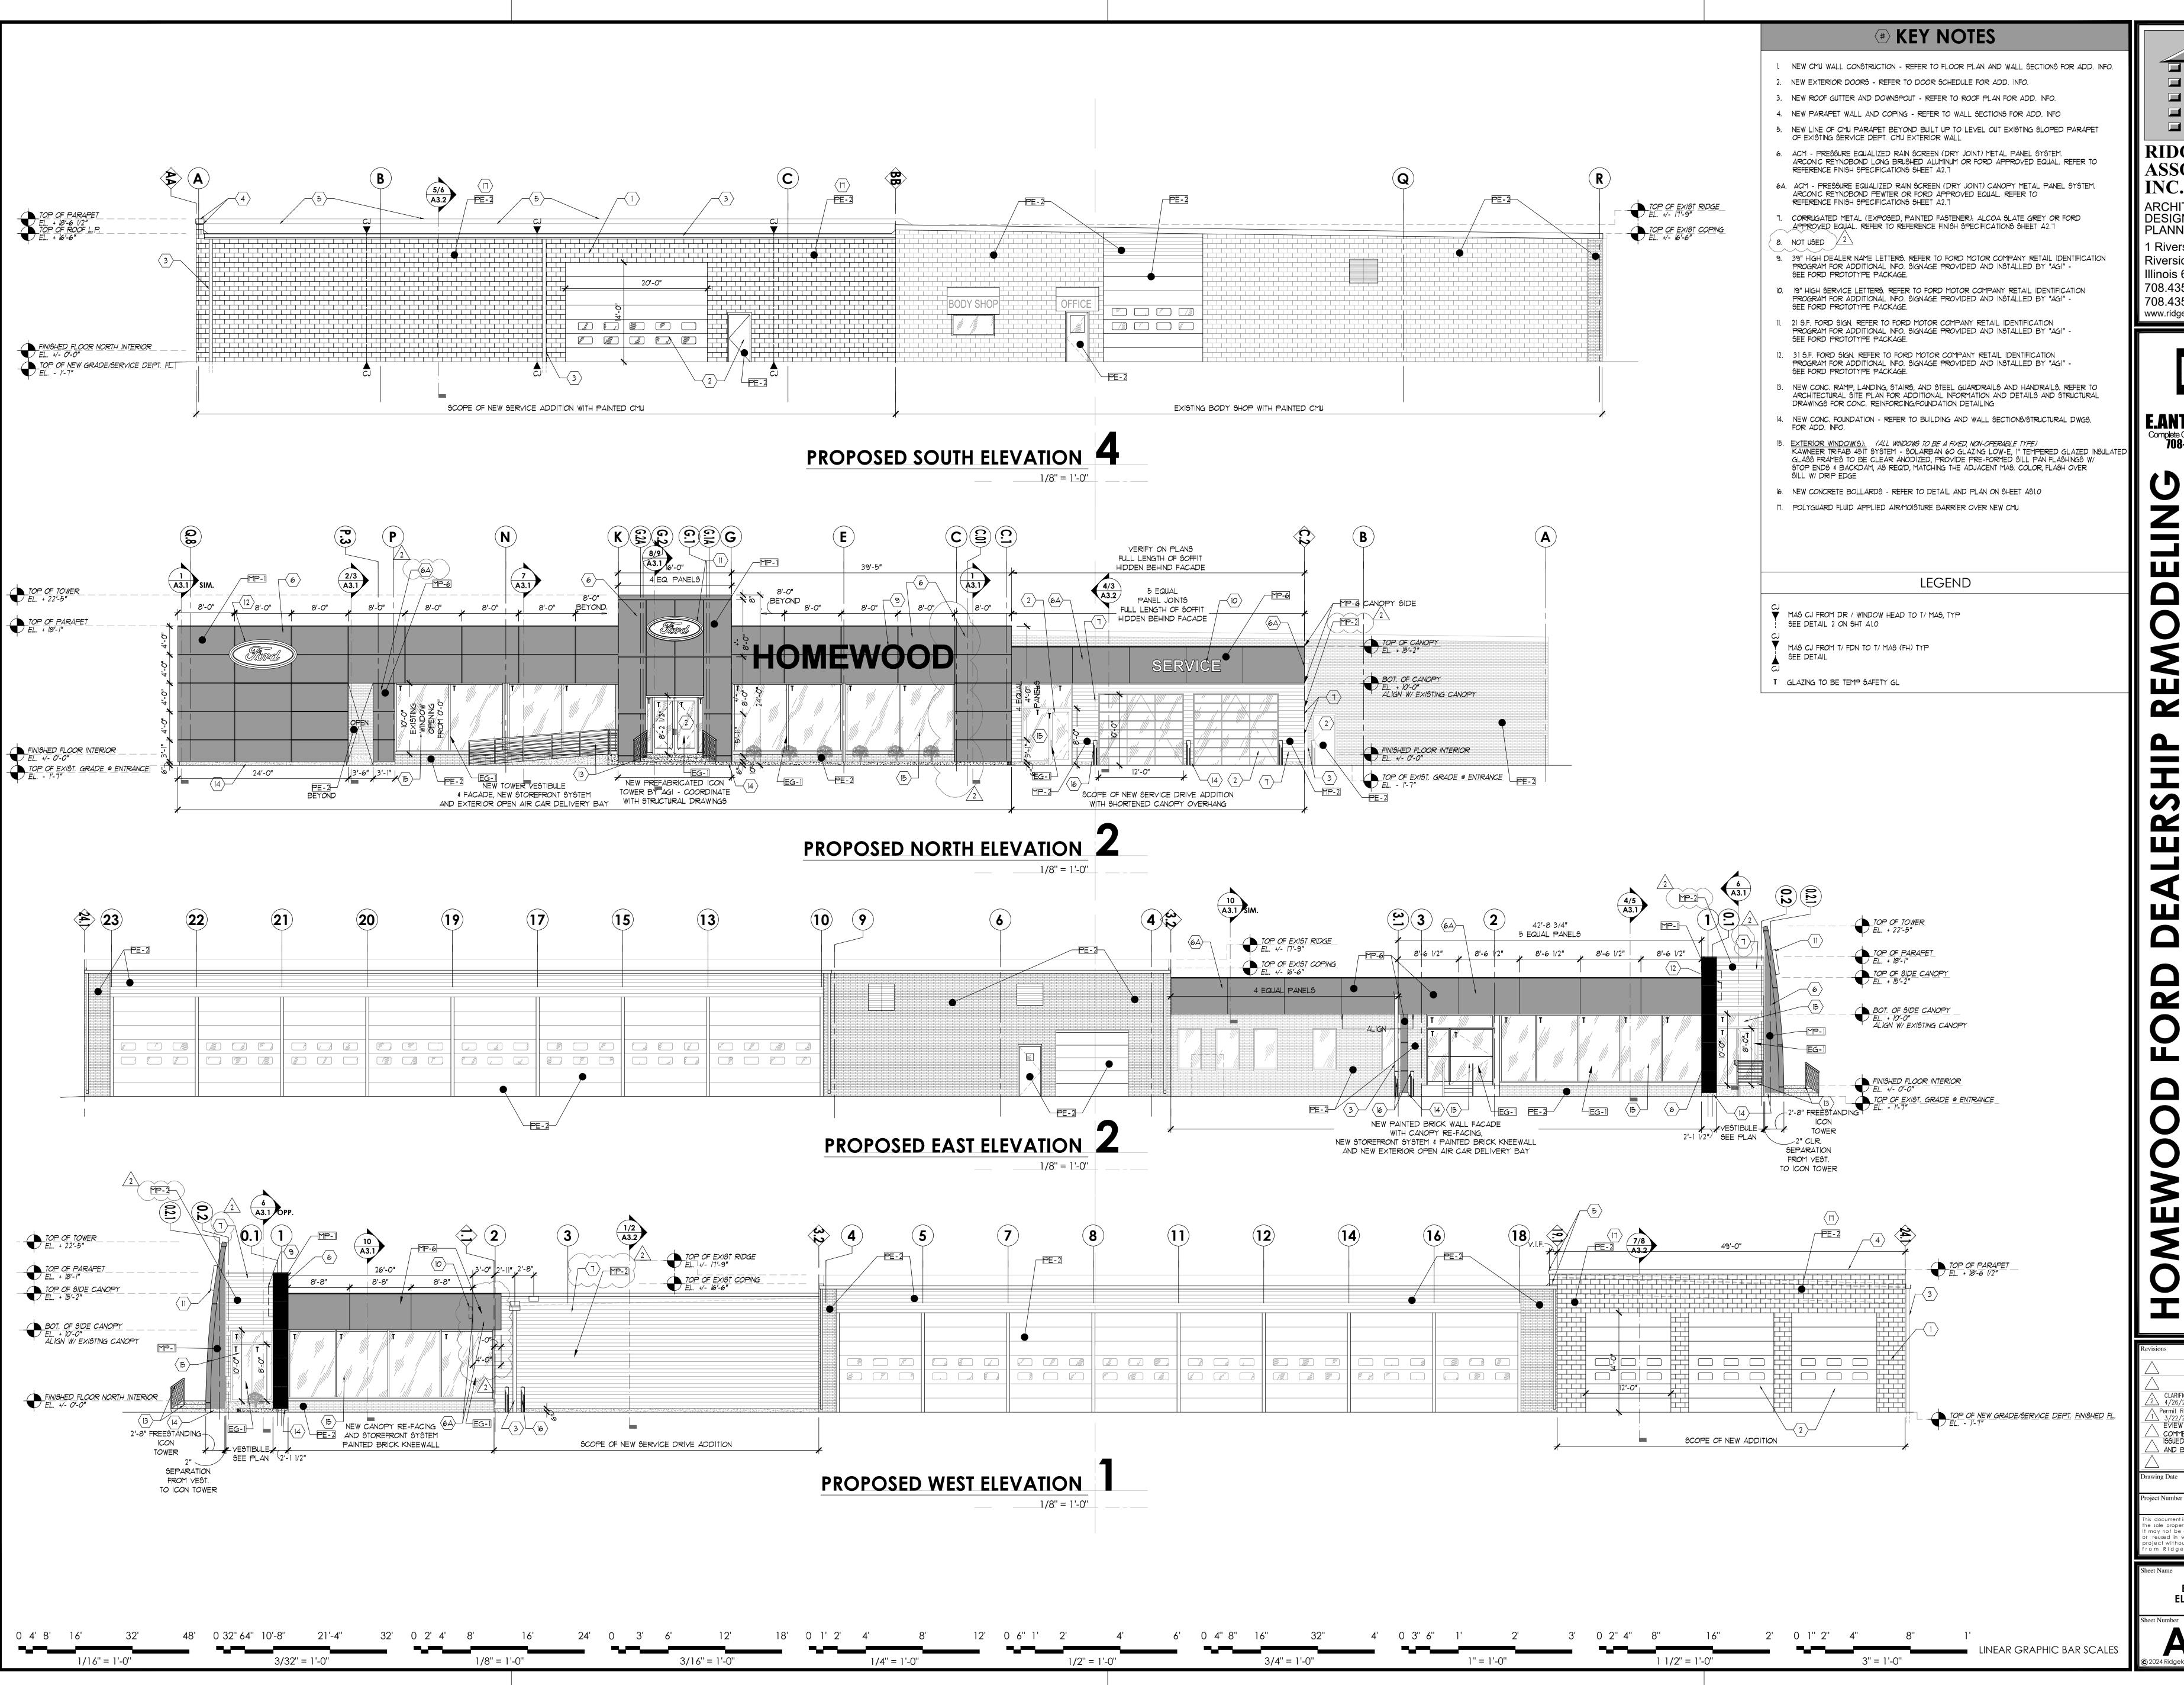

**RIDGELAND ASSOCIATES** 

ARCHITECTS DESIGNERS PLANNERS 1 Riverside Rd. Riverside Illinois 60546 708.435.0300 708.435.0305 fax www.ridgelandassociates.co


DESIGN/BUILD Complete Construction Services 708-802-8230


EVIEW 360 REVIEW COMMENTS - 3/6/24 ISSUED FOR PERMIT AND BID 1/15/24

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> **EXTERIOR ELEVATIONS**





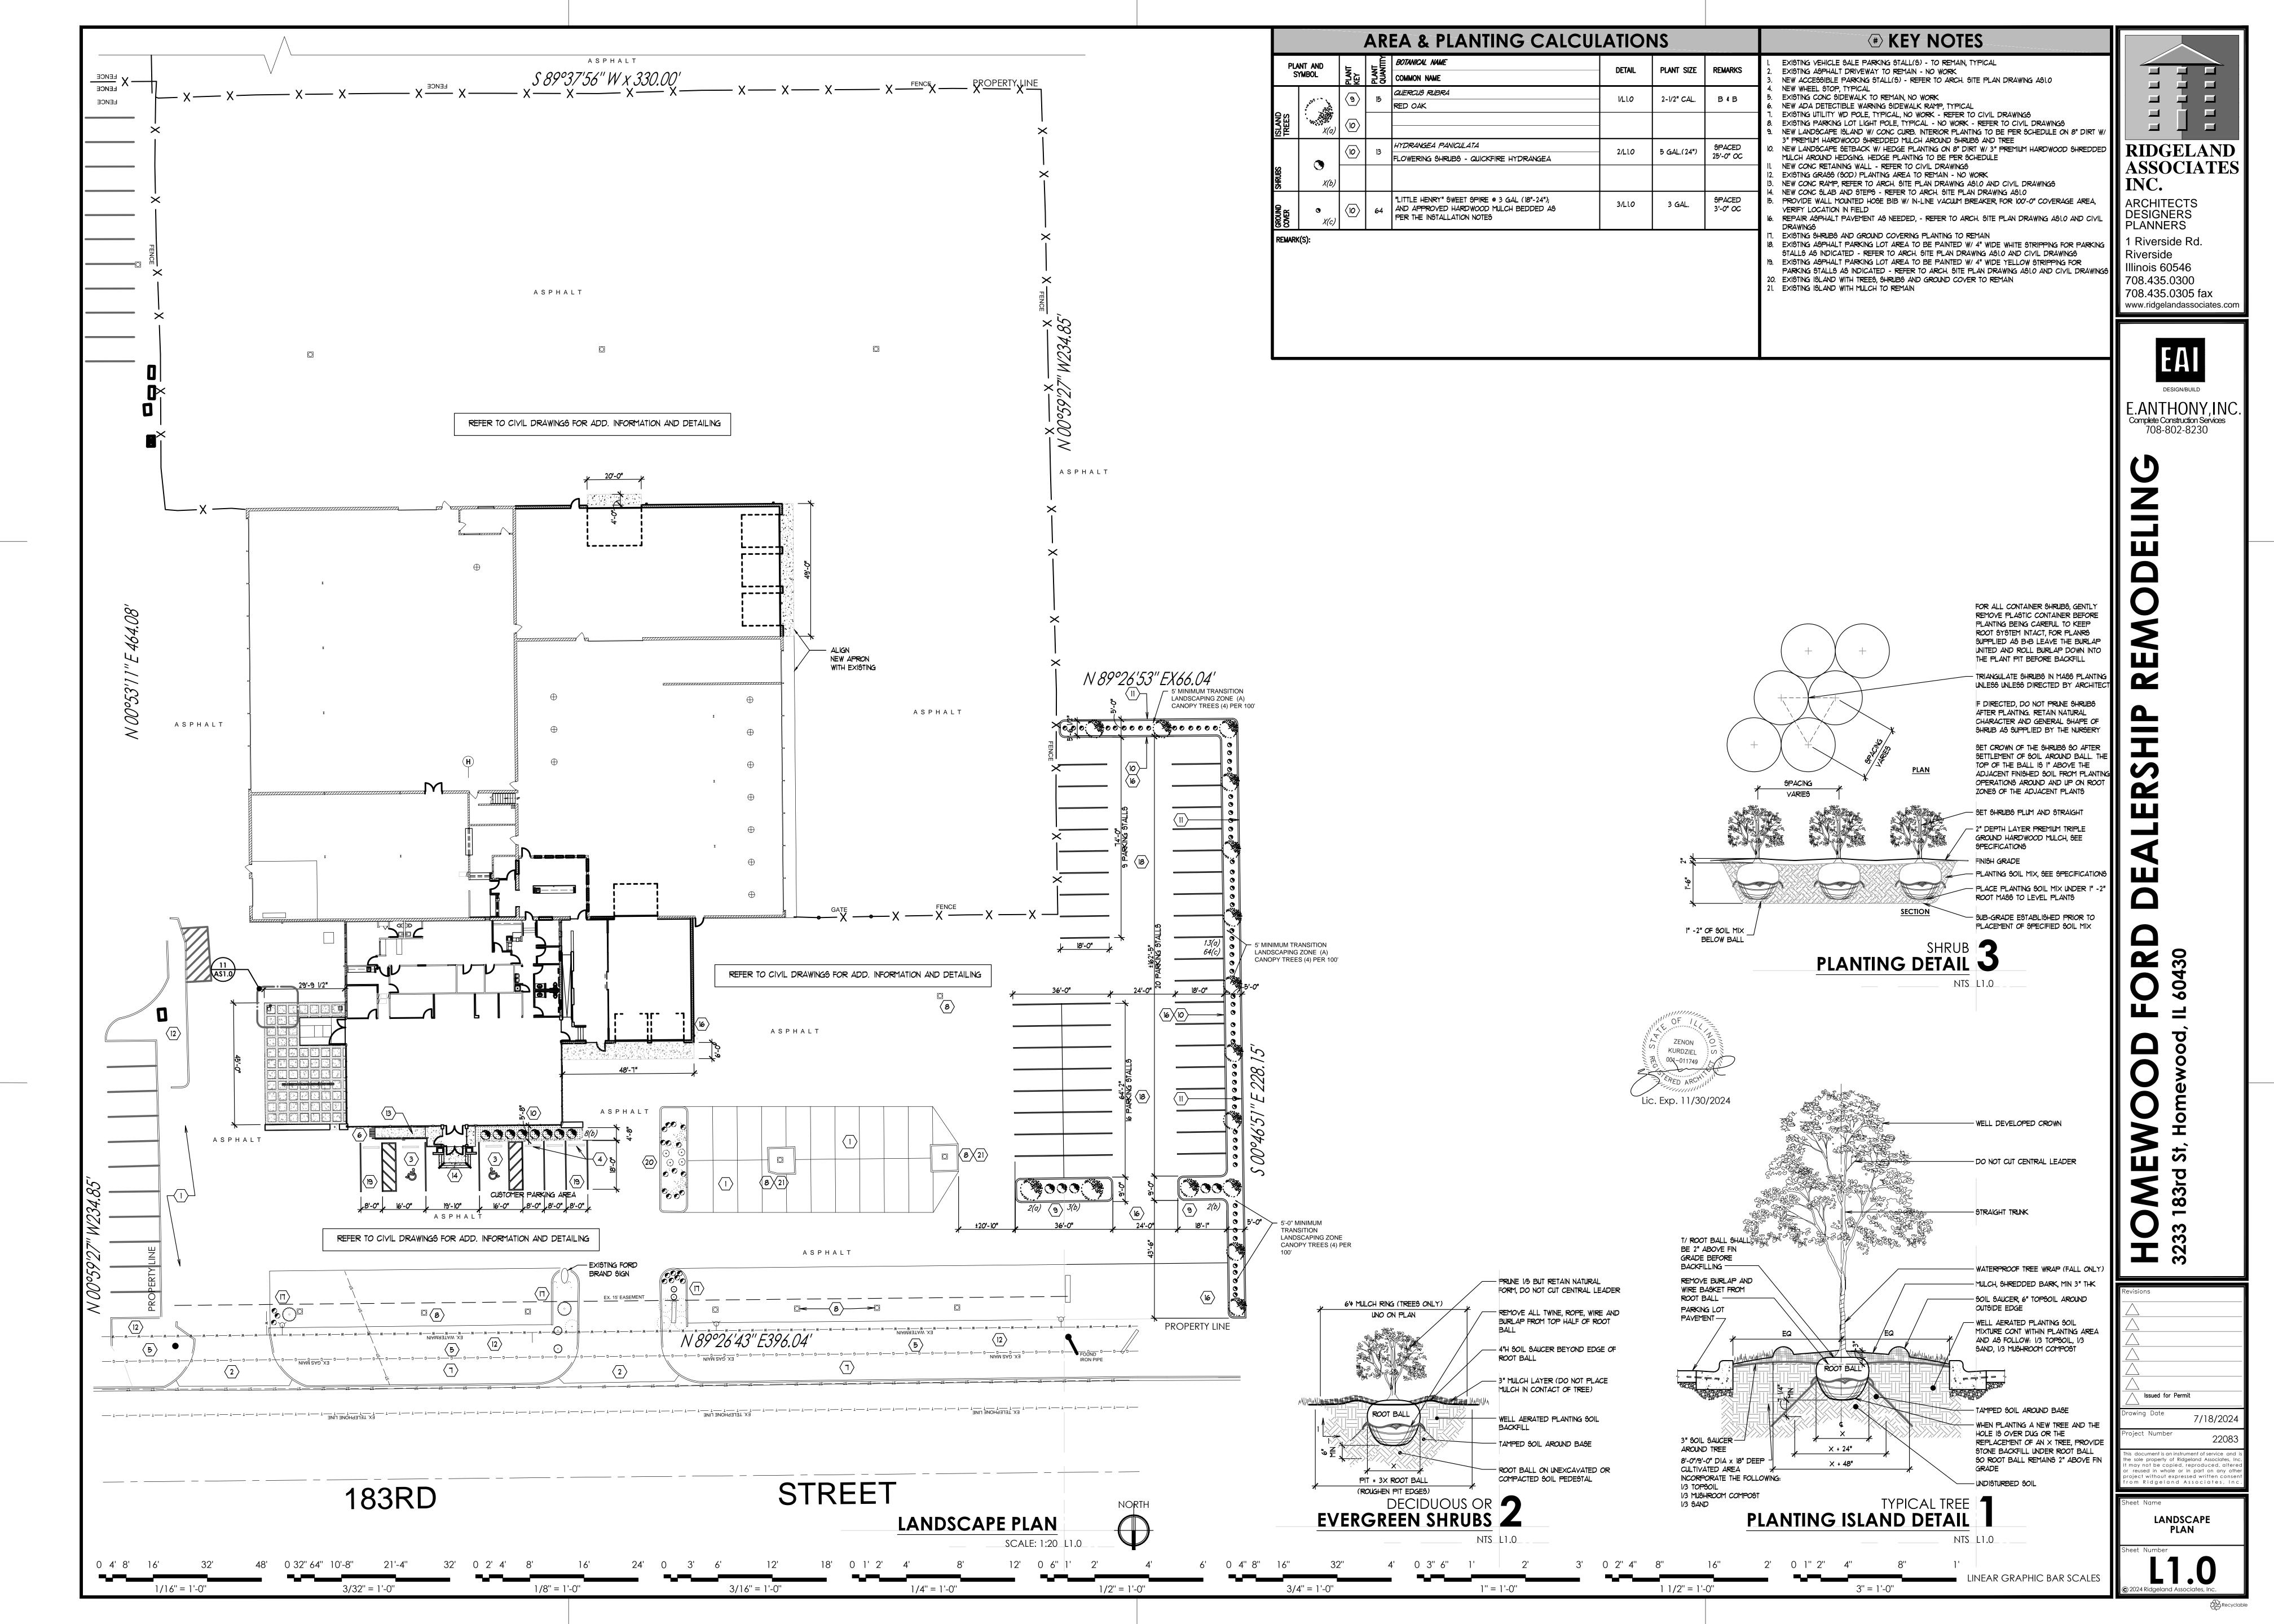
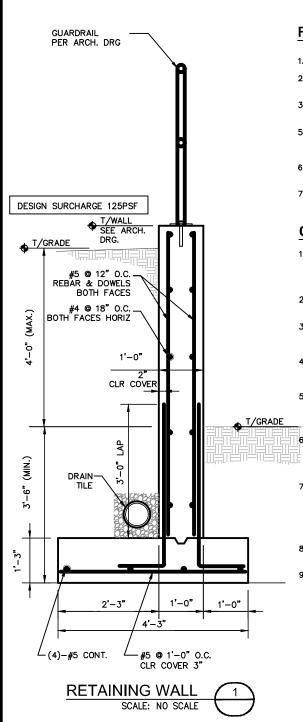
#### **FOUNDATIONS**

- 1. FOUNDATION DESIGN IS BASED ON ALLOWABLE NET BEARING CAPACITY OF 2000 PSF.
- 2. ALL EXCAVATED ELEVATIONS SHALL BE INSPECTED DESIGN BEARING CAPACITY SHALL BE VERIFIED BY A SOILS TESTING LABORATORY PRIOR TO PLACEMENT OF CONCRETE.
- 3. FILL AND ANY UNDERLYING PEAT / SOFT ORGANIC SOIL SHALL BE REMOVED AT ALL FOUNDATION LOCATIONS AND REPLACED WITH GRANULAR BACKFILL OR LEAN CONCRETE.
- 5. ALL COMPACTED STRUCTURAL FILL SHALL BE PLACED IN LAYERS NOT EXCEEDING 10" AND COMPACTED TO A MINIMUM DENSITY EQUAL TO 95% OF MAXIMUM DRY DENSITY AS OBTAINED IN ACCORDANCE WITH ASTM D-1557.
- 6. NO MUD SLABS, FOOTINGS OR SLAB ON GRADE SHALL BE PLACED INTO OR AGAINST SUBGRADES CONTAINING FREE WATER, FROST OR ICE.
- 7. ALL SUBGRADE AND MUD SLABS UNDER SLABS ON GRADE SHALL BE THOROUGHLY CLEANED IMMEDIATELY PRIOR TO CONCRETE PLACEMENT.

#### **CONCRETE AND REINFORCEMENT**

- 1. ALL CONCRETE WORK SHALL CONFORM TO AMERICAN CONCRETE INSTITUTE "BUILDING CODE REQUIREMENTS FOR STRUCTURAL CONCRETE" ACI 318, "SPECIFICATIONS FOR STRUCTURAL CONCRETE FOR BUILDINGS" ACI 301, AND THE ACI CODE OF STANDARD PRACTICE. DELIVERY AND PLACEMENT OF CONCRETE SHALL BE IN ACCORDANCE WITH ACI 304 AND ASTM C94.
- 2. ALL CONCRETE SHALL HAVE A COMPRESSIVE STRENGTH OF 3000 PSI AT 28 DAYS. CONCRETE SHALL HAVE 6% +/- 1% AIR ENTRAINMENT AND MAXIMUM WATER TO CEMENT RATIO OF 0.40.
- 3. CEMENT SHALL CONFORM TO ASTM C150 TYPE I OR II. FLY ASH CONFORMING TO ASTM C618 MAY BE USED TO REPLACE NOT MORE THAN 20 PERCENT OF THE CEMENT IN THE MIXES. AGGREGATES FOR NORMAL WEIGHT CONCRETE SHALL CONFORM TO ASTM C33.
- 4. CONCRETE ADMIXTURE FOR AIR—ENTRAINMENT SHALL CONFORM TO ASTM C260. ALL OTHER CONCRETE ADMIXTURES SHALL CONFORM TO ASTM C494. CALCIUM CHLORIDE OR ADMIXTURES CONTAINING CALCIUM CHLORIDE SHALL NOT BE USED IN THE CONCRETE MIXES.
- 5. COLD WEATHER CONCRETING SHALL BE IN ACCORDANCE WITH ACI 306 WHEN THE ATMOSPHERIC TEMPERATURE IS EXPECTED TO FALL BELOW 40 DEGREES F. HOT WEATHER CONCRETING SHALL BE IN ACCORDANCE WITH ACI 305 WHEN THE ATMOSPHERIC TEMPERATURE IS EXPECTED TO RISE ABOVE 90 DEGREES F.
- 6. FINISHED CONCRETE SHALL BE EVALUATED AND REPAIRED AS NOTED HEREIN AND IN ACCORDANCE WITH STANDARD INDUSTRY PRACTICE. ALL CONCRETE SHALL BE FREE FROM HONEYCOMBS AND OTHER DEFECTS AND SHALL BE PROPERLY CONSOLIDATED IN ACCORDANCE WITH ACI 309 "GUIDE FOR CONSOLIDATION OF CONCRETE".
- 7. CONCRETE FORMWORK AND FORMED CONCRETE SURFACES SHALL CONFORM TO ACI 347 "GUIDE TO FORMWORK FOR CONCRETE". EXTERIOR CONCRETE SURFACES WHICH WILL BE EXPOSED TO VIEW IN THE FINISHED STRUCTURE SHALL BE CLASS A AND SHALL BE RUBBED SMOOTH. ALL OTHER EXPOSED SURFACES SHALL BE CLASS C EXCEPT THAT CONCEALED SURFACES MAY BE CLASS D. USE FORM RELEASE AGENTS WHICH WILL NOT STAIN THE FINISHED CONCRETE SURFACES OR ADVERSELY AFFECT THE APPLICATION OF FINISHES.
- 8. REBAR SHALL CONFORM TO ASTM A615 GRADE 60 AND SHALL NOT BE WELDED. WELDED WRE FABRIC SHALL CONFORM TO ASTM A185.
- 9. COVER FOR REBAR SHALL BE IN ACCORDANCE WITH ACI 318 AND SHALL NOT BE LESS THAN THE FOLLOWING:

CONCRETE CAST AGAINST AND PERMANENTLY IN CONTACT WITH EARTH 3

CONCRETE EXPOSED TO EARTH OR WEATHER: #6 THRU #18 BARS

2



EXP. 11/30/2024



PROJECT:


HOMEWOOD FORD 3233 183rd ST., HOMEWOOD, IL 60430

ARCHITECT:

RIDGELAND ARCHITECTS

DRAWING #: **SK-01** DATE: **JUL 18 2024** 

DRAWN: **DG** REV:

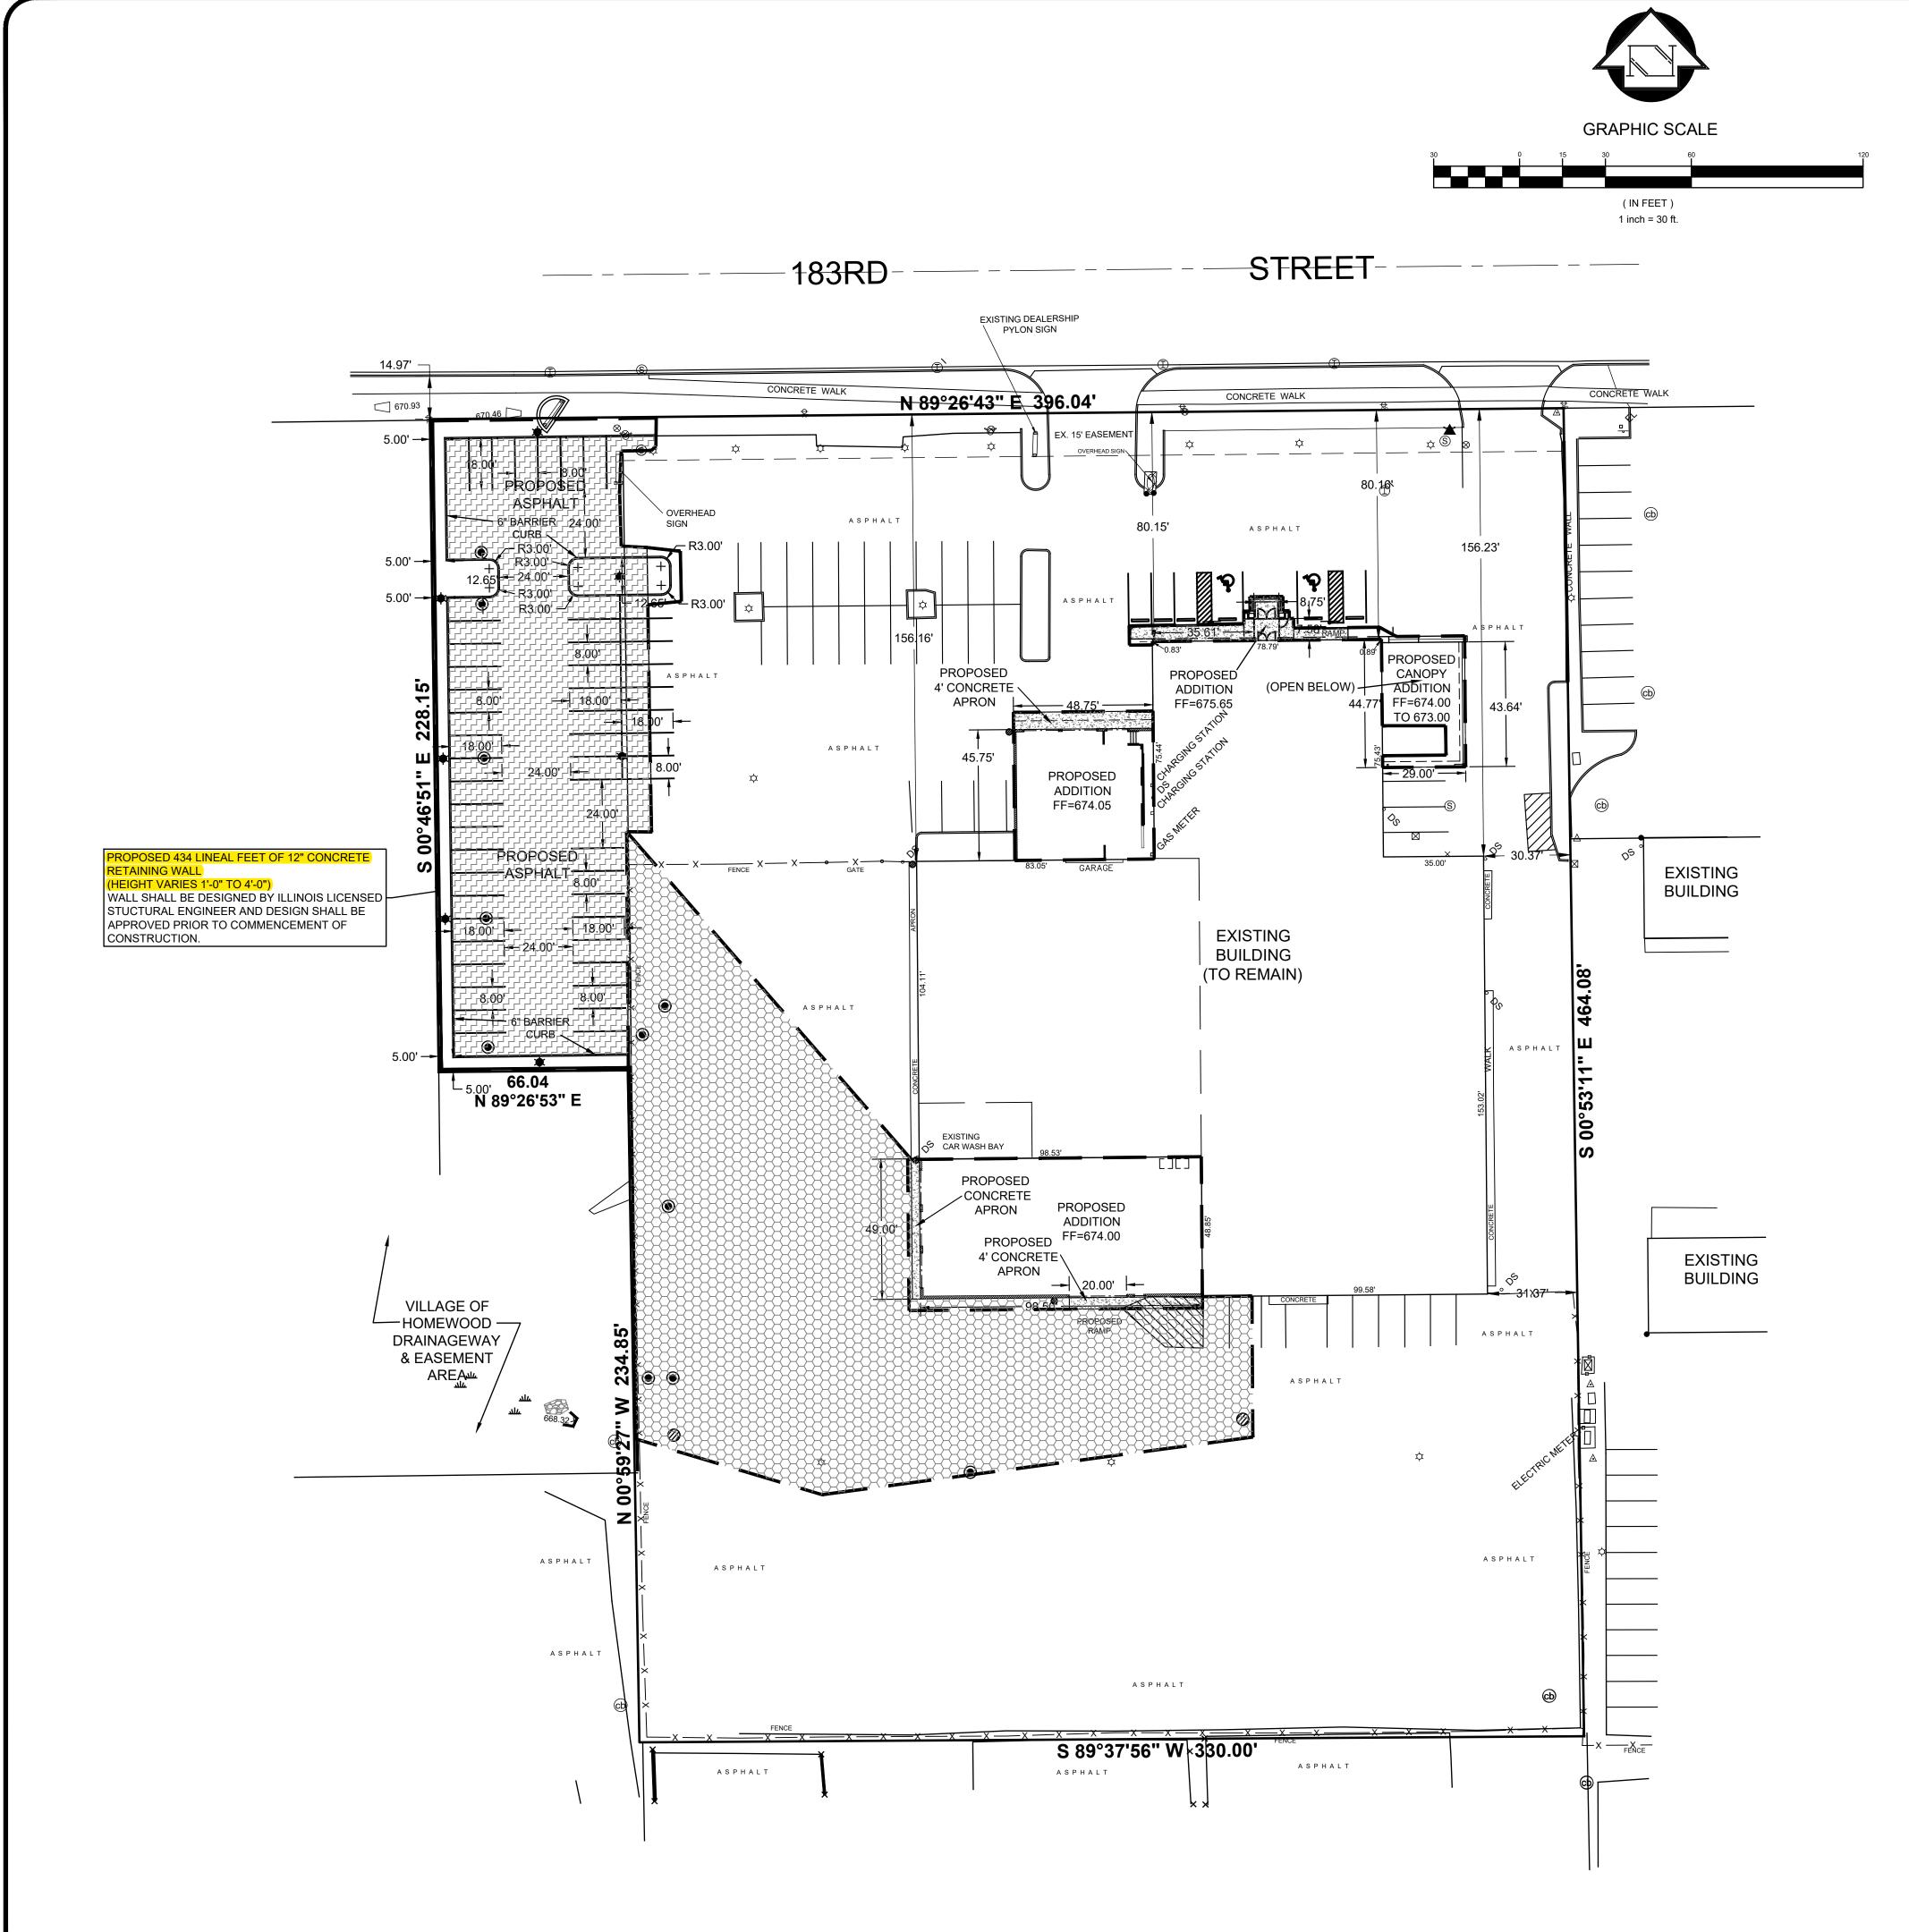

**GENERAL NOTES:** 

1. THE INFORMATION SHOWN HEREIN WAS TAKEN FROM A TOPOGRAPHIC SURVEY PREPARED BY JOSEPH A. SCHUDT AND ASSOCIATES. 9455 ENTERPRISE DRIVE MOKENA, ILLINOIS 60448

708.720.1000 (P) 708.720.1065 (F)

- 2. ALL DESIGN INFORMATION BASED UPON GEOTECHNICAL REPORT PREPARED BY (PENDING)
- 3. ALL HANDICAP SITE FEATURES SHALL BE CONSTRUCTED TO MEET ALL FEDERAL, STATE AND LOCAL CODES.
- 4. ANY DISCREPANCY IN THIS PLAN AND ACTUAL FIELD CONDITIONS SHALL BE REPORTED TO THE OWNER PRIOR TO START OF CONSTRUCTION. GENERAL CONTRACTOR SHALL BE RESPONSIBLE FOR VERIFICATION OF ALL SETBACKS, EASEMENTS, AND DIMENSIONS SHOWN HEREON BEFORE BEGINNING CONSTRUCTION.
- 5. PRIOR TO STARTING CONSTRUCTION, THE GENERAL CONTRACTOR SHALL BE RESPONSIBLE TO VERIFY THAT ALL REQUIRED PERMITS AND APPROVALS HAVE BEEN OBTAINED. NO CONSTRUCTION OR FABRICATION OF ANY ITEM SHALL BEGIN UNTIL THE CONTRACTOR HAS RECEIVED ALL PLANS AND ANY OTHER DOCUMENTATION FROM ALL OF THE PERMITTING AND ANY OTHER REGULATORY AUTHORITIES. FAILURE OF THE CONTRACTOR TO FOLLOW THIS PROCEDURE SHALL CAUSE THE CONTRACTOR TO ASSUME FULL RESPONSIBILITY FOR ANY SUBSEQUENT MODIFICATION OF THE WORK MANDATED BY ANY REGULATORY AUTHORITY. ALL CONSTRUCTION TO BE IN ACCORDANCE WITH PERMITS ISSUED AND APPLICABLE STATE, COUNTY AND LOCAL
- 6. THE GENERAL CONTRACTOR SHALL CONTACT ALL OWNERS OF EASEMENTS, UTILITIES AND RIGHT-OF-WAYS, PUBLIC OR PRIVATE PRIOR TO WORKING IN THESE AREAS.
- 7. CONTRACTOR SHALL MAINTAIN THE SITE IN A MANNER SO THAT WORKMEN AND PUBLIC SHALL BE PROTECTED FROM INJURY AND ADJOINING PROPERTY PROTECTED FROM DAMAGE.
- 8. ACCESS TO UTILITIES, FIRE HYDRANTS, STREET LIGHTING, ETC., SHALL REMAIN UNDISTURBED, UNLESS COORDINATED WITH RESPECTIVE UTILITY
- 9. CONTRACTOR IS RESPONSIBLE FOR DAMAGE TO ANY EXISTING ITEM AND/OR MATERIAL INSIDE OR OUTSIDE CONTRACT LIMITS DUE TO CONSTRUCTION OPERATIONS.
- 10. ALL PARKING LOT DIMENSIONS ARE TO THE FACE OF CURB, UNLESS OTHERWISE NOTED.
- 11. ALL RADII DIMENSIONS ARE TO THE BACK OF CURB, UNLESS OTHERWISE NOTED.
- 12. DO NOT SCALE THIS DRAWING AS IT IS A REPRODUCTION AND SUBJECT TO DISTORTION.
- 13. THE GENERAL CONTRACTOR SHALL REMOVE ALL TRASH AND DEBRIS FROM THE SITE UPON COMPLETION OF THE PROJECT AND AT LEAST ONCE A WEEK DURING CONSTRUCTION.
- 14. THE GENERAL CONTRACTOR SHALL KEEP THE AREA OUTSIDE THE "CONSTRUCTION LIMITS" BROOM CLEAN AT ALL TIMES.
- 15. GENERAL CONTRACTOR WILL ERECT AND ILLUMINATE A SITE IDENTIFICATION SIGN, PER OWNER'S SPECIFICATION. COORDINATE LOCATION WITH OWNER'S REPRESENTATIVE
- 16. FINISH CURB AND WALK ELEVATIONS SHALL BE 6" ABOVE FINISH PAVEMENT GRADE UNLESS NOTED DIFFERENT ON PLAN.
- 17. CONTRACTOR SHALL ENSURE THAT ADEQUATE SITE LIGHTING IS PROVIDED PER OWNER'S SPECIFICATIONS.
- 18. ALL STREET SURFACES, DRIVEWAYS, CULVERTS, CURB AND GUTTERS, ROADSIDE DRAINAGE DITCHES AND OTHER STRUCTURES THAT ARE DISTURBED OR DAMAGED IN ANY MANNER AS A RESULT OF CONSTRUCTION SHALL BE REPLACED OR REPAIRED IN ACCORDANCE WITH THE SPECIFICATIONS.
- 19. ALL DISTURBED AREAS SHALL HAVE TEMPORARY SEEDING AND MULCHING. ALL AREAS THAT ARE PLANNED TO BE BARE FOR MORE THAN 45 DAYS SHALL BE SEEDED AND MULCHED WITHIN SEVEN (7) DAYS.
- 20. ALL LOT STRIPING AND DIRECTIONAL ARROWS TO BE WHITE REFLECTIVE MARKINGS AND SHALL CONFORM TO LOCAL REGULATIONS.
- 21. COMPACTION AND MAINTENANCE OF PROPER MOISTURE CONTENT OF THE SOIL UNDER BUILDINGS AND PAVED AREAS SHALL BE ACCOMPLISHED TO ACHIEVE 95% OF THE STANDARD PROCTOR MAXIMUM DRY DENSITY OR AS RECOMMENDED IN THE SOIL
- 22. BEFORE COMMENCEMENT OF WORK, THE CONTRACTOR SHALL REVIEW ALL PLANS AND SPECIFICATIONS AND THE JOB SITE. THE CONTRACTOR SHALL NOTIFY THE OWNER AND THE ENGINEER WHO PREPARED THE PLANS OF ANY DISCREPANCIES THAT MAY REQUIRE MODIFICATIONS TO THESE PLANS OR OF ANY FIELD CONFLICTS.
- 23. ALL PERMITS RELATIVE TO THE PROJECT MUST BE OBTAINED, PRIOR TO CONSTRUCTION.
- 24. THE CONTRACTOR SHALL REFER TO THE ARCHITECTURAL DRAWINGS FOR ALL BUILDING DIMENSIONS.
- 25. CONTRACTOR SHALL COORDINATE EXACT SIZE OF HVAC CONCRETE PADS WITH MECHANICAL CONTRACTOR. REFER TO MECHANICAL PLANS FOR DETAILS.
- 26. ALL SEEDING, TEMPORARY AND PERMANENT, TO BE INSTALLED TO LOCAL REGULATIONS AND STANDARD PRACTICES.
- 27. ALL ROAD WORK SHALL BE PERFORMED IN ACCORDANCE WITH "THE CURRENT EDITION OF THE STATE DEPARTMENT OF TRANSPORTATION CONSTRUCTION AND MATERIALS SPECIFICATIONS".
- 28. ANY AND ALL QUANTITIES SHOWN OR IMPLIED ON THESE PLANS ARE FOR ESTIMATION PURPOSES ONLY.
- 29. CONTRACTOR AGREES THAT IN ACCORDANCE WITH GENERALLY ACCEPTED CONSTRUCTION PRACTICES, CONTRACTOR WILL BE REQUIRED TO ASSUME SOLE AND COMPLETE RESPONSIBILITY FOR JOB SITE CONDITIONS DURING THE COURSE OF CONSTRUCTION OF THE PROJECT, INCLUDING SAFETY OF ALL PERSONS AND PROPERTY. THIS REQUIREMENT SHALL BE MADE TO APPLY CONTINUOUSLY AND NOT BE LIMITED TO NORMAL WORKING HOURS. CONTRACTOR FURTHER AGREES TO DEFEND, INDEMNIFY, AND HOLD THE OWNER AND DESIGN PROFESSIONAL HARMLESS OF ANY AND ALL LIABILITY, REAL OR ALLEGED IN CONNECTION WITH THE PERFORMANCE OF WORK ON THIS PROJECT, ACCEPTING LIABILITY ARISING FROM THE SOLE NEGLIGENCE OF THE OWNER OR DESIGN PROFESSIONAL.

SITE DEVELOPMENT AREA ( MILL AND RESURFACE AREAS NOT CONSIDERED DEVELOPMENT) 48,003 Sq. Ft. (1.102 ACRES)

### PAVEMENT LEGEND

STANDARD DUTY ASPHALT

CONCRETE

HEAVY DUTY ASPHALT PAVING

OF Project No.:


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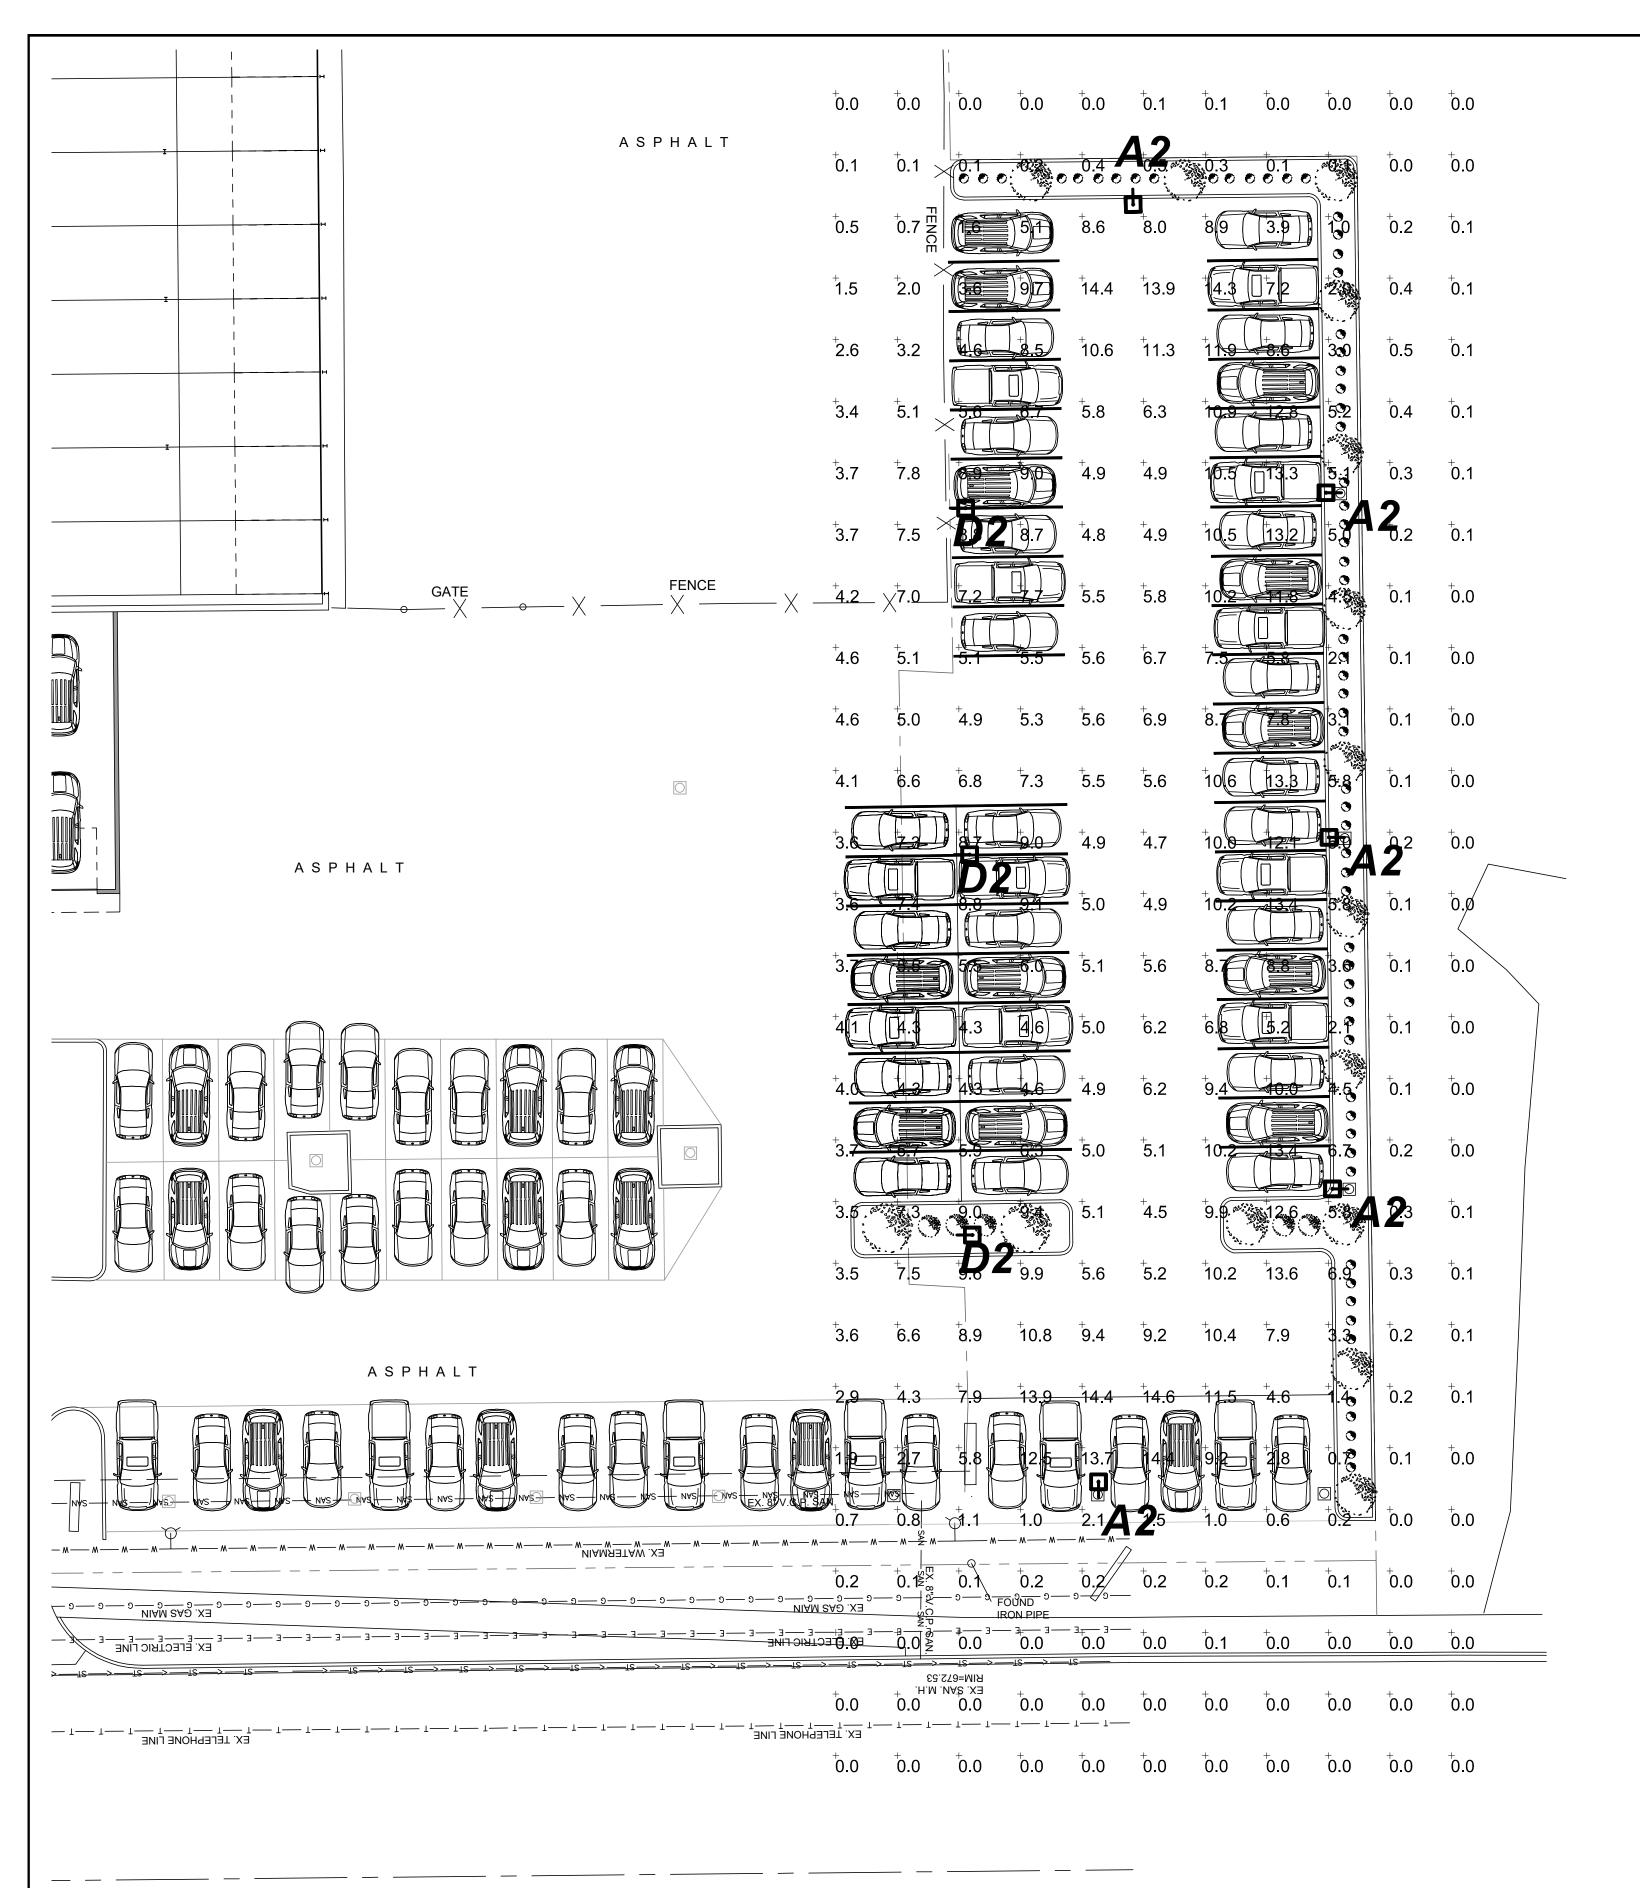
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HOMEWO 3rd  $\infty$  $\overline{\phantom{a}}$ 

Date: 12-15-23 Scale: 1"=30' File Name: 16-052-ENG-12-15-Drawn: TMF Checked: DWO Sheet:





## **LIGHTING NOTES:**

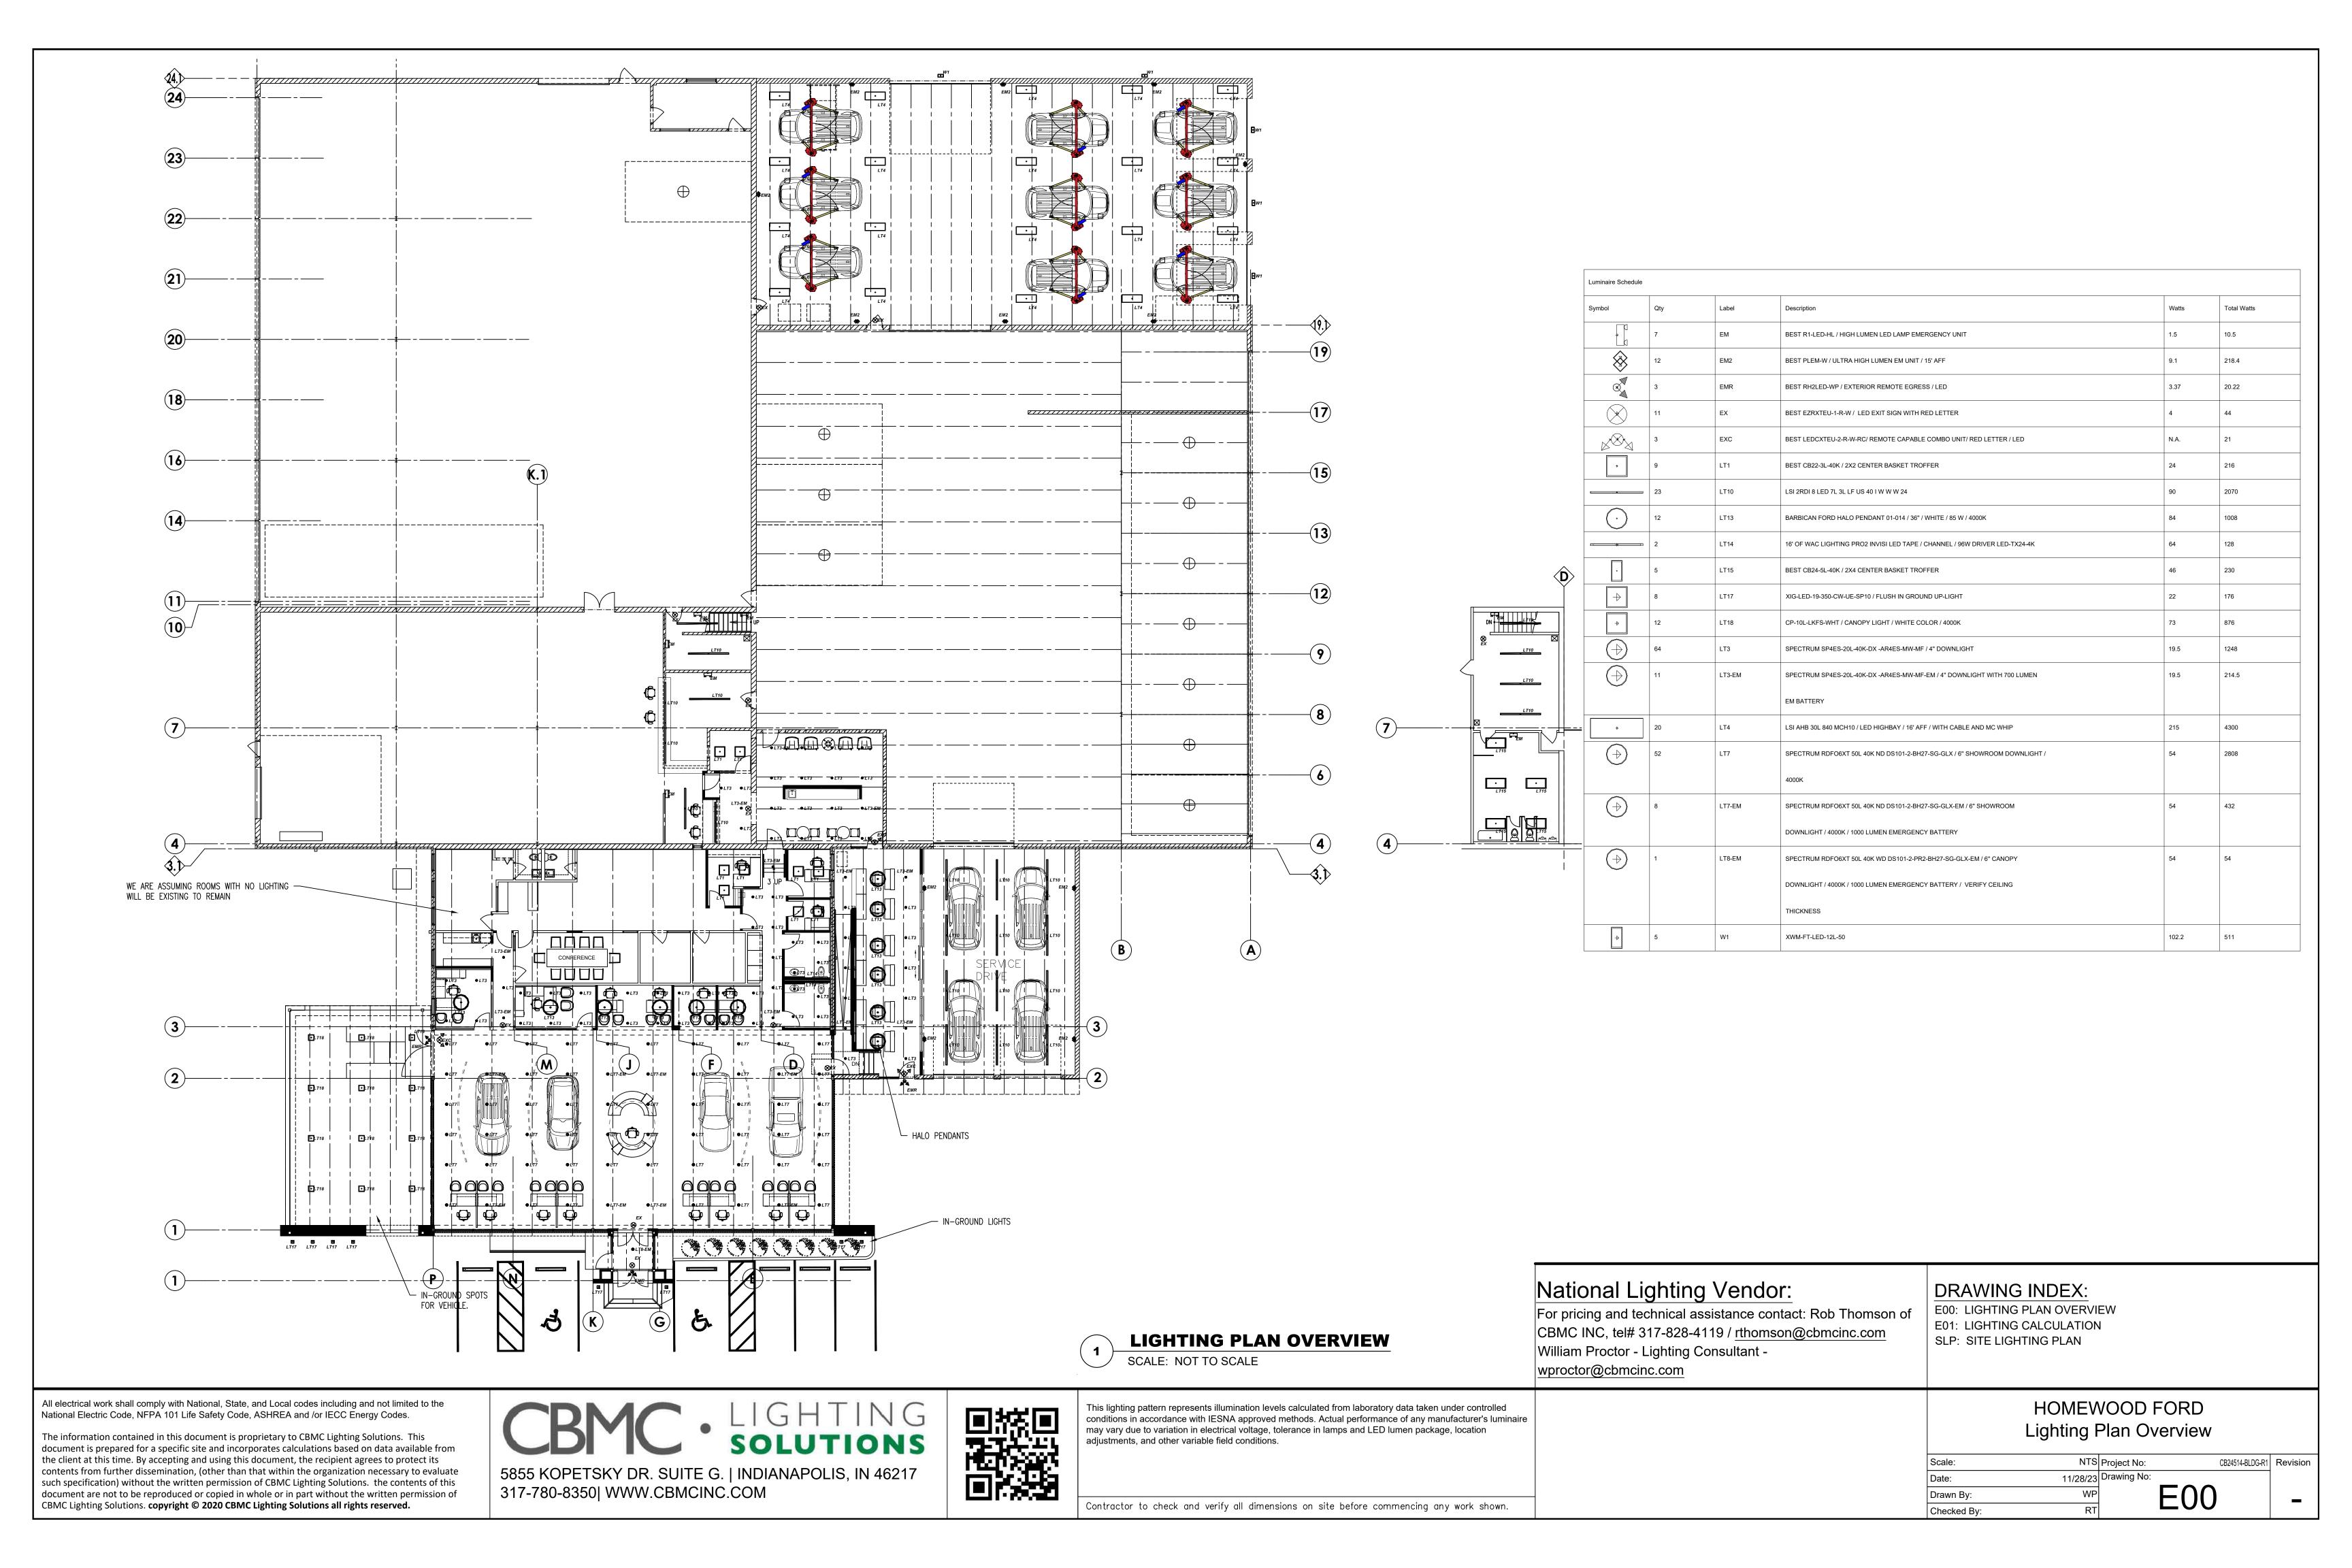- LIGHT POLES ARE 16' TALL MOUNTED ON BASES 2' A.F.G.
- LIGHT LEVELS ARE CALCULATED AT INITIAL LIGHT LEVEL 3' A.F.G.

Calculation Summary							
Label	СаІсТуре	Units	Avg	Max	Min	Avg/Min	Max/Min
SITE EXPANSION	Illuminance	Fc	4.24	14.6	0.0	N.A.	N.A.
SITE - FRONT DISPLAY ROW	Illuminance	Fc	4.76	14.4	0.2	23.80	72.00
SITE - STORAGE	Illuminance	Fc	7.79	14.4	3.9	2.00	3.69

Luminaire Schedule								
Symbol	Qty	Label	Arrangement	Description	LLF	Watts	Total	BUG Rating
							Watts	
+	3	D2	Single	SINGLE MRS-LED-24L-SIL-5W-50-70CRI / 16' POLE	1.000	196	588	B5-U0-G3
+	5	A2	Single	SINGLE MRS-LED-24L-SIL-FT-50-70CRI-IL / 16' POLE	1.000	196	980	B1-U0-G2

### STREET 183RD

**SITE LIGHTING EXPANSION** 



# National Lighting Vendor:

For pricing and technical assistance contact: Rob Thomson of CBMC INC, tel# 317-828-4119 / rthomson@cbmcinc.com William Proctor - Lighting Consultant -

wproctor@cbmcinc.com

HOMEWOOD FORD

Site Lighting Plan NTS Project No: CB24514-BLDG-R1 Revision 11/28/23 Drawing No: SLP Drawn By: WP

All electrical work shall comply with National, State, and Local codes including and not limited to the National Electric Code, NFPA 101 Life Safety Code, ASHREA and /or IECC Energy Codes.

The information contained in this document is proprietary to CBMC Lighting Solutions. This document is prepared for a specific site and incorporates calculations based on data available from the client at this time. By accepting and using this document, the recipient agrees to protect its contents from further dissemination, (other than that within the organization necessary to evaluate such specification) without the written permission of CBMC Lighting Solutions. the contents of this document are not to be reproduced or copied in whole or in part without the written permission of CBMC Lighting Solutions. copyright © 2020 CBMC Lighting Solutions all rights reserved.



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This lighting pattern represents illumination levels calculated from laboratory data taken under controlled conditions in accordance with IESNA approved methods. Actual performance of any manufacturer's luminaire may vary due to variation in electrical voltage, tolerance in lamps and LED lumen package, location adjustments, and other variable field conditions.

Contractor to check and verify all dimensions on site before commencing any work shown.

