

## APPEARANCE REVIEW


INFORMATION ss: 3055 183rd St  ex Number(s): 31-01-100-012-0000  Request icable boxes for Appearance Commission requests believation, including: g Elevations ape Plan g, Photometric Plan g, Photometric Plan g Signage  Intel Silken Ina Three Corp  55 Glenberry Ln Inley Park, IL 60430	PROPERTY OWNE Name Company	<u>R</u>	□ R-2 □ B-2 □ M-2	51	
ex Number(s): 31-01-100-012-0000  Request icable boxes for Appearance Commission requests between the commission requests betw	Proposed Develop  low.  PROPERTY OWNE  Name  Company	□ B-1 □ M-1	□ B-2 □ M-2	■ B-3 □ PL-1	□ B-4 □ PL-2
ex Number(s): 31-01-100-012-0000  Request icable boxes for Appearance Commission requests between the commission requests betw	Proposed Develop  low.  PROPERTY OWNE  Name  Company	□ M-1	□ M-2	□ PL-1	□ PL-2
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Nev Park II 60430					
icy i aik, ie 00400					
7-867-6649	Phone				
achsilken@gmail.com	Email				
	Check box if the ar	oplicant is th	ne proper	ty owner	
resentatives are permitted to make reasonable in ; ay all required fees;	spections of the subject pr	operty nec	essary to	process	this
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Fee: _	🗆 Paid 🔻 🗅	ate Receive	ed:		
Action: Comm	ents/Conditions:			Date:	
rr;	and attest that: rmation and exhibits submitted with this applicate esentatives are permitted to make reasonable instay all required fees; by be done without first obtaining a Building Permittees.  Applicant Signates.	and attest that: rmation and exhibits submitted with this application are true and accurate to essentatives are permitted to make reasonable inspections of the subject property and all required fees; by be done without first obtaining a Building Permit. All work shall be companies.  Applicant Signature  Fee: Paid	and attest that:  rmation and exhibits submitted with this application are true and accurate to the best essentatives are permitted to make reasonable inspections of the subject property necessary all required fees;  ay be done without first obtaining a Building Permit. All work shall be completed in accordances.  Applicant Signature  Fee: Paid Date Received.	The Check box if the applicant is the proper and attest that:  If mation and exhibits submitted with this application are true and accurate to the best of my known as a permitted to make reasonable inspections of the subject property necessary to any all required fees;  But be done without first obtaining a Building Permit. All work shall be completed in accordance ances.  Applicant Signature  Fee: Paid Date Received:	Check box if the applicant is the property owner and attest that:  I mation and exhibits submitted with this application are true and accurate to the best of my knowledge essentatives are permitted to make reasonable inspections of the subject property necessary to process ay all required fees;  By be done without first obtaining a Building Permit. All work shall be completed in accordance with Vilences.  Do not write b  Fee: Paid Date Received:

This application has zoning approvals and may proceed to obtain Building Permits or a Certificate of Occupancy.

Signature:\_

Name:

Date:

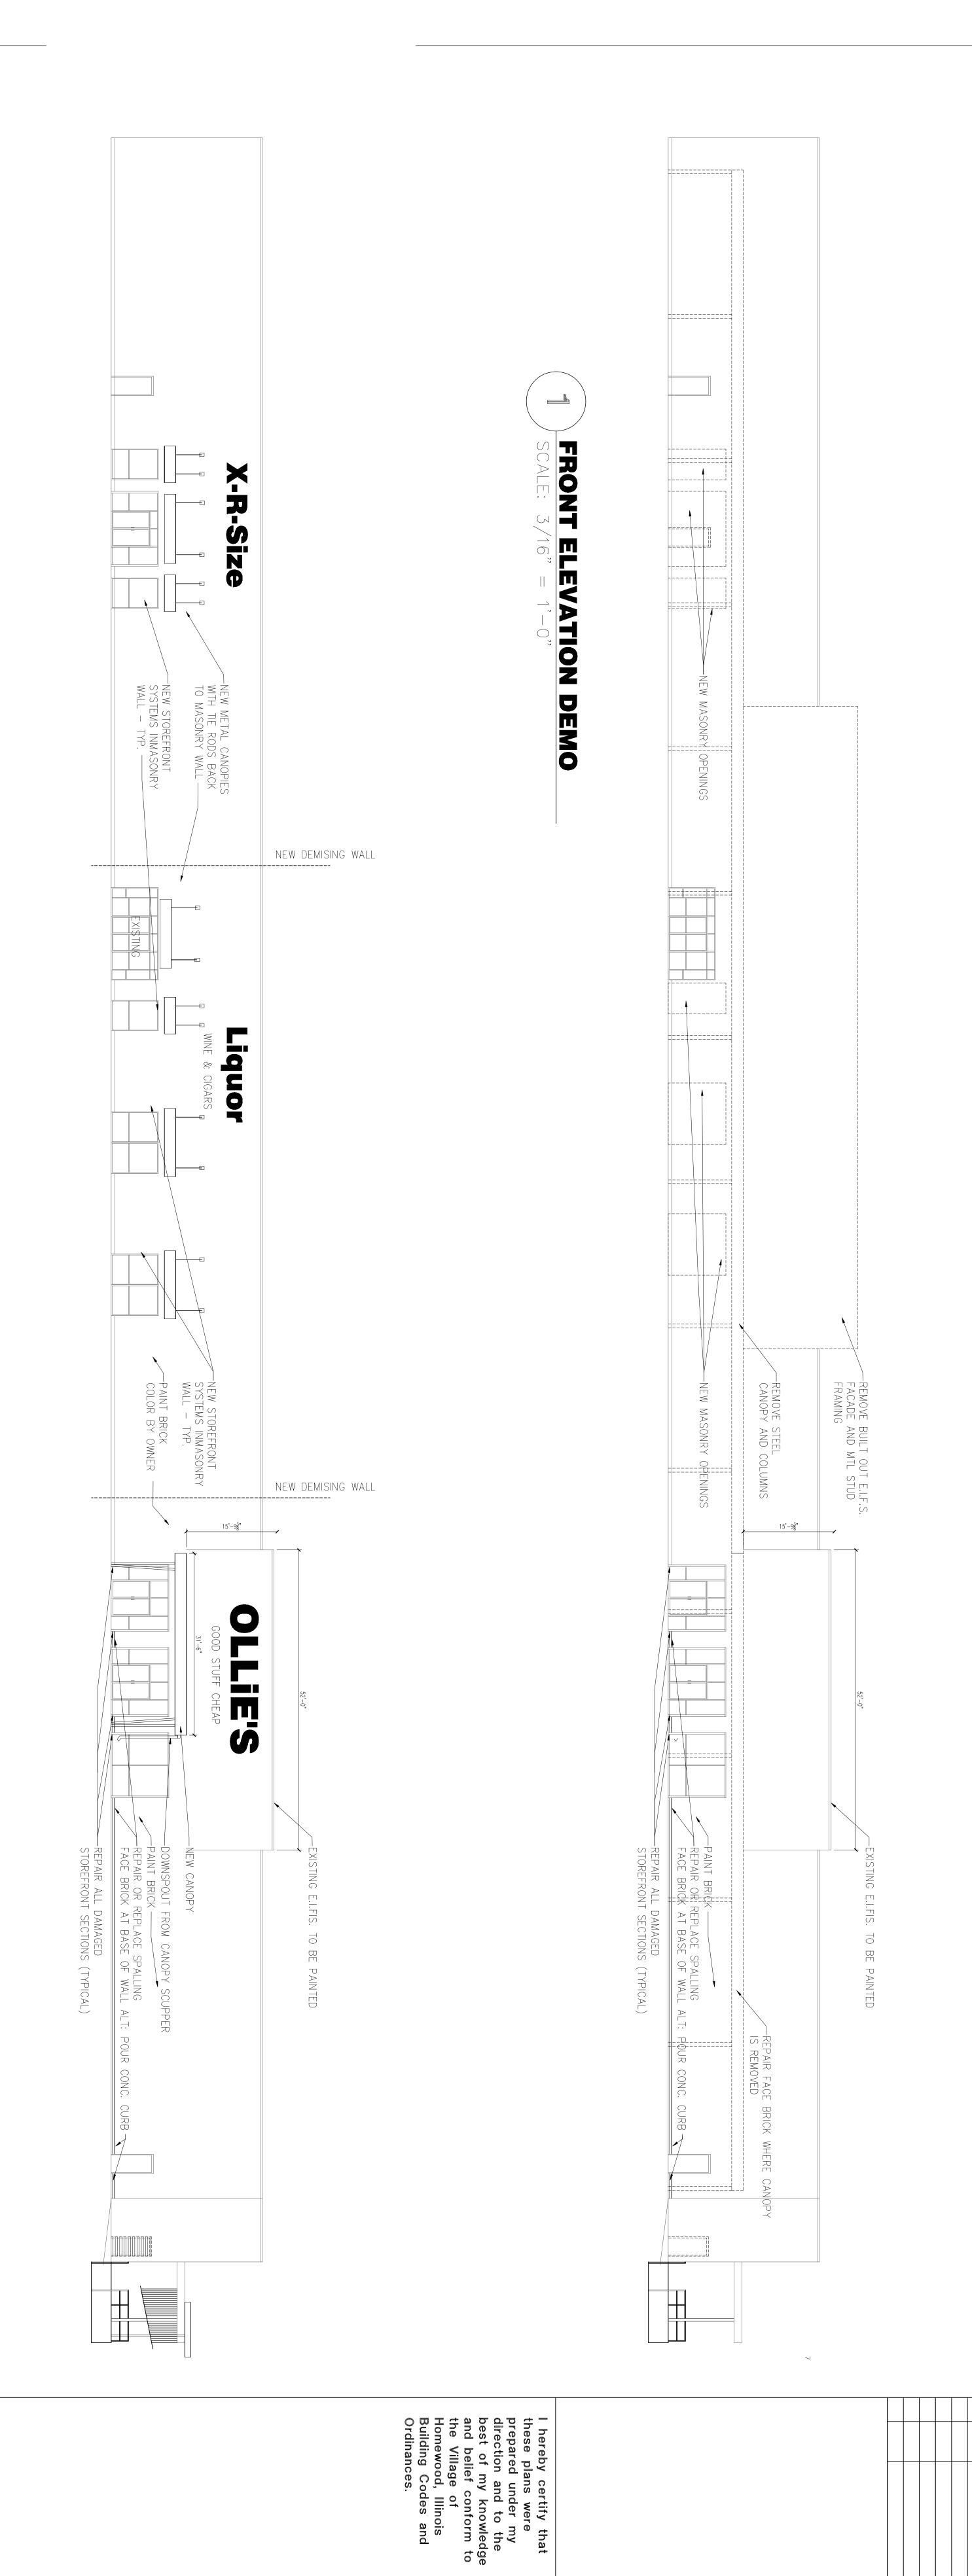

DRAWN BY:
CHECKED BY:
ND. DATE:
7.10.24


REMODEL OF: 3045 183 rd St. HOMEWOOD IL 60430

395 Poplar Ave. Elmhurst IL. 60126 630-632-1371 johnrarchitect@gmail.c John C. Robins
A R C H I T E C


FRONT ELEVATIONS

JOB NO.; 2402

DATE: 2.24.2024

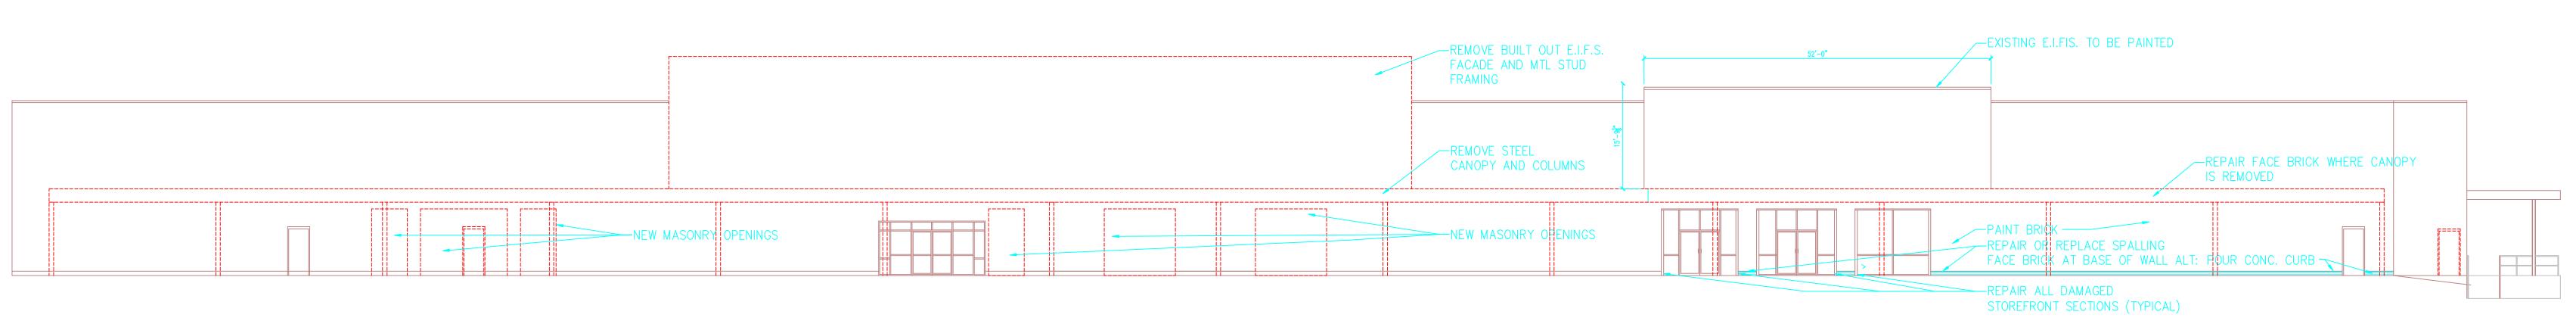

## FRONT ELEVATION DEMO

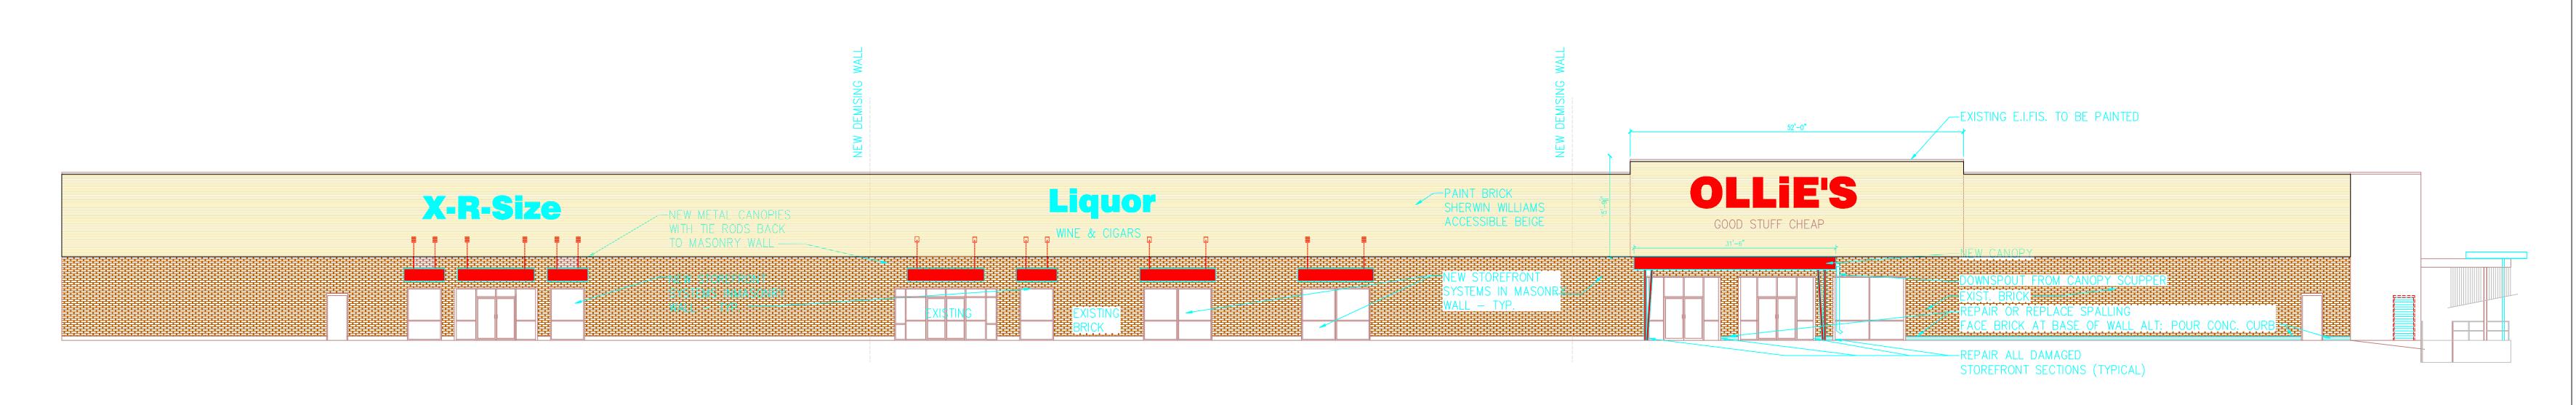

FRONT ELEVATION PROPOSED

DRAWN BY:
CHECKED BY:
ND. DATE: DESCRIPTION

7.10.24 REVIEW

I hereby certify that these plans were prepared under my direction and to the best of my knowledge and belief conform to the Village of Homewood, Illinois Building Codes and Ordinances.


REMODEL OF: 3045 183 rd St. HOMEWOOD IL 60430

John C. Robins
ARCHITECT

395 Poplar Ave.
Elmhurst IL. 60126
630-632-1371
johnrarchitect@gmail.com

FRONT SUB NO.: 2402

DATE: 2.24.2024

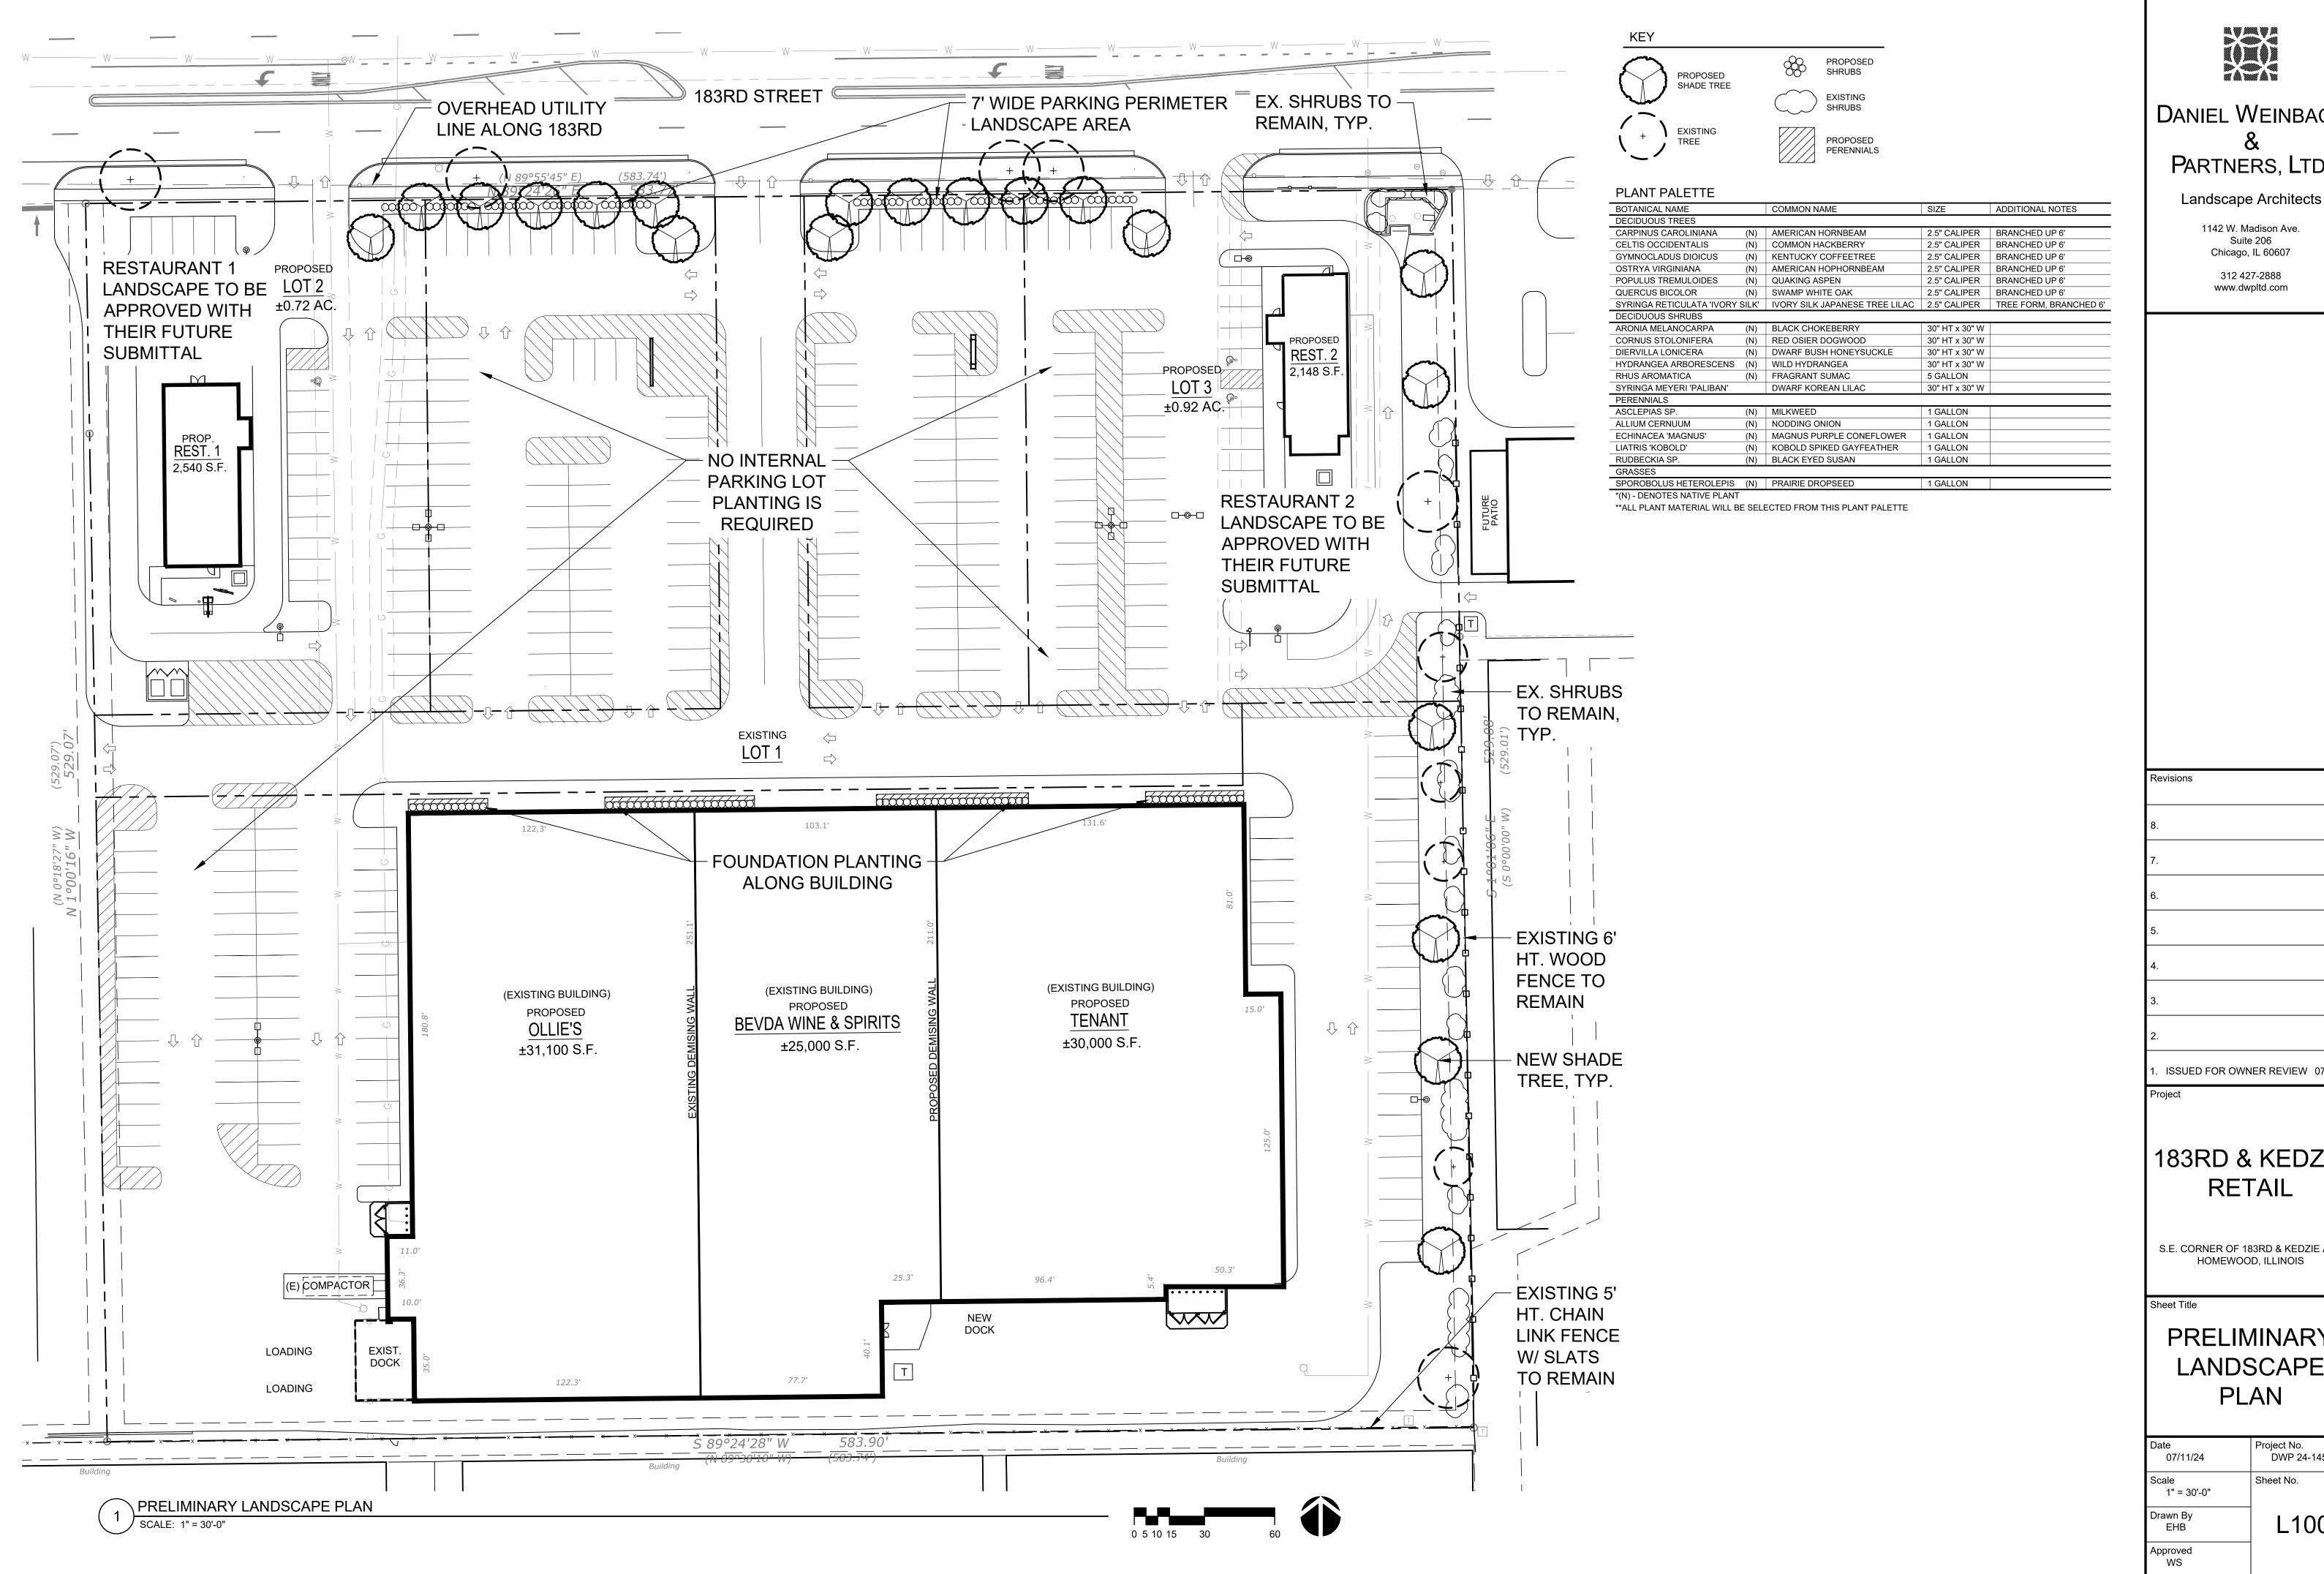



# DANIEL WEINBACH PARTNERS, LTD.

1142 W. Madison Ave. Chicago, IL 60607

ISSUED FOR OWNER REVIEW 07/07/1

| 183RD & KEDZIE

S.E. CORNER OF 183RD & KEDZIE AVE HOMEWOOD, ILLINOIS

PRELIMINARY LANDSCAPE PLAN

Date 07/11/24	Project No. DWP 24-145
Scale 1" = 30'-0"	Sheet No.
Drawn By EHB	L100
Approved WS	



### **ALLP1**

#### **Applications**

The ALLP1 is a cost-effective area light designed to offer optimal flexibility to the customer. The ALLP1 provides multiple combinations of options to maximize labor and energy savings. The ALLP1 Area Light provides uniform distribution for area and site lighting in retail, commercial, and residential applications including driveways and parking areas.

Project Name:	
Catalog Number:	
Type:	
Note:	
Date:	

















#### ALL P1B1UNVFD8CSBRT43CRSP

#### **Construction & Design**

- Type II, III, IV, and Type V light distributions
- Field selectable lumens provide a late point adjustment at the installation site
- 12,000 to 42,000 lumens
- Nine lumen packages
- Precision engineered lens made of optical grade polycarbonate for maximum light intensity
- Anti-corrosion stainless steel hardware
- Heavy duty die-cast aluminum housing with external heat-sink for optimal thermal management
- Fixture comes standard in bronze
- Field selectable CCT between 3000K, 4000K or 5000K
- Minimum 80 CRI
- Efficacy up to 158 LPW

#### **Additional Options**

- Lens field install kits for each light distribution type (Type II, III, IV, V)
- Multiple mounting options
- Light shield kit options

#### **Electrical**

- Available in 120v-277v and 277v-480v
- 10kV/5kA Surge Protection Standard
- Power Factor > 0.90\*
- Total Harmonic Distortion < 20%\* \*Note: Varies based on option

#### **Control and Sensor Options**

- Factory installed NEMA 3-pin photocell receptacle comes standard (shorting cap included)
- Photo control and occupancy sensor options available
- Fixture comes sensor ready for field installed Motion sensor options

#### Lumen Maintenance

See lumen maintenance table on page

### Fixture Certifications & Listings

- UL/cUL Wet Locations
- **IK08 Impact Rating**
- IP65 Rated
- 3.0G Vibration load rating per ANSI C136.31
- DarkSky Compliant. 3000K must be selected with direct pole mount to meet International DarkSky Association approval criteria
- DesignLights Consortium™ Premium qualified luminaire
- Visit the **DLC QPL** for listed models

### Warranty

See Orion's Product Limited Warranty for more details and information



### **ALLP1**

### Performance Information, 277v, ≥80 CRI, 5000K<sup>1</sup>

Lumens		Type II			Type III			Type IV			Type V						
Lumen	Nominal	Wattage	Actual Lumens	LPW	BUG	Wattage	Actual Lumens	LPW	BUG	Wattage	Actual Lumens	LPW	BUG	Wattage	Actual Lumens	LPW	BUG
A1	12,000	81w	12,054lm	149	B3-U0-G3	80w	11,973lm	150	B3-U0-G2	80w	11,946lm	149	B3-U0-G3	80w	11,582lm	145	B4-U0-G2
AI	14,000	100w	14,348lm	144	B3-U0-G3	99w	14,251lm	144	B3-U0-G2	99w	14,219lm	144	B3-U0-G3	99w	13,786lm	140	B4-U0-G2
B1	15,000	105w	15,542lm	148	B3-U0-G3	105w	15,267lm	146	B3-U0-G3	106w	15,058lm	142	B3-U0-G3	105w	15,051lm	144	B4-U0-G2
ы	20,000	146w	20,166lm	138	B3-U0-G3	145w	19,809lm	136	B3-U0-G3	147w	19,538lm	133	B3-U0-G3	145w	19,529lm	135	B4-U0-G2
C1	24,000	168w	23,250lm	138	B4-U0-G4	173w	23,177lm	134	B4-U0-G3	169w	23,339lm	138	B4-U0-G3	171w	22,946lm	135	B5-U0-G3
C1	28,000	201w	27,229lm	135	B4-U0-G4	207w	27,142lm	131	B4-U0-G3	201w	27,333lm	136	B4-U0-G3	204w	26,873lm	132	B5-U0-G3
	32,000	238w	33,337lm	140	B4-U0-G3	237w	33,291lm	140	B4-U0-G3	234w	33,239lm	142	B4-U0-G4	235w	33,257lm	141	B5-U0-G4
D1	36,000	268w	37,028lm	138	B4-U0-G3	268w	36,977lm	138	B4-U0-G3	263w	36,919lm	140	B4-U0-G4	265w	36,939lm	139	B5-U0-G4
	42,000	304w	40,990lm	135	B4-U0-G3	304w	40,933lm	135	B4-U0-G3	299w	40,869lm	137	B4-U0-G4	301w	40,892lm	136	B5-U0-G4

### Lumen Maintenance<sup>2</sup>

Lumen Code	Nominal Lumens	Operating Temperature	Cald	culated Lumen Maintena	nce
Lumen Code	Nominal Lumens	Operating remperature	L70	L80	L90
A1	12 000 / 14 000	25°C	189,000	119,000	57,000
AI	12,000 / 14,000	50°C	153,000	94,000	46,000
D1	B1 15,000 / 20,000	25°C	184,000	116,000	55,000
ВІ		50°C	150,000	94,000	45,000
C1	24.000 / 20.000	25°C	162,000	102,000	49,000
C1	24,000 / 28,000	50°C	154,000	97,000	46,000
D1	32,000 / 36,000 / 42,000	25°C	173,000	108,000	52,000
וט		50°C	140,000	86,000	41,000

### Additional Specification Information

 $<sup>^1</sup>$  Actual performance may vary by up to  $\pm 10\%$  of values listed; facility factors and fixture options can affect performance values.

<sup>&</sup>lt;sup>2</sup>Calculated hours based on TM-21 projections and components used at the time of testing. Warranty is not associated with Calculated Lumen Maintenance




### **ALLP1**


### Physical Information<sup>3</sup>

Nominal Lumen Code	Length	Height	Width	Weight	EPA (side) Using Slipfitter
A1/B1/C1	15.63"	2.38"	11.18"	9.00 lbs.	.64 ft²
D1	19.65"	2.38"	13.97"	12.20lbs.	.77 ft²

### A1/B1/C1

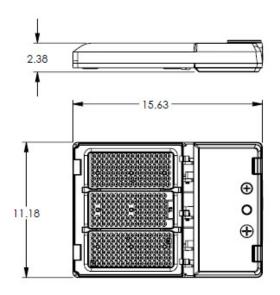

### D1

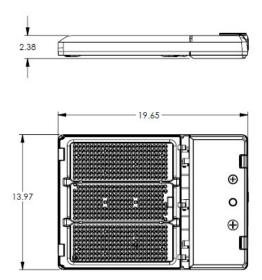

### **Ambient Operating Temperatures**

Nominal Lumen Code	Standard Range
All Lumen Packages	-40°C to 50°C (-40°F to 122°F)

Sensor Type	Operating Range
All Sensors	-30°C to 50°C (-22°F to 122°F)

### Additional Specification Information



### **ALLP1**

## Ordering Information Example (NOTE: No dashes or spaces unless noted below) **ALLP1B1UNVFD8CST43CRSP**

### Ordering Information

Series	Nominal Lumen Code <sup>4</sup>	Voltage	Driver Type	CRI; Color Temp	Fixture Colors	Light Distribution	Standard Factory	Packaging Options
							Installed	

Series	Nominal Lumen Code <sup>4*</sup>	Voltage	Driver Type	CRI; Color Temp*	Fixture Colors	Light Distribution	Standard Factory Installed	Packaging Options
ALLP1= HARRIS LED Lumen Select Area Light, Gen 1	A1= Lumen Selectable 12,000 lm/ 14,000 lm  B1= Lumen Selectable 15,000 lm/ 20,000 lm/ 20,000 lm  C1= Lumen Selectable 24,000 lm/ 28,000 lm/ D1= Lumen Selectable 32,000 lm/ 36,000 lm/ 42,000lm/	UNV= 120v-277v HMV= 277v-480v	FD= Full Dimming	8CS= 80CRI; Color Selectable 3000K/ 4000K / 5000K	BR= Bronze	T2= Type II T3= Type III T4= Type IV T5= Type V	3CR= 3-Pin Universal NEMA Receptacle and Sensor Ready**5	SP= Single Pack

\*Note: All fixtures are set to max lumen range output at 5000K at the factory EX: ALLP1A1=14,000 at 5000K)

### Fixture Options (Factory Installed)







Motion Sensor Ready



Field Selectable Lumens and CCT

### Additional Specification Information

<sup>4</sup> For actual lumens, see performance table

<sup>5</sup> Use of Sensor and Photocell together is not recommended

<sup>\*\*</sup>Note: See Page 5 for Photocell and Motion Sensor Options



### **ALLP1**

### Accessories (Sold Separately-Field Installed)

	Mounting Options									
EXT-ALLP-SFT-001	Bronze Slip-fitter, 2-3/8" Tenons									
EXT-ALLP-TRN-001	TRN-001 Bronze Trunnion Mount									
EXT-ALLP-ADJ-001	Bronze Adjustable Pole Mount, 3" Round Pole, Max 5" Round, Min. 3" Square Pole									
EXT-ALLP-WM-001	F-ALLP-WM-001 Bronze Adjustable Wall Mount Arm Kit									
EXT-ALLP-DPM-001	Bronze Direct Pole Mount, Dark Sky Compliant, 3" Round Pole, Max 5" Round, Min. 3" Square Pole									
	Light Shield Options									
EXT-ALLP-FLS-001	Bronze Back and Side Light Shields, A1/B1/C1									
EXT-ALLP-FLL-001	Bronze Back and Side Light Shields, D1									
	Control Options <sup>5</sup>									
EXT-ALLP-PE3-001 Twist-lock Photocell On/Off Daylight Sensing Only, 120v-277v										
EXT-ALLP-PE3-002	Twist-lock Photocell On/Off Daylight Sensing Only, 347v									
EXT-ALLP-PE3-003	EXT-ALLP-PE3-003 Twist-lock Photocell On/Off Daylight Sensing Only, 480v									
Motion Sensor Options <sup>5,6</sup>										
EXT-LSW-RC	EXT-LSW-RC Remote Control for Sensor Commissioning (For HB02DPR and HB01DMS-A Sensors)									
HB02DPR	PIR Occupancy/Daylight Sensor, High and Low End Trim, 0-10v Dimming, 20' max. mounting height									
HB01DMS-A	Microwave Occupancy Sensor, Photosensor, Low End Trim, 0-10v Dimming, IR Remote Programmable, 45' max. mounting height									
	Lens Kit Options - Field Replacement									
ROL-ALLP1-S-T2	Replacement Lens: ALLP, Light distribution Type II (T2), Small (A1/B1/C1)									
ROL-ALLP1-S-T3	Replacement Lens: ALLP, Light distribution Type III (T3), Small (A1/B1/C1)									
ROL-ALLP1-S-T4	Replacement Lens: ALLP, Light distribution Type IV (T4), Small (A1/B1/C1)									
ROL-ALLP1-S-T5	Replacement Lens: ALLP, Light distribution Type V (T5), Small (A1/B1/C1)									
ROL-ALLP1-L-T2	Replacement Lens: ALLP, Light distribution Type II (T2), Large (D1)									
ROL-ALLP1-L-T3	Replacement Lens: ALLP, Light distribution Type III (T3), Large (D1)									
ROL-ALLP1-L-T4	Replacement Lens: ALLP, Light distribution Type IV (T4), Large (D1)									
	Replacement Lens: ALLP, Light distribution Type V (T5), Large (D1)									

### Accessories (Field Installed)



Slipfitter (EXT-ALLP-SFT-001)



Adjustable Wall Arm Mount (EXT-ALLP-WM-001)



Trunnion Mount
(EXT-ALLP-TRN-001)



Direct Pole Mount (EXT-ALLP-DPM-001)



Adjustable Arm Mount (EXT-ALLP-ADJ-001)



Light Shield (EXT-ALLP-FLx-001)

### Additional Specification Information

<sup>6</sup> Sensor options are only approved for use when using the max lumen switch position. Power usage and dimming levels are only accurate when using max lumen switch position

<sup>&</sup>lt;sup>5</sup> Use of Sensor and Photocell together is not recommended

### **ALLP1**

### Accessories (Field Installed)




Photocell (EXT-ALLP-PE3-00x)




Lens Kit (ROL-ALLP1-x-Tx)


### ISO Footcandle Plots

Visit orionlighting.com to obtain all .IES files

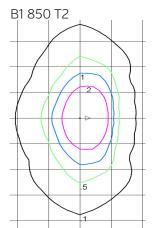


Distance are in Units of Mounting Height Mounting Height 30' Max. Calculated Value: 6.58 Fc

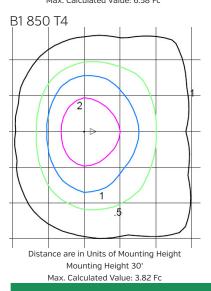

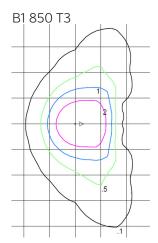

Distance are in Units of Mounting Height Mounting Height 30' Max. Calculated Value: 4.92 Fc

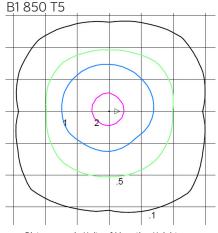


Distance are in Units of Mounting Height Mounting Height 30' Max. Calculated Value: 2.48 Fc



### **ALLP1**


### Fixture with Mounting Dimensions and Physical Information

Slipfitter Mount (EXT-ALLP-SFT)

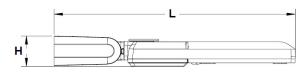


	Lumen     Length     Height     Width     Weight     EPA_(s       Code     @ 0°									
A1/B1/C1 22.51" 2.93" 11.18" 10.40lbs64 ft <sup>2</sup>										
	D1 26.53" 2.93" 13.97" 13.60lbs77 ft <sup>2</sup>									
Ì	Note: This slipfitter can adapt to 2-3/8" tenons.									

### Trunnion Mount (EXT-ALLP-TRN)

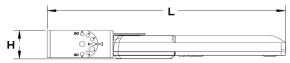

Lumen Code	Length	Height	Width	Weight	EPA (side @ 0°)
A1/B1/C1	21.60"	2.88"	11.18"	12.10lbs.	.63 ft²
D1	25.62"	2.88"	13.97"	13.97lbs.	.92 ft²


### Adjustable Arm Mount (EXT-ALLP-ADJ)

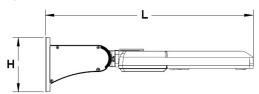

Lumen Code	Length	Height	Width	Weight	EPA (side @ 0°)
A1/B1/C1	24.15""	6.30"	11.18"	11.40bs	.80 ft²
D1	28.17"	6.30"	13.97"	14.60lbs	.75 ft²


**Note:** This mounting kit can adapt to round poles (3">5" diameter and square poles (min. 3")

#### Adjustable Wall Mount (EXT-ALLP-WM)

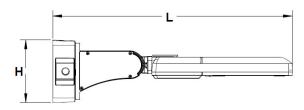

#### EPA (side Lumen Length Height Width Weight Code @ 0°] A1/B1/C1 .89 ft<sup>2</sup> 26.63" 6.94" 11.18" 13.60lbs. 1.01 ft<sup>2</sup> D1 30.65" 6.94" 13.97" 16.80lbs.

### Direct Pole Mount (EXT-ALLP-DPM)

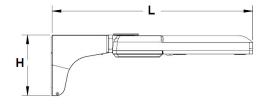

Lumen Code	Length	Height	Width	Weight	EPA (side @ 0°)
A1/B1/C1	23.70"	6.94"	11.18"	13.00lbs.	.75 ft²
D1	27.50"	6.94"	13.97"	16.20lbs.	.87 ft²

Note: This mounting kit can adapt to round poles (3">5" diameter and square poles (min. 3")