Sheet No.

GHULAM M KAMAL

081-006522

A100

RESERVED **ZONING DATA** ACCESSIBLE PARKING SIGNAGE SIZE & DIMENSIONS PER LOCAL ACCESSIBILT PARKING F WITH THE ILLINOIS STANDARD R7-I10 **ZONING DISTRICT CENTRAL BUSINESS DIST. (B-1)** PLATE SHOWING THE AMOUNT OF TH FINE FOR ILLEGALLY PARKING IN THE LOT AREA: RESERVED ACCESSIBLE SPACE(S).) **TOTAL BUILDING AREA** 16,646 15,788 SQ FT. RESIDENTIAL STORAGE **CONSTRUCTION TYPE PREVIOUS OCCUPANCY TYPE** TYP. ACCESSIBLE PARKING STALL AND SIGNAGE **OCCUPANCY TYPE RESIDENTIAL OCCUPANT LOAD** 15,788 GSF / 200 79

16,646

10,987

28,387


SQ FT.

23 STALLS


27 STALLS

1 STALLS

28 STALLS

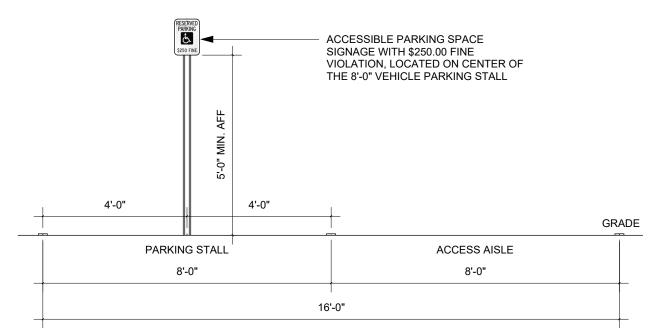

ACCESSIBLE PARKING - DETAIL

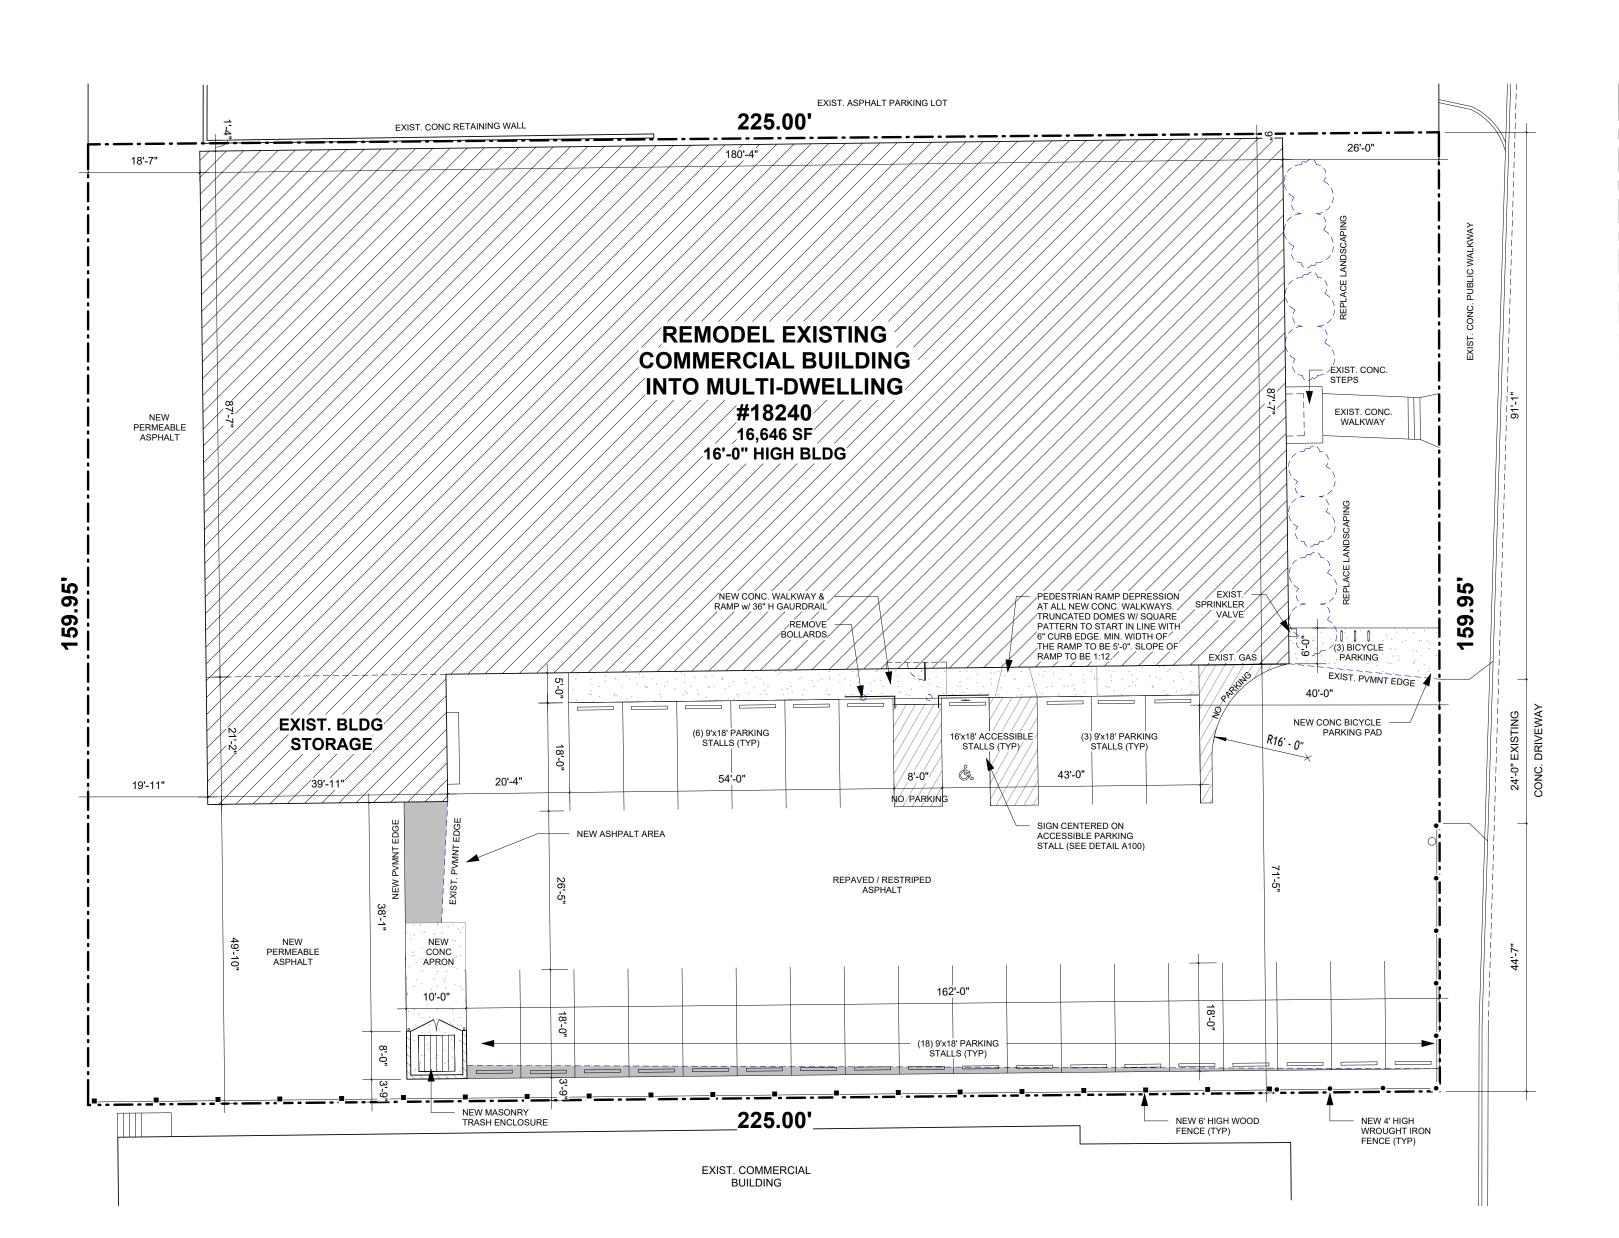



TOTAL BUILDING AREA

EXISTING IMPERVIOUS PVMNT

NEW TRASH ENCLOSURE / APRON

REQUIRED PARKING (1.5 / D.U.) - 15 UNITS

NEW ASPHALT/CONC. PVMNT


HANDICAP PARKING SPACES

TOTAL (ASSIGNED) PARKING

TOTAL IMPERVIOUS AREA

PARKING SPACES



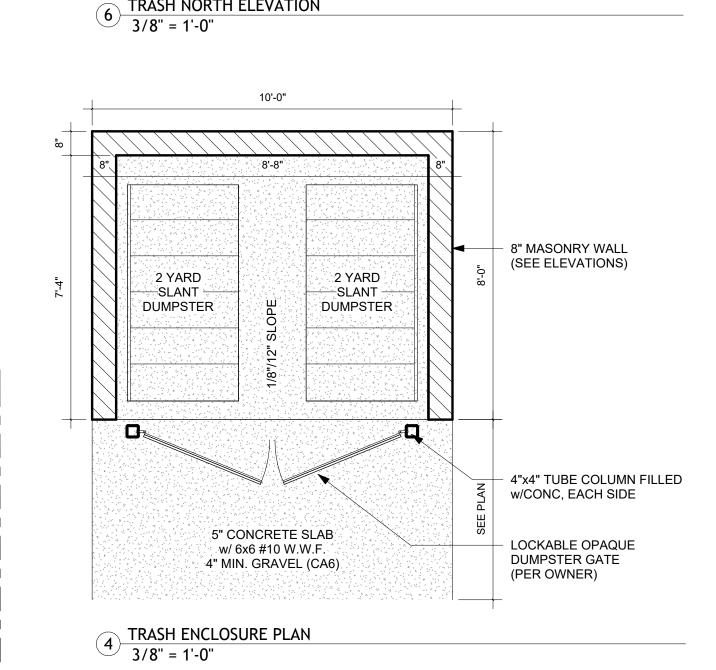

10'-0"

8'-8"

GRADE

6" | 8" | 6

TRASH NORTH ELEVATION

ALUMINUM COPING w DRIP EDGE 8" MASONRY WALL 4"x4" TUBE COLUMN FILLED w/CONC EACH SIDE CONC. SLAB ON GRADE w/ 6x6 #10 W.W.F. GRADE 12" CONC. TURNDOWN FOUNDATION-NEW 8" CONC. FND. _w/ 20"x12" FTG

5 TRASH EAST ELEVATION
3/8" = 1'-0"

DRAWING INDE	ΕX
Sheet Name	Sheet Number
COVER PAGE	A100
DEMOLITION PLAN	A101
PROPOSED FLOOR PLANS	A102.1
PROPOSED FLOOR PLANS	A102.2
UNIT FLOOR PLANS	A102.3
ELEVATIONS	A201
LANDSCAPE	L101
PHOTOMETRIC	L201

MULTI-DWELLING UNIT BUILD-OUT IN EXISTING COMMERCIAL BUILDING

NOTICE TO CONTRACTOR:

ALUMINUM COPING w

4"x4" TUBE COLUMN FILLED

6' HIGH CEDAR DUMPSTER

w/INTERGRAL FLUSH BOLT AND

PAD LOCK. CAST STL. SLEEVE

IN CONC.FOR FLUSH BOLT

4" Ø BOLLARD EACH SIDE

8" CONC. FOUNDATION

w/ (2) #4 REBAR CONT.

GATE - PAINTED STAINED

DRIP EDGE

MASONRY WALL

FULLY GROUTED

w/CONC, EACH SIDE

GATE LOCK DEVICE

CONC. SLAB

w/ 6x6 #10 W.W.F.

1. THE ARCHITECT OF RECORD IS PROVIDING PLANS ONLY, NO OTHER TYPE OF ARCHITECTURAL SERVICE IS INTENDED OR IMPLIED. THESE PLANS ARE TO BE USED BY A COMPETENT LICENSED CONTRACTOR KNOWLEDGEABLE IN THE BUILDING TRADES, WHO WILL CHECK AND VERIFY ALL DIMENSIONS AND CONDITIONS AND BE RESPONSIBLE FOR THEM.

2. ADMINISTRATION OF THE CONTRACT WILL BE BY OWNER OR HIS REPRESENTATIVE. THE CONTRACTOR AND THE OWNER SHALL BE SOLELY RESPONSIBLE FOR THE BUILDING CONSTRUCTION PROCESS MEANS AND

3. THE DRAWINGS INDICATE THE GENERAL SCOPE OF THE PROJECT - THE DIMENSIONS OF THE BUILDING. MAJOR ARCHITECTURAL ELEMENTS, AND TYPE OF STRUCTURAL SYSTEM. THE DRAWINGS DO NOT DESCRIBE ALL THE WORK REQUIRED FOR SUCCESSFULLY COMPLETING THE PROJECT. BASED ON THE DRAWINGS, THE CONTRACTOR MUST FURNISH ALL ITEMS REQUIRED FOR THE PROPER EXECUTION AND COMPLETION OF THE

5. THE CONTRACTOR MUST THOROUGHLY EXAMINE THE DRAWINGS TO DETERMINE THE SCOPE AND THE INTENT OF THESE DOCUMENTS AND DRAWINGS. THE CONTRACTOR MUST VISIT THE SITE AND BECOME INFORMED OF ALL EXISTING CONDITIONS, DIMENSIONS AND LIMITATIONS UNDER WHICH THE WORK IS TO BE PERFORMED. IF ANY DISCREPANCIES OR OMISSIONS ARE DISCOVERED. THE CONTRACTOR MUST NOTIFY THE ARCHITECT AND OBTAIN CLARIFICATIONS BEFORE SUBMITTING HIS BID. FAILURE TO GIVE NOTICE OR OBTAIN CLARIFICATION WILL NOT BE CAUSE FOR ADDITIONAL COMPENSATION.

6. THE CONTRACTOR MUST FURNISH SKILLED LABOR, MATERIALS, EQUIPMENT, APPLIANCES AND SERVICES, AND PERFORM ALL OPERATIONS NECESSARY TO COMPLETE THE WORK IN A SAFE AND WORKMANLIKE MANNER WITHIN THE OWNER'S SCHEDULE.

7. NOTED DIMENSIONS TAKE PRECEDENCE OVER SCALED DIMENSIONS - DO NOT SCALE DRAWINGS 8. ALL EXTERIOR DIMENSIONS ARE TO FACE OF BRICK OR CONCRETE.

9. ALL MATERIALS AND EQUIPMENT MUST BE INSTALLED PER MANUFACTURER INSTRUCTIONS AND RECOMMENDATIONS, AND TO THE BEST INDUSTRY STANDARDS.

10. CONTRACTOR IS RESPONSIBLE FOR REMOVAL AND PROPER DISPOSAL OF ALL DEBRIS GENERATED BY THE

WORK. CLEAN UP IS REQUIRED ON DAILY BASIS.

LIMITATION OF WARRANTY OF ARCHITECTS WORK PRODUCT:

THE ARCHITECT AND HIS CONSULTANTS DO NOT WARRANT OR GUARANTEE THE ACCURACY AND COMPLETENESS OF THE WORK PRODUCT HEREIN BEYOND REASONABLE DILIGENCE. IF ANY MISTAKES, OMISSIONS, OR DISCREPANCIES ARE FOUND TO EXIST WITHIN THE WORK PRODUCT, THE ARCHITECT SHALL BE PROMPTLY NOTIFIED SO THAT HE MAY HAVE THE OPPORTUNITY TO TAKE STEPS NECESSARY TO RESOLVE THEM. FAILURE TO PROMPTLY NOTIFY THE ARCHITECT OF SUCH CONDITIONS SHALL ABSOLVE THE ARCHITECT OF ANY RESPONSIBILITY FOR THE CONSEQUENCES OF SUCH FAILURE. ACTIONS TAKEN WITHOUT KNOWLEDGE AND CONSENT OF THE ARCHITECT, OR IN CONTRADICTION TO THE ARCHITECT'S WORK OR RECOMMENDATIONS, SHALL BECOME THE RESPONSIBILITY OF THE PARTIES RESPONSIBLE FOR SAID ACTIONS.

ADOPTED BUILDING CODES

2018 INTERNATIONAL BUILDING CODE w/LOCAL AMENDMENTS

2018 INTERNATIONAL ENERGY CONSERVATION CODE w/LOCAL AMENDMENTS

2003 INTERNATIONAL ELECTRICAL CODE w/LOCAL AMENDMENTS 2017 NATIONAL ELECTRICAL CODE w/LOCAL AMENDMENTS

2018 INTERNATIONAL MECHANICAL CODE w/LOCAL AMENDMENTS

2018 INTERNATIONAL FUEL/GAS CODE w/LOCAL AMENDMENTS

2014 ILLINOIS PLUMBING CODE w/LOCAL AMENDMENTS

2018 INTERNATIONAL EXISTING BUILDING CODE w/LOCAL AMENDMENTS

SCOPE OF WORK:

INTERIOR REMODEL OF AN EXISTING VACANT COMMERCIAL SPACE INTO MULTI-DWELLING UNITS. WORK SHALL INCLUDE NEW PLUMBING, NEW INTERIOR NON-LOAD BEARING WALLS, NEW SUSPENDED GYPSUM BOARD CEILING, NEW ELECTRICAL AND NEW MECHANICAL.

-AUTOMATIC FIRE ALARM / SPRINKLER SYSTEM SHALL BE DESIGNED AND SUBMITTED BY A CERTIFIED THIRD-PARTY CONTRACTOR UNDER SEPARATE PERMIT. -ALL SIGNAGE DESIGNS SHALL BE SUBMITTED FOR APPROVAL PRIOR TO INSTALL.

NOTE: IF APPLICABLE, ALL ZONING, SITE ENGINEERING AND FIRE PROTECTION REVIEWS, INCLUDING THOSE FOR EXTERIOR SIGNAGE, LIGHTING, COLORS, SITE IMPROVEMENTS, ROOFTOP SCREENING, FIRE SPRINKLER, FIRE ALARM, ETC. ARE REVIEWED BY OTHERS UNDER SEPARATE SUBMITTAL AND, AS SUCH, ARE NOT

ENERGY CONSERVATION STATEMENT

I CERTIFY TO THE BEST OF MY KNOWLEDGE AND BELIEF THE ATTACHED PLANS

(x) FULLY COMPLY () NEED NOT COMPLY

WITHIN THE SCOPE OF THIS REVIEW.

WITH THE REQUIREMENTS OF THE LOCAL ENERGY CONSERVATION CODE.

01-08-2025

GHULAM M KAMAL 081-006522 (Arch. S.E. or P.E.) Illinois License Number: 062-069096

CERTIFICATION STATEMENT

I HEREBY CERTIFY THAT THESE PLANS WERE PREPARED UNDER MY DIRECT SUPERVISION AND TO THE BEST OF MY PROFESSIONAL KNOWLEDGE AND BELIEF CONFORM TO THE CURRENT EDITION OF THE VILLAGE OF HOMEWOOD BUILDING AND ZONING CODE.

01-08-2025

LUCID ENGINEERING SERVICES, LLC

Design Firm Number: 184-006684-0006 Illinois License Number: 081-006522 Exp: 11/2026



EXISTING FRONTAGE FACADE

GENERAL DEMOLITION NOTES

PRIOR TO DEMOLITIONS OF WALLS, COLUMNS, FLOORS AND ROOFS, THE CONTRACTOR MUST VERIFY EXISTING STRUCTURAL CONDITIONS AND LOCATION OF ALL BEARING WALLS. NOTIFY THE ARCHITECT OF ANY STRUCTURAL CONDITIONS THAT ARE CONTRARY TO THESE DRAWINGS.

PROPERLY SHORE EXISTING STUCTURE WHEN REMOVING COLUMNS, WALLS, FLOORS AND ROOF.

THIS PLAN SHOWS GENERAL DEMOLITION WORK TO BE PERFORMED AND DOES NOT RELIEVE THE CONTRACTOR OF OTHER DEMOLITION WORK REQUIRED TO PRODUCE THE BUILDING MODIFICATIONS SHOWN ON THE REMAINING CONTRACT DOCUMENTS, INCLUDING PLUMBING, HVAC AND ELECTRICAL WORK.

PROTECT ALL EXISTING CONSTRUCTION SHOWN TO REMAIN FROM DAMAGE DURING CONSTRUCTION, FOR THE EXTENT OF THE DEMOLITION AND MODIFICATION

THE CONTRACTOR WILL SUPERVISE AND DIRECT THE WORK, USING THE CONTRACTOR'S BEST SKILL AND ATTENTION. THE CONTRACTOR WILL BE RESPONSIBLE FOR AND HAVE CONTROL OVER CONSTRUCTION MEANS, METHODS, TECHNIQUES, SEQUENCES, (UNLESS A SEQUENCE IS SPECIFIED BY THE OWNER OR CONTRACT DOCUMENTS) AND PROCEDURES, AND FOR COORDINATING ALL PORTIONS OF THE WORK.

ALL LABOR, MATERIALS AND CONSTRUCTION MEANS AND METHODS SHALL COMPLY WITH ALL RULES, REGULATIONS AND ORDINANCES OF ALL FEDERAL, STATE AND LOCAL AUTHORITIES HAVING JURISDICTION OVER THE WORK, INCLUDING THE OCCUPATIONAL SAFETY AND HEALTH ACT (OSHA)


THE CONTRACTOR WILL KEEP THE PREMISES FREE FROM THE ACCUMULATION OF WASTE MATERIAL AND RUBBISH. AT THE COMPLETION OF THE WORK UNDER EACH PHASE HE MUST REMOVE FROM THE PREMISES ALL RUBBISH, IMPLEMENTS, AND SURPLUS MATERIALS AND THE PREMISES ALL RUBBISH, IMPLEMENTS, AND SURPLUS MATERIALS AND LEAVE THE AREAS BROOM CLEAN. SITE BURNING WILL NOT BE ALLOWED.


THE CONTRACTOR WILL PERFORM DEMOLITION IN A MANNER


THAT WILL PROTECT EXISTING CONSTRUCTION, INCLUDING MECHANICAL, ELECTRICAL, PLUMBING WORK, ETC. THAT IS TO REMAIN AND/ OR BE REUSED. ALL ITEMS INDICATED TO BE SALVAGED SHALL BE CAREFULLY REMOVED. SALVAGED SHALL BE CAREFULLY REMOVED.

INFORMATION CONTAINED WITHIN THESE DRAWINGS IS BASED ON EARLIER DOCUMENTATION AND FIELD VERIFICATION OF APPARENT ITEMS. THE CONTRACTOR WILL BE RESPONSIBLE FOR VERIFYING THE ACCURACY OF THE PLANS AND INFORMATION CONTAINED HEREIN. THE ARCHITECT MUST BE NOTIFIED OF ANY LATENT AND UNFORESEEN CONDITIONS THAT MAY ADVERSELY AFFECT THE PROGRESS OF WORK. SECURE ANY DAMAGED AREAS AS REQUIRED TO MAINTAIN A SAFE ENVIRONMENT FOR ADDITIONAL EVALUATION AND REMEDIAL WORK TO OCCUR.


DEMOLITION DESCRIBED FOR THE EXISTING FACILITY AND SYSTEMS CANNOT POSSIBLY CONVEY ALL THE ELEMENTS OF THE DEMOLITION WORK. CANNOT POSSIBLY CONVEY ALL THE ELEMENTS OF THE DEMOLITION WORK. THE INTENT OF THE DEMOLITION NOTES CONTAINED HEREIN IS TO CONVEY THE MAJOR ITEMS TO BE REMOVED. THE NOTES ALSO IMPLY THAT ALL MINOR ITEMS COINCIDENT WITH A MAJOR ITEM BE REMOVED. THUS, THE PURPOSE OF THESE DRAWINGS IS TO SHOW THE MINIMUM LIMITS AND NOT THE ENTIRE SCOPE OF WORK.

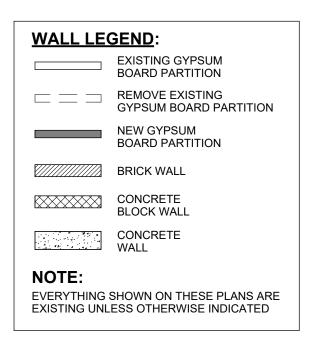

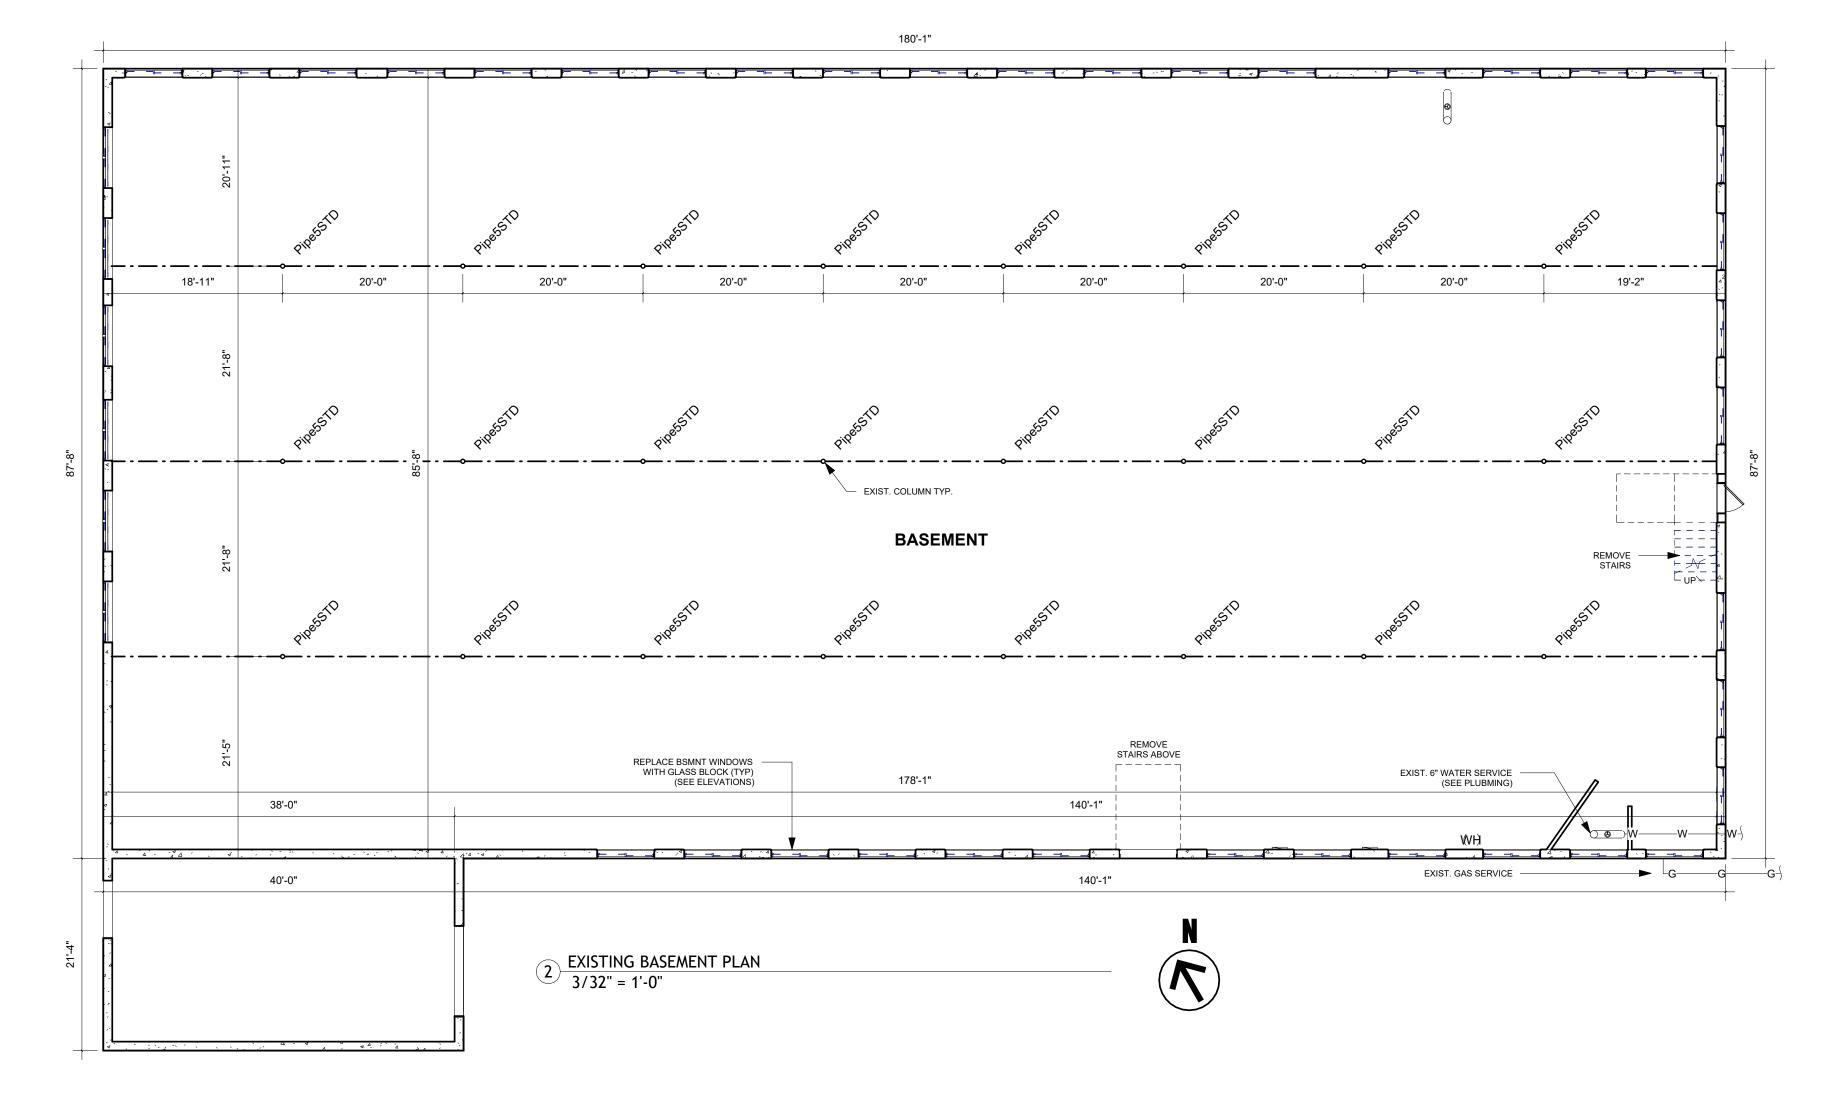

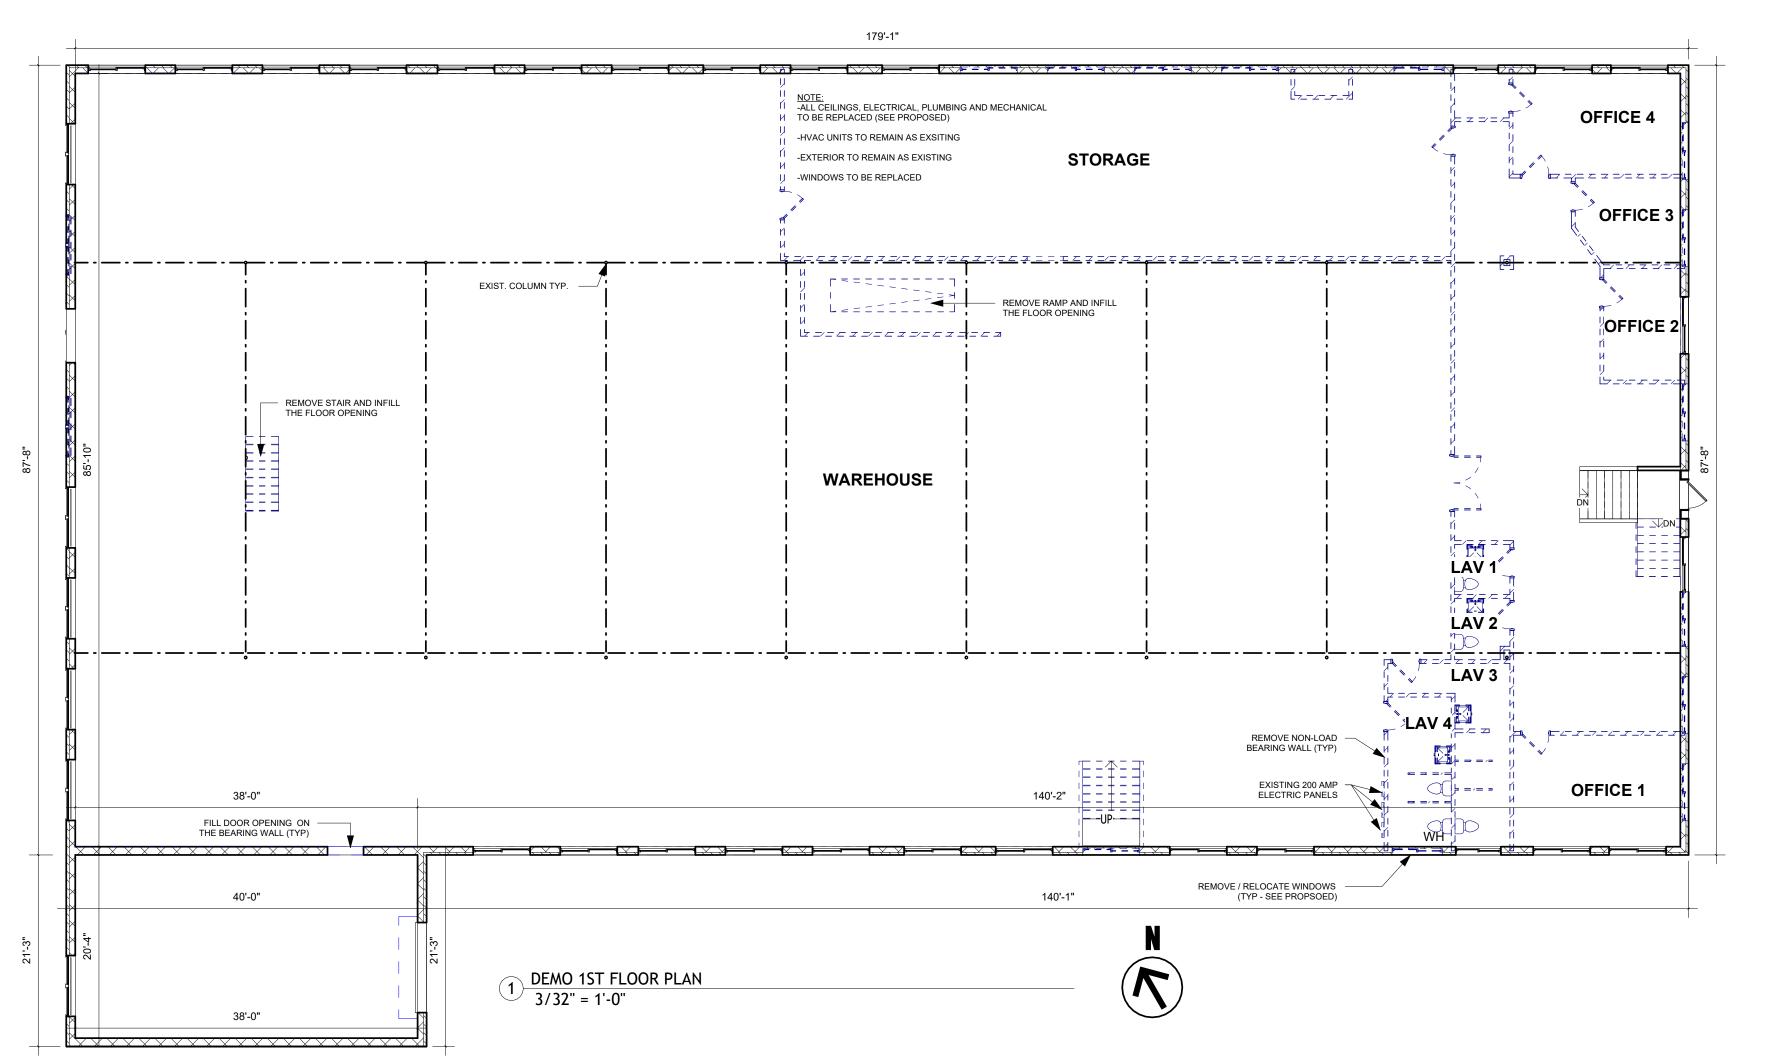

GHULAM M. KAMAL, S.E., P.E. Lucid engineering services group, l.

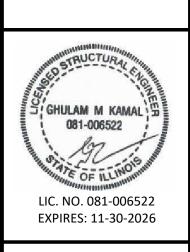


JLTI-DWELLING UNIT BUILD-C IN EXISTING COMMERCIAL BUILDING
18240 Harwood Aveue

			ISSUE	
Drawn:	A.D.S.	No.	Description	Date
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Date:	01-08-2025		ZONING REVISION 1	12-05-2024
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DEMOLITION PLAN

Sheet No.

A101



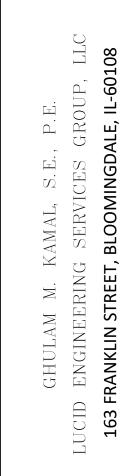


Homewood, IL 60		
	01-08-2025	ING REVISION 2
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	10-24-2024	MIT TO ZONING
MULTI-DWELLING UNITION IN EXISTING COM	Date	<u>ISSUE</u> <u>Description</u>

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	0202-00-10			12.00.21
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Sheet Description:
PROPOSED FLOOR
PLANS

Sheet No.

A102.1



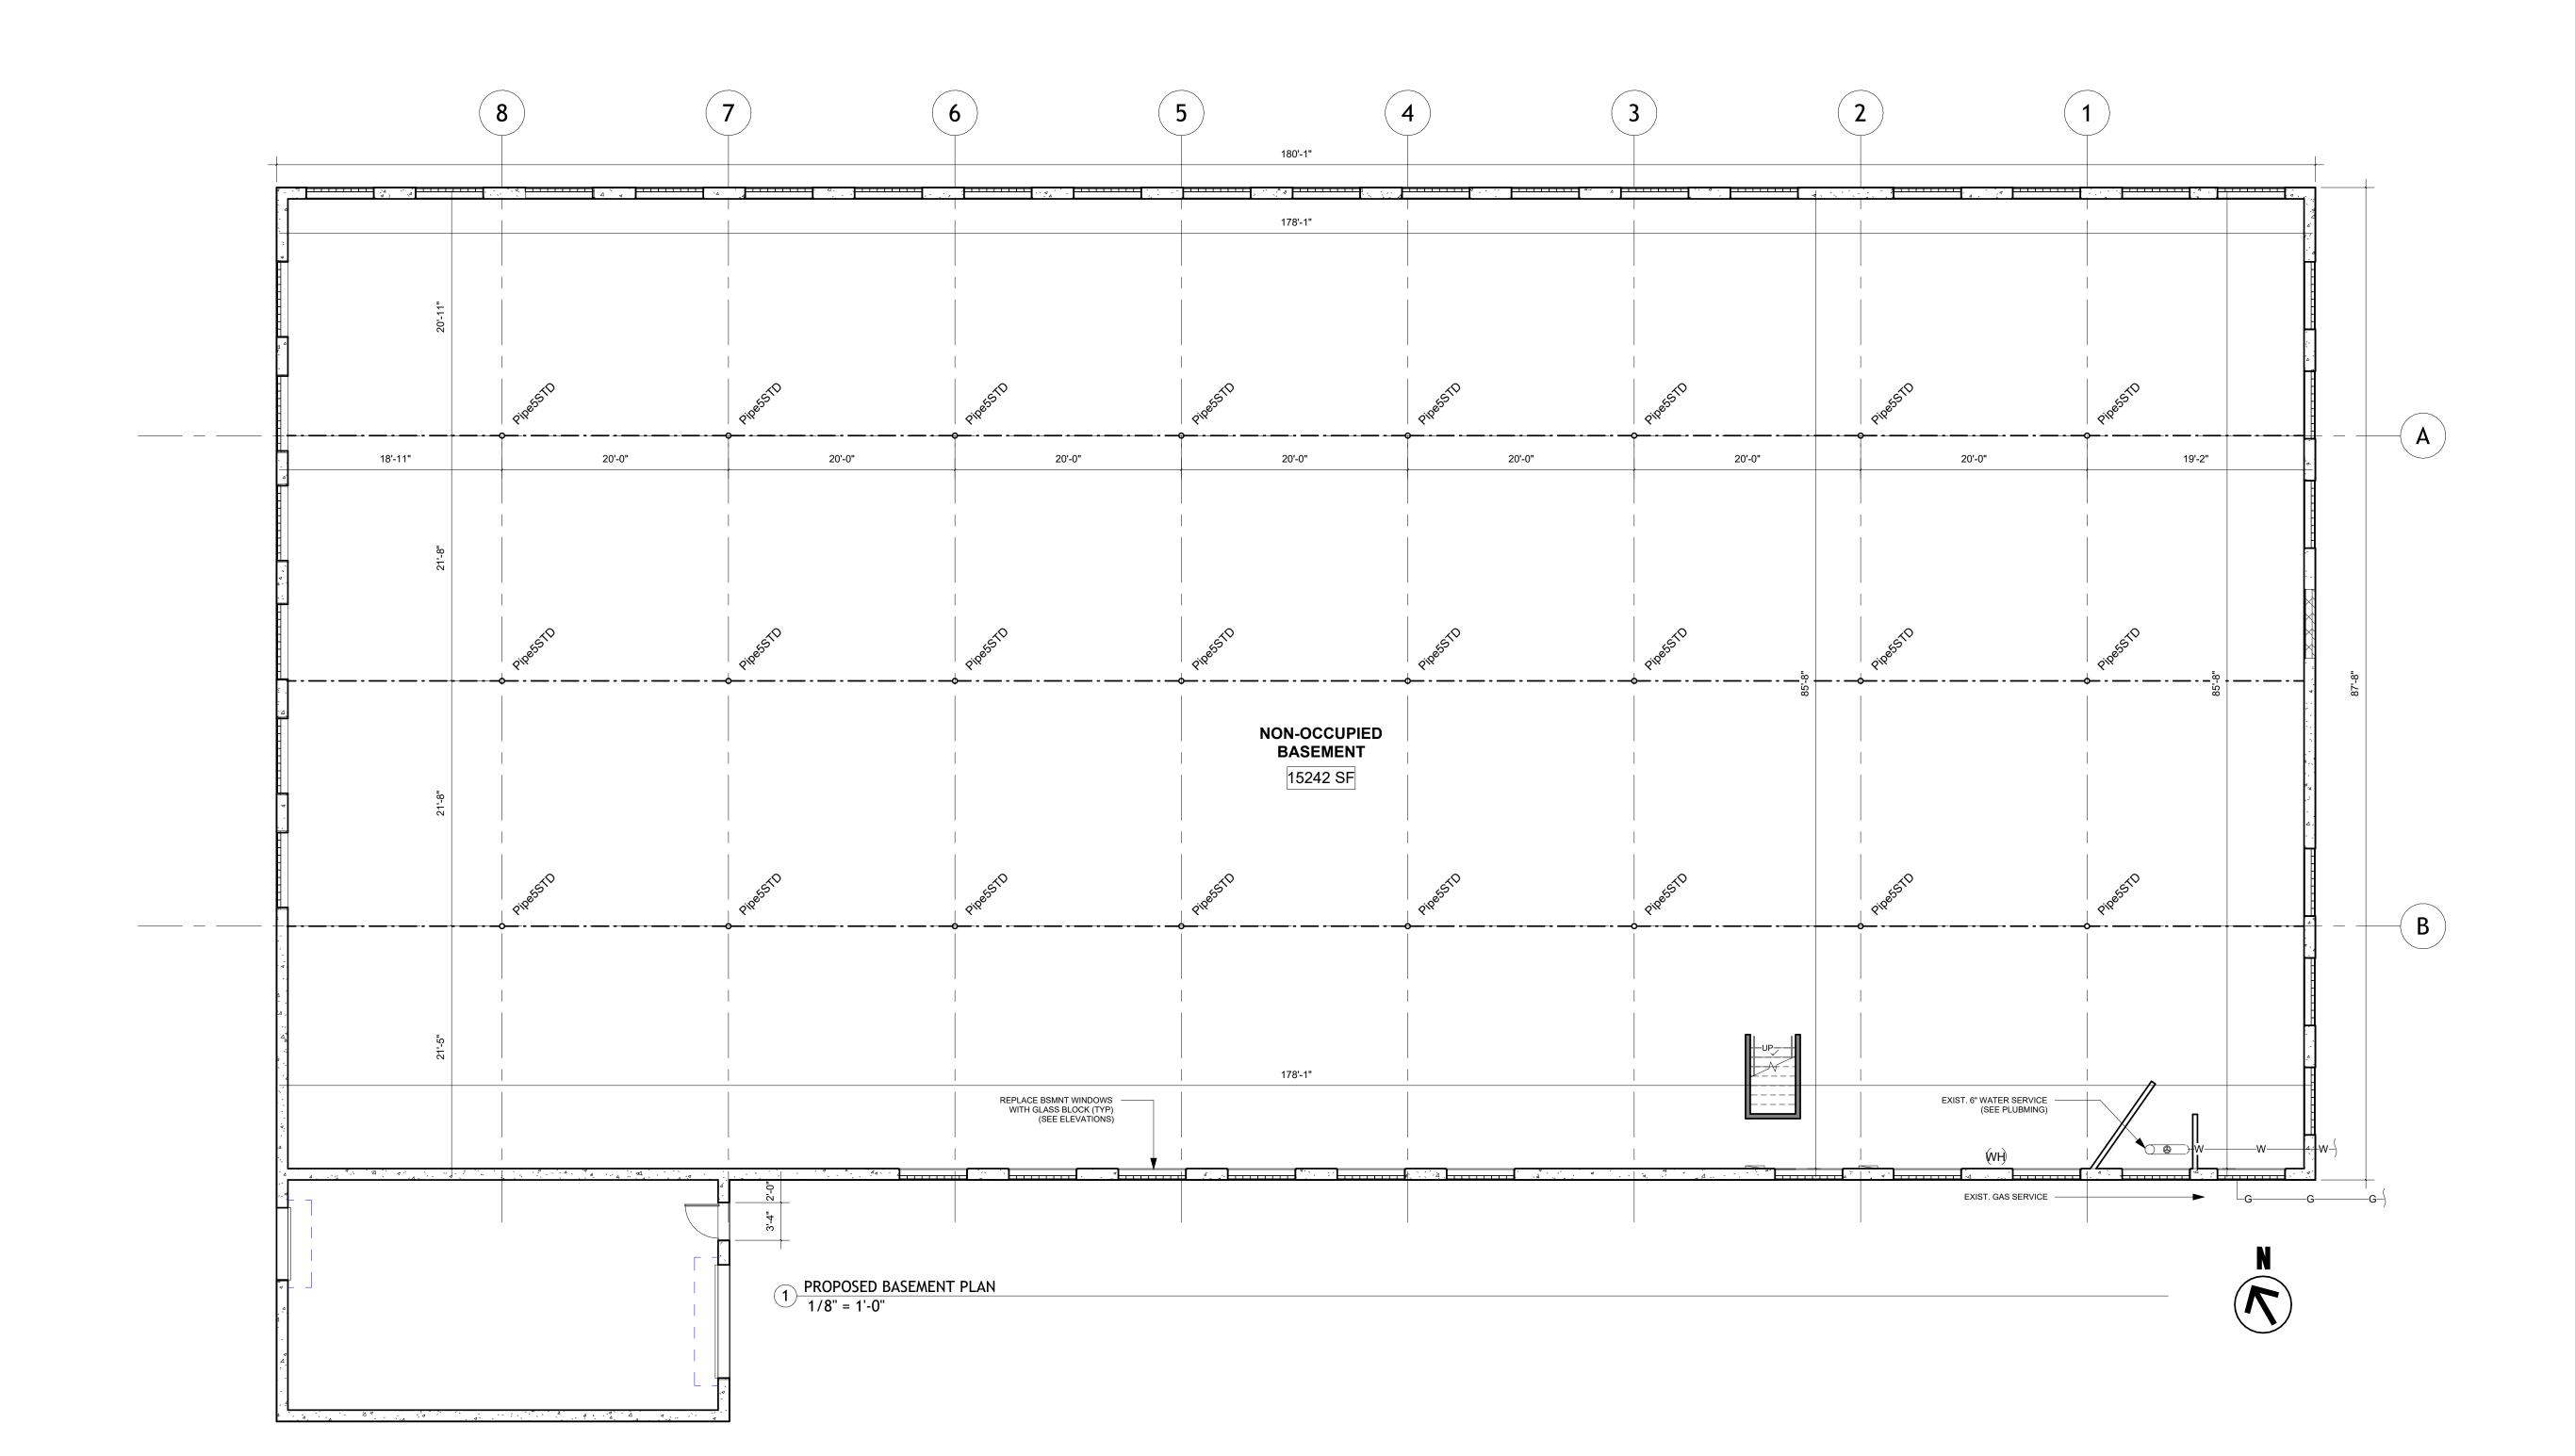

GHULAM M KAMAL

081-006522

LIC. NO. 081-006522


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12-05-2024	ZONING REVISION 1		01-08-2025	Date:
10-24-2024	SUBMIT TO ZONING		G.M.K.	Checked:
Date	Description	No.	A.D.S.	Drawn:
	ISSUE		#24-0084	oject No.:

Sheet Description:
PROPOSED FLOOR
PLANS


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A102.2





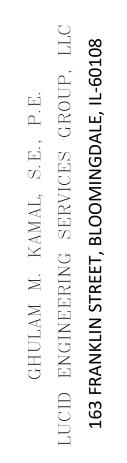

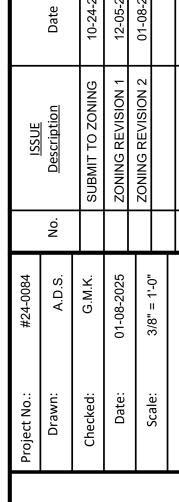


UNIT FLOOR

Sheet No.

10'-7" 10'-7" **BED 2** 116 SF **BED 1** 139 SF MECH 44 SF **BATH** 53 SF W/D 21'-7" (UNIT 11) KITCHEN / LIVING RM 396 SF

2 UNIT #11 (TYP) 3/8" = 1'-0"

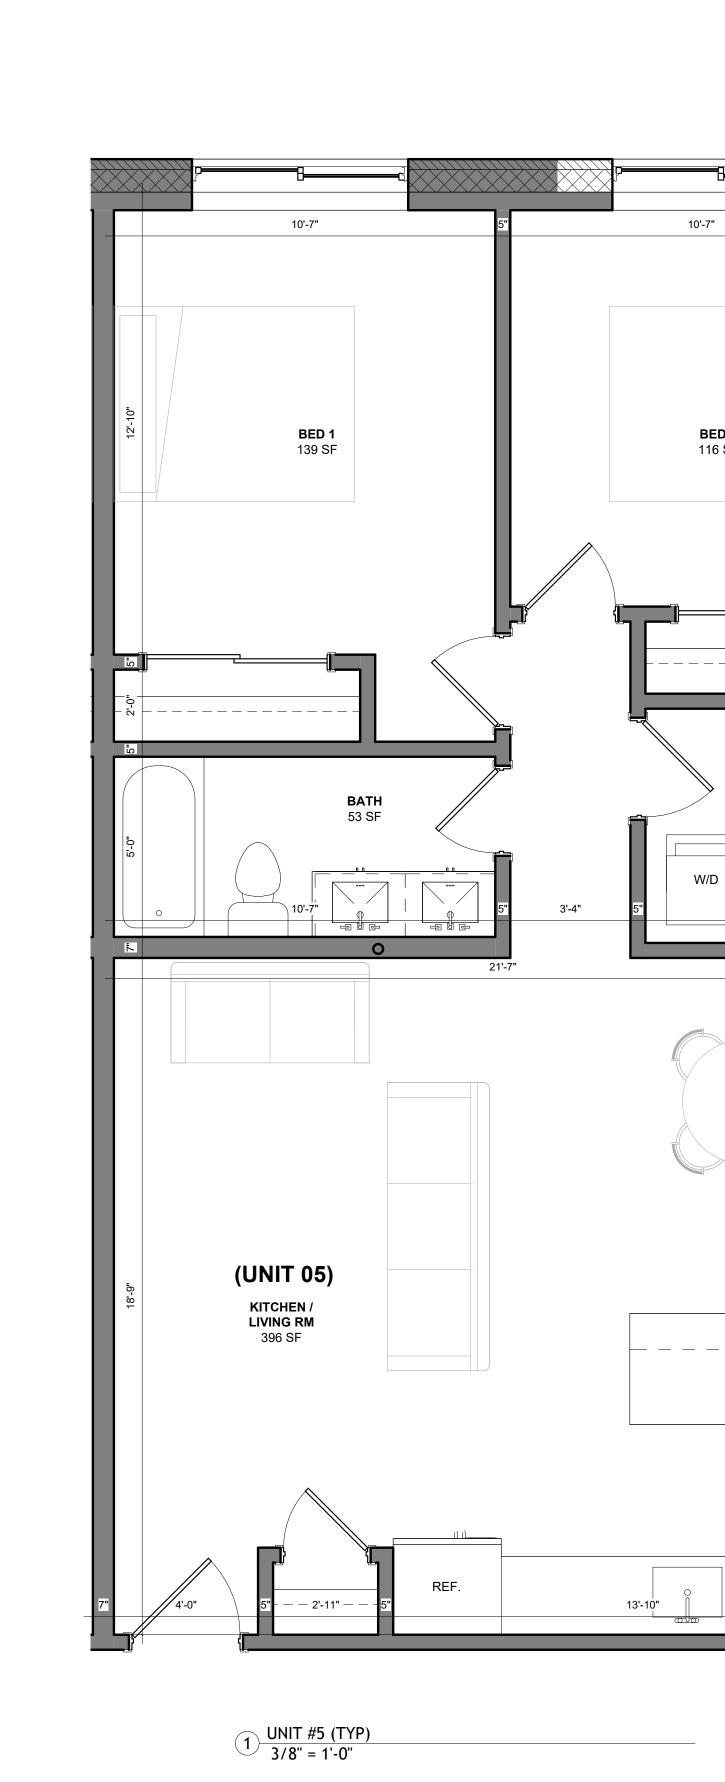


BED 2 116 SF

MECH 44 SF

W/D

FUR

WH

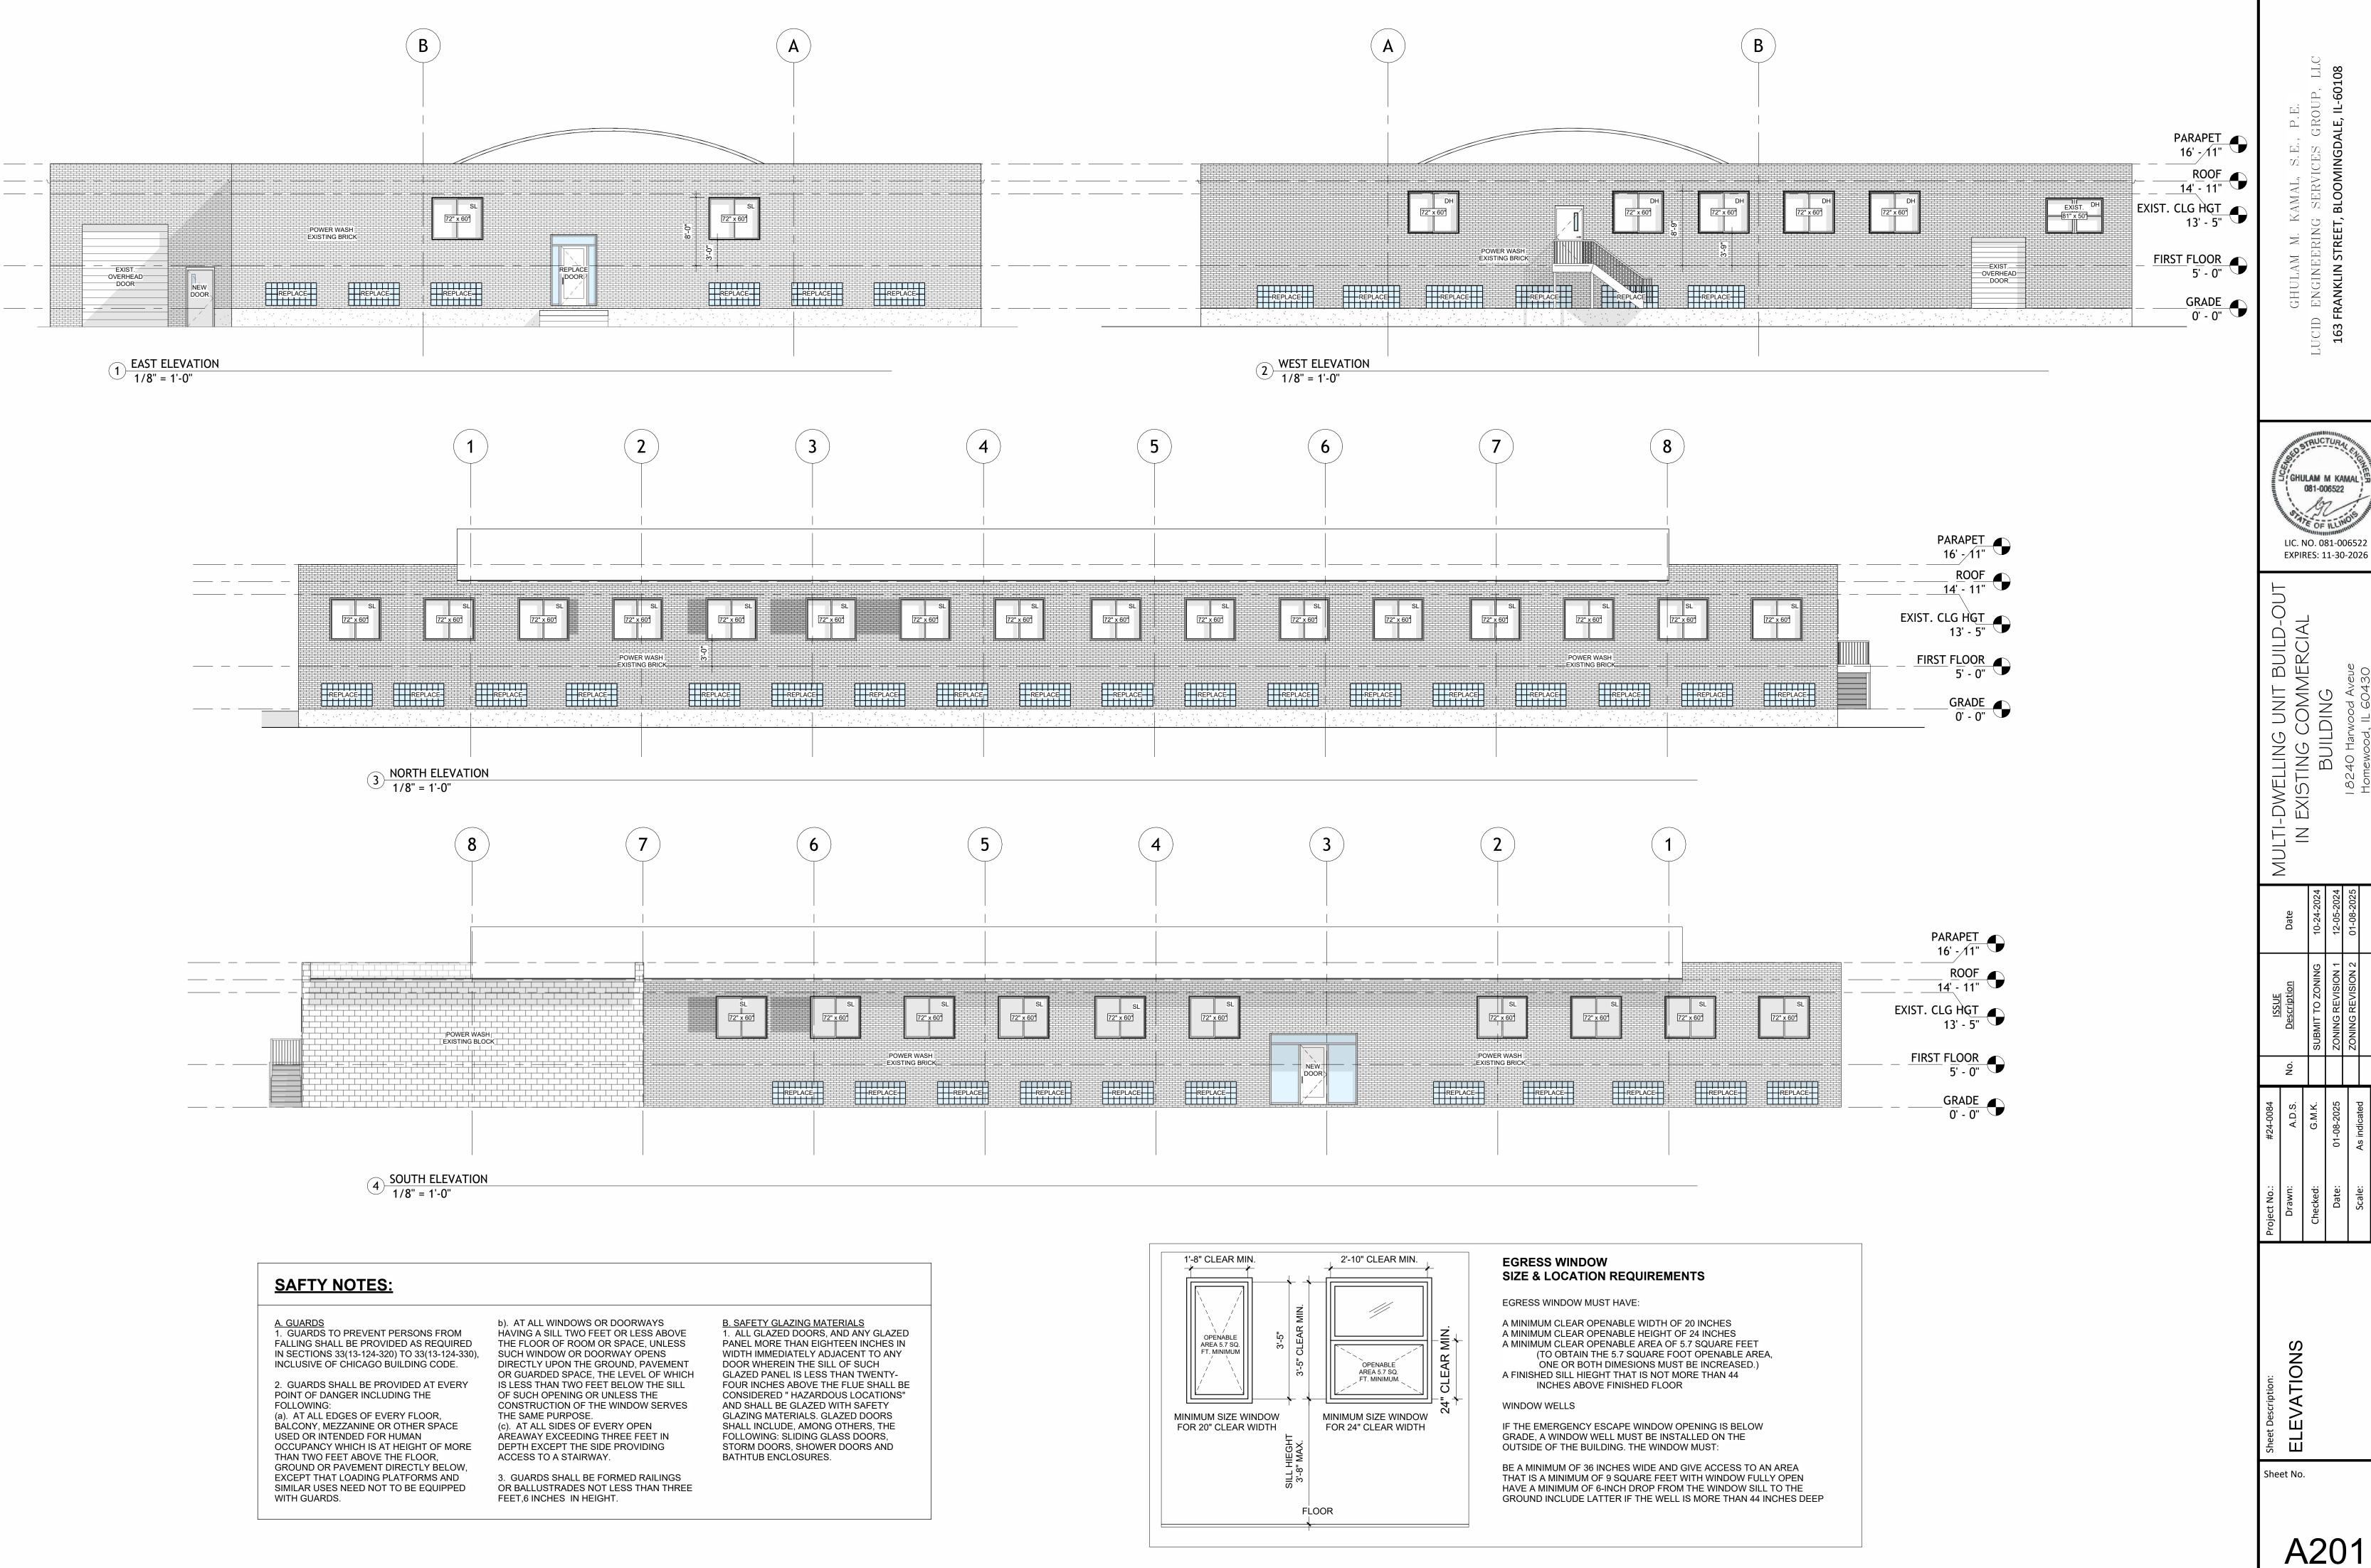

A201

1. PLANTS SHALL MEET THE STANDARDS OF "AMERICAN STANDARD FOR NURSERY STOCK", ANSI Z60.1 - LATEST EDITION, AMERICAN ASSOCIATION OF NURSERYMEN.

2. PLANTS SHALL MEET ALL REQUIREMENTS OF FEDERAL, STATE, AND LOCAL LAW WITH RESPECT TO PLANT TYPE, LABELING, NURSERY OR PLAN INSPECTION, DISEASE, INSECT, AND OTHER PEST INFESTATION, AND ANY OTHER REQUIREMENTS.

3. PLANTS SHALL BE HIGH QUALITY NURSERY-GROWN STOCK.

4. SUBSTANDARD 'B-GRADE" OR "PARK GRADE" PLANTS ARE NOT ACCEPTABLE.

5. FIELD-COLLECTED PLANTS ARE NOT ACCEPTABLE, EVEN IF THEY HAVE BEEN SUBSEQUENTLY PLANTED IN THE GROUND IN A NURSERY OR PLANTED IN A CONTAINER.

6. PLANTS SHALL HAVE BEEN GROWN IN A CLIMATE ZONE SIMILAR TO HOMEWOOD, I.E. UNITED STATES DEPARTMENT OF AGRICULTURE ZONE 4 OR 5. PLANTS FOR ZONE 6B OR MORE, I.E., WARMER CLIMATE ZONES, ARE NOT ACCEPTABLE. 7. PLANTS SHALL BE IN A HEAL THY, VIGOROUS CONDITION, FREE OF DEAD OR BROKEN BRANCHES,

SCARS THAT ARE NOT COMPLETELY HEALED, FROST CRACKS, DISFIGURING KNOTS, BROKEN OR ABRADED BARK, REDUNDANT LEADERS OF BRANCHES, RUBBING BRANCHES, OR ABERRATIONS OF ANY KIND. PLANTS SHALL NOT HAVE MULTIPLE LEADERS, UNLESS THIS IS THE NATURAL FORM, MULTI-STEM TREES ARE NOT ACCEPTABLE FOR REQUIRED PLANTING IN PARKWAYS. 8. PLANTS SHALL HAVE FULL, EVEN, WELL DEVELOPED BRANCHING AND A DENSE, FIBROUS, AND

9. BALLED-AND-BURLAPPED PLANTS SHALL BE HANDLED ONLY BY THE ROOTBALL, NOT BY THE TRUNK OR BRANCHES, AS THIS MAY BREAK OR LOOSEN THE ROOTBALL AND DAMAGES THE ROOT SYSTEM. 10. BARE-ROOT SHRUBS AND GROUNDCOVER PLANTS ARE ACCEPTABLE, IF THEY ARE DUG AND INSTALLED AT THE APPROPRIATE SEASON AND HANDLED IN THE APPROPRIATE MANNER.

11. BARE-ROOT TREES ARE NOT ACCEPTABLE. 12. PLANTS SHALL BE PROTECTED FROM DRYING-OUT DURING SHIPPING WITH TARPAULINS OR OTHER COVERINGS.

13. PLANTS SHALL BE PROTECTED FROM DRYING-OUT AFTER DELIVERY BY PLANTING IMMEDIATELY; IF THIS IS NOT POSSIBLE, "THE ROOTBALL SHALL BE COVERED WITH PEAT MOSS OR EARTH, AND WATERED FREQUENTLY TO KEEP IT MOIST UNTIL PLANTING.

14. DO NOT HANDLE, MOVE, BIND, TIE OR OTHERWISE TREAT PLANTS SO AS TO DAMAGE THE

ROOTBALL, ROOTS, TRUNK, OF BRANCHES IN ANYWAY. 15. ALL WORK TO FOLLOW ANSI A300 - 2.133.1 STANDARDS, AS WELL AS INTERNATIONAL SOCIETY OFARBORICULTURE BEST MANAGEMENT PRACTICES.

		PLANT LIST			
CODE	BOTANICAL NAME	COMMON NAME	SIZE	ROOT	TOTAL
SOD	LOLIUM PERENNE	PERENNIAL RYEGRASS	VARIES	N/A	V.I.F.
BLK	N/A	BLACK MULCH	VARIES	N/A	V.I.F.
CL	CALAMAGROSTIS	GRASS - KARL FOERSTER	36" HGT	3 GAL.	6
HS	HIBISCUS SYRIACUS	PILLAR ROSE-OF-SHARON	36" HGT	3 GAL.	2
ВА	BAPTISIA	BAPTISIA - LEMON MERINGUE	36" HGT	3 GAL.	8
WT	ILEX VERTICILLATA	COMMON WINTERBERRY	36" HGT	3 GAL.	6
TE	THUJA OCCIDENTALIS	TECHNY ARBORVITAE	2.5" CAL.	В&В	30
AF	ACER X FREEMANII	AUTUMN BLAZE MAPLE	2.5" CAL.	В&В	9

LANDSCAPE ANA (FOR EXISTING COMMERCIAL BU	
VEHICULAR USE AREA	11,479 SF
REQUIRED LANDSCAPED AREA	N/A
ACTUAL LANDSCAPED AREA	V.I.F.
REQUIRED INTERIOR TREES	0
ACTUAL INTERIOR TREES (NEW)	39
REQUIRED SHRUBS	N/A
ACTUAL SHRUBS	22

6'-0"





CALAMAGROSTIS - CL

ILEX VERTICILLATA - WT



BAPTISIA - BA

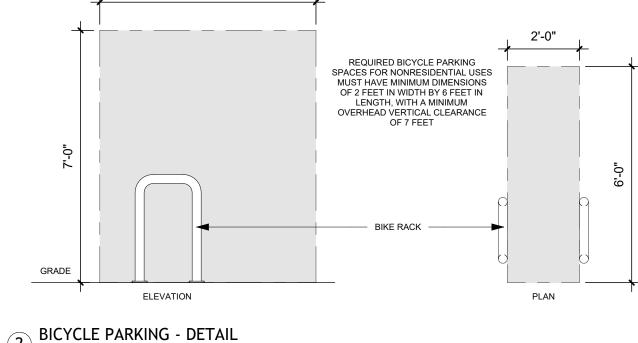

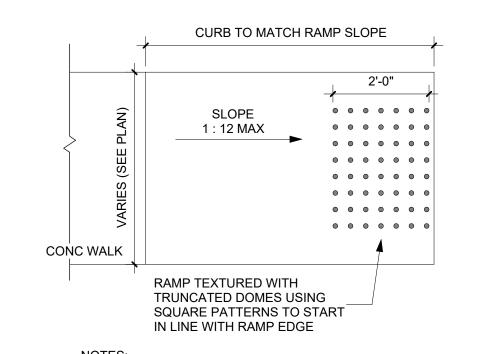

1. ALL CURB CUTS TO HAVE TRUNCATED DOMES


2. USE SQUARE PATTERN ONLY 3. TRUNCATED DOMES TO START IN LINE WITH THE 6" WIDE CURB AND EDGE 4. MIN WIDTH OF RAMP TO BE 4'-0"

6. SLOPE OF FLARED SIDES TO BE 1:10 MAX 7. TRUNCATED DOMES TO BE STEEL 3 ACCESSIBLE RAMP - DETAIL 1/2" = 1'-0"

5. SLOPE OF RAMP TO BE 1:12 MAX





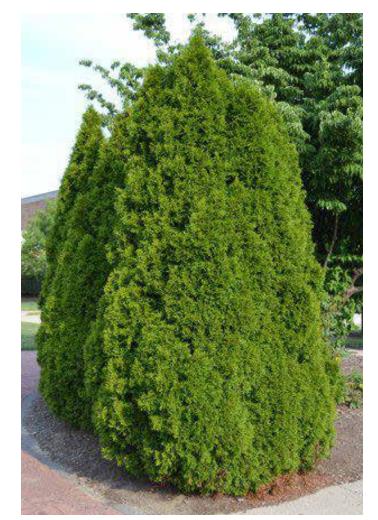


THUJA OCCIDENTALIS

LNDSCP.-1 GENERAL CONSTRUCTION NOTES: 1. ALL ALTERATIONS MUST BE APPROVED BY THE VILLAGE ENGINEER THROUGH VILLAGE FORESTER. CONTRACTORS MUST VERIFY ALL QUANTITIES AND OBTAIN ALL PROPER PERMITS AND LICENSES FROM THE PROPER AUTHORITIES. ALL LANDSCAPE IMPROVEMENTS SHALL MEET MUNICIPALITY REQUIREMENTS AND GUIDELINES, WHICH SHALL BE VERIFIED BY MUNICIPAL AUTHORITIES. ALL MATERIAL MUST MEET INDUSTRY STANDARDS AND THE LANDSCAPE ARCHITECT HAS THE RIGHT TO REFUSE ANY POOR MATERIAL OR WORKMANSHIP. 5. LANDSCAPE ARCHITECT IS NOT RESPONSIBLE FOR UNSEEN SITE CONDITIONS. ALL PLANTINGS SHALL BE SPACED EQUAL DISTANCE, BACKFILLED WITH PARENT MATERAIL IN A HOLE TWICE THE ROOTBALL DIAMETER, WATERED IF CALLED FOR, PRUNED, AND HAVE ALL ROPES REMOVED. 7. TREES SHALL MEET THE STANDARDS SET BY THE VILLAGE, AND HAVE A WATERING SAUCER AT BASE. 8. ALL BEDS TO BE BERMED 12" TO 24" ABOVE GRADE AND MEET DRAINAGE REQUIREMENTS. LAWN AND BED AREAS SHALL BE ROTOTILLED UP TO ANY AND ALL PRE-EXISTING DRIP-LINES, RAKED OF CLUMPS AND DEBRIS. 10. SOD SHALL BE ROLLED AND STAKED ON SLOPES. 11. ALL BEDS SHALL BE EDGED, HAVE WEED PREEMERGENTS APPLIED AT THE RECOMMENDED RATE, AND SHREDDED HARDWOOD MULCH SPREAD AT A MINIMUM OF 3" DEEP. IRRIGATION SYSTEM SHALL BE SET AS PER THE LOCAL AUTHORITIES WATER SCHEDULE. AIMED AWAY FROM TREES AND SHRUBS. SOIL DRAINAGE MUST BE EXAMINED FOR PERCOLATION RATES. 13. ALL DEBRIS SHALL BE REMOVED FROM THE SITE. ALL PARKWAYS AND PARKING LOT ISLANDS SHALL HAVE SOD AS A GROUNDCOVER, UNLESS OTHERWISE NOTED. ALL EXISTING TREES OF HIGH QUALITY, LOCATED OUTSIDE OF THE CONSTRUCTION ZONE, SHALL BE SAVED AND PROTECTED THROUGH TREE PRESERVATION ZONES UNLESS CO-DOMIONATE SUBORDINATION IS REQUIRED. DO NOT CUT LEADER ON ANY TREES. -PRUNE 1/3 OF INNER CROWN, MAINTAINING NATURAL SHAPE. ONLY IF SPECIFIED BY VILLAGE ENGINEER SET ROOTFLARE APPROXIMATELY AT-ESCAVATED MATERIAL. CORDS AROUND ROOTBALL AND TRUNK AND REMOVE. SET ROOTBALL ON UNDISTURBED SUBGRADE TREE PLANTING DETAIL **EVERGREEN TREE** PLANTING DETAIL HOMEWOOD STANDARD

GENERAL CONSTRUCTION NOTES: 1. ALL ALTERATIONS MUST BE APPROVED BY THE VILLAGE ENGINEER THROUGH VILLAGE FORESTER. CONTRACTORS MUST VERIFY ALL QUANTITIES AND OBTAIN ALL PROPER PERMITS AND LICENSES FROM THE PROPER AUTHORITIES. 3. ALL LANDSCAPE IMPROVEMENTS SHALL MEET MUNICIPALITY REQUIREMENTS AND GUIDELINES, WHICH SHALL BE VERIFIED BY MUNICIPAL AUTHORITIES. ALL MATERIAL MUST MEET INDUSTRY STANDARDS AND THE LANDSCAPE ARCHITECT HAS THE RIGHT TO REFUSE ANY POOR MATERIAL OR WORKMANSHIP. 5. LANDSCAPE ARCHITECT IS NOT RESPONSIBLE FOR UNSEEN SITE CONDITIONS. ALL PLANTINGS SHALL BE SPACED EQUAL DISTANCE, BACKFILLED WITH PARENT MATERIAL IN A HOLE TWICE THE ROOTBALL DIAMETER, WATERED IF CALLED FOR, PRUNED, AND HAVE ALL ROPES REMOVED. 7. TREES SHALL MEET THE STANDARDS SET BY THE VILLAGE, AND HAVE A WATERING SAUCER AT BASE. 8. ALL BEDS TO BE BERMED 12" TO 24" ABOVE GRADE AND MEET DRAINAGE REQUIREMENTS. LAWN AND BED AREAS SHALL BE ROTOTILLED UP TO ANY AND ALL PRE-EXISTING DRIP-LINES, RAKED OF CLUMPS AND DEBRIS. 10. SOD SHALL BE ROLLED AND STAKED ON SLOPES. ALL BEDS SHALL BE EDGED, HAVE WEED PREEMERGENTS APPLIED AT THE RECOMMENDED RATE, AND SHREDDED HARDWOOD MULCH SPREAD AT A MINIMUM OF 3" DEEP. 12. IRRIGATION SYSTEM SHALL BE SET AS PER THE LOCAL AUTHORITIES WATER SCHEDULE, AIMED AWAY FROM TREES AND SHRUBS. SOIL DRAINAGE MUST BE EXAMINED FOR PERCOLATION RATES. 13. ALL DEBRIS SHALL BE REMOVED FROM THE SITE. 14. ALL PARKWAYS AND PARKING LOT ISLANDS SHALL HAVE SOD AS A GROUNDCOVER, UNLESS OTHERWISE NOTED. 15. ALL EXISTING TREES OF HIGH QUALITY, LOCATED OUTSIDE OF THE CONSTRUCTION ZONE, SHALL BE SAVED AND PROTECTED THROUGH TREE PRESERVATION ZONES INLESS CO-DOMINATE SUBORDINATION IS REQUIRED. ROOT MASS WILL BE MANUALL AGITATED IN ORDER TO BREAK-UP GIRDLING ROOTS UNDISTURBED SUBGRADE IN I BACKFILL PIT WITH PLANTING PIT BACKSOIL. CUT AND REMOVE ANY CORDS AROUND ROOTBALL AND TRUNK. SET ROOTBALL ON UNDISTURBED SUBGRADE. SHRUB PLANTING DETAIL 2" DEEP MULCH. WORK MULCH UNDER BRANCHES UNDISTURBED SUBGRADE ANNUAL, PERENNIAL, AND GROUNDCOVER DETAIL HOMEWOOD STANDARD FEBRUARY, 2008

LNDSCP.-

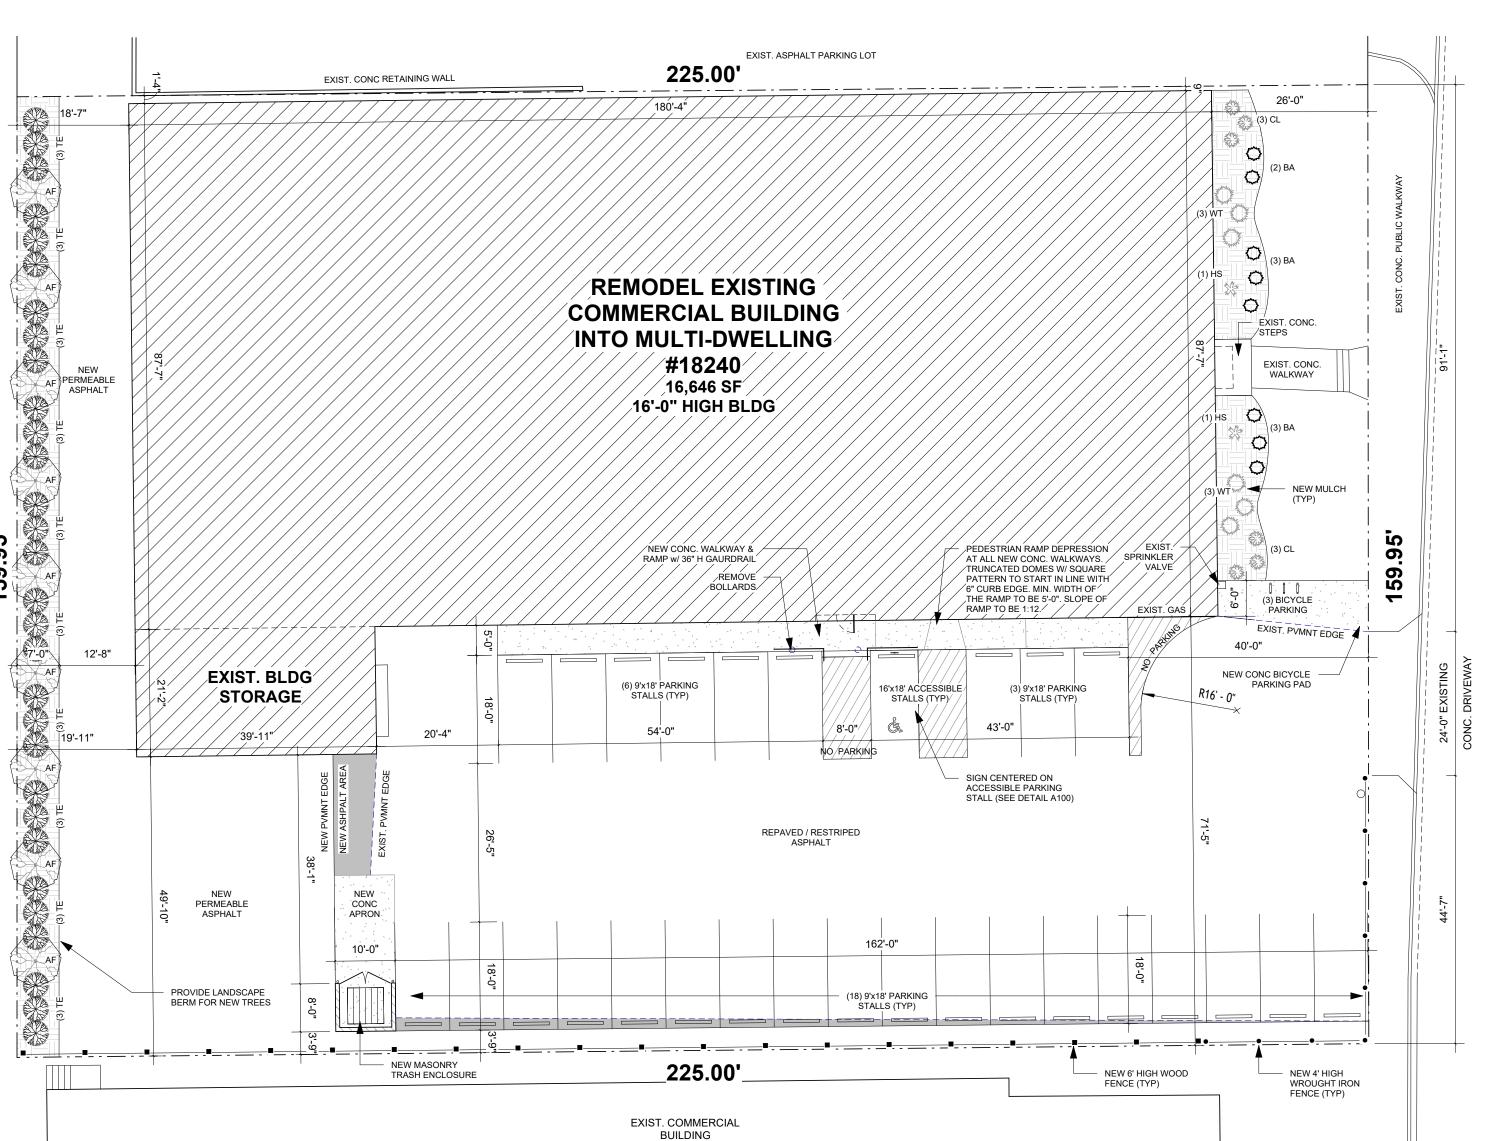

FEBRUARY, 2008

4 HARWOOD

			As Indicated	scale:
0	ZONING REVISION 2			.0/00
1	ZONING REVISION 1		01-08-2025	Date:
1	SUBMIT TO ZONING		G.M.K.	Checked:
	<u>Description</u>	No.	A.D.S.	Drawn:
	ISSUE		#24-0084	Project No.:

081-006522

LIC. NO. 081-006522

EXPIRES: 11-30-2026

BUILI MERCI

Sheet No.

L101

BLACK MULCH - BLK ACER X FREEMANII 1 SITE PLAN
1/16" = 1'-0"

081-006522

LIC. NO. 081-006522 EXPIRES: 11-30-2026

Date	10-24-2024	12-05-2024	01-08-2025		
Description	SUBMIT TO ZONING	ZONING REVISION 1	ZONING REVISION 2		
No.					
.S.	1.K.	025	7 (+	lled	

ISSUE	Description		SUBMIT TO ZONING	ZONING REVISION 1	ZONING REVISION 2		
	No.						
#24-0004	A.D.S.	G.M.K.		01-08-2025	L 0400 [L 04]	As mulcated	
riojett NO	Drawn:		Checked:	Date:	.0 00)	orale.	

Sheet No.

L201

PLT

CLASSIC LED WALL PACK

- PRODUCT FEATURES

 Up to 82% energy saving compared to traditional fixtures. Heavy-duty die cast aluminum housing.
- Architectural bronze finish, anti-corrosion spray.
- Borosilicate glass lens for long life durability, no fading, high light transmittance.
- IP65 rated, waterproofing material is used throughout the fixture. DLC 5.1 Premium***
- Dusk to dawn photocell options.
- 4000K/5000K CCT selectable; -40 Deg. to 113 Deg. F operating temperature. • 100%/80%/60% wattage selectable. 5 Years warranty.


e i	ECTRICAL	SDECIEICATIONS	

ļ	ELECTRICA	L SPE	CIFICA	ATIONS	S		,	*Optiona	**See	Selectable Tabl	ial Order. Call 1- e on Page 5 for or full list of DLC	full breakdown.									
	Catalog Number	Photocell	Wattage	Lumens**	Dimming	сст	Efficacy**	CRI	Housing Color	Input Voltage	LED L70 Life Hours	Wattage Equivalent									
		Yes	0414//			4000K			Bronze												
	PLT-12999 PLT-13000		21W/ 28W/ 35W	Up to 4800 lm	0-10V		Up to 149 lm/W	>80	Black*	120-277V	100,000 hrs	175W MH									
		No	3344			5000K			White*												
		Yes				4000K			Bronze												
	PLT-12997 PLT-12998		30W/ 40W/	Up to 6900 lm	0-10V		Up to 149 lm/W	>80	Black*	120-277V	100,000 hrs	250W MH									
	7 21-12000	1 21-12000	No	50W	5000	50W			5000K			White*									
	Yes	95 45W/	60W/		// 10.500 lm		4000K			Bronze											
	PLT-12995 PLT-12996			60W/			0-10V		Up to 146 lm/W	>80	Black*	120-277V	100,000 hrs	250W MH							
			10,500 lm	2.201	5000K		UVV	White*													
		PLT-13002 No 80W/													4000K			Bronze			
	PLT-13002		Up to	Up to 14,000 lm				0-10V		Up to	>80	Black*	120-277V	100,000 hrs	400W MH						
			100W			5000K			White*												
					4000K			Bronze													
	PLT-13001	No	72W/ 96W/	Up to 16,800 lm	0-10V	4000K	Up to 147 lm/W	>80	Black*	120-277V	100,000 hrs	400W MH									




CLASSIC LED WALL PACK

DIMENSIONS

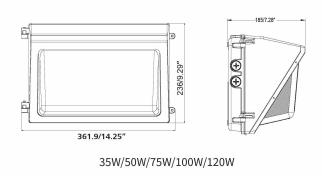

PHOTOMETRICS

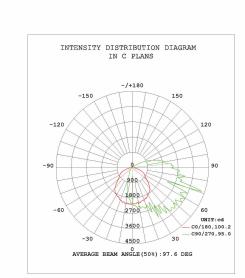

PITCH SINGLE WALL SCONCE

TECH LIGHTING

output in this modern	e reminiscent of beautifully classic ro LED wall sconce suitable for both indo -cast metal body houses powerful LEI es down along a wall.	oor and outdoor applications.	
High quality LM80-te for consistent long-life	ested LEDs e performance and color		
Marine-grade power Stainless Steel mo Impact-resistant, L	unting hardware JV stabilized frosted acrylic lensing		
SPECIFICATIONS	up lighting or down lighting		
DELIVERED LUMENS	823		
WATTS	26.1		11 369
VOLTAGE	120V, 277V		
DIMMING	ELV		
LIGHT DISTRIBUTION	Symmetric		
MOUNTING OPTIONS	Downlight or Uplight	PITCH SINGLE	PITCH SINGLE
ССТ	2700K, 3000K	shown in black	shown in bronze
CRI	80+		
COLOR BINNING	3 Step		
BUG RATING	B1-U0-G0		
DARK SKY	Compliant (Downlight)		
WET LISTED	IP65		
GENERAL LISTING	ETL	DITOLLORIOLE	DITOLIONOLE
CALIFORNIA TITLE 24	Can be used to comply with CEC 2016 Title 24 Part 6 for outdoor use. Registration with CEC Appliance Database not required.	PITCH SINGLE shown in charcoal	PITCH SINGLE shown in silver
START TEMP	-30°C		
FIELD SERVICEABLE LED	No		
CONSTRUCTION	Aluminum		
HARDWARE	Stainless Steel		
FINISH	Marine Grade Powder Coat		
LED LIFETIME	L70; 70,000 Hours		
WARRANTY*	5 Years		

700WSPIT	SIZE	FINISH	LAMP	
	S SINGLE	B BLACK Z BRONZE H CHARCOAL I SILVER	-LED827 LED 80 CRI, 2700K 120V -LED82727 LED 80 CRI, 2700K 277V -LED830 LED 80 CRI, 3000K 120V -LED830277 LED 80 CRI, 3000K 277V	

PITCH SINGLE w	ALL SCONCE	TECH LIGHTING.
1 5° 1 133° 1 122 mm		
PHOTOMETRICS*		*For latest photometrics, please visit www. techlighting.com/OUTDOOR
PITCH SINGLE Total Lumen Output: 823 Total Power: 26.2 Luminaire Efficacy: 31.4 Color Temp: 3000K CRI: 80+ BUG Rating: B1-U0-G0 320 188° 170° 160° 159° 140° 120° 107 107 108 109 107 107 109 107 107 108 107 107 107 108 107 107 107 108 109 107 107 107 108 107 107 108 109 109 109 109 109 109 109 109 109 109		
PROJECT INFO		
FIXTURE TYPE & QUANTITY	JOB NAME & INFO	NOTES

techlighting.com

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ТҮР	DESCRIPTION	LAMP	TEMPERATURE	LUMENS	MOUNTING HEIGHT	COUNT		
A1	PITCH SINGLE WALL SCONCE - LED827277	26 W	3000 K	823	8-10'	4		
A2	LED WALL PACK - PTL-13000	35 W	4000 K	4800	7'	9		
SEE A	SEE ATTACHED CUT SHEETS FOR FIXTURE DETAILS							

