
PROJECT: KMV-BS-23-102 - BOCA HIGHLANDS - OSP

ADDRESS: 4801 S OCEAN BLVD, HIGHLAND BEACH, FL 33487 -


CITY OF HIGHLAND BEACH PERMIT

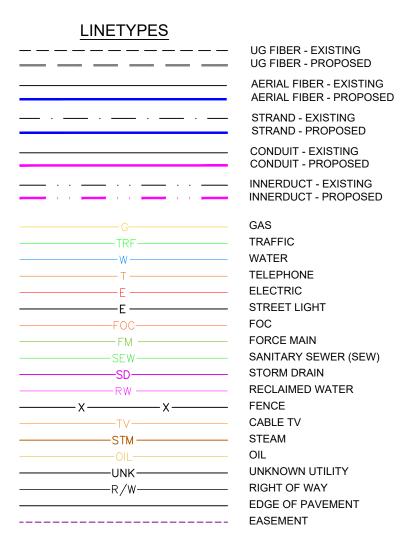



SITE LOCATION

SUMMARY DATA				
JOB DESCRIPTION	FTG			
DIRECTIONAL BORE	535'			
HANDHOLE	3			

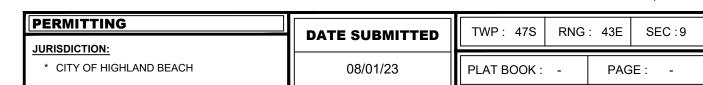



CONTACTS

BLUE STREAM

JONATHAN LARA

DESIGN ENGINEER

PHONE: 954-753-0100

JLARA@BLUESTREAMFIBER.COM

EXPERT DRILL LLC

MARIO SAGASTUME

CONTRACTOR

PHONE: 703-929-2256

MARIO.S@EXPERTDRILLFL.COM

KMV FIBERTELECOM INC

SANDRA KARINA VARGAS

10604 NW 48TH ST

CORAL SPRINGS FL 33076

PHONE: 954-937-5239

KARINAV@KMVFIBERTELECOM.COM

SITE INDEX

01 - COVER SHEET/SITE LOCATION

02 - OVERALL MAP

03 - CONSTRUCTION NOTES

04 - 04B - PLAN VIEWS & PROFILES

05 - TYPICAL


Know what's below.

06 - 08 - MOTS

3				AS-BUILT			
2	080223	KMV	AC	REVISION # 1			
1	080123	KMV	GQ	ORIGINAL			
NO.	NO. DATE ENG DESIGN DRAFTING COMMENT						



CHECKED BY:	GIULIANO LEON	
ENGINEERING FI	RM: KMV FIBERTELECO	OM INC
PROJECT NUMBE	R: KMV-BS-23-102	
LOCATION: 4801	S OCEAN BLVD	
HIGH	LAND BEACH, FL 33487	•
DRAWING NAME:	KMV-BS-23-102 - BOCA HIGHL	ANDS, HIGHLAND BEACH.dwg
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NO.	NO. DATE ENG DESIGN DRAFTING COMMENT					

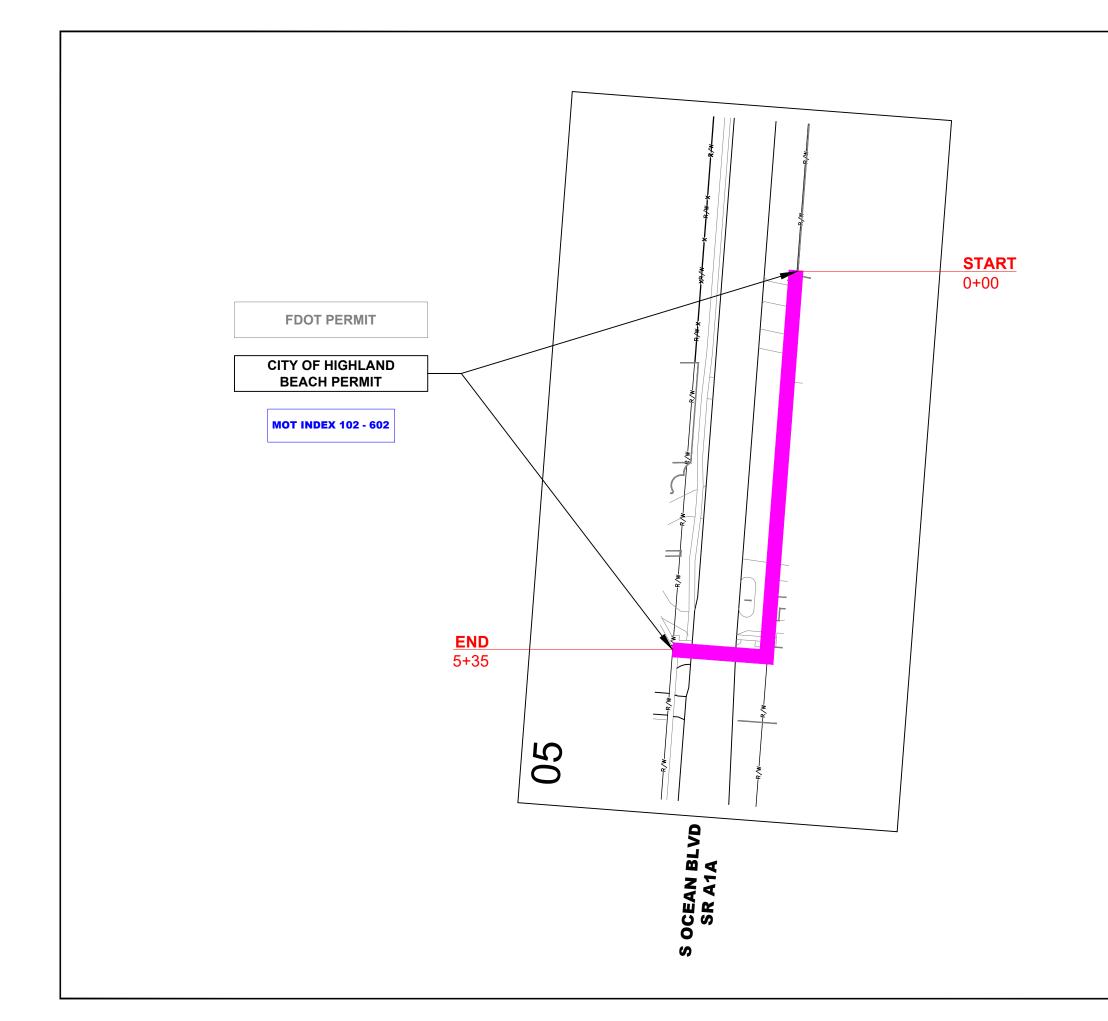

CHECKED BY:	GIULIANO LEON
ENGINEERING FIRM	I: KMV FIBERTELECOM INC
PROJECT NUMBER:	KMV-BS-23-102

LOCATION: 4801 S OCEAN BLVD
HIGHLAND BEACH, FL 33487
DRAWING NAME: KMV-BS-23-102-BOCA HIGHLANDS, HIGHLAND BEACH.dwg

SHEET: 02 OF 08

CONSTRUCTION NOTES

TYPICAL UNDERGROUND CONSTRUCTION:

- RESTORE ALL SURFACES TO EQUAL OR BETTER CONDITION.
- CONTRACTOR TO VERIFY ALL MEASUREMENTS AND DISTANCES PRIOR TO CONSTRUCTION.
- CONTRACTOR TO VERIFY LOCATION AND CONDITION OF EXISTING CONDUIT PRIOR TO CONSTRUCTION.
- CONTRACTOR SHALL VERIFY ALL PLANS, EXISTING DIMENSIONS AND CONDITIONS ON THE JOB SITE AND IMMEDIATELY NOTIFY THE ENGINEER IN WRITING OF ANY DISCREPANCIES BEFORE PROCEEDING WITH THE WORK.
- MAINTAIN MINIMUM 24" VERTICAL AND HORIZONTAL SEPARATION BETWEEN PROPOSED BY BLUE STREAM DUCTS & EXISTING UTILITIES.
- MAINTAIN A MIN BENDING RADIUS OF 5' ON ALL DUCT CONFIGURATION.
- ANY CHANGES ON PROPOSED RUNNING LINE HAVE TO GET APPROVAL FROM BLUE STREAM CONSTRUCTION MANAGER.

FOR CONSTRUCTION:

- EXTREME CAUTION TO BE TAKEN TO CONTAIN SLURRY AROUND WORK AREAS NEAR WETLANDS TO AVOID ANY WATER QUALITY ISSUES!
- LOCATIONS, ELEVATIONS LOCATIONS, ELEVATIONS AND DIMENSIONS OF EXISTING UTILITIES, STRUCTURES AND OTHER SITE FEATURES SHOWN ON THE DRAWINGS ARE BASED ON LIMITED INVESTIGATION TECHNIQUES AND SHOULD BE CONSIDERED APPROXIMATE ONLY. PLEASE CONTACT SUNSHINE STATE ONE-CALL AT 1-800-432-4770
- CAUTION: EXISTING UNDERGROUND UTILITIES IN AREA. NO ELEVATION RECORDS FOR EXISTING UTILITIES AVAILABLE. CONTRACTOR SHOULD CONTACT SUNSHINE 811, LOCATE ALL UTILITIES AND VERIFY ALL DEPTHS PRIOR TO CONSTRUCTION

DESIGN TICKET #212308223

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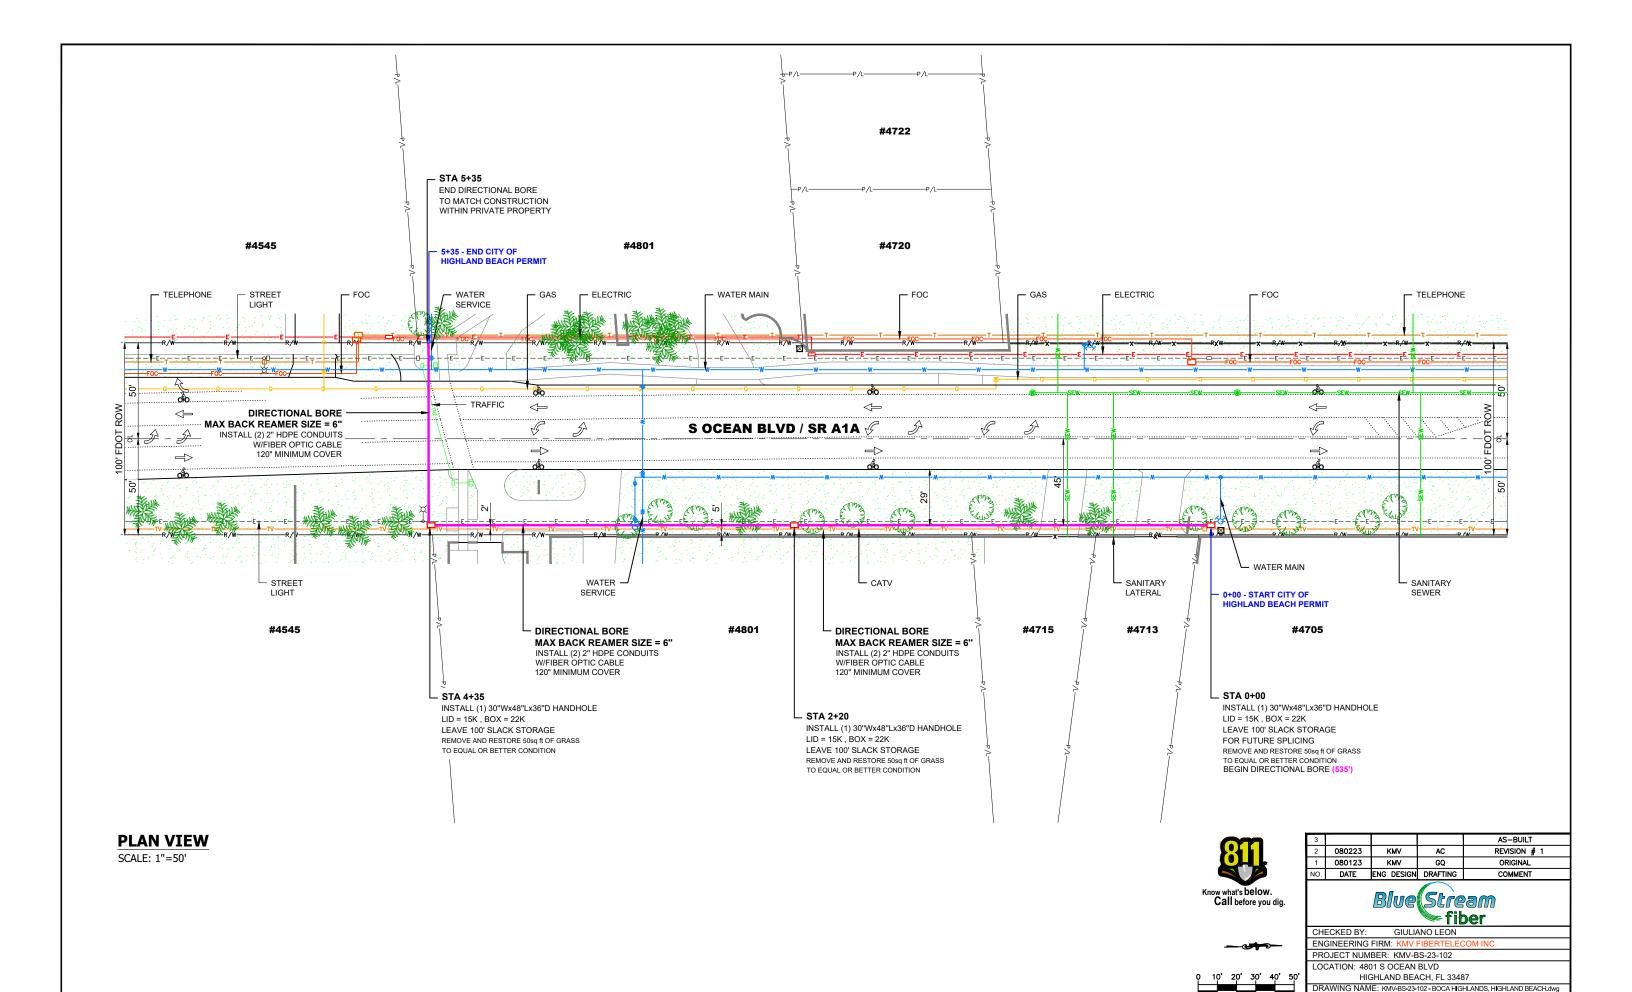
CHECKED BY: GIULIANO LEON

ENGINEERING FIRM: KMV FIBERTELECOM INC

PROJECT NUMBER: KMV-BS-23-102 LOCATION: 4801 S OCEAN BLVD HIGHLAND BEACH, FL 33487


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CONFIDENTIAL/PROPRIETARY SHEET: 03 OF 08



SCALE: 1"=50'

SHEET: 04 OF 08

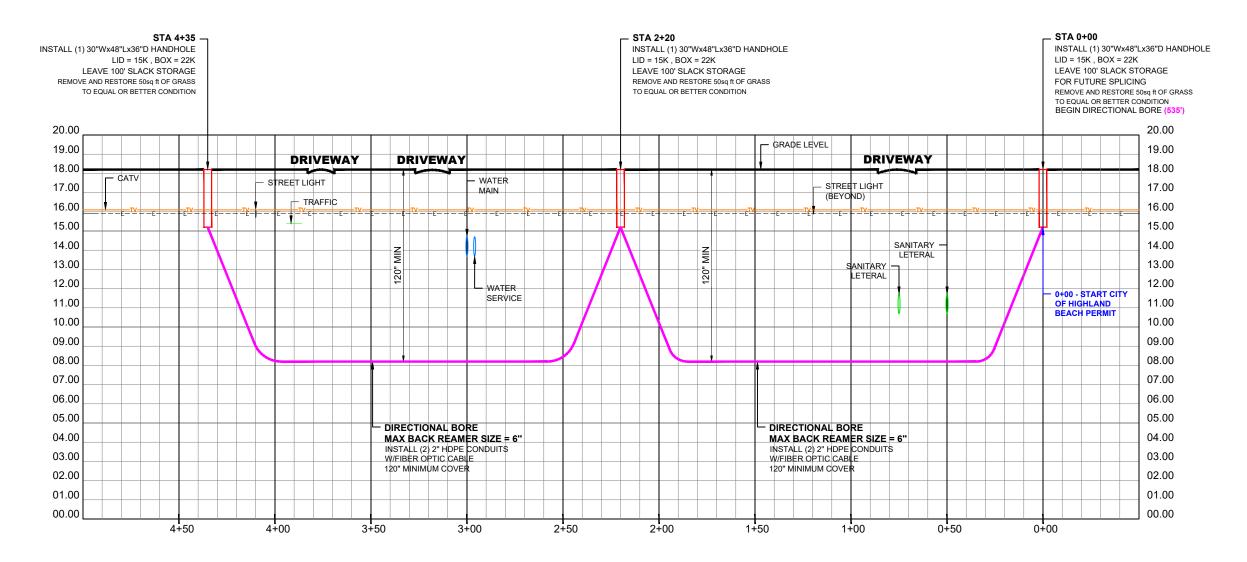

PROFILE - S OCEAN BLVD / SR A1A (LOOKING WEST)

HORIZONTAL SCALE: 1"=50' VERTICAL SCALE: 1"=5'

> RECORD ON UTILITY PLANS CONSTRUCTION CONTRACTOR SHALL CALL LOCATES AND SOFT DIG TO DETERMINE UTILITY ELEVATION BEFORE CONSTRUCTION.




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NO.	NO. DATE ENG DESIGN DRAFTING COMMENT					

CHECKED BY: GIULIANO LEON ENGINEERING FIRM: KN

PROJECT NUMBER: KMV-BS-23-102 LOCATION: 4801 S OCEAN BLVD

HIGHLAND BEACH, FL 33487 DRAWING NAME: KMV-BS-23-102 - BOCA HIGHLANDS, HIGHLAND BEACH.dwg

SHEET: 04A OF 08

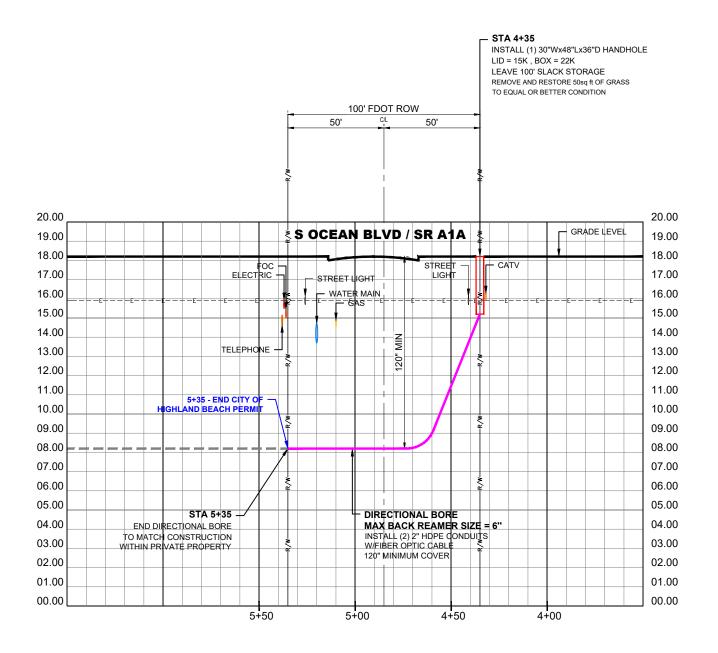

CROSS SECTION - S OCEAN BLVD / SR A1A (LOOKING NORTH)

HORIZONTAL SCALE: 1"=50' VERTICAL SCALE: 1"=5'

RECORD ON UTILITY PLANS
CONSTRUCTION CONTRACTOR
SHALL CALL LOCATES AND SOFT DIG TO DETERMINE
UTILITY ELEVATION BEFORE CONSTRUCTION.



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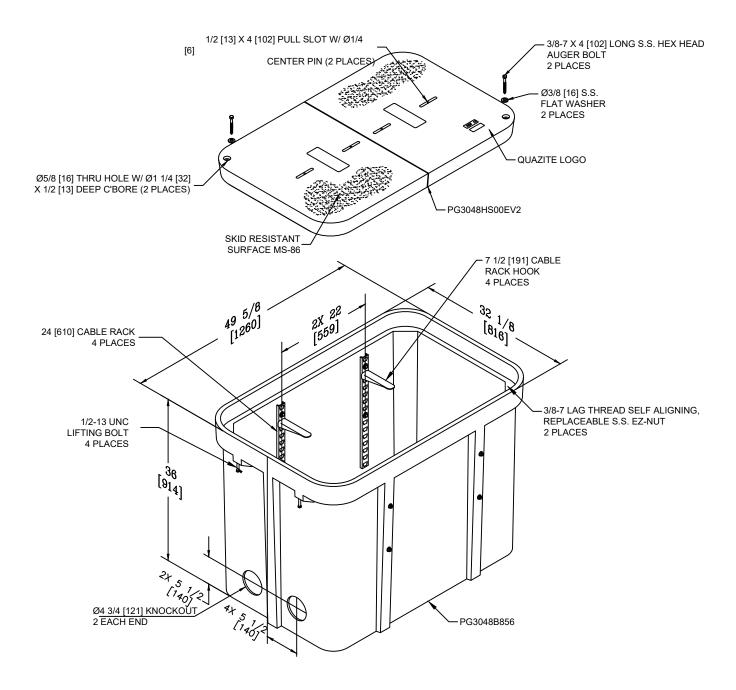
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PROJECT NUMBER: KMV-BS-23-102 LOCATION: 4801 S OCEAN BLVD HIGHLAND BEACH, FL 33487

DRAWING NAME: KMV-BS-23-102 - BOCA HIGHLANDS, HIGHLAND BEACH.dwg

ONFIDENTIAL/PROPRIETARY SHEET: 04B OF 08

TYPICAL



TYPICAL DETAIL - # 2

QUAZITE 30X48X36 ASSEMBLY
W/(4) 24" CABLE RACKS
& (4) 7 1/2" HOOKS
PG3048Z987EV2

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HIGHLAND BEACH, FL 33487
DRAWING NAME: KMV-BS-23-102 - BOCA HIGHLANDS, HIGHLAND BEACH.dwg

ONFIDENTIAL/PROPRIETARY SHEET: 05 OF 08

1	General Notes, TTC Tables			
	Definitions			
	Temporary Traffic Control Devices			
2	Overhead Work			
	Railroads			
	Sight Distance			
	Above Ground Hazard			
	Clear Zone Widths For Work Zones			
	Superelevation			
	Length Of Lane Closures			
3	Overweight/Oversize Vehicles			
	Lane Widths			
	High-Visibility Safety Apparel			
	Speed Reduction Signing			
	Flagger Control			
4	Survey Work Zones			
	Signs			
5	Work Zone Sign Supports			
6	Commonly Used Warning and Regulatory Signs In Work Zones			
	Manholes/Crosswalks/Joints			
	Truck Mounted Attenuators			
7	Signals			
,	Channelizing Devices			
	Channelizing Devices Consistency			
	Advanced Warning Arrow Boards			
8	Drop-Offs In Work Zones			
	Business Entrance			
9	Temporary Asphalt Separator			
10	Channelizing Devices Notes			
10	Temporary Barrier Notes			
11	Pavement Markings			

GENERAL NOTES:

- 1. This Index contains information specific to the Federal and State guidelines and standards for the preparation of traffic control plans and for the execution of traffic control in work zones, for construction and maintenance operations and utility work on highways, roads and streets on the State Highway System. Certain requirements in this Index are based on the high volume nature of State Highways. For highways, roads and streets off the State Highway System, the local agency (City/County) having jurisdiction may adopt requirements based on the minimum requirements provided in the MUTCD.
- 2. Use this Index in accordance with the Plans and Indexes 102-601 through 102-680. Indexes 102-601 through 102-680 are Department-specific typical applications of commonly encountered situations. Adjust device location or number thereof as recommended by the Worksite Traffic Supervisor and approved by the Engineer. Devices include, but are not limited to, flaggers, portable temporary signals, signs, pavement markings, and channelizing devices. Comply with MUTCD or applicable Department criteria for any changes and document the reason for the change.
- 3. Except for emergencies, any road closure on State Highway System must comply with Section 335.15, F.S.

		TABLE	= 1	
CHA	NNELIZ	ING DE	VICE SP	ACING
Mante		Max.	Spacing (fee	t)
Work Zone Speed (mph)	Cones or Temporary Tubular Markers		Type I Barricades Type II Barricades Vertical Panels, or Dr	
V,	Taper	Tangent	Taper	Tangent
≤ 45	25	50	25	50
≥ 50	25	50	50	100

TAB	LE 2
TAPER LE	NGTH "L"
Work Zone Speed (mph)	Min. Length (feet)
≤ 40	$L = \frac{WS^2}{60}$
≥ 45	L = W5
	idth of offset n feet need in mph

TABL	.E 3		
WORK ZONE SIG	GN SPACING "X"		
Road Type	Min. Spacing (feet)		
Arterials and Collectors with Work Zone Speed ≤ 40 mph	200		
Arterials and Collectors with Work Zone Speed ≥ 45 mph	500		
Limited Access Roadways *	1,500		
* For Limited access roadway mph, the minimum spacing m with the MUTCD and as app	ay be reduced in accordance		

TABLE 4 BUFFER LENGTH "B"			
Work Zone Speed (mph)	Min. Length (feet)		
25	155		
30	200		
35	250		
40	305		
45	360		
50	425		
55	495		
60	570		
65	645		
70	730		
Note: When But	fer Length "B"		

Note: When Buffer Length "B" cannot be attained due to geometric constraints, use the greatest length possible, but not less than 155 feet.

DESCRIPTION: REVISION 11/01/20

FDOT

FY 2023-24 STANDARD PLANS GENERAL INFORMATION FOR TRAFFIC CONTROL THROUGH WORK ZONES

INDEX 102-600

SHEET 1 of 11

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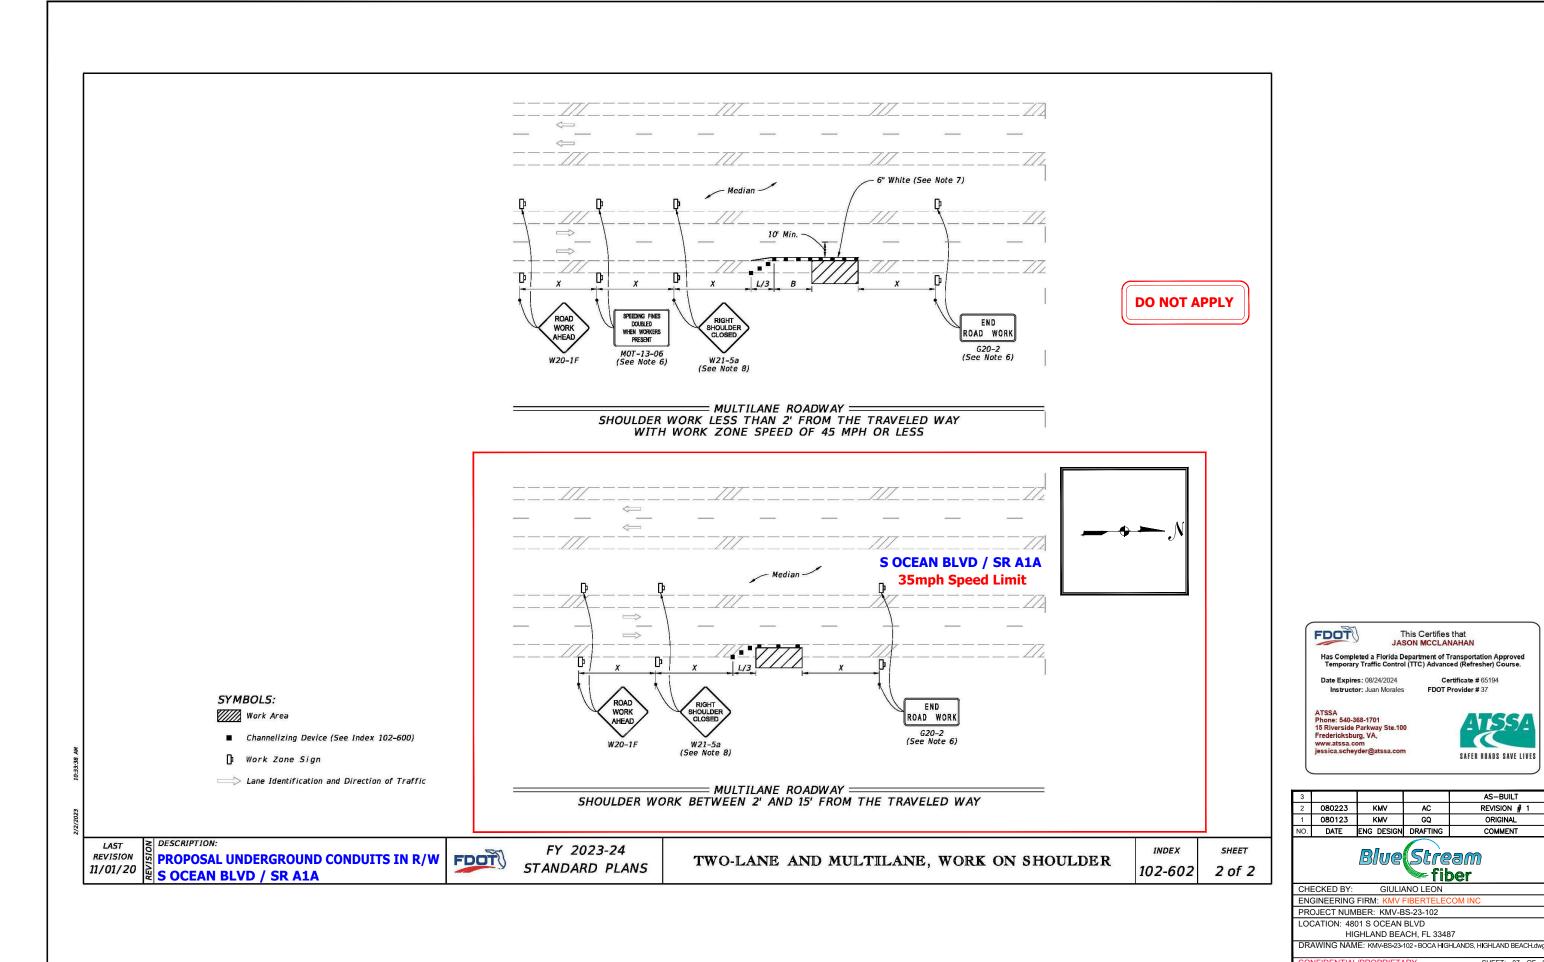


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DRAWING NAME: KMV-BS-23-102 - BOCA HIGHLANDS, HIGHLAND BEACH.dwg

SHEET: 06 OF 08



This Certifies that JASON MCCLANAHAN

GQ

Certificate # 65194 FDOT Provider # 37

SAFER ROADS SAVE LIVES

AS-BUILT

COMMENT

REVISION # 1

Certificate of Completion

JASON MCCLANAHAN

Has Completed a Florida Department of Transportation Approved Temporary Traffic Control (TTC) Advanced (Refresher) Course.

08/24/2024 37 Juan Morales 65194

Date Expires

FDOT Provider #

Instructor

Certificate #



ATSSA

15 Riverside Parkway Ste.100 Fredericksburg, VA, www.atssa.com jessica.scheyder@atssa.com



www.motadmin.com

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