
MAY 11 2023

HIGHLAND BEACH BUILDING DEPARTMENT



PROJECT ADDRESS: 2362 S. OCEAN BLVD., HIGHLAND BEACH, FL 33487, US

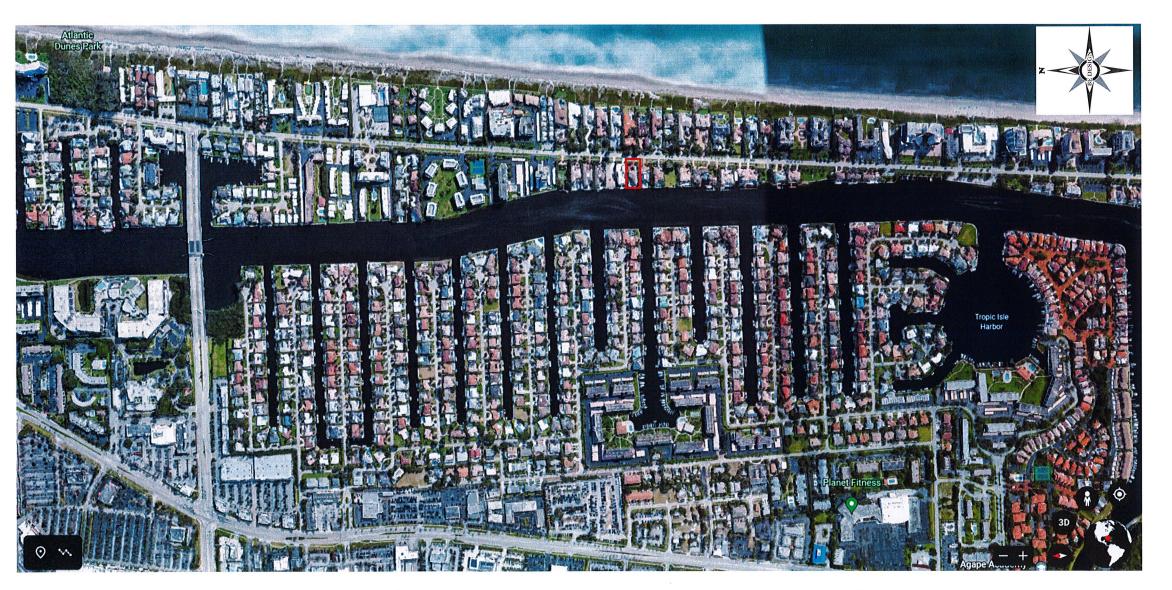

"SUNSHINE STATE ONE CALL" PRIOR TO DIG AT 811 OR (800) 432-4770

FLOOD ZONE INFORMATION

LOOD INFORMATION: COMMUNITY NUMBER: PANEL NUMBER: FIRM DATE:

FIRM EFFECT./REV DATE: FLOOD ZONE:

BASE FLOOD ELEVATION: BENCH MARK INFORMATION: Palm Beach County Benchmark: NAVD Elevation:

1209900987 10-05-2017 10-05-2017

6.00' NAVD 1988

WATERWAY

ASTAL

SCALE: 1" = 10'

"M 310' 5.17

SITE INFORMATION OBTAINED FROM SURVEY: PREPARED BY: KENNETH J. OSBORNE PROFESSIONAL SURVEYOR & MAPPER: #6415 STATE OF FLORIDA - LB #6415

REFER TO PAGE A-08 FOR NOTES & SCHEDULES

REFER TO LANDSCAPE AND CIVIL DRAWINGS (SHEET PD-1) FOR LANDSCAPE, GRADING, PAVING, DRAINAGE INFORMATION AND SEWER CONNECTIONS

SITE REGULATIONS

ZONE: RS-RESIDENTIAL SINGLE FAMILY

FUTURE LAND USE: SINGLE FAMILY

SUMMARY

HORIZONTAL RESTRAINTS	МІМІМИМ	PROVIDED		
FRONT SETBACK:	25'	25.04' min.		
L & R (SIDE) SETBACK:	12'	12.62' & 12.38' mi		
REAR SETBACK:	20'	22.04' min.		
POOL SETBACK (REAR/ L&R SIDES):	10'	10.00' min.		
VERTICAL RESTRAINTS	MAXIMUM	PROVIDED		
MAX. NUMBER OF STORIES:	TWO	Two		
MAX. HEIGHT:	35' 2	31'-83/8"		

SCOPE OF WORK

THE SCOPE OF WORKS CONSISTS OF THE ADDITION AND RENOVATION OF AN EXISTING 2 STORY HOME. THE LEYEL OF ALTERATION IS LEYEL 3 (EXCEEDS 50 PERCENT OF THE BUILDING

EXTERIOR IMPROVEMENTS INCLUDE NEW: DRIVEWAY, PATHWAYS, POOL & POOL DECK, SPA, CMU PERIMETER WALL FENCE, MECHANICAL FENCE, MECHANICAL EQUIPMENT, CONCRETE PADS, LIVING ROOM TERRACE, COVERED ENTERTAINMENT, MAIN ENTRANCE, EXTERIOR

RAILINGS, METAL ROOF, FACADE CLADDING & STUCCO/ PAINT, ADDITION OF NEW BUILDING

INTERIOR IMPROVEMENTS: THE RECONFIGURATION OF SPACES / EXTENSION OF SYSTEMS,

SKETCH OF ADJACENT STRUCTURES

SCALE: 1" = 40

VOLUMES WHICH DO NOT EXCEED EXISTING BUILDING HEIGHT, UTILITY METERS, LANDSCAPE

NSTALLATION OF EQUIPMENT. THE DEMO OF WALLS, APPLIANCES, PLUMBING FIXTURES, LIGHTING STAIRS, CEILINGS, FIREPLACE, DOORS, FLOOR FINISHES, WALL FINISHES, BUILT-INS.

STAIRS, WATER FOUNTAIN, LIGHTING FIXTURES, WINDOWS & DOORS, MODERN GLAS

INO DIOKI HOME APPHION AND RENOVATION PROJECT

CURRENT USE OF PROPERTY: EXISTING RESIDENTIAL EXISTING ZONING: RS RESIDENTIAL SINGLE FAMILY

ADDRESS:

2362 S. OCEAN BLVD HIGHLAND BEACH FI.

LEGAL DESCRIPTION:

LOT 6 PLATING 1 CAMELOT ON THE ATLANTIC ACCORDING TO THE MAP OR PLAT THEREOF AS RECORDED IN PLAT BOOK 39 PAGE 160 PUBLIC LOT 6, PLAT NO, 1, CAMELOT ON THE ATLANTIC, ACCORDING TO THE MAP OR PLAT THEREOF AS RECORDED IN PLAT BOOK 39, PAGE 160, PUBLIC
RECORDS OF PAME BECAM COUNTY, EXORDAL CONTROL THE MAP OR PLAT THEREOF AS RECORDED IN PLAT BOOK 39, PAGE 160, PUBLIC
DESCRIBED AS FOLLOWS, BEGIN AT THE NORTHEAST CORNER OF SAID LOT. THENCE NORTH 69'3300' EAST, ALONG THE EASTERLY PROJECTION
OF THE NORTH BOUNDARY OF SAID LOT, 87.49 FEET TO A POINT ON THE EAST BOUNDARY OF PLAT; THENCE SOUTH (A"0100' WEST, ALONG SAID
EAST BOUNDARY, 80.24 FEET TO THE SOUTHEAST CORNER OF SAID PLAT; THENCE NORTH 2'4"32" WEST, ALONG THE EASTERLY BOUNDARY OF
SAID LOT, 50.00 FEET TO A POINT ON THE ACCORD OF A RADAILLY THANGENT CURVE; THENCE NORTHWESTERLY, ALONG SAID EAST BOUNDARY AND
ALONG THE ARG OF SAID CURVE BEING CONCAVE TO THE NORTHEAST, HAWING A RADILS OF A GOUS FEET, A DELTA OF 117"16"24", AND AN ARC
DISTANCE OF 81.87 FEET TO THE POINT OF BEGINNING OF THE PUBLIC RECORDS OF PAIM BEACH COUNTY, FLORIDA.

ELEVATIONS LISTED HERE ARE FROM THE ARCHITECTURAL PROJECT

FOR EXTERIOR ELEVATIONS (DRAINAGE) FOLLOW THOSE FROM CIVIL ENGINEERS' PLANS.

PROJECT ZERO = 6.60 'NAVD (EXISTING)

7.017' NEW T.O.S. + 0.125 F.F. = 7.142' NAVD


(MIMIMUM DESIGN ELEVATION: BFE 6.0 + 1' FBC FREEBOARD = 7' NAVD)

SITE GRADING


GRADING SHALL BE ACCOMPLISHED IN ACCORDANCE VITH CHAPTER 33 OF THE FLORIDA BUILDING CODE. LL EXCAVATED MATERIAL RESULTING FROM GRADING SHALL BE REMOVED FROM THE SITE BY THE CONTRACTOR EXCEPT SOIL TO BE STOCKPILED FOR REDISTRIBUTION ON SITE AS DIRECTED.


2. LIMIT SITE GRADING TO THE BUILDING PAD AND SURROUNDING BUILDING ENVELOPE. ALL AC PAVING AND CONCRETE SHALL SLOPE AWAY FROM THE BUILDING TO PROVIDE POSITIVE DRAINAGE AWAY FROM THE BUILDING AT A MIN. SLOPE OF 1/8" PER FOOT FOR CONCRETE AND AC AND 1/4" PER FOOT FOR NATURAL



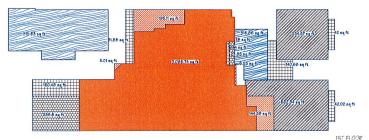

9 ft 12.5 eg ft 12.5 eg ft 8.03 eg ft 8.03 eg ft 16.06 eg ft

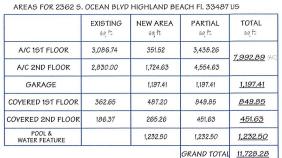


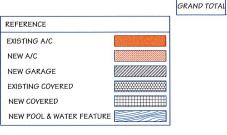

RECEIVED

MAY 11 2023

HIGHLAND BEACH **BUILDING DEPARTMENT**

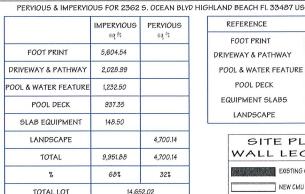



ADDITION AND TION

IN

JOB ID 210512.033.WI

2023.pln SVTING DATE 5/10/2023

DRAWN BY E.B. - R.R.


SITE PLAN


SIDENCE

2



AREAS NOT TO SCALE

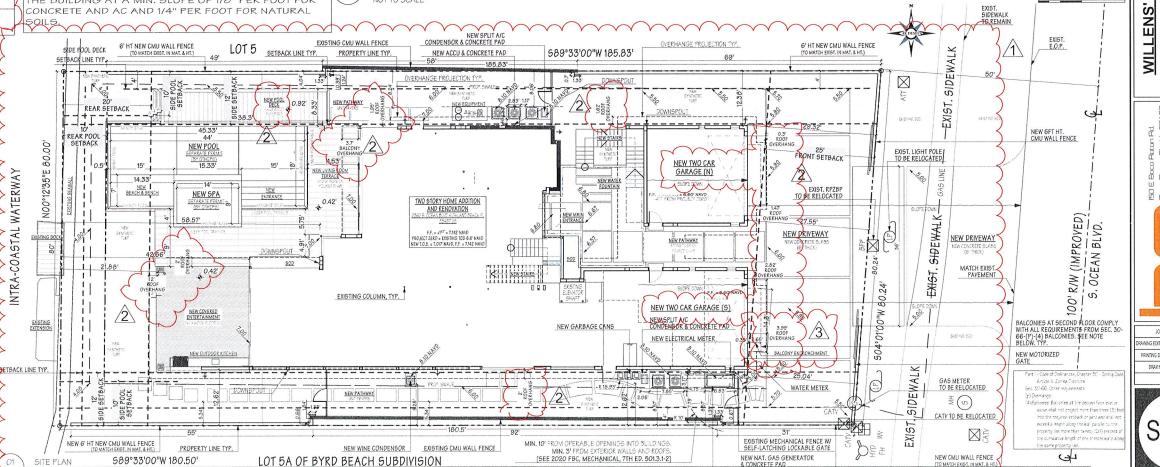

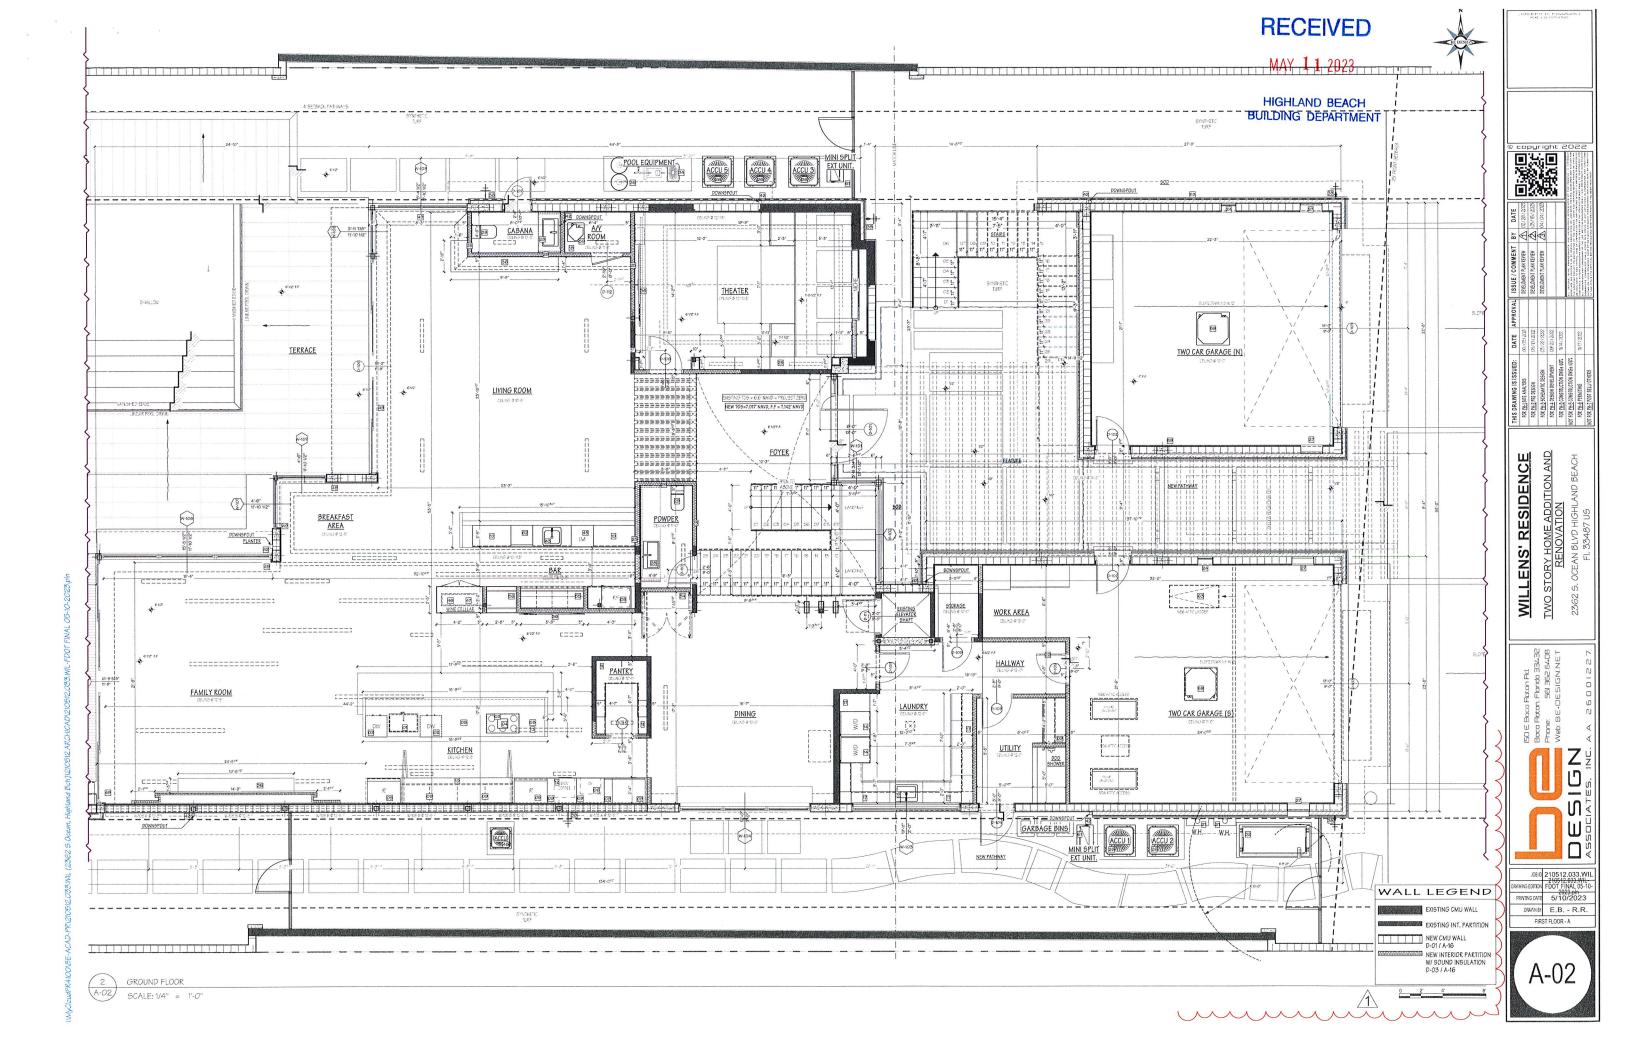

OIBE-ACAD-PRIZIOSIZIOSS.WIL (2362 S Ocean, Highland Bch)IZIOSIZ.ARCHICADIZIOSIZIOSSIWIL-FDOT FINAL OS-10-2023.pH

RRAIOONBE-ACAD-PRIZICOSIZOSAME (2002 9 Ocean, Highland Boh)/ZICO12.ARCHICAD/ZICO2/WI-+1V01 FINAL O5-10-20/ZO-pri



HIGHLAND BEACH BUILDING DEPARTMENT

WILLENS' RESIDENCE
TWO STORY HOME ADDITION AND
RENOVATION

U N

JOB ID 210512.033.WIL-210512.033.WIL-210512.033.WIL-2023.plh PRIVTING DATE 5/10/2023

DRAWN BY E.B. - R.R. FRONT AND REAR YARD - B

SCALE: 1/4" = 1'-0"



THIS DRAWING IS SSUED:
FOR ELLESTER ANYTHIS
FOR ELLESTER
F

IIGHLAND BEACH US

2362 S. OCEAN E

ח

N

JOB ID 210512.033, WILL-210512.033, WILL-RAWING EDITION FDOT FINAL 05-10-2023.pln PRIVITING DATE 5/10/2023


DRAWN BY E.B. - R.R.

TWO STORY HOME ADDITION AND RENOVATION

WILLENS' RESIDENCE

MAY 11 2023

HIGHLAND BEACH **BUILDING DEPARTMENT**

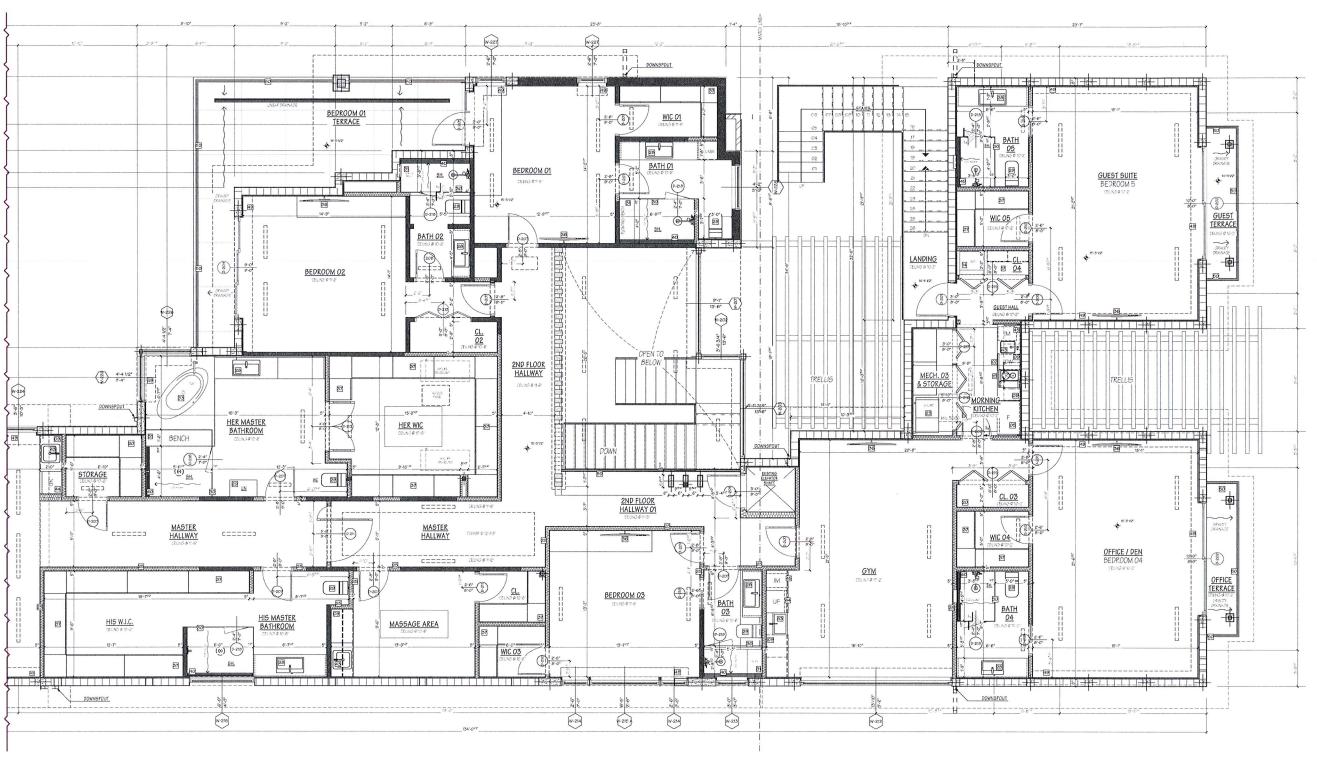

SECOND FLOOR PLAN SCALE: 1/4" = 1'-0"

WALL LEGEND EXISTING CMU WALL \triangle

NEW CMU WALL
D-01 (A-16

NEW INTERIOR PARTITION
W/ 50UND INSULATION D-03 / A-16

SECOND FLOOR - A

CIOUARRAIOOIBE-ACAD-RRIZIOSISMI (2362 8 Ocean, Highiana Bch)(ZIOSIZ.ARCHICAD/ZIOSIZ.UOSIMIL-1101 FINAL OS-10-2025)pin


© copyright a

WILLENS' RESIDENCE
TWO STORY HOME ADDITION AND
RENOVATION

2362 S. OCEA

MAY 11 2023

HIGHLAND BEACH BUILDING DEPARTMENT

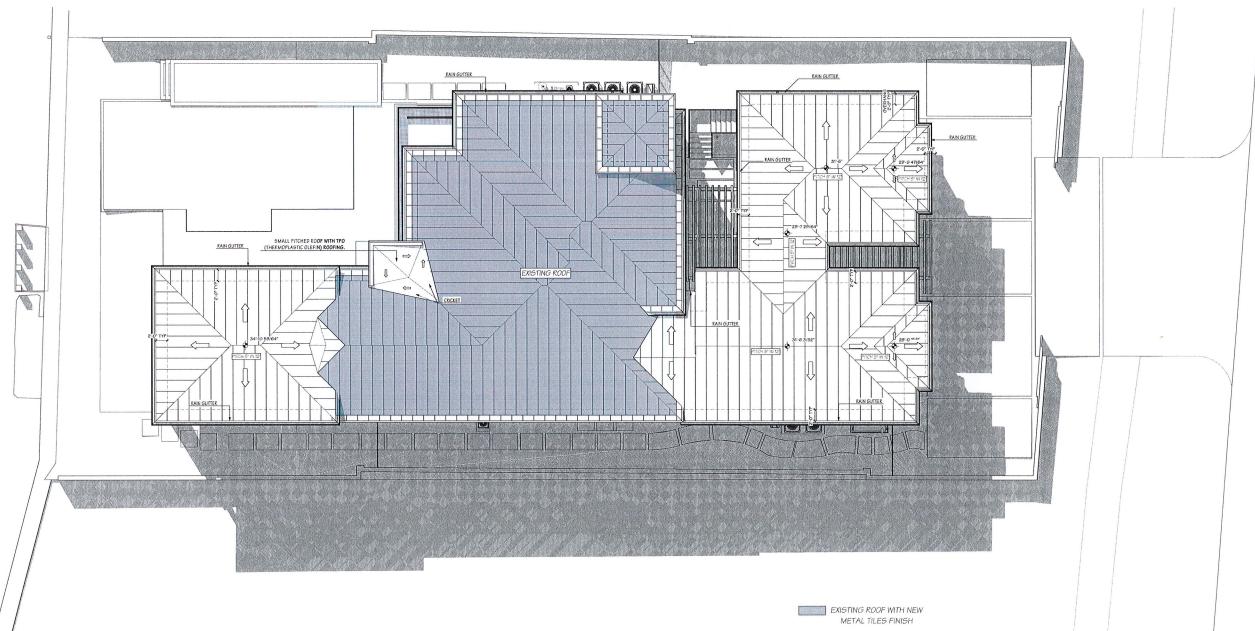

EXISTING ROOF WITH NEW
METAL TILES FINISH


JOB ID 210512.033.WIL 210512.033.WIL WING EDITION FDOT FINAL 05-10-2023.pln 5/10/2023 DRAWN BY E.B. - R.R.

MAY 11 2023

HIGHLAND BEACH BUILDING DEPARTMENT



NEW FRONT ELEVATION COLOR SCALE: 3/16" = 1'-0"

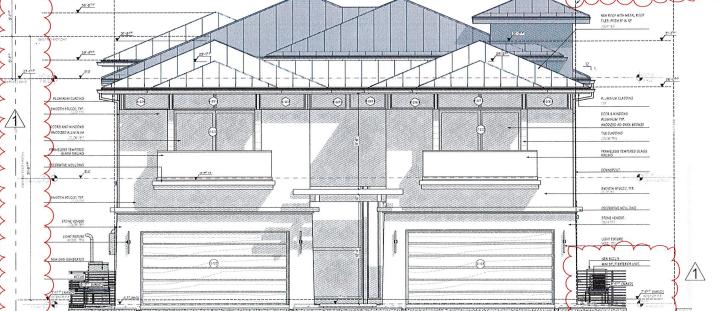

EXISTING ROOF WITH NEW METAL TILES FINISH

************ 0 EXISTING FRONT ELEVATION SCALE: 3/16" = 1'-0" SCALE: 3/16" = 1'-0"

© copyright

ISSUE / COMMENT BY DATE
PERIOREN TAN REVEN A COLORIZED
PERIOREN TAN REVEN A COLORIZED
PERIOREN TAN REVEN A COLORIZED

TWO STORY HOME ADDITION AND RENOVATION WILLENS' RESIDENCE

JOB ID 210512.033.WIL-210512.033.WIL-210512.033.WIL-2023.pin PRIVIING DATE 5/10/2023 DRAWNBY E.B. - R.R. ELEVATIONS FRONT

E-01

MAY 11 2023

HIGHLAND BEACH BUILDING DEPARTMENT




NEW REAR ELEVATION

SCALE: 3/16" = 1'-0"



EXISTING REAR VIEW SCALE: 3/16" = 1'-0"

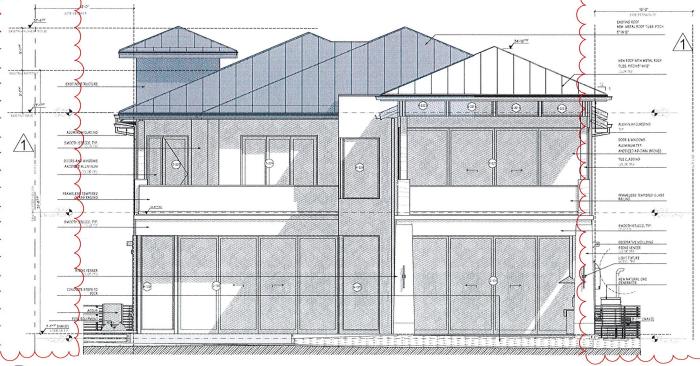

NEW REAR ELEVATION SCALE: 3/16" = 1'-0"

> EXISTING ROOF WITH NEW METAL TILES FINISH

± € € €

WILLENS' RESIDENCE
TWO STORY HOME ADDITION AND
RENOVATION

ທັ M

JOBID 210512.033.WIL 210512.033.WIL 210512.033.WIL PLOT FINAL 05-10-2023.pln 5/10/2023

DRAWN BY E.B. - R.R.
ELEVATIONS REAR





EXISTING RIGHT SIDE ELEVATION

SCALE: 3/16" = 1'-0"

| ISONE | COMMENT BY | DATE | COMMENT BY DATE | COMMENT BY DATE | COMMENT BY DATE | COMMENT BY |

WILLENS' RESIDENCE
TWO STORY HOME ADDITION AND
RENOVATION
2362 S. OCEAN BLVP HIGHLAND BEACH
FI. 33487 US

ISD E Boca Poton Pd.
Boca Paton, Florida 334.32
Phone: SG 392 64.08
Web: BE - DE SI G N. NE T

ESCENSION OF THE PROPERTY OF T

JOS ID 210512.033.WIL 210512.033.WIL 210512.033.WIL 210512.033.WIL 210512.033.WIL 2023.phi
PRIVINS DATE 5/10/2023
DRAIN BY E.B. - R.R.
RIGHT SIDE VIEW

E-03

MAY 11 2023

HIGHLAND BEACH BUILDING DEPARTMENT

NEW RIGHT SIDE ELEVATION

SCALE: 3/16" = 1'-0"

© copyright a

ISSUE / COMMENT BY DATE
PREJMENTAN KONEN A CALI DA CALIDA DA CALID


WILLENS' RESIDENCE

TWO STORY HOME ADDITION AND
RENOVATION
2362 S. OCEAN BLVD HIGHLAND BEACH
FI. 33487 US

Z U U

JOBID 210512.033.WIL 210512.033.WIL 210512.033.WIL 210512.033.WIL 2023.96 PRIVING DATE 5/10/2023 DRAINE E.B. - R.R. RIGHT SIDE VIEW



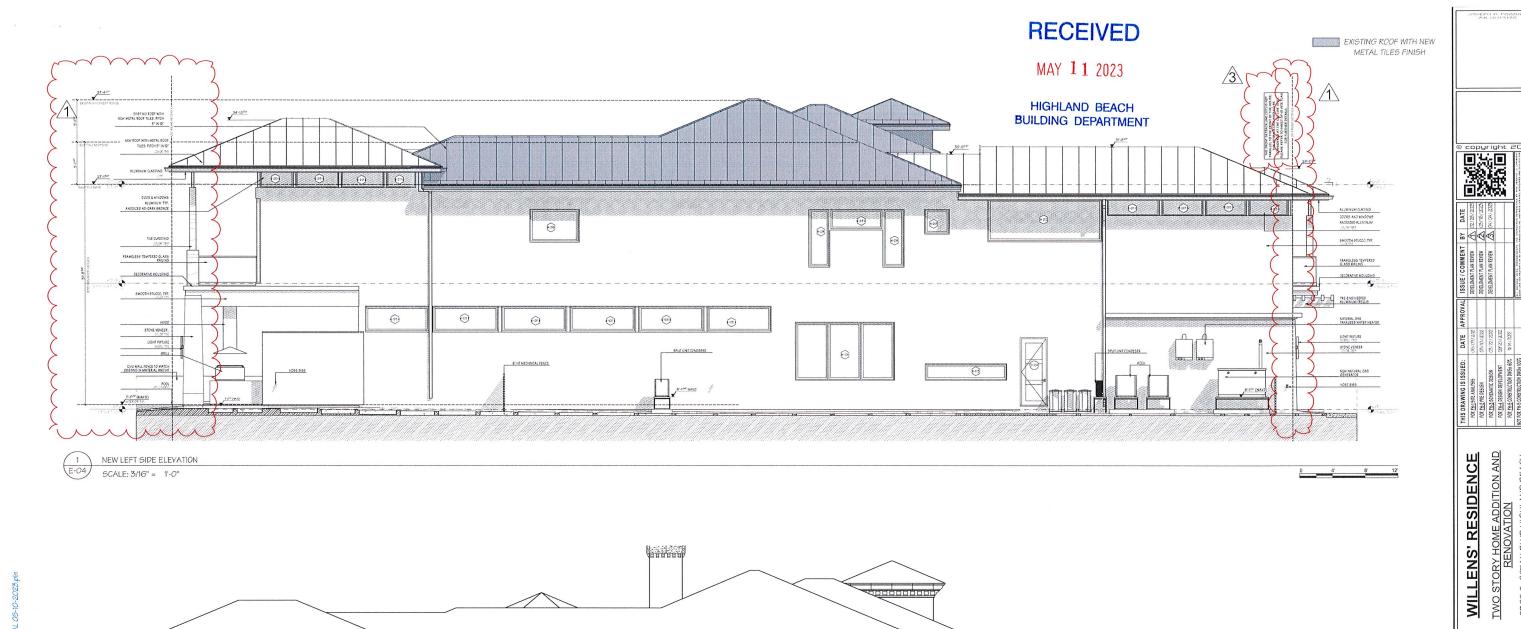



2362 S. OCEAN E

Z U

JOB D 210512.033.WIL 210512.033.WIL


E-04

150 E Boca Phone Web:



MAY 11 2023

HIGHLAND BEACH BUILDING DEPARTMENT

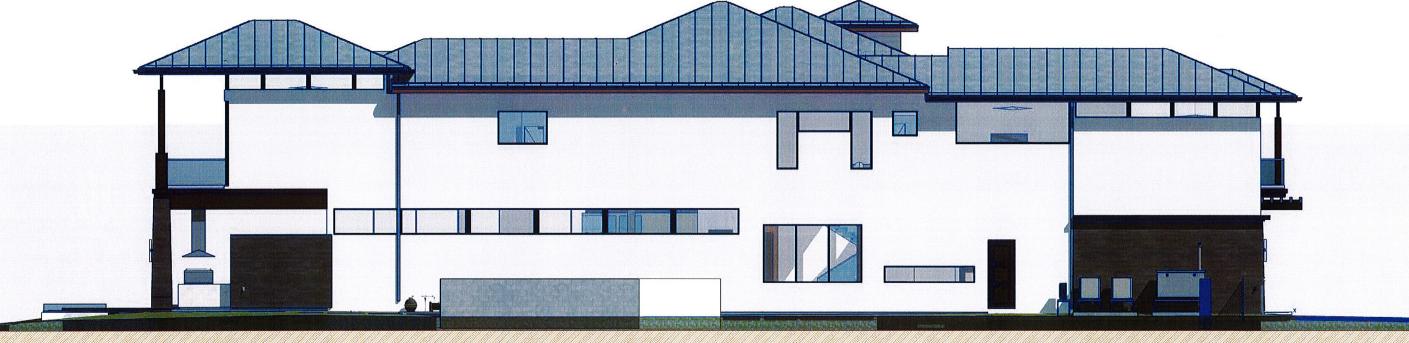

NEW LEFT SIDE ELEVATION

SCALE: 3/16" = 1'-0"

ISSUE / COMMENT BY DATE
DEFLORENT FLAN EFFER A CALIZED ACCES
DEFLORENT FLAN EFFER A CALIZED ACCESSED ACC

WILLENS' RESIDENCE
TWO STORY HOME ADDITION AND
RENOVATION
2362 S. OCEAN BLYD HIGHLAND BEACH
FI. 33487 US

Z U N S

JOB DI 210512.033.WIL 210512.033.WIL 210512.033.WIL 210512.033.WIL 210512.033.WIL 2003.00
PRINTING DAIT 5/10/2023
DRAWNET E.B. - R.R. LEFT SIDE VIEW





REAR VIEW (WEST)

MAY 11 2023


HIGHLAND BEACH BUILDING DEPARTMENT



RIGHT SIDE VIEW (NORTH)



LEFT SIDE VIEW (SOUTH)

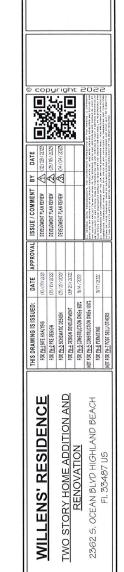



JOB ID 210512.033.WIL.
210512.033.WIL.
210512.033.WIL.
210512.033.WIL.
2023.ph
PRINTING DATE 5/10/2023

DRAIN BY E.B. - R.R.
RENDERINGS

E-05

PRIVATE CLIENT TWO STORY HOME ADDITION AND RENOVATION

2362 SOUTH OCEAN BOULEVARD, HIGHLAND BEACH, FL 33487





MAY 11 2023

HIGHLAND BEACH
BUILDING DEPARTMENT



INDEX OF SHEETS: SHEET No. TITLE

CS-1 COVER SHEET

25-1 COVER SHI

PAVING, GRADING & DRAINAGE PLAN

PD-2 PAVING, GRADING & DRAINAGE DETAILS

STORMWATER POLLUTION PREVENTION PLAN

SOUTH OCEAN BLVD

2362 SOUT


CLIENT: PRIVATE CLIENT

PROJECT NAME: TWO STORY HOME ADDITION AND

PROJECT ADDRESS: 2362 SOUTH OCEAN BLVD HIGHLAND BEACH, FL 33487

PROJECT NUMBER:

REVISIONS				
ΓE	BY	DESCRIPTION		
	┡			
	\vdash			
	Π			

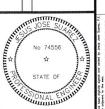

DATE:
JESUS J. SUAREZ, P.E.
ORIDA REGISTRATION NO. - 745

DATE: 10/14/2021

BCALE: AS SHOWN

DESIGNED BY: J.S.

DEAWN BY: LS

DESIGNED BY: J.S.

DRAWN BY: J.S.

CHECKED BY: J.S.

FILE:

JOB No. C100-2021-6

SHEET N

CS-1


LOCATION MAP

1"=200'

FOLIO: 24-43-46-28-44-000-0060

PAVING, GRADING & DRAINAGE PLANS



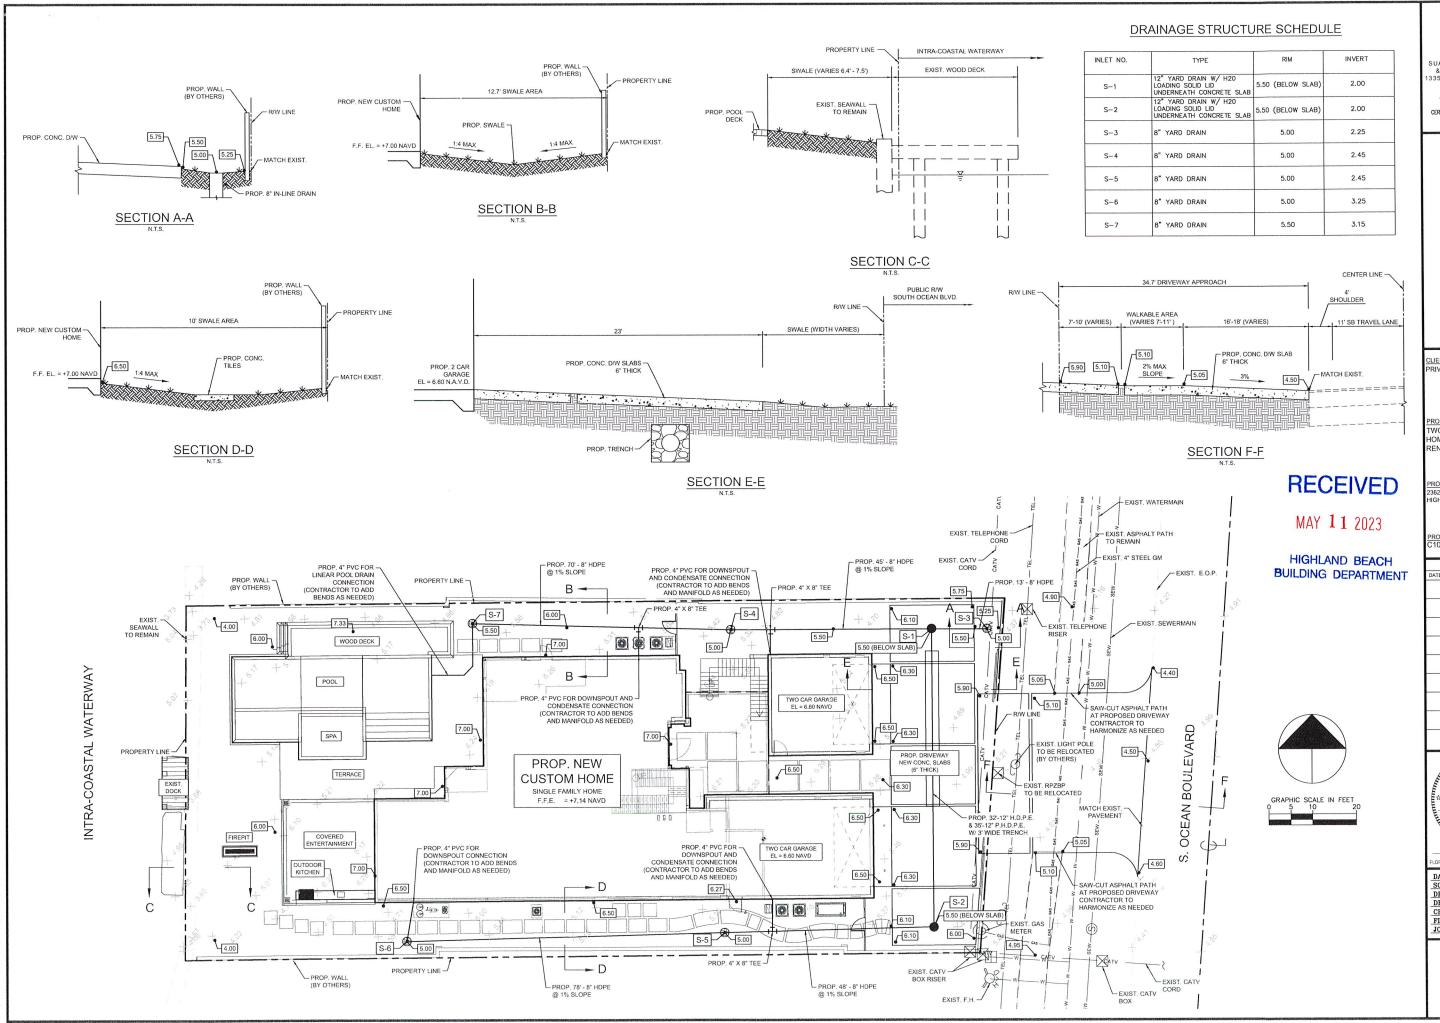

5

SUAREZ ENGINEERING & SURVEYING, INC 3350 SW 131ST STREET SUITE 103 MIAMI, FL 33186 Tel: 305.596.1799 CETIFICATE OF AUTHORIZATION LIC. NO.34996

2362 SOUTH OCEAN BLVD
PAVING, GRADING
& DRAINAGE PLAN

CLIENT: PRIVATE CLIENT

PROJECT NAME: TWO STORY HOME ADDITION AND RENOVATION

PROJECT ADDRESS: 2362 SOUTH OCEAN BLVD HIGHLAND BEACH, FL 33487

PROJECT NUMBER: C100-2021-60

REVISIONS
DATE BY DESCRIPTION

I DESCRIPTION

I DESCRIPTION



DATE:

JESUS J. SUAREZ, P.E.

RIDA REGISTRATION NO. - 74556

DATE: 10/14/2021 SCALE: AS SHOWN DESIGNED BY: J.S. DRAWN BY: J.S. CHECKED BY: J.S. FILE: JOB No. C100-2021-60

SHEET NO.


PD-1

MAY 11 2023


HIGHLAND BEACH **BUILDING DEPARTMENT**

6" THICK CONC. SLAB 12" STABILIZED SUBGRADE FILTER FABRIC : >- 12" P.H.D.P.E 3/4" WASH ROCK TOP OF TRENCH EL. 4.00 INVERT EL. 2.00 BOTTOM OF TRENCH EL. 1.00


TRENCH DETAIL

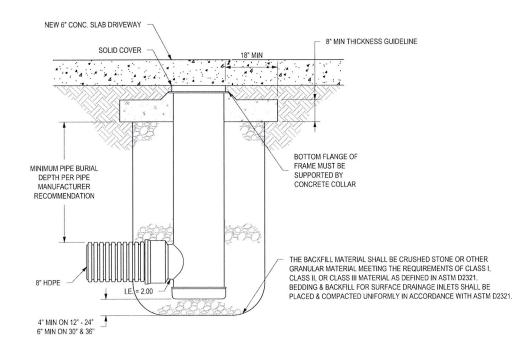

S-1 AND S-2 CONNECTION DETAIL

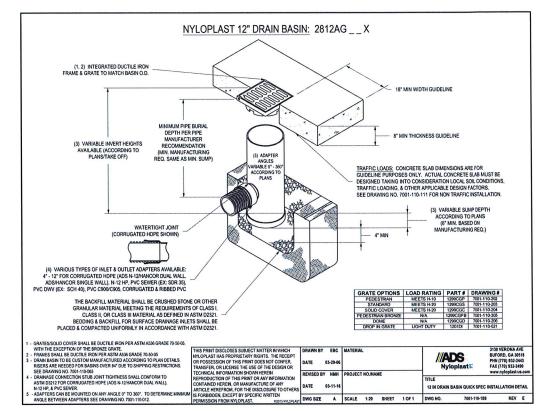

12" YARD DRAIN DETAIL

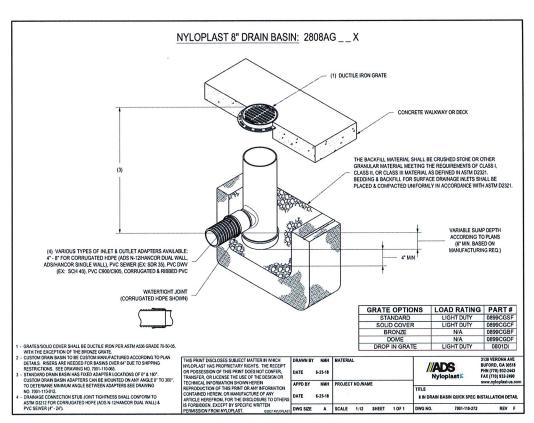

8" YARD DRAIN DETAIL

SUAREZ ENGINEERING & SURVEYING, INC 13350 SW 131ST STREET SUITE 103 MIAMI, FL 33186 Tel: 305.596.1799 CERTIFICATE OF AUTHORIZATION LIC. NO.: 34996

, DRAINAGE

SOUTH OCEAN BLVD GRADING & DETAILS PAVING, 2362


<u>CLIENT:</u> PRIVATE CLIENT

PROJECT NAME: TWO STORY HOME ADDITION AND RENOVATION

PROJECT ADDRESS: 2362 SOUTH OCEAN BLVD GHLAND BEACH, FL 33487

PROJECT NUMBER: C100-2021-60

REVISIONS DATE BY DESCRIPTION
DATE BY DESCRIPTION
1 1

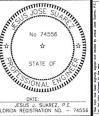

DATE: 10/14/2021 SCALE: AS SHOWN DESIGNED BY: J.S.
DRAWN BY: J.S. CHECKED BY: J.S. JOB No. C100-2021-60

SHEET NO.

PD-2

MAY 11 2023


HIGHLAND BEACH **BUILDING DEPARTMENT**

FLOATING TURBIDITY BARRIER INSTALLATION NOTES

- FLOATING TURBIDITY BARRIERS SHALL BE INSTALLED WITHIN EXISTING LAKES AND/OR CANALS. REFER TO STORMWATER POLLUTION PREVENTION PLANS FOR EXACT LOCAT
- CONTRACTOR MAY INSTALL A SUBSTITUTION FOR THE TYPE 1 AND TYPE 2 FLOATING TURBIDITY BARRIERS ONLY IF APPROVED BY BOTH THE ENGINEER-OF-RECORD AND THE APPLICABLE GOVERNMENTAL AGENCIES.

TYPE 2 TYPE 1

FLOATING TURBIDITY BARRIER INSTALLATION DETAIL

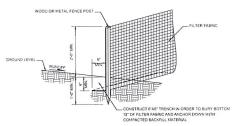

POST & FILTER FABRIC INSTALLATION DETAIL

GENERAL EROSION AND TURBIDITY CONTROL NOTES

- ALL EROSION AND TURBIDITY CONTROL DEVICES AND TEMPORARY BARRIERS SHALL BE INSTALLED WITHIN THE LIMITS OF THE CONSTRUCTION AREA PRIOR


- 5. PRACTICES SUCH AS SEEDING. MULCHING AND WETTING WHICH MINIMIZE ALD DUST AND PARTICULATE EMISSIONS GENERATED DURING CONSTRUCTION AC SHALL BE USED AS DIRECTED BY BOTH THE ENGINEER-OF-RECORD AND/OR APPLICABLE COVERNMENTAL AGENCIES.
- ALL AREAS DISTRIBUTED DURING CONSTRUCTION ACTIVITIES, WHICH ARE NOT GOING TO BE PAYED OR LANDSCAPED. SHALL BE SEEDED AND MULCHED.

SILT FENCE & POST INSTALLATION NOTES

- THE HEIGHT OF THE SILT FENCE SHALL BE INSTALLED AT A MINIMUM OF 24 INCHES BUT SHALL NOT EXCEED 36 INCHES.

SILT FENCE INSTALLATION DETAIL

- 6. THE FENCE POSTS SHALL BE INSTALLED AT A MAXIMUM OF 10 FEET APART AND DRIVEN SECURELY INTO THE GROUND FOR A MINIMUM OF 12 INCHES WHEN THE FILTER ASPICE IS USED WITHOUT WIRE MESH SUPPORT. IF WIRE SUPPORTIS US THEN THE FENCE POSTS SHALL BE SPACED AT A MAXIMUM OF 6 FEET APART.
- WHEN INSTALLING TWO SILT FENCES AROUND THE PERIMETER. PLACE THE POSTS OF THE SECOND FENCE INSIDE THE POSTS OF THE FIRST FENCE. ROTATE BOTH FENCE POSTS AT A CLOCKWISE DIRECTION IN ORDER TO CREATE A TIGHT SEAL. FOLLOW ALL OTHER

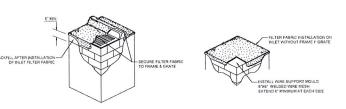


FILTER FABRIC INSTALLATION DETAIL

FILTER FABRIC INSTALLATION NOTES

- . CONTRACTOR SHALL CLEAN OUT DRAINAGE INLET AND FILTER FABRIC AFTER EVERY STORM EVENT OR AS NEEDED.
- CONTRACTOR SHALL REMOVE FILTER FABRIC FROM DRAINAGE INLETS PRIOR TO STARTING FINAL PAVING OPERATIONS.



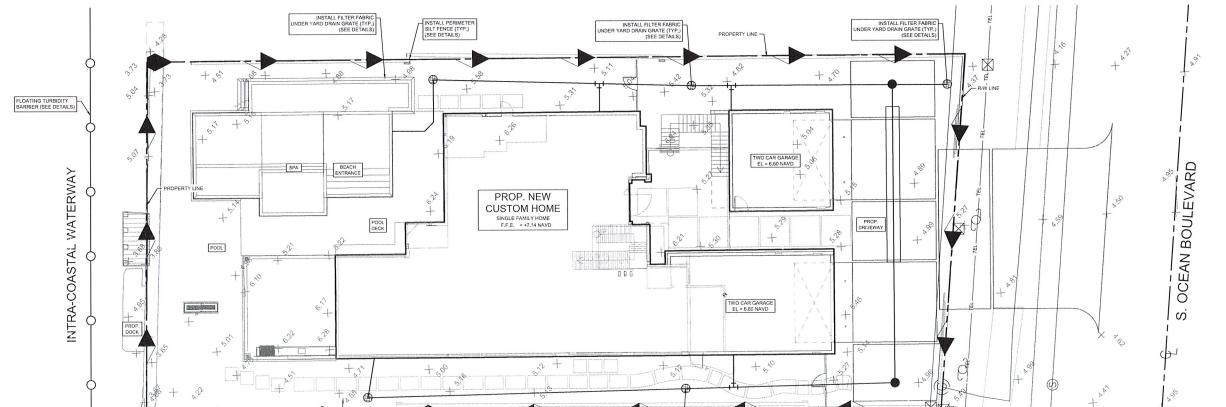

SUAREZ ENGINEERING & SURVEYING, INC 13350 SW 131ST STREET SUITE 103 MIAMI, FL 33186 Tel: 305.596.1799 CERTIFICATE OF AUTHORIZATION LIC. NO.: 34996

2362 SOUTH OCEAN BLVD STORMWATER POLLUTION PREVENTION PLAN & EROSION CONTROL DETAILS

CLIENT: PRIVATE CLIENT

PROJECT NAME: TWO STORY HOME ADDITION AND RENOVATION

PROJECT ADDRESS: 2362 SOUTH OCEAN BLVD HIGHLAND BEACH, FL 33487

PROJECT NUMBER: C100-2021-60

REVISIONS DATE BY DESCRIPTION



DATE: 10/14/2021 SCALE: AS SHOWN DESIGNED BY: J.S. DRAWN BY: J.S.
CHECKED BY: J.S. FILE: JOB No. C100-2021-60

SHEET NO.

SWPP-1



PRIVATE RESIDENCE 2362 S. OCEAN BLVD HIGHLAND BEACH, FL

SCOPE OF WORK

STATE ROAD A1A (S. OCEAN BLVD) MILE POST: 7.644 TO 7.629

FDOT SPECIFICATIONS AND DESIGN STANDARDS

Governing Standard Plans: Florida Department of Transportation, FY 2022-23 Standard Plans for Road and Bridge Construction and applicable Interim Revisions (IRs)
Governing Standard Specifications: Florida Department of Transportation, July 2022 Standard Specifications for Road and Bridge Construction
ROADWAY DESIGN SPEED FOR A1A = 35 MPH

RECEIVED

MAY 11 2023

HIGHLAND BEACH BUILDING DEPARTMENT


INDEX OF SHEETS

SHEET No. TITLE

CS-1 COVER SHEET

LANDSCAPE ARCHITECTURE

LP-1 LANDSCAPE PLAN LP-2 NOTES & DETAILS

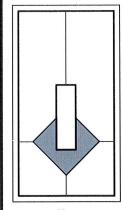




TWO STORY HOME ADDITION AND RENOVATION 2362 S. OCEAN BLVD.
HIGHLAND BEACH, FL 33487

DISTRIBUTION: DATE:

DRAWING NAME: COVER SHEET SHEET

DRAWING NUMBER:

FDOT LANDSCAPE PERMIT NO: 2023-L-496-00005

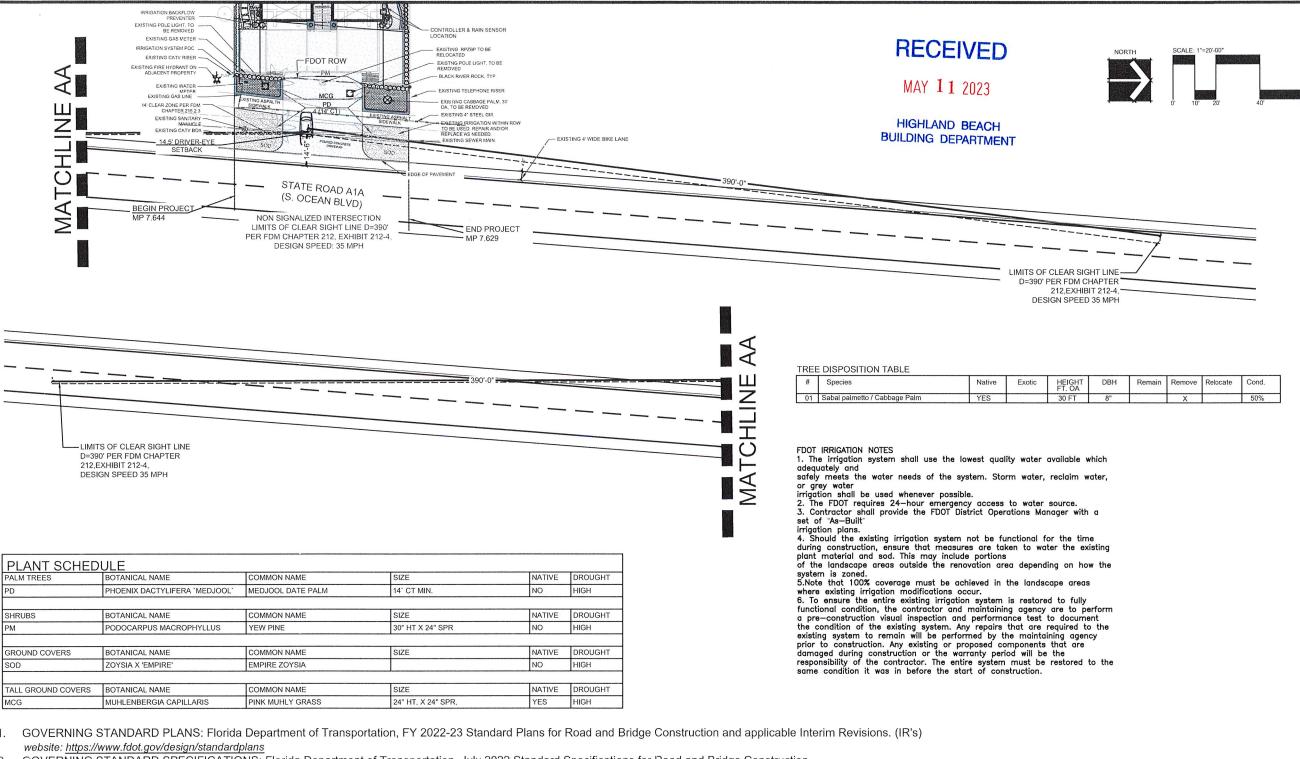

- 2. GOVERNING STANDARD SPECIFICATIONS: Florida Department of Transportation, July 2022 Standard Specifications for Road and Bridge Construction. website:

FDOT GENERAL NOTES

1. Architectural Pavers installation for sidewalks, medians, driveways, or roadways within the FDOT right of way shall comply with current FDOT Standard Specification 526. Online Reference: https://fdotwww.blob.core.windows.net/sitefinity/docs/default-source/programmanagement/implemented/specbooks/fy-2023-24/fy2023-24ebook.pdf?sfvrsn=6b69416d_6

FDOT PLANTING NOTES

- 1. For the portion of landscape plant material that will be installed within the FDOT Right of Way, landscape installation shall comply with current applicable FDOT Maintenance Specification 580. Online Reference:
- 2. For the portion of landscape plant material that will be installed within the FDOT Right of Way refer to the FDOT Standard Plans Index 580-001 Landscape Installation. Online Reference: https://fdotwww.blob.core.windows.net/sitefinity/docs/default-source/design/standardplans/2023/idx/580-001.pdf?
- 3. Cypress Mulch is not permitted on FDOT right of way. Mulch permitted to be used are Hardwood Mulch (containing no Cypress products), Recycled Mulch or approved equal, certified by the Mulch and Soil Council (MSC). Submit proof of certification to the FDOT District Operations Permit Landscape Inspector upon inspection.
- 4. Sodded areas will be in accordance with Standard Plans Index 570-010 and Standard Specifications Sections 162, 570, 981, 982, 983, 987 of the Department's latest edition of Governing Design Standards and Standard Specifications. All disturbed areas will be sodded within one (1) week of installation of said permitted work.



Rylgned STAT023.04 RENOVATION CLIEN RY HOME ADDITION AND REI 2362 S. OCEAN BLVD. HIGHLAND BEACH, FL 33487 **PRIVATE** STORY TWO

DATE
_

DRAWING NAME:
LANDSCAPE PLANS

RAWING NUMBER P.

FDOT GENERAL NOTES


- 1. GOVERNING STANDARD PLANS: Florida Department of Transportation, FY 2022-23 Standard Plans for Road and Bridge Construction and applicable Interim Revisions. (IR's) website: https://www.fdot.gov/design/standardplans
- 2. GOVERNING STANDARD SPECIFICATIONS: Florida Department of Transportation, July 2022 Standard Specifications for Road and Bridge Construction.
- https://www.fdot.gov/programmanagement/implemented/specbooks
- Contractor shall repair any and all damage done to FDOT property during demolition, relocation &/or installation activities at his sole
- Any plant material substitution within or impacting the FDOT Right of Way whether requested by the Contractor, Owner, Landscape Architect or other will need to get approval from the FDOT District Landscape Architect.
- 5. Ownership of all suitable excavated materials, as determined by the Department, shall remain in the Department until a final acceptance of the permitted project is fullfilled. Excavated materials shall be hauled by the Permittee, at their cost and expense from the site to the Broward Operations Center or stockpiled in those areas as directed by the Department, including asphalt millings.
- Maintenance of Traffic (MOT) for this project will comply with FDOT Standard Plans Index (102 Series) and the latest edition of the Manual of Uniform Traffic Control Devices (MUTCD). Special attention will be given to FDOT Design Plans Standard Index 102-005, 102-010, 102-045, and 102-075.
- 7. Permittee will restore the Right-Of-Way as a minimum, to its original condition or better in accordance w/ FDOT's latest Standard Specifications for Road and Bridge Construction or as directed by the Resident Operations Engineer.
- 8. Restricted hours of operations will be from 9:00am to 3:30pm, (Monday-Friday), unless otherwise approved by the operations Engineer, or designee.
- 9. Permittee will ensure that all locates have been performed prior to scheduling of any WORKING activities. This shall include soft digs to verify vertical and horizontal alignment.
- 10. Permittee will coordinate all work with Asset Managment. Contact David Moore of Transfield Services at 954-317-8044, moore@transfieldservices.com. Coordination will include a Pre-Construction meeting.


FDOT PLANTING NOTES


1. For the portion of landscape plant material that will be installed within the FDOT Right of Way landscape installation shall comply with current FDOT Maintenance Specifications 580-2.1. Online


http://www.fdot.gov/programmanagement/Maintenance/2022July/default.shtm.

- 2. For the portion of landscape plant material that will be installed within the FDOT Right of Way refer to FDOT Standard Plans Index 580-001 Landscape Installation. Online Reference: http://www.fdot.gov/design/standardplans/current/IDx/580-001.pdf
- No Category I or II invasive plants shall be planted on FDOT right
- Cypress Mulch is not permitted on FDOT right of way. Mulch permitted to be used are Hardwood Mulch (containing no Cypress products), Recycled Mulch or approved equal, certified by the Mulch and Soil Council (MSC). Submit proof of certification to the FDOT District Operations Permit Landscape Inspector upon inspection.

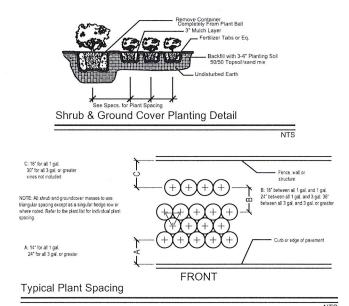

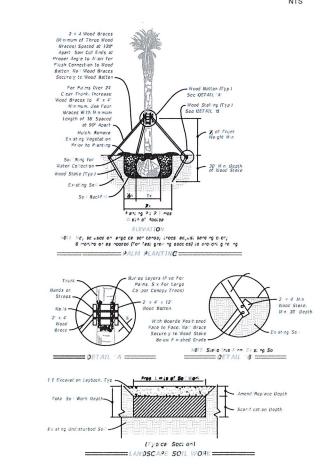

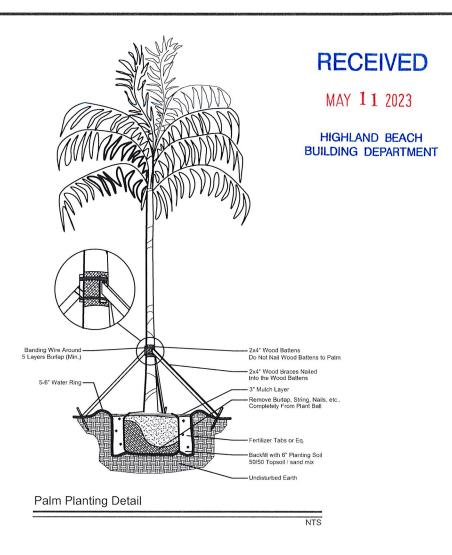

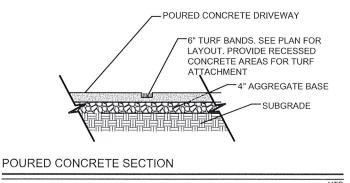





RIVATE

0


ORY

DRAWING NAME NOTES & DETAILS

DRAWING NUMBER:

LEGAL DESCRIPTION

LOT 6, PLAT NO. 1, CAMELOT ON THE ATLANTIC, ACCORDING TO THE MAP OR PLAT THEREOF AS RECORDED IN PLAT BOOK 39, PAGE 160, PUBLIC RECORDS OF PALM BEACH COUNTY, FLORIDA. TOGETHER WITH A PORTION OF TRACTS A-2 AND B-2 OF SAID PLAT, MORE PARTICULARLY DESCRIBED AS FOLLOWS: BEGIN AT THE NORTHEAST CORNER OF SAID LOT; THENCE NORTH 89°33'00" EAST, ALONG THE EASTERLY PROJECTION OF THE NORTH BOUNDARY OF SAID LOT, 87.49 FEET TO A POINT ON THE EAST BOUNDARY OF PLAT; THENCE SOUTH 04°01'00" WEST, ALONG SAID EAST BOUNDARY, 80.24 FEET TO THE SOUTHEAST CORNER OF SAID PLAT; THENCE NORTH 27°43'24" WEST, ALONG THE EASTERLY BOUNDARY OF SAID LOT, 50.00 FEET TO A POINT ON THE ARC OF A RADIALLY TANGENT CURVE; THENCE NORTHWESTERLY, ALONG SAID EAST BOUNDARY AND ALONG THE ARC OF SAID CURVE BEING CONCAVE TO THE NORTHEAST, HAVING A RADIUS OF 40.00 FEET, A DELTA OF 117°16'24", AND AN ARC DISTANCE OF 81.87 FEET TO THE POINT OF BEGINNING OF THE PUBLIC RECORDS OF PALM BEACH COUNTY, FLORIDA.

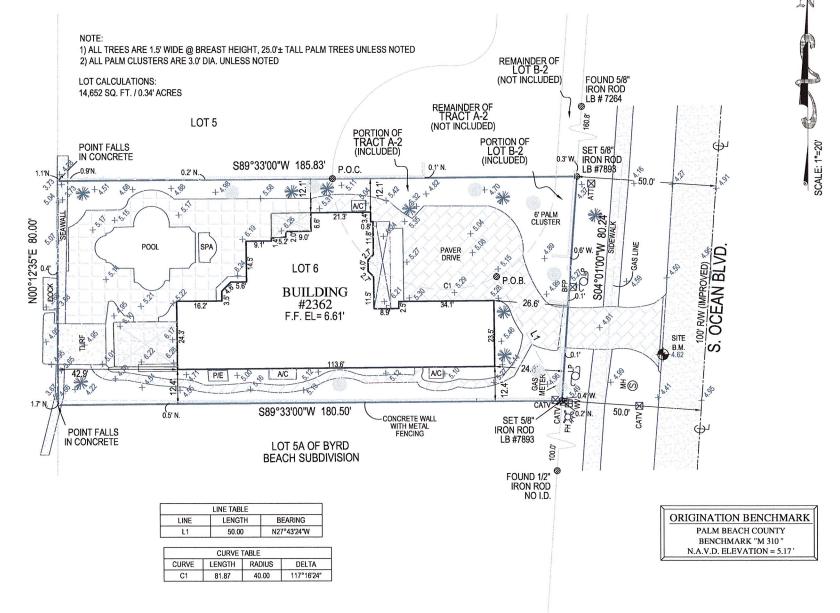



VICINITY MAP

Flood Zone: AE
Community Number: 120192
Panel: 12099C0987
Suffix: F
Base Flood Elevation: 6.0'
FIRM Date: 10-05-2017
FIRM Effect./Rev Date: 10-05-2017

LEGEND

AC AIR CONDITIONER
B.F.P. BACKFLOW PREVENTER
C.B.S. CONCRETE BLOCK STRUCTURE
EL. ELEVATION
F.F. FINISHED FLOOR
I.D. IDENTIFICATION
L. LENGTH
L.B. LICENSED BUSINESS
M. MEASURED
NALL & DISC
NALL & DATUM
ORB. OFFICIAL RECORDS BOOK
PLAT
PROFESSIONAL SURVEYOR AND MAPPER
P.B.M. PERMANENT REFERENCE MONUMENT
P.B. PLAT BOOK
R. PARKER KYLON NAIL
R. ADIUS
T.B.M. TEMPORARY BENCH MARK
C. CENTERLINE
AND
MUMBER
A DELTA OR CENTRAL ANGLE

Project C-560568 Date Sheet

BOUNDARY SURVEY WITH TOPOGRAPHY & TREE LOCATION 2362 SOUTH OCEAN BOULEVARD HIGHLAND BEACH, FL 33487

VID

Project C-560568 Date 09-21-2022 Scale 1"=20'

OVPASS WEST PALM BEACH, FL 33407 PHONE: 561.640,4800 FAX: 561.640,0576 WWW.COMPASSSURVETING

LB #7463

NOTES

INTRA-COASTAL WATERWAY

- 1. LEGAL DESCRIPTION PROVIDE BY CLIENT
- 2. NO SEARCH OF THE PUBLIC RECORD FOR THE PURPOSE OF ABSTRACTING TITLE WAS PERFORMED BY THIS OFFICE
- 3. NO SUBSURFACE IMPROVEMENTS WERE LOCATED AS PART OF THIS SURVEY
- 4. ALL ANGLES OR BEARINGS AND DISTANCES SHOWN HEREON ARE BOTH RECORD AND MEASURED UNLESS OTHERWISE NOTED
- 5. SOME FEATURES MAY NOT BE AT SCALE IN ORDER TO SHOW DETAIL.
- 6. THE BEARINGS SHOWN HEREON ARE BASED UPON THE SOUTH PROPERTY LINE, HAVING A BEARING OF S 89° 33' 00" W.

REVISIONS:

- 1) REVISED WALLS AND FENCES: 11-15-2022
- 2) ADD LOT AREA: 03-07-2023

DATE OF FIELD WORK: 09-21-2022 DATE OF MAP: 09-27-2022 SURVEYORS CERTIFICATE:
I HEREBY CERTIFY THAT THIS BOUNDARY SURVEY IS A
TRUE AND CORRECT REPRESENTATION OF A SURVEY
PREPARED UNDER MY DIRECTION. NOT VALID
WITHOUT A RAISED EMBOS SEBISTALIAN SIGNATURE.

Kenneth by Kenneth Osborne Date: 2023.03.07

KENNETH J. OSBORNE PROFESSIONAL SURVEYOR AND MAPPER #6415

RECEIVED

MAY 11 2023

HIGHLAND BEACH BUILDING DEPARTMENT