MCKENNA



November 13, 2025

Planning Commission City of Grosse Pointe Woods 20025 Mack Plaza Grosse Pointe Woods, MI 48236

Subject: 20160 Mack Avenue: Conditional Rezoning (Map Amendment), Review #2

Parcel ID: 009-01-0001-000

Current Zoning: RO-1, Restricted Office District

Proposed Rezoning: C, Commercial Business District (Conditionally)

Dear Commissioners,

We have reviewed a Conditional Rezoning application submitted by Stucky Vitale Architects on behalf of Buccellato Development, LLC. The applicant proposes to conditionally rezone 20160 Mack from the RO-1, Restricted Office District to the C, Commercial Business District. The updated conditions proposed by the applicant are provided in their *Statement of Voluntary Conditions*.

The subject site is located on Mack Avenue between Oxford and S. Renaud. The existing building will be demolished and replaced with a two-story, mixed-use building. The first floor is approximately 8,800 sq. ft. for tenants across office, retail, or personal service establishments, and the second floor will have up to seven residential units.





Conditional Rezoning Review

#1: MASTER PLAN AND FUTURE LAND USE CLASSIFICATIONS

Will the proposed amendment further the comprehensive planning goals and policies of the City and is the proposed amendment consistent with the Future Land Use Map of the Master Plan?

Findings: Alignment and harmony with the recently adopted Master Plan is achieved with this rezoning.


First, this rezoning is consistent with numerous goals from the 2024 Master Plan, as follows:

- Goal #1 Housing: Provide a range of housing choices for all ages, abilities, and incomes. The applicant proposes a two-story, mixed-use building with multi-family residential units on the top floor. This proposed use brings housing diversity to the heart of Grosse Pointe Woods' downtown, within walking distance to daily amenities. Offering high-quality housing options can bring young professionals and growing families to the City, who might not be ready to purchase a traditional, detached home.
- Goal #2 Economic Development: Elevate Mack Avenue as a thriving, vibrant commercial corridor that meets the daily needs of residents and is a destination for visitors. The applicant proposes a high-quality, aesthetically rich development that will attract both new businesses and foot traffic to Mack Avenue. The 2024 Master Plan specifically calls out the potential for mixed-use developments for revitalizing Mack Avenue and in promoting housing readiness. In particular, the Master Plan notes that "Mixed use developments often include greater density housing types with neighborhood scale commercial goods and services to serve the residents therein and could be an appropriate option along Mack Avenue. Mixed use developments are particularly amenable to the needs of seniors and children who often do not drive, by providing increased accessibility and opportunities for walkability that are not present in other areas of the City, further away from Mack Avenue." (pg. 28).
- Goal # 3 Community Character: Strengthen sense of place, identity, and character throughout the City and its neighborhoods. The applicant proposes to use brick and other high-quality building materials that complement existing structures on the Mack Avenue corridor and in the surrounding neighborhoods, which aligns with Goal #3's stated objective to "Maintain quality building materials and design throughout the City."

Second, this rezoning is consistent with the 2024 Master Plan's Future Land Use Map, which designates this area as *Corridor Mixed Use*.

This is described in the text of the Master Plan as, "This land use designation includes retail, restaurant, personal service, and office establishments which are designed for the day-to-day needs of nearby residents and are found along the Mack Avenue corridor and along its easternmost boundary of Harper Avenue that extends one-and-a-half blocks between Stanhope Street and just north of Allard Avenue. These facilities are intended to be located in close proximity to residential neighborhoods but with adequate buffering. These land uses equate to the City's C Commercial zoning district, P Parking district and some areas zoned RO-1 Restricted Office".



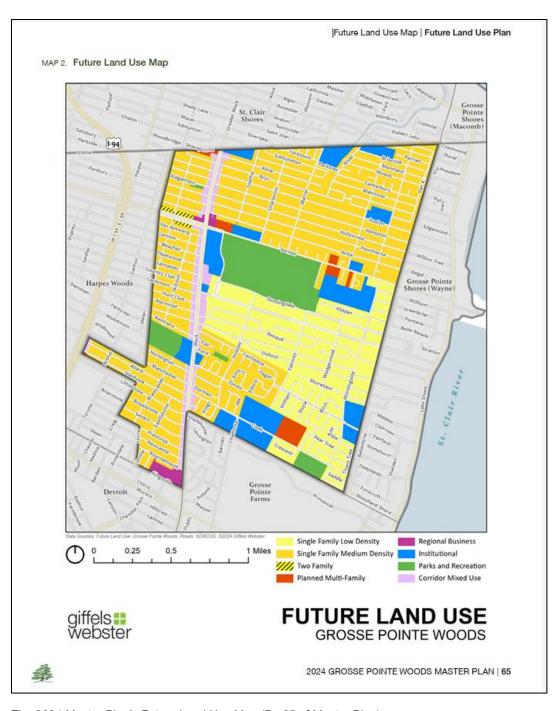

The 2024 Master Plan's Future Land Use Map (Pg 65 of Master Plan).



#2: INTENT AND USES OF THE ZONING ORDINANCE

Is the request in accordance with the basic intent and purpose of the Zoning Ordinance?

The basic intent and purpose of the Zoning Ordinance is to provide regulations on the uses of land and structures to promote and protect the public health, safety, and general welfare of the Grosse Pointe Woods community.

The chart below details the existing land use, current zoning, and the 2024 Master Plan Future Land Use designations:

Location	Existing Land Use	Zoning Districts	Future Land Use Designation (2024 Master Plan)
Subject Site	Neurology Office	RO-1, Restricted Office	Corridor Mixed Use
North	Bank Office	RO-1, Restricted Office	Corridor Mixed Use
South	Dentist	RO-1, Restricted Office	Corridor Mixed Use
East	Single-Family Residential	R1-D / R1-B, One-Family Residential	Single Family Low Density
West	Orthodontics Office / Fitness Facility / Jewelers	C, Commercial Business	Corridor Mixed Use

Findings: Intent Statements. The Zoning Ordinance is intended to ensure harmonious, thoughtfully planned development – and this requires an understanding of the *purpose statements* and *permitted uses* in the two applicable districts, as detailed below. To summarize, the C, Commercial District is intended to promote economic development in condense ways that serve neighboring communities with services as well as residential employment opportunities, and to reduce strip business development as well as any hazards of nuisances from any business operations.

Purpose Statement: Section 50-3.1.L: RO-1, Restricted Office	Purpose Statement: Section 50-3.1.J: C, Commercial Business
"The RO-1 restricted office district is intended to permit those office and restricted business uses which will provide opportunities for local employment close to residential areas, thus reducing travel to and from work; which will provide clean, modern office buildings in landscaped settings; which will provide, adjacent to residential areas, appropriate districts for uses which do not generate large volumes of traffic, traffic congestion and parking problems; and which will promote the most desirable use of land in accordance with the city's land use plan."	"The C commercial business district is intended to be that permitting retail business and service uses which are needed to serve the nearby residential areas. In order to promote such business development insofar as it is possible and appropriate in each area, uses are prohibited which would create hazards, offensive and loud noises, vibration, smoke, glare, heavy truck traffic or late hours of operation. The intent of this district is also to encourage the concentration of local business areas to the mutual advantage of both the consumers and merchants and thereby promote the best use of land at certain strategic locations and avoid the continuance of encouraging marginal strip business development along major streets."



Findings: Allowable Uses. The uses permitted in the C, Commercial Business District include a mix of retail, office, restaurant, and residential uses, which are generally compatible with the commercial nature of Mack Avenue surrounding this property. While the property abuts two residential properties, the applicant has noted that buffering will be provided, per the requirements of the Grosse Pointe Woods City Ordinance. The associated site plan applications details that this proposed screening includes three new trees along the east side of the site, as well as a 5-foot stepped masonry screening wall with a decorative stone cap.

Further, the applicant has offered the voluntary condition of only one ground-floor "quick service" restaurant or food service use, which will operate approximately between the hours of 6:00am and 11:00pm, and will not include any liquor sales or service. These voluntarily offered conditions are intended to mitigate any potential adverse impact from noise and other nuisances.

#3: SPECIFIC ZONING ORDINANCE CRITERION

Could all requirements in the proposed zoning classification be complied with on the subject parcel?

Findings: Dimensional Requirements.

The project's compliance with dimensional standards will be further explored during the site plan review stage. However, the table below demonstrates that the proposed use can feasibly comply with the basic dimensional standards of the C, Commercial Business District. The table below demonstrates the requirements under the proposed C, Commercial Business District, and the dimensions proposed by the applicant in their corresponding Site Plan application.

Zoning Ordinance Standard	C, District Requirement Details	Required	Proposed	Notes
Max. Lot Area	None	None	0.758 acres	Complies
Max Lot Width	None	None	Mack Avenue: Approximately 134.63ft	Complies
Max Lot Coverage	None	None	Approximately 33,007 sq. ft.	Complies
Min. Front Setback (West)	No front yard is permitted where the property use is for the purposes specified in section 50-4.9 retail businesses and business offices.	0 ft.	0 ft.	Complies
Min. Side Setback (North / South)	In the Commercial Business District, no side yard is required on the street side of corner lots.	0 ft.	0 ft.	Complies



Zoning Ordinance Standard	C, District Requirement Details	Required	Proposed	Notes
Min. Rear Setback (East)	Rear yards are not required along interior rear lot lines for buildings or parts of buildings not used as dwellings, if all walls abutting or facing such lot lines are of fire-proof construction and wholly without windows or other openings; provided that in all cases where the rear wall is not of fireproof construction a rear yard shall be provided, and provided further that, in all cases where the rear wall is of fireproof construction and contains windows or other openings (other than emergency exits or vents), either a rear yard or an outer court as specified in subsection I shall be provided.	8 ft.	140 ft.	Complies
Max. Building Height	2 stories, 28 ft.	2 stories, 28 ft.	2 stories, 28 ft.	Complies

The site meets all requirements of the C, Commercial Business District. Such a rezoning allows for a buildable lot and does not create a new non-conformity.

Findings: Parking and Circulation.

Currently the Site Plan indicates a total of 7 residential units on the second floor, as well as 4 ground floor commercial tenant spaces. At this time, one-bedroom dwelling unit parking requirements apply; however, if the residential units change in size/type, the appropriate parking requirements would apply. The specific uses of the proposed commercial tenants have not yet been identified, and the parking requirements for those specific uses will apply once specific tenants seek to lease the space. At this time, general retail parking requirements are applied.

Use Type	Number of Off-Street Parking Spaces Required		Number of Off- Street Parking Spaces Provided	Number of Parking Spaces within 500 ft.	Total Parking Spaces Available (on- and off-site) within 500 ft.
Multi-family Residential	Two for each efficiency or one-bedroom dwelling unit = 14 spaces	Total: 58	45 anggos in let	18 parking spaces on the East side of Mack Ave.	63 parking spaces (excluding S. Renaud)
Retail	One for each 200 square feet of gross floor area = 44 spaces	spaces required	45 spaces in lot	+ 14 parking spaces on S. Renaud	77 parking spaces total (including S. Renaud)

The site, and the surrounding 500-feet parking radius, offer flexibility in the variety of uses that could ultimately be proposed on this site. Each end user will be evaluated during the site plan phase, should this conditional rezoning be approved.



As detailed on the site plan, the proposed parking spaces comply with the minimum required dimensions of 9 ft. by 19 ft., and a 12 ft. by 50 ft. loading zone is proposed (in compliance).

Lastly, Section 50-5.3(U) requires that parking lots provide traffic lane markings to indicate entrances and exits, and to provide for the safe and orderly movement of vehicles. These required traffic lane markings are depicted on the plans. This includes markings on the ingress/egress from S. Renaud Road and on Oxford Road, as well as within the parking lot itself, as well as the inclusion of signage to bar turns onto the adjoining residential streets.

The applicant also submitted a Traffic Study, as is required for Conditional Rezoning Applications. A trip generation comparison was performed, indicating that the proposed development is comparable to the current use (medical office building) of the project site. Note that while the current medical office building is vacant, a fully operational medical office building would generate traffic comparable to estimates provided in the applicant's trip generation comparison.

The Traffic Study also sought to explore questions of pedestrian safety in the context of the new development. Sidewalks are currently provided along both sides of Mack Avenue, S. Renaud Road, and Oxford Road, and are proposed internal to the site. The Study explains that "the proposed development includes the removal of one (1) of the existing driveways on Oxford Road, which will reduce the number of conflict points between motorized vehicles and pedestrian / bicycle traffic, thereby improving non-motorized safety".

Findings: Architecture and Building Design:

The proposed building will be primarily composed of high-quality brick with dark grey aluminum accents, with additional glass windows on the top and bottom floor facade. The design of the building follows traditional, high quality architectural design which is encouraged by the Zoning Ordinance.

The architectural design features and requirements will be further reviewed during the Site Plan Review process. At this time, the proposed architectural elements are in line with the traditional, timeless design style of the Mack Avenue corridor and of surrounding residential neighborhoods.



For landscaping, the applicant proposes ornamental grasses and grass lawns adjacent to the proposed building, as well as four new planted trees. A screening wall is proposed along the eastern side of the property, where the site abuts two residential properties. Currently, the screening wall proposed at the east side of the side exceeds maximum height restrictions. To reach compliance with the screening wall requirements, the applicant would need to reduce the masonry wall height to 4 feet or submit for and receive a variance for a taller masonry wall. The screening of the subject site will be determined during the site plan review process.



Conclusions

PROCESS

Following consideration of public comments received during the Public Hearing, the Planning Commission has the following available motions when considering a map amendment (rezoning):

- Recommendation to the City Council for approval of the rezoning; or
- Recommendation to the City Council for denial of the rezoning.
- Table the application.

In the case of approval or denial, the Commission must specify the findings of fact which the decision is based upon.

RECOMMENDATION

It is recommended that the conditional rezoning (map amendment) to the C, Commercial Business District at 20160 Mack Avenue be recommended for approval to the City Council, based on the following findings of fact:

- a. This rezoning and proposed development is consistent with numerous goals from the 2024 Master Plan, including Goal #1 Housing: Provide a range of housing choices for all ages, abilities, and incomes; Goal #2 Economic Development: Elevate Mack Avenue as a thriving, vibrant commercial corridor that meets the daily needs of residents and is a destination for visitors; and Goal #3 Community Character: Strengthen send of place, identity, and character throughout the City and its neighborhoods.
- b. This rezoning brings the site closer to the intentions of the 2024 Master Plan's Future Land Use Plan, which designates the site as "Corridor Mixed Use".
- c. The uses permitted in the C, Commercial Business District, including a mix of retail, office, restaurant, and residential uses, are generally compatible with the commercial nature of Mack Avenue surrounding this property. The applicant must provide appropriate buffering between adjacent properties of dissimilar zoning, per the requirements of the Ordinance, during the site plan review process.
- d. While the Voluntary Conditions offered by the applicant place an additional limitation on the type of future occupancy, i.e.: "The property shall be limited to one potential "quick services restaurant" with no drivethrough and shall not exceed 3,200 square feet", restaurants are subject to the City's Special Land Use process. Should a restaurant be proposed in the future, an additional public hearing and review of the specific use (including maximum occupancy, square footage, available parking, loading, etc.) will be evaluated for compliance with the Zoning Ordinance.
- e. The site meets all Zoning Ordinance dimensional requirements of the C, Commercial Business District. The rezoning allows for a buildable lot and does not create a non-conformity.
- f. The rezoning is not anticipated to significantly alter traffic generation in the area. The proposed uses are anticipated to generate comparable amounts of traffic to that of an operating medical office, and



- pedestrian and non-motorized transportation safety is expected to be improved through sidewalk connectivity and the reduction of a driveway.
- g. The design of the building follows traditional, high quality architectural design which is encouraged by the Zoning Ordinance and is largely compatible with the Mack Avenue Corridor and surrounding neighborhoods.

If you have further questions, please do not hesitate to contact us.

Respectfully submitted,

McKENNA

Ashley Jankowski, AICP

Phley Janhowski

Associate Planner



09/30/2025

Building Department City of Grosse Pointe Woods 20025 Mack Plaza, Grosse Pointe Woods, MI 48236

Re: 20160 Mack Ave.

Architects' Project No.: 2025.018

To Whom it May Concern,

Please find below a detailed written statement fully explaining the request to rezone the property at 20160 Mack Ave.

The existing zoning of the parcel at 20160 Mack Ave. is RO-1 and its current use is for a medical office. The request to rezone this parcel to C Commercial is to permit re-development of the site as a mixed use two-story building. The existing building and parking lot on site are currently in poor condition. The intent of the development group is to demolish the existing building and parking lot and construct a new building approximately 8,800 square feet and parking lot suitable for the proposed commercial and residential uses. The location and layout of ingress and egress on the southern property boundary will be modified to accommodate the new parking layout. There are no proposed changes to the existing property boundaries. All necessary steps will be taken to provide appropriate buffering between adjacent properties of dissimilar zoning per Grosse Pointe Woods City Ordinance. Additional details may be found in the drawings enclosed.

Sincerely,

John A. Vitale, AIA, NCARB

Enclosure: City Submittal Update Drawings

CITY OF GROSSE POINTE WOODS

20025 Mack Plaza, Grosse Pointe Woods, MI 48236 Phone (313) 343-2440

REZONING APPLICATION

1.	Applicant: John Vitale		· · · · · · · · · · · · · · · · · · ·
	Mailing Address: 27172 Woodward Ave. Street	Royal Oak City	48067 Zip
	Daytime Phone: <u>248-546-6700</u>	Fax:248-546-8454	4
2.	Property Owner: Buccellato Development		
	Mailing Address: 20259 Mack Ave, Suite 2	Grosse Pointe Woods, M	11 48236
	Daytime Phone: <u>(313)</u> 300-7280	Fax:	
3.	Project Manager: (required) John Vitale		
	Mailing Address: 27172 Woodward Ave.	Royal Oak	48067
	Street	City	Zip
	Daytime Phone: <u>248-546-6700</u>	_ Fax: <u>248-546-8454</u>	
	Other Phone: 313-516-9810		· · · · · · · · · · · · · · · · · · ·
4.	Address of Property: 20160 Mack Ave, Gro	sse Pointe Woods, MI 48	3236
5.	Legal Description of Property: See attached	d Legal Description	
	(or attach a legal boundary description)		
6.	Permanent Parcel Number: 400090100010	000	
7.	Request: To Rezone From: RO-1	To:	
	For the Following Purpose: RE-DEVELOPMENT OF THE SITE FOR M	MIXED USE	

Attach a detailed written statement fully explaining your request.

8. Present Use of Property: EXISTING MEDICAL OFFICE

- 9. Attach an Accurate Drawing of the Site Showing:
 - a) Property boundaries
 - b) Existing buildings
 - c) Unusual physical features of the site or building
 - d) Abutting streets
 - e) Existing zoning on adjacent properties
 - f) Location of buildings on adjacent properties
- 10. Names and Addresses of all other Persons, Firms or Corporations having a Legal or Equitable Interest in the Property:

	V	1	Δ
П	N	/	_

Applicant must provide lease, purchase agreement or written authorization from Owner.

DECLARATION:

I, the applicant, do hereby declare that I am the owner, or the authorized agent of the owner, of the above, legally described property on which the request is proposed, and that the answers given herein are true to the best of my knowledge. I understand that if the request is granted, I am in no way relieved from all other applicable requirements of the City of Grosse Pointe Woods Zoning Ordinance.

By virtue of my application, I do hereby declare that the appropriate appointed officials and City staff responsible for the review of my application are given permission to visit and inspect the property regarding my petition in order to determine the suitability of the request.

Applicant Signature:

Date: 09/30/2025

Filing Fee: \$750.00 + Public Hearing Fee \$375



Date: 9/30/2025

City Council of Grosse Pointe Woods 20025 Mack Plaza Drive Grosse Pointe Woods, MI 48236

Subject: Conditional Rezoning Request — Proposed Conditions

To Whom it May Concern,

On behalf of Buccellato Development and Mack & Oxford, LLC, we are submitting the following conditions in support of our request for conditional rezoning of the property located at 20160 Mack Ave. Grosse Pointe Woods, MI 48236.

- 1. Limitation on type of occupancy The property shall be limited to one potential "quick service restaurant" with no drive through and shall not exceed 3,200 square feet.
- 2. Residential Use We are committed to a second-story residential use consisting of up to seven (7) apartment units.
- 3. Hours of Operation The restaurant shall operate approximately between the hours of 6:00 a.m. and 10:00 p.m. Hard liquor sales or service shall not be permitted.
- 4. Setbacks Setbacks shall be as shown on Site Plan A-1.
- 5. Provide Dust Mitigation Plan at time of construction.
- 6. Construction Hours per city of GPW City Ordinances.

These conditions are proposed to ensure that the development remains compatible with the surrounding area and consistent with the intent of the GPW zoning ordinance.

Thank you for your review and consideration of this request.

Sincerely, Justin A. Buccellato Buccellato Development

MIXED-USE DEVELOPMENT

20160 Mack Ave, Grosse Pointe Woods, MI 48236

DEVELOPER

BUCCELLATO DEVELOPMENT 20259 MACK AVE, SUITE 2 GROSSE POINTE WOODS, MI 48236 (313) 300-7280

ARCHITECT

STUCKY VITALE ARCHITECTS 27172 WOODWARD AVENUE **ROYAL OAK, MICHIGAN 48067** (248) 546-6700

PROJECT INFORMATION


RE-DEVELOPMENT OF EXISTING SITE FOR MIXED USE, TWO-STORY.

DEMOLITION OF EXISTING STRUCTURE & CONSTRUCTION OF NEW MIXED USE

IMPROVEMENTS TO EXISTING SITE AND PARKING LOT.

	SHEET INDEX - GENERA	L	
DWG#	DRAWING NAME	ISSUED FOR	DATE
G1	COVER SHEET, GENERAL INFORMATION, DRAWING INDEX	CITY SUBMITTAL	09.30.25
DRAWING	3S: 1	·	·
	SHEET INDEX - ARCHITECTU	JRAL	
DWG#	DRAWING NAME	ISSUED FOR	DATE
A1	SITE PLAN + LANDSCAPE PLAN + DETAILS	CITY SUBMITTAL	09.30.25
A2	EXTERIOR ELEVATIONS + RENDERING	CITY SUBMITTAL	09.30.25
A3	FLOOR PLAN - GROUND LEVEL	CITY SUBMITTAL	09.30.25
A4	FLOOR PLAN - UPPER LEVEL	CITY SUBMITTAL	09.30.25
DRAWING	3S: 4		
	SHEET INDEX - REFERENCE	CE	
DWG#	DRAWING NAME	ISSUED FOR	DATE
1 OF 1	PHOTOMETRIC PLAN	CITY SUBMITTAL	09.30.25
	LIGHT FIXTURE SPECIFICATIONS		
1 OF 1	ALTA/NSPS LAND TITLE SURVEY	CITY SUBMITTAL	09.30.25
DRAWING	GS: 2		

<u>NOTE:</u>
THESE CONSTRUCTION DRAWINGS WERE PREPARED FOR COMPLIANCE WITH THE MICHIGAN CONSTRUCTION CODES IN EFFECT AT THE TIME OF PERMIT SUBMITTAL. ALL ENGINEERS, CONTRACTORS AND SUPPLIERS INVOLVED WITH THIS PROJECT SHALL COMPLY WITH THE SAME CODES, ISSUED AND APPROVED CODE MODIFICATIONS AND/OR CITY CODE AUTHORITY CONSTRUCTION BOARDS OF APPEALS RULINGS AND WHENEVER REQUIRED SHALL PROVIDE SHOP DRAWINGS AND SUBMITTALS CLEARLY DESCRIBING COMPLIANCE TO THE REGISTERED DESIGN PROFESSIONAL IN RESPONSIBLE CHARGE FOR REVIEW AND APPROVAL

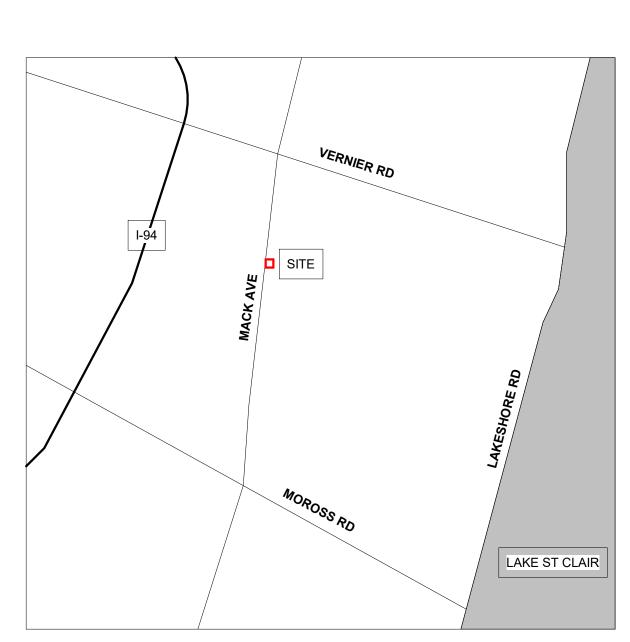






CONCEPTUAL RENDERING

SYMBOL LEGEND



(A101) INTERIOR ELEVATION TAG

EXTERIOR ELEVATION TAG

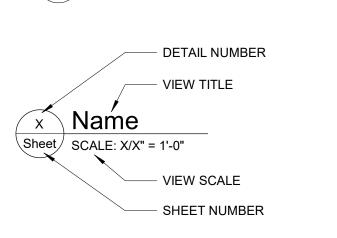

ROOM NAME ROOM NAME ROOM TAG

DATUM WORKPOINT

COLUMN GRIDS NUMBERS DESIGNATE VERTICAL COLUMN LINES LETTERS DESIGNATE

HORIZONTAL COLUMN LINES SQUARE DESIGNATE EXISTING COLUMN GRID

DOOR TAGS NEW DOOR TAG DESIGNATION

EXISTING DOOR TAG **DESIGNATION (ONLY IF** EXISTING DOOR TO BE MODIFIED)

2C3-Ys PARTITION TAG

 $\langle xx \rangle$ KEYNOTE TAG

SHEET REF FOR DRAWING CONTINUATION

EQUIPMENT TAG

MATCH LINE

LVT

MAX

MFR.

MIN.

LUXURY VINYL TILE

MANUFACTURER

MISCELLANEOUS

MASONRY OPENING

MAXIMUM MECHANICAL

MINIMUM

ABBREVIATION LEGEND ¢ or ← CENTERLINE ANGLE DIAMETER PLUS OR MIN **ACCESSIBILITY** ACCESS. ACOUS. ACOUSTICAL NOT IN CONTRACT ACT ACOUSTICAL CEILING TILE NOMINAL NTS AREA DRAIN NOT TO SCALE A.D. O/C OFC OPNG ADJ **ADJUSTABLE** ON CENTER A.F.F. ABOVE FINISH FLOOR **OPENING** ALUMINUM OPP ANOD. ANODIZED **OPPOSITE** OVFD ARCH. ARCHITECTURAL or ARCHITECT OVERFLOW DRAIN ASPH. **ASPHALT** PLASTIC LAMINATE PLAS BARRIER FREE PLASTER BLDG. PNT BUILDING PLYWD PLYWOOD BLK'G. BLOCKING PREFAB BOT. BOTTOM PREFABRICATED PREFINISH or PREFINISHED CAB. PROJ CABINET PROJECTION CEM. CEMENT C.J. CONTROL JOINT REFLECTED CEILING PLAN CLG CEILING COLD FORMED METAL FRAMING R.C. **ROOF CONDUCTOR** C.O. CLEAN OUT **ROOF DRAIN** CLO. CLOSET REINF REINFORCING CLR. CLEAR REQ'D REQUIRED COL. COLUMN RESIL RESILIENT CONC. CONCRETE ROOFING CORNER GUARD CONST. CONSTRUCTION R.S. **ROOF SUMP** CONT. CONTINUOUS SAN SANITARY COR. SOLID CORE CORRIDOR SCHED CORR. CORRUGATED SCHEDULE CPT SIM C.T. CERAMIC TILE SIMILAR CTSK **COUNTER SUNK** SPEC **SPECIFICATIONS CURTAIN WALL** ST.STL STAINLESS STEEI DRINKING FOUNTAIN DET. **SOLID SURFACE** DIAMETER STD STL DIM. DIMENSION STANDARD STEEL STN DOOR OPENING STAIN D.O. STOR STORAGE STRUCT STRUCTURAL or STRUCTURE DOWN SPOUT DWG. DRAWING SUSP SUSPENDED DWR. DRAWER SYMMETRICAL **EXPANSION JOINT** T&B TOP AND BOTTOM **ELEVATION** TERRAZZO T.O.C. ELEC. ELECTRICAL TOP OF CURB **ELEVATOR** T&G TONGUE AND GROOVE ELEV. E.O.S./EOS EDGE OF SLAB THK E.O.D./EOD EDGE OF DECK THRES. THRESHOLD ELECTRICAL PANEL T.O.P. **TOP OF PARAPET** EPX **EPOXY TOILET ACCESSORY** EQ. **EQUAL** TELEVISION **EQUIPMENT** T.O.W. **EACH WAY** TOS / T.O.S. TOP OF STEEL EXIST. / EX **TYPICAL** U/C UNDERCUT EXTERIOR UNLESS NOTED OTHERWISE U.SK. V.B. FIRE ALARM UTILITY SINK VAPOR BARRIER FLOOR DRAIN VCT VERT. FOUNDATION VINYL COMPOSITION TILE FIRE EXTINGUISHER VERTICAL VEST FIRE EXTINGUISHER CABINET VESTIBULE FIRE HOSE CABINET VINYL FLOORING V.I.F. FIN VERIFY IN FIELD **FLOOR** WIDTH WALL BASE F.O.S. FACE OF STUD **FPRF FIREPROOF** W.C. WATER CLOSET WC WALLCOVERING WD FIBERGLASS REINFORCED PANEL WOOD FIRE RETARDANT TREATED WITHOUT WATER RESISTANT FULL SIZE WSCT. FOOT or FEET WAINSCOT FOOTING WT. WEIGHT W.W.F. FUR WELDED WIRE FABRIC **FURRING** GAUGE GALVANIZED **GRAB BAR** GFRC. GLASS FIBER REINFORCED CONCRETE GYP. **GYPSUM** HOSE BIBB H.C. **HOLLOW CORE** HDWD HARDWOOD **HDWE** HARDWARE **HOLLOW METAL** HORIZ. HORIZONTAL HGT HEIGHT INSUL INSULATION INSULATED METAL PANEL INSULATED METAL WALL PANEL INTERIOR JANITOR'S CLOSET KITCHEN LAVATORY LENGTH L.L.V. LONG LEG VERTICAL

STUCKY VITALE ARCHITECTS 27172 WOODWARD AVENUE ROYAL OAK, MI 48067-0925 P. 248.546.6700 F. 248.546.8454

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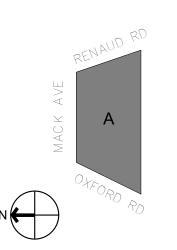
Consultants



Project: MIXED-USE DEVELOPMENT

20160 Mack Ave, Grosse Pointe Woods, MI 48236

Key Plan:



Issued for

CITY SUBMITTAL 09.30.25


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Checked by:

Sheet Title: COVER SHEET, GENERAL INFORMATION, DRAWING INDEX

Project No. 2025.018

Sheet No. G¹

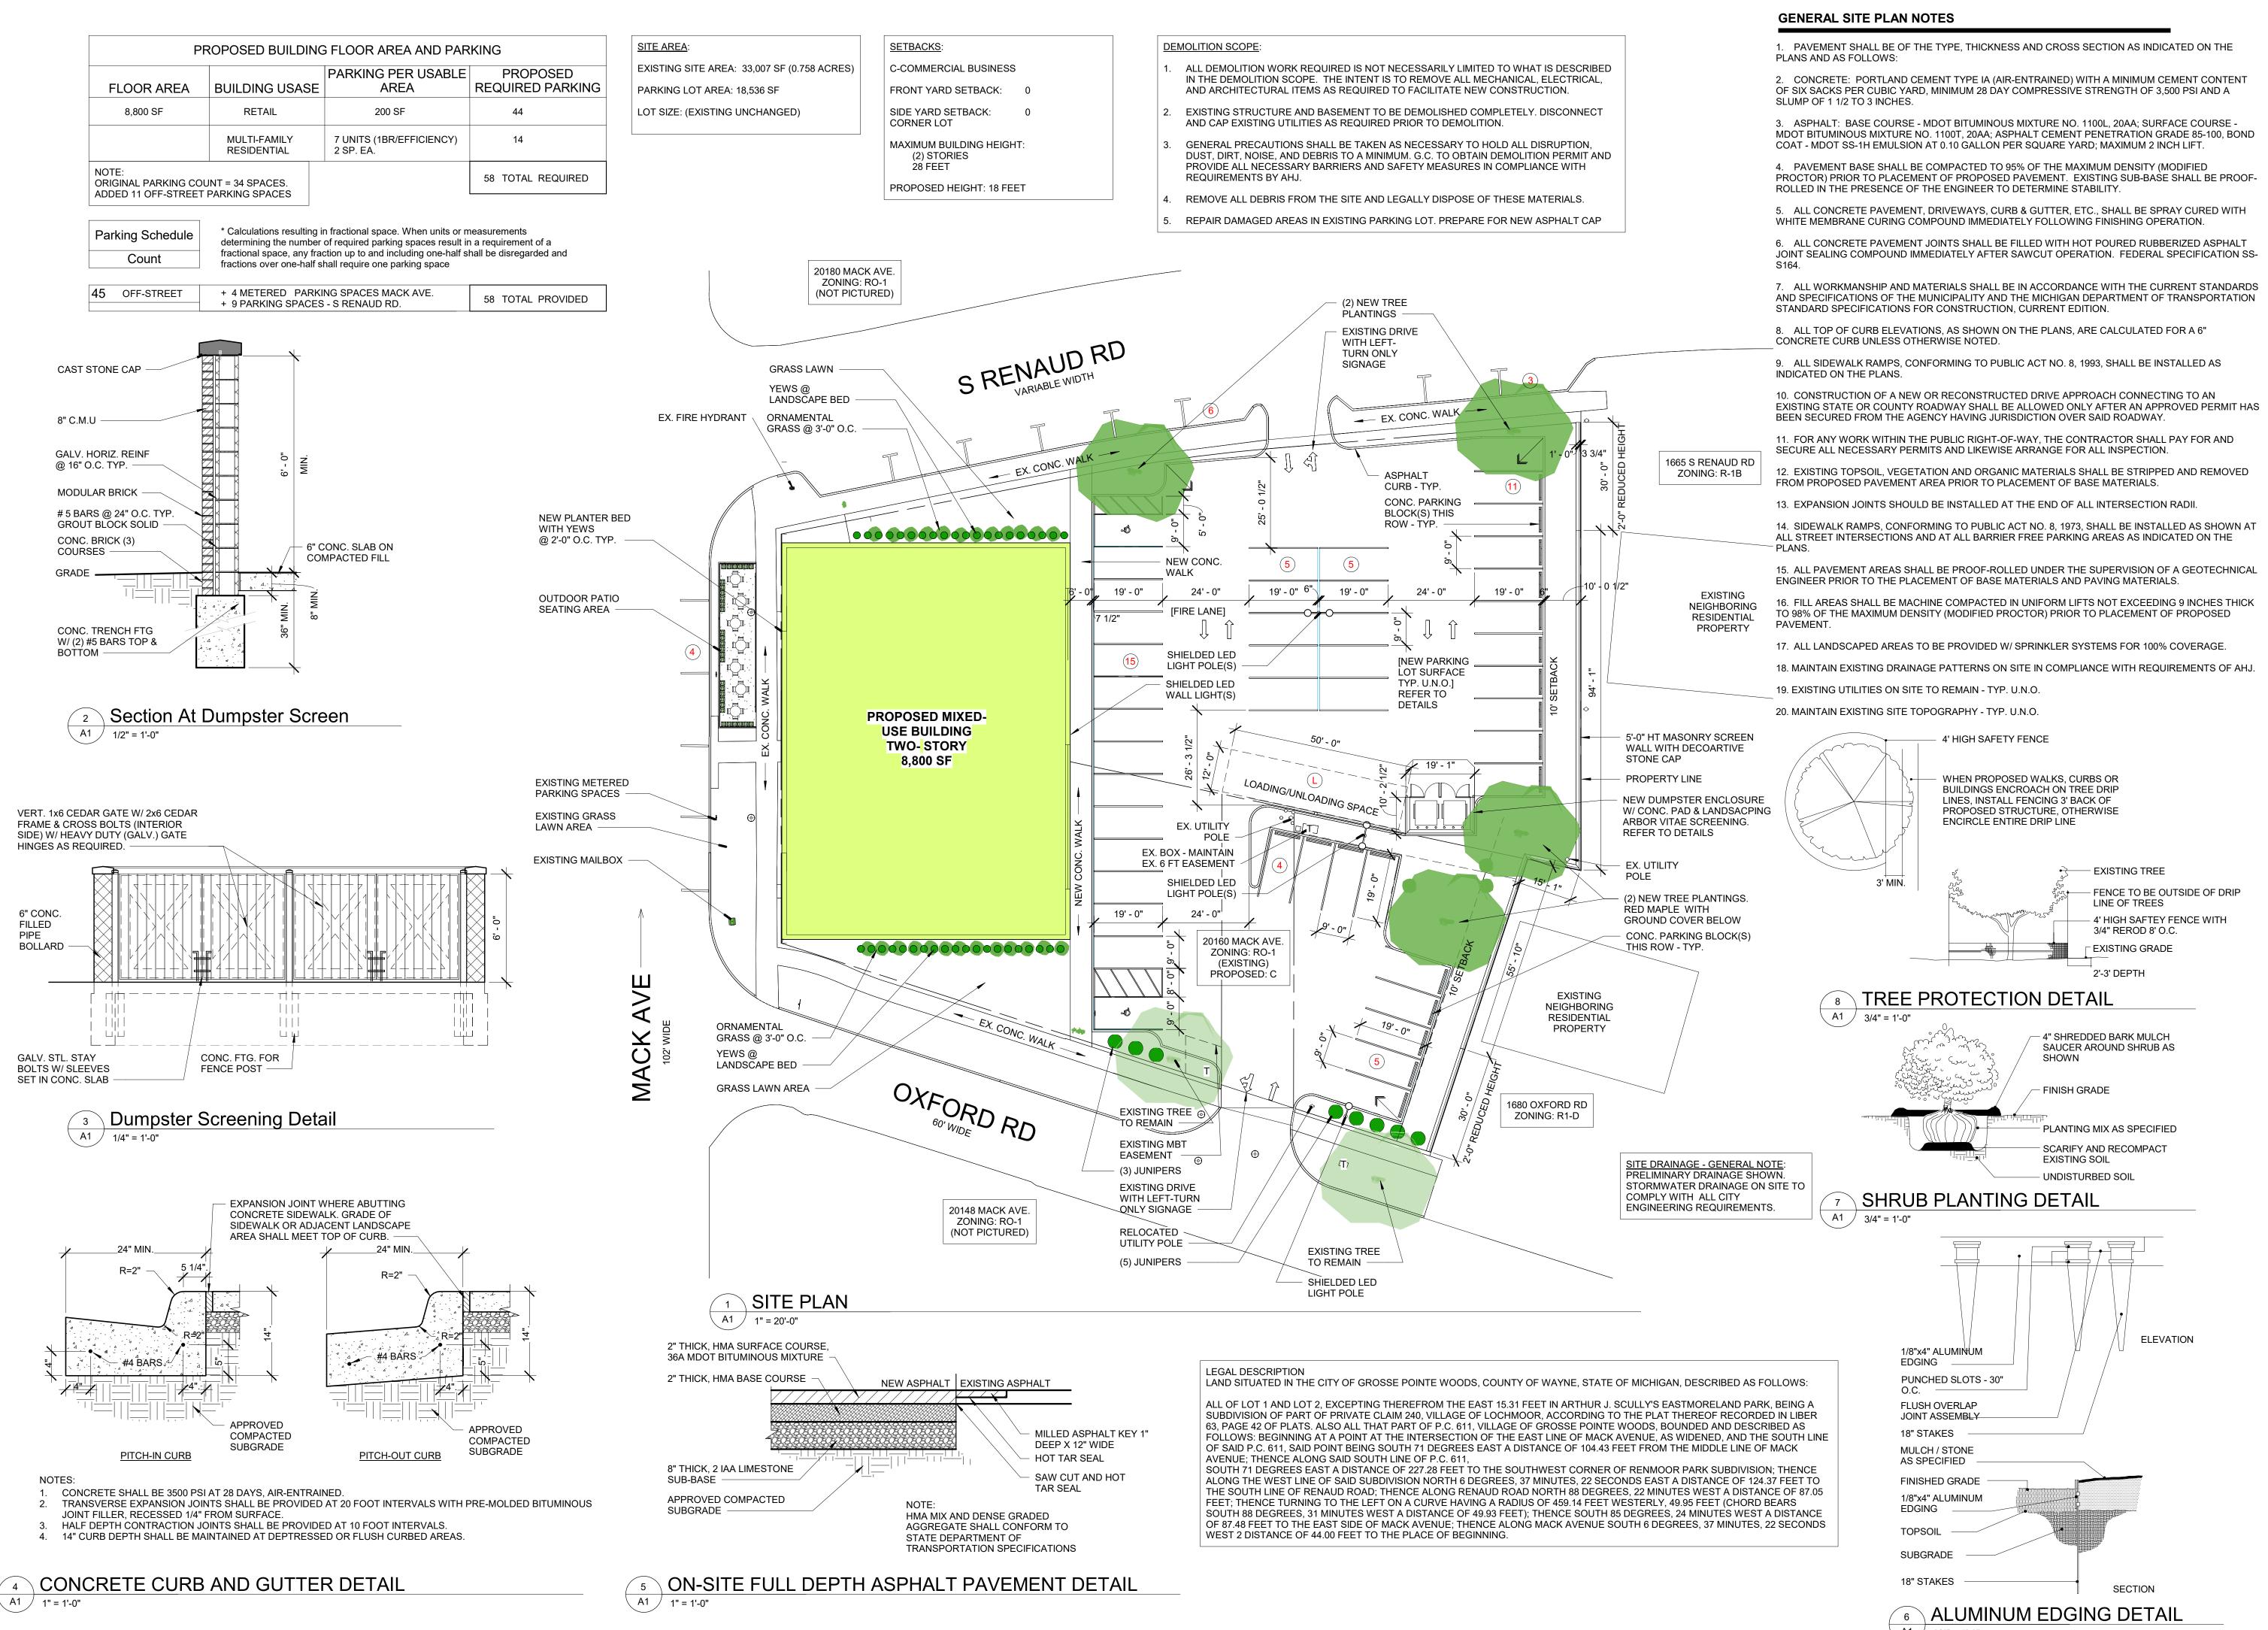

STUCKY VITALE ARCHITECTS 27172 WOODWARD AVENUE

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F. 248.546.8454 WWW.STUCKYVITALE.COM

Consultants

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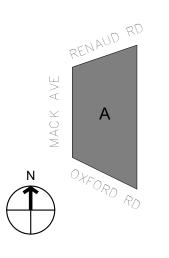
JOHN A. VITALE ARCHITECT 1301029086

Project: **MIXED-USE**

DEVELOPMENT

20160 Mack Ave, Grosse Pointe Woods, MI 48236

Key Plan:



Issued for

CITY SUBMITTAL

09.30.25

Drawn by JGB, JPM

Checked by JPM, JAV

DETAILS

Sheet Title SITE PLAN + LANDSCAPE PLAN +

Project No. 2025.018

Sheet No.

A

A1 $\int 3/4" = 1'-0"$

E	EXTE	RIOR FINISH SCHEDULE
MASONRY	BR-1	BRICK MFG: BELDEN BRICK OR APPROVED EQUAL COLOR: BELCREST 730 - OR SIMILAR SIZE: MODULAR
WIND.	SF-1	STOREFRONT MFG: KAWNEER OR SIMILAR COLOR: NIGHT HAWK GRAY FINISH: POWDER COATED (OR EQUAL) SIZE: (VARIES)
DOORS	DR-1	ALUMINUM ENTRANCE DOOR SYSTEM MFG: KAWNEER OR APPROVED EQUAL STYLE: 2" X 6" COLOR: TO MATCH WINDOW FRAME WITH CLEAR GLASS
GLASS	GL-1	ALL GLASS TO BE: 1", LOW-E, INSULATED GLASS MFR: VIRACON OR APPROVED EQUAL COLOR/STYLE: CLEAR
MISC.	TR-1	TRIM: FIBER CEMENT BOARD - HARDIE OR APPROVED EQUAL COLOR: DARK GRAY TO MATCH STOREFRONT
Σ	MTL-1	COPING: PREFINISHED ALUMINUM COLOR: MATCH ADJACENT MATERIALS
	MTL-2	RAILING: PREFINISHED ALUMINUM COLOR: MATCH ADJACENT MATERIALS

SIGNAGE - GENERAL NOTE:

SIGNAGE AREAS TO COMPLY WITH CITY OF GROSSE POINTE WOODS ZONING ORDINANCE. ALL TENANT SIGNAGE TO BE PERMITTED SEPARATELY.



CONCEPTUAL RENDERING - EXTERIOR



STUCKY VITALE ARCHITECTS 27172 WOODWARD AVENUE ROYAL OAK, MI 48067-0925 P. 248.546.6700

F. 248.546.8454 WWW.STUCKYVITALE.COM


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Project: MIXED-USE DEVELOPMENT

20160 Mack Ave, Grosse Pointe Woods, MI 48236

Key Plan:



Issued for CITY SUBMITTAL 09.30.25

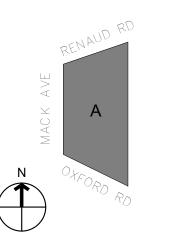Drawn by: JGB, JPM

Checked by: JPM, JAV

Sheet Title: EXTERIOR ELEVATIONS + RENDERING

Project No. 2025.018


Sheet No.

A2

PROPOSED MIXED-**USE BUILDING** TWO-STORY

> 8,800 SF **FOOTPRINT**



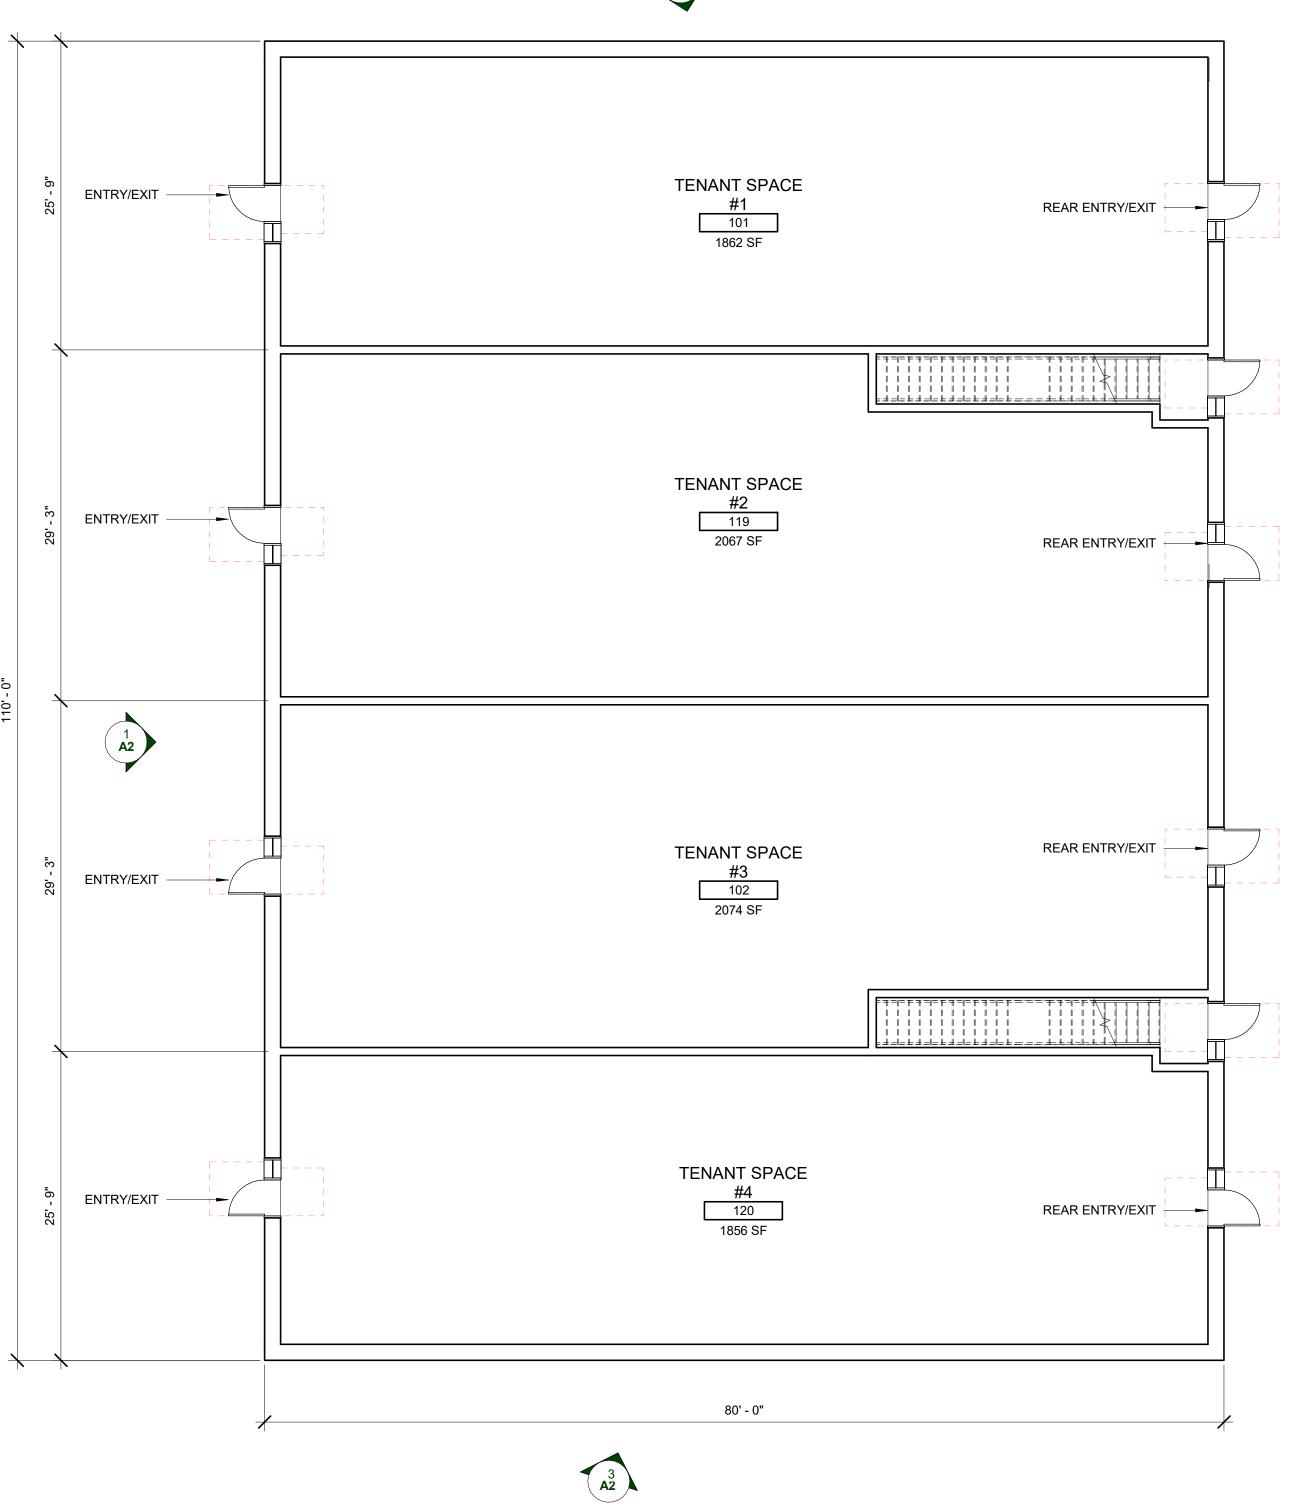

FLOOR PLAN - GROUND LEVEL

GENERAL FLOOR PLAN NOTES

- 1. THIS DRAWING IS DIAGRAMMATIC AND SHOULD BE USED TO DETERMINE THE DESIGN INTENT. THE CONTRACTOR IS RESPONSIBLE FOR THE COMPLETE SET OF WORK AS INDICATED AND SHALL FIELD VERIFY ALL WORK, COORDINATE ALL DRAWINGS / NEW WORK AND SHALL NOTIFY ARCHITECT IMMEDIATELY OF ANY DISCREPANCIES IN THE DOCUMENTS BEFORE PROCEEDING. FAILURE TO DO SO WILL RESULT IN THE CONTRACTOR TAKING FULL RESPONSIBILITY AND LIABILITY FOR SAID DISCREPANCIES.
- 2. ALL DIMENSIONS ARE SHOWN FROM FINISH FACE TO FINISH FACE OF PARTITION UNLESS OTHERWISE NOTED.
- 3. WALL THICKNESS' ARE NOMINAL NOT ACTUAL DIMENSIONS. SEE WALL SCHEDULE FOR ACTUAL DIMENSIONS.
- 4. ALL WOOD, INCLUDING BLOCKING, USED ON THE PROJECT SHALL BE FIRE RETARDANT TREATED.
- 5. ALL WORK SHALL BE DONE IN ACCORDANCE WITH ALL LOCAL, STATE, COUNTY CODE REGULATIONS, O.S.H.A., AND THE AMERICAN WITH DISABILITIES ACT (ADA). REFER TO THE CODE PLAN FOR MORE INFORMATION.
- 6. PROVIDE POSITIVE SLOPE TO ALL FLOOR DRAINS WHILE KEEPING FLOOR LEVEL AT WALL BASE CONDITION.
- 7. PROVIDE TRANSITION STRIPS AT EACH CHANGE IN FLOOR FINISH MATERIALS.
- 8. PROVIDE CONTROL JOINTS IN GYPSUM BOARD PARTITIONS AT 30'-0" O.C. MAXIMUM AND AS INDICATED IN THE CONTRACT DOCUMENTS.
- 9. CONTRACTOR SHALL CONDUCT A ROUGH ELECTRICAL INSPECTION WITH OWNER, PRIOR TO ENCLOSING WALLS, FOR THE PURPOSE OF CONFIRMING ALL J-BOX LOCATIONS FOR POWER, DATA, VOICE, SWITCH, THERMOSTAT, ETC.
- 10. A TACTILE SIGN STATING 'EXIT' AND COMPLYING WITH ICC-A117.1 SHALL BE PROVIDED ADJACENT TO EACH DOOR TO AN 'AREA OF REFUGE', AN EXTERIOR AREA FOR ASSISTED RESCUE, AN EXIT STAIRWAY, AN EXIT RAMP, AN EXIT PASSAGEWAY, AND THE EXIT DISCHARGE.
- 11. PROVIDE PERMANENT MIN 3-INCH HIGH CONTRASTING COLOR MARKING AND IDENTIFICATION AT ALL FIRE WALLS, FIRE BARRIERS, FIRE PARTITIONS, SMOKE BARRIERS, SMOKE PARTITIONS OR ANY OTHER WALL REQUIRED TO HAVE PROTECTED OPENINGS OR PENETRATIONS WITHIN 15 FEET AT THE END OF EACH WALL, AND NOT EXCEEDING 30 FEET MAXIMUM HORIZONTAL INTERVALS, MINIMUM 2 LOCATIONS EACH WALL. TYPICAL FOR ACCESSIBLE CONCEALED FLOOR, FLOOR-CEILING, OR ATTIC SPACES PER CODE (MBC 703.7)





STUCKY VITALE ARCHITECTS

27172 WOODWARD AVENUE ROYAL OAK, MI 48067-0925 P. 248.546.6700

F. 248.546.8454

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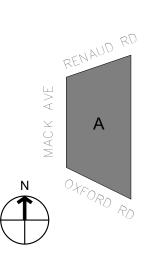
Consultants



MIXED-USE DEVELOPMENT

20160 Mack Ave, Grosse Pointe Woods, MI 48236

Key Plan:



Issued for

CITY SUBMITTAL 09.30.25

Drawn by:

Checked by:


Sheet Title :

FLOOR PLAN - GROUND LEVEL

Project No.

Sheet No.

A3

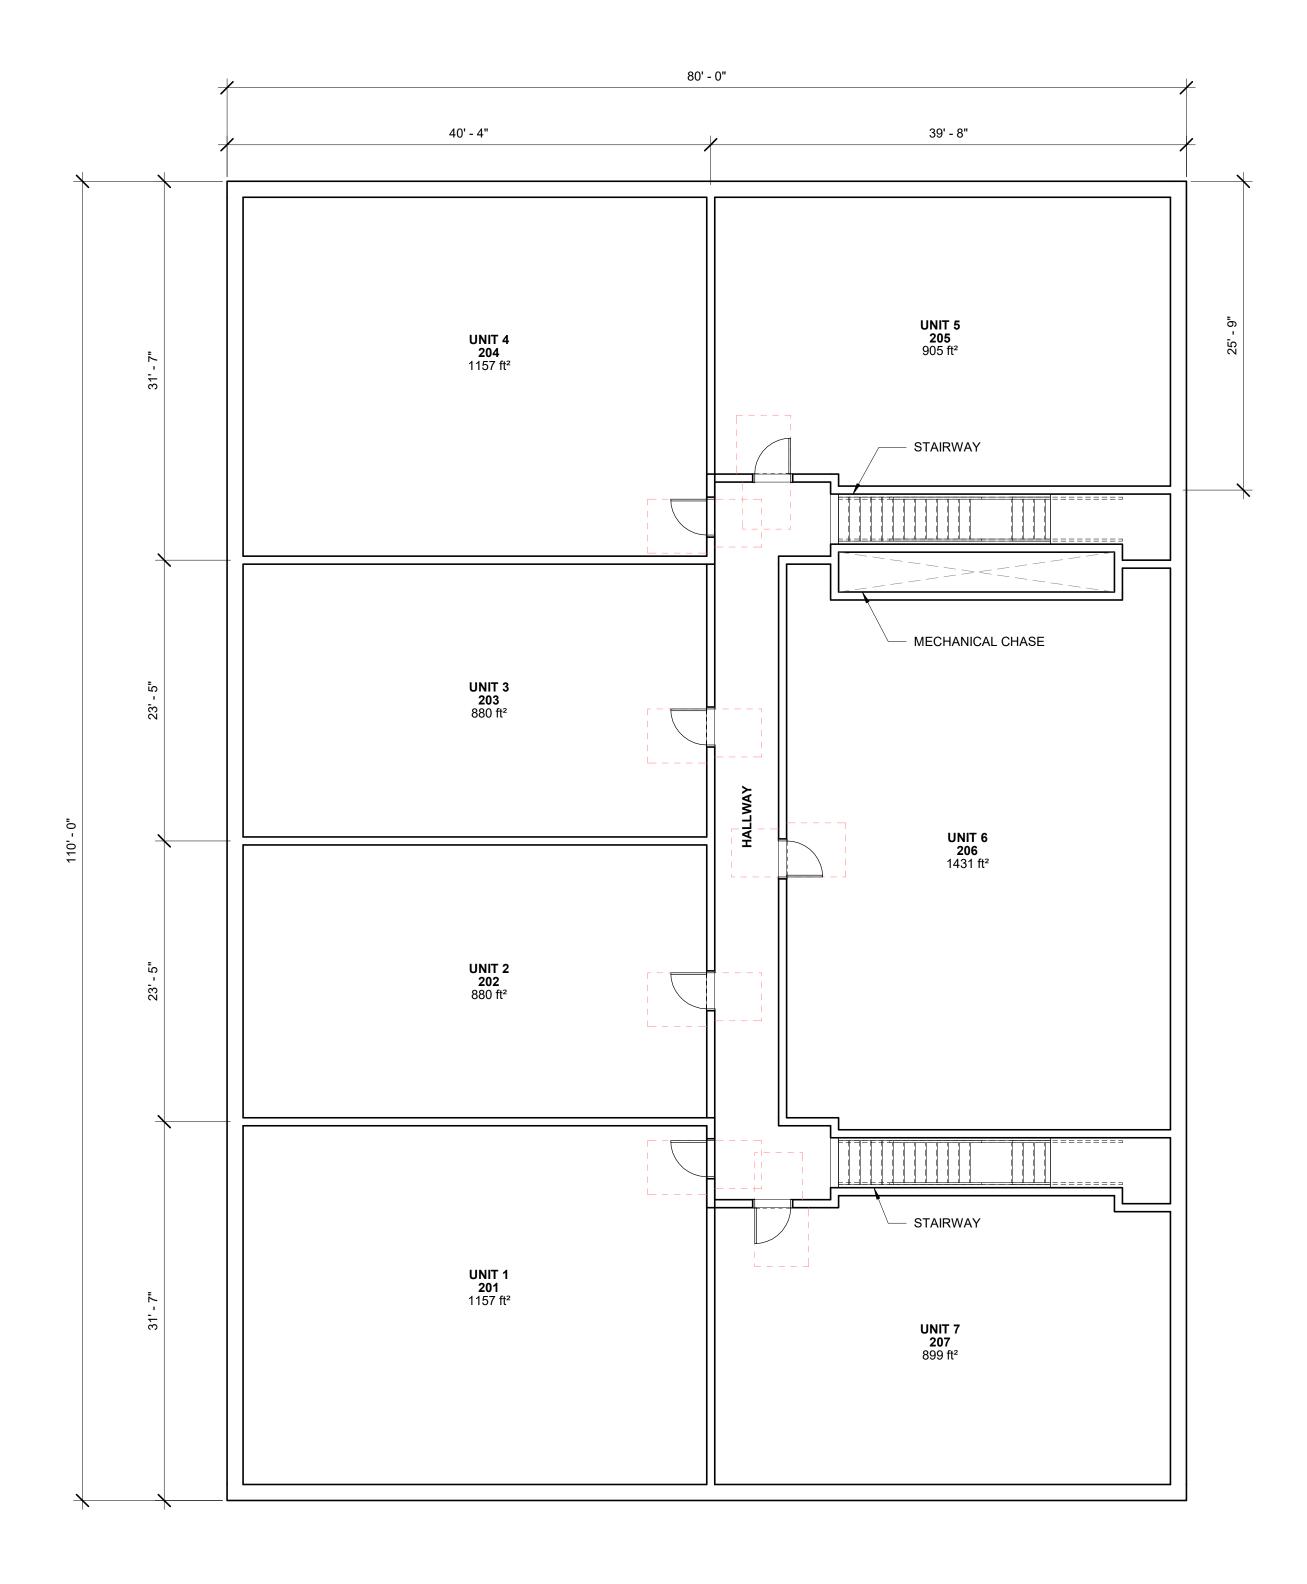

T FLOOR PLAN - UPPER LEVEL

GENERAL FLOOR PLAN NOTES

- 1. THIS DRAWING IS DIAGRAMMATIC AND SHOULD BE USED TO DETERMINE THE DESIGN INTENT. THE CONTRACTOR IS RESPONSIBLE FOR THE COMPLETE SET OF WORK AS INDICATED AND SHALL FIELD VERIFY ALL WORK, COORDINATE ALL DRAWINGS / NEW WORK AND SHALL NOTIFY ARCHITECT IMMEDIATELY OF ANY DISCREPANCIES IN THE DOCUMENTS BEFORE PROCEEDING. FAILURE TO DO SO WILL RESULT IN THE CONTRACTOR TAKING FULL RESPONSIBILITY AND LIABILITY FOR SAID DISCREPANCIES.
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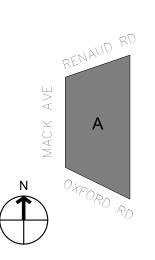


Project:

MIXED-USE DEVELOPMENT

20160 Mack Ave, Grosse Pointe Woods, MI 48236

Key Plan:



Issued for

CITY SUBMITTAL 09.30.25

Drawn by:

Checked by:

Sheet Title : FLOOR PLAN - UPPER LEVEL

Project No.

Sheet No.

A4

General Note

- 1. SEE SCHEDULE FOR LUMINAIRE MOUNTING HEIGHT.
- 2. SEE LUMINAIRE SCHEDULE FOR LIGHT LOSS FACTOR.
- 3. CALCULATIONS ARE SHOWN IN FOOTCANDLES AT: GRADE

THE ENGINEER AND/OR ARCHITECT MUST DETERMINE APPLICABILITY OF THE LAYOUT TO EXISTING / FUTURE FIELD CONDITIONS. THIS LIGHTING LAYOUT REPRESENTS ILLUMINATION LEVELS CALCULATED FROM LABORATORY DATA TAKEN UNDER CONTROLLED CONDITIONS IN ACCORDANCE WITH ILLUMINATING ENGINEERING SOCIETY APPROVED METHODS. ACTUAL PERFORMANCE OF ANY MANUFACTURER'S LUMINAIRE MAY VARY DUE TO VARIATION IN ELECTRICAL VOLTAGE, TOLERANCE IN LAMPS, AND OTHER VARIABLE FIELD CONDITIONS. MOUNTING HEIGHTS

INDICATED ARE FROM GRADE AND/OR FLOOR UP. THESE LIGHTING CALCULATIONS ARE NOT A SUBSTITUTE FOR INDEPENDENT ENGINEERING ANALYSIS OF LIGHTING

ENERGY CODE AND LIGHTING QUALITY COMPLIANCE.

SYSTEM SUITABILITY AND SAFETY. THE ENGINEER AND/OR ARCHITECT IS RESPONSIBLE TO REVIEW FOR MICHIGAN

UNLESS EXEMPT, PROJECT MUST COMPLY WITH LIGHTING CONTROLS REQUIRMENTS DEFINED IN ASHRAE 90.1 2019. FOR SPECIFIC INFORMATION CONTACT GBA CONTROLS GROUP AT CONTROLS@GASSERBUSH.COM OR 734-266-6705.

Alternates Note

THE USE OF FIXTURE ALTERNATES MUST BE RESUBMITTED TO THE CITY FOR APPROVAL.

Ordering Note

QUOTES@GASSERBUSH.COM OR 734-266-6705.


Drawing Note

THIS DRAWING WAS GENERATED FROM AN ELECTRONIC IMAGE FOR ESTIMATION PURPOSE ONLY. LAYOUT TO BE VERIFIED IN FIELD BY OTHERS.

FOR INQUIRIES CONTACT GASSER BUSH AT

Mounting Height Note

MOUNTING HEIGHT IS MEASURED FROM GRADE TO FACE OF FIXTURE. POLE HEIGHT SHOULD BE CALCULATED AS THE MOUNTING HEIGHT LESS BASE HEIGHT.

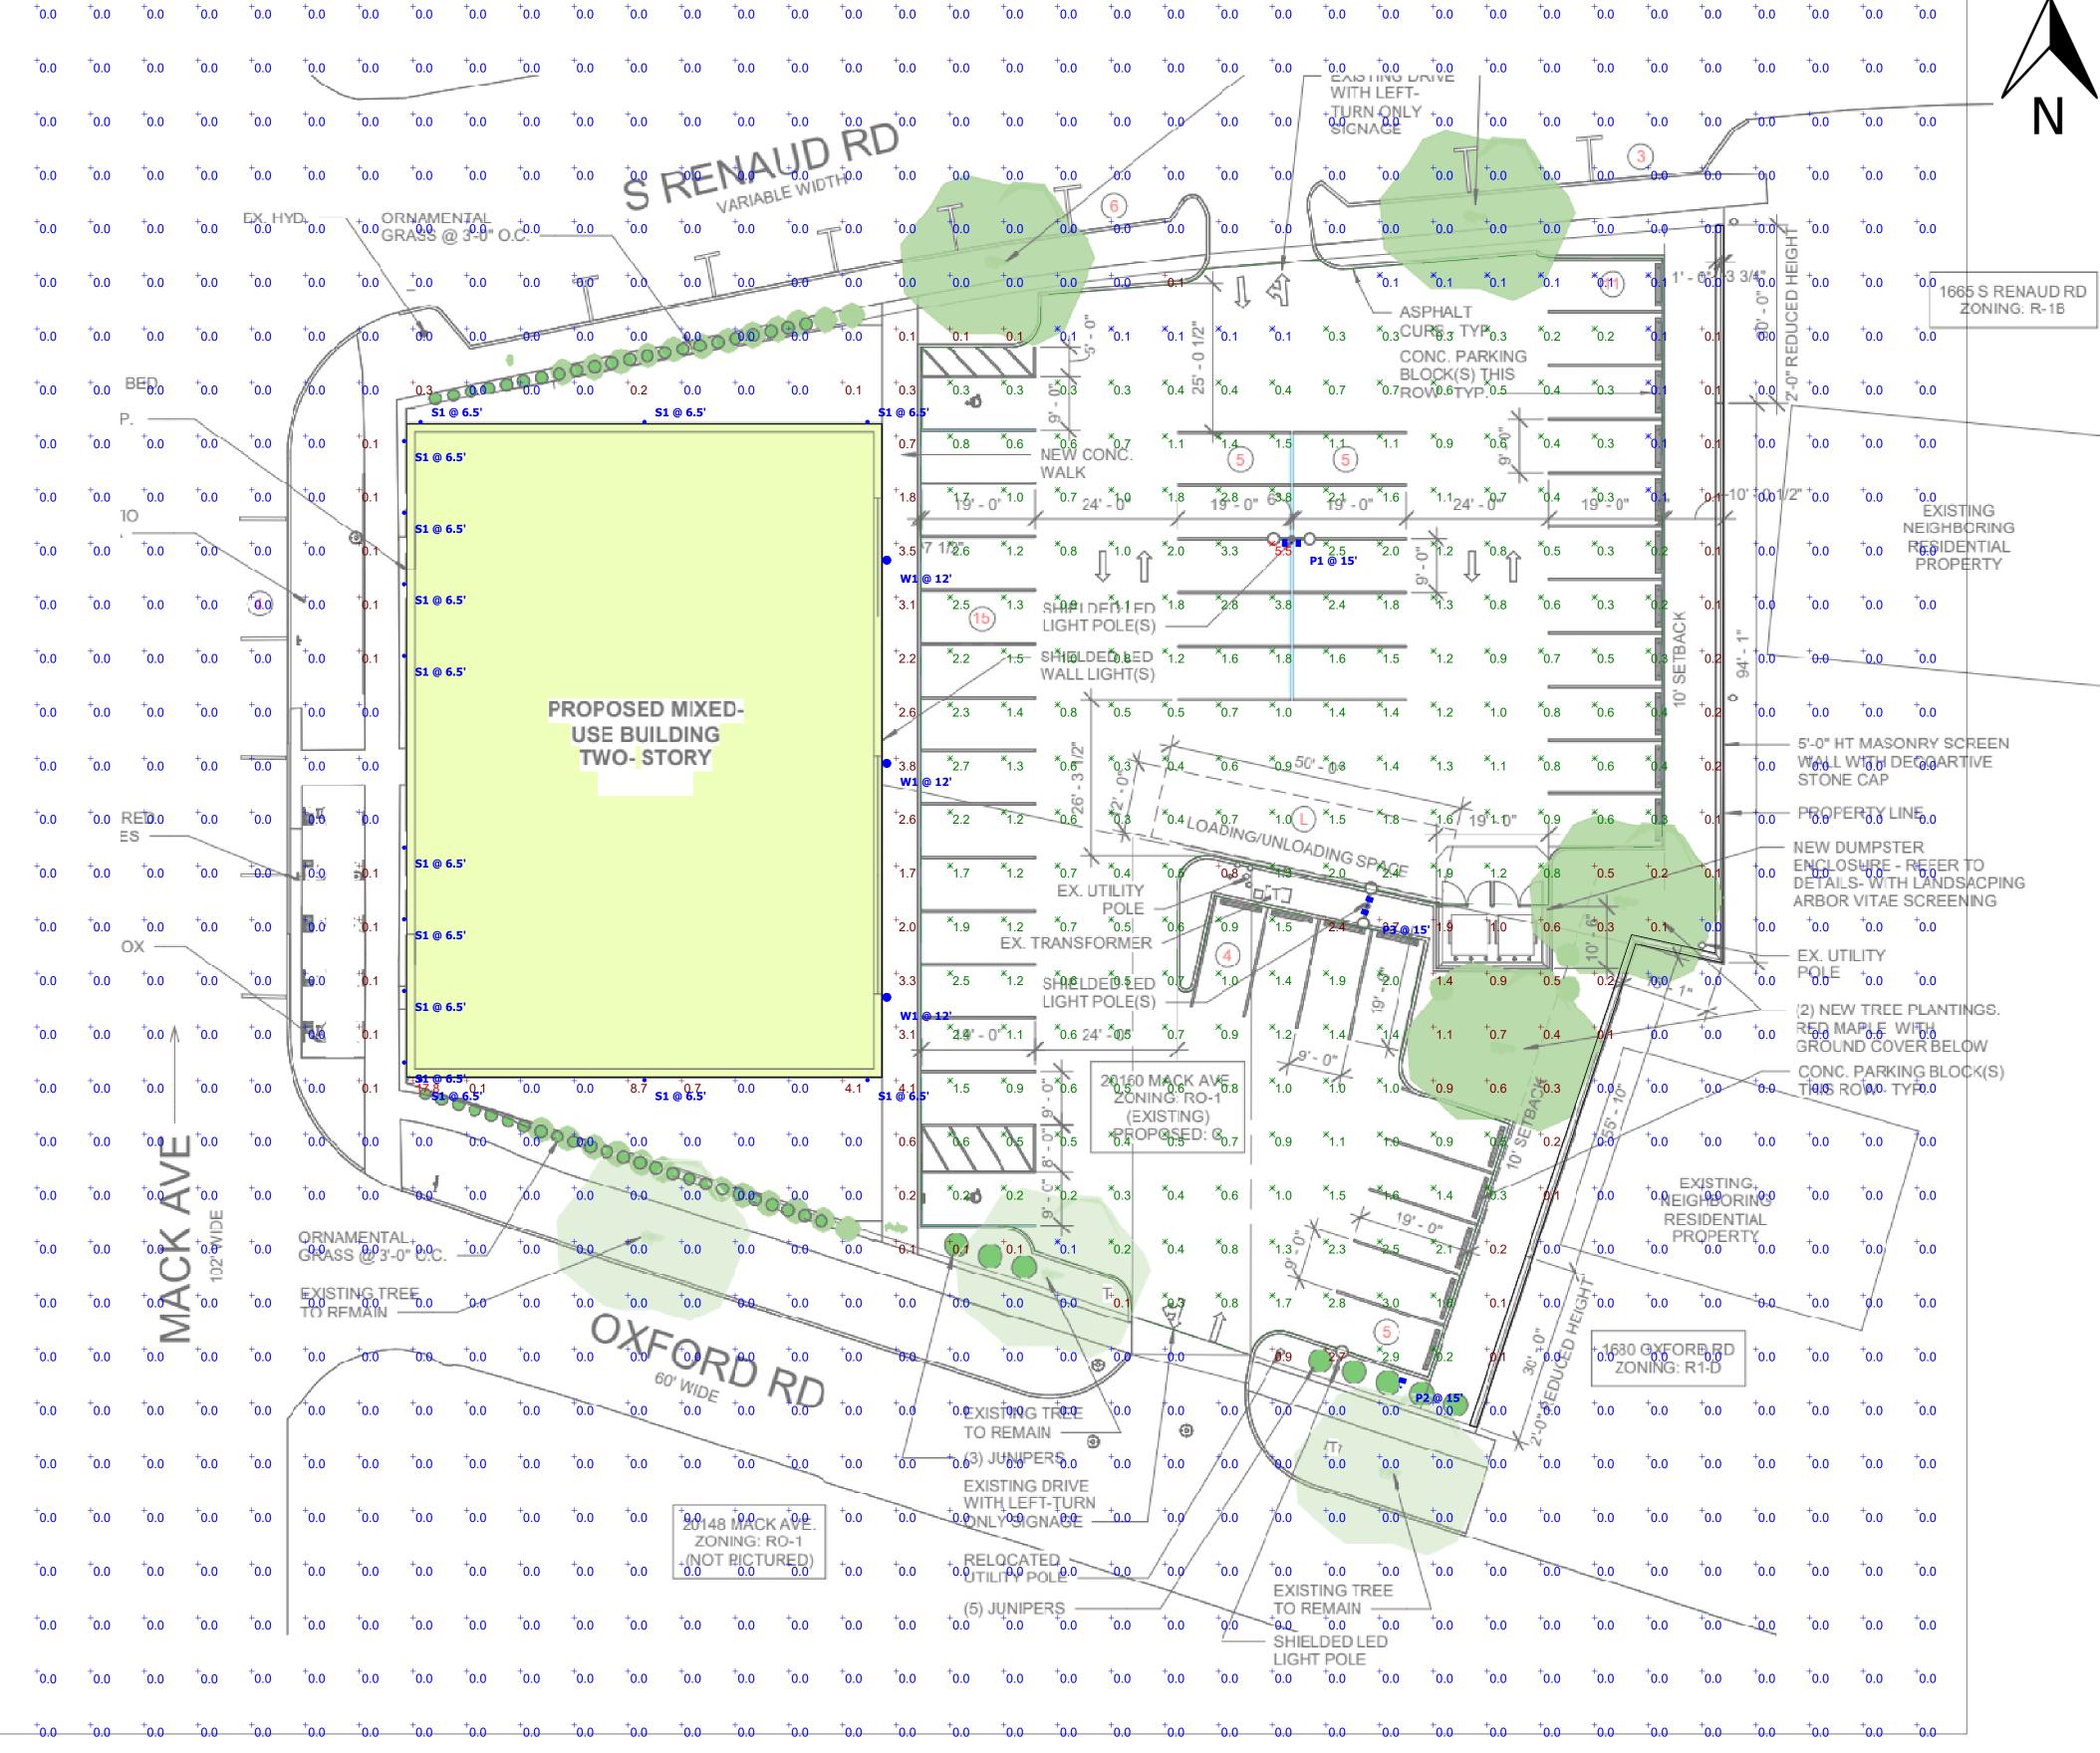

Plan View Scale - 1" = 16ft

Statistics						
Description	Symbol	Avg	Max	Min	Max/Min	Avg/Min
Overall/Grade	+	0.3 fc	17.8 fc	0.0 fc	N/A	N/A
Parking & Drive Lanes	Ж	1.0 fc	5.5 fc	0.1 fc	55.0:1	10.0:1

Designer Date 09/23/2025 Scale Not to Scale Drawing No. #V4

MACK / EXTERIOR PHOTC GASSER BUSH / WWW.GASSER

Lumenicon

Rotated optics

MUTAIRZ PIRHM mingth AiR gen 3 mebbed with Di-min motion / emblent sensor.

5-10 mounting hight, ambies i

First Now, Intolion/arribient sensor

5-40 mounting height, ambient

NEMA twist-look receptacies of y

Five-pin receptacle only (control)

(controls entires eparate)

amnocenabled at 26, 13 0,111

urnsor enabled at 26. 0 4 3

P10 P12

P117 P137

(this section 70CR) only)

70CRI

BOCKI

80CRI

80CRI

BOCKI

PER7 Seven-pin receptable only

FAO Field adjustable output

BL30 Bi-level switched dimming

BLSO Bi-level switched dimming.

OMG 0-10y dimming wires pulled.

separately)

ounde foture (for the

an external control, codered

(controls ordered separate)

30K 3000K

40K 4000K

50K 51000

27K 2700K

BOK BOOK

35K 1500M

40K 4000K

SOK SHOOK

entrol option

Shipped installed

Other options

Shipped installed

L90 Left totated optics1

R90 Right waterd option

Shipped separately

SF Single fuse (120, 277, 347V)2"

DF Double fuse (208, 240, 480V)

BSDB - Bird Spikes (field install required)

HS Houseside shield (black finish standard)

TAM Type IV medium

T4LG Type IV low glare

TFTM. Forward throw

muzium

ordered separate) * ** LITHONIA LIGHTING

COMMERCIAL OUTDOOR

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1 Acuity Way • Decatus, Georgia 30035 • Phone: 1-800-705-SERV (7378) •

EGSR External Glare Shield (reversible, field install required, matches housing finish)

D-Series Size 0 LED Area Luminaire

Introduction

The modern styling of the D-Series features a highly refined aesthetic that blends seamlessly with its environment. The D-Series offers the benefits of the latest in LED technology into a high performance, high efficacy, long-life

The photometric performance results in sites with excellent uniformity, greater pole spacing and lower power density. D-Series outstanding photometry aids in reducing the number of poles required in area lighting applications, with typical energy savings of 70% and expected service life of over 100,000 hours.



TSM Type V median

TSLG Type V low glare

BLC3 Type II backlight

BLC4 Type IV backlight

LCCO Telt comer cutoff

RCCO Right corner cusoff

BLC4 Type W backlight 240 % > 277 % >

TSW Type V wide.

EXAMPLE: DSX0 LED P6 40K 70CRI T3M MVOLT SPA NLTAIR2 PIRHN DDBXD

Items marked by a shaded background qualify for the Design Select program and ship in 15 days or less. To learn more about Design Select, visit www.acuitybrands.com/designselect. *See ordering tree for details

MVOLT (FZIPY-277V)

HVDLT (3479-480//)

XVDLT (277V-480V)

Shipped included

Square pole mounting (#8 miling 35" min: 50 pole)

Lund pale mounting (#8

milling, 3" mon. RND pole)

chilling 3" min. 50 pale)"

stilling 3" min. RND pole)."

(#8 chilling 3" min. 5Q pole)

RPA5 Round pole mounting (#5

WBA Wall teacher

DOBXD Barr Brunge

DNAXD Natural Alternation

DDBTXD Textured dark bronze

DNATXD | Festured natural aluminum

DSX0-LED

Page 1 of 9

Rev. 08/28/25

DBLBXD Fextured black

DWHGXD Textured white:

DOLXD Hack

DWHXD White

SPASN Square narrow pole mounting

MA Masi arm adapter (mounts on 2.3/6 CD borizontal renon)

-	
	A
Α.	В.

8" ROUND DIRECT / ADJUSTABLE INDIRECT

ACCENTUATOR SERIES

APPLICATION

CO816ADJUXT - WALL MOUNT

8" round x 16" high 8" diameter series direct / indirect cylinder luminaire with adjustable tilt indirect (uplight) component.

FEATURES Spectrum's Cylinder series provides traditional architectural style with high performance and energy efficient illumination. Rugged design with flexible mounting, finish and LED options make these extremely versatile fixtures. Quick change LED module with interchangeable optics for job site flexibility and fixture upgrade. Uplight LED module may be filted up to 20° from vertical and locked.

Multi-stage polyester powder-coat process applied on our dedicated paint lines. See mounting and color pages for standard finishes. All exposed materials are chromate pretreated to resist corrosion.

ELECTRONICS

LED system features Xicato LED module with proprietary phosphor technology that provides consistent stable color with CCT control at +/- 100K over life of the light engine. Base CRI is 83 with 2-step MacAdam Ellipse binning. High CRI is 98 with 1 x 2-step MacAdam Ellipse binning. Variety of electronic 120V/277V and dimming drivers. 1 or 2 circuit operation.

CONSTRUCTION

Fabricated seamless aluminum fixture housing. Silicone gasket seals optical chamber. Specular primary optical reflectors provide high efficiency illumination. Impact resistant tempered glass lenses. Stainless steel hardware with galvanized steel brackets to resist cotrosion. Trim formed from .063 thick high purity aluminum and finished to specification.

BAA compliant. ETL certified to meet US and Canadian standards. Suitable for dry or damp locations. Wet Location Option: Manufactured and tested to UL standards No. 1598/8750.

LUF	MENS / WAT	TAGE DATE		
PART NUMBER	SOURCE LUMENS	DELIV- ERED LUMENS*	SYSTEM WAITS*	LPW
CORRESPONDED TO THE PROPERTY OF THE PROPERTY O	2000	1846	18	90
COSIGADULD(TIBLe2	2600	2216	26	85
COB/BADJUNTZOUAZ	4000	5400	49	70

SERIES	UPLI	GHT⁴		DOWN	LIG	HT.	C	CT	DRIVE	R / DIMMING ^e	OF	TIONS'		TRIM		MOUNTING®		FINISH"
CORIGADJUXT	LLIMENS!	OPT	cs	LUMENS'	OP'	ncs	83	CRI	EX	Électronic Driver,	WL	Wet	TSG	Semi Diffuse Low	WM3	Wall Mount 5" Extension	MW'	Matte White
	10L 1000 Lm 13L 1300 Lm	MD MD WD XW	23° 37° 42°	10L 1000 Lm 13L 1300 Lm	MD	12° 22° 39° 46° 574	30K 35K	2700K 3000K 3500K 4000K		120V/277V 109b, 0-10V, 120W/277V 196, 0-10V, 120V/277V		Location Fuse Holder and Fuse 2 Circuit	TCY	Indescent Clear Same Color as Cylinder Clustom Color	WMS	Wall Mount 5" Extension	1.74	
	20L 2000 Lm			20L 2000 Lm			27HK 30HK 35HK	2700K 2700K 3000K 3500K 4000K	DS2W1	ELV/MLV, 120V			50	LENS Clear Glass Lens Micro Prism Solite ³⁴ Lens Frosted Glass Lens	EMRM	RENCY BATTERY OPTIONS 7W Remote EM 7W Remote with Enclosure		

EXAMPLE: CO816ADJUXT10LND20LWD35KEX/TSGSO/WM5/MW

1 Normal Source Lumens of Any CCT 2 territorial Delivered Lumens at 85 CR of Any CCT with Will Car, WIDTER SD 3 At 60 CR of 40° Cream Date 5 No. Marchine recreaments with the CCP Option 6 Contact Factory for Additional Options 7 See Product Options Page for Details 8 Standard Lens for All Indiced and Direct #N, ND 9 Standard Lens for All Indiced Mill, NO, NW 10 See Mounting Page for Details on Companions and Freshall 11 Reference Corp. Sheet Located on Product Webpage for Full Ltd of Available Colons Consult Factory for Special Freshall.



WWW 5/30L 341/50M - 334 JEFF 6/50M 5/1/EET FALL TVET MA 02721 - 5/26 6/3/2003 PAX 5/38.676,22667

82-00044_RC

Specification Sheet

Catalog / Part Number Side View 013 017 WO WIT Side Mount Am Plat Am Chie In STX Aim Configuration Bottom view

Distributio	ons			Desc
•				
Type II	Type fit.	Type IV	Type V Square	
		-		
Rack gls thred	Type III Backight sheds	Type IV Hacklight should	Type v Sofulle	Feat

Colors and Color Temperatures

2200K 2700K 3000K 3500K 4000K 5700K

ON/OFF 0-10V

WITH THE PARTY OF THE PARTY OF

IP66 (optical chamber) Certifications



	P66 rated with phenomenal heat dissipation: the Lumenican Area Medium is ready to take it to the streets (or parking lats, or building sides, or onramps, or)
Features	
Color and Color Temperature	2200K, 2700K, 3000K, 3500K, 4000K, 5700K
Distributions	Type II, Type III or Type IV (with or without backlight shield). Type 5 square and Type V Softsite
3G Vibration Rated	Meets 3G ANSI C136.31-2010 vibration standard for bridge applications
Options	Corrosion-Resistant Coating for Hostile Environments, Surge Protector, 5-Pin Receptacle With ar Without Sharting Cap, 7-Pin Receptacle With or Without Shorting Cap
Mounting Options	Side Overlap (2.3/8 in Tenan)
Warranty	5-year limited warranty
4 1 4 Mary 1 1 1 1 1 1 1 1 1 1 1 1 1 1 1 1 1 1 1	

(reported, Ta 77 °F)

Minimum 3000lm / Maximum 20000lm

temperatures, BUG rating of UO)

Die cast low capper 360 aluminum a loy

3 SDCM for CRI 70+ and 2 SDCM for CRI 80+

TM-21 L70 527,000 hrs (projected, Ta 77 °F), 36,000 hrs

DarkSky compliant (2200K, 2700K and 3000K color

The Lumanicon Area Medium creates a consistent aesthetic

while Illuminating city streets, local roads, residential streets.

parking lots and laneways. An Innovative, toolless opening

system makes the plug-and-play components easy to access.

lumenpulse"	120 Across Dec. 200 DEC 200 CAN 1.51 A V37 2015 1.81 PC 200 1.81 P	
-------------	--	--

Performance

Color Rendering

DarkSky

Physical

Housing Material

Lumen Maintenance

Output (Nominal Lumens)

Designer Date 09/23/2025 Scale Not to Scale Drawing No.

- THIS SURVEY AND THE BOUNDARIES SHOWN HEREON ARE THE RESULT OF AN ACTUAL FIELD SURVEY PERFORMED DURING APRIL 22, 2025, BASED ON AVAILABLE MAPS AND DEEDS OF RECORD, AND PHYSICAL EVIDENCE. THIS SURVEY IS SUBJECT TO ALL EASEMENTS, RIGHTS OF WAY AND AGREEMENTS OF RECORD THAT A TITLE SEARCH MAY
- 2. THIS SURVEY IS VALID ONLY WHEN A DIGITAL SEAL IS AFFIXED HERETO.
- 3. THE SURVEYOR IS NOT QUALIFIED TO IDENTIFY ENVIRONMENTAL CONDITIONS OR THE PRESENCE OR ABSENCE OF WETLANDS.
- 4. THE CERTIFICATION SHOWN HEREON IS NOT TRANSFERABLE TO ADDITIONAL INSTITUTIONS OR SUBSEQUENT OWNERS.
- 5. ANY SUBSURFACE UTILITIES SHOWN HAVE BEEN LOCATED FROM MARKOUTS OBSERVED ON SITE DURING THE FIELD SURVEY, AND SURFACE FEATURES SUCH AS VALVES, MANHOLES AND GRATES. STORM DRAINAGE AND OR SANITARY INVERTS ARE DEPICTED BASED ON OBSERVATIONS MADE IN THE FIELD. THE SURVEYOR MAKES NO GUARANTEES THAT THE UNDERGROUND UTILITIES SHOWN COMPRISE ALL SUCH UTILITIES IN THE AREA, EITHER IN SERVICE OR ABANDONED. THE SURVEYOR FURTHER DOES NOT WARRANT THAT THE UNDERGROUND UTILITIES SHOWN ARE IN THE EXACT LOCATION INDICATED, ALTHOUGH THEY ARE LOCATED AS ACCURATELY AS POSSIBLE FROM INFORMATION USED. THE SURVEY HAS NOT PHYSICALLY LOCATED THE UTILITIES. BEFORE ANY EXCAVATIONS ARE BEGUN, THE PROPER UTILITY AGENCIES MUST BE CONTACTED FOR VERIFICATION OF UTILITY TYPE AND FOR FIELD LOCATIONS.
- 6. BEARINGS ARE REFERENCED TO THE MICHIGAN STATE PLANE COORDINATE SYSTEM (NAD83) SOUTH ZONE. ELEVATIONS SHOWN HEREON ARE REFERENCED TO THE NORTH AMERICAN VERTICAL DATUM OF 1988 (NAVD 88), ESTABLISHED VIA RTK GPS OBSERVATIONS UTILIZING MICHIGAN DEPARTMENT OF TRANSPORTATION CONTINUOUSLY OPERATING REFERENCE SYSTEM (MDOT CORS).
- 7. BASEMENT OR BELOW GRADE STRUCTURES (IF ANY) ARE UNKNOWN.
- 8. BENCHMARK #I = SANITARY MANHOLE = 584.57 (NAVD88). - NORTH SIDE OF OXFORD ROAD IN SECOND DRIVE EAST OF MACK AVENUE. BENCHMARK #2 = ARROW ON FIRE HYDRANT = 586.81 (NAVD88). - SOUTHEAST CORNER OF MACK AVENUE AND SOUTH RENAUD ROAD.

FLOOD NOTE

BY GRAPHIC PLOTTING ONLY, THIS PROPERTY IS IN ZONE X (UNSHADED)(AREA DETERMINED TO BE OUTSIDE THE 0.2% ANNUAL CHANCE FLOODPLAIN) OF THE FLOOD INSURANCE RATE MAP, COMMUNITY NO. 260231, MAP NUMBER 26163C0141F WHICH BEARS AN EFFECTIVE DATE OF OCTOBER 21, 2021.

SURVEY REFERENCES:

- DEED BETWEEN SCOTT FISHER, INC. (GRANTOR) AND REAL PROPERTIES, INC. (GRANTEE), DATED AUGUST 27, 1992 AND RECORDED IN THE OFFICE OF THE REGISTER OF DEEDS, WAYNE COUNTY, MICHIGAN IN LIBER 25975, PAGE 47.
- "ARTHUR J. SCULLY'S EASTMORELAND PARK" A SUBDIVISION OF PART OF PRIVATE CLAIM 240, VILLAGE OF LOCHMOOR, WAYNE COUNTY, MICHIGAN, DATED OCTOBER 6, 1928 AND RECORDED IN THE WAYNE COUNTY REGISTER OF DEEDS OFFICE IN LIBER 63 OF
- "RENMOOR PARK" A SUBDIVISION OF PART OF PRIVATE CLAIM 611, VILLAGE OF GROSSE POINTE WOODS, WAYNE COUNTY, MICHIGAN, DATED AUGUST 25, 1945 AND RECORDED IN THE WAYNE COUNTY REGISTER OF DEEDS OFFICE IN LIBER 70 OF PLATS, PAGES 35 AND 36.
- 4. A TITLE COMMITMENT FOR TITLE INSURANCE PREPARED BY TITLE CONNECT LLC AS ISSUING AGENT FOR FIRST AMERICAN TITLE INSURANCE COMPANY, ISSUING OFFICE FILE NUMBER TC13-117308, COMMITMENT DATE JANUARY 22, 2025 AT 8:00 AM.

PARCEL DESCRIPTION:

THE LAND REFERRED TO HEREIN BELOW IS SITUATED IN THE COUNTY OF WAYNE, STATE OF MICHIGAN AND IS DESCRIBED AS FOLLOWS:

LAND SITUATED IN THE CITY OF GROSSE POINTE WOODS, COUNTY OF WAYNE, STATE OF MICHIGAN, DESCRIBED AS FOLLOWS:

ALL OF LOT I AND LOT 2, EXCEPTING THEREFROM THE EAST 15.31 FEET IN ARTHUR J. SCULLY'S EASTMORELAND PARK, BEING A SUBDIVISION OF PART OF PRIVATE CLAIM 240, VILLAGE OF LOCHMOOR, ACCORDING TO THE PLAT THEREOF RECORDED IN LIBER 63, PAGE 42 OF PLATS, ALSO ALL THAT PART OF P.C. 611, VILLAGE OF GROSSE POINTE WOODS. BOUNDED AND DESCRIBED AS FOLLOWS: BEGINNING AT A POINT AT THE INTERSECTION OF THE EAST LINE OF MACK AVENUE, AS WIDENED, AND THE SOUTH LINE OF SAID P.C. 611, SAID POINT BEING SOUTH 71 DEGREES EAST A DISTANCE OF 104.43 FEET FROM THE MIDDLE LINE OF MACK AVENUE: THENCE ALONG SAID SOUTH LINE OF P.C. 611, SOUTH 71 DEGREES EAST A DISTANCE OF 227.28 FEET TO THE SOUTHWEST CORNER OF RENMOOR PARK SUBDIVISION; THENCE ALONG THE WEST LINE OF SAID SUBDIVISION NORTH 6 DEGREES, 37 MINUTES, 22 SECONDS EAST A DISTANCE OF 124.37 FEET TO THE SOUTH LINE OF RENAUD ROAD; THENCE ALONG RENAUD ROAD NORTH 88 DEGREES, 22 MINUTES WEST A DISTANCE OF 87.05 FEET: THENCE TURNING TO THE LEFT ON A CURVE HAVING A RADIUS OF 459.14 FEET WESTERLY, 49.95 FEET (CHORD BEARS SOUTH 88 DEGREES, 31 MINUTES WEST A DISTANCE OF 49.93 FEET); THENCE SOUTH 85 DEGREES, 24 MINUTES WEST A DISTANCE OF 87.48 FEET TO THE EAST SIDE OF MACK AVENUE; THENCE ALONG MACK AVENUE SOUTH 6 DEGREES, 37 MINUTES, 22 SECONDS WEST 2 DISTANCE OF 44.00 FEET TO THE PLACE OF BEGINNING.

BEING THE SAME PROPERTY AS DESCRIBED IN A TITLE COMMITMENT FOR TITLE INSURANCE PREPARED BY TITLE CONNECT LLC AS ISSUING AGENT FOR FIRST AMERICAN TITLE INSURANCE COMPANY, ISSUING OFFICE FILE NUMBER TC13-117308, COMMITMENT DATE JANUARY 22, 2025 AT 8:00 AM.

SCHEDULE B - PART II EXCEPTIONS

A TITLE COMMITMENT FOR TITLE INSURANCE PREPARED BY TITLE CONNECT LLC AS ISSUING AGENT FOR FIRST AMERICAN TITLE INSURANCE COMPANY, ISSUING OFFICE FILE NUMBER TC13-117308, COMMITMENT DATE JANUARY 22, 2025 AT 8:00 AM.

ITEMS I THROUGH 7, INCLUSIVE, AND 9 THROUGH 16, INCLUSIVE, ARE NOT SURVEY RELATED.

- 8. SUBJECT TO THE EASEMENTS, RESTRICTIONS AND RESERVATIONS CONTAINED IN THE ARTHUR J. SCULLY'S EASTMORELAND PARK SUBDIVISION PLAT RECORDED AT LIBER 63, PAGE(S) 42, WAYNE COUNTY RECORDS. (SHOWN)
- 17. EASEMENT IN FAVOR OF MICHIGAN BELL TELEPHONE COMPANY, AND THE TERMS, CONDITIONS AND PROVISIONS CONTAINED THEREIN, RECORDED IN LIBER 22079, PAGE 915. **(SHOWN)**


AREA NOTES TOTAL LAND AREA

33.007 SOUARE FEET± OR 0.758 ACRES± **EXISTING STRIPED PARKING**

HANDICAP = 2 SPACES TOTAL = 33 SPACES (INCLUDES

REGULAR = 31 SPACES

WATER MH RIM ELEV= 583.66

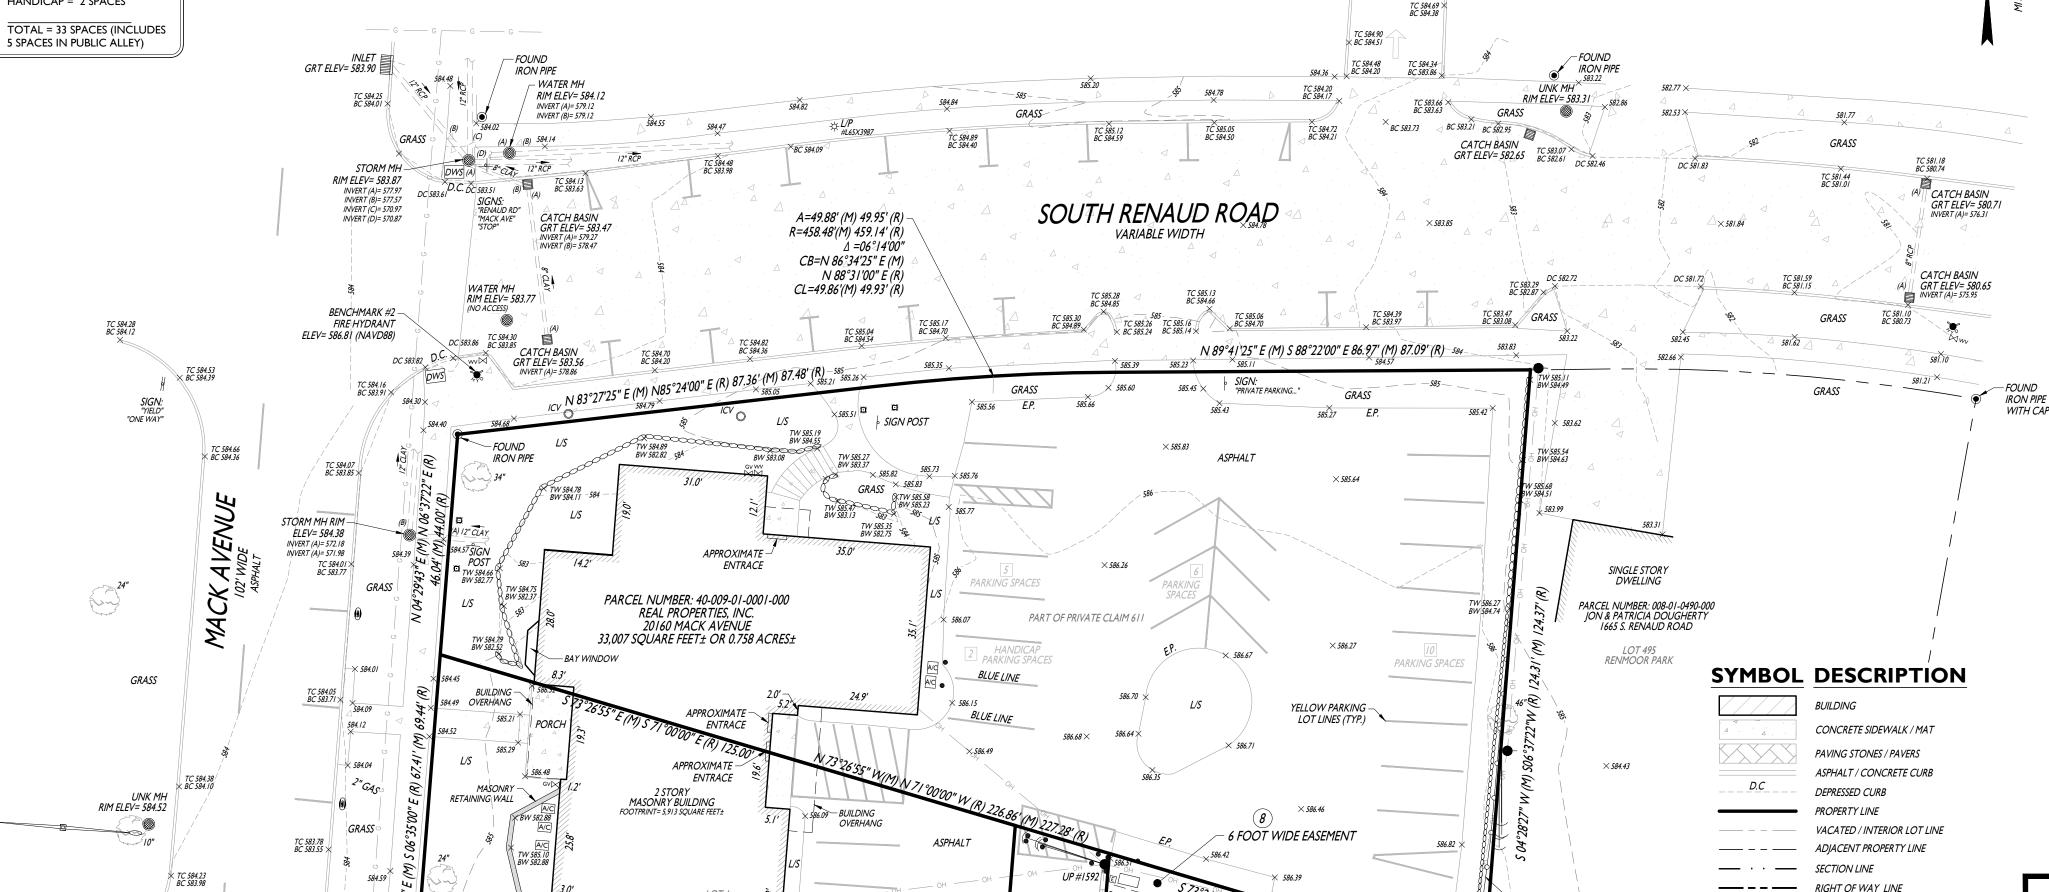

imes 586.22

BENCHMARK #I -

SAN MH RIM ELEV= 584.57

GRAPHIC SCALE IN FEET

I" = 20'

ASPHAL 7

MBT EASEMENT

GRASS

TELECOM/ELEC MH -

RIM ELEV= 585.05

TC 585.21 BC 584.77

TC 585.13 BC 585.10<

L.22079, P.915

FOUND

RIM ELEV = 583.79 (WATER FILLED)

SINGLE STORY MASONRY BUILDING

TC 583.87× BC 583.58

DC 583.63 ×

DC 583.64

CONCRETE

- WOOD FENCE

- WOOD FENCE

PARCEL NUMBER: 009-01-0002-002

GARY FELTS 1680 OXFORD ROAD

PART OF LOT 2

585.15 ×

GRASS

× 585.26

_____ - ____ CENTERLINE --- EASEMENT

— ОН —

BOARD-ON-BOARD FENCE

MAST ARM LIGHT POLE

UTILITY POLE

GUY WIRE

LIGHT POLE

SIGNS

LIGHT FIXTURE

WATER VALVE

GAS VALVE

MAN HOLE

BOLLARDS

PAY METER

FIRE HYDRANT

BOX (ELEC, GAS, ETC.)

EDGE OF PAVEMENT

OVERHEAD WIRE

MAJOR CONTOUR

MINOR CONTOUR

DETECTABLE WARNING STRIP

HANDICAP PARKING

PAVEMENT STRIPING

CLEAN OUT

MAILBOX IRON ROD

TYPICAL

GRATE UNKNOWN BUILDING **LANDSCAPING**

MANHOLE

MEASURED DEED

POINT OF BEGINNING

ELEVATION CONCRETE

ELEV

GRT.

P.O.B.

TELEPHONE PEDESTAL

SURVEY MONUMENT SECTION CORNER

AIR CONDITIONING UNIT

IRRIGATION CONTROL VALVE

DECIDUOUS TREE - DIAMETER NOTED

STORM PIPE

100.00 GRADE SPOT SHOT

X TC 100.50 TOP OF CURB SHOT

STONE WALL

→ BC 100.00 BOTTOM OF CURB SHOT TW 102.00 TOP OF WALL SHOT

→ BW 100.00 BOTTOM OF WALL SHOT

DRAIN

INLET



Know what's **below Call** before you dig.

NOT TO SCALE

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Headquarters: 92 Park Avenue, Rutherford, NJ 07070 Phone 201.340.4468 · Fax 201.340.4472

ALTA/ NSPS LAND TITLE SURVEY

MAP OF SURVEY OF:

I	05/12/25	MVZ	AG	04/22/25	JU	FOR ISSUE
ISSUE	DATE	DRAFT BY	CHECK BY	FIELD DATE	FIELD CREW	DESCRIPTION

THIS IS TO DECLARE THAT THIS MAP OR PLAT AND THE SURVEY ON WHICH IT IS BASED WERE MADE

THE FIELDWORK WAS COMPLETED ON APRIL 22, 2025

ROBERT E. HORNYAK, PS

PROJECT ID: DET-250182 SHEET: I OF I

SOURCE: GOOGLE MAPS

PARCEL NUMBER: 009-01-0001-000 20160 MACK AVENUE **CITY OF GROSSE POINTE WOODS COUNTY OF WAYNE, STATE OF MICHIGAN**

I	05/12/25	MVZ	ĀG	04/22/25	JU	FOR ISSUE
ISSUE	DATE	DRAFT BY	CHECK BY	FIELD DATE	FIELD CREW	DESCRIPTION

IN ACCORDANCE WITH THE 2021 MINIMUM STANDARD DETAIL REQUIREMENTS FOR ALTA/NSPS LAND TITLE SURVEYS, JOINTLY ESTABLISHED AND ADOPTED BY ALTA AND NSPS, AND INCLUDES ITEMS 2, 3, 4, 7, 8, 9 & 13 OF TABLE A THEREOF.

MICHIGAN PROFESSIONAL SURVEYOR No. 4001044286

SCALE: I"=20'



IMPACT STATEMENT

PROPOSED RETAIL DEVELOPMENT
PARCEL ID: 40009010001000
20160 MACK AVE
GROSSE POINTE WOODS
WAYNE COUNTY, MICHIGAN

PREPARED BY:

STONEFIELD ENGINEERING & DESIGN, LLC
NIK BAUER
SED DET-250182

SIGNED

DEVELOPER / APPLICANT:

NibBan

BUCCALLETO DEVELOPMENT 20259 MACK AVENUE, SUITE 2 GROSSE POINTE WOODS, MI 48236 (313) 300-7280

stonefieldeng.com



REP	ORT CONTENTS	
1.1	PROPERTY DESCRIPTION	3
1.2	Existing Conditions	3
1.3	Proposed Conditions	3
1.4	CURRENT ZONING	3
1.5	UTILITY & RIGHT-OF-WAY IMPACTS	4
1.6	ENVIRONMENTAL IMPACTS	4
APP	ENDICIES	
FLOC	ODPLAIN M APS	A
FEMA	4 FIRM MAP	В
NRC	S SOIL SURVEY MAP	C
EGL	E RIDE MAPPER	D



I.I Property Description

Legal Description

Land situated in the City of Grosse Pointe Woods, County of Wayne, State of Michigan, described as follows:

All of lot 1 and lot 2, excepting therefrom the east 15.31 feet in Arthur J. Scully's Eastmoreland Park, being a subdivision of part of private claim 240, Village of Lochmoor, according to the plat thereof recorded in liber 63, page 42 of plats. also all that part of P.C. 611, village of Grosse Pointe Woods, bounded and described as follows: beginning at a point at the intersection of the east line of Mack Avenue, as widened, and the south line of said P.C. 611, said point being south 71 degrees east a distance of 104.43 feet from the middle line of Mack Avenue; thence along said south line of P.C. 611, south 71 degrees east a distance of 227.28 feet to the southwest corner of Renmoor Park Subdivision; thence along the west line of said subdivision north 6 degrees, 37 minutes, 22 seconds east a distance of 124.37 feet to the south line of Renaud Road; thence along Renaud road north 88 degrees, 22 minutes west a distance of 87.05 feet; thence turning to the left on a curve having a radius of 459.14 feet westerly, 49.95 feet (chord bears south 88 degrees, 31 minutes west a distance of 49.93 feet); thence south 85 degrees, 24 minutes west a distance of 87.48 feet to the east side of Mack Avenue; thence along Mack Avenue south 6 degrees, 37 minutes, 22 seconds west 2 distance of 44.00 feet to the place of beginning.

1.2 Existing Conditions

The project site is a 0.76 acres commercial lot, home of the 'Pointe Neuroscience Center'. The area of improvements is limited to the building & its accessory asphalt parking area. No environmental hazards have been identified on the site per EGLE's Ride Mapper system, and the site falls outside of any local wellhead protection areas. Access to the site is provided by driveways to the S Renaud Road & Oxford Road systems.

1.3 Proposed Conditions

The scope of the proposed improvements includes demolition of the existing building and parking lot, and construction of a 2-story 8,900 SF Mixed Use Building and accessory parking lot containing 56 vehicle parking spaces.

1.4 CURRENT ZONING

The Current Zoning is (RO-I) Restricted Office with a proposed rezone to (C) Commercial Business, and the master plan's Future Land Use identifies the site as 'Corridor Mixed Use', which fits the characteristics of the proposed development. Refer to the current Grosse Pointe Woods Zoning Map & Master Plan for more information.



1.5 UTILITY & RIGHT-OF-WAY IMPACTS

No negative impacts to public utilities such as stormwater, sanitary waste, domestic water, natural gas, or electrical services are anticipated. Though the proposed Commercial & Residential uses will have a slightly greater demand on public utilities than the existing medical office use, the existing city infrastructure has adequate capacity for the proposed development. No impacts to fire or police services are anticipated.

Landscaping improvements are proposed along the right-of-way frontages, as well as an outdoor seating area along Mack Avenue. The existing right-of-way sidewalks will remain and be repaired as necessary. The existing on-street parking spaces abutting the subject property will remain.

1.6 ENVIRONMENTAL IMPACTS

No environmental impacts are anticipated. The amount of green space on-site shall remain relatively unchanged with enhanced landscaping proposed along the right-of-way frontages and the rear lot line. The existing landscaping (trees, plantings, etc.) shall remain to the greatest extent possible.

The subject property is not located within a mapped floodplain (Zone 'X', area of minimum flood hazard) nor mapped wetlands. Refer to the FEMA map (Number 26163C0141F eff. 10/21/2021) USFWS National Wetlands Inventory Map, and EGLE Wetlands Map.

The subject site's soils are comprised of mainly 'Urban Land-Fortress Family Complex' (UrbapB per NRCS Soil Survey maps, refer to Appendix C) which carries a low permeability (HSG 'D'). Groundwater depth is not expected to be a conflict.




APPENDIX A WETLAND MAPS

Wetlands Map Viewer




September 19, 2025

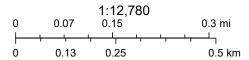

Sources: Esri, HERE, Garmin, USGS, Intermap, INCREMENT P, NRCan, Esri Japan, METI, Esri China (Hong Kong), Esri Korea, Esri (Thailand), NGCC, (c) OpenStreetMap contributors, and the GIS User Community

U.S. Fish and Wildlife Service National Wetlands Inventory

20160 Mack Ave Wetlands

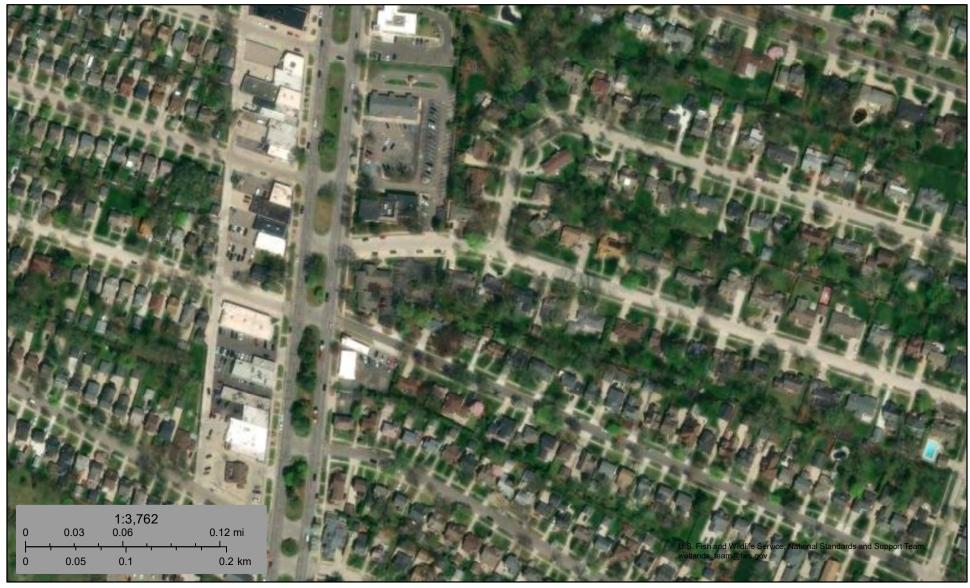

September 19, 2025

Wetlands

Estuarine and Marine Deepwater

Estuarine and Marine Wetland

Freshwater Emergent Wetland

Freshwater Forested/Shrub Wetland

Freshwater Pond

Lake

Other

Riverine

This map is for general reference only. The US Fish and Wildlife Service is not responsible for the accuracy or currentness of the base data shown on this map. All wetlands related data should be used in accordance with the layer metadata found on the Wetlands Mapper web site.



APPENDIX B FEMA FIRM MAP

National Flood Hazard Layer FIRMette


250

500

1,000

1,500



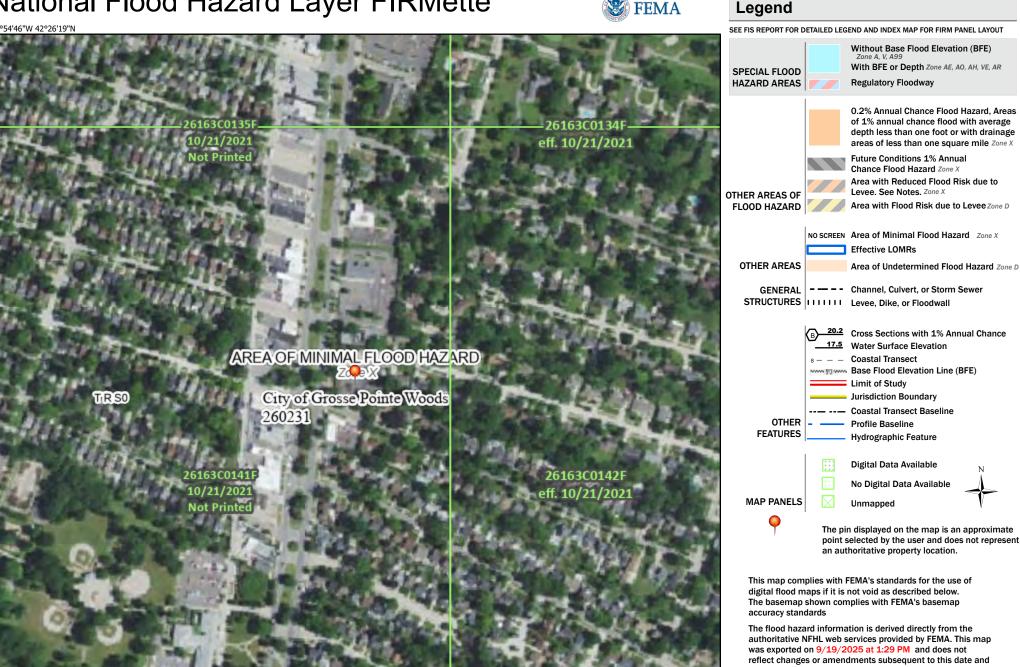

1:6,000

2,000

digital flood maps if it is not void as described below. The basemap shown complies with FEMA's basemap

authoritative NFHL web services provided by FEMA. This map was exported on 9/19/2025 at 1:29 PM and does not reflect changes or amendments subsequent to this date and time. The NFHL and effective information may change or become superseded by new data over time.

This map image is void if the one or more of the following map elements do not appear: basemap imagery, flood zone labels, legend, scale bar, map creation date, community identifiers, FIRM panel number, and FIRM effective date. Map images for unmapped and unmodernized areas cannot be used for regulatory purposes.



APPENDIX C NRCS SOIL SURVEY MAPS



Wayne County, Michigan

UrbapB—Urban land-Fortress family complex, dense substratum, 0 to 4 percent slopes

Map Unit Setting

National map unit symbol: 2whsw

Elevation: 570 to 670 feet

Mean annual precipitation: 28 to 38 inches Mean annual air temperature: 45 to 52 degrees F

Frost-free period: 135 to 210 days

Farmland classification: Not prime farmland

Map Unit Composition

Urban land: 80 percent

Fortress family, dense substratum, and similar soils: 19 percent

Minor components: 1 percent

Estimates are based on observations, descriptions, and transects of the mapunit.

Description of Urban Land

Properties and qualities

Slope: 0 to 1 percent

Depth to restrictive feature: 0 inches to manufactured layer

Runoff class: High

Capacity of the most limiting layer to transmit water (Ksat): Very low (0.00 to 0.00

in/hr)

Interpretive groups

Land capability classification (irrigated): None specified

Land capability classification (nonirrigated): 8

Hydrologic Soil Group: D Hydric soil rating: No

Description of Fortress Family, Dense Substratum

Setting

Landform: Water-lain moraines, wave-worked till plains

Down-slope shape: Linear

Across-slope shape: Convex, linear, concave

Parent material: Sandy human-transported material over clayey lodgment till

Typical profile

^Au - 0 to 9 inches: loamy sand

^Cu - 9 to 68 inches: gravelly-artifactual sand

2Cd - 68 to 80 inches: clay

Properties and qualities

Slope: 0 to 4 percent

Depth to restrictive feature: 54 to 78 inches to densic material

Drainage class: Moderately well drained

Runoff class: Very low

Capacity of the most limiting layer to transmit water (Ksat): Very low (0.00 to 0.00

in/hr)

Depth to water table: About 30 to 54 inches

Frequency of flooding: None

Custom Soil Resource Report

Frequency of ponding: None

Calcium carbonate, maximum content: 28 percent

Gypsum, maximum content: 1 percent

Maximum salinity: Nonsaline (0.1 to 1.5 mmhos/cm)

Available water supply, 0 to 60 inches: Low (about 3.3 inches)

Interpretive groups

Land capability classification (irrigated): None specified

Land capability classification (nonirrigated): 8

Hydrologic Soil Group: A

Ecological site: F099XY003MI - Warm Moist Sandy Depression

Hydric soil rating: No

Minor Components

Riverfront, dense substratum, steep

Percent of map unit: 1 percent

Landform: Deltas, water-lain moraines, wave-worked till plains

Down-slope shape: Linear

Across-slope shape: Convex, linear

Ecological site: F099XY007MI - Lake Plain Flats

Hydric soil rating: No

UrbarB—Urban land-Riverfront complex, dense substratum, 0 to 4 percent slopes

Map Unit Setting

National map unit symbol: 2whsx

Elevation: 560 to 720 feet

Mean annual precipitation: 28 to 38 inches Mean annual air temperature: 45 to 52 degrees F

Frost-free period: 135 to 210 days

Farmland classification: Not prime farmland

Map Unit Composition

Urban land: 80 percent

Riverfront, dense substratum, and similar soils: 19 percent

Minor components: 1 percent

Estimates are based on observations, descriptions, and transects of the mapunit.

Description of Urban Land

Properties and qualities

Slope: 0 to 1 percent

Depth to restrictive feature: 0 inches to manufactured layer

Runoff class: High


Capacity of the most limiting layer to transmit water (Ksat): Very low (0.00 to 0.00

in/hr)



APPENDIX D EGLE RIDE MAPPER

ArcGIS Web Map

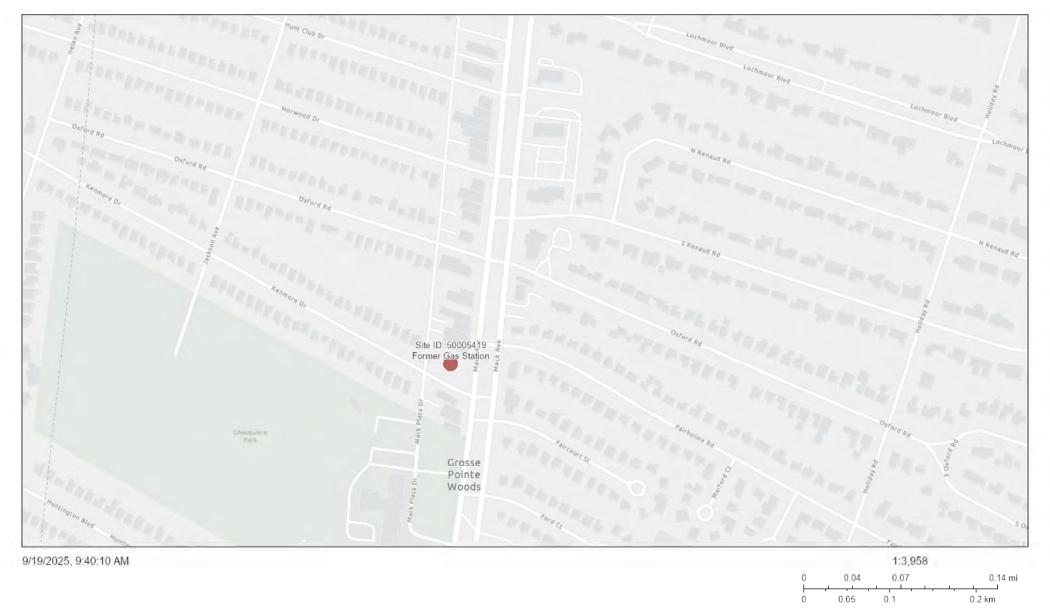

Sources: Esri, TomTom, Garmin, FAO, NOAA, USGS, © OpenStreetMap contributors, and the GIS User Community





VIA EMAIL: buccellato @buccdevelopment.com

To: Justin Buccellato

Julie Kroll, PE, PTOE

From: Massara Khalid

Fleis & VandenBrink

Date: August 11, 2025

Revised September 11, 2025

20160 Mack Avenue - Retail Development

Re: Grosse Pointe Woods, Michigan

Trip Generation Analysis

1 Introduction

This memorandum presents the results of the Trip Generation Analysis (TGA) for the proposed mixed-use development in Grosse Pointe Woods, Michigan. The project site is located at 20160 Mack Avenue, between Oxford Road and S. Renaud Road, as shown in **Exhibit 1**. The proposed development includes the construction of a mixed-use development that includes multi-family residential and retail land uses, on property that was previously occupied by a medical office. The project site will close one (1) of the existing driveways on Oxford Road; the proposed access to the project site will maintain one (1) driveway on Oxford Road and one (1) driveway on S. Renaud Road, both of which are under the jurisdiction of the City. A TGA has been required for this project, as part of the site plan approval process.



EXHIBIT 1: SITE LOCATION MAP

The scope of work for this study was prepared based upon Fleis & VandenBrink's (F&V) knowledge of the study area, understanding of the development program, accepted traffic engineering practice, professional experience, and the methodologies published by the Institute of Transportation Engineers (ITE). Sources of data for this study include the Michigan Department of Transportation (MDOT), the Michigan Traffic Crash Facts (MTCF) database, and ITE.

2 SITE TRIP GENERATION

2.1 SITE TRIP GENERATION

The number of weekday peak hour (AM and PM) and daily vehicle trips that would be generated by the development were calculated based on information published by the Institute of Transportation Engineers (ITE) in the *Trip Generation Manual, 12th Edition*. The proposed development includes the construction of a mixed-use development that includes multi-family residential and retail land uses. The vehicular trips generated by the proposed development are summarized in **Table 1**.

Land Use	ITE	Amount	Units	Average Daily Traffic	AM F	Peak Ho	ur (vph)	PM Pe	ak Hour	(vph)
	Code			(vpd)	ln	Out	Total	ln	Out	Total
Multi-Family Housing (Low-Rise)	220	8	DU	50	1	2	3	2	2	4
Strip Retail Plaza (<40k SF)	822	8,900	SF	605	19	16	35	36	35	71
Pass-By (0% AM, 40% PM)			40% PM)	121	0	0	0	14	14	28
New Trips			New Trips	484	19	16	35	22	21	43
Total Trips			otal Trips	655	20	18	38	38	37	75
Total Pass-By				121	0	0	0	14	14	28
Total New Trips			534	20	18	38	24	23	47	

Table 1: Vehicular Trip Generation Summary

As is typical of commercial developments, a portion of the trips generated are from vehicles that are already on the adjacent roadways and will pass the site on their way from an origin to their ultimate destination. Therefore, not all traffic at the site driveways is necessarily new traffic added to the street system. This percentage of the trips generated by the development are considered either "pass-by" or "diverted link" trips, which are already present within the adjacent street system. These trips are therefore reduced from the total external trips generated by a study site. The pass-by and diverted link trips impact on the study intersections are shown in Exhibit 1. The percentage of pass-by trips used in this analysis was determined based on the rates published by ITE in the *Trip Generation Manual*, 12th Edition.

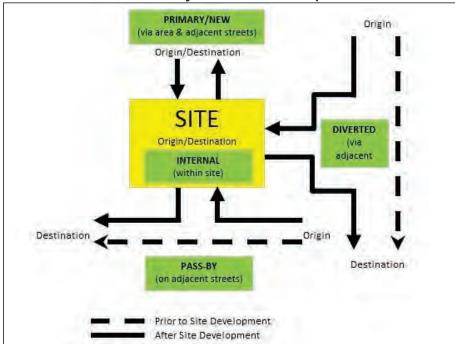


Exhibit 1: Pass-By & Diverted Link Trips Defined



2.2 TRIP GENERATION COMPARISON

The existing building on the project site is currently being utilized as a medical office. The number of weekday peak (AM and PM) and daily vehicle trips that are generated by the existing use of the project site were calculated based on the data published by ITE in the *Trip Generation Manual, 12th Edition.* The trip generation forecast for the existing use was compared to the proposed development, as shown in **Table 2**.

AM Peak Hour PM Peak Hour ITE Average Daily (vph) (vph) Amount Units Scenario Land Use Code Traffic (vpd) Out Total Out Total In ln Medical-Dental Office Building **Existing Site** 720 11,826 SF 405 28 7 35 11 27 38 2 2 Multi-Family Housing (Low-Rise) 220 8 DU 50 2 3 4 1 SF Proposed Use | Strip Retail Plaza (<40k SF) 822 8,900 605 19 16 35 36 35 71 35 71 Total 655 19 16 35 36 -9 9 Difference 250 0 25 8 33

Table 2: Trip Generation Comparison

The results of the trip generation comparison indicate that the proposed development is comparable to the existing use of the project site.

3 SITE TRIP DISTRIBUTION

The vehicular trips that would be generated by the proposed development were assigned to the study roadway network based on existing peak hour traffic patterns in the adjacent roadway network, the proposed site access points, and the methodologies published by ITE. Current traffic volume along Mack Avenue was obtained from the MDOT Traffic Count Database System (TCDS) website, for use in determining the project site distribution.

Additionally, traffic volume data was not available along Oxford Road and S. Renaud Road. It is expected that some residents of the adjacent neighborhoods on Oxford Road and S. Renaud Road will access the proposed retail development to/from the east of the site. However, it is expected that the majority of traffic generated by the proposed development will be to/from Mack Ave.

The ITE trip distribution methodology assumes that vehicle trips will enter the network and access the development, then leave the development, and return to their direction of origin. However, in order to provide a conservative analysis, the pass-by trips were not considered for the purpose of this TGA. The site trip distributions utilized in this analysis are summarized in **Table 3**.

Residential Commercial To/From Via AM AM PM PM North Mack Ave 43% 38% 47% 38% 52% South Mack Ave 47% 43% 52% 5% 5% 5% East S Renauld Road 5% East Oxford Road 5% 5% 5% 5% Total 100% 100% 100% 100%

Table 3: Site Trip Distribution

The site-generated vehicular traffic volumes shown in **Table 1** were distributed to the study roadway network according to the site trip distribution shown in **Table 3**. The project site trip distribution volumes are shown in the attached **Figure 1**.



4 SAFETY REVIEW

4.1 CRASH ANALYSIS

A crash analysis was conducted at the intersections of Mack Avenue & S. Renauld Road and Mack Avenue & Oxford Road. The crash data used in the analysis was obtained from the Michigan Traffic Crash Facts (MTCF) website, for the most recent **five years** (January 1, 2020, to December 31, 2024) of available data.

The results of the crash analysis indicate that a total of 17 crashes occurred within the study area, based on the five years of available crash data. There 13 crashes reported at the Mack Avenue & Oxford Road intersection and four (4) crashes reported at the Mack Avenue & S. Renauld Road intersection.

- The majority (94%) of the crashes were due to failure to yield to traffic on Mack Ave. within the bidirectional crossovers.
- Three (3) crashes resulted in "Type-B" injuries and three (3) crashes resulted in "Type-C" injuries.

4.2 MULTI-MODAL REVIEW

The existing non-motorized facilities and the interconnectivity to the project site are shown in the attached **Figure 2**, indicating possible points of conflict between motorized traffic and pedestrian / bicycle traffic on the adjacent study roadways. Below is a summary of the existing non-motorized facilities:

- Sidewalk is currently provided along both sides of Mack Avenue, S. Renaud Road, and Oxford Road, within proximity of the project site.
- There are two (2) bus stops located within close proximity to the project site, including one (1) bus stop adjacent to the property frontage on Mack Avenue.
- Bike lanes are not provided along any of the study roadways, within close proximity of the project site.

The proposed development includes the removal of one (1) of the existing driveways on Oxford Road, which will reduce the number of conflict points between motorized vehicles and pedestrian / bicycle traffic, thereby improving non-motorized safety. Additionally, existing sidewalks are provided along all of the adjacent study roadways and is proposed internal to the site; therefore, pedestrian connectivity will be provided in all directions between the project site and the adjacent roadway network.

5 CONCLUSIONS

The conclusions of this TGA are as follows:

- The trips generated by the proposed development will access the property via driveways on S. Renaud Road and Oxford Road. The majority of traffic is expected to travel to/from Mack Avenue.
- A trip generation comparison was performed, indicating that the proposed development is comparable to the previous use (medical office building) of the project site.
- A crash analysis was conducted at the adjacent intersections of Mack Avenue & S. Renauld Road and Mack Avenue & Oxford, based on the most recent five (5) years of available data in the MTCF database.
 Detailed review of the crash reports (UD-10s) indicates that the majority (94%) of the crashes at the study intersections involved vehicles within the bi-directional crossovers.
- The proposed development plan includes the removal of one (1) of the existing site driveways on Oxford Road, which will reduce the number of conflict points between motorized vehicles and pedestrian / bicycle traffic, thereby improving non-motorized safety.
- Sidewalk is provided along all the adjacent study roadways and is proposed internal to the site; therefore, pedestrian connectivity will be provided in all directions between the project site and the adjacent roadway network.



Any questions related to this memorandum, study, analysis, and results should be addressed to Fleis & VandenBrink.



I hereby certify that this engineering document was prepared by me or under my direct personal supervision and that I am a duly licensed Professional Engineer under the laws of the State of Michigan.

Julie M. Kroll Julie M. Kuell 2025.09.11 14:46:47-04'00'

Attachments: Figures 1-2

Site Plan

Traffic Volume Data



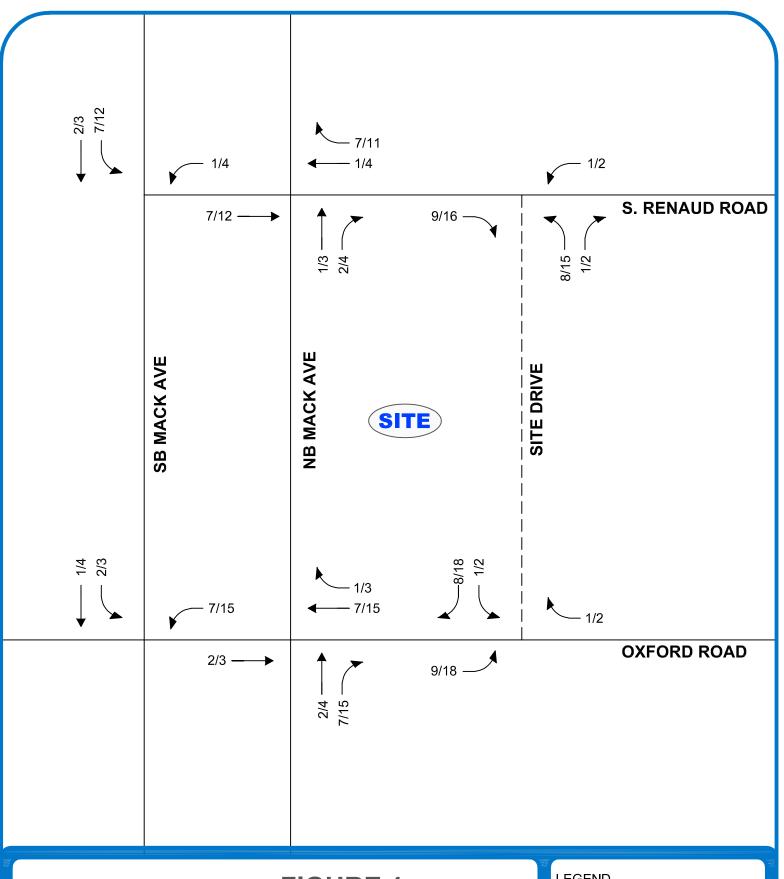




FIGURE 1 SITE-GENERATED TRAFFIC VOLUMES

BUCCELLATO RETAIL TGA - GROSSE POINTE WOODS, MI



ROADS



TRAFFIC VOLUMES (AM/PM)



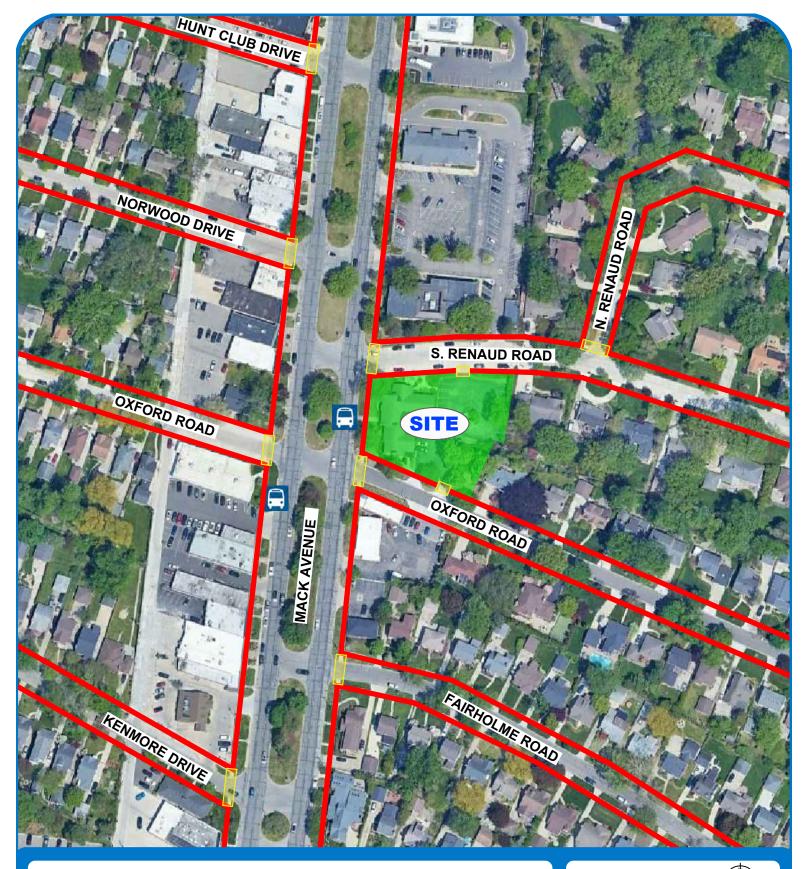




FIGURE 2 MULTI-MODAL CIRCULATION PLAN

BUCCELLATO RETAIL TGA - GROSSE POINTE WOODS, MI







SITE LOCATION NORTH SCALE: NOT TO SCALE




EXISTING SIDEWALK

BIKE LANE



EXISTING CROSSWALK / CONFLICT POINT BUS STOP

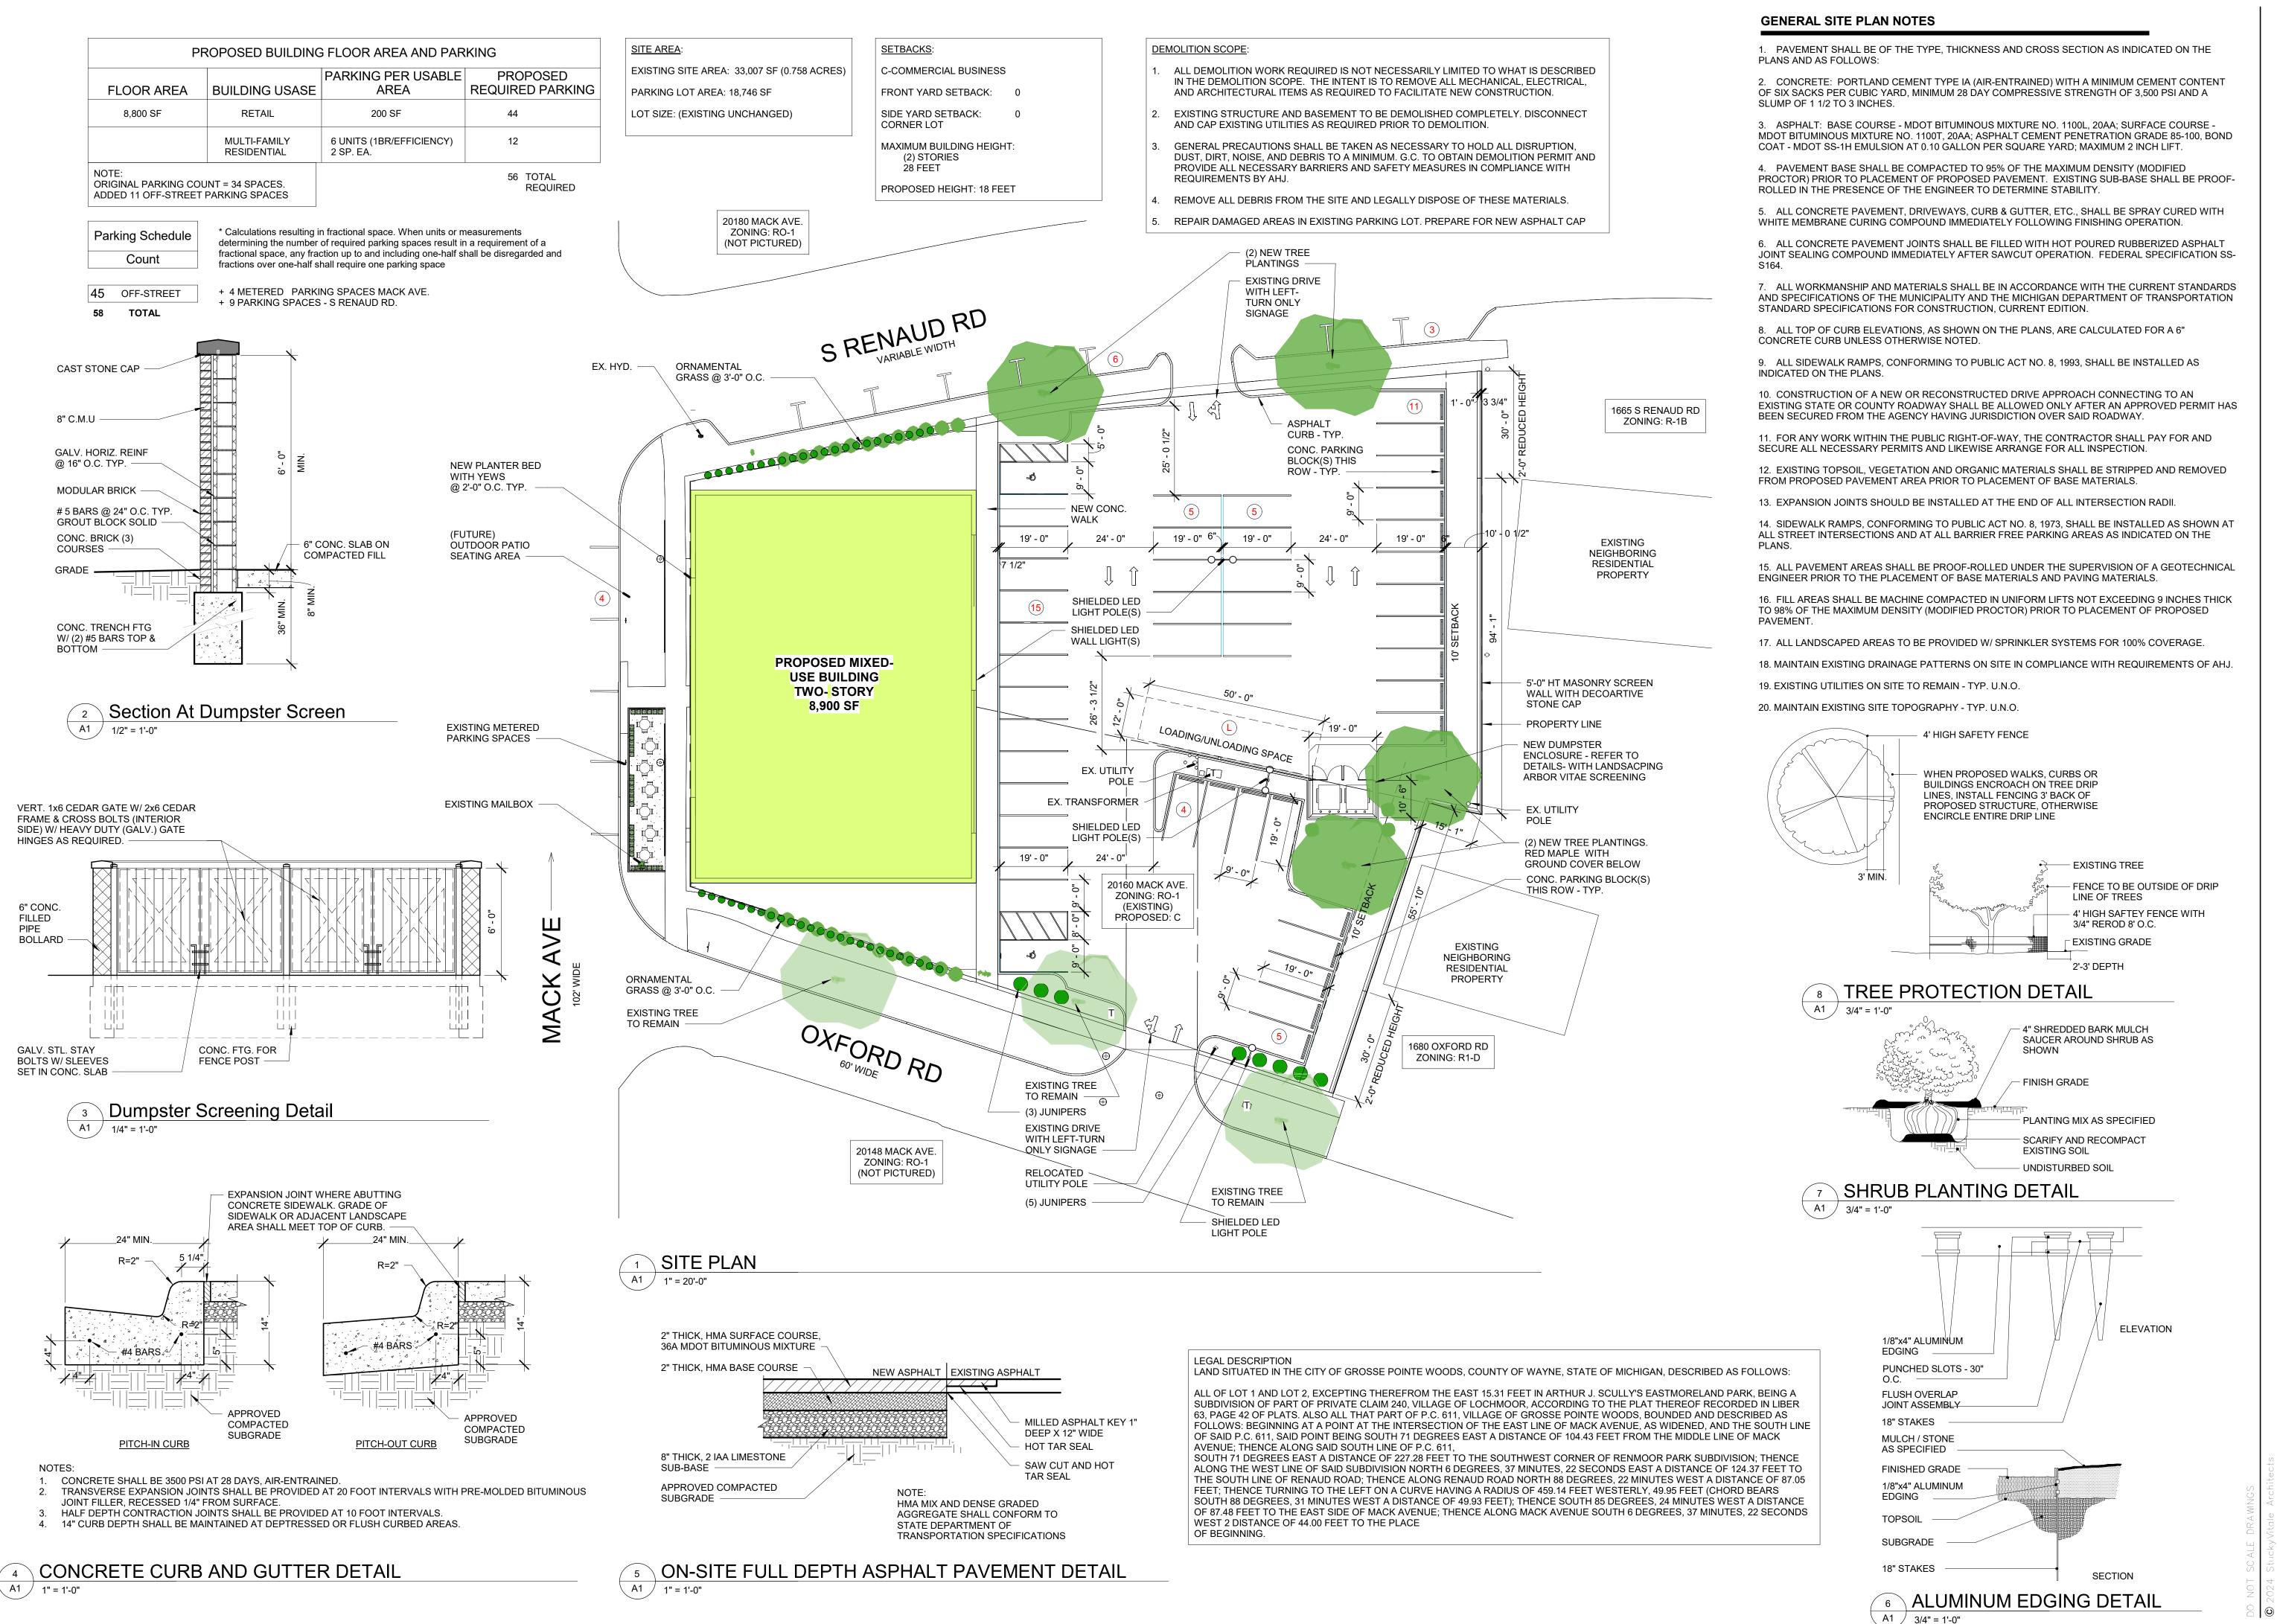

SVA

STUCKY VITALE ARCHITECTS
27172 WOODWARD AVENUE

ROYAL OAK, MI 48067-0925 P. 248.546.6700

F. 248.546.8454 WWW.STUCKYVITALE.COM

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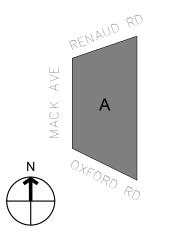
Consultants

Project :

RETAIL DEVELOPMENT

20160 Mack Ave, Grosse Pointe Woods, MI 48236

Key Plan:



Issued for

CITY SUBMITTAL 03.14.25
CITY SUBMITTAL 04.17.25
UPDATE
CITY SUBMITTAL 05.14.25

UPDATE

Drawn by : JGB, JPM

Checked by : JPM, JAV

Sheet Title : SITE PLAN + LANDSCAPE PLAN + DETAILS

Project No. : 2025.018

Sheet No. :

A1



Traffic Count (TCDS)





Volume Count Report

LOCATION INFO						
Location ID	50-5362					
Туре	SPOT					
Fnct'l Class	4					
Located On	Greater Mack Ave					
BETWEEN	Avalon St AND Maxine St					
Direction	2-WAY					
County	Macomb					
Community	St Clair Shores					
MPO ID	51633					
HPMS ID						
Agency	MDOT					

COUNT DATA INFO						
Count Status	Accepted					
Holiday	No					
Start Date	Wed 7/9/2025					
End Date	Thu 7/10/2025					
Start Time	12:00:00 AM					
End Time	12:00:00 AM					
Direction	2-WAY					
Station						
Study						
Speed Limit						
Description						
Sensor Type	Video (Length-based)					
Source	CombineVolumeCountsIncremental					
Latitude,Longitude						

INTERVAL:15-MIN							
	19	5-min	Hourly				
Time	1st	2nd	3rd	4th	Count		
0:00-1:00	17	13	7	11	48		
1:00-2:00	6	7	2	3	18		
2:00-3:00	6	2	2	2	12		
3:00-4:00	0	3	2	3	8		
4:00-5:00	4	9	14	18	45		
5:00-6:00	14	26	44	36	120		
6:00-7:00	48	57	90	114	309		
7:00-8:00	118	101	197	189	605		
8:00-9:00	191	198	210	249	848		
9:00-10:00	206	213	227	241	887		
10:00-11:00	237	265	251	273	1,026		
11:00-12:00	296	314	319	316	1,245		
12:00-13:00	330	315	359	368	1,372		
13:00-14:00	334	344	318	346	1,342		
14:00-15:00	302	302	262	333	1,199		
15:00-16:00	365	322	332	299	1,318		
16:00-17:00	360	367	370	345	1,442		
17:00-18:00	362	348	386	364	1,460		
18:00-19:00	306	329	331	289	1,255		
19:00-20:00	247	222	221	208	898		
20:00-21:00	197	157	161	119	634		
21:00-22:00	126	129	106	96	457		
22:00-23:00	60	52	43	42	197		
23:00-24:00 📵	36	26	28	14	104		
					10.016		
Total		16,849					
AADT	16,849 11:45-12:45						
AM Peak	1,320						
PM Peak	17:00-18:00 1,460						

NOTES/F	FILES		
	Note	Date	



Traffic Count (TCDS)





Volume Count Report

LOCATION INFO	
Location ID	50-5362_NE
Туре	SPOT
Fnct'l Class	4
Located On	Greater Mack Ave
Loc On Alias	
BETWEEN	Avalon St AND Maxine St
Direction	NE
County	Macomb
Community	St Clair Shores
MPO ID	51633
HPMS ID	
Agency	MDOT

COUNT DATA INF	FO
Count Status	Accepted
Holiday	No
Start Date	Wed 7/9/2025
End Date	Thu 7/10/2025
Start Time	12:00:00 AM
End Time	12:00:00 AM
Direction	
Station	
Study	
Speed Limit	
Description	
Sensor Type	Video (Length-based)
Source	
Latitude,Longitude	

INTERVAL:15-MIN							
	1:	15-min Interval					
Time	1st	2nd	3rd	4th	Count		
0:00-1:00	10	5	4	7	26		
1:00-2:00	4	3	1	3	11		
2:00-3:00	3	2	0	1	6		
3:00-4:00	0	1	0	1	2		
4:00-5:00	2	5	5	5	17		
5:00-6:00	6	9	14	10	39		
6:00-7:00	20	24	28	38	110		
7:00-8:00	55	48	97	81	281		
8:00-9:00	81	105	94	126	406		
9:00-10:00	115	121	114	122	472		
10:00-11:00	125	121	128	141	515		
11:00-12:00	156	187	174	160	677		
12:00-13:00	189	169	211	178	747		
13:00-14:00	168	185	155	172	680		
14:00-15:00	153	142	135	178	608		
15:00-16:00	216	179	189	166	750		
16:00-17:00	192	199	198	197	786		
17:00-18:00	206	210	216	205	837		
18:00-19:00	176	172	196	143	687		
19:00-20:00	115	109	112	100	436		
20:00-21:00	100	72	85	53	310		
21:00-22:00	66	69	44	44	223		
22:00-23:00	24	30	18	23	95		
23:00-24:00 📵	14	13	16	7	50		
Total	8,771						
AM Peak	11:45-12:45 729						
PM Peak	17:00-18:00 837						

NOTES/F	TILES		
	Note	Date	



Traffic Count (TCDS)





Volume Count Report

LOCATION INFO	
Location ID	50-5362_SW
Туре	SPOT
Fnct'l Class	4
Located On	Greater Mack Ave
Loc On Alias	
BETWEEN	Avalon St AND Maxine St
Direction	SW
County	Macomb
Community	St Clair Shores
MPO ID	51633
HPMS ID	
Agency	MDOT

COUNT DATA INF	0
Count Status	Accepted
Holiday	No
Start Date	Wed 7/9/2025
End Date	Thu 7/10/2025
Start Time	12:00:00 AM
End Time	12:00:00 AM
Direction	
Station	
Study	
Speed Limit	
Description	
Sensor Type	Video (Length-based)
Source	
Latitude,Longitude	_

INTERVAL:15-MIN					
	15-min Interval Hour				
Time	1st	1st 2nd 3rd			Count
0:00-1:00	7	8	3	4	22
1:00-2:00	2	4	1	0	7
2:00-3:00	3	0	2	1	6
3:00-4:00	0	2	2	2	6
4:00-5:00	2	4	9	13	28
5:00-6:00	8	17	30	26	81
6:00-7:00	28	33	62	76	199
7:00-8:00	63	53	100	108	324
8:00-9:00	110	93	116	123	442
9:00-10:00	91	92	113	119	415
10:00-11:00	112	144	123	132	511
11:00-12:00	140	127	145	156	568
12:00-13:00	141	146	148	190	625
13:00-14:00	166	159	163	174	662
14:00-15:00	149	160	127	155	591
15:00-16:00	149	143	143	133	568
16:00-17:00	168	168	172	148	656
17:00-18:00	156	138	170	159	623
18:00-19:00	130	157	135	146	568
19:00-20:00	132	113	109	108	462
20:00-21:00	97	85	76	66	324
21:00-22:00	60	60	62	52	234
22:00-23:00	36	22	25	19	102
23:00-24:00 📵	22	13	12	7	54
Total					8,078
AM Peak	11:45-12:45 591				
PM Peak	12:45-13:45 678				

NOTES/FILES			
	Note	Date	

City of Grosse Pointe Woods Planning Commission

Dear Planning Commission members,

For the past seven months, residents in the community surrounding 20160 Mack Avenue (and all over Grosse Pointe Woods) have been voicing concerns regarding the rezoning of the parcel and proposed new development. I thank you for taking some of the issues into consideration; however, I feel it is important to re-address many concerns, as the scope of the project has drastically changed.

The initial structure (April 2025 Planning Commission Public Hearing) comprised a one-story building with three individual retail units (11,000 total SF), with no planned uses or business-types provided by the developer. Residents voiced many concerns regarding traffic and pedestrian safety, lack of onsite parking, noise and light pollution, storm water drainage, lack of green space and more.

We are now presented with a new development consisting of two stories, 17,600 SF (almost double), with four planned retail units on the first floor and seven residential apartments on the second. The issues raised by residents over the past seven months are still extremely valid, given the expanded scope and include the following:

- 1. Parking While McKenna is currently noting that the proposed development offers a variety of uses and flexibility, they also state that each end user will be evaluated during the site plan phase AFTER conditional zoning approval has occurred. I hope that the planning commission is seriously weighing all of the possible scenarios that could occur. The apartments were described in the last commission meeting as 'high-end' by the architect, so what if there are multiple qualified tenants who would require more than one parking space per unit? Other considerations: Will these residential spaces be off limits to the customers of the retail establishments?; What about visitor and delivery parking for the residential units?; How can the correct allotment of manager and employee parking be guaranteed for the retail units when the businesses are unknown?; Will DoorDash, Uber Eats etc. drivers double-park on the residential streets to run in if the lot is full?; to name just a few. Currently, there is one medical office with an adjoining parking lot. We are faced with a rather large jump to a 4 retail/7 residential unit building. This most definitely guarantees that parking will overflow onto the adjoining streets.
- 2. Use of space Once again, no retail tenants have been named. Every other item that has come before the Planning Commission has the intended occupant stated. What if these retail establishments fail to command any new business once built? Will they sit empty awaiting potential lessees? The developer is also adding the condition that "The property shall be limited to one potential "quick services restaurant" with no drive-through and shall not exceed 3,200 square feet". The surrounding neighborhoods have stated time and again that they don't support food establishments of any kind, due to several adverse factors that will affect the community. A second condition states that the restaurant shall operate between the

hours of 6:00 a.m. and 10:00 p.m. and hard liquor sales shall not be permitted. This brings the following questions to mind: When do the residents get to enjoy their homes in peace?; No hard liquor is allowed, but what about beer and wine, which can lead to disorderly patrons?; Who is going to rent expensive apartments on top of retail and restaurant establishments and when do they get any peace in their homes?; and, Has anyone considered ADA accessibility standards for 2nd floor apartments?

- 3. Traffic and safety A Trip Generation Analysis (TGA) was performed by Fleis & Vandenbrink, based on their "knowledge of the study area, understanding of the development program, accepted traffic engineering practice, professional experience, and the methodologies published by the Institute of Transportation Engineers (ITE).". But what about the daily experience that residents have, navigating the area roads and this intersection in particular? Their concerns dealing with the heavily traversed Mack Avenue, blind spots turning from residential streets, and the ability to carefully navigate with other traffic and pedestrians has been brought to the attention of the commission and city council several times. Is the Planning Commission aware that there was a bad traffic accident that occurred recently on September 17th? A truck and an SUV ended up on the front lawn of the medical office, after taking out the postal dropbox and nearby signs. What if there had been an outdoor patio with customers in this space? These are real-life experiences, based on fact rather than assumption and theoretical calculations. Also, the MDOT traffic count presented in the agenda was located on Greater Mack Avenue between Avalon and Maxine streets – in St. Clair Shores, not Grosse Pointe Woods.
- 4. Advertising Lastly, is the commission aware that this piece of property had been advertised nationally as 'commercial' (now 'mixed-use') since early 2025? https://landmarkcres.com/properties/grosse-pointe-woods-new-development/. The State of Michigan requires real estate brokers to operate within legal boundaries and maintain professional standards. The Michigan Consumer Protection Act prohibits brokers from presenting false or misleading representations regarding property conditions, legal status, market value, etc. Rezoning has not officially occurred on this property, yet there is a new development brochure online, as well as a brokerage sign in front of 20160 Mack Ave., implying zoning other than RO-1.

Residents still have faith and expect that the Planning Commission will think critically and debate this proposal with careful consideration. Our homes are our refuge and sanctuary, and this development is sure to create a significant deal of change in a short period of time. Please think of the long-term effects this will have on the community, as well as the reason people are drawn to this city in the first place (peace and safety), and vote 'no' on rezoning this property to commercial. Thank you for your time and consideration.

Respectfully,

C. McIver 1653 S. Renaud Rd