TOWN OF GRAND LAKE STORMWATER MANAGEMENT PLAN



SEPTEMBER 2024



WATERVATION

Horizontal Scale & Orientation

	<u>=</u>	_	
Revision	Ву	Appd.	YY.MM.D
Issued		Appd.	YY.MM.D



TOWN OF GRAND LAKE STORMWATER MANAGEMENT PLAN

GRAND LAKE, CO

COVER

2023007041 NTS

GENERAL NOTES & LEGEND

- THESE PLANS ARE INTENDED TO PROVIDE THE TOWN OF GRAND LAKE WITH DESIGN DOCUMENTS TO OBTAIN CONTRACTOR BIDS. THESE DESIGNS
 MAY NEED TO BE MODIFIED AFTER ADDITIONAL INFORMATION IS OBTAINED SUCH AS, BUT NOT LIMITED TO, GROUND SURVEY, UTILITY
 LOCATIONS. ETC.
- 2. <u>UTILITIES HAVE NOT BEEN LOCATED</u> AS PART OF THE DESIGN FOR THIS PROJECT. MODIFICATIONS TO THESE DESIGNS MAY BE REQUIRED IF UTILITY CONFLICTS ARE FOUND.
- 3. THE CONTRACTOR SHALL DETERMINE THE EXACT LOCATION OF ALL EXISTING UTILITIES BEFORE COMMENCING WORK. CONTRACTOR TO CALL FOR UTILITY LOCATOR AT LEAST 3 CALENDAR DAYS BEFORE EXCAVATION. THE CONTRACTOR SHALL BE FULLY RESPONSIBLE FOR ANY AND ALL DAMAGES WHICH MIGHT BE CAUSED BY THEIR FAILURE TO EXACTLY LOCATE AND PRESERVE ANY AND ALL ABOVE GROUND AND UNDERGROUND UTILITIES. IN THE EVENT THAT THE CONTRACTOR UTILITY VERIFICATION RESULTS IN EXISTING STRUCTURES OR UTILITIES BEING IN CONFLICT WITH THE PROPOSED WORK OF THIS CONTRACT, THE CONTRACTOR SHALL IMMEDIATELY NOTIFY UTILITIES AND COORDINATE ANY NEEDED MODIFICATIONS TO THE PROPOSED WORK.
- 4. THE CONTRACTOR SHALL COORDINATE WITH ALL AFFECTED UTILITY OWNERS TO ESTABLISH THE REQUIREMENTS AND METHODS TO ACCOMMODATE THE PROTECTION, TEMPORARY SUPPORT, ADJUSTMENT OR RELOCATION OF UTILITIES PRIOR TO THE START OF CONSTRUCTION.
- OVERHEAD UTILITIES ARE NOT INDICATED ON PROFILE OR SECTION DRAWINGS.
- 6. THE CONTRACTOR SHALL BE RESPONSIBLE FOR PROTECTING AND MAINTAINING IN CONTINUOUS OPERATION, ALL EXISTING STRUCTURES. NOT ALL POTENTIALLY IMPACTED STRUCTURES MAY BE SHOWN ON THE DRAWINGS AND IT IS THE CONTRACTOR'S RESPONSIBILITY TO IDENTIFY AND PROTECT ALL STRUCTURES INCLUDING BUT NOT LIMITED TO STREETS, CURB AND GUTTER, BRIDGE PIERS AND ABUTMENTS, CREEK BANK PROTECTION OF VARIOUS TYPES, CREEK DROP STRUCTURES, SIGNS, PEDESTRIAN WALKS, RETAINING WALLS AND FENCING. IN THE EVENT THAT A STRUCTURE OR UTILITY IS DAMAGED DURING CONSTRUCTION THE CONTRACTOR SHALL IMMEDIATELY NOTIFY THE TOWN OF GRAND LAKE (TOWN) IN WRITING AND MAKE REPAIRS PER TOWN SPECIFICATIONS.
- 7. THE CONTRACTOR SHALL CONFIRM THE RECEIPT OF ALL NECESSARY PERMITS AND APPROVALS BEFORE THE START OF CONSTRUCTION.
- 8. ALL CONSTRUCTION SHALL BE IN ACCORDANCE WITH THE STANDARDS OF THE TOWN UNLESS SPECIFICALLY DETAILED OTHERWISE ON THESE PLANS AND ASSOCIATED SPECIFICATIONS. ANY ELEMENT OF CONSTRUCTION WHICH IS NOT ADDRESSED EITHER BY THESE PLANS AND SPECIFICATIONS OR BY THE STANDARDS OF THE TOWN SHALL CONFORM TO THE STANDARD SPECIFICATIONS OF THE NATURAL RESOURCES CONSERVATION SERVICE.
- THE CONTRACTOR SHALL MAINTAIN AT THE SITE AT ALL TIMES ONE SIGNED COPY OF THE PROJECT DRAWINGS AND SPECIFICATIONS, ONE COPY OF THE STORMWATER MANAGEMENT PLAN AND ONE COPY OF ALL REQUIRED PERMITS.
- 10. THE CONTRACTOR SHALL CONDUCT THEIR OPERATIONS IN SUCH A WAY THAT THE AREA OF DISTURBANCE IS MINIMIZED. ALL EXISTING TREES, SHRUBS AND VEGETATION SHALL BE PROTECTED UNLESS OTHERWISE NOTED ON THE DRAWINGS. NO TREES SHALL BE REMOVED WITHOUT APPROVAL FROM THE TOWN.
- 11. FOR ALL SITE GRADING, SMOOTH, PARABOLIC TRANSITIONS SHALL BE MADE BETWEEN CHANGES IN SLOPE. ALL FILL MATERIAL SHALL BE COMPACTED.
- 12. THE CONTRACTOR SHALL BE SOLELY RESPONSIBLE FOR PROVIDING STABLE EXCAVATIONS AND TEMPORARY SLOPES AND FOR SATISFYING ALL APPLICABLE FEDERAL, STATE AND LOCAL REGULATIONS.
- 13. CONSTRUCTION OF THE PROPOSED WORK WILL TAKE PLACE WITHIN THE CHANNEL AND WATER CONTROL MEASURES WILL BE REQUIRED. THE CONTRACTOR SHALL BE RESPONSIBLE FOR THE ACCEPTANCE AND CONTROL OF DRAINAGE WATER FROM AREAS ADJACENT TO THE SAN MIGUEL RIVER AND FOR FLOW WITHIN THE SAN MIGUEL RIVER AND ITS TRIBUTARIES INCLUDING STORMWATER OUTFALLS. THE CONTRACTOR SHALL BE SOLELY RESPONSIBLE FOR ESTABLISHING MEANS AND METHODS OF GROUND AND SURFACE WATER CONTROL APPROPRIATE FOR CONSTRUCTION IN ACCORDANCE WITH THE REQUIREMENTS OF THE PROJECT DRAWINGS AND SPECIFICATIONS AND ALL APPLICABLE FEDERAL, STATE AND LOCAL REGULATIONS AND PERMITS.
- 14. THE CONTRACTOR SHALL PREPARE AND MAINTAIN THE STORMWATER MANAGEMENT PLAN AND OBTAIN THE NATIONAL POLLUTION DISCHARGE ELIMINATION SYSTEM (NPDES) PERMIT THROUGH THE COLORADO DEPARTMENT OF PUBLIC HEALTH & ENVIRONMENT AND ALL OTHER APPROPRIATE FEDERAL, STATE AND LOCAL PERMITS.
- 15. CONTRACTOR SHALL BE RESPONSIBLE FOR AS-BUILT DRAWINGS TO BE SUBMITTED TO THE TOWN, IN ACCORDANCE WITH THE CONTRACT DOCUMENTS.
- 16. THE CONTRACTOR SHALL PROVIDE AND MAINTAIN DAILY ON-SITE GPS SURVEY CONTROL
- 17. CONTRACTOR SHALL FENCE OFF CRITICAL AREAS TO BE PROTECTED AT THE DISCRETION OF THE TOWN.
- 18. THE CONTRACTOR SHALL DEVELOP A TRAFFIC CONTROL PLAN IF REQUIRED BY THE TOWN.
- 19. CONSTRUCTION TOLERANCES:
- 19.1. HORIZONTAL=PER PLAN
- 19.2. VERTICAL=0.10 FEET
- 20. CHANGES TO THESE DESIGN PLANS SHALL NOT BE ALLOWED UNLESS APPROVED IN WRITING BY THE DESIGN ENGINEER
- 21. ALL DESIGNS WERE SIZED FOR THE 2-YEAR STORM.
- 22. DESIGNS BASED ON 2020 USGS LIDAR. DISCREPANCIES BETWEEN THIS LIDAR DATA AND GROUND-BASED SURVEY DATA. ACTUAL GROUND ELEVATIONS SHALL BE SURVEYED PRIOR TO CONSTRUCTION. IF SIGNIFICANT DISCREPANCIES EXIST THE DESIGNS CONTAINED HEREIN MAY NEED TO BE MODIFIED.
- 23. ALL DAYLIGHT SLOPED SHALL BE COVERED WITH NEDIA KOIR MAT 900 (OR APPROVED EQUAL) AND INSTALLED PER MANUFACTURERS RECOMMENDATIONS.
- 24. ALL DISTURBED AREAS SHALL BE REVEGETATED WITH NATIVE WETLAND, RIPARIAN, AND/OR UPLAND SEED MIXES, DEPENDING ON HYDROLOGIC ZONE. CONTRACTOR TO CONSULT WITH A QUALIFIED ECOLOGIST FOR SPECIFIC RECOMMENDATIONS.

SURVEY CONTROL

DESIGNS BASED ON 2020 USGS LIDAR NAD 83 COLORADO STATE PLANES NORTH, U.S. FOOT NAVD 88

SPECIFICATIONS

- BIORETENTION & GRASS SWALE
- 1.1. MILE HIGH FLOOD DISTRICT SPECIFICATIONS
- ROCK SWALE
- 2.1. MILE HIGH FLOOD DISTRICT SPECIFICATIONS
- 3. REINFORCED CONCRETE PIPE & INLETS
- 3.1. COLORADO DEPARTMENT OF TRANSPORTATION



WATERVATION
130 W. Sackett Ave., Unit A
Salida, CO 81201

Copyright Reserved

The Contractor shall verify and be responsible for all dimensions. DO NOT scale the drawing - any errors or omissions shall be reported to Water Vation without delay. The Copyrights to all designs and drawings are the property of Water Vation. Reproduction or use for any purpose other than that

Sub-Consultants

Horizontal Scale & Orientatio

Legend

	 _		
	 =	_	
D. 11.	 By	Appd	YY.MM.D
Revision	 		
	 _		
	=	=	
	=		
Issued	Ву	Appd.	YY.MM.E
File Name	 		24 00 12

Dwn Chkd Dsan YY.MM.DC



Client/Project

TOWN OF GRAND LAKE STORMWATER MANAGEMENT PLAN

GRAND LAKE, CO

Project Milestone

CENTER AT MOTE

GENERAL NOTES

2023007041 NTS

Project No. Horizo

Horizontal Scal

Sheet 2 of 68

C:\Users\lucasbabbitt\watervation Dropbox\Projects\2023007041_grand Lake Stormwater Ne 2024/09/16 9:50 AM 8r. Lucas Babbitt

	Sheet List Table
Sheet Number	Sheet Title
1	COVER
2	GENERAL NOTES
3	TABLE OF CONTENTS
4	CONCEPT PLAN
5	AREAS SELECTED FOR PRELIM. DESIGN
6	WATER QUALITY DATA
7	BIORETENTION B-1
8	BIORETENTION B-3
9	GRASS SWALE_MDS_1 (1)
10	GRASS SWALE_MDS_1 (2)
11	XSEC_MDS_1
12	XSEC_MDS_1 (2)
13	XSEC_MDS_1 (3)
14	XSEC_MDS_1 (4)
15	XSEC_MDS_1 (5)
16	GRASS SWALE_MDS_2
17	XSEC_MDS_2
18	XSEC_MDS_2 (2)
19	XSEC_MDS_2 (3)
20	GRASS SWALE_CDW (1)
21	GRASS SWALE_CDW (2)
22	XSEC_CDW (23)
23	XSEC_CDW (22)
24	XSEC_CDW (21)
25	XSEC_CDW (20)
26	XSEC_CDW (19)
27	XSEC_CDW (18)
28	XSEC_CDW (17)
29	XSEC_CDW (16)
30	XSEC_CDW (15)
31	XSEC_CDW (14)
32	XSEC_CDW (13)
33	XSEC_CDW (12)
34	XSEC_CDW (11)
35	XSEC_CDW (10)
36	XSEC_CDW (9)
37	XSEC_CDW (8)
38	XSEC_CDW (7)
39	XSEC_CDW (6)
40	XSEC_CDW (5)
41	XSEC_CDW (4)
42	XSEC_CDW (3)
43	XSEC_CDW (2)

44	XSEC_CDW
45	GRASS SWALE_CDE
46	XSEC_CDE (5)
47	XSEC_CDE (4)
48	XSEC_CDE (3)
49	XSEC_CDE (2)
50	XSEC_CDE
51	ROCK SWALE
52	ROCK SWALE (2)
53	LITTLE COLUMBINE CREEK - (1)
54	LITTLE COLUMBINE CREEK - (2)
55	LITTLE COLUMBINE CREEK - (3)
56	DETAIL_BIORETENTION
57	DETAIL_BIORETENTION CONT.
58	DETAIL_WETLAND SOD
59	DETAIL_WETLAND SOD (2)
60	LOG RIFFLE EXAMPLE
61	DETAIL_LOG RIFFLE
62	BEAVER DAM ANALOGUE STRUCTURE EXAMPLE
63	DETAIL_BEAVER DAM ANALOGUE STRUCTURE
64	DETAIL_ROCK SWALE TYPICAL SECTION
65	DETAIL_VOID FILLED RIPRAP
66	DETAIL_CDOT TYPE C INLET
67	DETAIL_CDOT RCP
68	DETAIL_CDOT END SECTION



Copyright Reserved

The Contractor shall verify and be responsible for all dimensions. DO NOT scale the drawing - any errors or omissions shall be reported to WaterValton without delay.

The Copyrights to all designs and drawings are the property of WaterValton. Reproduction or use for any purpose other than that authorized by WaterValton is forbidden.

Sub-Consultants

Horizontal Scale & Orientation

Revision			Appd. YY.MM.DD	
Issued			Appd. YY.MM.DD	
File Name:	Dwn.	Chkd.	24.09.12 Dsgn. YY.MM.DD	



Client/Project

TOWN OF GRAND LAKE STORMWATER MANAGEMENT PLAN


GRAND LAKE, CO


Project Milestone

TABLE OF CONTENTS

2023007041 NTS Project No.

Sheet 3 of 68

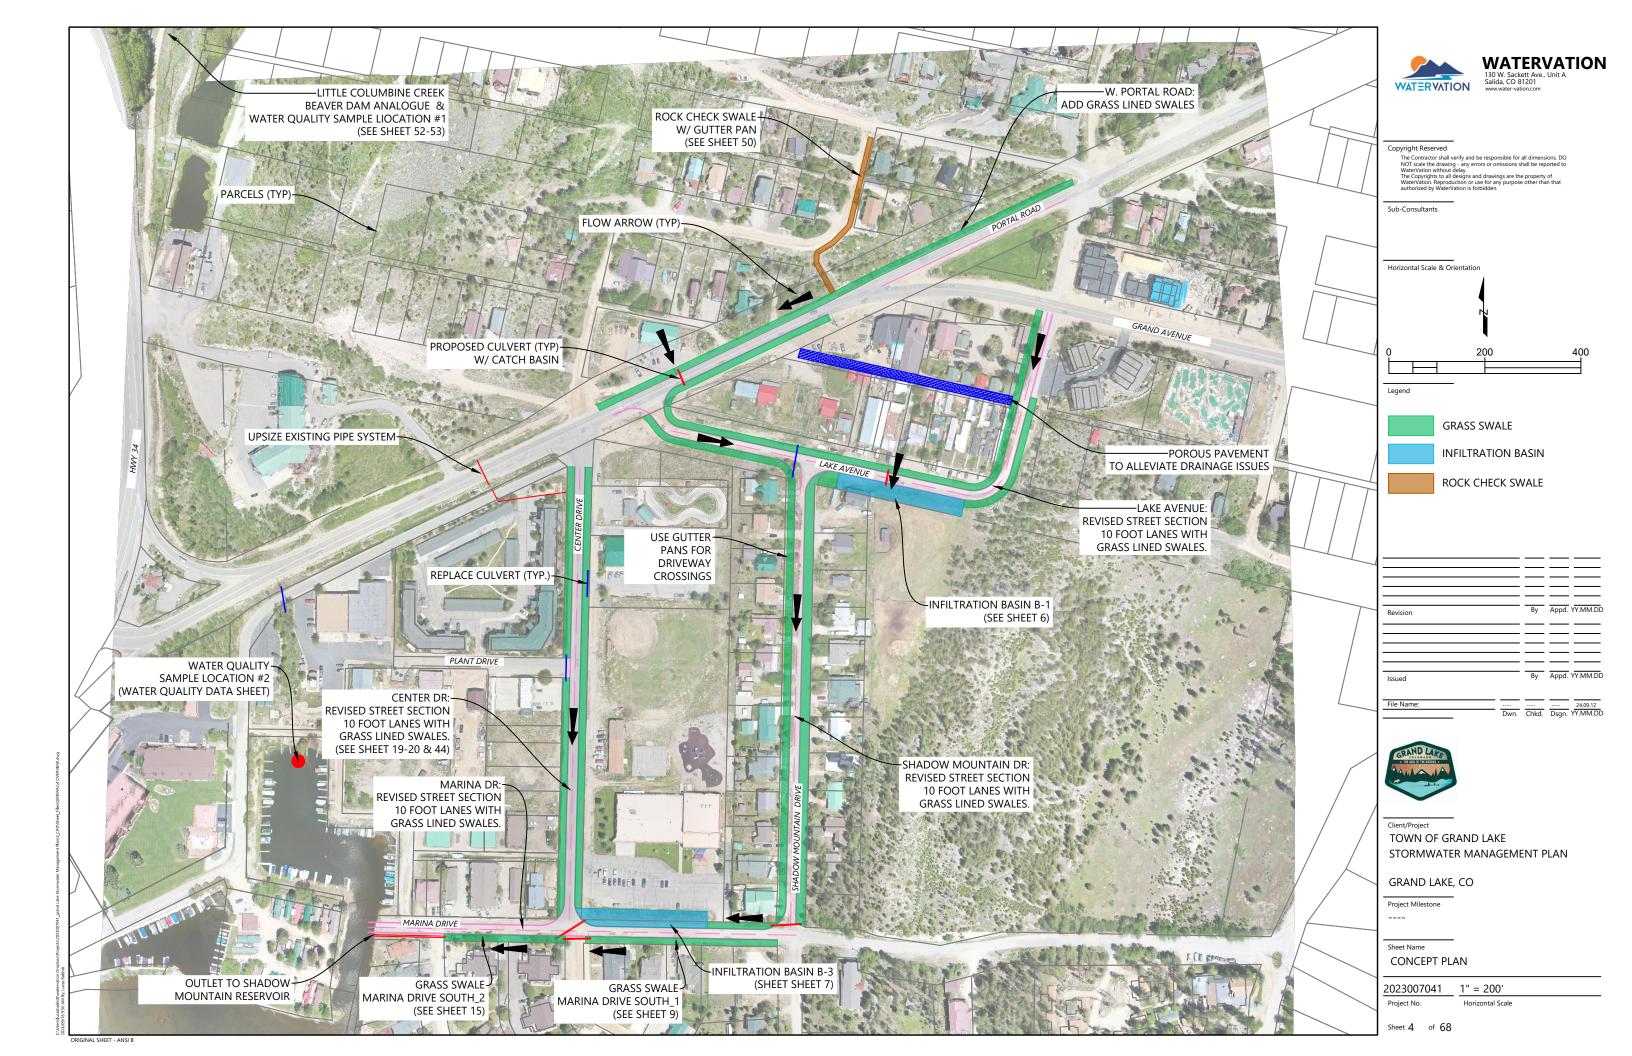

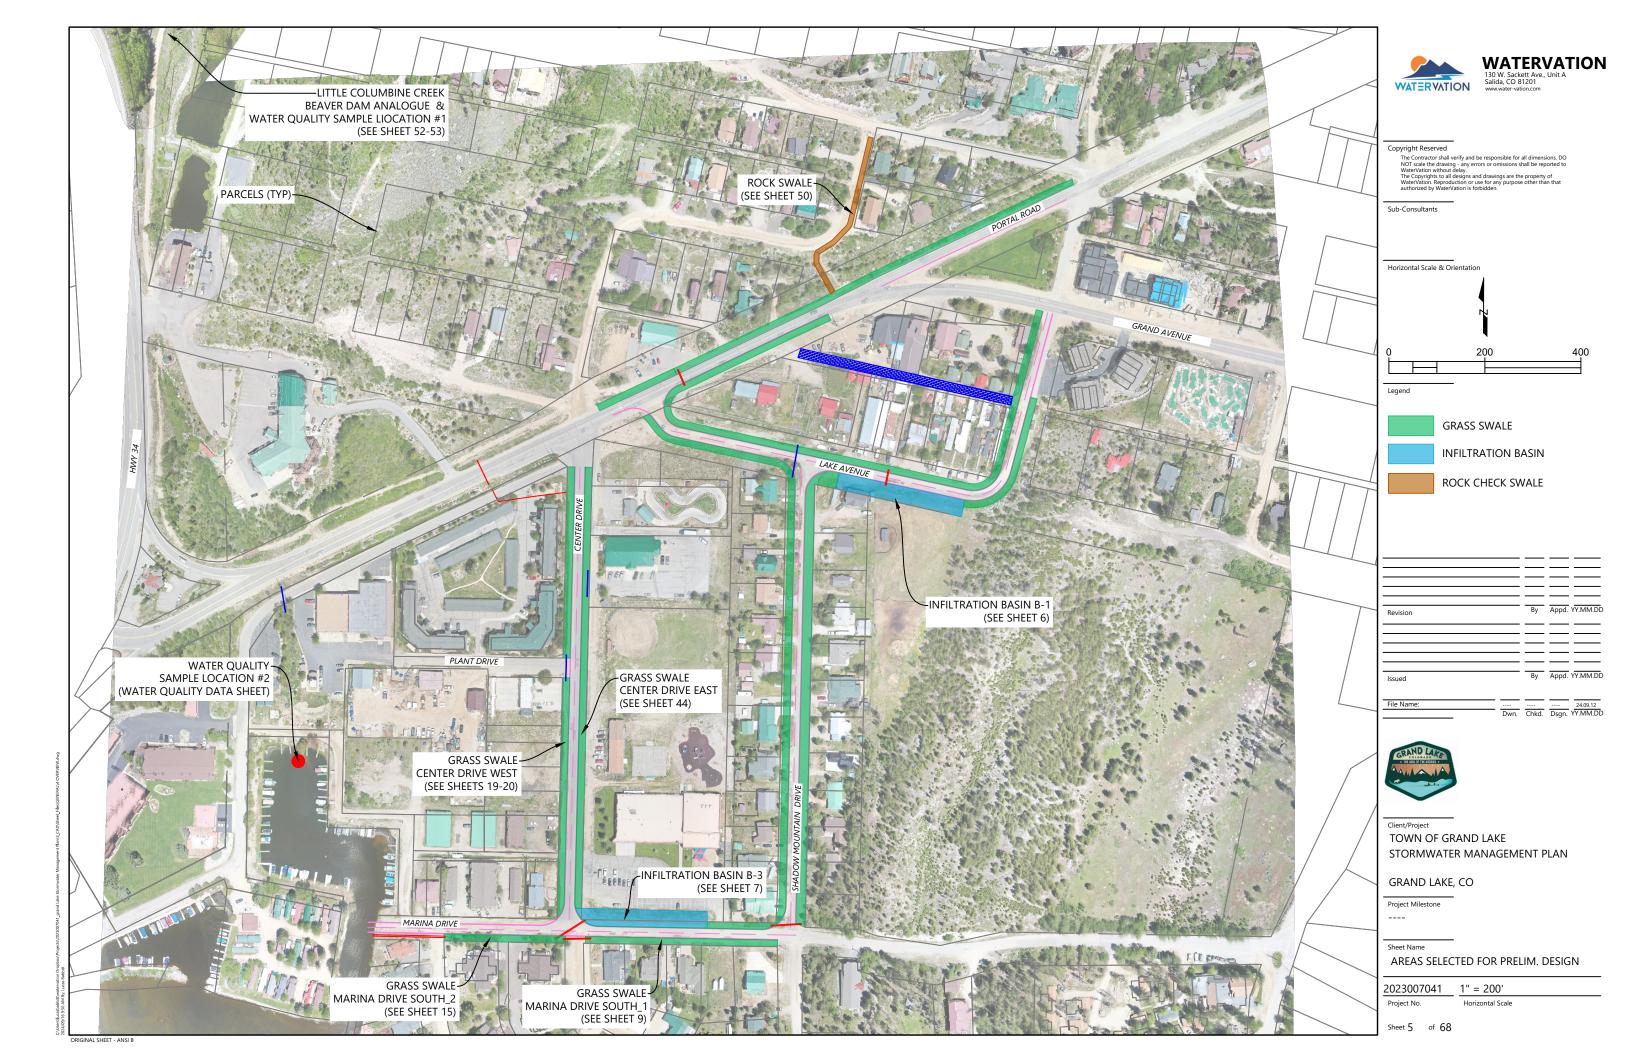

BASELINE WATER QUALITY DATA

I	LOCATION	DESCRIPTION	TOTAL COLIFORM (MPN/100mL)	E. COLI (MPN/100mL)	ORTHO-PHOSPHATE (mg/L)	NITRATE-NITRITE (mg/L)
	#1	LITTLE COLUMBINE CREEK	325.5	79.8	<0.05	0.120
	#2	MARINA	613.1	7.40	<0.05	0.099

Definitions

MPN/100mL = Most Probable Number per 100 milliliters

mg/L =Milligrams per liter

Water quality analysis performed by Colorado Department of Public Health & Environment



WATERVATION

Copyright Reserved

pypright Keserved

The Contractor shall verify and be responsible for all dimensions. DO

NOT scale the drawing - any errors or omissions shall be reported to

Water Vation without delay.

The Copyrights to all designs and drawings are the property of

Water Vation. Reproduction or use for any purpose other than that

authorized by Water Vation is forbidden.

Sub-Consultants

Horizontal Scale & Orientation

	\equiv		
Revision		Appd.	YY.MM.DI
	\equiv		
		Appd.	YY.MM.DI
Issued	-,	ррч.	



Client/Project

TOWN OF GRAND LAKE STORMWATER MANAGEMENT PLAN


GRAND LAKE, CO

Project Milestone

WATER QUALITY DATA

2023007041 NTS

Sheet 6 of 68

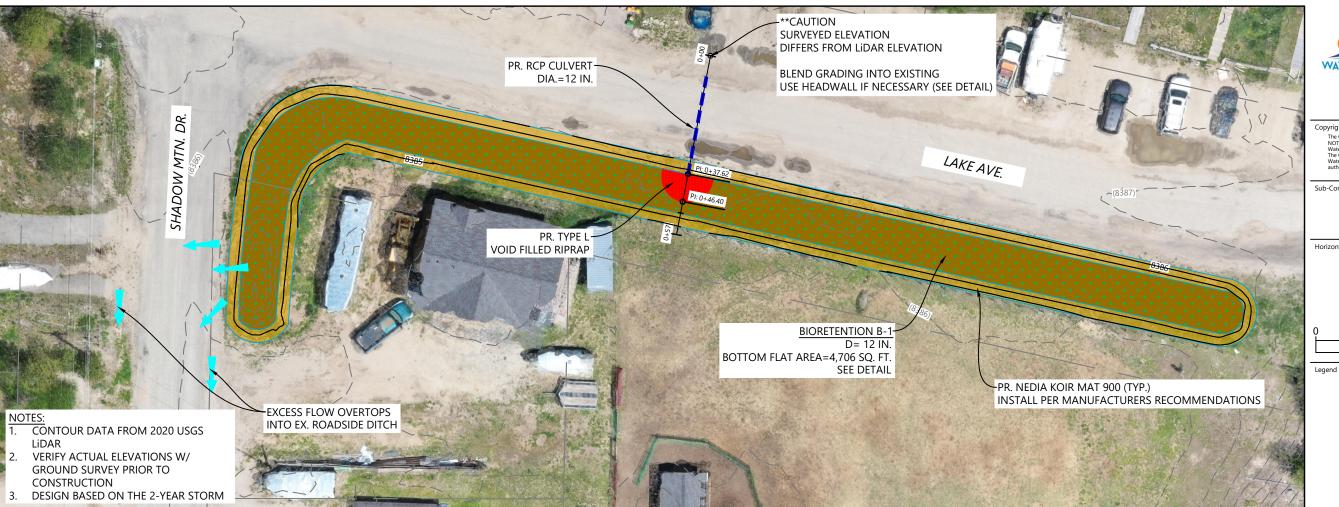



WATERVATION


Copyright Reserved


pyright, neserveu.

The Contractor shall verify and be responsible for all dimensions. DO NOT scale the drawing - any errors or omissions shall be reported to Water-Vation without delay.

The Copyrights to all designs and drawings are the property of Water-Vation. Reproduction or use for any purpose other than that authorized by Water-Vation is Torbidden.

Sub-Consultants

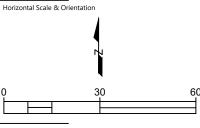

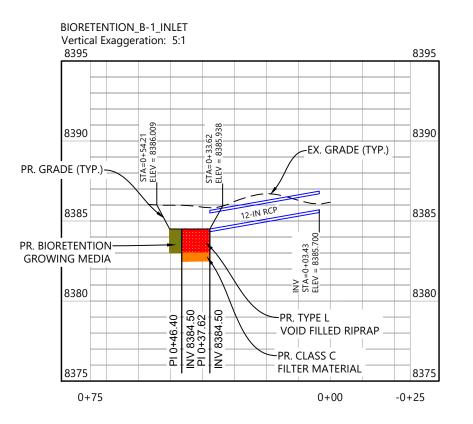

Issued File Name:
 Dwn.
 Chkd.
 Dsgn.
 24.09.12 YY.MM.DD



Client/Project

TOWN OF GRAND LAKE STORMWATER MANAGEMENT PLAN


GRAND LAKE, CO


Project Milestone **PRELIMINARY**

BIORETENTION B-1

2023007041 1" = 30'

Sheet 7 of 68

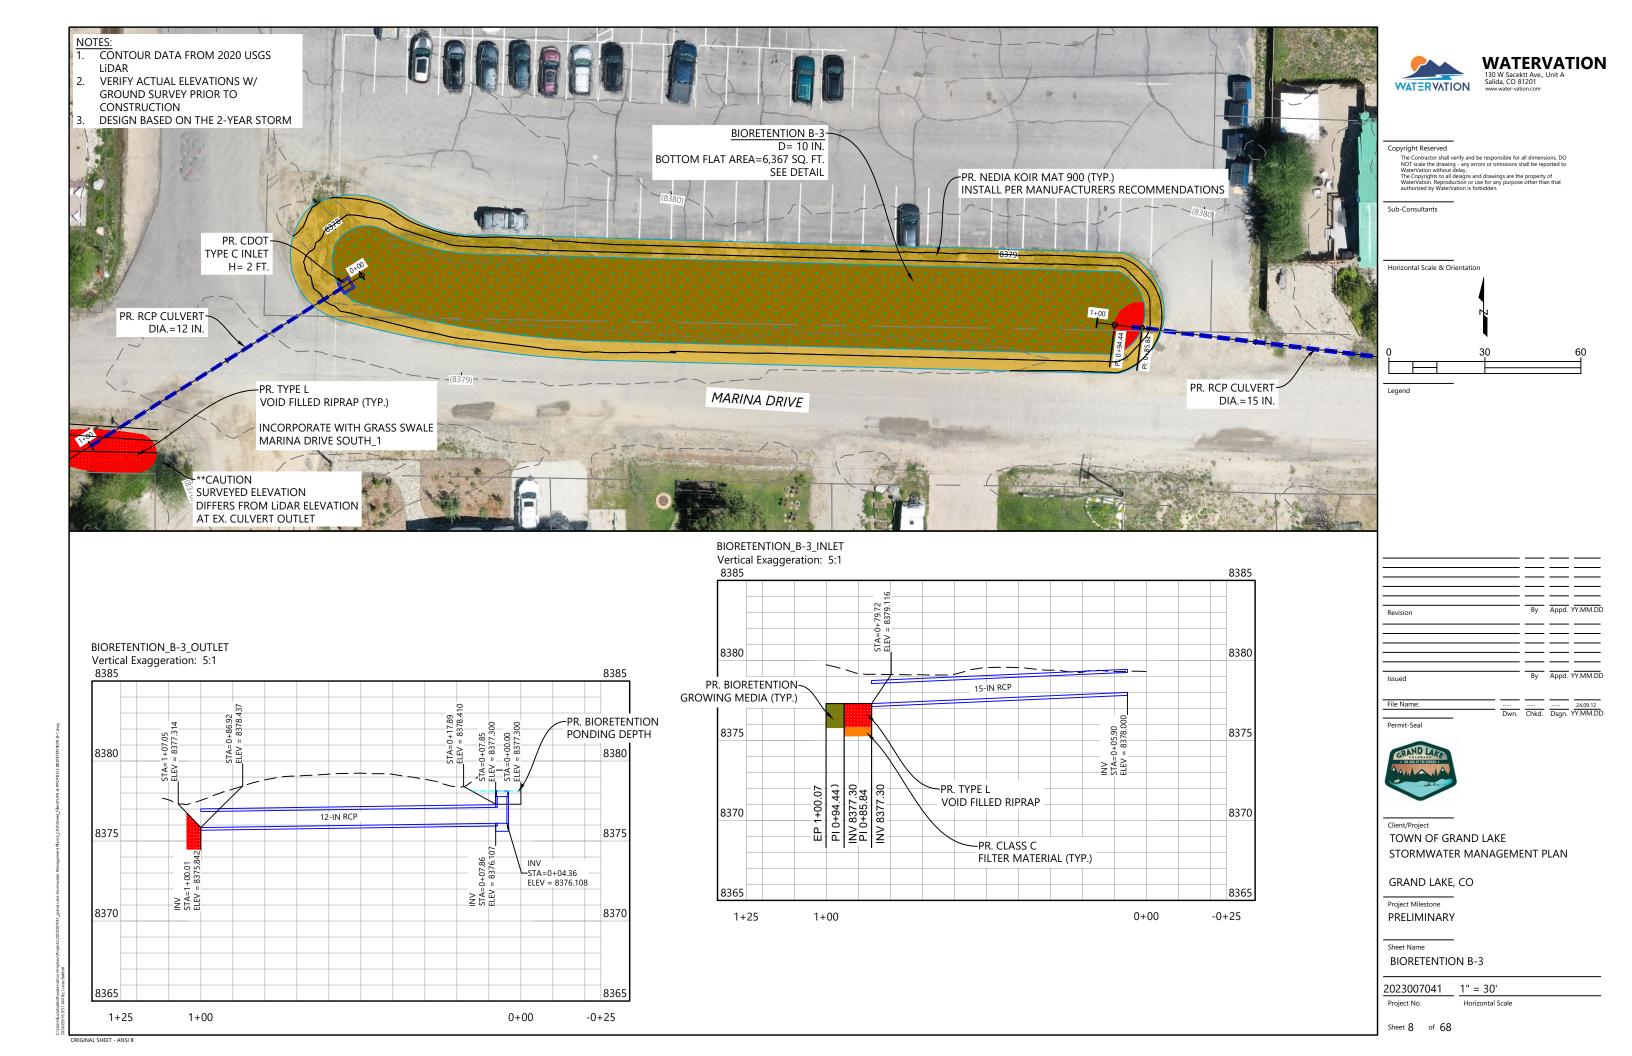

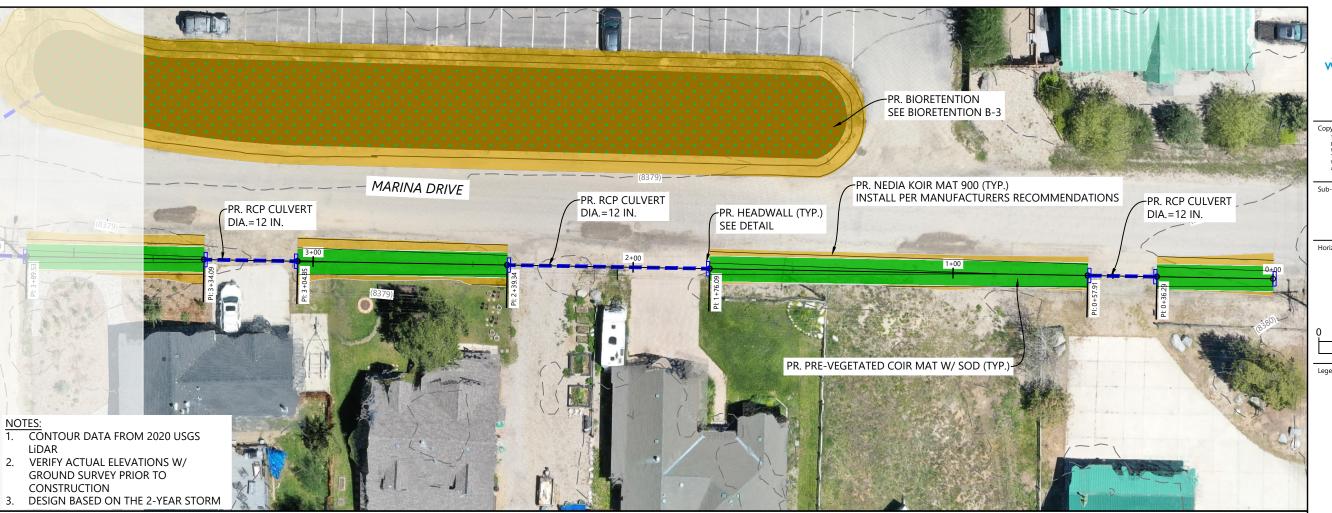



WATERVATION

Copyright Reserved

Lypright Reserveu.


The Contractor shall verify and be responsible for all dimensions. DO NOT scale the drawing - any errors or omissions shall be reported to Water-Vation without delay.

The Copyrights to all designs and drawings are the property of Water-Vation. Reproduction or use for any purpose other than that authorized by Water-Vation is forbidden.

Sub-Consultants

Horizontal Scale & Orientation

MARINA DRIVE_SOUTH_1 Vertical Exaggeration: 5:1

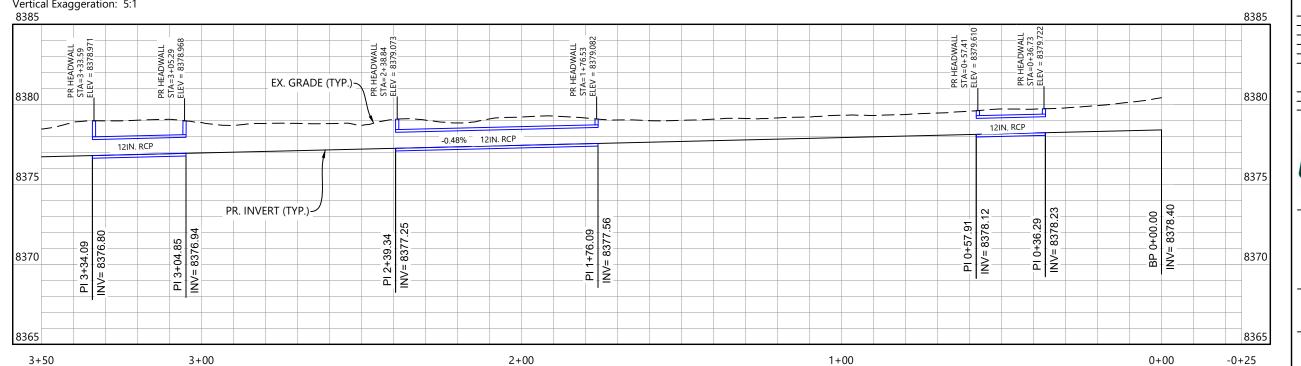

Issued File Name:
 Dwn.
 Chkd.
 Dsgn.
 YY.MM.DD



Client/Project

TOWN OF GRAND LAKE STORMWATER MANAGEMENT PLAN


GRAND LAKE, CO

Project Milestone

GRASS SWALE_MDS_1 (1)

2023007041 1" = 30'

Sheet 9 of 68

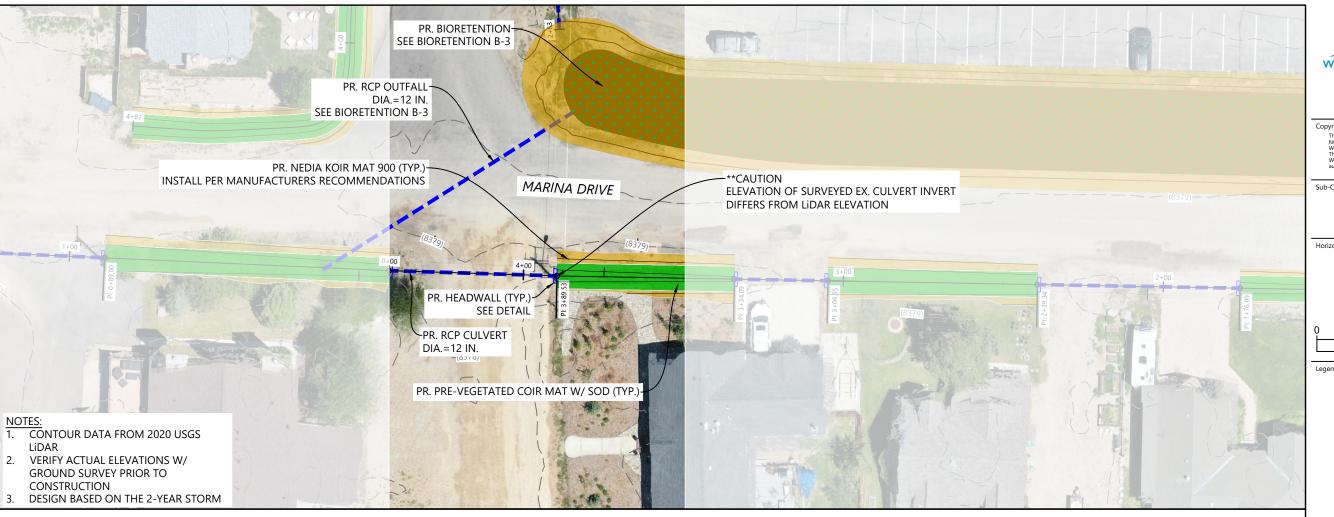

4+00


8385


8380 岩

8375

8370

4+50

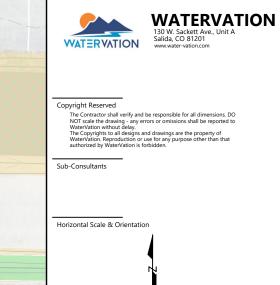

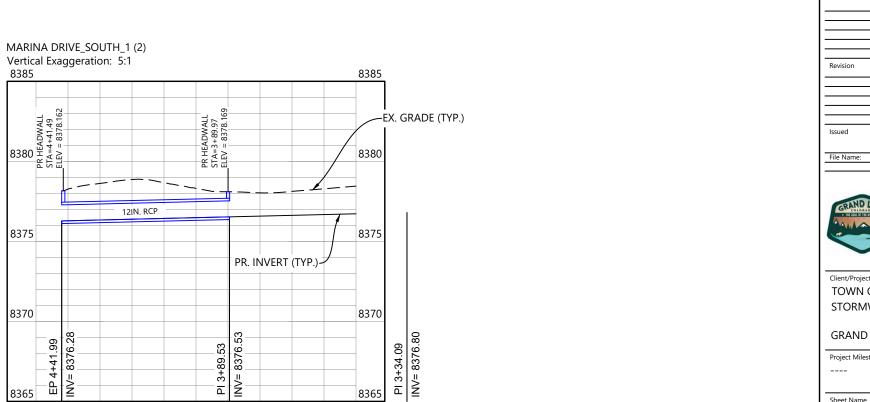


8365

3+50



2023007041 1" = 30'

Sheet 10 of 68

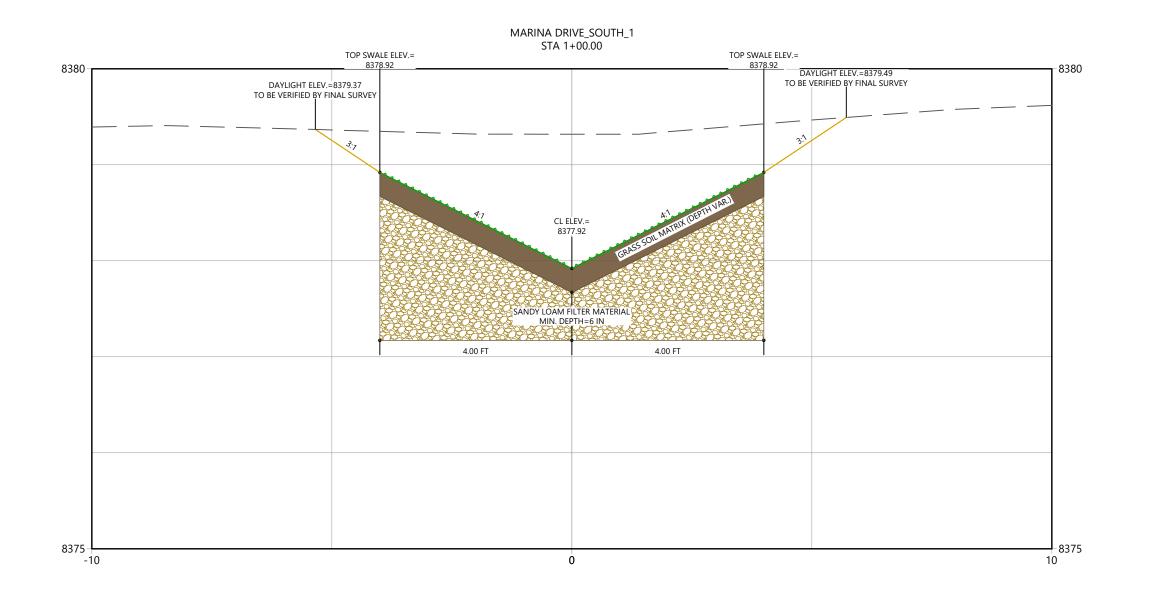



Copyright Reserved

opyright Keserved

The Contract shall verify and be responsible for all dimensions. DO

NOT scale the drawing - any errors or omissions shall be reported to

Water Vation without delay.

The Copyrights to all designs and drawings are the property of

WaterVation. Reproduction or use for any purpose other than that

authorized by WaterVation is forbidden.

Sub-Consultants

Horizontal Scale & Orientation

()	2	2	4

Legeno

			_	
		=	=	
		—		
Revision		Ву	Appd.	YY.MM.DD
		—		
		=		
		—		
Issued		Ву	Appd.	YY.MM.DD
File Name:				24.09.12
	Dwn.	Chkd.	Dsgn.	YY.MM.DD

Permit-Seal

Client/Project

TOWN OF GRAND LAKE STORMWATER MANAGEMENT PLAN

GRAND LAKE, CO

Project Milestone


Sheet Name
XSEC_MDS_1

2023007041 1" = 2'

t No. Horizontal S

Sheet 11 of 68

C:\Users\Lucasbabbittwatervation Dropbox\Projects\2023007041_grand Lake Stormwater Manage 2024/09/16 951 AM Br. Lucas Babbitt

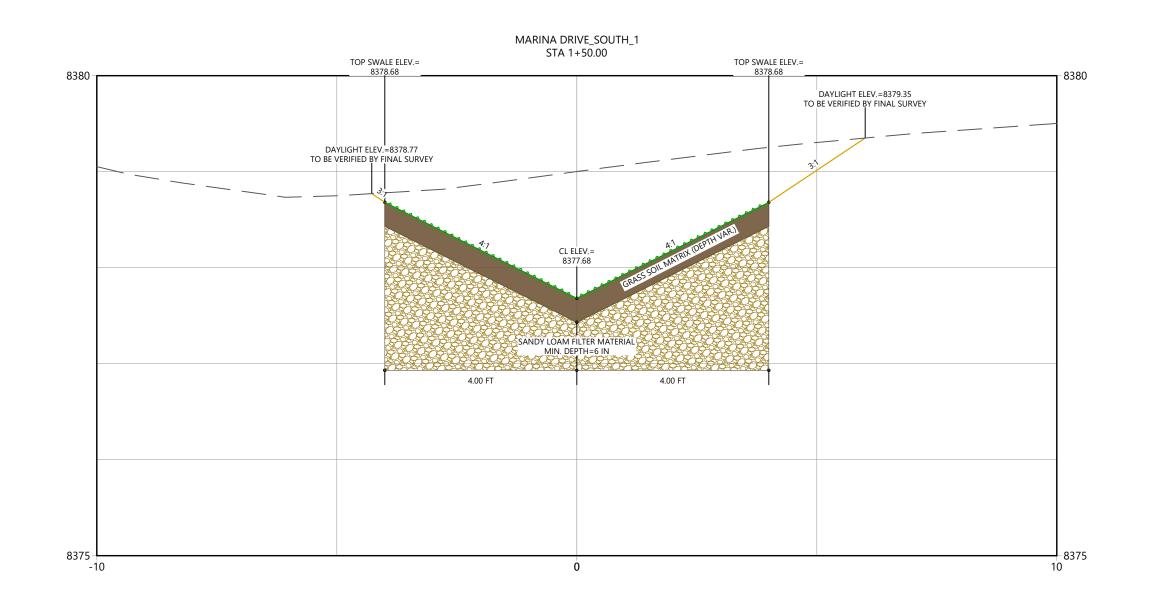



Copyright Reserved

pypright Keserved

The Contractor shall verify and be responsible for all dimensions. DO

NOT scale the drawing - any errors or omissions shall be reported to

Water Vation without delay.

The Copyrights to all designs and drawings are the property of

Water Vation. Reproduction or use for any purpose other than that

authorized by Water Vation is forbidden.

Sub-Consultants

Horizontal Scale & Orientation

Ιº	2	<u>2</u>
		•

		=	_	
		_	_	
		_	_	
Revision		Ву	Appd.	YY.MM.DD
		_	=	
		=	_	
		By	Annd	YY.MM.DD
Issued		Бу	арра.	TT.MIM.UU
File Name:	Dwn.	Chkd.	Dsgn.	24.09.12 YY.MM.DD

Client/Project
TOWN OF GRAND LAKE

STORMWATER MANAGEMENT PLAN

GRAND LAKE, CO


Project Milestone

Sheet Name
XSEC_MDS_1 (2)

2023007041 1" = 2'

Horizontal Scale

Sheet 12 of 68

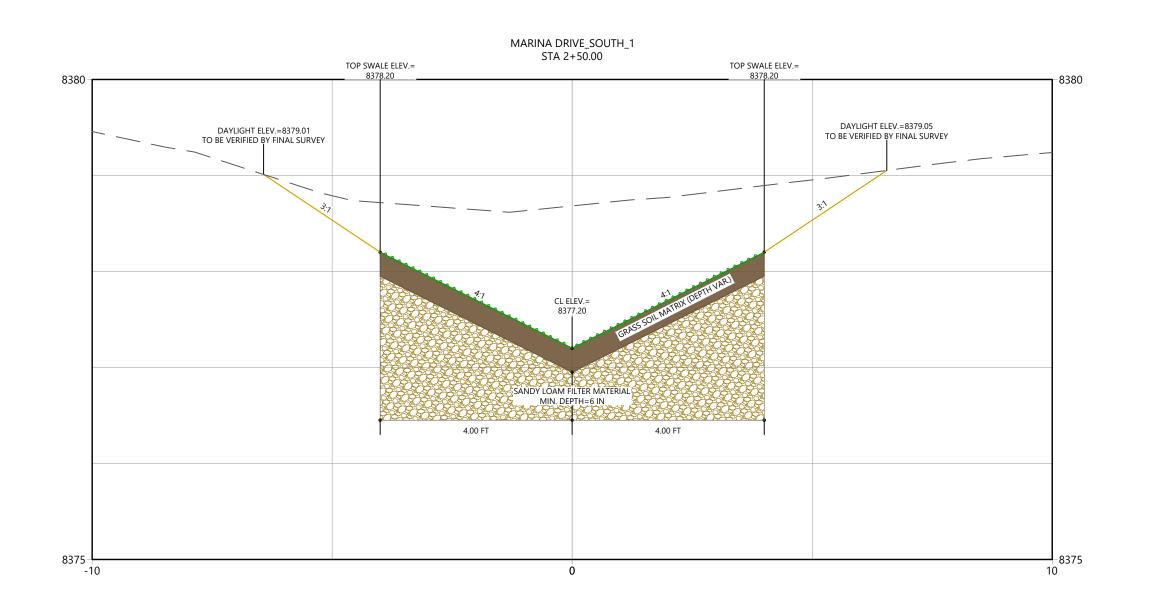



Copyright Reserved

opyright Keserved

The Contract shall verify and be responsible for all dimensions. DO

NOT scale the drawing - any errors or omissions shall be reported to

Water Vation without delay.

The Copyrights to all designs and drawings are the property of

WaterVation. Reproduction or use for any purpose other than that

authorized by WaterVation is forbidden.

Sub-Consultants

Horizontal Scale & Orientation

()	2	2	
				Ī

Legeno

		=		
evision		Ву	Appd.	YY.MM.DD
sued		Ву	Appd.	YY.MM.DD
ile Name:				24.09.12
	Dwn.	Chkd.	Dsgn.	YY.MM.DD

Client/Project

TOWN OF GRAND LAKE STORMWATER MANAGEMENT PLAN

GRAND LAKE, CO


Project Milestone

Sheet Name
XSEC_MDS_1 (3)

2023007041 1" = 2'

roject No

Sheet 13 of 68

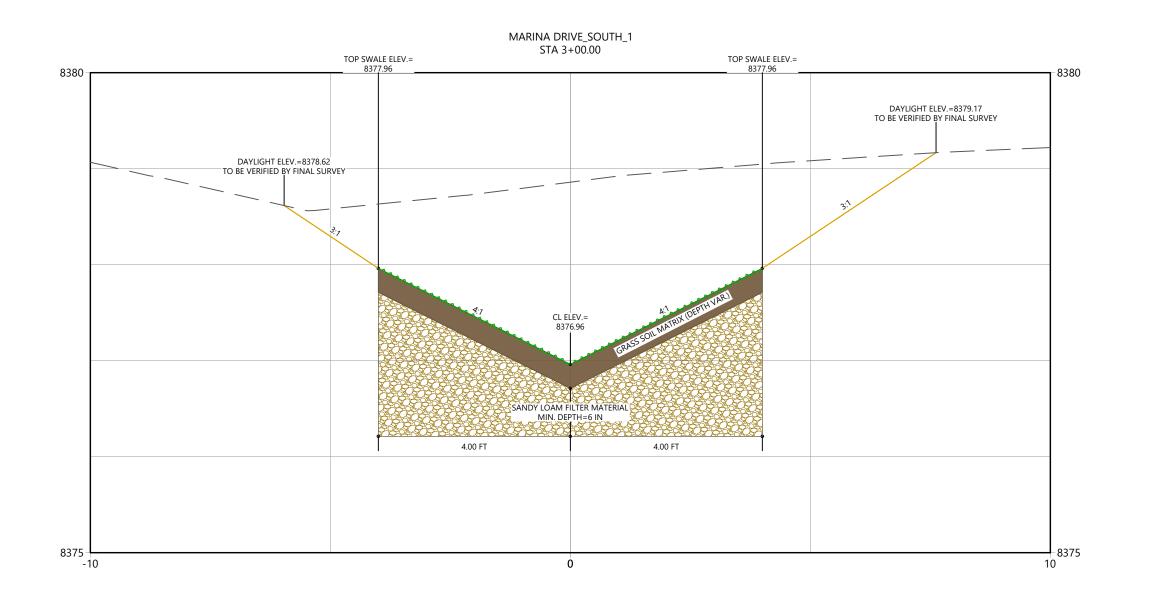



WATERVATION
130 W. Sackett Ave., Unit A
Salida, CO 81201

Copyright Reserved

opyright Keserved

The Contract shall verify and be responsible for all dimensions. DO

NOT scale the drawing - any errors or omissions shall be reported to

Water Vation without delay.

The Copyrights to all designs and drawings are the property of

WaterVation. Reproduction or use for any purpose other than that

authorized by WaterVation is forbidden.

Sub-Consultants

Horizontal Scale & Orientation

ı	Q	2	2	4
ı				
ı				

Legend

		_	_	
	_	=	_	=
Revision		Ву	Appd.	YY.MM.DD
		=	_	
	_	\equiv	\equiv	\equiv
Issued		Ву	Appd.	YY.MM.DD
File Name:	Dwn.	Chkd.	Dsgn.	24.09.12 YY.MM.DD

Client/Project

TOWN OF GRAND LAKE STORMWATER MANAGEMENT PLAN

GRAND LAKE, CO

Project Milestone

Sheet Name


XSEC_MDS_1 (4)

2023007041 1" = 2'

Project No.

Horizontal Scal

Sheet **14** of **68**

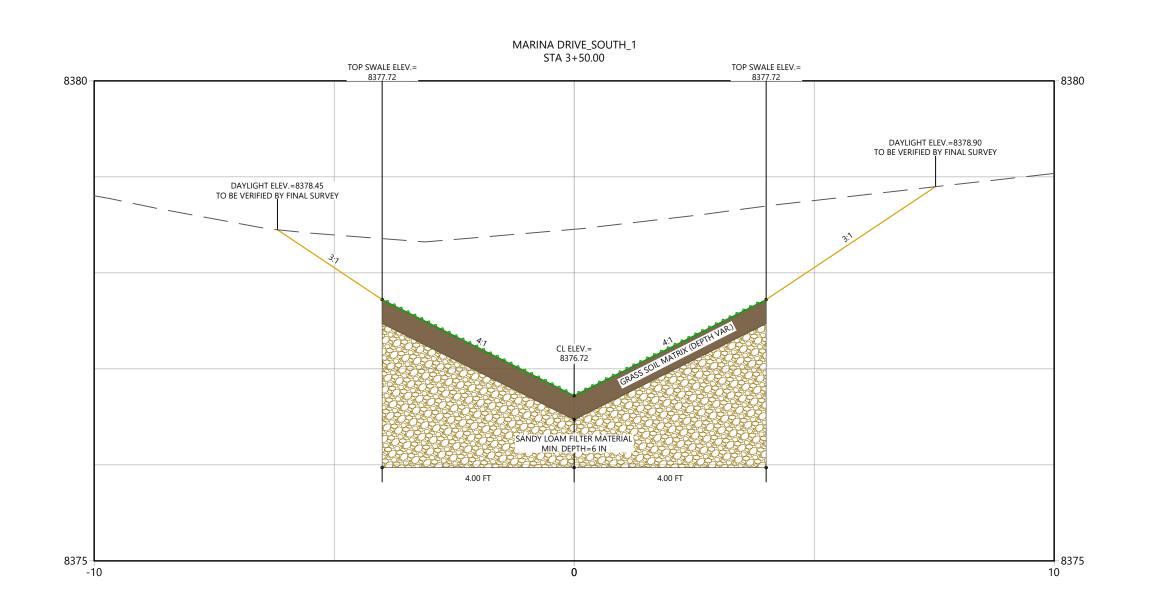



Copyright Reserved

opyright Keserved
The Contract shall verify and be responsible for all dimensions. DO
NOT scale the drawing - any errors or omissions shall be reported to
WaterVation without delay.
The Copyrights to all designs and drawings are the property of
WaterVation. Reproduction or use for any purpose other than that
authorized by WaterVation is forbidden.

Sub-Consultants

Horizontal Scale & Orientation

P	2	<u>)</u> i	

Legend

		=		
levision		By	Appd.	YY.MM.DD
ssued		Ву	Appd.	YY.MM.DD
ile Name:				24.09.12
	Dwn.	Chkd.	Dsgn.	YY.MM.DD

Client/Project

TOWN OF GRAND LAKE STORMWATER MANAGEMENT PLAN

GRAND LAKE, CO

Project Milestone


Sheet Name

XSEC_MDS_1 (5)

2023007041 1" = 2'

Sheet 15 of 68

C:\Users\lucsababbitt\watervation Dropbox\Projects\2023007041_grand Lake Stormwater 2024/09/16 9:52 AM 8v; Lucss Babbitt

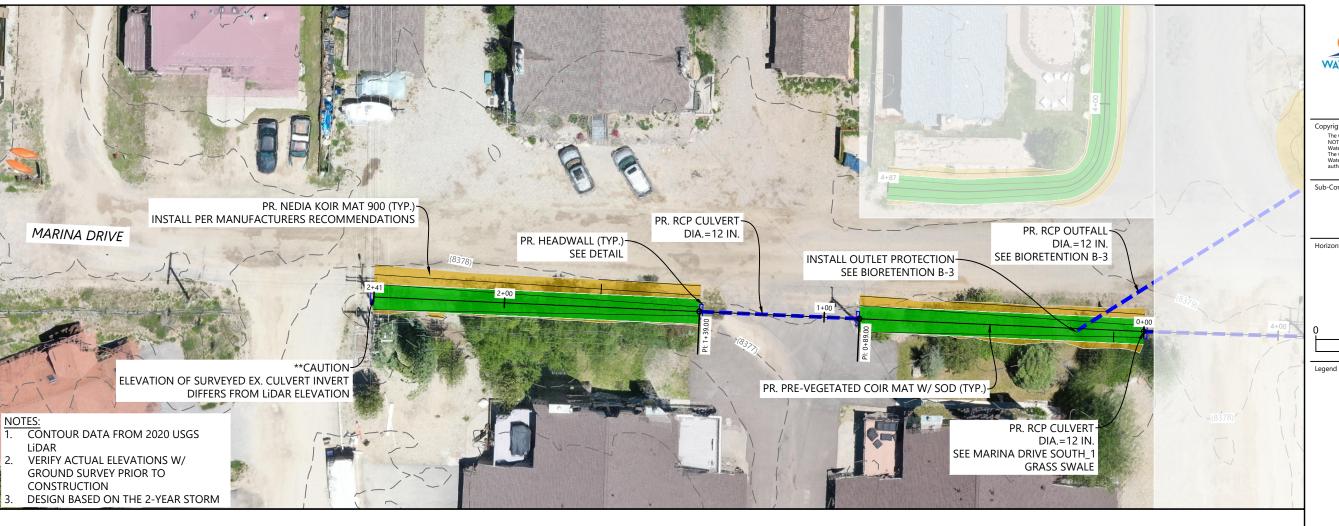



WATERVATION

Copyright Reserved

Lypright Reserved:

The Contractor shall verify and be responsible for all dimension

NOT scale the drawing - any errors or omissions shall be report


Water Vation without delay.


The Copyrights to all designs and drawings are the property of

WaterVation. Reproduction or use for any purpose other than the

authorized by Water Vation is forbridden.

Sub-Consultants

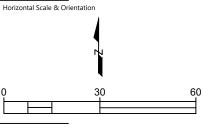

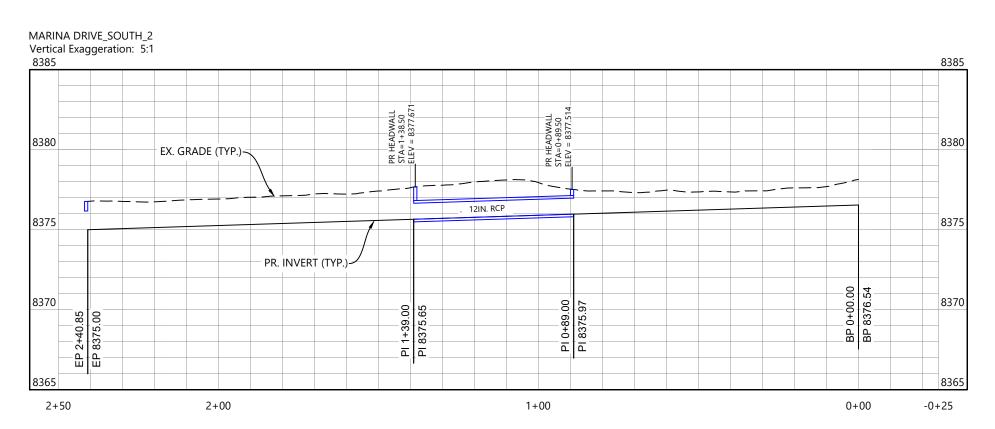

Issued File Name:
 Dwn.
 Chkd.
 Dsgn.
 YY.MM.DD



Client/Project

TOWN OF GRAND LAKE STORMWATER MANAGEMENT PLAN


GRAND LAKE, CO

Project Milestone

GRASS SWALE_MDS_2

2023007041 1" = 30'

Sheet 16 of 68

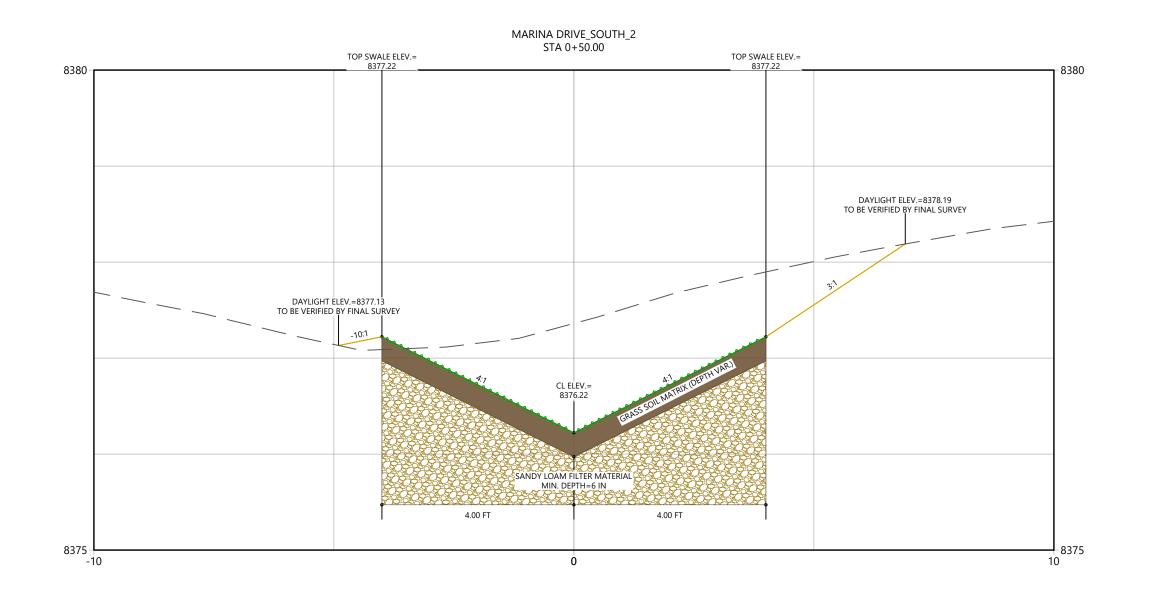



WATERVATION
130 W. Sackett Ave., Unit A
Salida, CO 81201

Copyright Reserved

pypright Keserved

The Contractor shall verify and be responsible for all dimensions. DO

NOT scale the drawing - any errors or omissions shall be reported to

Water Vation without delay.

The Copyrights to all designs and drawings are the property of

Water Vation. Reproduction or use for any purpose other than that


authorized by Water Vation is forbidden.

Sub-Consultants

Horizontal Scale & Orientation

9)		2	2	4
П					
Ι.		•			

Legeno

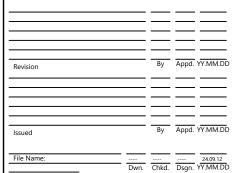

Client/Project

TOWN OF GRAND LAKE STORMWATER MANAGEMENT PLAN

GRAND LAKE, CO

Project Milestone


Sheet Name
XSEC_MDS_2

2023007041 1" = 2'

Project No.

Sheet 17 of 68

C:\Users\lucasbabbitt\watervation Dropbox\Projects\2023007041_grand Lake Stormwate 2024/09/16 952 AM By. Lucas Babbitt

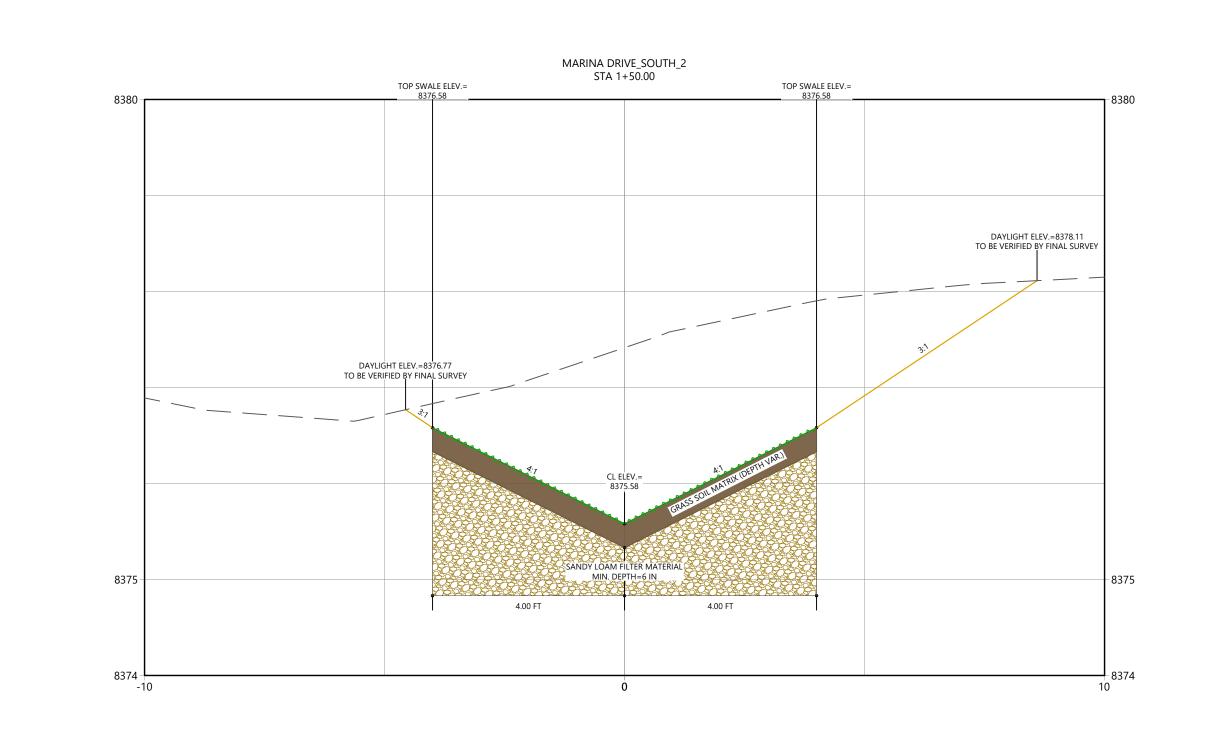



Copyright Reserved

pypright KeserVed
The Contractor shall verify and be responsible for all dimensions. DO
NOT scale the drawing - any errors or omissions shall be reported to
Water Vation without delay.
The Copyrights to all designs and drawings are the property of
Water Vation. Reproduction or use for any purpose other than that
authorized by Water Vation is forbidden.

Sub-Consultants

Horizontal Scale & Orientation

By Appd. YY.MM.DD Issued Dwn. Chkd. Dsgn. YY.MM.DD File Name:

Client/Project

TOWN OF GRAND LAKE STORMWATER MANAGEMENT PLAN


GRAND LAKE, CO

Project Milestone

2023007041 1" = 2'

Sheet **18** of **68**

XSEC_MDS_2 (2)

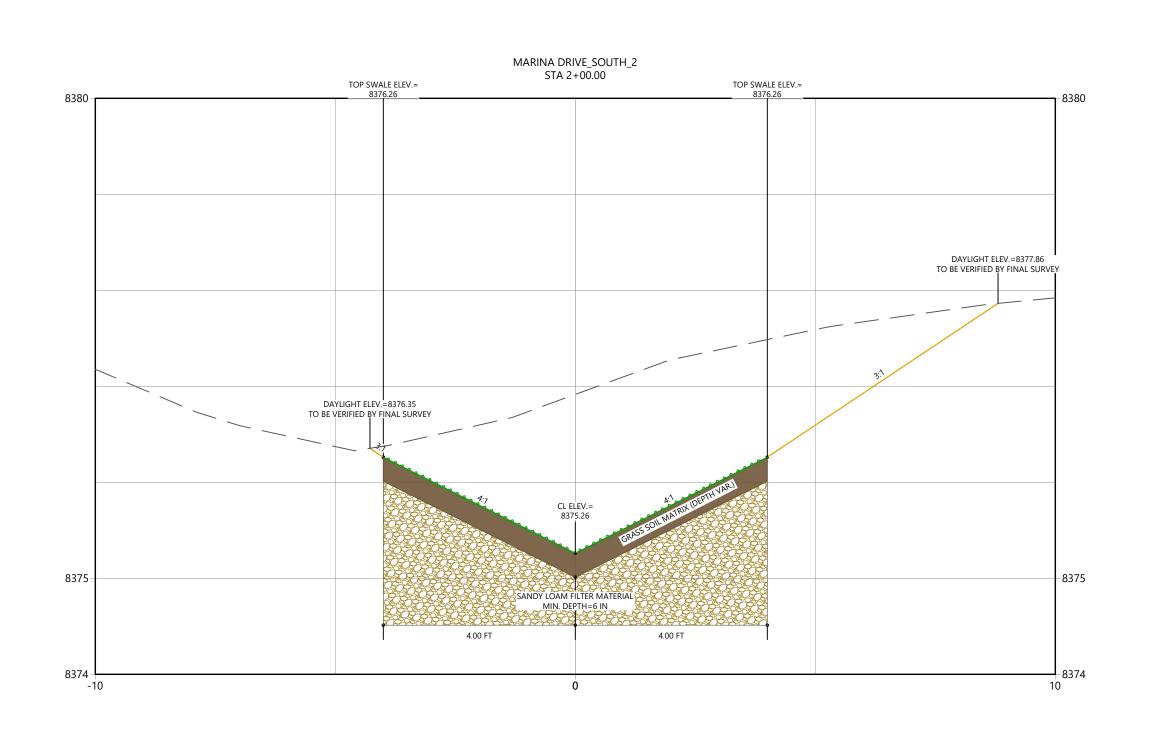



Copyright Reserved

opyright Keserved
The Contract shall verify and be responsible for all dimensions. DO
NOT scale the drawing - any errors or omissions shall be reported to
WaterVation without delay.
The Copyrights to all designs and drawings are the property of
WaterVation. Reproduction or use for any purpose other than that
authorized by WaterVation is forbidden.

Sub-Consultants

Horizontal Scale & Orientation

ļ o	2	2

Legend

Revision			Appd.	YY.MM.DD
Issued			Appd.	YY.MM.DD
File Name:	Dwn.	Chkd.	Dsgn.	24.09.12 YY.MM.DD

Permit-Seal

Client/Project

TOWN OF GRAND LAKE STORMWATER MANAGEMENT PLAN

GRAND LAKE, CO


Project Milestone

Sheet Name
XSEC_MDS_2 (3)

2023007041 1" = 2'

Project No. H

Sheet 19 of 68

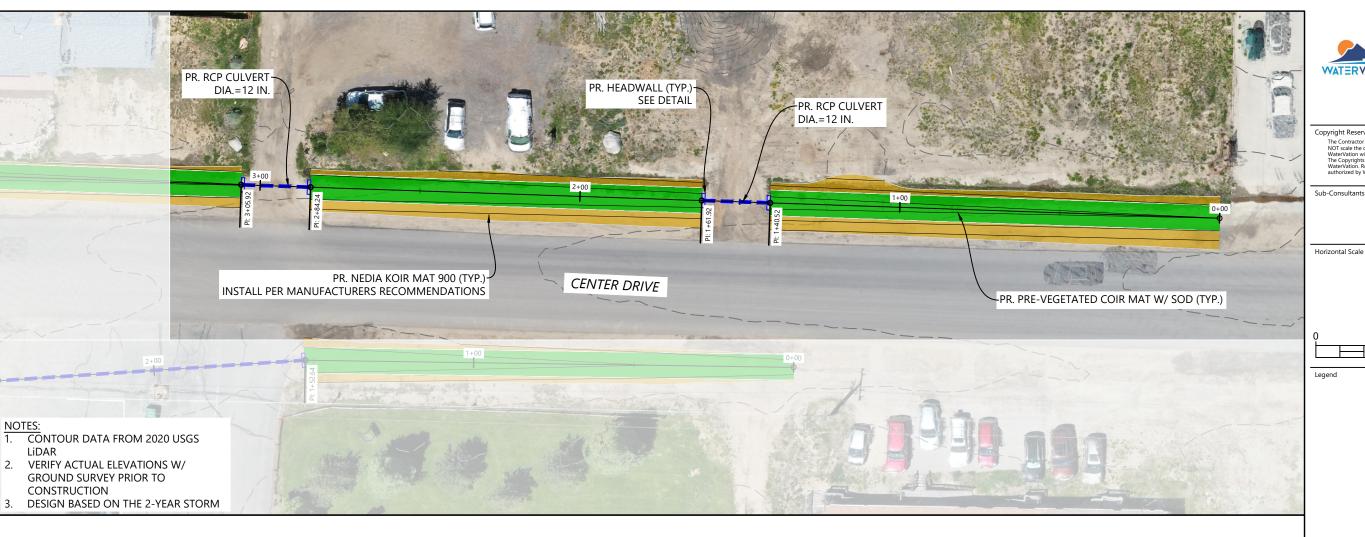



Copyright Reserved


pypyight Neser vec.

The Contractor shall verify and be responsible for all dimensions. DO NOT scale the drawing - any errors or omissions shall be reported to Water-Vation without delay.

The Copyrights to all designs and drawings are the property of Water-Vation. Reproduction or use for any purpose other than that authorized by Water-Vation is forbidden.

Horizontal Scale & Orientation

CENTER DRIVE WEST Vertical Exaggeration: 5:1

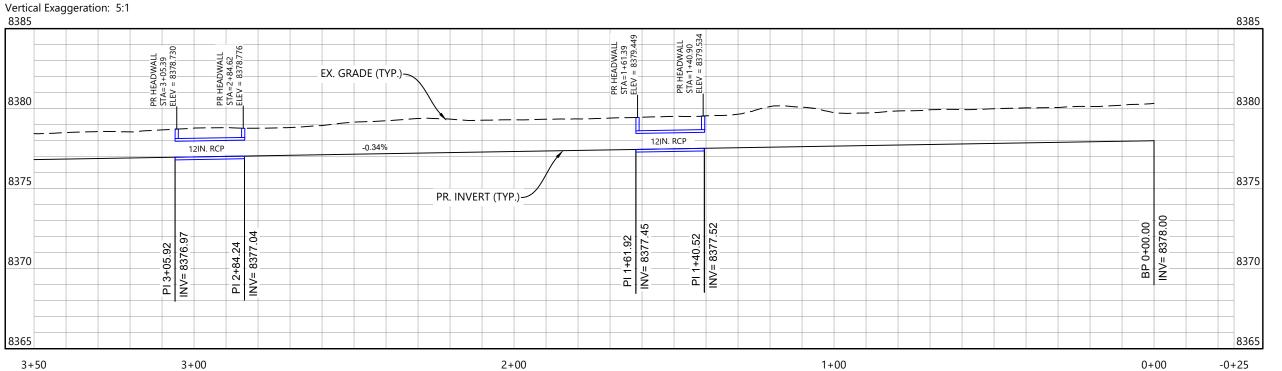

 Dwn.
 Chkd.
 Dsgn.
 YY.MM.DD



Client/Project

TOWN OF GRAND LAKE STORMWATER MANAGEMENT PLAN


GRAND LAKE, CO

Project Milestone

GRASS SWALE_CDW (1)

2023007041 1" = 30'

Sheet 20 of 68

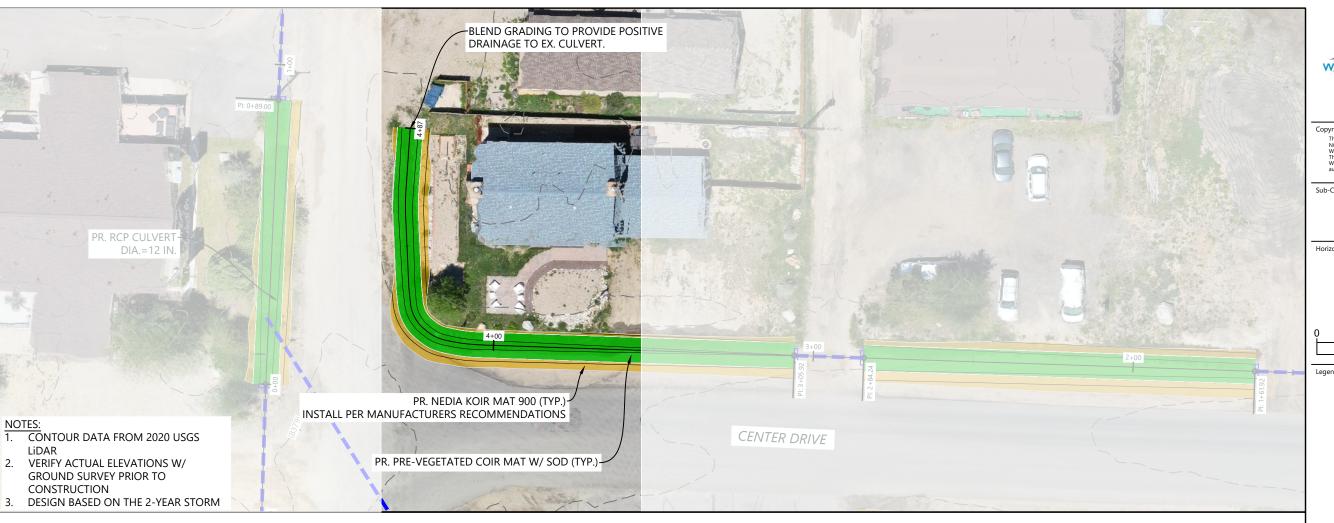



WATERVATION

Copyright Reserved

pypyight Reserver.


The Contractor shall verify and be responsible for all dimensions. DO NOT scale the drawing - any errors or omissions shall be reported to Water-Vation without delay.

The Copyrights to all designs and drawings are the property of Water-Vation. Reproduction or use for any purpose other than that authorized by Water-Vation is forbidden.

Sub-Consultants


Horizontal Scale & Orientation



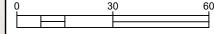

CENTER DRIVE WEST (2)

5+00

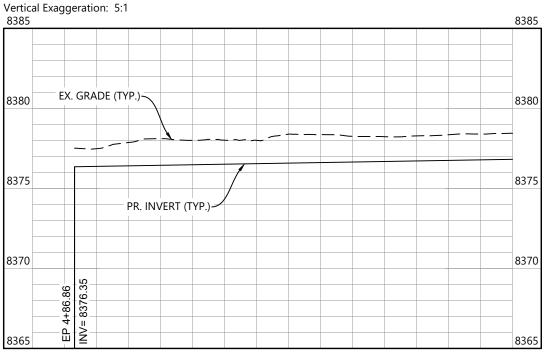

4+00

3+50

Dwn. Chkd. Dsgn. YY.MM.DD



Client/Project

TOWN OF GRAND LAKE STORMWATER MANAGEMENT PLAN


GRAND LAKE, CO

Project Milestone

GRASS SWALE_CDW (2)

2023007041 1" = 30'

Sheet 21 of 68

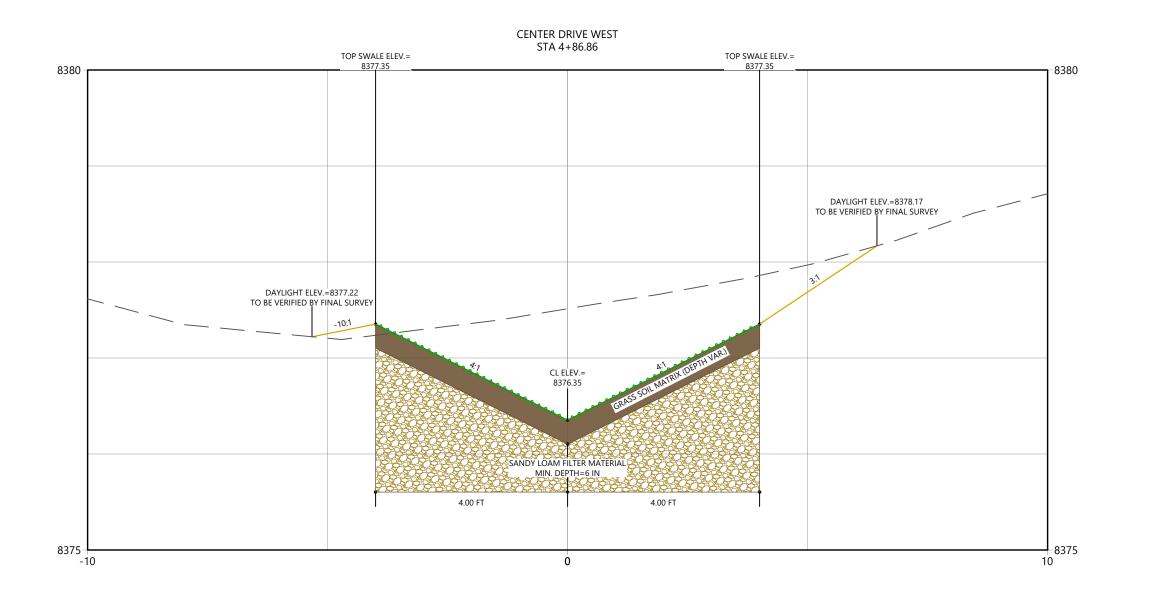



WATERVATION

Copyright Reserved

opyright Keserved
The Contract shall verify and be responsible for all dimensions. DO
NOT scale the drawing - any errors or omissions shall be reported to
WaterVation without delay.
The Copyrights to all designs and drawings are the property of
WaterVation. Reproduction or use for any purpose other than that
authorized by WaterVation is forbidden.

Sub-Consultants

Horizontal Scale & Orientation

By Appd. YY.MM.DD Issued
 Dwn.
 Chkd.
 Dsgn.
 YY.MM.DD
 File Name:

Client/Project

TOWN OF GRAND LAKE STORMWATER MANAGEMENT PLAN


GRAND LAKE, CO

Project Milestone

XSEC_CDW (23)

2023007041 Custom

Sheet 22 of 68

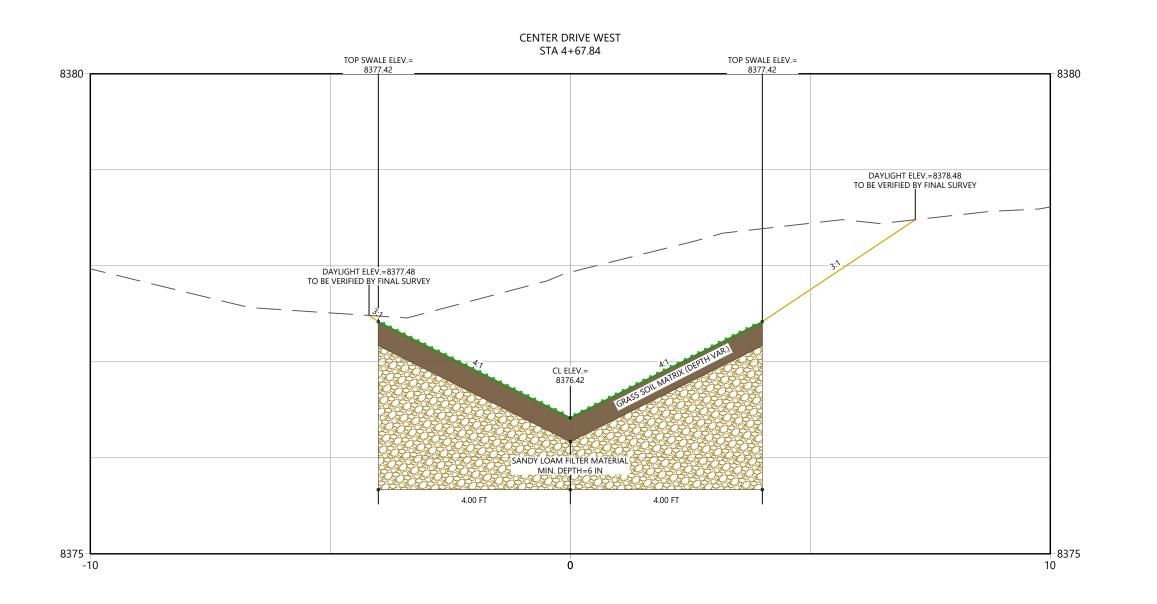



Copyright Reserved

pypright Keserved

The Contractor shall verify and be responsible for all dimensions. DO

NOT scale the drawing - any errors or omissions shall be reported to

Water Vation without delay.

The Copyrights to all designs and drawings are the property of

Water Vation. Reproduction or use for any purpose other than that

authorized by Water Vation is forbidden.

Sub-Consultants

Horizontal Scale & Orientation

0 2 4

Legend

Revision By Appd. YY.MM.DD

Issued By Appd. YY.MM.DD

| Sylic | Sylic

Client/Project

TOWN OF GRAND LAKE
STORMWATER MANAGEMENT PLAN

GRAND LAKE, CO

Project Milestone


Sheet Name

XSEC_CDW (22)

2023007041 Custom
Project No. Horizontal Sc

Sheet 23 of 68

C:\Useas\lucasbabbitt\watervation Dropbox\Projects\2023007041_grand Lake Stormwater Manag 2024/09/16 953 AM By: Lucas Babbitt

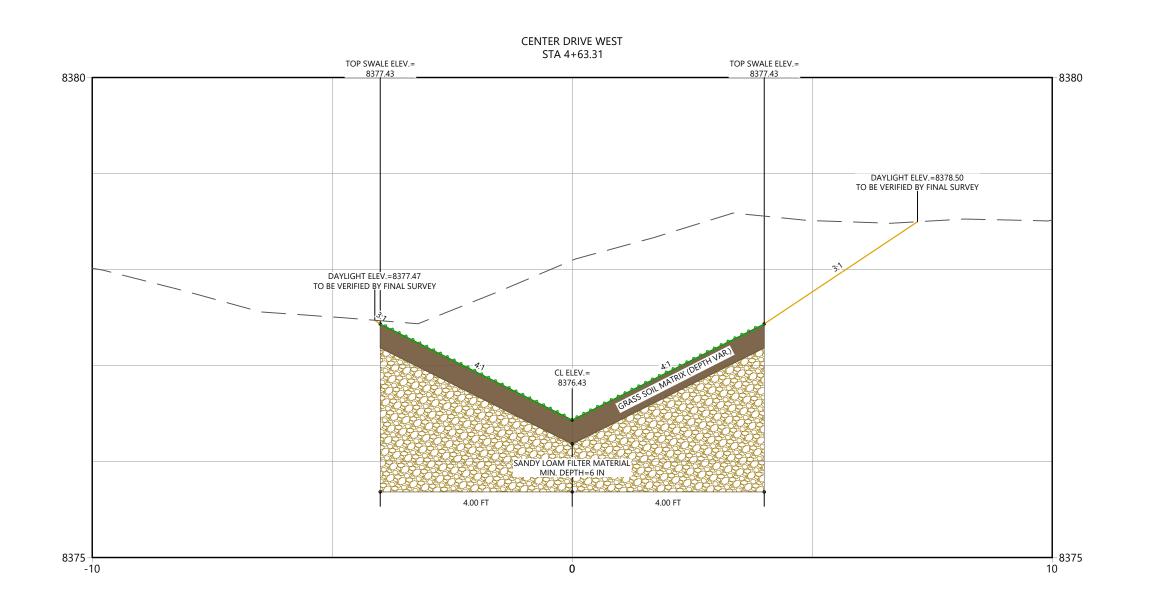



Copyright Reserved

pypright Keserved

The Contractor shall verify and be responsible for all dimensions. DO

NOT scale the drawing - any errors or omissions shall be reported to

Water Vation without delay.

The Copyrights to all designs and drawings are the property of

Water Vation. Reproduction or use for any purpose other than that

authorized by Water Vation is forbidden.

Sub-Consultants

Horizontal Scale & Orientation

ı	()	2	2	4
1					_
1					\Box
-					

Legend

		<u>=</u>	<u>=</u>	
Revision		Ву	Appd.	YY.MM.DD
		\equiv	\equiv	\equiv
Issued		Ву	Appd.	YY.MM.DD
File Name:	Dwn.	Chkd.	Dsgn.	24.09.12 YY.MM.DD

Client/Project
TOWN OF GRAND LAKE

STORMWATER MANAGEMENT PLAN

GRAND LAKE, CO

Project Milestone

Permit-Seal


heet Name

XSEC_CDW (21)

2023007041 Custom

Sheet 24 of 68

C:\Users\tucssbabbitt\watervation Dropbox\Projects\2023007041_grand Lake Stormwa 2024/09/16 953 AM 8rr. Lucas Babbitt

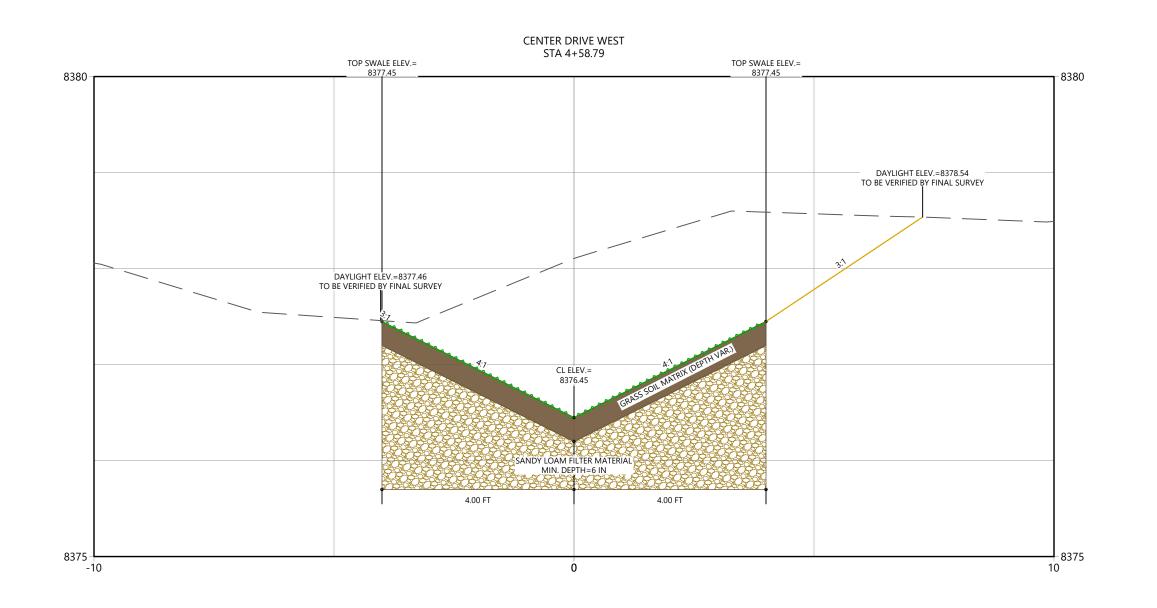



Copyright Reserved

pypright Keserved

The Contractor shall verify and be responsible for all dimensions. DO

NOT scale the drawing - any errors or omissions shall be reported to

Water Vation without delay.

The Copyrights to all designs and drawings are the property of

Water Vation. Reproduction or use for any purpose other than that

authorized by Water Vation is forbidden.

Sub-Consultants

Horizontal Scale & Orientation

ΙÝ	4	4
\Box	 1	

Legeno

		\equiv		<u>=</u>
Revision		Ву	Appd.	YY.MM.DD
		<u>=</u>		
Issued		Ву	Appd.	YY.MM.DD
File Name:	Dwn.	Chkd.	Dsgn.	24.09.12 YY.MM.DD

Permit-Seal

Client/Project

Client/Project
TOWN OF GRAND LAKE
STORMWATER MANAGEMENT PLAN

GRAND LAKE, CO

Project Milestone


Sheet Name

XSEC_CDW (20) 2023007041 Custom

Project No. Horizontal Scale

Sheet 25 of 68

C:\Users\luxasbabbitt\watervation Dropbox\Projects\2023007041_grand Lake Stormwater M 2024/09/16 9:53 AM By: Luxas Babbitt

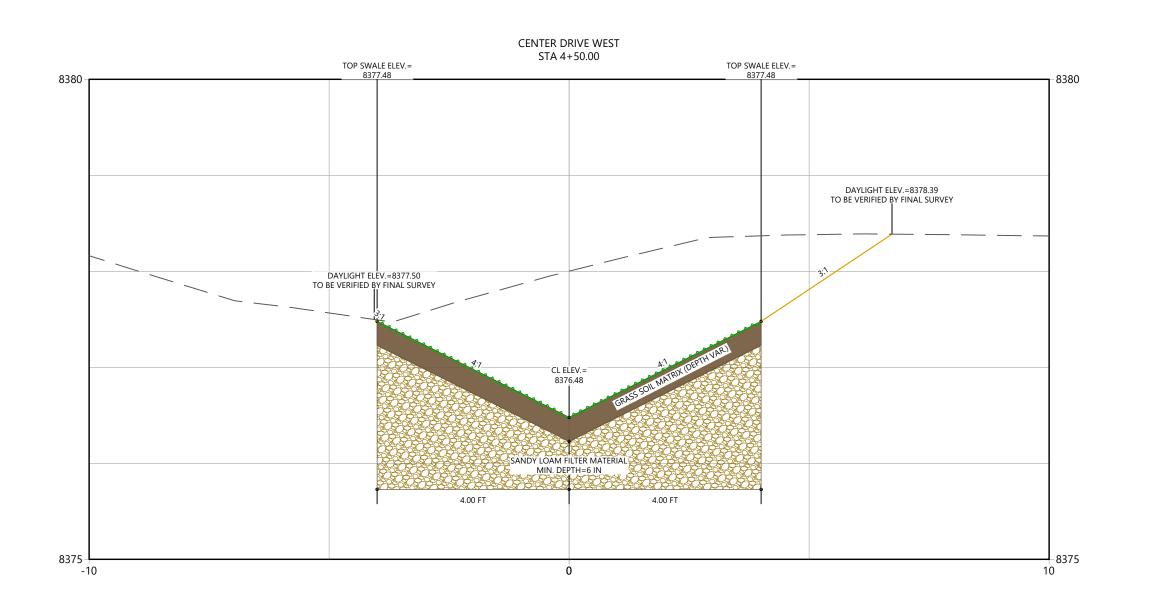



Copyright Reserved

opyright Keserved
The Contract shall verify and be responsible for all dimensions. DO
NOT scale the drawing - any errors or omissions shall be reported to
WaterVation without delay.
The Copyrights to all designs and drawings are the property of
WaterVation. Reproduction or use for any purpose other than that
authorized by WaterVation is forbidden.

Sub-Consultants

Horizontal Scale & Orientation

Legend

Client/Project

TOWN OF GRAND LAKE STORMWATER MANAGEMENT PLAN

GRAND LAKE, CO

Project Milestone


Sheet Name
XSEC_CDW (19)

2023007041 Custom

piect No. Horizontal Scale

Sheet 26 of 68

C:\Users\lucasbabbirt\watervation Dropbox\Projects\2023007641_grand Lake Stormwate 2024/09/16 9:54 AM By: Lucas Babbitt

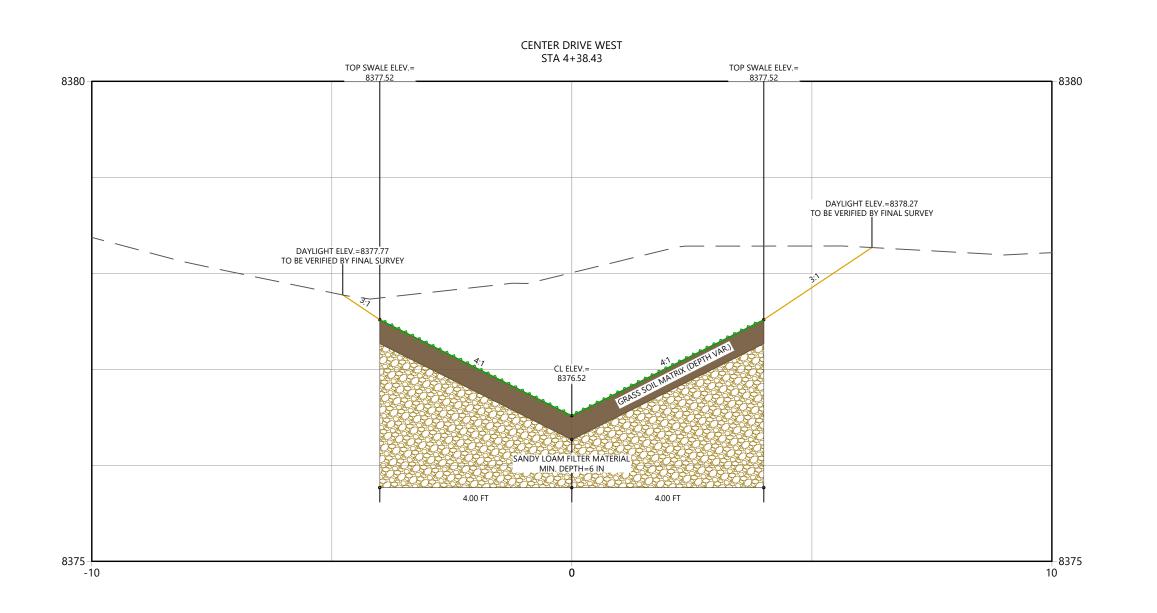



WATERVATION
130 W. Sackett Ave., Unit A
Salida, CO 81201

Copyright Reserved

opyright Keserved
The Contract shall verify and be responsible for all dimensions. DO
NOT scale the drawing - any errors or omissions shall be reported to
WaterVation without delay.
The Copyrights to all designs and drawings are the property of
WaterVation. Reproduction or use for any purpose other than that
authorized by WaterVation is forbidden.

Sub-Consultants

Horizontal Scale & Orientation

ı	0		2	2	4
-	Г				
ı	ᆫ			l	

Legeno

		 	Annd	YY.MM.DD
Revision			Арри.	TT.IWIIVI.DD
	<u> </u>	\equiv		_
Issued		Ву	Appd.	YY.MM.DD
File Name:	Dwn.	Chkd.	Dsgn.	24.09.12 YY.MM.DD

Client/Project
TOWN OF GRAND LAKE
STORMWATER MANAGEMENT PLAN

GRAND LAKE, CO

Project Milestone


neet Name

XSEC_CDW (18)

2023007041 Custom

Sheet 27 of 68

C:\Users\lucasbabbittwatervation Dropbox\Projects\2023007041_grand Lake Stor 2024/09/16 9:54 AM By: Lucas Babbitt

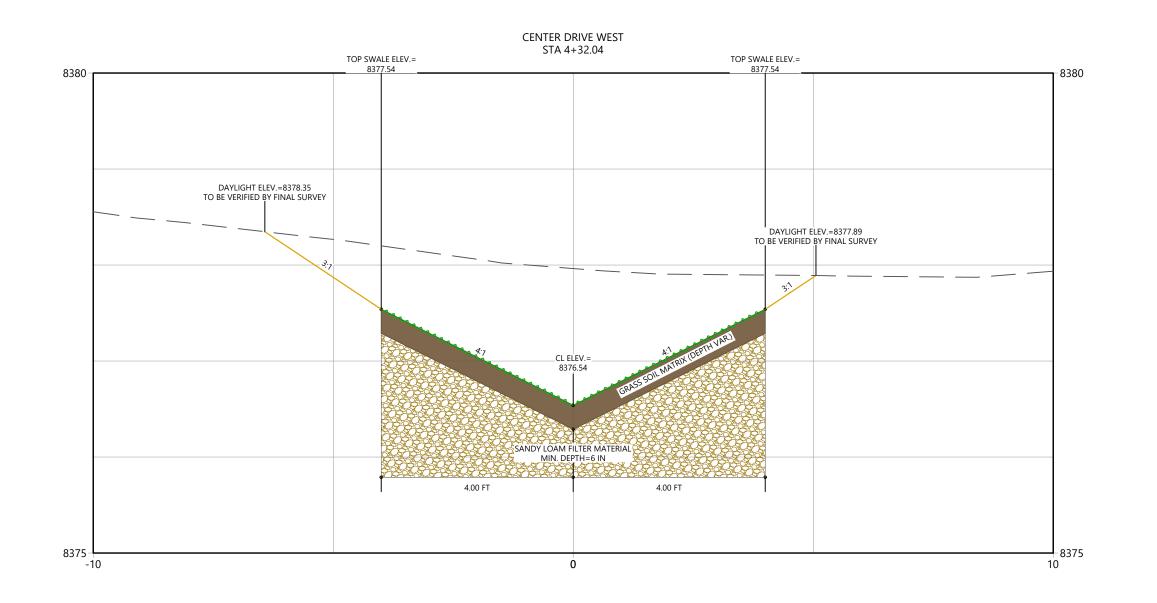



Copyright Reserved

opyright Keserved
The Contract shall verify and be responsible for all dimensions. DO
NOT scale the drawing - any errors or omissions shall be reported to
WaterVation without delay.
The Copyrights to all designs and drawings are the property of
WaterVation. Reproduction or use for any purpose other than that
authorized by WaterVation is forbidden.

Sub-Consultants

Horizontal Scale & Orientation

1

Legeno

		=		
		=	=	
Revision		Ву	Appd.	YY.MM.DD
		=		
		=	=	
Issued		Ву	Appd.	YY.MM.DD
File Name:	Dwn.	Chkd.	Dsgn.	24.09.12 YY.MM.DD

Client/Project

TOWN OF GRAND LAKE STORMWATER MANAGEMENT PLAN

GRAND LAKE, CO

Project Milestone


Sheet Name

XSEC_CDW (17)

2023007041 Custom
Project No. Horizontal Sc

Sheet 28 of 68

CAUSers/Jucasbabbitt/watervation Dropbox/Projects/2023007041_grand Lake Storr 2024/09/16 9:54 AM By: Lucas Babbitt

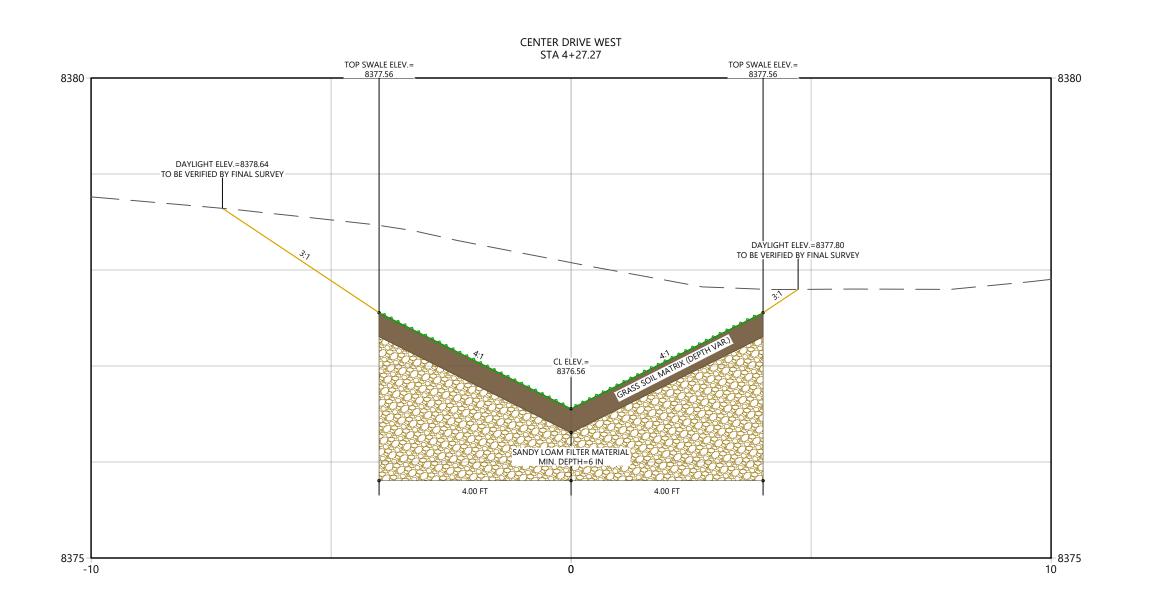



WATERVATION
130 W. Sackett Ave., Unit A
Salida, CO 81201

Copyright Reserved

opyright Keserved
The Contract shall verify and be responsible for all dimensions. DO
NOT scale the drawing - any errors or omissions shall be reported to
WaterVation without delay.
The Copyrights to all designs and drawings are the property of
WaterVation. Reproduction or use for any purpose other than that
authorized by WaterVation is forbidden.

Sub-Consultants

Horizontal Scale & Orientation

ļ)			2

Legend

evision		By	Appd.	YY.MM.DD
sued		Ву	Appd.	YY.MM.DD
le Name:				24.09.12
	Dwn.	Chkd.	Dsgn.	YY.MM.DD

Client/Project

TOWN OF GRAND LAKE STORMWATER MANAGEMENT PLAN

GRAND LAKE, CO

Project Milestone


Sheet Name

XSEC_CDW (16)

2023007041 Custom

Sheet 29 of 68

C:\Users\ucsababbitt\watervation Dropbox\Projects\2023007041_grand Lake Stormwat 2024/09/16 954 AM Br; Luzas Babbitt

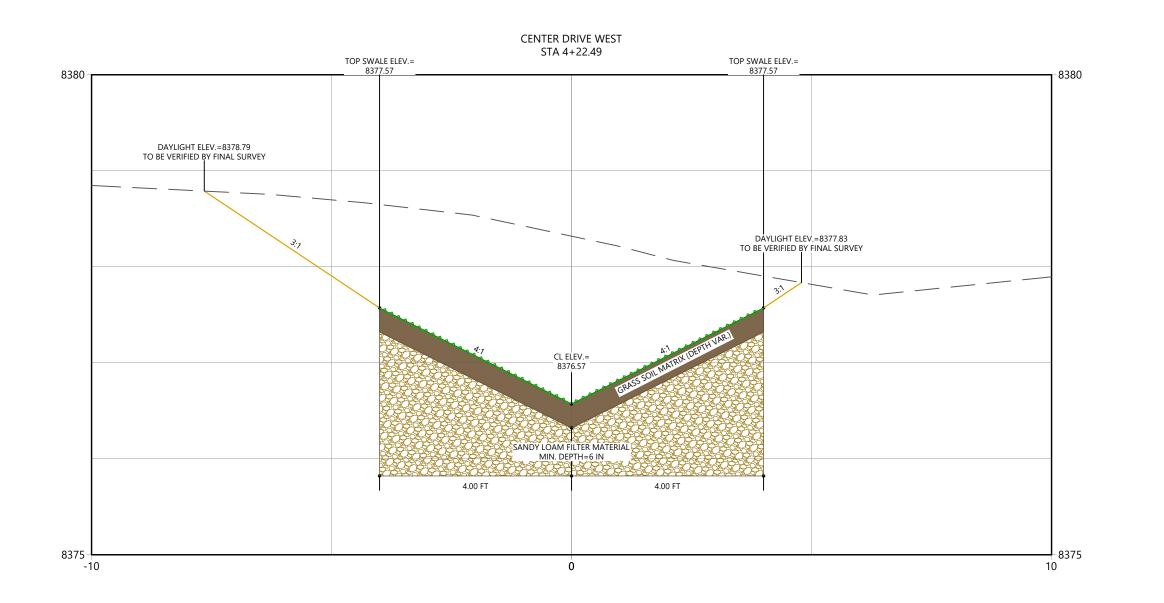



Copyright Reserved

opyright Keserved

The Contract shall verify and be responsible for all dimensions. DO

NOT scale the drawing - any errors or omissions shall be reported to

Water Vation without delay.

The Copyrights to all designs and drawings are the property of

WaterVation. Reproduction or use for any purpose other than that

authorized by WaterVation is forbidden.

Sub-Consultants

Horizontal Scale & Orientation

)		2 4	4
П				ı
		1]

Legend

		_	=	_
		=	_	
Revision		By	Appd.	YY.MM.DD
Revision				
		_	_	
		_	_	
Issued		Ву	Appd.	YY.MM.DD
F'I. N				
File Name:	Dwn.	Chkd.	Dsgn.	24.09.12 YY.MM.DD

Client/Project

Permit-Seal

TOWN OF GRAND LAKE STORMWATER MANAGEMENT PLAN

GRAND LAKE, CO

Project Milestone


Sheet Name

XSEC_CDW (15)

2023007041 Custom
Project No. Horizontal Sc

Sheet 30 of 68

C:\Useas\lucasbabbitt\watervation Dropbox\Projects\2023007041_grand Lake Stormwater Manage 2024/09/16 954 AM By: Lucas Babbitt

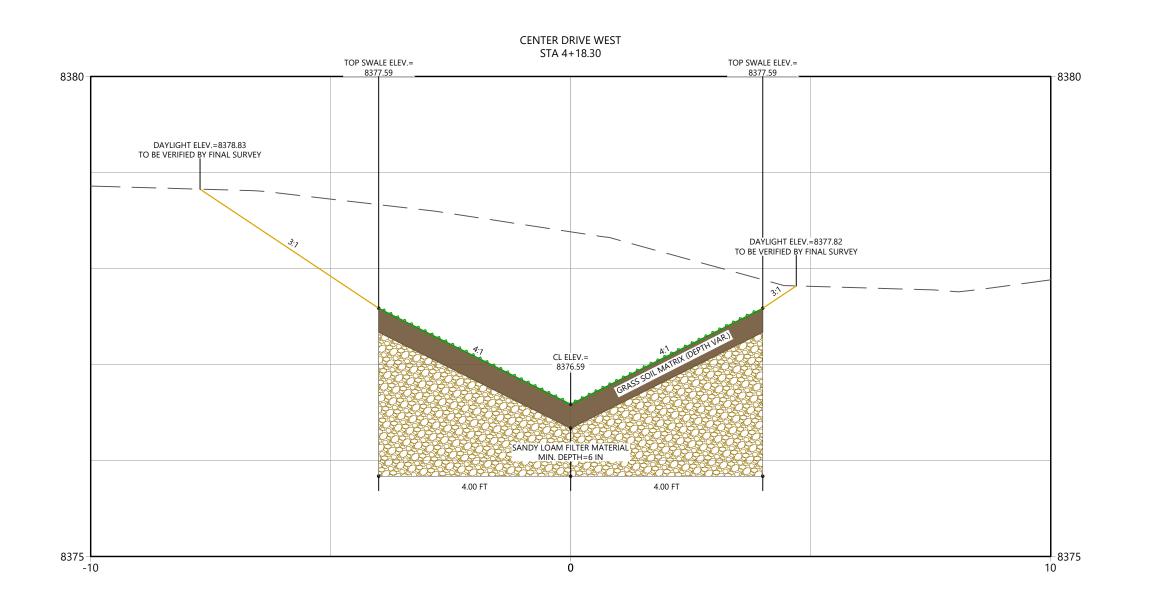



Copyright Reserved

opyright Keserved

The Contract shall verify and be responsible for all dimensions. DO

NOT scale the drawing - any errors or omissions shall be reported to

Water Vation without delay.

The Copyrights to all designs and drawings are the property of

WaterVation. Reproduction or use for any purpose other than that


authorized by WaterVation is forbidden.

Sub-Consultants

Horizontal Scale & Orientation

ΙŅ	2	2 4
ΙÞ		
l ⊢		
I —		

Legeno

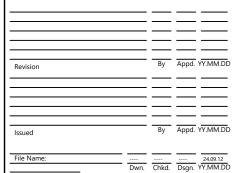

Client/Project

TOWN OF GRAND LAKE STORMWATER MANAGEMENT PLAN

GRAND LAKE, CO

Project Milestone


Sheet Name

XSEC_CDW (14)

2023007041 Custom
Project No. Horizontal Sc

Sheet 31 of 68

C:\Users\lucasbabbitt\watervation Dropbox\Projects\2023007641_grand Lake Stormwater Me 2024/09/16 9:54 AM By: Lucas Babbitt

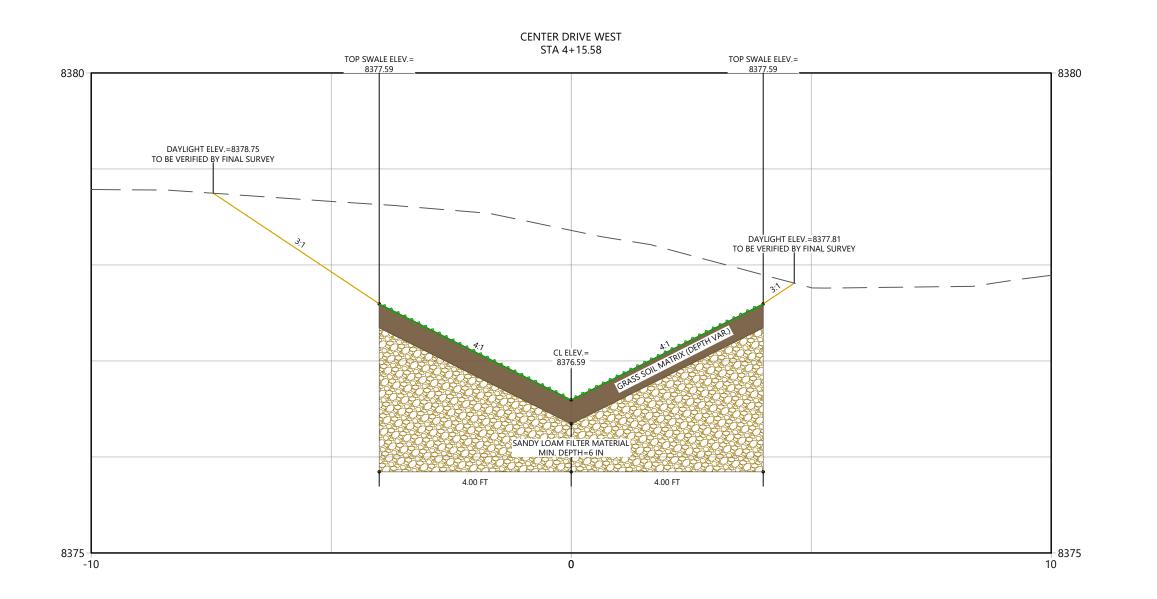



Copyright Reserved

opyright Keserved

The Contract shall verify and be responsible for all dimensions. DO

NOT scale the drawing - any errors or omissions shall be reported to

Water Vation without delay.

The Copyrights to all designs and drawings are the property of

WaterVation. Reproduction or use for any purpose other than that

authorized by WaterVation is forbidden.

Sub-Consultants

Horizontal Scale & Orientation

١	()	2	2	4
- 1					
- 1					1
- 1]
- 1					J

Legeno

	_	\equiv		
Revision	_	Ву	Appd.	YY.MM.DD
	<u> </u>	\equiv	=	<u> </u>
Issued	=	Ву	Appd.	YY.MM.DD
File Name:	Dwn.	Chkd.	Dsgn.	24.09.12 YY.MM.DD

Client/Project

Permit-Seal

TOWN OF GRAND LAKE STORMWATER MANAGEMENT PLAN

GRAND LAKE, CO

Project Milestone


Sheet Name
XSEC_CDW (13)

2023007041 Custom

Project No. Horizontal Scale

Sheet 32 of 68

C?\Users\lucsasbabitt\watervation Dropbox\Projects\2023007041_grand Lake Stormwater Management | 2024/09/16 9:54 AM By: Lucas Babbitt

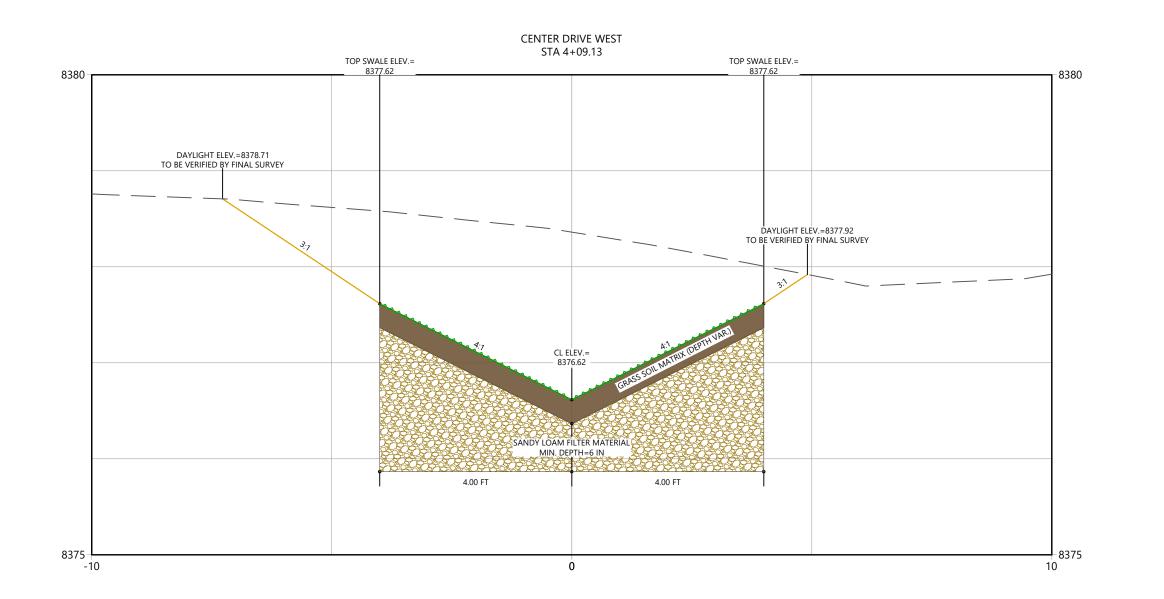



Copyright Reserved

opyright Keserved

The Contract shall verify and be responsible for all dimensions. DO

NOT scale the drawing - any errors or omissions shall be reported to

Water Vation without delay.

The Copyrights to all designs and drawings are the property of

WaterVation. Reproduction or use for any purpose other than that

authorized by WaterVation is forbidden.

Sub-Consultants

Horizontal Scale & Orientation

ı	P		2			4
-]
ı	ᆫ					L

Legend

Revision		Ву	Appd.	YY.MM.DD
		_		
		=	=	
Issued		Ву	Appd.	YY.MM.DD
File Name:				24.09.12
	Dwn.	Chkd.	Dsgn.	YY.MM.DD

Client/Project
TOWN OF GRAND LAKE

STORMWATER MANAGEMENT PLAN


GRAND LAKE, CO

Project Milestone

Sheet Name
XSEC_CDW (12)

2023007041 Custom

Sheet 33 of 68

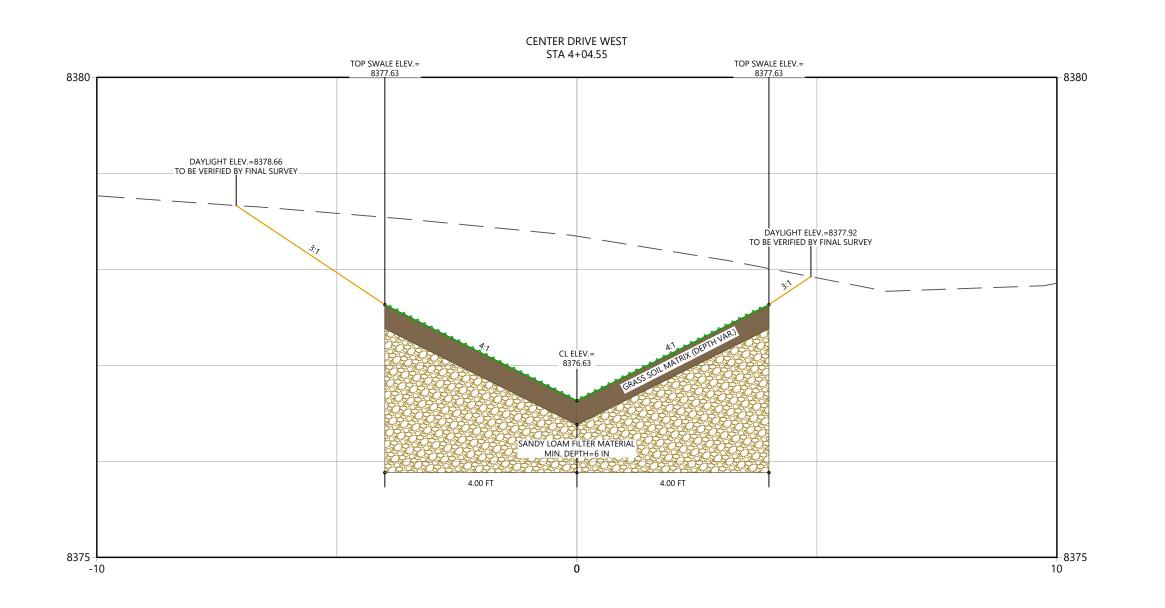



WATERVATION
130 W. Sackett Ave., Unit A
Salida, CO 81201

Copyright Reserved

pypright Keserved

The Contractor shall verify and be responsible for all dimensions. DO

NOT scale the drawing - any errors or omissions shall be reported to

Water Vation without delay.

The Copyrights to all designs and drawings are the property of

Water Vation. Reproduction or use for any purpose other than that

authorized by Water Vation is forbidden.

Sub-Consultants

Horizontal Scale & Orientation

0	2	2 4
I⊢		
l ∟		
l		

Legeno

		\equiv	=	<u> </u>
Revision		Ву	Appd.	YY.MM.DD
		<u>=</u>		<u> </u>
Issued		Ву	Appd.	YY.MM.DD
File Name:	Dwn.	Chkd.	Dsgn.	24.09.12 YY.MM.DD

Client/Project
TOWN OF GRAND LAKE
STORMWATER MANAGEMENT PLAN

GRAND LAKE, CO

Project Milestone


Sheet Name
XSEC_CDW (11)

2023007041 Custom

oject No. Horizontal Scale

Sheet **34** of **68**

C:\Users\ucsababbitt\watervation Dropbox\Projects\2023007041_grand Lake Stormwater N 2024/09/16 954 AM 8v; tucss Babbitt

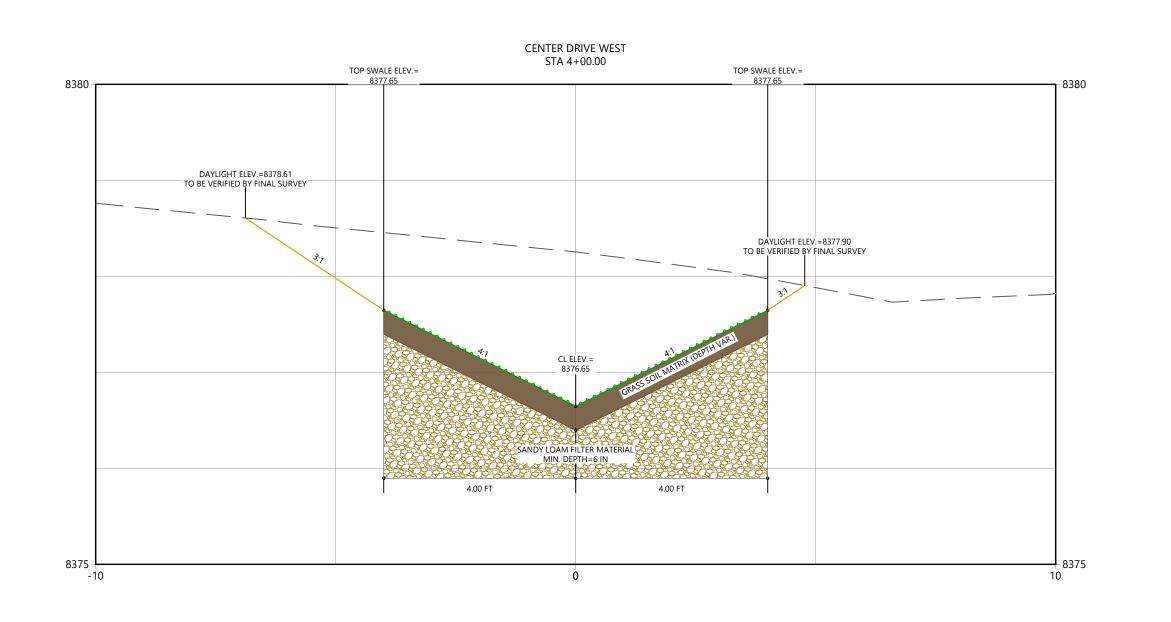



Copyright Reserved


pypright KeserVed
The Contractor shall verify and be responsible for all dimensions. DO
NOT scale the drawing - any errors or omissions shall be reported to
Water Vation without delay.
The Copyrights to all designs and drawings are the property of
Water Vation. Reproduction or use for any purpose other than that
authorized by Water Vation is forbidden.

Sub-Consultants

Horizontal Scale & Orientation

ļ o	2	2	4

Legend

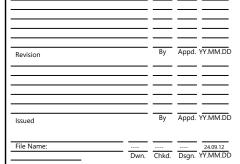

Client/Project

TOWN OF GRAND LAKE STORMWATER MANAGEMENT PLAN

GRAND LAKE, CO

Project Milestone


Sheet Name
XSEC_CDW (10)

2023007041 Custom

Project No. Horizont

Sheet 35 of 68

C:\Users\lucasbabbitt\watervation Dropbox\Projects\2023007041_grand Lake Stormw 2024/09/16 9:54 AM By: Lucas Babbitt

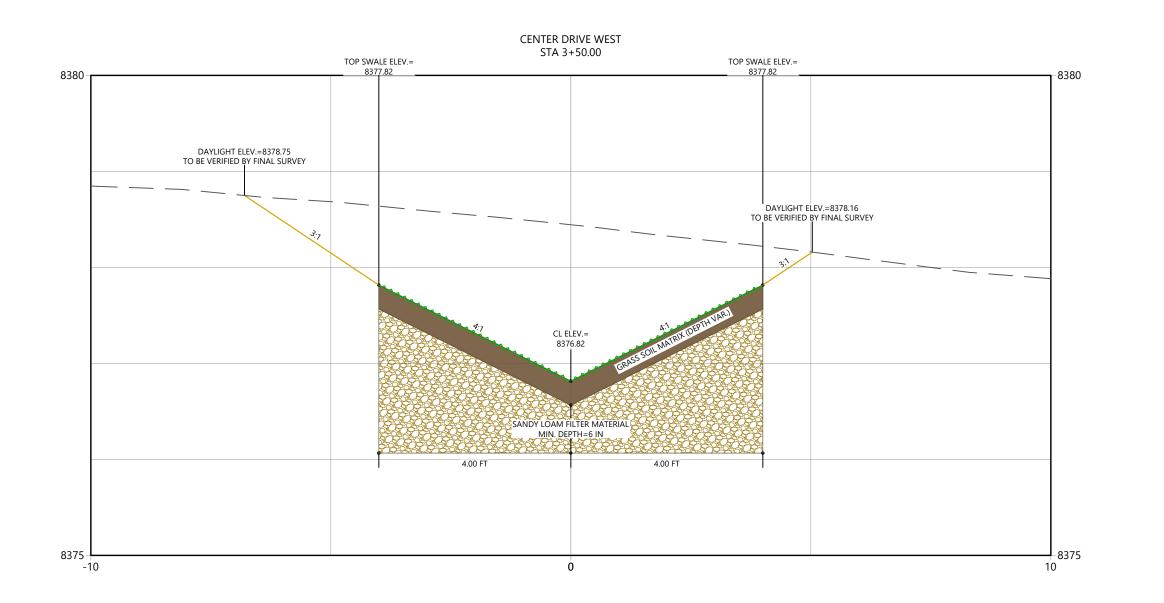



Copyright Reserved

opyright Keserved
The Contract shall verify and be responsible for all dimensions. DO
NOT scale the drawing - any errors or omissions shall be reported to
WaterVation without delay.
The Copyrights to all designs and drawings are the property of
WaterVation. Reproduction or use for any purpose other than that
authorized by WaterVation is forbidden.

Sub-Consultants

Horizontal Scale & Orientation

Ιò		2 4
Ιħ		
-	 1	

Legend

		\equiv		
Revision		Ву	Appd.	YY.MM.DD
		=		
		_		=
Issued		Ву	Appd.	YY.MM.DD
File Name:	Dwn.	Chkd.	Dsgn.	24.09.12 YY.MM.DD

Client/Project

TOWN OF GRAND LAKE STORMWATER MANAGEMENT PLAN

GRAND LAKE, CO

Project Milestone

| ----


Sheet Name

XSEC_CDW (9)

2023007041 Custom

Sheet 36 of 68

C:\Users\lucasbabbitt\watervation Dropbox\Projects\2023007041_grand Lake Stormwi 2024/09/16 9:54 AM Br; Lucas Babbitt

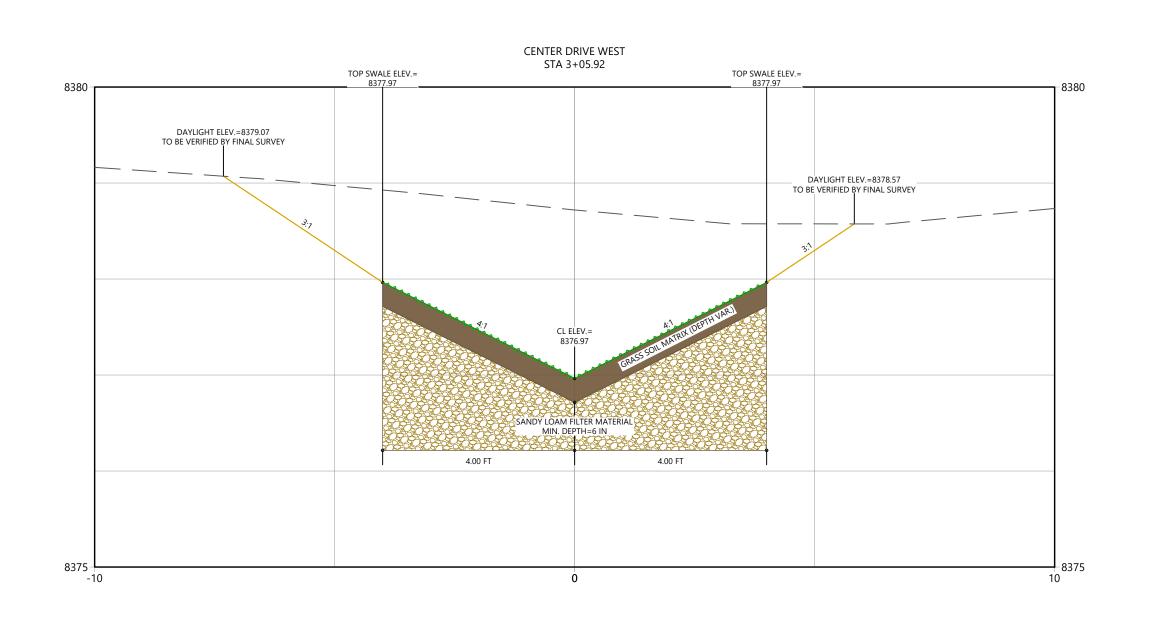



WATERVATION
130 W. Sackett Ave., Unit A
Salida, CO 81201
www.water-vation.com

Copyright Reserved

pypright Keserved

The Contractor shall verify and be responsible for all dimensions. DO

NOT scale the drawing - any errors or omissions shall be reported to

Water Vation without delay.

The Copyrights to all designs and drawings are the property of

Water Vation. Reproduction or use for any purpose other than that

authorized by Water Vation is forbidden.

Sub-Consultants

Horizontal Scale & Orientation

ı	Q	2	2	4
ı				
ı				

Legend

Revision By Appd. YY.MM.DD

Issued By Appd. YY.MM.DD

| Sylic | Sylic

Permit-Sea

Client/Project

TOWN OF GRAND LAKE STORMWATER MANAGEMENT PLAN

GRAND LAKE, CO

Project Milestone

Sheet Name


XSEC_CDW (8)

2023007041 Custom

Sheet 37 of 68

C:\Users\lucasbabbitt\watervation Dropbox\Projects\2023007041_grand Lake Stormwater Manageme 2024/09/16 9:54 AM 8y; Lucas Babbitt

ORIGINAL SHEET - ANSI B

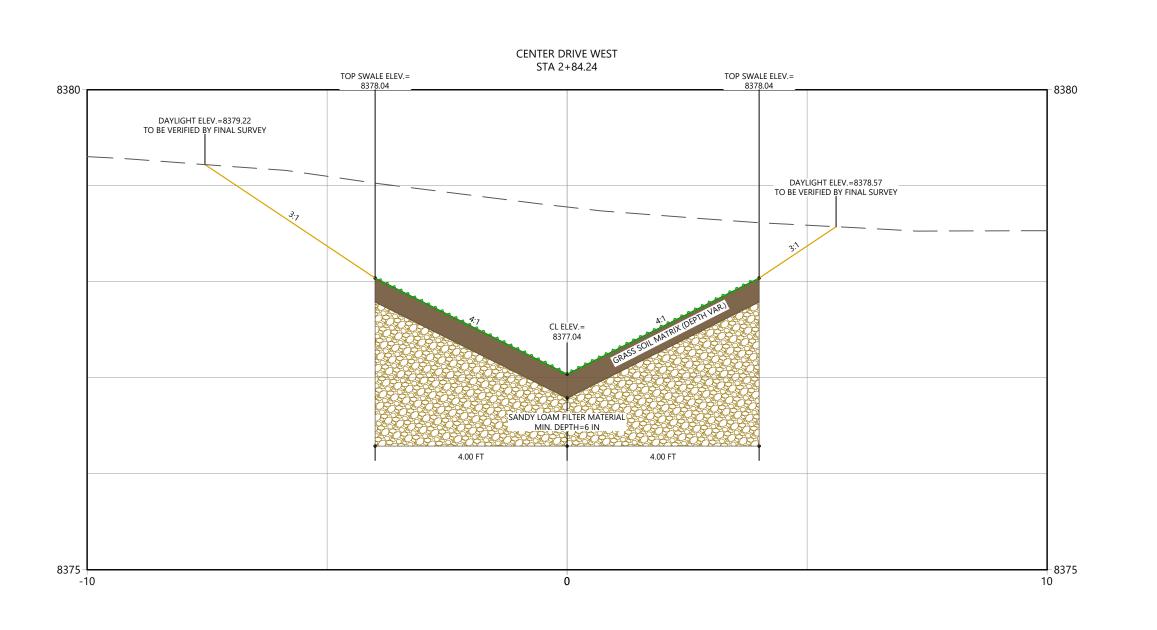



WATERVATION
130 W. Sackett Ave., Unit A
Salida, CO 81201
www.water-vation.com

Copyright Reserved

pypright Keserved

The Contractor shall verify and be responsible for all dimensions. DO

NOT scale the drawing - any errors or omissions shall be reported to

Water Vation without delay.

The Copyrights to all designs and drawings are the property of

Water Vation. Reproduction or use for any purpose other than that

authorized by Water Vation is forbidden.

Sub-Consultants

Horizontal Scale & Orientation

ļ Ņ		2	2	4
	\vdash			

Legeno

Client/Project

TOWN OF GRAND LAKE STORMWATER MANAGEMENT PLAN

GRAND LAKE, CO

Project Milestone

Sheet Name
XSEC_CDW (7)


7,5EC_CD W (1)

2023007041 Custom

Sheet 38 of 68

C:\Users\lucasbabbitt\watervation Dropbox\Projects\2023007041_grand Lake Stormwater Mana 2024/09/16 9:55 AM By: Lucas Babbitt

ORIGINAL SHEET - ANSI B

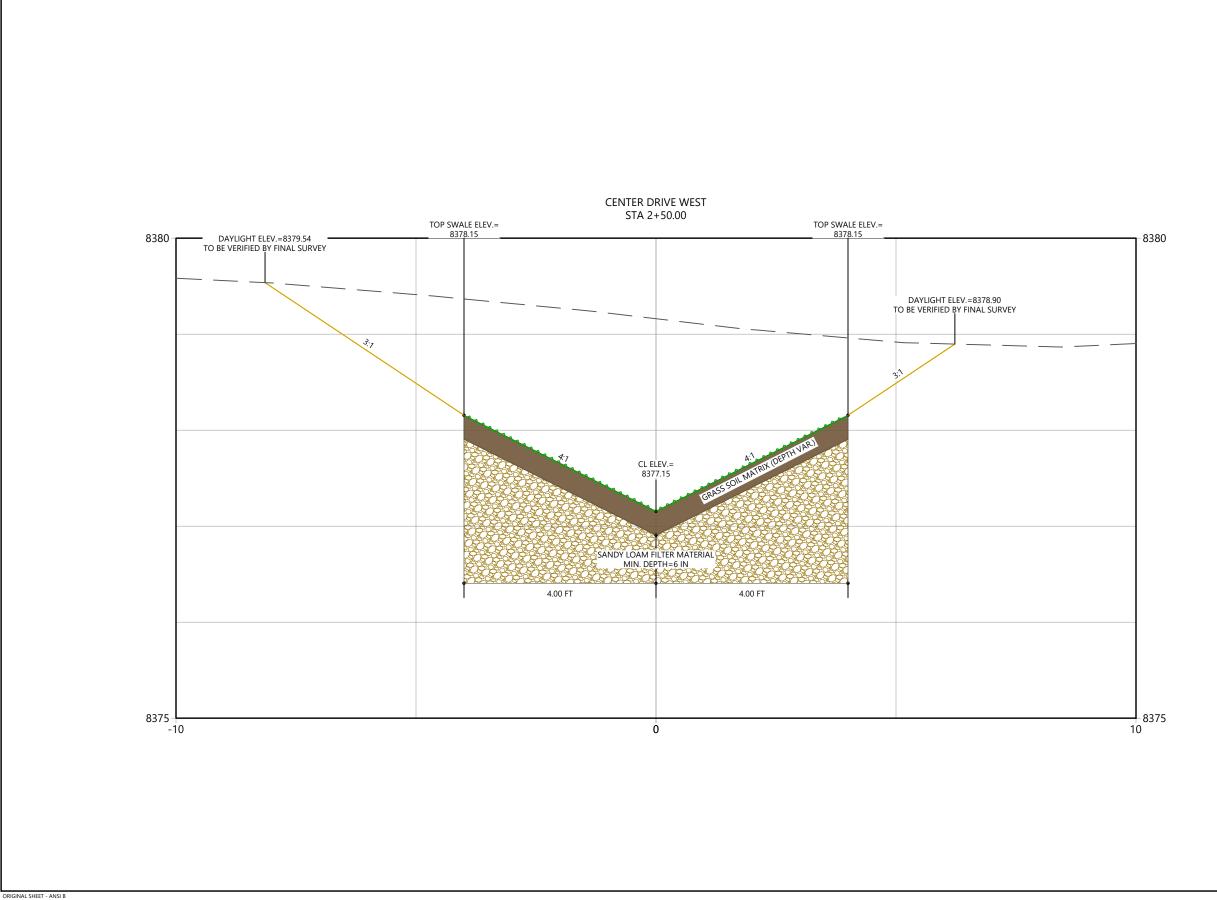



WATERVATION 130 W. Sackett Ave., U Salida, CO 81201 www.water-vation.com

Copyright Reserved

opyright Keserved
The Contract shall verify and be responsible for all dimensions. DO
NOT scale the drawing - any errors or omissions shall be reported to
WaterVation without delay.
The Copyrights to all designs and drawings are the property of
WaterVation. Reproduction or use for any purpose other than that
authorized by WaterVation is forbidden.

Sub-Consultants

Horizontal Scale & Orientation

()	Ź	2

	<u> </u>	=	=	
Revision	_		Appd.	YY.MM.DD
	<u> </u>	\equiv	=	
	<u> </u>	\equiv	=	\equiv
Issued		Ву	Appd.	YY.MM.DD
File Name:	Dwn.	Chkd.	Dsgn.	24.09.12 YY.MM.DD

Client/Project TOWN OF GRAND LAKE STORMWATER MANAGEMENT PLAN


GRAND LAKE, CO

Project Milestone

Sheet Name XSEC_CDW (6)

2023007041 Custom

Sheet 39 of 68

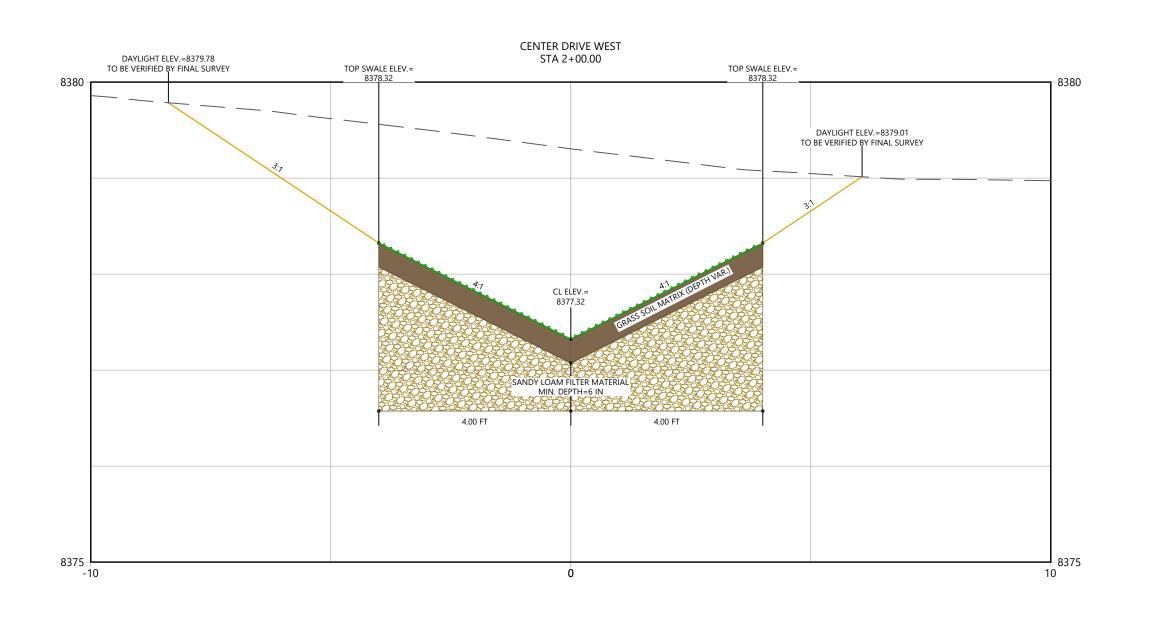



WATERVATION
130 W. Sackett Ave., Unit A
Salida, CO 81201

Copyright Reserved

opyright Keserved

The Contract shall verify and be responsible for all dimensions. DO

NOT scale the drawing - any errors or omissions shall be reported to

Water Vation without delay.

The Copyrights to all designs and drawings are the property of

WaterVation. Reproduction or use for any purpose other than that

authorized by WaterVation is forbidden.

Sub-Consultants

Horizontal Scale & Orientation

ļ Ņ	2	2	4

Legeno

		=		
evision		By	Appd.	YY.MM.DD
		=		
sued		By	Appd.	YY.MM.DD
ile Name:				24.09.12
	Dwn.	Chkd.	Dsgn.	YY.MM.DD

Permit-Sea

Client/Project

TOWN OF GRAND LAKE STORMWATER MANAGEMENT PLAN

GRAND LAKE, CO

Project Milestone


Sheet Name
XSEC_CDW (5)

2023007041 Custom

ect No. Horizontal Sca

Sheet 40 of 68

C:\Users\unders\users\users\users\users\users\users\users\users\users\users\unders\users\undern\unders\undern

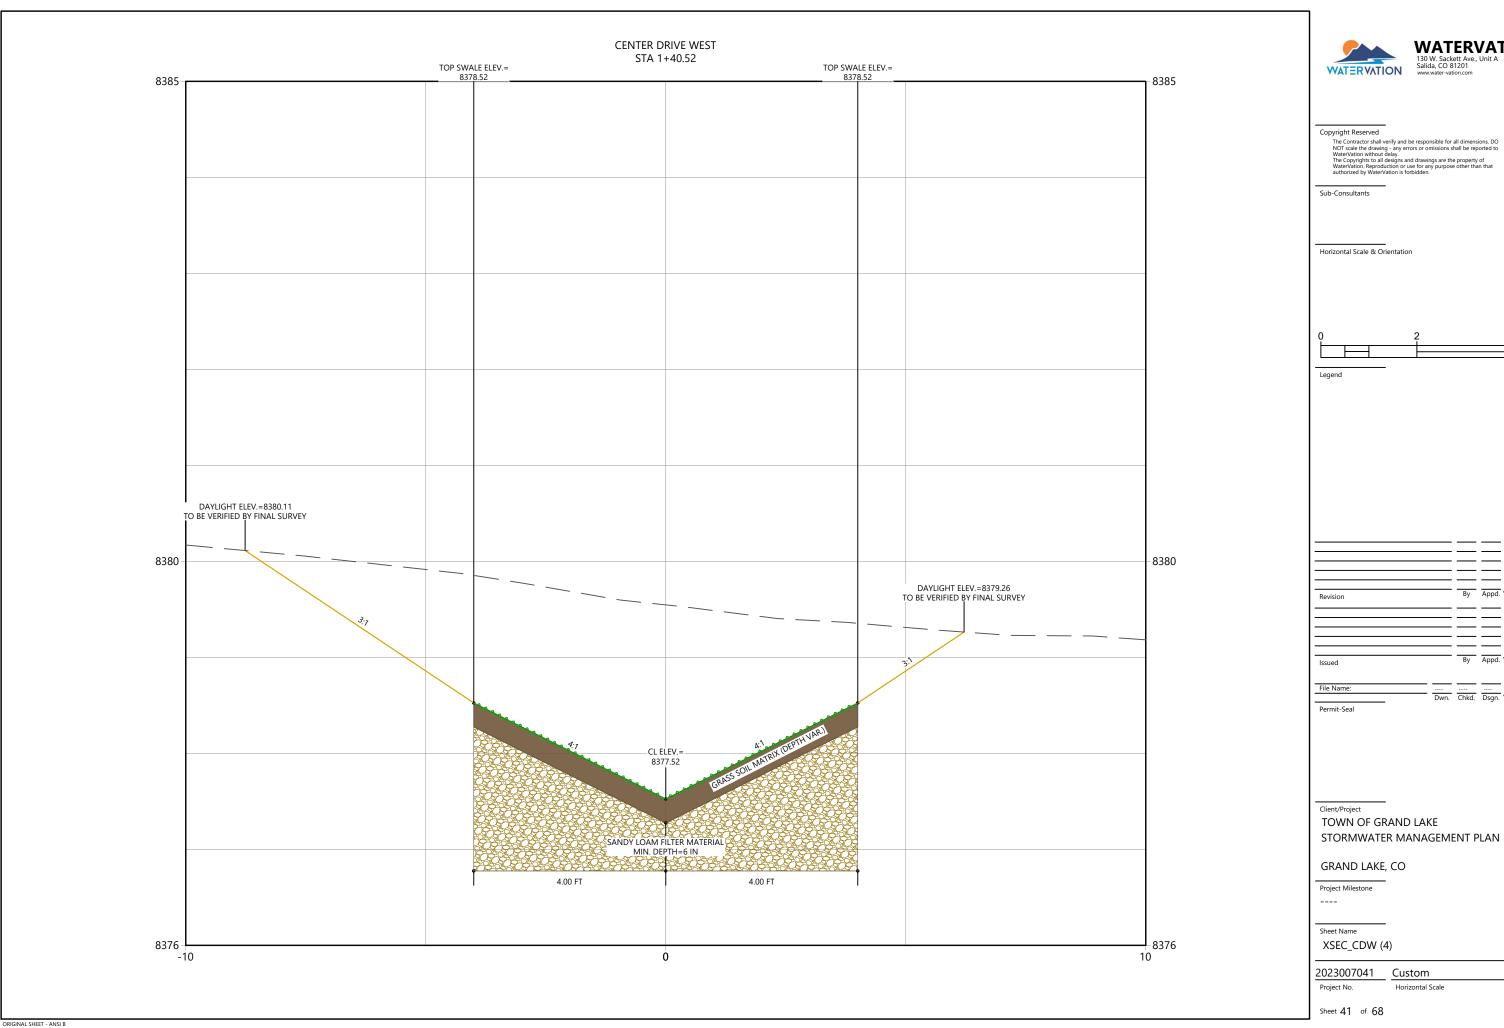


WATERVATION

()	2	2	1
				1
				J

Revision			Appd. YY.MM.DD)
Issued		 	Appd. YY.MM.DE)
File Name:	Dwn.	Chkd.	24.09.12 Dsgn. YY.MM.DE)

TOWN OF GRAND LAKE

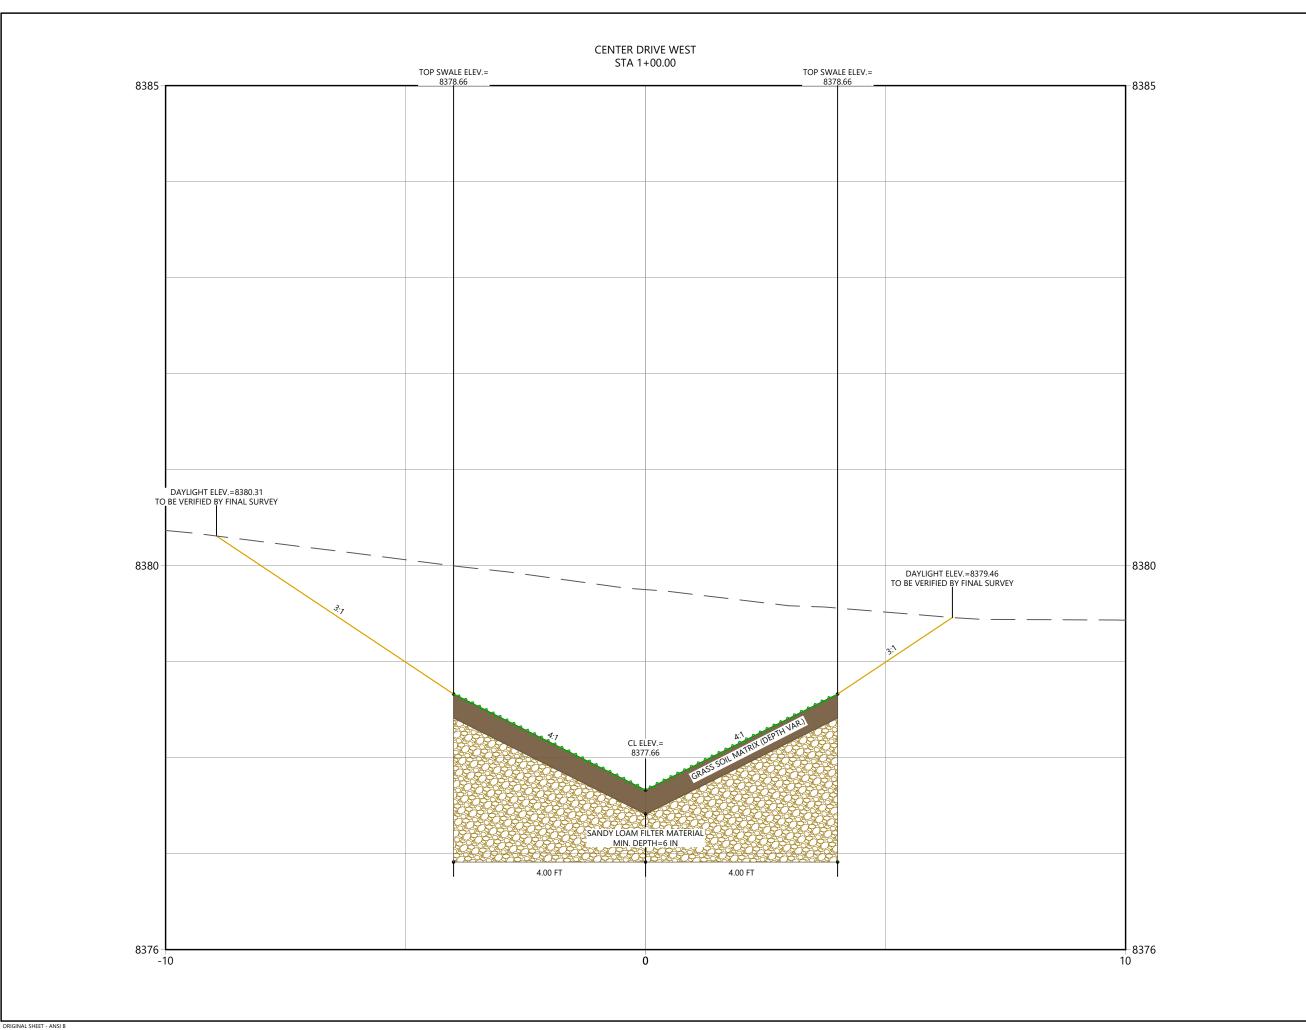



WATERVATION 130 W. Sackett Ave. Salida, CO 81201 www.water-vation.com

Copyright Reserved

Sub-Consultants

opyright Keserved

The Contract shall verify and be responsible for all dimensions. DO

NOT scale the drawing - any errors or omissions shall be reported to

Water Vation without delay.

The Copyrights to all designs and drawings are the property of

WaterVation. Reproduction or use for any purpose other than that

authorized by WaterVation is forbidden.

Horizontal Scale & Orientation

ΙQ	7	2	4

	<u> </u>	<u>=</u>	=	
Revision		Ву	Appd.	YY.MM.DD
		_	_	_
		=	_	
Issued		Ву	Appd.	YY.MM.DD
File Name:	Dwn.	Chkd.	Dsgn.	24.09.12 YY.MM.DD

Client/Project

TOWN OF GRAND LAKE STORMWATER MANAGEMENT PLAN

GRAND LAKE, CO


Project Milestone ----

Sheet Name

XSEC_CDW (3)

2023007041 Custom Project No.

Sheet **42** of **68**

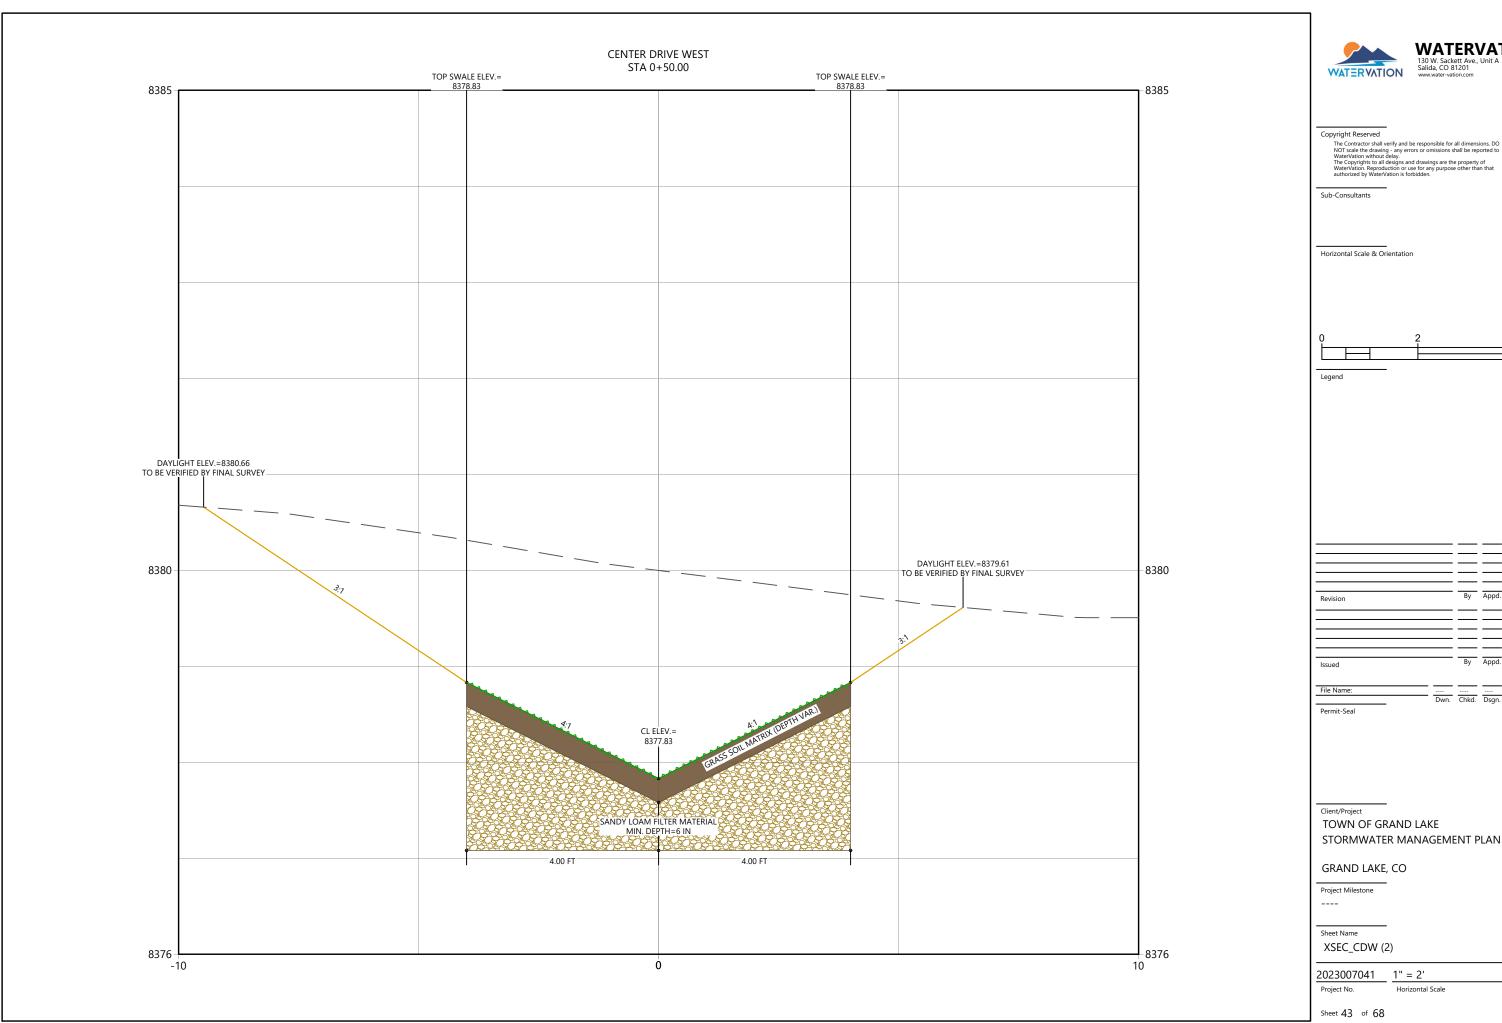



WATERVATION 130 W. Sackett Ave. Salida, CO 81201 www.water-vation.com


١	()	2	2	4
- 1					
- 1					1
- 1]
- 1					J


		<u> </u>	\equiv	<u> </u>
Revision		Ву	Appd.	YY.MM.DD
		=	=	<u> </u>
Issued		Ву	Appd.	YY.MM.DD
File Name:	Dwn.	Chkd.	Dsgn.	24.09.12 YY.MM.DD

TOWN OF GRAND LAKE STORMWATER MANAGEMENT PLAN

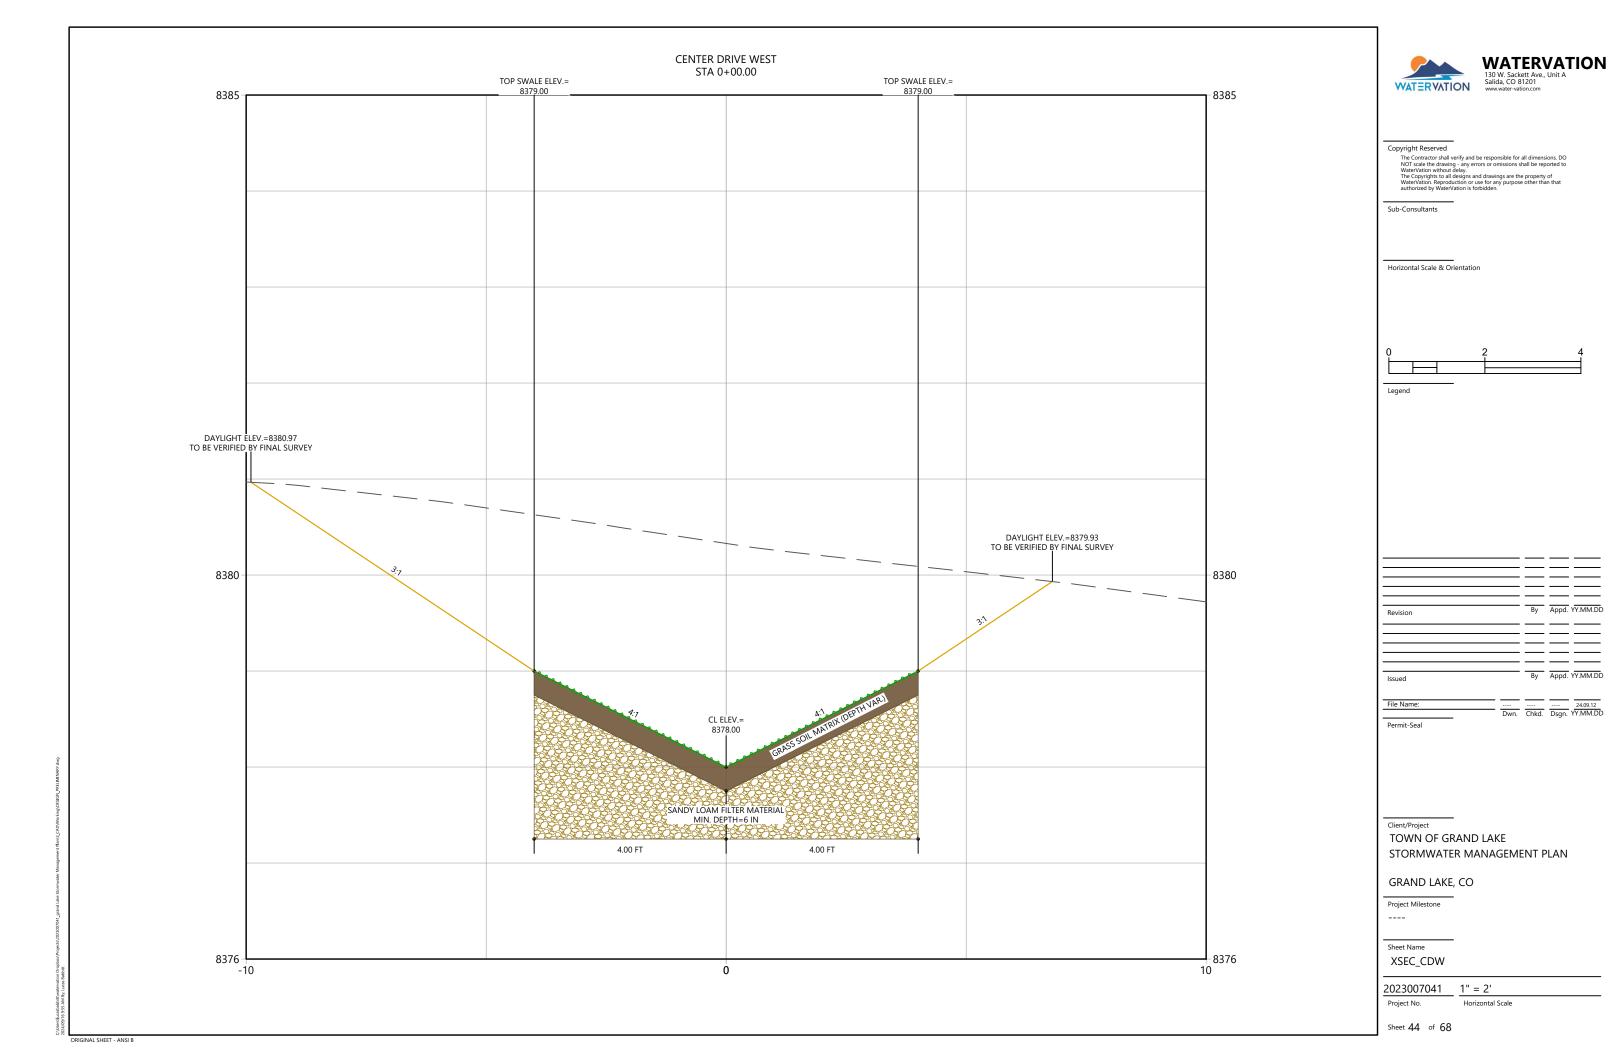

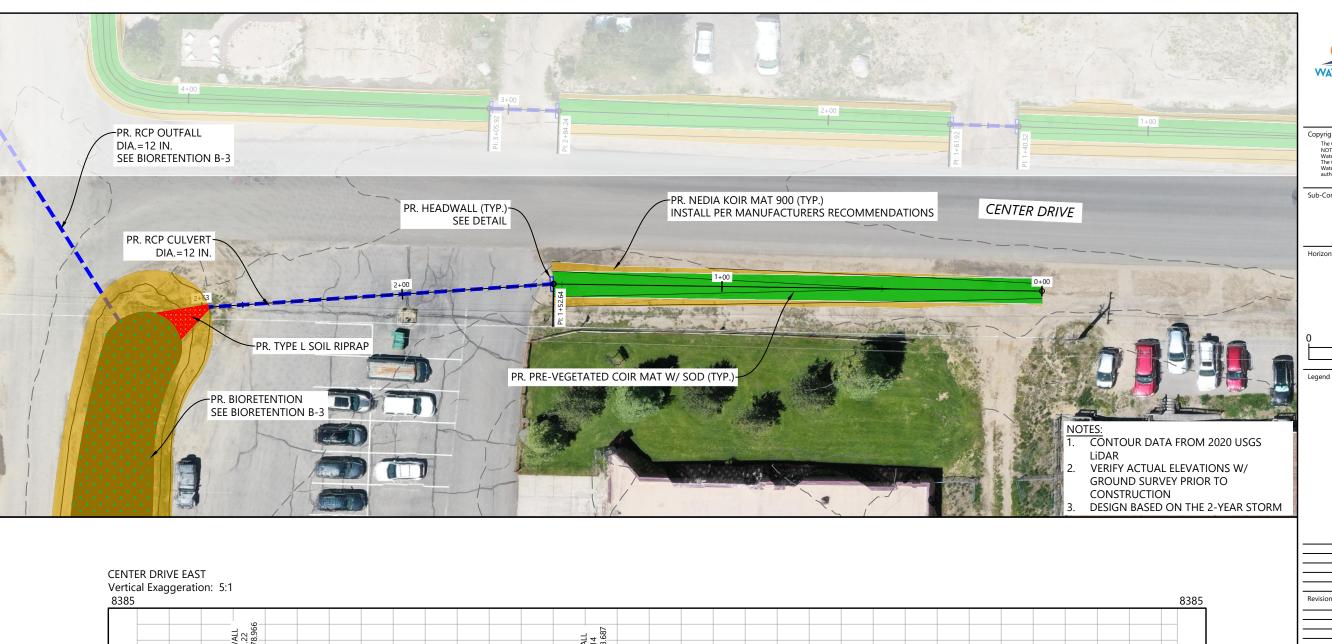

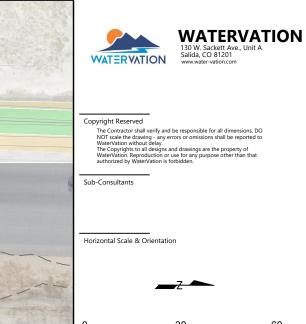

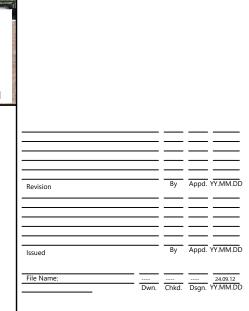



Client/Project

TOWN OF GRAND LAKE
STORMWATER MANAGEMENT PLAN

GRAND LAKE, CO


Project Milestone


The set Nieses

GRASS SWALE_CDE

2023007041 1" = 30'

Sheet **45** of **68**

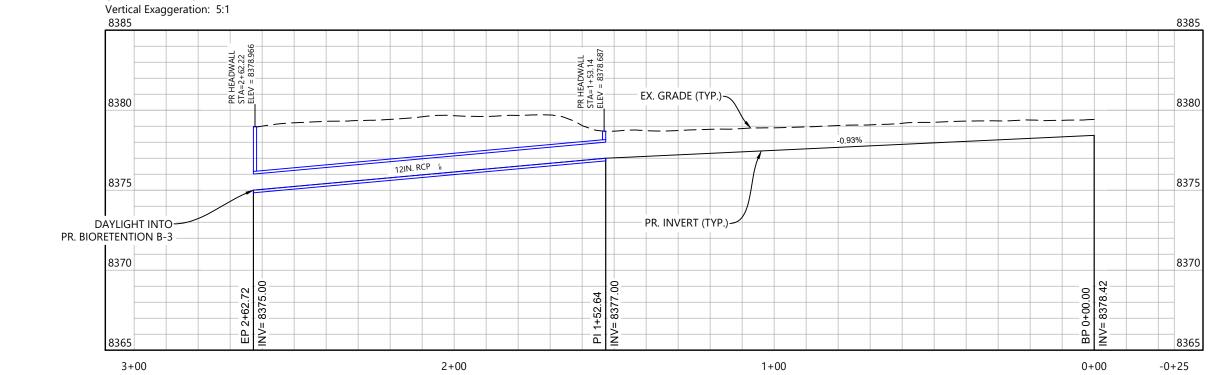

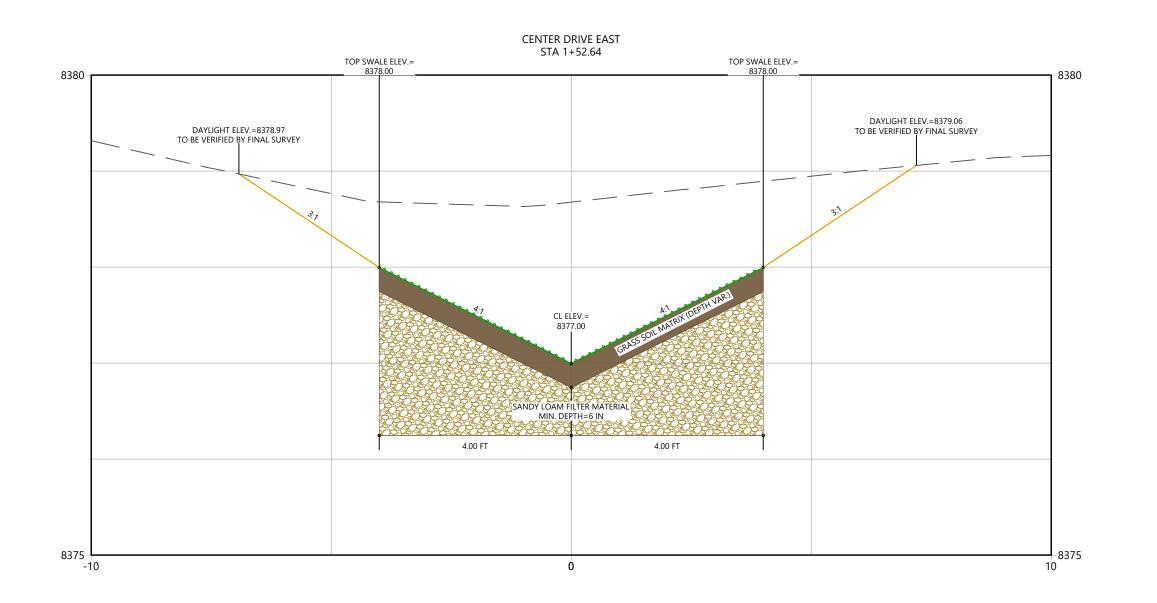



WATERVATION

Copyright Reserved

opyright Keserved

The Contract shall verify and be responsible for all dimensions. DO

NOT scale the drawing - any errors or omissions shall be reported to

Water Vation without delay.

The Copyrights to all designs and drawings are the property of

WaterVation. Reproduction or use for any purpose other than that

authorized by WaterVation is forbidden.

Sub-Consultants

Horizontal Scale & Orientation

ı	Q	2	2	4
ı				
ı				

		\equiv	=	<u> </u>
Revision		Ву	Appd.	YY.MM.DD
		<u>=</u>		<u> </u>
Issued		Ву	Appd.	YY.MM.DD
File Name:	Dwn.	Chkd.	Dsgn.	24.09.12 YY.MM.DD

Client/Project TOWN OF GRAND LAKE

STORMWATER MANAGEMENT PLAN

GRAND LAKE, CO


Project Milestone

Sheet Name

XSEC_CDE (5)

2023007041 1" = 2'

Sheet **46** of **68**

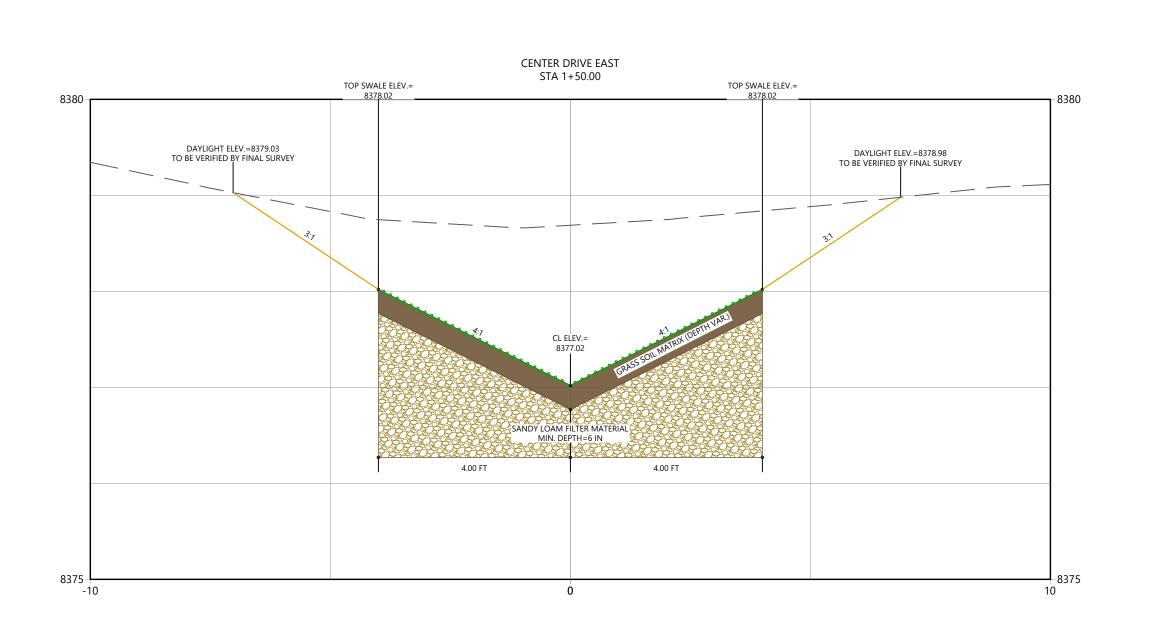



WATERVATION 130 W. Sackett Ave., Unit A Salida, CO 81201 www.water-vation.com

Copyright Reserved

opyright Keserved
The Contract shall verify and be responsible for all dimensions. DO
NOT scale the drawing - any errors or omissions shall be reported to
WaterVation without delay.
The Copyrights to all designs and drawings are the property of
WaterVation. Reproduction or use for any purpose other than that
authorized by WaterVation is forbidden.

Sub-Consultants

Horizontal Scale & Orientation

()	2	2	4

Legend

		=		
evision		Ву	Appd.	YY.MM.DD
sued		Ву	Appd.	YY.MM.DD
le Name:				24.09.12
	Dwn.	Chkd.	Dsgn.	YY.MM.DD

Client/Project

TOWN OF GRAND LAKE STORMWATER MANAGEMENT PLAN

GRAND LAKE, CO

Project Milestone


Sheet Name

XSEC_CDE (4)

2023007041 1" = 2'

. . . .

Sheet **47** of **68**

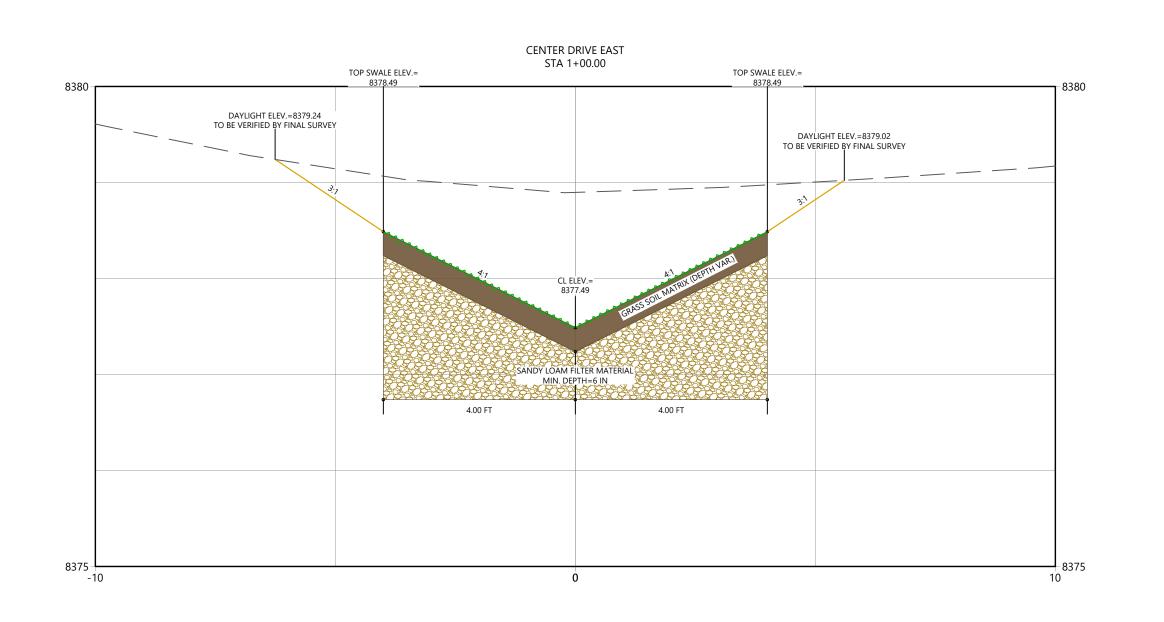



WATERVATION

Copyright Reserved

pypright KeserVed
The Contractor shall verify and be responsible for all dimensions. DO
NOT scale the drawing - any errors or omissions shall be reported to
Water Vation without delay.
The Copyrights to all designs and drawings are the property of
Water Vation. Reproduction or use for any purpose other than that
authorized by Water Vation is forbidden.

Sub-Consultants

Horizontal Scale & Orientation

ļ Ņ	2	2	
-			

Revision		Ву	Appd.	YY.MM.DD
			_	
		=		
Issued		Ву	Appd.	YY.MM.DD
File Name:				24.09.12
	Dwn.	Chkd.	Dsgn.	YY.MM.DD

Client/Project

TOWN OF GRAND LAKE STORMWATER MANAGEMENT PLAN


GRAND LAKE, CO

Project Milestone

Sheet Name XSEC_CDE (3)

2023007041 1" = 2'

Sheet **48** of **68**

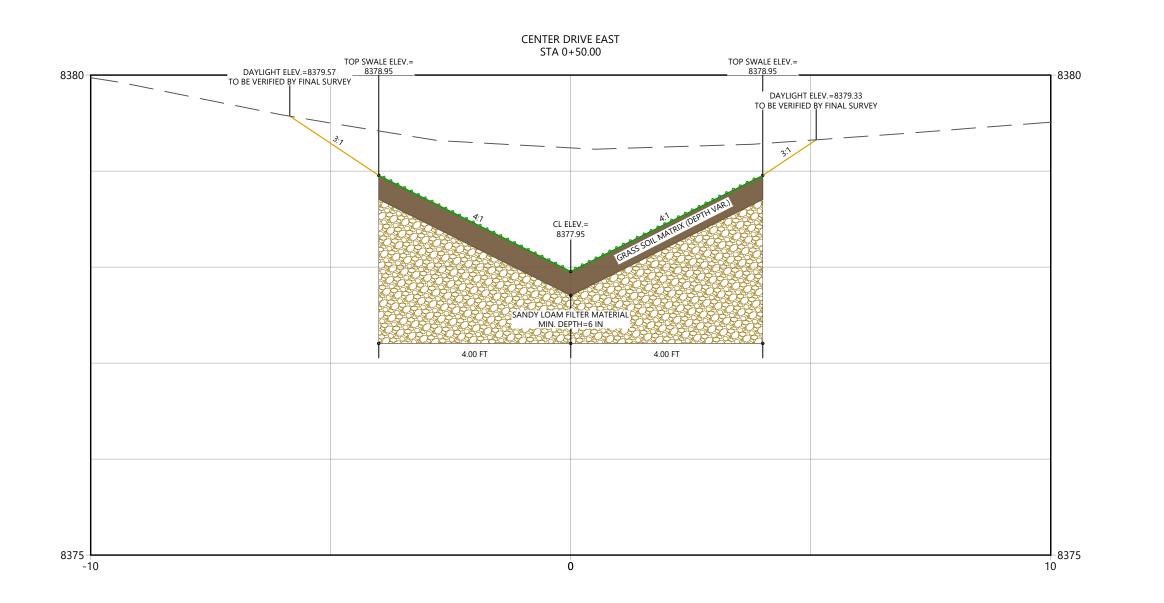



WATERVATION
130 W. Sackett Ave., Unit A
Salida, CO 81201
www.water-vation.com

Copyright Reserved

opyright Keserved
The Contract shall verify and be responsible for all dimensions. DO
NOT scale the drawing - any errors or omissions shall be reported to
WaterVation without delay.
The Copyrights to all designs and drawings are the property of
WaterVation. Reproduction or use for any purpose other than that
authorized by WaterVation is forbidden.

Sub-Consultants

Horizontal Scale & Orientation

()	2	<u>)</u>	
				_
			I .	-
_				

Legend

Client/Project

TOWN OF GRAND LAKE STORMWATER MANAGEMENT PLAN

GRAND LAKE, CO

Project Milestone

Sheet Name
XSEC_CDE (2)


2023007041 1" = 2'


Project No.

Sheet 49 of 68

C:\Users\lucasbabbitt\watervation Dropbox\Projects\2023007041_grand Lake Stormwater Management Plan\3_C 2024/09/16 9:56 AM 8y; Lucas Babbitt


ORIGINAL SHEET - ANSI B

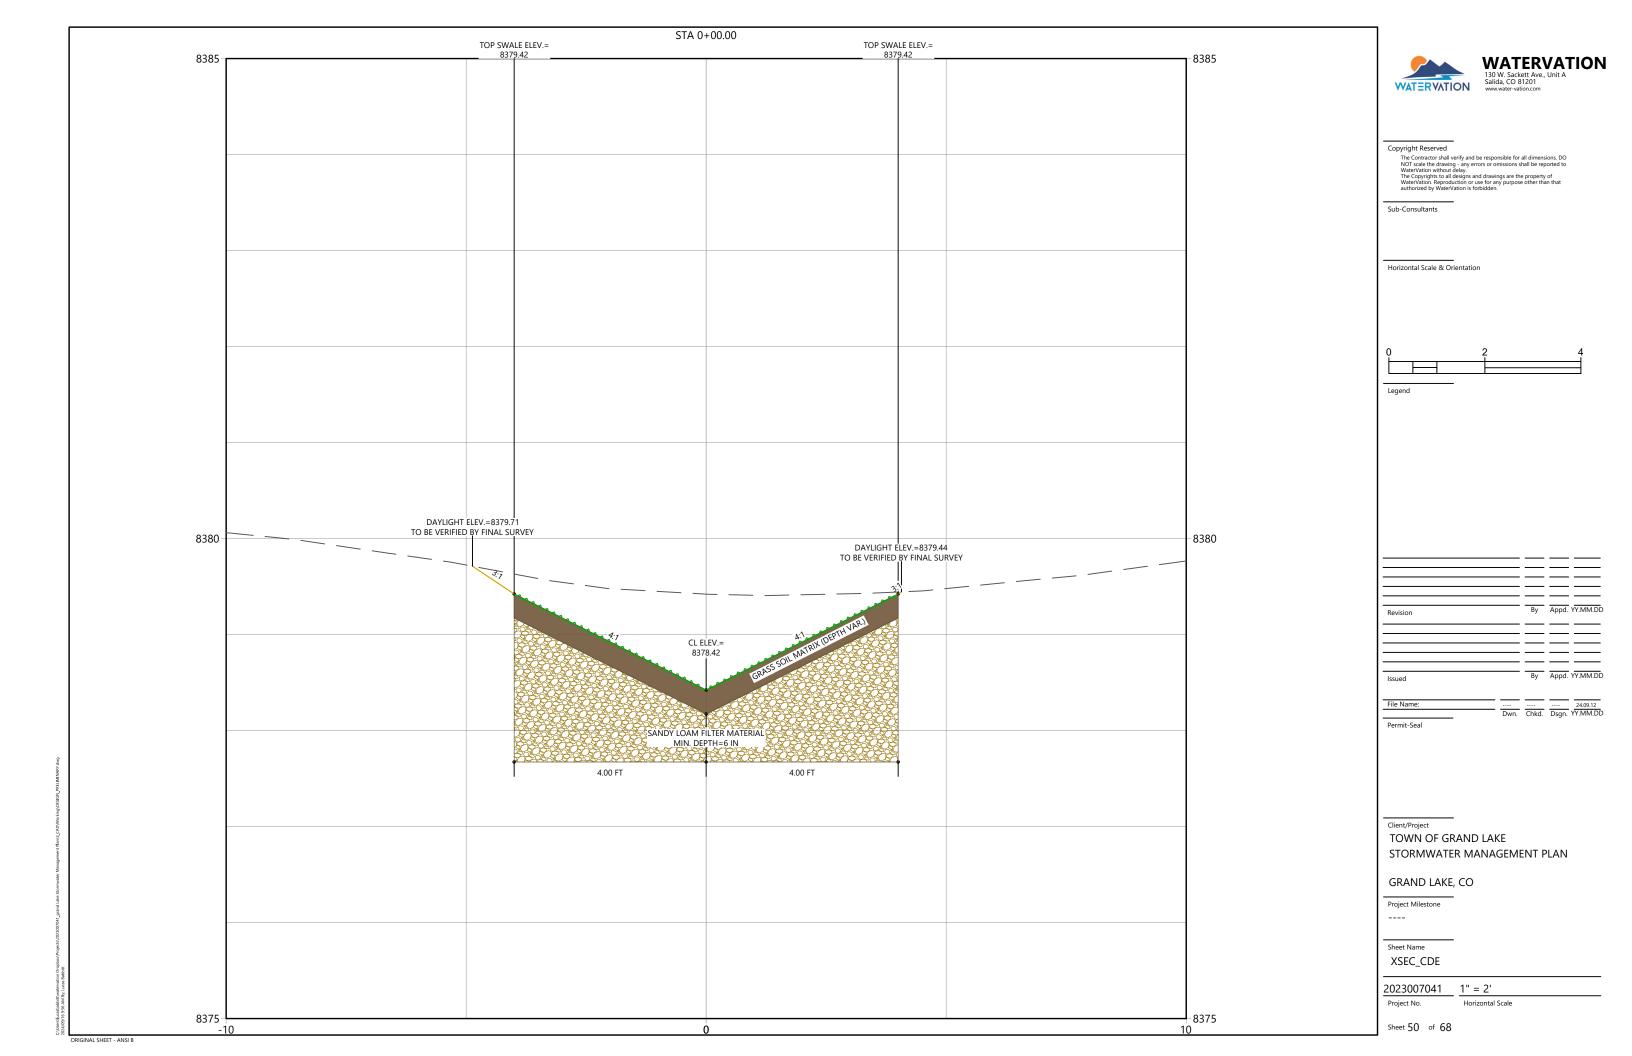

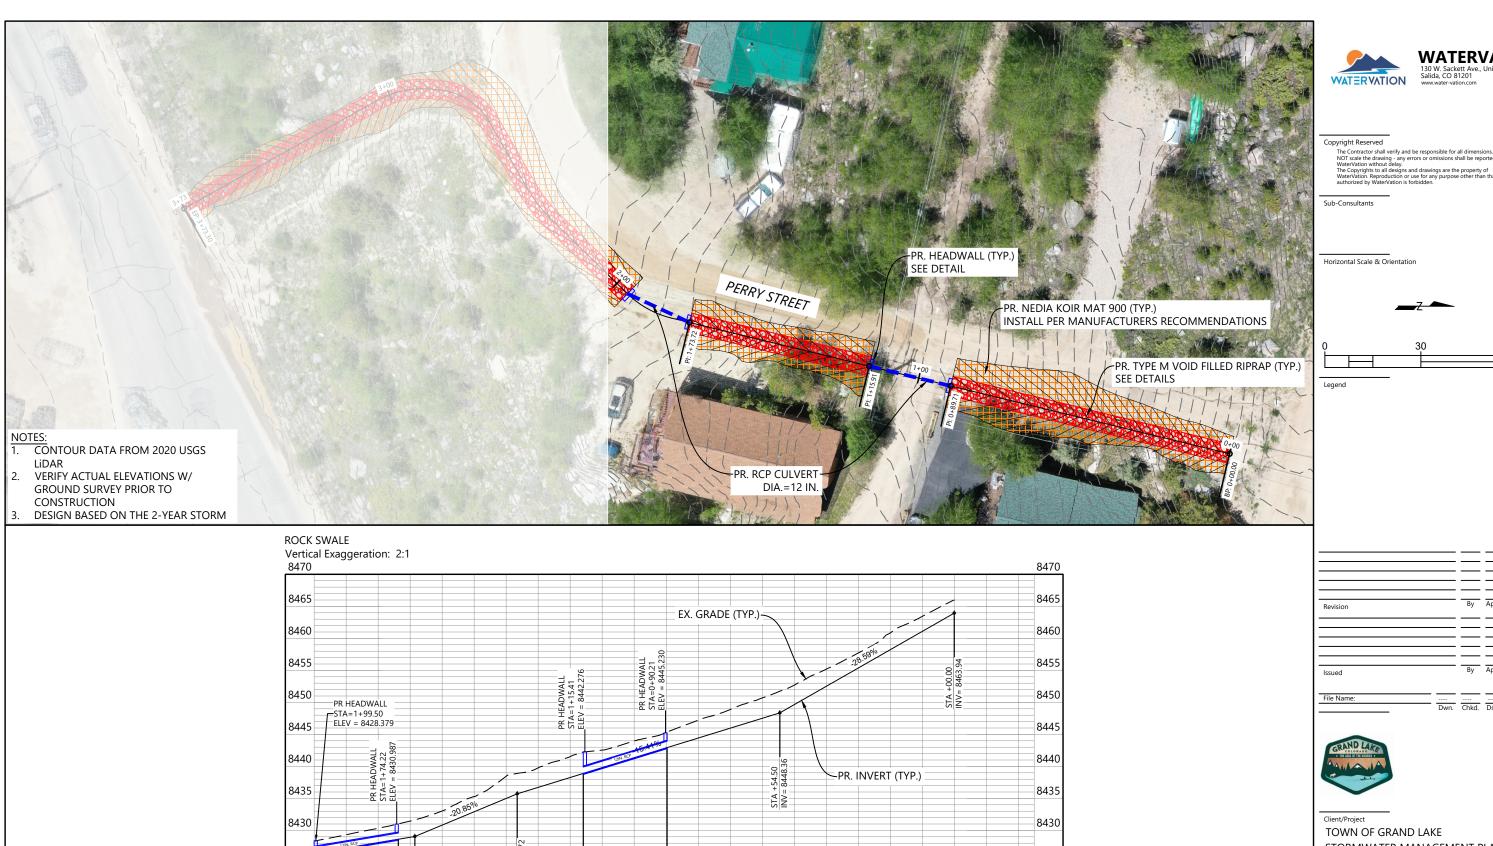

1+00

WATERVATION

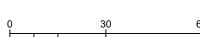

 Dwn.
 Chkd.
 Dsgn.
 YY.MM.DD

STORMWATER MANAGEMENT PLAN

GRAND LAKE, CO

Project Milestone

8425

8420

8415

8410

8405

-0+25

0+00

Sheet Name

ROCK SWALE

2023007041 1" = 30' Project No.

Sheet 51 of 68

8425

8420


8415

8410

8405

2+00

≣ੂ

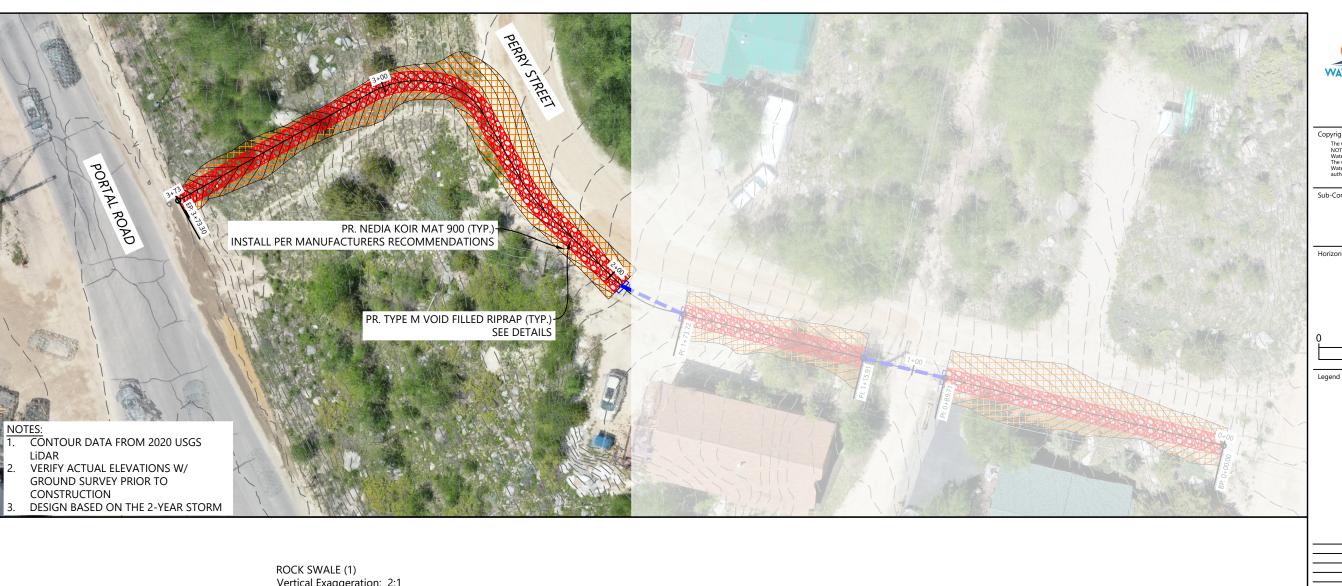



WATERVATION

Copyright Reserved

pyright, reserved:

The Contractor shall verify and be responsible for all dimensions.


NOT scale the drawing - any errors or omissions shall be reported Water-Vation without delay.


The Copyrights to all designs and drawings are the property of Water-Vation. Reprociuction or use for any purpose other than the authorized by Water-Vation is forbidden.

Sub-Consultants

Horizontal Scale & Orientation



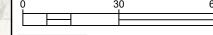

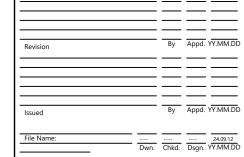



Client/Project

TOWN OF GRAND LAKE STORMWATER MANAGEMENT PLAN


GRAND LAKE, CO


Project Milestone


ROCK SWALE (2)


2023007041 1" = 30'

Sheet 52 of 68

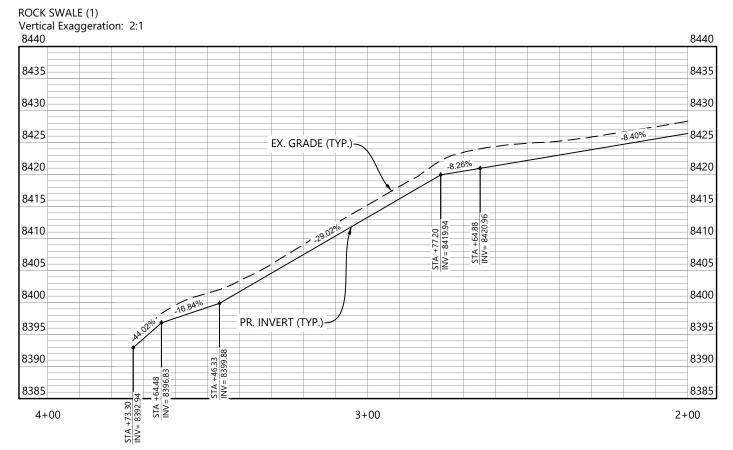


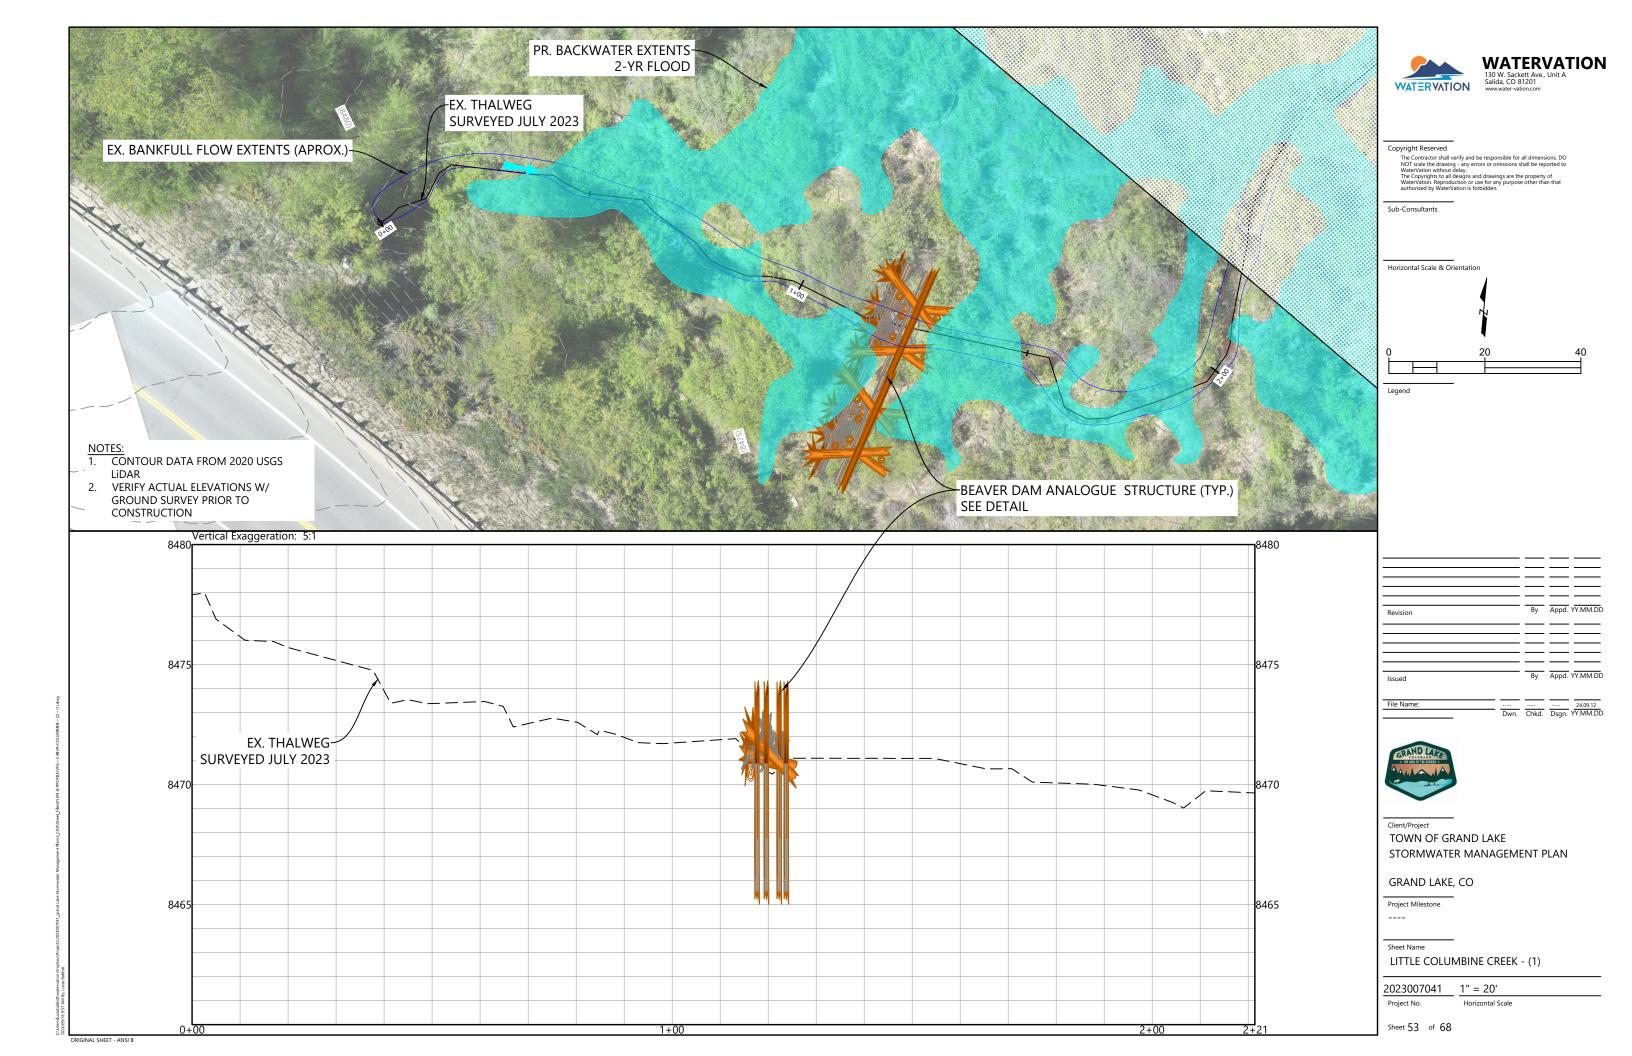

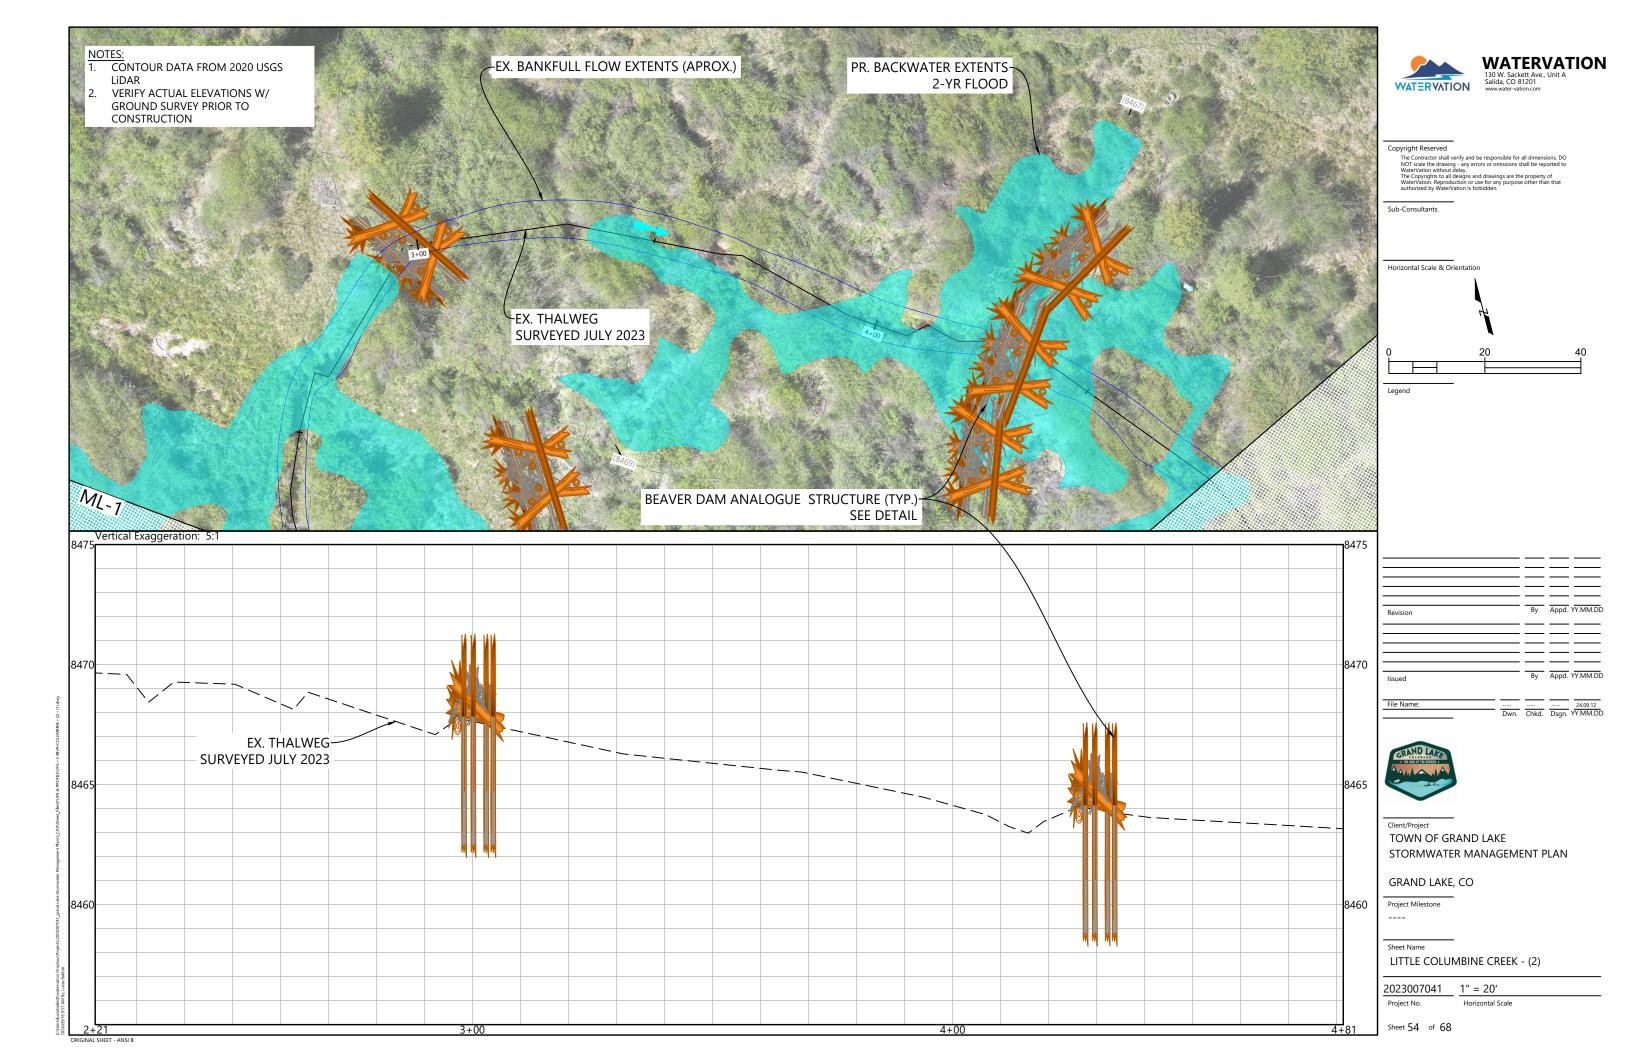

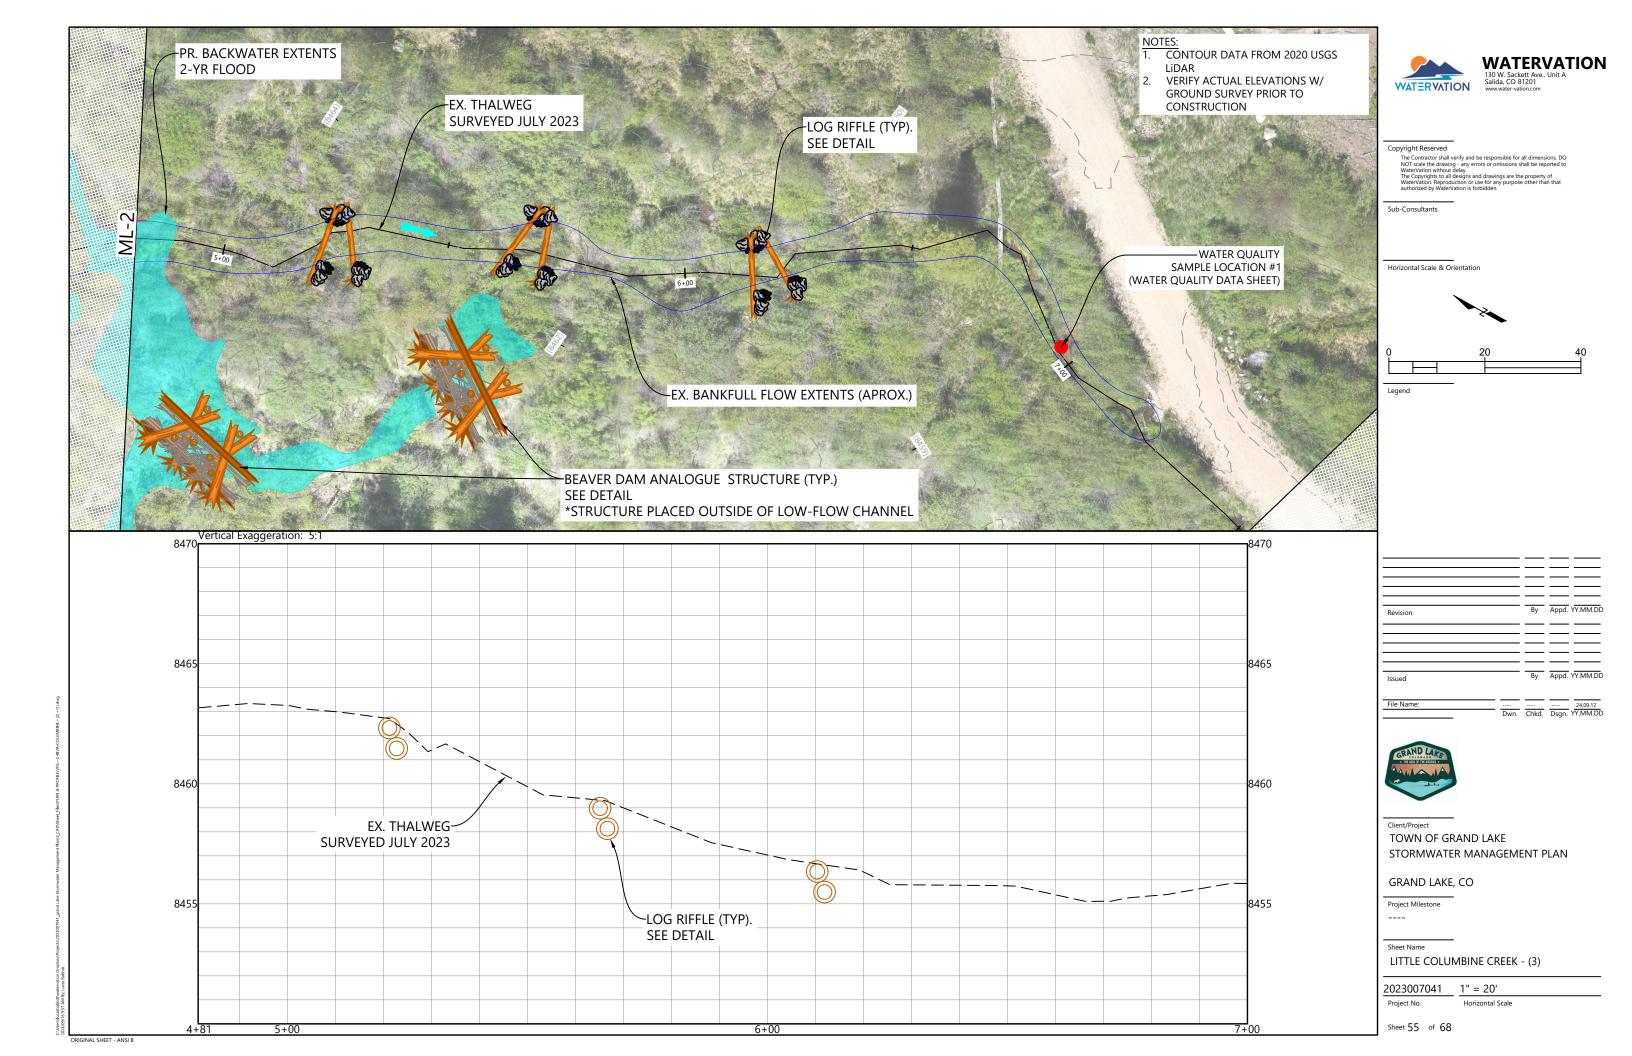

TYPICAL BIORETENTION DETAIL

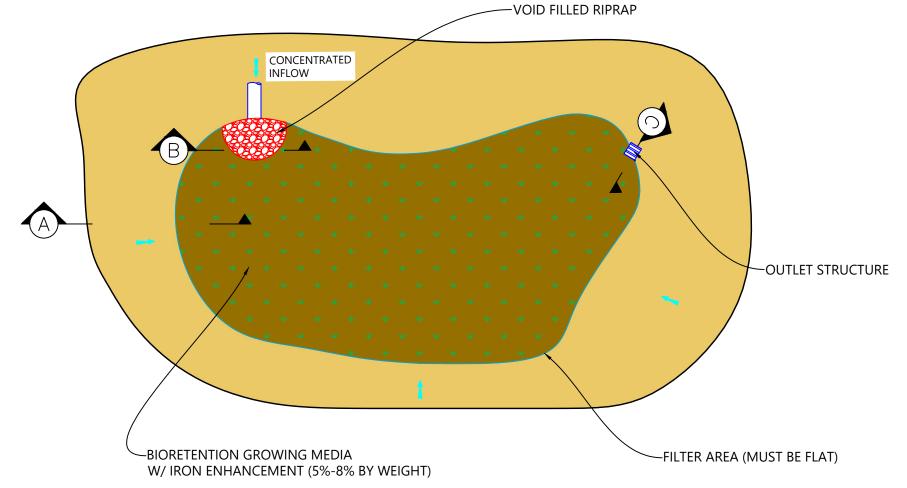





WATERVATION

Horizontal Scale & Orientation

Revision		Ву	Appd. YY.MM.DI
		\equiv	
Issued		Ву	Appd. YY.MM.DI
File Name:	 Dwn	Chkd	24.09.12 Dsgp YY MM DI



TOWN OF GRAND LAKE STORMWATER MANAGEMENT PLAN


GRAND LAKE, CO

Project Milestone

DETAIL_BIORETENTION

2023007041 NTS

Sheet **56** of **68**

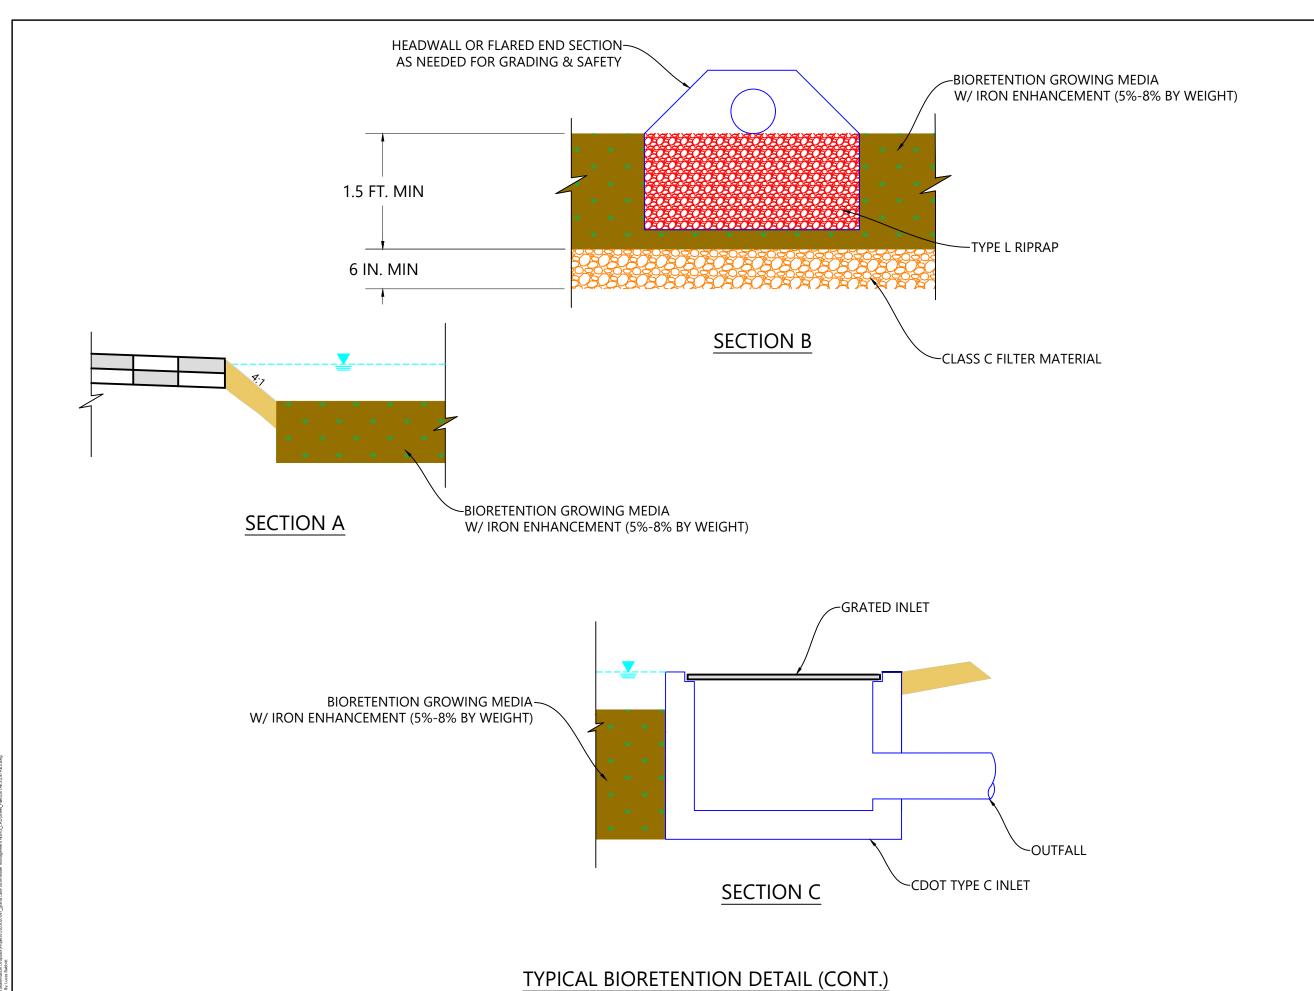



WATERVATION 130 W. Sackett Ave., Unit A Salida, CO 81201

Copyright Reserved

I ne Contractor shall verify and be responsible for all dimensions NOT scale the drawing - any errors or omissions shall be reporte WaterVation without delay. The Copyrights to all designs and drawings are the property of

Sub-Consultants

Horizontal Scale & Orientation

Leger

	\equiv	
Revision	Ву	Appd. YY.MM.D
Issued		Appd. YY.MM.D
File Name:	 Chkd.	24.09.12 Dsgn. YY.MM.D



Client/Projec

TOWN OF GRAND LAKE STORMWATER MANAGEMENT PLAN

GRAND LAKE, CO

Project Milestone

Sheet Name

DETAIL_BIORETENTION CONT.

2023007041 NTS

Horizontal Scale

Sheet 57 of 68

ORIGINAL SHEET - AN

SPECIFICATIONS

1-208-354-3691

Mat Material: 100% Biodegradable coconut fiber, plugged with native wetland plants.

<u>Typical Plants</u>: Sedges, rushes, wetland grasses, bulrushes and spike rushes.

<u>Custom Orders</u>: Wetland Sod can be custom grown to your species specifications.

Pricing: Stock Wetland Sod mixes, \$205.44 per mat (\$3.96/ft²). Delivery and installation can be arranged but are not included in sales price.

Length: 16.2 ft (5 m) Width: 3.2 ft (1 m) Area: 52 ft² (5 m²)

Coir Mat Thickness: 2.75 in (7 cm) Weight: 100-150 lbs per unit <u>Plant Height</u>: 8" - 36" depending on plant species.

<u>Plant Coverage</u>: Minimum of 50% root and 50% shoot coverage.



www.northforknativeplants.com

WETLAND SOD Pre-vegetated Coir Erosion Control Mats



a product of





WATERVATION

Horizontal Scale & Orientation

		=	_	
		_	_	
Revision		Ву	Appd.	YY.MM.DI
		=	=	
		—		
		=		
Issued		Ву	Appd.	YY.MM.DI
File Name:				24.09.12
	Dwn	Chkd	Dsan	YY.MM.DI



TOWN OF GRAND LAKE STORMWATER MANAGEMENT PLAN

GRAND LAKE, CO

Project Milestone

DETAIL_WETLAND SOD

2023007041 NTS

Sheet 58 of 68

Wetland Sod Installation Guidelines

Delivery Related

- 1. Wetland Sod mat delivery should be scheduled to coincide with immediate job site installation. If mats cannot be immediately installed, they can be stored in a shady location for no more than **three** days and must be kept thoroughly saturated and covered (tarped) during that time. In hot, dry weather mats should be stored under the same conditions for no more than **two** days.
- 2. Mats are delivered rolled and are most easily moved by two people with hay hooks. NFNP does not use pallets to ship Wetland Sod.
- 3. Each Wetland Sod mat is approximately 16.2 feet in length and 3.2 feet wide. Per mat weights vary seasonally between 120 170 pounds.
- 4. Each mat is banded with a species classification tag for identification. For example, a mix with *Carex nebrascensis*, *Carex aquatilis* and *Juncus arcticus* will read *CnCaJa*.

Installation Related

- 1. Mats are simply moved to the installation site, unrolled and then staked down. Ensure that the plant roots and the bottom of the mat are in direct contact with the soil. Space between the mat bottom and ground caused by folds, wrinkles or upturned mat edges will create a void that will allow the root system to dry out. Installing mats over large rocks, tree branches, very rough ground or anything that prevents root-to-soil contact should be avoided or remedied prior to installation.
- 2. Mats should **not** be installed on slopes steeper than 2.5:1. Some die-back can be expected when slopes exceed 3:1 steepness
- 3. NFNP recommends the following staking pattern for Wetland Sod installation:
 - a. Drive stakes through the mat at a slight angle and leave about 4" of the stake protruding above the mat.
 - b. Use eight to twelve, 16" wooden stakes per mat for installations involving moving water (i.e. stream channels, windward lake shores, storm water retention areas).
 - c. Use six to eight, 16" wooden stakes per mat for site conditions without erosive characteristics (i.e. pond and lake shorelines, wetland areas)



1499 S 6000 W Rexburg, ID 83440 Tel: 208.354.3691 Toll Free: 877.444.6996 Fax: 208.247.0941 www.northforknativeplants.com

Installation Related ~ Continued

4. Ideally, mats should be installed in water depths of 2 inch to 4 inches. If site hydrology at the time of installation is lacking, plants will need supplemental irrigation. Additional irrigation will need to be provided during the first 3-4 weeks in order to ensure plant root establishment in surrounding soils. Conversely, if water levels are too deep at installation or during the first month after installation, the plants can die. After roots are well established, plants can tolerate periodic hydrologic famine or deeper water conditions.

Stream Bank Application Comments

On stream banks we recommend Wetland Sod installation just after peak flows, when water levels are gradually dropping. Supplemental irrigation may be required to fully establish the vegetation, but it will generally be fully rooted and ready for high water the following spring. The time required for roots to provide adequate anchoring depends on growing conditions including heat, light, and moisture.

In our experience, it is virtually impossible to pull up rooted coir manually after as little as 2-3 weeks at warm, low elevation sites or 4-5 weeks at cooler, high elevation sites. Although there is little data on initial or long-term performance of pre-planted coir in high energy channel environments, we have worked on projects where installed material was exposed to intense flows from storm runoff within several weeks after installation and was not dislodged or damaged

Other Useful Information

Labor/Installation

NFNP does not provide installation services. We have, however, compiled data from various clients to provide some guidelines with respect to anticipated installation times.

Based on that data, average installation time per mat is approximately .40 labor hours (24 minutes). This figure includes time for unloading, handling, on site distribution, and installation. Of course this is an average, installation times and labor requirements can vary significantly from site-to-site depending primarily on site accessibility.

Use of a 4-wheeler or utility vehicle is not required but may make handling easier and installation faster depending upon site conditions.



1499 S 6000 W Rexburg, ID 83440 Tel: 208.354.3691 Toll Free: 877.444.6996 Fax: 208.247.0941 www.northforknativeplants.com



WATERVATION 130 W. Sackett Ave., Unit A Salida, CO 81201

Copyright Reserved

The Contractor shall verify and be responsible for all dimensions. D NOT scale the drawing - any errors or omissions shall be reported t WaterVation without delay.

The Copyrights to all designs and drawings are the property of

Sub-Consultants

Horizontal Scale & Orientation

Leger

		_		
		=		
		By	Appd	YY.MM.D
Revision		Бу	дрри.	TT.IVIIVI.D
		_		
		=		
11		By	Appd.	YY.MM.D
Issued		-,		
File Name:				24.00.12
THE INDITIE.	_ ===			24.09.12



Client/Project

TOWN OF GRAND LAKE STORMWATER MANAGEMENT PLAN

GRAND LAKE, CO

Project Milestone

. roject

DETAIL_WETLAND SOD (2)

2023007041

NTS

Sheet 59 of 68

LOG RIFFLE STRUCTURE





WATERVATION 130 W. Sackett Ave., Unit A Salida, CO 81201

Copyright Reserve

The Contractor shall verify and be responsible for all dimensions NOT scale the drawing - any errors or omissions shall be reporte WaterVation without delay. The Copyrights to all designs and drawings are the property of WaterVation. Reproduction or use for any ourpose other than the

Sub Consulta

Horizontal Scale & Orientation

Leger

	\equiv	
Revision	Ву	Appd. YY.MM.DE
	\equiv	
Issued	 Ву	Appd. YY.MM.DI
File Name:	 Chkd.	24.09.12 Dsgn. YY.MM.DI



Client/Project

TOWN OF GRAND LAKE STORMWATER MANAGEMENT PLAN

GRAND LAKE, CO

Project Milestor

. rojeci

Sheet Name


LOG RIFFLE EXAMPLE

2023007041 NTS

Horizontal Sc

Sheet 60 of 68

C/Users/Lucasbabbittywatervation Dropbox/Projects/2023007041_grand Lake Stormwater Management Plant3_CAD/Sheet_Files/DETALLS/ 2024/99/16 957 AM By: Lucas Babbitt

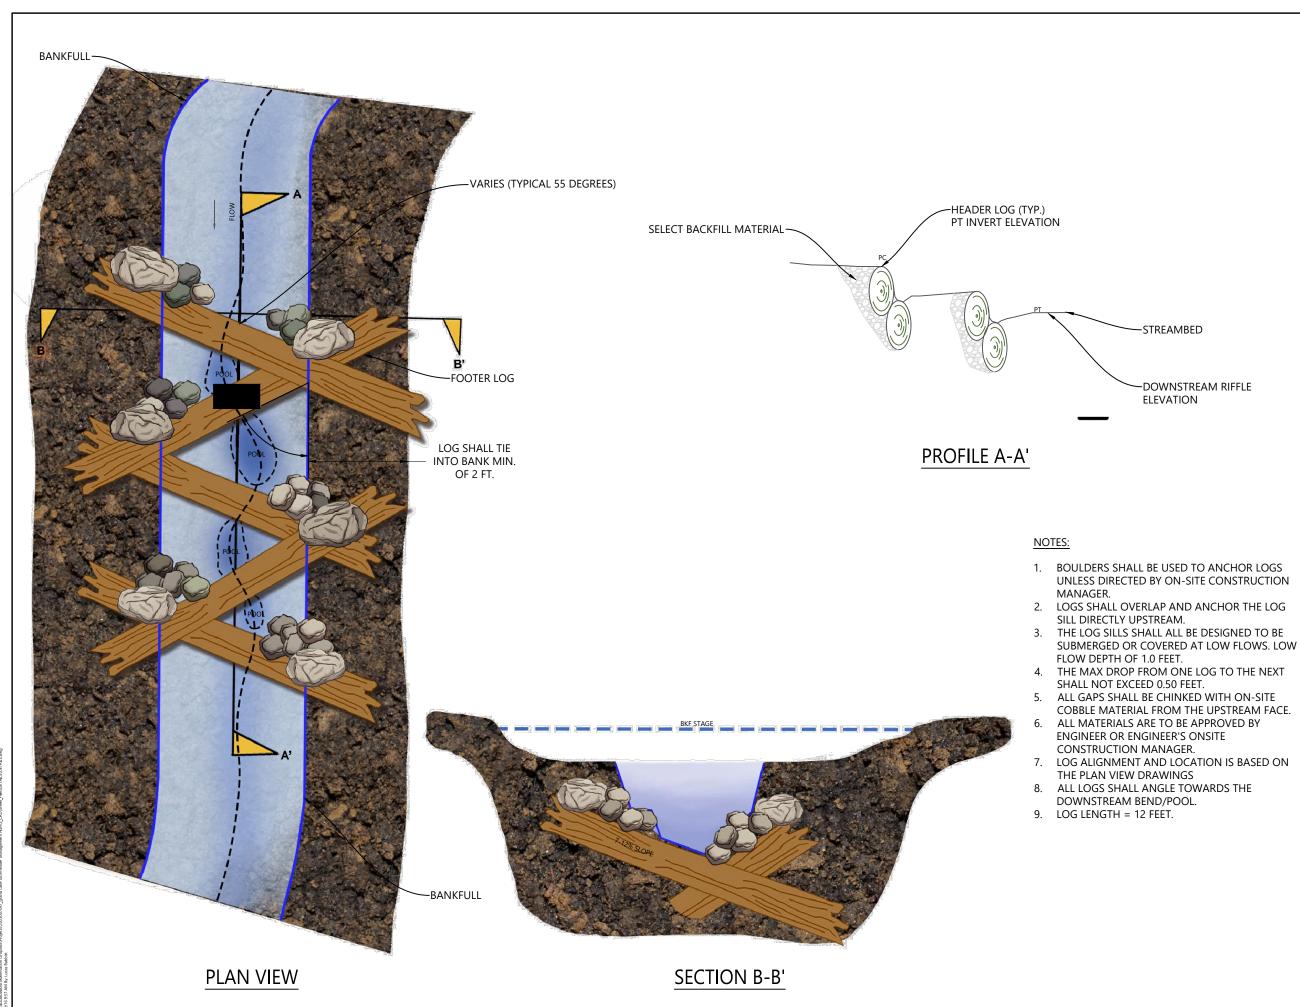



WATERVATION

Copyright Reserved

The Contractor shall verify and be responsible for all dimensions. NOT scale the drawing - any errors or omissions shall be reported Water-Vation without delay.

The Copyrights to all designs and drawings are the property of Water-Vation. Reproduction or use for any purpose other than the authorized by Water-Vation is forbidden.

Sub-Consultants

Horizontal Scale & Orientation

-STREAMBED

ELEVATION

-DOWNSTREAM RIFFLE

Issued Dwn. Chkd. Dsgn. YY.MM.DD



TOWN OF GRAND LAKE STORMWATER MANAGEMENT PLAN

GRAND LAKE, CO

Project Milestone

DETAIL_LOG RIFFLE

2023007041 NTS

Sheet 61 of 68

BEAVER DAM ANALOGUE STRUCTURE



BEAVER DAM STRUCTURE ON DUNOIR RIVER, WY



WATERVATION 130 W. Sackett Ave., Unit A Salida, CO 81201

Copyright Reserved

The Contractor shall verify and be responsible for all dimensions NOT scale the drawing - any errors or omissions shall be reporte Water/Vation without delay.

The Copyrights to all designs and drawings are the property of Waterland Property of the company of the property of the contract of the con

Sub-Consulta

Horizontal Scale & Orientation

Leg

	 _	_	=
Revision		Appd.	YY.MM.DD
Issued		Appd.	YY.MM.DD
File Name:	 		24.09.12



Client/Project

TOWN OF GRAND LAKE STORMWATER MANAGEMENT PLAN

GRAND LAKE, CO

Project Mileston

....

Cl . . N


BEAVER DAM ANALOGUE STRUCTURE EXAMPLE


2023007041 NTS

Horizontal Scale

riorizoritai se

Sheet 62 of 68

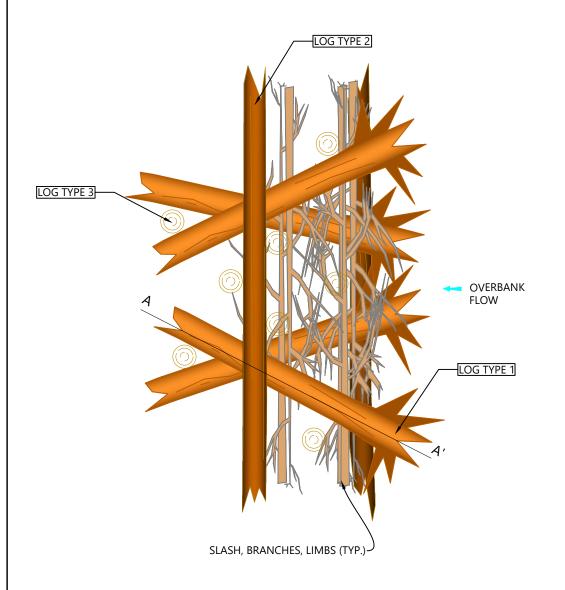

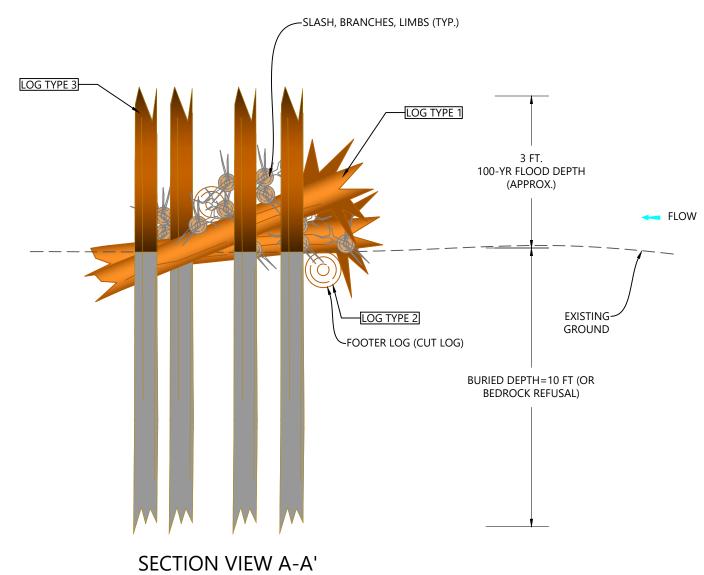

PLAN VIEW

NOTES:

- 1. ALL KEY LOGS SHALL BE PLACED ON THE FLOODPLAIN SURFACE. NO EXCAVATION OR BURIAL OF LOGS SHALL BE
- PILES SHALL BE DRIVEN OR PUSHED INTO THE GROUND WITHOUT EXCAVATION.
- 3. ALL EXPOSED LOG ENDS SHALL HAVE BROKEN ENDS RATHER THAN SAW CUT ENDS.
- 4. FLOODPLAIN WOOD ASSEMBLAGE DETAIL IS TYPICAL AND IS INTENDED TO BE CONFIGURED IN MULTIPLE ORIENTATIONS AS DIRECTED BY THE ENGINEER.
- 5. 100-YEAR WATER SURFACE DEPTH IS APPROXIMATELY 3 FEET ABOVE FINAL GRADE.
- 6. PILE LOGS SHALL BE DRIVEN TO A DEPTH OF 10 FEET BELOW FINISHED GRADE (OR BEDROCK REFUSAL).

LARGE WOOD SCHEDULE							
LOG TYPE	LOG TYPE	LOG SIZE	QUANTITY PER STRUCTURE				
1	SURFACE	12"-18" DIA. X 20-30' LONG, WITH ROOTWAD ATTACHED	4				
2	SURFACE	12"-18" DIA. X 20-30' LONG, CUT LOG	2				
3	PILE	12"-18" DIA. X 10'-15' LONG, CUT LOG	10				



WATERVATION

Copyright Reserved

pyright, teserveu.

The Contractor shall verify and be responsible for all dimensions.

NOT scale the drawing - any errors or omissions shall be reported Water-Vation without delay.

The Copyrights to all designs and drawings are the property of Water-Vation. Reproduction or use for any purpose other than tha authorized by Water-Vation is forbidden.

Sub-Consultants

Horizontal Scale & Orientation

Dwn. Chkd. Dsgn. YY.MM.DD



Client/Project

TOWN OF GRAND LAKE STORMWATER MANAGEMENT PLAN


GRAND LAKE, CO

Project Milestone

DETAIL_BEAVER DAM ANALOGUE STRUCTURE

2023007041 NTS

Sheet 63 of 68

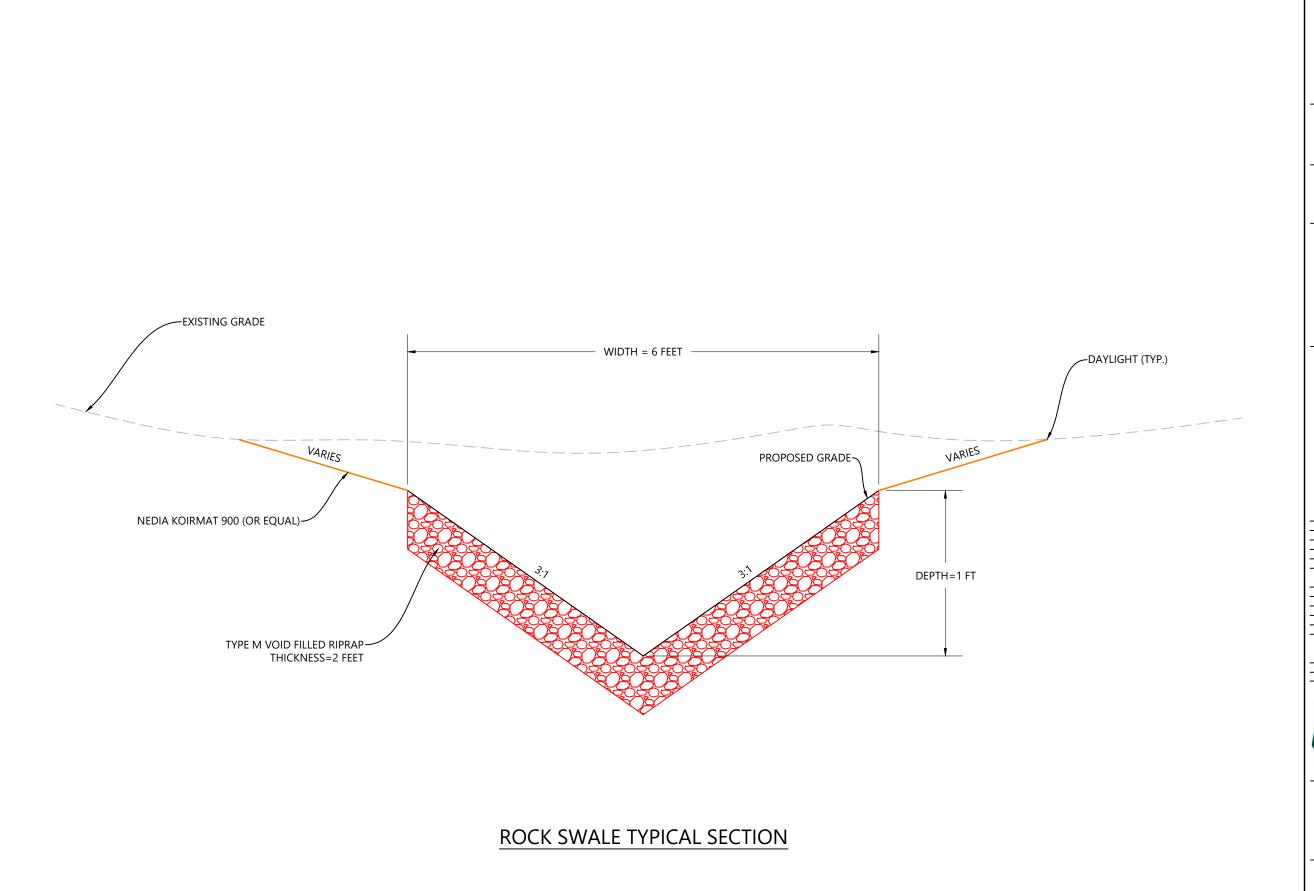



WATERVATION
130 W. Sackett Ave., Unit A
Salida, CO 81201
www.water-vation.com

Copyright Reserved

pypyight Reserver.

The Contractor shall verify and be responsible for all dimensions. DO NOT scale the drawing - any errors or omissions shall be reported to Water-Vation without delay.

The Copyrights to all designs and drawings are the property of Water-Vation. Reproduction or use for any purpose other than that authorized by Water-Vation is forbidden.

Sub-Consultants

Horizontal Scale & Orientation

Dwn. Chkd. Dsgn. YY.MM.DD



Client/Project

TOWN OF GRAND LAKE STORMWATER MANAGEMENT PLAN


GRAND LAKE, CO

Project Milestone

DETAIL_ROCK SWALE TYPICAL SECTION

2023007041 NTS

Sheet **64** of **68**

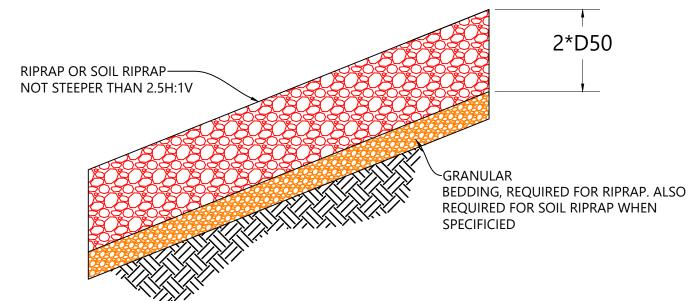

RIPRAP DESIGNATION	% SMALLER THAN GIVEN SIZE BY WEIGHT	INTERMEDIATE ROCK DIMENSION (INCHES)	D ₅₀ * (INCHES)
TYPE VL	70 - 100 50 - 70 35 - 50 2 - 10	12 9 6 2	6
TYPE L	70 - 100 50 - 70 35 - 50 2 - 10	15 12 9 3	9
TYPE M	70 - 100 50 - 70 35 - 50 2 - 10	21 18 12 4	12
ТҮРЕ Н	70 - 100 50 - 70 35 - 50 2 - 10	30 24 18 6	18
*D ₅₀ = MEAN ROCK SIZE	1		

RIPRAP AND SOIL RIPRAP PLACEMENT AND GRADATION

NOTES:

- 1. ELEVATION TOLERANCES FOR THE SOIL RIPRAP SHALL BE 0.10 FEET. THICKNESS OF SOIL RIPRAP SHALL BE NO LESS THAN THICKNESS SHOWN AND NO MORE THAN 2-INCHES GREATER THAN THE THICKNESS SHOWN.
- 2. WHERE "SOIL RIPRAP" IS DESIGNATED ON THE CONTRACT DRAWINGS, RIPRAP VOIDS ARE TO BE FILLED WITH NATIVE SOIL. THE RIPRAP SHALL BE PRE-MIXED WITH THE NATIVE SOIL AT THE FOLLOWING PROPORTIONS BY VOLUME: 65 PERCENT RIPRAP AND 35 PERCENT SOIL. THE SOIL USED FOR MIXING SHALL BE NATIVE TOPSOIL AND SHALL HAVE A MINIMUM FINES CONTENT OF 15 PERCENT. THE SOIL RIPRAP SHALL BE INSTALLED IN A MANNER THAT RESULTS IN A DENSE, INTERLOCKED LAYER OF RIPRAP WITH RIPRAP VOIDS FILLED COMPLETELY WITH SOIL. SEGREGATION OF MATERIALS SHALL BE AVOIDED AND IN NO CASE SHALL THE COMBINED MATERIAL CONSIST PRIMARILY OF SOIL; THE DENSITY AND INTERLOCKING NATURE OF RIPRAP IN THE MIXED MATERIAL SHALL ESSENTIALLY BE THE SAME AS IF THE RIPRAP WAS PLACED WITHOUT SOIL.
- 3. WHERE SPECIFIED (TYPICALLY AS "BURIED SOIL RIPRAP"), A SURFACE LAYER OF TOPSOIL SHALL BE PLACED OVER THE SOIL RIPRAP ACCORDING TO THE THICKNESS SPECIFIED ON THE CONTRACT DRAWINGS. THE TOPSOIL SURFACE LAYER SHALL BE COMPACTED TO APPROXIMATELY 85% OF MAXIMUM DENSITY AND WITHIN TWO PERCENTAGE POINTS OF OPTIMUM MOISTURE IN ACCORDANCE WITH ASTM D698. TOPSOIL SHALL BE ADDED TO ANY AREAS THAT SETTLE.
- 4. ALL SOIL RIPRAP THAT IS BURIED WITH TOPSOIL SHALL BE REVIEWED AND APPROVED BY THE ENGINEER PRIOR TO ANY TOPSOIL PLACEMENT.



WATERVATION

Copyright Reserved

The Contractor shall verify and be responsible for all dimension NOT scale the drawing - any errors or omissions shall be repor Water/Vation without delay. The Copyrights to all designs and drawings are the property of Water/Vation. Reproduction or use for any purpose other than the contract of the Copyright of

Sub-Consultants

Horizontal Scale & Orientation

		<u>=</u>	
Revision		Ву	Appd. YY.MM.DD
Issued			Appd. YY.MM.DD
File Name:	Dwn.	Chkd.	24.09.12 Dsgn. YY.MM.DD



TOWN OF GRAND LAKE STORMWATER MANAGEMENT PLAN


GRAND LAKE, CO

Project Milestone

DETAIL_VOID FILLED RIPRAP

2023007041 NTS

Sheet 65 of 68

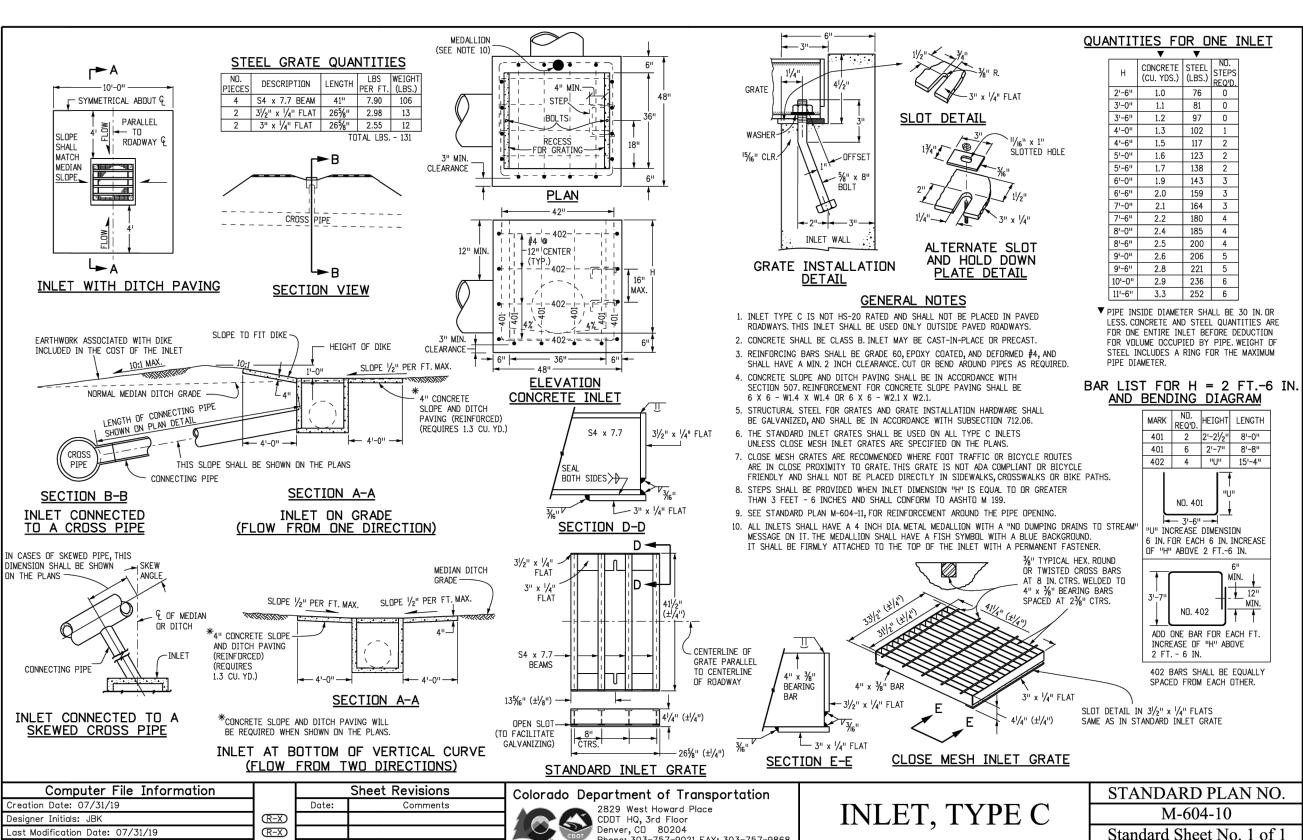

Phone: 303-757-9021 FAX: 303-757-9868

JBK

Issued by the Project Development Branch: July 31, 2019

Project Development Branch



WATERVATION

Copyright Reserved

The Contractor shall verify and be responsible for all dimensions. DO NOT scale the drawing - any errors or omissions shall be reported to Water-Vation without delay. The Copyrights to all designs and drawings are the property of Water-Vation. Reproduction or use for any purpose other than that authorized by Water-Vation is forbidden.

Sub-Consultants

Horizontal Scale & Orientation

Appd. YY.MM.DD Issued File Name
 Dwn.
 Chkd.
 Dsgn.
 24.09.12 YY.MM.DD



TOWN OF GRAND LAKE STORMWATER MANAGEMENT PLAN

GRAND LAKE, CO

Project Milestone

Project Sheet Number:

DETAIL_CDOT TYPE C INLET

2023007041 NTS

Sheet 66 of 68


ORIGINAL SHEET - ANSI B

Detailer Initials: LTA

CAD Ver.: MicroStation V8 Scale: Not to Scale Units: English

(R-X)

 \mathbb{R} - \mathbb{X}

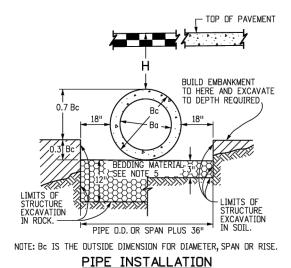


CIR	CULAR (CIR)		VERTICAL ELLIPTICAL (VE)			HORIZONTAL ELLIPTICAL (HE)				
PIPE SIZE= Ba (INSIDE DIA)	WALL THICKNESS	0.3 BC (OUTSIDE DIA)	SPAN	RISE	WALL THICKNESS	0.3 OUTSIDE RISE	SPAN	RISE	WALL THICKNESS	0.3 OUTSIDE RISE
IN.		FT.		IN.		FT.		IN.		FT.
12 15 18	2 2-l/ ₄ 2-l/ ₂	0.40 0.49 0.58					23	14	2-3/4	0.49
21 24 27	2- ³ / ₄ 3 3- ¹ / ₄	0.66 0.75 0.84					30 34	19 22	3-l/ ₄ 3-l/ ₂	0.66 0.73
30 33 36	3-1/ ₂ 3-3/ ₄ 4	0.92 1.01 1.10	29	45	4-1/2	1.35	38 45	24 29	3-¾ 4-1/ ₂	0.79 0.95
42 48	4-l/ ₂ 5	1.28 1.45	34 38	53 60	5 5-1/ ₂	1.58 1.78	53 60	34 38	5 5-1/ ₂	1.10 1.23
54 60 66	5-l/ ₂ 6 6-l/ ₂	1.62 1.80 1.97	43 48 53	68 76 83	6 6-1/ ₂ 7	2.00 2.23 2.43	68 76 83	43 48 53	6 6-1/ ₂ 7	1.38 1.53 1.68
72 78 84	7 7-l/ ₂ 8	2.15 2.32 2.50	58 63 68	91 98 106	7- ¹ / ₂ 8 8- ¹ / ₂	2.65 2.85 3.08	91 98 106	58 63 68	7-l/ ₂ 8 8-l/ ₂	1.83 1.98 2.13
90 96	8-l/ ₂ 9	2.68 2.85	72 77	113 121	9 9-l/ ₂	3.28 3.50	113 121	72 77	9 9-l/ ₂	2.25 2.40
102 108	9-l/ ₂ 10	3.02 3.20	82 87	128 136	9-¾ 10	3.69 3.90	128 136	82 87	9-¾ 10	2.54 2.68

△ ALSO EQUIVALENT ROUND DIMENSION FOR ELLIPTICAL PIPE.

DIMENSIONS FOR REINFORCED CONCRETE PIPE

(FOR INFORMATION ONLY)

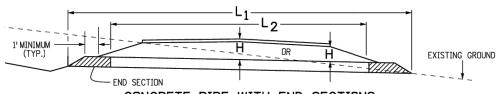


CONCRETE PIPE WITH END SECTIONS

NOTE: USE THE $oldsymbol{\mathsf{H}}$ THAT IS GREATER FOR MAXIMUM ALLOWABLE FILL HEIGHT.

H = HEIGHT OF FILL OVER TOP OF PIPE, INCLUDING PAVEMENT THICKNESS.


L1 = LENGTH OF PIPE TO BE MEASURED WHEN PLACED IN ACCORDANCE WITH SECTION 624.

 L_2 = LENGTH OF PIPE TO BE MEASURED WHEN PLACED IN ACCORDANCE WITH SECTION 603.

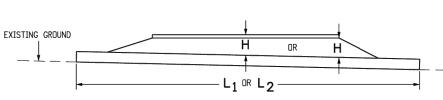

CONCRETE PIPE WITHOUT END SECTIONS

NOTE: USE THE $oldsymbol{\mathsf{H}}$ THAT IS GREATER FOR MAXIMUM ALLOWABLE FILL HEIGHT

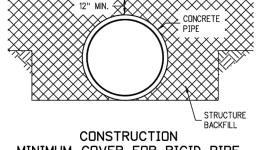

				BACKFILL
	CONSTR	RUCTI	ON	
MINIMUM	COVER	FOR	RIGID	PIPE

		HEIGHT OF FILL	OVER TOP OF P	IPE , H (FEET)	
		CLASS OF PIPE	(0.01 IN. C	RACK D-LOAD)	
TYPE OF PIPE	CLASS CIR II	CLASS CIR III	CLASS CIR IV	CLASS CIR V	
	CLASS VE II	CLASS VE III	CLASS VE IV	CLASS VE V	CLASS VE VI
	CLASS HE II	CLASS HE III	CLASS HE IV		
	1000 D	1350 D	2000 D	3000 D	4000 D
CIRCULAR (CIR)	1 TO 18	1 TO 25	± 25 TO 37	± 37 TO 45	
VERTICAL ELLIPTICAL (VE)	1 TO 18	1 TO 25	± 25 TO 37	± 37 TO 45	± 45 TO 62
HORIZONTAL ELLIPTICAL (HE)	1 TO 18	1 TO 25	± 25 TO 37		

GENERAL NOTES

1. FILL HEIGHTS GREATER THAN MAXIMUM ALLOWED IN THE HEIGHTS OF FILL TABLE

3. THE HEIGHTS OF FILL OVER TOP OF PIPE ARE BASED ON UNIT WEIGHT OF SOIL AT

5. BEDDING IS CLASS B (MODIFIED) (FROM CONCRETE PIPE DESIGN MANUAL-AMERICAN CONCRETE PIPE ASSOCIATION) WITH SETTLEMENT RATIO R $= 0.0 \, \text{sd}$ (YIELDING BED).

BEDDING MATERIAL FOR RIGID PIPE IN SOIL SHALL BE 3 IN LOOSE THICKNESS STRUCTURE BACKFILL CLASS 2. BEDDING MATERIAL FOR RIGID PIPE IN ROCK SHALL

6. CHANGES IN DESIGN FACTORS REQUIRE COMPENSATING CHANGES IN PIPE DESIGN. 7. MINIMUM WALL THICKNESS DIMENSIONS ARE BASED ON AASHTO M 170 (WALL B) FOR

8. SPACING FOR MULTIPLE PIPE INSTALLATIONS SHALL CONFORM TO THE DETAILS SHOWN

1. AT THE OPTION OF THE CONTRACTOR, NONREINFORCED CONCRETE PIPE CONFORMING TO AASHTO M 86 MAY BE USED IN LIEU OF REINFORCED CONCRETE PIPE FOR ALL SIZES 36 INCHES IN DIAMETER AND SMALLER, THE NONREINFORCED CONCRETE PIPE SHALL MEET THE SAME D-LOAD TO PRODUCE THE ULTIMATE LOAD UNDER THE THREE-EDGE BEARING METHOD AS SPECIFIED FOR REINFORCED CONCRETE PIPE IN CONFORMANCE WITH AASHTO M 170. THE CONTRACTOR SHALL PROVIDE WRITTEN CERTIFICATION OF CONFORMACE. THE WALL THICKNESS OF THE NONREINFORCED PIPE MAY BE INCREASED

2. ALL REQUIREMENTS FOR REINFORCED CONCRETE PIPE, EXCEPT THOSE REFERRING TO

REINFORCEMENT, SHALL APPLY TO NONREINFORCED CONCRETE PIPE.

9. WHEN A PIPE IS TO BE EXTENDED, THE SAME PIPE MATERIAL AND SIZE AS IN THE

2. PIPE DESIGN IS BASED ON SAFETY FACTOR OF 1.33 ON ULTIMATE STRENGTH.

REINFORCED CONCRETE PIPE

135 LBS, PER CUBIC FT.

ON STANDARD PLAN M-206-1.

ON THIS SHEET REQUIRE SPECIAL DESIGN OF STRUCTURE.

4. PIPE CLASS IS DETERMINED FROM 0.01 IN. CRACK D-LOAD.

BE 12 IN. LOOSE THICKNESS STRUCTURE BACKFILL CLASS 1.

CIRCULAR PIPE, AND AASHTO M 207 FOR ELLIPTICAL PIPE.

NONREINFORCED CONCRETE PIPE

ORIGINAL PIPE INSTALLATION SHALL BE USED.

AS REQUIRED TO MEET D-LOAD REQUIREMENT.

ALLOWABLE RANGE OF HEIGHTS FOR FILL OVER REINFORCED CONCRETE PIPE

(ALL SIZES)

Computer File Information	Sheet Revisions				
Creation Date: 07/31/19		Date:	Comments		
Designer Initials: JBK	(R-X)				
Last Modification Date: 07/31/19	(R-X)				
Detailer Initials: LTA	(R-X)				
CAD Ver.: MicroStation V8 Scale: Not to Scale Units: Englis	(R-X)				

Colorado Department of Transportation

2829 West Howard Place CDDT HQ, 3rd Floor Denver, CO 80204 Phone: 303-757-9021 FAX: 303-757-9868 Project Development Branch

JBK

Issued by the Project Development Branch: July 31, 2019

REINFORCED M-603-2 CONCRETE PIPE Standard Sheet No. 1 of 1

STANDARD PLAN NO.

Project Sheet Number:

WATERVATION

WATERVATION 130 W. Sackett A Salida, CO 81201

Copyright Reserved

pyright, neserveu.

The Contractor shall verify and be responsible for all dimensions. DO NOT scale the drawing - any errors or omissions shall be reported to Water-Vation without delay.

The Copyrights to all designs and drawings are the property of Water-Vation. Reproduction or use for any purpose other than that authorized by Water-Vation is forbidden.

Sub-Consultants

Horizontal Scale & Orientation

Issued

TOWN OF GRAND LAKE STORMWATER MANAGEMENT PLAN

By Appd. YY.MM.DD

 Dwn.
 Chkd.
 Dsgn.
 24.09.12 YY.MM.DD


GRAND LAKE, CO

Project Milestone

DETAIL_CDOT RCP

2023007041 NTS

Sheet 67 of 68

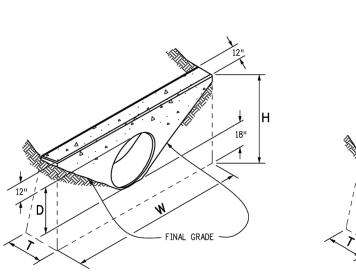

SINGLE PIPE

DOUBLE PIPE

CONCRETE HEADWALL INSTALLATIONS

SEE STANDARD PLAN M-601-10 FOR REINFORCING DETAILS.

DI	·DE		PIPE DIAMETER (AND EQUIVALENT DIAMETER) (IN.)										
PI	PE	1	.8	:	24	,	30		36		42	4	48
TYPE	MATERIAL	SINGLE	DOUBLE	SINGLE	DOUBLE	SINGLE	DOUBLE	SINGLE	DOUBLE	SINGLE	DOUBLE	SINGLE	DOUBLE
	RIGID	1.0	1.3	1.5	2.0	2.0	2.7	2.8	3.6	3.6	4.6	4.6	6.0
CIRCULAR	FLEXIBLE	1.1	1.4	1.6	2.1	2.2	3.0	3.0	4.0	3.9	5.3	5.0	6.8
ELLIPTICAL	DIGID	23 :	14	30 3	c 19	38 >	< 24	45 >	29	53 >	34	60 x	38
ELLIFITOAL	RIGID	0.9	1.2	1.3	1.6	1.7	2.2	2.3	2.9	2.9	3.7	3.5	4.4
ARCH	METAL	22 :	c 13	29 >	(18	36 x	22	43 >	27	50	x 31	58 x	36
ARCH	WILTAL	0.9	1.3	1.4	1.9	1.8	2.4	2.4	3.4	3.2	4.4	3.4	5.0

CONCRETE QUANTITIES FOR ONE CONCRETE HEADWALL (CUBIC YARDS)

THICKNESS	MATERIAL		P)	PE DIAMETER	R (IN.)		
THICKNESS	WATERIAL	18	24	30	36	42	48
4"	CONCRETE	0.4	0.8	1.2			
6"	CONCRETE				2.6	3.6	4.7
18"	RIPRAP	2.0	3.5	5.4	7.8	10.7	13.9

PIPE DUTLET PAVING (CUBIC YARDS)

NOTE: VOLUME OCCUPIED BY PIPE HAS BEEN DEDUCTED.

Computer File Information			Sheet Revisions
Creation Date: 07/31/19		Date:	Comments
Designer Initials: JBK	(R-X)		
Last Modification Date: 07/31/19	R-X		
Detailer Initials: LTA	(R-X)		
CAD Ver.: MicroStation V8 Scale: Not to Scale Units: English	(R-X)		

Colorado Department of Transportation 2829 West Howard Place CDOT HQ, 3rd Floor

Denver, CD 80204 Phone: 303-757-9021 FAX: 303-757-9868 Project Development Branch JBK

D = PIPE DIAMETER (INSIDE)

T = 0.4 H (NEAREST IN.)

B = 1.5 D (30'' MINIMUM)

HEADWALL DIMENSIONS

H = D + 30"

W = 3D + 18"

L = W + B

CIRCULAR

TYPE OF PIPE

HEADWALLS AND PIPE OUTLET PAVING

Issued by the Project Development Branch: July 31, 2019

TYPE OF PIPE

STANDARD PLAN NO. M-601-12


Standard Sheet No. 1 of 1

HEADWALL DIMENSIONS


Project Sheet Number:

GENERAL NOTES

- 1. FOR SIZE AND LOCATION OF PIPES, SEE THE PLANS.
- 2. ALL CONCRETE SHALL BE CLASS B.
- 3. FOOTINGS IN ROCK SHALL BE POURED OUT TO ROCK AND NOT FORMED IN ACCORDANCE WITH SUBSECTION 601.09(b).
- 4. EXPOSED CONCRETE CORNERS SHALL BE CHAMFERED 3/4 IN.
- 5. HEADWALL SHALL HAVE REINFORCING STEEL INSTALLED IN A PATTERN SIMILAR TO STANDARD PLAN M-601-10.
- 6. THE COST OF REINFORCING STEEL SHALL BE INCLUDED IN THE WORK UNLESS THE STEEL QUANTITIES ARE LISTED IN THE PLANS AND ARE PAID FOR SEPARATELY.

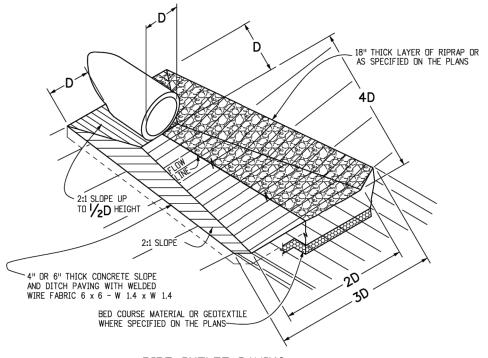

PIPE OUTLET PAVING MAY BE USED WITH MULTIPLE PIPES.

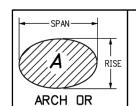

D = EQUIVALENT CIRCULAR DIAMETER (INSIDE)

H = RISE + 30" W = 3D + 18"

T = 0.4 H (NEAREST IN.) B = 1.5 D (30'' MINIMUM)

ELLIPTICAL L = W + B

TOWN OF GRAND LAKE STORMWATER MANAGEMENT PLAN

GRAND LAKE, CO

Project Milestone

DETAIL_CDOT END SECTION

2023007041 NTS

Sheet 68 of 68

File Name:

Dwn. Chkd. Dsgn. YY.MM.DD

By Appd. YY.MM.DD

WATERVATION

130 W. Sackett Av Salida, CO 81201

Lyyright Reserveu.

The Contractor shall verify and be responsible for all dimensions. DO NOT scale the drawing - any errors or omissions shall be reported to Water-Vation without delay.

The Copyrights to all designs and drawings are the property of Water-Vation. Reproduction or use for any purpose other than that authorized by Water-Vation is forbidden.

WATERVATION

Copyright Reserved

Sub-Consultants

Horizontal Scale & Orientation