

GENERAL NOTES

ALL PLANS, DESIGNS AND CONCEPTS SHOWN IN THESE DRAWINGS ARE THE EXCLUSIVE PROPERTY OF MUNN ARCHITECTURE, AIA. LLC AND SHALL NOT BE USED, DISCLOSED, OR REPRODUCED FOR ANY PURPOSE WHATSOFER WITHOUT THE ARCHITECTS WRITER

2) CODES:
HIS ROJECT IS GOVERNED BY THE LOCALLY ENFORCED BUILDING CODES AS ADOPTED BY THE
AUTHORITY HAVING JURISDICTION (AHI), CODE COMPLIANCES MANIBORDEY, THE BRAWNINGS AND
OTHERWISE. HIS GREEN ACCHINACTOR AND THE SUBCONTROLOGIS SANLE BESCALED, SHEET ENSATISTING ALL APPLICABLE CODES AND OBTAINING ALL PREMIS AND REQUIRED APPROVALS.
BUILDING AREAS, AS SHOWN FOR CODE PROPOSES CHAY LOS BALLE BESCALELIZATION FOR MY

3) FIELD VERIFICATION:

VERIEV AT LOUMENSIONS, CONDITIONS, AND UTILITY LOCATIONS ON THE JOB SITE PRIOR TO BEGINNING

VERIEV AT LOUMENSIONS, CONDITIONS, AND UTILITY LOCATIONS ON THE JOB SITE PRIOR TO BEGINNING

OF THE LOCATION OF THE LOCAT ANY WORK OR ORDERING ANY MATERIALS. NOTIFY ARCHITECT OF ANY CONFLICTS OR DISCREPANCIES IN THE DRAWINGS IMMEDIATELY.

IS: INSIONS ALWAYS TAKE PRECEDENCE OVER SCALED DIMENSIONS, DO NOT SCALE WHITE DIRECTOR ALL DIMENSIONS SHOULD RECEIVE OVER 2.6. ALL DIMENSIONS, OF ON SCALE
DIMENSIONS AND STATE OF THE DIMENSIONS SHOULD RECEIVE OF THE DIMENSIONS AND NOTIFICATE
ARCHITECT OF ANY CONFIGURE OF THE DIMENSIONS ARE TO THE FRANKING MATERIAL OF THE PROBLEMS OF THE DIMENSIONS ARE TO THE FACE OF THE FACE

D) DISCREPANCIES: THE OWNER HAS REQUESTED THE ARCHITECT TO PROVIDE LIMITED ARCHITECTURAL AND ENGINEERING THE PRINCE THE RECORD OF THE ACCURATE OF THE VOICE UNITED THE ACCURATE OF THE CONTRICTION OFT THE CONTRICTION OF THE CONTRICTION OFT THE CONTRICTION OF THE CONTRICTION OFT THE

AS DUTY OF COOPERATION.

RELAKE OF HEEF HAS CONTEMPLATES FURTHER COOPERATION BETWEEN THE OWNER AND/OR OWNERS REPRESENTATIVE, HIS ON HER CONTRACTOR, AND THE ACCHIECT, DESIGN AND CONSTRUCTION ARE COMPLEX, ALTHOUGH THE REACHIECT, DESIGN AND CONSTRUCTION ARE COMPLEX ALTHOUGH THE REACHIECT, OWN IS CONSTRUCTION HAVE PREFERED THE SERVICES WITH DUE CASE AND DULGSACE, THEY CANNOT GUARANTEE PREFICION.
COMMUNICATION SIMPRETICE, AND EYER CONTRINSECTOR CONNOT BE ARTICIPATED.

IMMEDIATE YO THE ARCHITECT, FAULES TO NOTIFY THE ARCHITECT COMPOUNDS

MINISTRUCTION AND INCREASES CONSTRUCTION COSTS, AFAILURE TO COOPERATE BY A SIMPLE NOTICE TO THE ARCHITECT SHALL RELEVE THE ARCHITECT FOR RESPONSIBILITY FOR ALL CONFIGURATIONS.

7) CHANGES TO WORK:
ANY TIEND DESCRIBED REPRETIVATE MY ACT PROJECT BUDGET OR THE SHALL BE REQUISITED FROM THE
CONTRACTOR WAS WRITERN CHANGE ORDER REQUEST PROOF TO SUCH WORK. PERFORMANCE OF
ACROMYREDAMEN AND WRITERN CHANGE ORDER REQUEST PROOF TO SUCH WORK. PERFORMANCE OF
ACROMYREDAMENT OF NO BUGGASET IN CONTRACT SUM OR TIME CHANGES FROM THE FRANS OR
SPECIFICATIONS MAD WRITHOUT THE CONSERT OF THE RECHITECT ARE BURNIFFRIEDE AND SHALL
RELEVE THE ACRITICATOR PROPOSIBILITY FOR ANY AND ALL CONSEQUENCES RESULTING FROM SUCH
CHANGES.

8) WORKMANSHIP: ITIS THE INITEM AND MEANING OF THESE DRAWINGS THAT THE CONTRACTOR AND EACH SUBCONTRACTOR PROVIDE ALL LABOR, MATERIALS, TRANSPORTATION, SUPPLIES, EQUIPMENT, ETC. TO OBTAIN A COMPLETE JOB WITHIN THE RECOGNIZED STANDARDS OF THE INDUSTRY.

9) SUBSTITUTIONS: SUBSTITUTION OF "EQUAL" PRODUCTS WILL BE ACCEPTABLE WITH THE ARCHITECTS WRITTEN APPROVAL. 10) CONSTRUCTION SAFETY:
THESE DRAWINGS DO NOT INCLUDE THE NECESSARY COMPONENTS FOR CONSTRUCTION SAFETY. THE

HISSE DRAWINGS DO NOT INCLUDE HE RECESSARY COMPONENTS FOR CONSTRUCTION SA GENERAL CONTRACTOR SHALL PROVIDE FOR THE SAFETY, CARE OF UTILITIES AND ADJACEN PROPERTIES DURING CONSTRUCTION AND SHALL COMPLY WITH STATE AND FEDERAL SAFETY REGULATION.

11] EXCAVATION PROCEDURES:
UPON COMPLETION OF ANY EXCAVATION, THE OWNER SHALL RETAIN A SOILS ENGINEER TO INSPECT
THE SUBSURFACE CONDITIONS IN ORDER TO DETERMINE THE ADEQUACY OF FOUNDATION DESIGN.
CONTRACTION SHALL NOT POUR ANY CONCRETE UNITL APPROVAL IS OBTAINED FROM SOILS ENGINEER.

12) RED CUTTING OF STRUCTURAL MEMBERS:
THE GENERAL CONTRACTOR AND THE SUBCONTRACTORS SHALL REID COORDINATE AND OSTAIN
THE GENERAL CONTRACTOR AND THE SUBCONTRACTORS SHALL REID COORDINATE AND OSTAIN
THE GENERAL CONTRACTOR AND THE STRUCTURAL BERNERS WHICH MAY AFFECT THE
STRUCTURAL INTEGENT OF THE BUILDING, REFER TO 2009 I.E.C., MANUFACTURES OR SUBPURES
TRISTRUCTURAL AND STRUCTURAL DEMONS FOR ADDITIONAL REQUIREMENT.

13) WEATHER CONDITIONS:

THE OWNER HAS BEEN ADVISED THAT DUE TO HASSH WINTER CONDITIONS, ROOF AND DECK SURFACE
MIGS BE ANMARIAND BESCHMALE FREE OF CEACH SHOWN TO BESURE WINNAM, PROCLEAS WITH
WHITE OF THE OWNER OF THE OWNER FOR THE OWNER OF THE OWNER OWNER OF THE OWNER O

BUILDING AREAS ARE SHOWN FOR CODE PURPOSES ONLY AND SHALL BE RECALCULATED FOR ANY OTHER US:

15) PROJECT STAKING:
THE CONTRACTOR SHALL VERIFY ALL EXISTING GRADES AND STAKE ALL BUILDING CORNESS
AND DRIVEWAY LOCATION FOR OWNER/ARCHITECT AND DESIGN REVIEW BOARD APPROVAL PRIOR TO
BEGINNING ANY SITE CLEARING.

THROUGHOUT CONSTRUCTION. 17) PROJECT GRADES:
THE GENERAL CONTRACTOR SHALL CHECK AND VERIFY ALL GRADES INCLUDING PAVED AREAS SLOPES

PRIOR TO POURING ANY FOUNDATION, SURVEY WORK SHOULD BE VERIFIED IN DETAIL

IF A SEPTIC SYSTEM IS REQUIRED, THE GENERAL CONTRACTOR IS TO BID NEW SEPTIC FIELD AND ALL NECESSARY PLUMBING PER COUNTY REQUIREMENTS AND PER SEPTIC DESIGN BY A SOILS ENGINEER.

SUSTAINABLE CONSTRUCTION PRACTICES

I] ENVIRONMENTALHEALTH
IT IS IN SECRETIVE THREE THAT THE CLIENT SECRIFY A PRODUCT THAT IS SOTH FUNCTIONAL AND
DESCRIBE WITH THE HEALTH AND WELL ESSING OF THE CLIENT IN MIND, TO THIS RIOL, ITTS ASSUMED THAT
MATERIAL SPECIFIED WILL SE, WENEFURE, AND WENEFURE PROSEDE, OF THE HERGET COLUMITY AND OF AN
ENVIRONMENTALLY SOUND NATURE: THIS INCLUDES, BUT IS NOT LUMITED TO, PAINTS AND CARPETS WITH HO
TO LOW VOLARIZE ORGANIC COMPOUND EMISSIONS.

2) RECYCLED MATERIALS & PRODUCTS FALLS & PRODUCTS ARE TO BE USED AS ALTERNATIVES TO ORIGINAL-FULLY OF PARTIALLY RECYCLED MATERIALS & PRODUCTS ARE TO BE USED AS ALTERNATIVES TO ORIGINAL-USE PRODUCTS WHENEVER APPROPRIATE (e.g., LUMBER, PLOCRING, ETC.), IT IS PURPHER EXPECTED THAT THE CONTRACTOR WILL PURCHASE MATERIALS THAT ARE MANUFACTURED AS PHYSICALLY CLOSE TO THE LOCATION OF THE PROJECT AS CAN BE REMONABLY DEPOCHED, WITH THE CONDISERATION OF CARBON

LOSE INSULATION IS USED AS AN ALTERNATIVE TO FIBERGLASS BATT OR FOAM, CONTRACTOR IS TO ADHERE STRICTLY TO MANUFACTURER'S GUIDELINES FOR INSTALLATION AND MOISTURE CONTROL. R-VALUES MUST EQUAL OR EXCEED SPECIFIED R-VALUES ON PLANS.

a) GUES AND ADHESIVES
LOW Y.O.C. GUES AND ADHESIVES ARE TO BE USED WHEN THEY MEET PROJECT TOLERANCES. EXAMPLES
INCLUDE DAPP 2000B Heavy-Duty Projects VOC-Compliant Construction Adhesive & PL 4000 Low VOC
Heavy Duty Construction Adhesive.

S) PAINTS AND SOLVENTS
USE LOW-OR ZERO-V.O.C. PAINTS SUCH AS KELLY-MOORE 'ENVIRO-COTE' OR DEVOE 'WONDERPUR
PAINTS. DETERIOR OIL BASED PAINTS ARE TO BE THINNED OR CLEANED WITH TURPENTINE, OR OTHER
NATURAL SOLVENTS. USE NATURAL PAINTS WHERE POSSIBLE, AS THE CLIENT REQUIRES.

6) RESOURCES USE THE LEED ONLINE GUIDELINES FOR SUSTAINABLE OPTIONS.

ADDITIONAL RESOURCES CAN BE FOUND AThttp://www.green-buildings.com/products-certification
the Name Green ic C 700 national green buildings acom/products-certification
The Name Green ic C 700 national green buildings standard can also be used to inform the
sustainable building practices plan outlinds below.

7) THE CONTRACTOR IS TO PRESENT A SUSTAINABLE BUILDING PRACTICES PLAN TO THE ARCHITECT & CLIENT DETAILING THE PROPOSED SUSTAINABLE ALTERNATIVES HE OR SHE INTENDS TO IMPLEMENT.

SPECIAL TESTING

THE CONTRACTOR IS TO PROVIDE LABOR AND MATERIAL FOR THE TESTING,
MANUFACTURE AND INSTALLATION OF THE FOLLOWING AS REQUIRED PER CODE:

A. RADON TESTING AND MITIGATION

MINIMUM DESIGN CRITERIA

1.	ROOF R-VALUE (MIN) - ATTIC AND OTHER:	R-49
2.	ROOF R-VALUE (MIN) – ATTIC AND OTHER: WALL R-VALUE (MIN) – ABOVE GRADE / WOOD FRAMED:	R-13 + R-7 Sci OR R-20 + R-3 Sci
	THE FIRST R-VALUE IS CAVITY INSULATION, THE SECOND VALUE IS CONTINUOUS	
	INSULATION, OUTSIDE THE STUD CAVITY ON THE EXTERIOR OF THE WALL.	
3.	MASS WALL R-VALUE (MIN): FLOOR R-VALUE (MIN) – JOIST / FRAMING:	R-15.2ci
4.		
5.	BASEMENT WALL R-VALUE (MIN):	R-10ci
6.	SLAB-ON-GRADE FLOOR R-VALUE / DEPTH (MIN):	R-15 FOR 24" BELOW
	(ADD R-5 TO THE REQUIRED R-VALUE FOR SLAB EDGE ON HEATED SLABS.	
	INSULATION DEPTH SHALL BE THE DEPTH OF THE FOOTING.)	
7.	CRAWLSPACE WALL R-VALUE (MIN):	R-15/19
	(R-15 CONTINUOUS INSULATED SHEATHING ON INTERIOR OR EXTERIOR	
	OR R-19 CAVITY INSULATION @ INTERIOR OF BASEMENT WALL.)	
8.	FENESTRATION (FIXED) U-FACTOR (MIN.):	0.29
9.	FENESTRATION (OPERABLE) U-FACTOR (MIN.):	0.37
10.	SKYLIGHT MAXIMUM U-FACTOR:	0.50
11.	GLAZED FENESTRATION SHGC (MAX.):	NR
13.	DESIGN SNOW LOAD: WIND LOAD (ULTIMATE):	91 PSF (ROOF)
14.		
15.	SIESMIC DESIGN:	CATEGORY B 3'-0" MIN (TOP OF FOOTING)
	FROST DEPTH:	

ENERGY CODE REQUIREMENTS

1) AIR LEARAGE
THE CONTRACTOR IS RESPONSIBLE FOR PROVIDING A SEALED, WEATHER TIGHT BUILDING THERMAL ENVELOPE AS REQUIRED PER IECC RIQ2.4 WITH CAULKING, GASKES, WEATHERSTRIPPING OR OTHERWISE SEALED WITH AN AIR BARRIER MATERIAL, SUITABLE THIN OR SOLD MATERIAL AT THE FOLLOWING LOCATION

- A. BUILDING THERMAL ENVELOPE AT ALL EXTERIOR BREAKS, JOINTS, SEAMS AND PENETRATIONS.
- A. BUILDING HERMAL ENVELOYE- AT ALL EXTENSIVE BREAKS, JOINIS, SE
 S. CELLING / ATIL
 S. WALLS
 D. WINDOWS, SKYLIGHTS AND DOORS.
 E. RIM JOINTS
 F. ROOKS (INCLUDING ABOVE GARAGE AND CANTILLVERED FLOORS)
 G. CRAWL SPACE WALLS
 N. SHAFTS, PREBRATIONS
- J. NARROW CAVITIES
 K. GARAGE SEPARATION AIR SEALING BETWEEN THE GARAGE AND CONDITIONED SPACES
 L. RECESSED LIGHTING
 M. PLUMBING AND WIRING

- M. PLUMBING AND WIRING
 N. SHOWER 7 JIB ON EXTERIOR WALL
 O. ELECTRICAL / PHONE BOX ON EXTERIOR WALLS
 P. HVAC REGISTER BOOTS
 Q. CONCEALED SPRINKERS
 R. COMMON WALLS BETWEEN UNITS
 S. OTHER SOURCES OF INFILITRATION

APPLICABLE CODES AND STANDARDS

THE TOWN OF GRAND LAKE
GRAND COUNTY BUILDING DEPARTMENT
THREE LAKE WATER AND SANITATION DISTRICT
GRAND LAKE RIGE PROTECTION DISTRICT
GRAND LAKE RIGE PROTECTION DISTRICT
COLORADO DEPARTMENT OF PUBLIC HEALTH AND ENVIRONMENT

APPLICABLE CODES

2015 BC - INTERNATIONAL BUILDING CODE
2015 IECC - INTERNATIONAL BUIEDING CODE
2015 IEC - INTERNATIONAL RECODE
2015 IECC - INTERNATIONAL RECODE
2015 IECC - INTERNATIONAL RECODE
2015 IECC - INTERNATIONAL FUNDA CODE
2017 IECC - INTERNATIONAL FUNDA CODE
2017 IECC - INTERNATIONAL FUNDA CODE

ACCESSIBILITY STANDARDS 2010 ADA STANDARDS FOR ACCESSIBLE DESIGN 2017 ICC / ANSI A117.1 - ACCESSIBLE AND USEABLE BUILDINGS AND FACILITIES

ISSUED X REMOVED FROM DRAWING SET NOTISSUED

R ISSUED FOR REFERENCE ONLY

SHEET INDEX LEGEND:



L1.00 LANDSCAPE PLA ARCHITECTURAL ABBREVIATIONS AND SYMBO 22 WALL, ROOF AND FLOOR TYPE SCHEDULES A1.00 PROJECT SITE PLAN
A1.05 SITE ELEMENTS PLAN & PROJECT IMPAC

\$0.1	TURAL GENERAL NOTES	٦,	•	•
S0.2	STRUCTURAL DETAILS	٠,	•	•
\$1.1	FOUNDATION PLAN BLDG A	٠,	•	•
\$1.2	FOUNDATION PLAN BLDG B	٠,	•	•
\$2.1	LOWER ROOF FRAMING PLAN BLDG A	٠,	•	•
\$2.2	LOWER ROOF FRAMING PLAN BLDG B	٠,	•	•
\$3.1	UPPER ROOF FRAMING PLAN BLDG A	٠,	•	•
\$3.2	UPPER ROOF FRAMING PLAN BLDG B	٠,	•	•
\$4.0	FOUNDATION AND ROOF FRAMING PLAN GAZEBO	٠,	•	•

STRUCTURAL ENGINEER

ASCENT GROUP INC.

JARED VEENSTRA 79050 US HWY 40 WINTER PARK, CO 80482 PH: 970.363.6100

HOUSING RTORY PROPERTIES, I

Munn Architecture, HC 315 FAST AGATE AVENUE GRANBY, CO 80446 970-887-9366 WWW.MUNNARCH.COM

80447 DWAY HOU 0 MOUNTAIN REPERTO ADWAY ST, GRAND LAKE, C #: 1914 ⋖ RO, OFF-BF ROCKY / 450 BROA

ISSUANCE: DATE : 2022-0321

SHEET TITLE: COVER SHEET

SHEET NUMBER : G0.00

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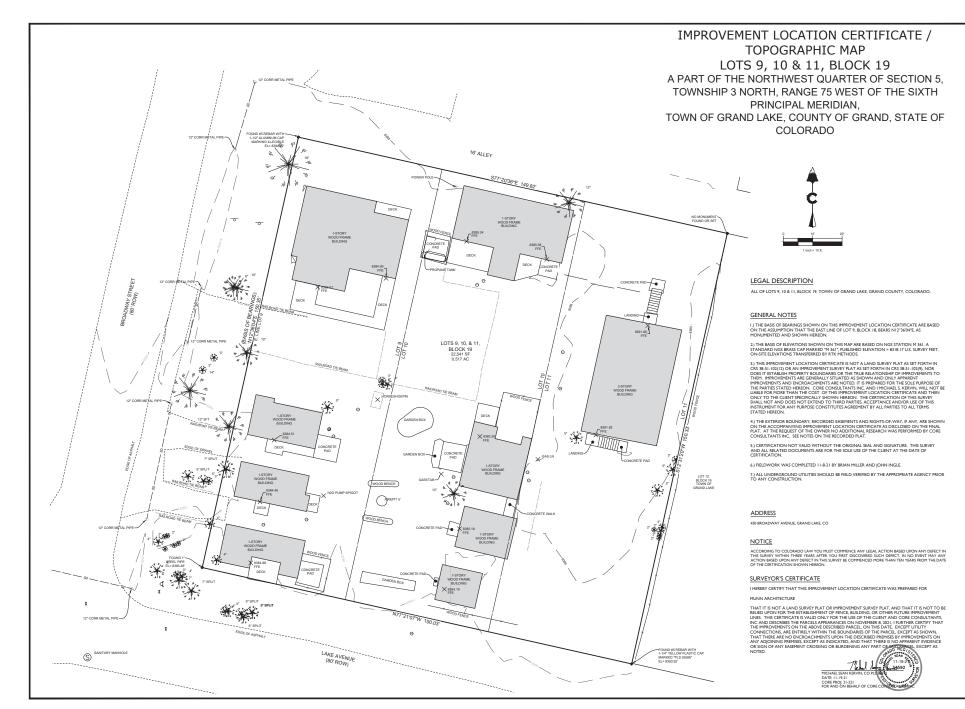
SOILS ENGINEER KUMAR & ASSOCIATES, INC. JAMES PARKER 240 ANNIE ROAD PO DRAWER 1887 SILVERTHORNE, CO 80498 PH: 970.468.1989


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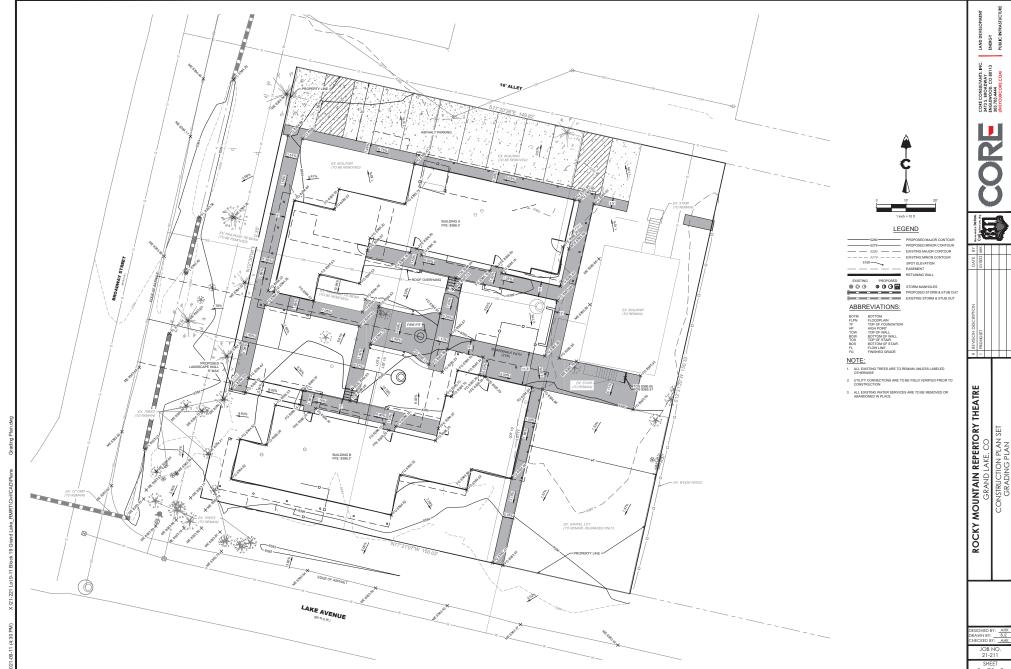
CORE CONSULTANTS ANDREW KIDDER 3473 SOUTH BROADWAY ENGLEWOOD, CO 80113 PH: 303.730.5990

JOB NO. 21-221

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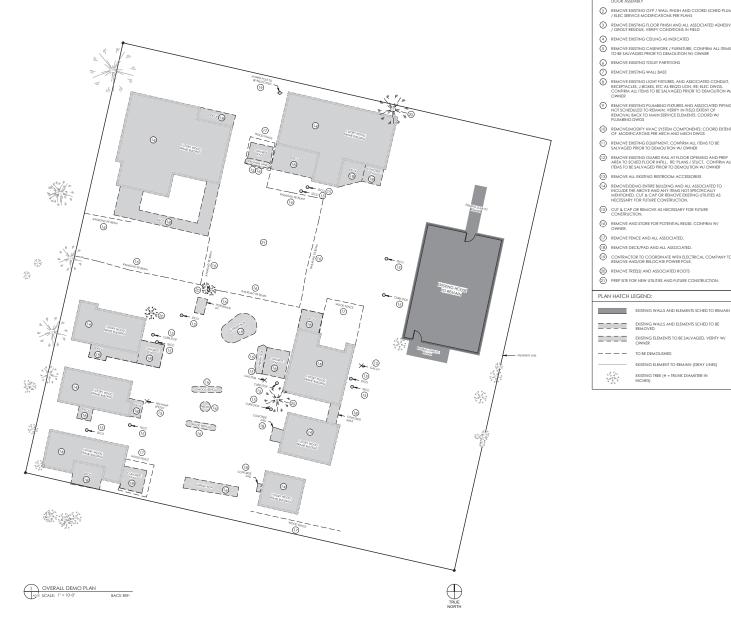




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DEMOLITION NOTES:

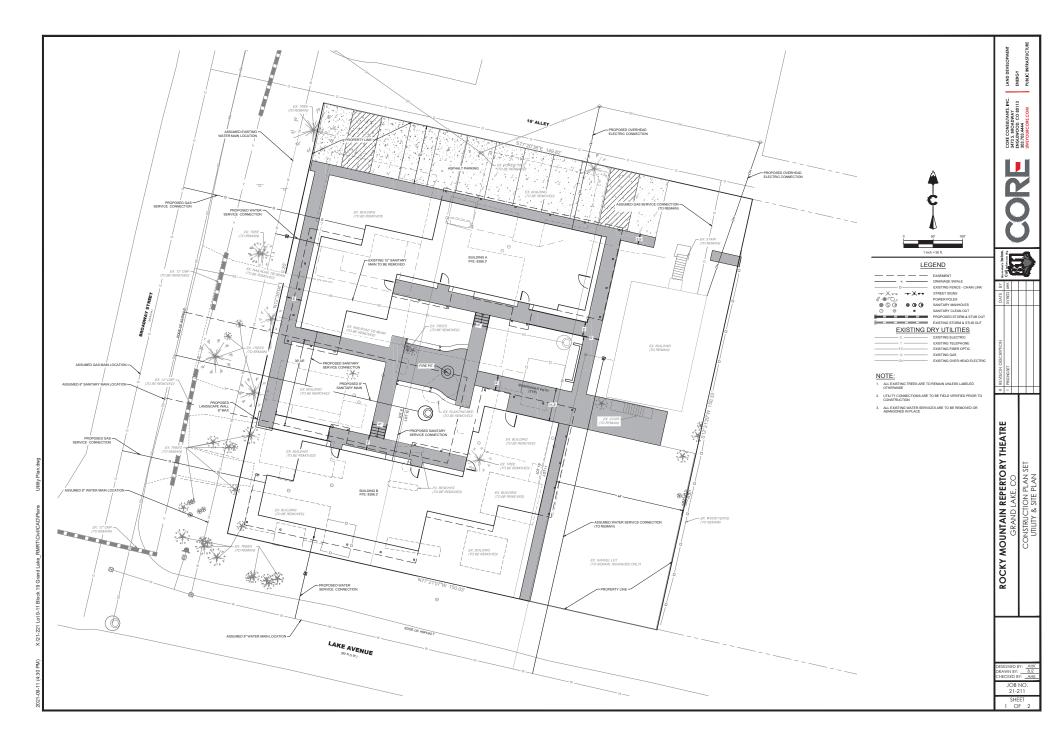- DEMOLITION REQUIRES THE SELECTIVE REMOVAL AND SUBSEQUE REUSE, RECYCLE OR DISPOSAL OF THE EXISTING BUILDING MATERIALS AS INDICATED ON THE DRAWINGS,
- THE DESIGN DOCUMENTS ARE BASED UPON OWNER-PROVIDED DRAWINGS, PHOTOGRAPHS AND RIED MEASUREMENTS. DIMENSIONS SHOWN ON THE DEMOLITION DRAWINGS ARE APPROXIMATE, VERIFY REQUIREMENTS OF PROPOSED CONSTRUCTION PRIOR TO COMMENCING DEMOLITION WORK.
- CONTRACTOR SHALL CONDUCT A PRE-DEMOLITION MEETING PRIOR TO BEGINNING ANY DEMOLITION-RELATED ACTIVITIES W/ PRIOR TO BEGINNING ANY DEMOULION-RELATED ACTIVITIES WINACCHIEF AND OWNER TO VERIFY ALL ITEMS TO BE SALVAGED, RELOCATED, MODIFIED AND/OR REMOVED FROM THE PROJECT, AND PRODUCE WRITTEN DOCUMENTATION OF THE CONDITION OF EACH ITEM PRIOR TO REMOVAL.
- CONTRACTOR SHALL PROVIDE CARE IN THE REMOVAL OF ALL ITEMS LISTED AS OWNER SALVAGE AND COORDINATE TEMPOR TIEMS LISTED AS OWNER, IF INDICATED TO BE LOCATED IN PROJECT INSTALL SALVAGED ITEMS TO PULLY FUNCTIONAL CONDITION PER THE CONTRACT DOCUMENTS.
- THE PREFERRED ORDER OF DEMOLISHED ITEMS:
 A. OWNER REUSE
 B. G.C. TO RECYCLE ITEMS AS MUCH AS POSSIBLE, W/DOCUMENTATION. C. ITEMS GO TO TRASH.
- 6. ITEMS TO BE REUSED ARE TO BE STOCKPILED AND PROTECTED UNTI PUT BACK IN SERVICE.
- THE GENERAL CONTRACTOR SHALL COORDINATE ALL CUTTING AND PATCHING WITH THEIR SUBCONTRACTORS DURING BIDDIN AND DURING CONSTRUCTION, IT IS NOT THE INTENTION OF THESE DOCUMENTS TO ASSIGN TASKS.
- 8. ALL CONTRACTORS SHALL VISIT THE JOB SITE AND COMPLETEL' FAMILIARIZE THEMSELVES WITH EXISTING CONDITIONS PRIOR TO
- PLAN DIMENSIONS ARE TO THE FACE OF THE FRAMING MEMBERS, FACE OF WOOD FURRING OR FACE OF CONCRETE WALLS UNLESS OTHERWISE NOTED.
- CONTRACTOR SHALL SAWCUT AND CORE DRILL AS REQ'D TO ACCOMMODATE PROPOSED MECHANICAL AND ELECTRICAL PENETRATIONS.
- CONTRACTOR SHALL PERFORM DEMOLITION IN AN ORDERLY AND CAREFUL MANNER IN WHICH TO ACCOMMODATE PROPOSED CONSTRUCTION PER THE CONTRACT DOCUMENTS.
- 12. CONTRACTOR SHALL PROMPTLY REPAIR DAMAGES CAUSED TO ADJACENT FACILITIES BY DEMOLITION PERFORMED IN EXCESS OF THAT REQUIRED AT NO COST TO THE OWNER. RETURN STRUCTURES AND SURFACES TO THE CONDITION DISTRING PRIOR TO THE COMMENCEMENT OF DEMOLITION WORK.
- RELOCATION OF PIPES CONDUIT DUCTS AND OTHE RELOCATION OF PIPES, CONDUIT, DUCTS, AND OTHER MECHANICAL OR ELECTRICAL WORK IS SPECIFIED BY THESE RESPECTIVE TRADES. REFER TO MECHANICAL OR ELECTRICAL DEMOLITION REQUIREMENTS. PATCH AREAS AT MECHANICAL ANE ELECTRICAL DEMOLITION AREAS TO MATCH ADJACENT SURFACES
- 14. "CUTTING AND PATCHING" SHALL INCLUDE CUTTING INTO EXISTING CONSTRUCTION TO PROVIDE FOR THE INSTALLATION OR PERFORMANCE OF OTHER WORK AND SUBSEQUENT FITTING AND PATCHING REQUIRED TO RESTORE SURFACES TO THEIR ORIGINAL
- 15. CONTRACTOR SHALL NOT CUT PATCH WORK IN A MANNER THAT WOULD RESULT IN SUBSTANTIAL VISUAL EVIDENCE OF CUT AND PATCH WORK. REMOVE AND REPLACE WORK JUDGED BY HE ARCHITECT TO HAVE BEEN CUT AND PATCHED IN A VISUALLY UNSAITS
- 16. CONTRACTOR SHALL REMOVE HVAC, PLUMBING, ELECTRICAL AND ARCHITECTURAL ELEMENTS INDICATED FOR DEMOLITION IN THEIR ENTIRETY, DO NOT ABANDON IN PLACE UNLESS OTHERWISE NOTED.
- CONTRACTOR SHALL PATCH AND PREPARE EXISTING WALLS SCHEDULED TO REMAIN TO AN ACCEPTABLE SUBSTRATE CONDITION FOR REVISED FINISH LOCATIONS.
- 18. CONTRACTOR SHALL PROTECT EXISTING FINISH WORK, EQUIPMEN AND FIXTURES FROM DAMAGE DUE TO DEMOLITION AND SUBSEQUENT CONSTRUCTION, PROVIDE FLOOR COVERING AS REQ'D TO PROTECT EXISTING FLOOR FINISH TO REMAIN.
- 19 CONTRACTOR SHALL REMOVE AND RECYCLE/DISPOSE OF ALL CONINACION SHALL KEMOVE AND RECYCLE/IZBYGS OF ALL MATERIALS, GUIPMENT, AND DEMOLITION DEBBS AT THE END OF EACH WORKING DAY, UPON COMPLETION OF DEMOLITION WORK, REMOVE FOOLS, EQUIPMENT, AND DEMOLITION DEBBS FROM SITE. REMOVE PROTECTIVE COVERINGS AND LEAVE INTERIOR AREAS BROOM CLEAN.
- 20. IN AREAS SCHEDULED TO RECEIVE A CHANGE IN ROOM FINISHES
 - A. REMOVE EXISTING FLOOR FINISHES, ADHESIVES OR SETTING BED, TO CONCRETE SUBSTRATE. PATCH & REPAIR TO PROVIDE ACCEPTABLE SUBSTRATE TO RECEIVE FLOOR
 - B. REMOVE EXISTING RESILIENT BASE AND ADHESIVE. PAT & REPAIR GYPSUM BOARD & CMU TO PROVIDE AN ACCEPTABLE SURFACE FOR SCHEDULED BASE.
 - C. REMOVE EXISTING WALL FINISHES, ADHESIVES OR
 - BED. REFINISH WALL TO PROVIDE AND ACCEPTABLE SURFACE FOR SCHEDULED WALL FINISH. N ITS' ENTIRETY. PATCH & REPAIR WALLS TO ACCEPT SCHEDULED CEILING FINISH AT HEIGHT INDICATED.
- 21. REMOVE ALL EXISTING SIGNAGE, DISPLAY BOARDS AND OTHER ITEMS ATTACHED TO WALLS. RETAIN FOR OWNER REUSE.
- THE CONTRACTOR MAINTAIN EXISTING FIRE RATINGS AT ALL EXISTING TENANT DEMISING AND CORRIDOR WALLS WHERE APPLICABLE.
- 23. ALL EXISTING SECURITY AND FIRE ALARM / SUPPRESSION SYSTEMS ALL EXISTING SECURITY AND FIRE ALARM / SUPPRESSION SYSTEMS SHALL REMAIN OPERATIONAL DURING DEMOLITION AND CONSTRUCTION UNLESS NOTED OTHERWISE. THE CONTRACTOR IS RESPONSIBLE FOR TEMPORABILY RELOCATING ANY DEVICES IN WALLS OR CEILINGS SCHEDULED TO BE DEMOLISHED AND COORDINATING THE FINAL DEVICE LOCATIONS PER THE CONTRACT DOCUMENTS.
- CONTRACTOR TO WALK THE SITE WITH OWNER REP AND/OR ARCHITECT TO VERIFY DEMOLITION SCOPE.
- ENVIRONMENTAL REPORT TO BE PROVIDED BY OWNER, GC TO ASSUME SOME LEVEL OF ABATEMENT AS PART OF DEMOLITION.





- REMOVE HATCHED EXTENT OF EXISTING WALL, WINDOW OR DOOR ASSEMBLY
- 2 REMOVE EXISTING GYP / WALL FINISH AND COORD SCHED PLUME / ELEC SERVICE MODIFICATIONS PER PLANS
- REMOVE EXISTING FLOOR FINISH AND ALL ASSOCIATED ADHESIVE
 / GROUT RESIDUE, VERIFY CONDITIONS IN FIELD
- (4) REMOVE EXISTING CEILING AS INDICATED
- S REMOVE EXISTING CASEWORK / FURNITURE, CONFIRM ALL ITEMS TO BE SALVAGED PRIOR TO DEMOLITION W/ OWNER
- 6 REMOVE EXISITING TOILET PARTITIONS
- 7 REMOVE EXISTING WALL BASE
- REMOVE EXISTING LIGHT FIXTURES, AND ASSOCIATED CONDUIT, RECEPTACLES, J-BOXES, ETC AS REQ'D UON, RE: ELEC DWGS.
 CONFIRM ALL ITEMS TO BE SALVAGED PRIOR TO DEMOLITION W/
 OWNER
- REMOVE EXISTING PLUMBING FIXTURES AND ASSOCIATED PIPING NOT SCHEDULED TO REMAIN: VERIFY IN FIELD EXTENT OF REMOVAL BACK TO MAIN SERVICE ELEMENTS: COORD W/ PLUMBING DWGS
- (10) REMOVE/MODIFY HVAC SYSTEM COMPONENTS; COORD EXTENT OF MODIFICATIONS PER ARCH AND MECH DWGS
- (1) REMOVE EXISTING EQUIPMENT, CONFIRM ALL ITEMS TO BE SALVAGED PRIOR TO DEMOLITION W/OWNER
- (12) REMOVE EXISTING GUARD RAIL AT FLOOR OPENING AND PREP AREA TO SCHED FLOOR INFILL. RE: PLANS / STUCT. CONFIRM ALL ITEMS TO BE SALVAGED PRIOR TO DEMOLITION W/ OWNER
- (13) REMOVE ALL EXISTING RESTROOM ACCESSORIES
- (ii) REMOVE/DEMO ENTIRE BUILDING AND ALL ASSOCIATED TO INCLUDE THE ABOVE AND ANY ITEMS NOT SPECIFICALLY MENTIONED. CUT & CAP OR REMOVE EXISTING UTILITIES AS NECESSARY FOR FUTURE CONSTRUCTION.
- (15) CUT & CAP OR REMOVE AS NECESSARY FOR FUTURE CONSTRUCTION.
- (16) REMOVE AND STORE FOR POTENTIAL REUSE. CONFIRM W/OWNER.
- (17) REMOVE FENCE AND ALL ASSOCIATED.
- (18) REMOVE DECK/PAD AND ALL ASSOCIATED.
- (19) CONTRACTOR TO COORDINATE WITH ELECTRICAL COMPANY TO REMOVE AND/OR RELOCATE POWER POLE.
- (20) REMOVE TREE(S) AND ASSOCIATED ROOTS
- (21) PREP SITE FOR NEW UTILITIES AND FUTURE CONSTRUCTION.

PLAN HATCH LEGEND:

EXISTING WALLS AND ELEMENTS SCHED TO BE REMOVED EXISTING ELEMENTS TO BE SALVAGED, VERIFY W/

- TO BE DEMOLISHED

INCHES)

EXISTING ELEMENT TO REMAIN (GRAY LINES) EXISTING TREE (# = TRUNK DIAMETER IN

RO, FF-BF 0

315 FAST AGATE AVENUE P.O. BOX 21 GRANBY, CO 80446 970-887-9366 WWW.MUNNARCH.COM

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OPERTIES,

PR

REPERTORY

MOUNTAIN REPER DWAY ST, GRAND LAKE,

ROCKY

ISSUANCE: DATE :

450 BROADWAY ST, PROJECT #: 1914

2022-032

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HOUSING


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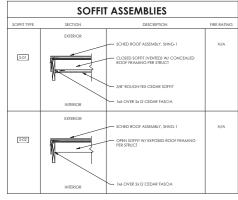
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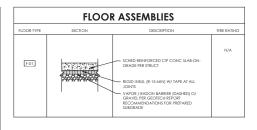
SHEET TITLE: OVERALL DEMO PLAN - LEVEL 01


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NOTE: IF OPEN CELL INSULATION IS USED IN CONJUNCTION W/ INTERIOR VAPOR BARRIER & EXTERIOR RIGID INSULATION W/ PERMEANCE LEVEL < 1.0 PERM, USE SMART BREATHABLE VAPOR BARRIER SYSTEM AT INTERIOR





OFF-BROADWAY HOUSING
ROCKY MOUNTAIN REPERTORY PROPERTIES, INC
450 BROADWAY ST, GRAND LAKE, CO 80447
PROJECT #: 1914

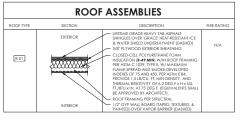ISSUANCE: DATE: 2022-0321

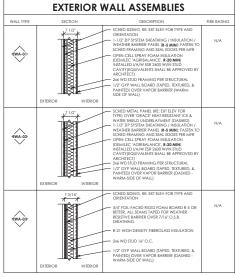
SHEET TITLE : WALL, ROOF AND FLOOR TYPE SCHEDULES

RMRT-RMRP\a\MA_RMRT-RMRP_A22 v5 -


DOOR TYPES LEGEND



WINDOW TYPES LEGEND

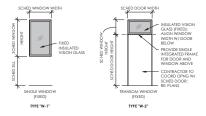

TRIM TYPES LEGEND

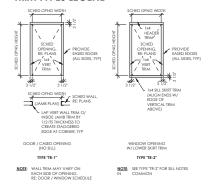

								DOOR	SCHE	DULE						
					DOOR							FRAME	/ TRIM			
DOOR	DOOR						UNDER		HARDWAR				JAMB		HEAD	
NUMBER	TYPE	WIDTH	HEIGHT	THICKNESS	MATERIAL	FINISH	CUT	FIRE RATING	E SET	TYPE	MATERIAL	FINISH	DETAIL	SILL DETAIL	DETAIL	COMMENTS
T.O. LVL 1 G	YPCRETE															
BLDGA-ST	D-3	4" - 0"	7' - 0"	0' - 2"	METAL					TR-1						1,8,9,10 - SUPL'D BY GC, NOT
OR																HERITAGE HOMES
BLDGB-STO R	D-3	4" - 0"	7" - 0"	0' - 2"	METAL					TR-1						1,8,9,10 - SUPL'D BY GC, NOT HERITAGE HOMES

DOOR SCHEDULE COMMENTS / ACCESSORIES LEGEND

- 1. KEYED ENTRY LOCK SET W/ THUMB TURN AT INTERIOR (EXTERIOR GRADE), FINISH TBD
- PRIVACY LOCK SET W/ PIN HOLE AT EXTERIOR AND PUSH-BUTTON AT INTERIOR (BEDROOMS AND BATHROOMS), FINISH TBD
- 3. PASSAGE KNOB / LEVER SET NO LOCK (CLOSETS), FINISH TBD
- 4. SINGLE CYLINDER DEADBOLT LOCK SET W/ THUMB TURN AT INTERIOR (BUMP KEY RESISTANT), FINISH TBD
- 5 PEEP-HOLE DOOR VIEWER JEXTERIOR-GRADEL FINISH TO MATCH DOOR HARDWARE
- BASEBOARD-MOUNTED DOOR STOP (SOLID WITH RUBBER TIP NO SPRINGS), FINISH TO MATCH DOOR HARDWARE
- 8. ALUM THRESHOLD / DOOR TRANSITION (ADA COMPLIANT) W/ BLACK ANODIZED FINISH IN CONTIN BED OF SEALANT
- 10. INSULATED DOOR (EXTERIOR-GRADE) WITH CONTIN WEATHER SEAL / DOOR SWEEP PER MFR

- DOOR NOTE:

 1. ALL EXTENCE DOORS SHALL BE INSULATED AND WEATHER STEPPED PRE DOOR MER.

 2. ALL ROUGH OPENINGS TO BE PROVIDED BY DOOR MER AND FIELD VERFED BY THE CONTRACTOR.

 2. ALL ROUGH OPENINGS TO BE PROVIDED BY DOOR MER AND FIELD VERFED BY THE CONTRACTOR.

 3. DOOR MANUFACTURES SHALL REVIEL EMPRESED GASS WHERE ERGQUIRED BY CODE.

 4. CONTRACTOR SHALL VERFEY DOOR ACCESSORIES AND FINISHES WITH OWNER PRIOR TO ORDERING.

 5. CONTRACTOR SHALL VERFEY DOOR MODE INAMERS! 3 (SEE) (JOANNITIES WITH MANUFACTURES PRIOR TO STARTING CONSTRUCTION AND INSTART WHERE MERGY WHITEN BRIDGLICHORS.

 6. WHERE TRACEOM WINDOWS ARE SCHOOLED ARROVE DOORS, UNITS / FRAMES SHALL BE MULLED TOGETHER PER WINDOW /

- 6. WIESE TRANSON WINSOWS ASK SCHEDULED ABOVE DOORS, UNITS I'RANKES SHALLE RAULED TOCKHER PER WINDOW.

 7. CONTINACTORS WILL REVOLVE DOORS AND FER SHAME STORE ASKELLITE ETRIPE WINDOW TO CONSTRUCTION.

 8. DOOR MANUFACTURES SHALL PROVIDED A BLACK ANDOEDS SPACER AT ALL BISULATED CASA SKRABLES WHIELE

 8. DOOR MANUFACTURES SHALL PROVIDED A BLACK ANDOEDS SPACER AT ALL BISULATED CASA SKRABLES WHIELE

 8. DOOR MANUFACTURES SHALL PROVIDED AS BLACK AND FER SHALL BISULATED CASA SKRABLES WHIELE

 8. WINEES CHEED DOOR COLOGY SHAN HEIST BID. CONTINACTION SHALL PROVIDE SAMMES TO OWNER AND ASCHIECT

 FOR APPROVAL PROOF TO CORDERING.

 10. CONTINACTION SHALL REDU WERF TOMS TOW ALL EXSTRUCT DOORS STEDULED FOR REPLACEMENT FROM TO GROBERING.

							WIND	OW SC	HEDU	LE			
			V	WODOW					TR	!IM			
WINDOW						HARDWAR		EXTERIOR			INTERIOR		
NUMBER	WINDOW TYPE	WIDTH	HEIGHT	SILL HEIGHT	HEAD HEIGHT	E SET	TYPE	MATERIAL	FINISH	TYPE	MATERIAL	FINISH	COMMENTS
T.O. LVL 1 G	YPCRETE												
BLDGA-ST OR	W-2	4" - 0"	1' - 4"	5' - 8"	7' - 0"		TR-2						PROVIDED BY GC, INSTALLED BY GC
BLDGB-STR G	W-2	4" - 0"	1' - 4"	5' - 8"	7' - 0"		TR-2						PROVIDED BY GC, INSTALLED BY GC
T.O. LVL 2 G	YPCRETE												
BLDGA-A1	W-1	4" - 0"	2' - 6"	4' - 6"	7" - 0"		TR-2						PROVIDED BY HERITAGE HOMES, INSTALLED BY GC
BLDGA-A2	W-1	2' - 6"	5' - 0"	2' - 0"	7" - 0"		TR-2						PROVIDED BY HERITAGE HOMES, INSTALLED BY GC
BLDGA-A3	W-1	4" - 0"	2' - 6"	6' - 6"	9' - 0"		TR-2						PROVIDED BY HERITAGE HOMES, INSTALLED BY GC
BLDGA-B1	W-1	2' - 6"	5' - 0"	2' - 0"	7' - 0"		TR-2						PROVIDED BY HERITAGE HOMES, INSTALLED BY GC
BLDGA-B2	W-1	4" - 0"	2' - 6"	6' - 0"	8' - 6"		TR-2						PROVIDED BY HERITAGE HOMES, INSTALLED BY GC
BLDGA-C1	W-1	2' - 6"	5' - 0"	2' - 0"	7' - 0"		TR-2						PROVIDED BY HERITAGE HOMES, INSTALLED BY GC
BLDGA-C2	W-1	4" - 0"	2' - 6"	6' - 0"	8' - 6"		TR-2						PROVIDED BY HERITAGE HOMES, INSTALLED BY GC
BLDGB-A1	W-1	4" - 0"	2' - 6"	4' - 6"	7' - 0"		TR-2						PROVIDED BY HERITAGE HOMES, INSTALLED BY GC
BLDGB-A2	W-1	2' - 6"	5' - 0"	2' - 0"	7" - 0"		TR-2						PROVIDED BY HERITAGE HOMES, INSTALLED BY GC
BLDGB-A3	W-1	4" - 0"	2' - 6"	6' - 6"	9' - 0"		TR-2						PROVIDED BY HERITAGE HOMES, INSTALLED BY GC
BLDGB-B1	W-1	2' - 6"	5' - 0"	2' - 0"	7" - 0"		TR-2						PROVIDED BY HERITAGE HOMES, INSTALLED BY GC
BLDGB-B2	W-1	4' - 0"	2' - 6"	6' - 0"	8' - 6"		TR-2						PROVIDED BY HERITAGE HOMES, INSTALLED BY GC
BLDGB-C1	W-1	2' - 6"	5' - 0"	2' - 0"	7' - 0"		TR-2						PROVIDED BY HERITAGE HOMES, INSTALLED BY GC
BLDGB-C2	W-1	4' - 0"	2' - 6"	6' - 0''	8' - 6"		TR-2						PROVIDED BY HERITAGE HOMES, INSTALLED BY GC

2022-0321

ISSUANCE: DATE:

OFF-BROADWAY HOUSING
ROCKY MOUNTAIN REPERTORY PROPERTIES, INC
450 BROADWAY ST, GRAND LAKE, CO 80447
PROJECT #: 1914

315 EAST AGATE AVENUE P.O. BOX 21 GRANBY, CO 80446 970-887-9366 WWW.MUNNARCH.COM

SHEET TITLE: DOOR & WINDOW SCHEDULES

SHEET NUMBER:

A0.20

MATERIALS AND FINISHES LEGEND

PAINT COLOR SELECTION KEY

A FLAT BELOW 15 B EGGSHELL 15 TO 20 C SEMI-GLOSS 30 TO 65 D GLOSS OVER 65

PAINTING

PT-1 PT-2 INTERIOR COLOR 1, TBD INTERIOR COLOR 2, TBD

(FINAL COLOR SELECTION AND ACCENT WALLS TO BE FIELD VERIFIED WITH OWNER AND ARCHITECT PRIOR TO BEGINNING WORK)

METAL PANEL

MP-1

MFR: RECLA METALS
PRODUCT: 9/16" RCM 50 PANEL SYSTEM W/ EXPOSED FASTENERS PER MFR
FINISH: 22 GA "ANTIQUE SILVER" NATURAL COLOR

SHNG-1

MFR: OWENS CORNING
PRODUCT: TRUDEFINITION ARCHITECTURAL SERIES, DURATION BRAND
LIFETIME-GRADE, HEAVY TAB ASPHALT SHINGLES
FINISH: TEAK

SIDING (EXTERIOR)

SDG-1 MFR: LP PRODUCT: SMARTSIDE LAP SIDING, 5.84" WIDE BOARDS FINISH: CEDAR TEXTURE, "MARSHLAND MOSS" COLOR

SDG-2

MFR: LP PRODUCT: SMARTSIDE LAP SIDING, 7.84" WIDE BOARDS FINISH: CEDAR TEXTURE, "CANYON BROWN" COLOR

SDG-3

MFR: LP PRODUCT: SMARTSIDE VERTICAL SIDING FINISH: SMOOTH FINISH, "CAVERN STEEL" COLOR

WTR-1

MFR: LP PRODUCT: ROUGH SAWN DF#2 2x4 EXTERIOR-GRADE CORNER TRIM FINISH: EXTERIOR GRADE SHERWIN WILLIAMS SW 7027 "HICKORY SMOKE"

WTR-2

MFR: TBD PRODUCT: 1x4 EXTERIOR GRADE WALL TRIM FINISH: TO MATCH WTR-1 CORNER TRIM

WTR-3

MFR: TBD PRODUCT: 1x4 EXTERIOR-GRADE WINDOW & DOOR TRIM (HEADER, SIDES & SILL) FINISH: TO MATCH WTR-1 CORNER TRIM

WTR-4

MFR: TBD
PRODUCT: BUILT-UP FASCIA WITH EXTERIOR-GRADE 1x6 OVER 2x12
FINISH: TO MATCH WTR-1 CORNER TRIM

MFR: TBD PRODUCT: 3/8" ROUCH-TEX CEDAR PLYWOOD SOFFIT FINISH: SHERWIN WILLIAMS EXTERIOR WATERBORNE CLEAR SEALER

WTR-6 MFR: PRODUCT: ROUGH-SAWN 2x12 EXTERIOR-GRADE EXPOSED RAFTERS FINISH: CLEAR STAIN TO MATCH WTR-5 SOFFIT

MFR: TBD
PRODUCT: VARIOUS EXTERIOR-GRADE TIMBER MEMBERS PER STRUCTURAL
FINISH: TO MATCH WTR-1 CORNER TRIM

			ROOM	a finish	SCHEDI	JLE		
ROOM NAME	AREA	FLOOR FINISH	WALL BASE	WAINSCOT	MOULDING	WALL FINISH	CEILING FINISH	COMMENTS
T.O. LVL 1 GYPCRETE								
BLDG A - STORAGE	100 SF	SEALED CONCRETE						
BLDG B - STORAGE	110 SF	SEALED CONCRETE						





315 EAST AGATE AVENUE P.O. BOX 21 GRANBY, CO 80446 970-887-9366 WWW.MUNNARCH.COM



OFF-BROADWAY HOUSING
ROCKY MOUNTAIN REPERTORY PROPERTIES, INC
450 BROADWAY ST, GRAND LAKE, CO 80447
PROJECT #: 1914

ISSUANCE: DATE: 2022-0321

SHEET TITLE :

FINISH SCHEDULE AND MATERIALS LEGEND



OFF-BROADWAY HOUSING
ROCKY MOUNTAIN REPERTORY PROPERTIES, INC
450 BROADWAY ST, GRAND LAKE, CO 80447
PROJECT #: 1914 ISSUANCE :

DATE :

SHEET TITLE : PROJECT SITE PLAN

SHEET NUMBER :

A1.00

PROJECT IMPACT

SITE AREA: 0.516 ACRE

EXISTING BUILDING SQUARE FOOTAGES:

292 sf 1,082 sf 934 sf 494 sf RESIDENTIAL OCCURENCE 3: RESIDENTIAL OCCURENCE 4: RESIDENTIAL OCCURENCE 5: RESIDENTIAL OCCURENCE 6:

RESIDENTIAL OCCURENCE 7: RESIDENTIAL OCCURENCE 8: *JUDY'S HOUSE (TO REMAIN) EXTRA FEATURE OCCURENCE 1: 252 sf 3,152 sf EXTRA FEATURE OCCURENCE 2: EXTRA FEATURE OCCURENCE 3: EXTRA FEATURE OCCURENCE 4: 120 sf 168 sf 1 sf

EXTRA FEATURE OCCURENCE 5: TOTAL: 176 sf 7,385 sf

NEW PROPOSED BUILDING SQUARE FOOTAGES:

4,143 sf 4,145 sf 8,288 sf *DOES NOT INCLUDE BUILDING A: BUILDING B:

JUDY'S HOUSE

EXISTING NUMBER OF BEDS/BEDROOMS:
RESIDENTIAL OCCURENCES 1-7: (19) BEDS

RESIDENTIAL OCCURENCE 8: *JUDY'S HOUSE (TO REMAIN) TOTAL: (12) BEDS/(6) BEDROOMS

(31) BEDS

NEW PROPOSED NUMBER OF BEDS/BEDROOMS:

BUILDING A: BUILDING B:

(12) BEDS/(12) BEDROOMS (12) BEDS/(12) BEDROOMS (24) BEDS/(24) BEDROOMS TOTAL: *DOES NOT INCLUDE JUDY'S HOUSE

PARKING:

REQUIRED OFF-STREET SPACES:
ON-STREET PARKING CREDITS:
TOTAL: (21) TOTAL SPACES

(24.99) CREDITS (-3.99) OFF-STREET SPACES REQUIRED

EXISTING PARKING SPACES: (0) STRIPED/PAINTED SPACES PROVIDED

NEW PROPOSED PARKING SPACES: (14) TOTAL OFF-STREET SPACES
*(2) ADA, (12) STANDARD

ST BROADWAY







OFF-BROADWAY HOUSING
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ISSUANCE: DATE: 2022-0321

SHEET TITLE SITE ELEMENTS PLAN & PROJECT IMPACT

- MODULAR BUILDINGS TO BE PERMITTED AND SUPPLIED BY HERITAGE HOMES, EACH BUILDING IS COMPRISED OF MULTIPLE MODULAR FOXES". UPON DELIVERY MODULAR BOXES WILL BE PU! IN PLACE ON FOUNDATION SYSTEM BY "SET CREW". ONCE SET, CC WILL "STICH" BOXES TO CEPHER. CC IS SESPONBILE FOR MEP




ROCKY MOUNTAIN REPERTORY PROPERTIES, INC 450 BROADWAY ST, GRAND LAKE, CO 80447 PROJECT #: 1914 OFF-BROADWAY HOUSING

ISSUANCE: DATE : 2022-0321

SHEET TITLE: OVERALL FLOOR PLAN - LEVEL 01

SHEET NUMBER :

A3.01

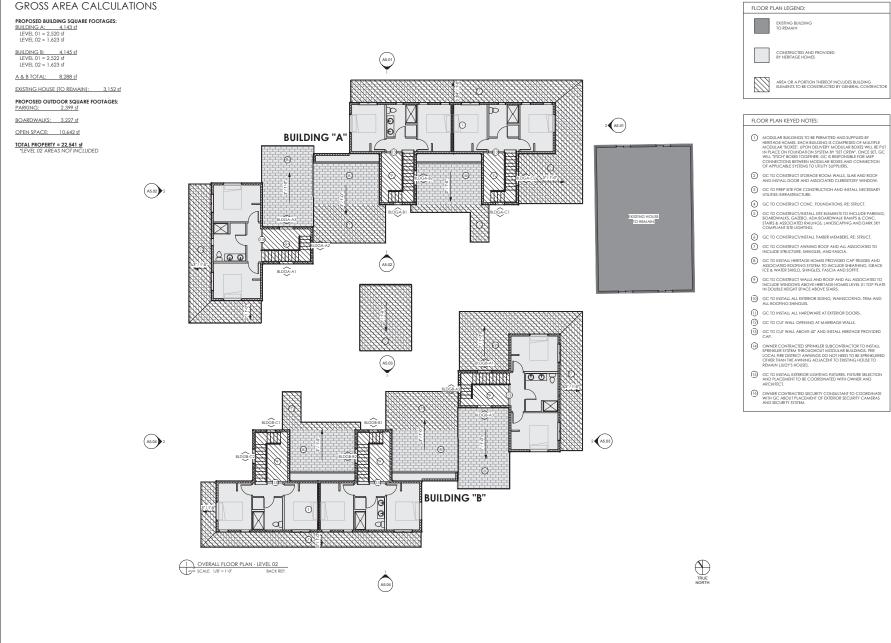

ISSUANCE: DATE : 2022-0321

ROCKY MOUNTAIN REPERTORY PROPERTIES, INC 450 BROADWAY ST, GRAND LAKE, CO 80447 PROJECT #: 1914


OFF-BROADWAY HOUSING

SHEET TITLE: OVERALL FLOOR PLAN - LEVEL 02

TYPICAL ROOF NOTES:

- CONTRACTOR TO PLACE HEAT TAPE WHERE REQUIRED TO PREVENT ICE AND SNOW BUILD-UP, INSTALL PER MANUFACTURER'S INSTRUCTIONS.
- 2. ROOF EAVES SHALL BE GUITERED ONLY WHERE NECESSARY TO PROMOTE A PEDESTRAIN FREINDLY ENVIRONMENT. GUITERS MUSI BE BUILT OF DURABLE MELAL MATERIALS APPROPRIATE TO THE BUILDING DESIGN, AND HEAT-TAPED TO PREVENT ICE BUILDING WHERE REQUIRED, DOWNSFORD SHALL BE 25'S" ANA OCAND DISCHARGE BEYOND THE EXTENT OF THE FOUNDATION BACKFILL.
- ROOF VENTS, IF INSTALLED, SHALL BE SHINGLED TO MATCH THE COLOR OF ROOF. ALL EXPOSED ROOF VENTS AND STACKS SHALL BE PAINTED TO MATCH THE ADJACENT ROOF MATERIAL.
- IT IS THE GENERAL CONTRACTOR'S AND ROOFING CONTRACTOR'S RESPONSIBILITY TO PROVIDE HEATTAPING AND FLASHING TO PREVISE HEAD BUILDING AND CONSEQUENT MIGHTURE HEATTAPING. AND FLASHING TO THE ROOF SYSTEM. THE CONTRACTOR SHALL THEREFORE INSECT THE ROOF DISHING THE WINTER MORNIS AFTER COMPLETION OF CONSTRUCTION TO SHAIRE THAT THERE IS NO DAMAGE HEAUREST DEVINED THE MIDDLE? AND THAT THERE IS NO DAMAGE HEAUREST DEVINED THE MIDDLE? AND THE MORNIS THAT THERE IS NO DAMAGE HEAUREST DEVINED THE MIDDLE? AND THE APPROPRIATE HEAT-TAPING WHERE NECESSARY TO PREVENT FUTURE ICE BUILD-UP OR DAMAGE.
- 5. ALL METAL WORK SHOULD BE A MINIMUM 24 GAUGE
 GALVANEED OR STANLESS STEEL, DO INCH ALUMINUM OR 3 LBS.
 LEAD FOR FARENCED FLANDERS, LESSER GAUGE STEEL
 LEAD FOR FARENCED FLANDERS, LESSER GAUGE STEEL
 BEDGES WITH A STREICH-OUT OF 5 INCH OR LBS. METAL WILL HOT
 BE LISED AC COMPONENTS OF BEF ASSIMED AT INSTRESCHOOKS
 OF THE ROOF AND VEREICAL SURFACES, HORIZONTAL FLANGES
 SHOULD BE A LESST AHICH, WITH
- ASSEMBLY/FLASHING SYSTEMS MUST BE INSTALLED AT ALL ROOF
 TO WALL TRANSITIONS, ROOF PLANE OR DIRECTION CHANGES,
 AND FLATT OF PICHED ROOF INTERSECTIONS. THE PURPOSE IS TO
 REINFORCE, AND PROTECT THESE CRITICAL JUNCTIONS FROM
 DAMAGE RESULTING FROM WATER INTRUSION AND FOOT
 TRAFFIC.

 TRAFFIC.
- 7. IT IS THE ROOFING APPLICATOR'S RESPONSIBILITY TO PURCHASE II IS THE KOUMING APPLICATIONS RESPONSIBILITY TO PURCHASE QUALITY MATERIALS AND APPLY THEM IN A PROFESSIONAL MANNER, ALL ROOFING MATERIALS AND SYSTEMS ARE TO BE APPLIED IN STRICT ACCORDANCE WITH THE REQUIREMENTS OF THE MATERIALS MANUFACTURER AND GOOD ROOFING PRACTICE. THE CONTRACTION MUST ALSO COMPLY WITH ALL REGULATORY REQUIREMENTS, GOVERNMENTAL REQUIREMENTS. AND THE CONTRACT DOCUMENTS.
- THE CONTRACTOR SHALL COORDINATE ANY ROOF PENETRATIONS
 WITH STRUCTURAL PRIOR TO ERAMING.
- MINIMUM ROOF SLOPE TO BE 1/4" PER 11-0" PER IBC CHAPTER 15, TYP, WHERE REQUIRED, CONTRACTOR IS TO PROVIDE GREATER SLOPES PER ROOFING MFR'S WRITTEN INSTRUCTIONS FOR WARRANTY.
- 10. FIELD VERIFY ALL LOCATIONS OF ROOF WALKABLE SURFACES.
- ALL PRE-FINISHED METAL FLASHINGS, COPINGS, ETC. EXPOSED TO VIEW ARE TO BE FINISHED AS NOTED IN EXT ELEVATIONS, VIF W/ ARCHITECT.
- 12. REFER TO A5.21 FOR EXTERIOR PERSPECTIVE VIEWS.
- 13. REFER TO THE REFLECTED CEILING PLANS FOR OVERHANG DIMS, TYP

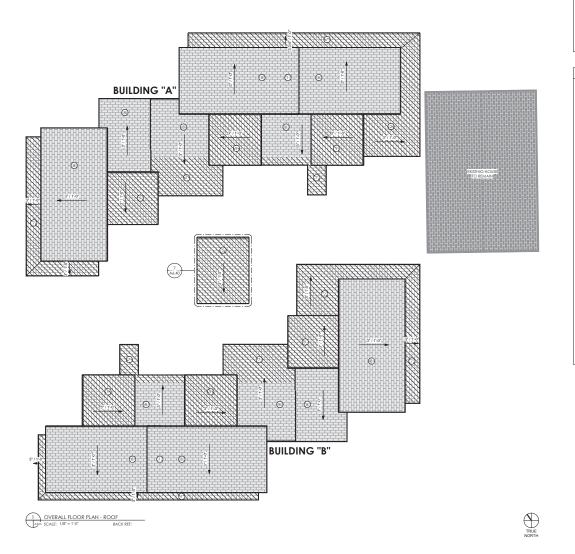









FLOOR PLAN KEYED NOTES:

- MODULAR BUILDINGS TO BE PERMITTED AND SUPPLIED BY HERITAGE HOMES, EACH BUILDING IS COMPRISED OF MULTIPLE MODULAR STOKES; HOWN DELIVERY MODULAR SOXES HILLE BUILT IN PLACE ON FOUNDAINGN SYSTEM BY "SET CREW". ONCE SET, OC WILL STICK! FOR SOST SOCIETIES OF BEPOYNSIBLE FOR MAPP CONNECTIONS SETWEST MODULAR SOXES AND CONNECTION OF APPLICABLE SYSTEMS TO BUILTY SUPPLIES.
- GC TO CONSTRUCT STORAGE ROOM WALLS, SLAB AND ROOF AND INSTALL DOOR AND ASSOCIATED CLERESTORY WINDOW.
- 3 GC TO PREP SITE FOR CONSTRUCTION AND INSTALL NECESSARY UTILITIES INFRASTRUCTURE.
- GC TO CONSTRUCT CONC. FOUNDATIONS, RE: STRUCT.
- (S) GC TO CONSTRUCT/INSTALL SITE ELEMENTS TO INCLUDE PARKING, BOARDWALKS, GAZERO, ADA BOARDWALK RAMPS & CONC. STAIRS & ASSOCIATED RAILINGS, LANDSCAPING AND DARK SKY COMPLIANT SITE LIGHTING.
- 6) GC TO CONSTRUCT/INSTALL TIMBER MEMBERS, RE: STRUCT.
- GC TO CONSTRUCT AWNING ROOF AND ALL ASSOCIATED TO INCLUDE STRUCTURE, SHINGLES, AND FASCIA.
- (B) GC TO INSTALL HERITAGE HOMES PROVIDED CAP TRUSSES AND ASSOCIATED ROOFING SYSTEM TO INCLUDE SHEATHING, GRACE ICE & WATER SHIELD, SHINGLES, FASCIA AND SOFFIT.
- GC TO CONSTRUCT WALLS AND ROOF AND ALL ASSOCIATED TO INCLUDE WINDOWS ABOVE HERITAGE HOMES LEVEL 01 TOP PLATE IN DOUBLE HEIGHT SPACE ABOVE STAIRS.
- (10) GC TO INSTALL ALL EXTERIOR SIDING, WAINSCOTING, TRIM AND ALL ROOFING SHINGLES.
- (1) GC TO INSTALL ALL HARDWARE AT EXTERIOR DOORS.
- (12) GC TO CUT WALL OPENING AT MARRIAGE WALLS.
- (13) GC TO CUT WALL ABOVE 42" AND INSTALL HERITAGE PROVIDED CAP.
- (4) OWNER CONTRACTED SPRINKLER SUBCONTRACTOR TO INSTALL SPRINKLER SYSTEM THROUGHOUT MODULAR BUILDINGS, PER LOCAL REP DISTRICT AWNINGS DO NOT SEED TO BE SPRINKLERD OTHER THAN THE AWNING ADJACENT TO EXISTING HOUSE TO REMAN LUDY'S MOUSE;
- (15) GC TO INSTALL EXTERIOR LIGHTING FIXTURES. FIXTURE SELECTION AND PLACEMENT TO BE COORDINATED WITH OWNER AND ARCHITECT.
- (16) OWNER CONTRACTED SECURITY CONSULTANT TO COORDINATE WITH GC ABOUT PLACEMENT OF EXTERIOR SECURITY CAMERAS AND SECURITY SYSTEM.





OFF-BROADWAY HOUSING
ROCKY MOUNTAIN REPERTORY PROPERTIES, INC
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SHEET TITLE: OVERALL ROOF PLAN



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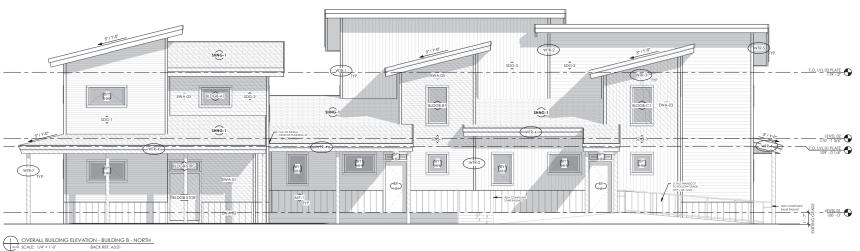
SHEET TITLE : OVERALL EXTERIOR ELEVATIONS -BUILDING "A"


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ISSUANCE : DATE:

SHEET TITLE : OVERALL EXTERIOR ELEVATIONS -BUILDING "A"







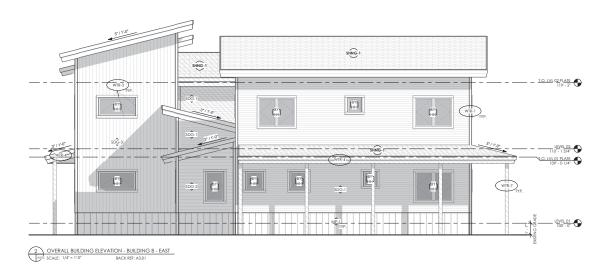



ISSUANCE : DATE:

SHEET TITLE : OVERALL EXTERIOR ELEVATIONS -BUILDING "B"



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ISSUANCE : DATE:

SHEET TITLE : OVERALL EXTERIOR ELEVATIONS -BUILDING "B"

NOTE:
3D PERSPECTIVES ARE FOR REFERENCE
ONLY. SEE ARCH DRAWINGS FOR MORE
DETAILED INFORMATION.











*O.Co. Reference of the Co. T.


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ISSUANCE: DATE:
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SET
TOGL 2022-0321
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SHEET TITLE :


OVERALL EXTERIOR
PERSPECTIVES


A5.21




4 SECTION - BOARDWALK LONGITUDINAL

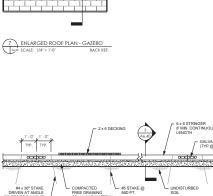
A-E SCALE: 1/2" = 1'-0" BACK REF:

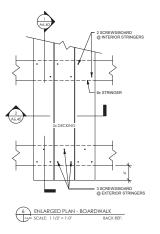

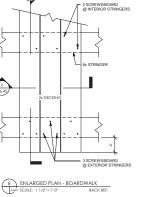

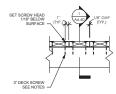



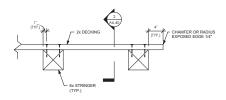



BOARWALK GENERAL NOTES:

- DECKING SHALL BE 2x 6 545 KIIN DRIED CONSTRUCTION COMMON REDWOOD. BOARDS TO PRE-STAINED FACES EDGES AND ENDS WITH TWO COLTS OF SEAL ONCE MULTI SEALANT WATERPROOFER OR APPROVED EQUAL. TRIMMED ENDS AND RIPPED EDGES TO BE RE-TREATED.
- WHERE RIPPED BOARDS ARE REQUIRED, THE RIPPED EDGE OF THE BOARD SHALL BE RADIUS BY MEANS OF SANDING OR ROUTING.
- DECK BOARDS SHALL BE INSTALLED SQUARE TO STRINGERS WITH A UNIFORM GAP BETWEEN BOARDS AND A MAXIMUM BOARD TO BOARD VERTICAL DISPLACEMENT OF 1/16 INCH.
- 5. DECK BOARDS TO BE FASTENED AS SHOWN USING SIMPSON STRONG DRIVE SDWS22300DB STRUCTURAL WOOD SCREWS DRIVEN TO 1/16 INCH BEOW THE BOARD SURFACE, PRE-DRILL FOR SCREWS INSTALLED AT BOARD ENDS TO PREVENT SPLITTING
- SCREWS SHALL BE INSTALLED TO UNIFORM LINES AT THE LOCATIONS SHOWN.
- REFER TO CHAPTER 11: MUNICIPAL PROPERTY REGULATIONS ARTICLE 4: BOARDWALKS, SIDEWALKS AND COMMUNITY GREENWAYS SECTION 11-4-6 FOR ADDITIONAL REQUIREMENTS.






OFF-BROADWAY HOUSING
ROCKY MOUNTAIN REPERTORY PROPERTIES, INC
450 BROADWAY ST, GRAND LAKE, CO 80447
PROJECT #: 1914

ISSUANCE: DATE: 2022-0321

SHEET TITLE : SITE DETAILS

SHEET NUMBER:

A6.40

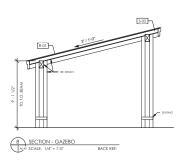




6x STRINGER

3 SECTION - BOARDWALK TRANSVERSE

ALC SCALE: 1/2" = 1"-0" BACK REF:

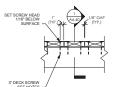

BACK REF



5 PLAN - BOARDWALK ALM SCALE: 1/2' = 1'-0'

1.0 GOVERNING BUILDING CODE: 2015 INTERNATIONAL BUILDING CODE C. WIND: a. ULTIMATE WIND SPEED: I I 5 MPH - DYPOSURE 19' (3 SECOND GUST) b. RISK CATECORY: II c. INTERNAL PRESSURE: +0.18, -0.18 (ENCLOSED BUILDING) D. SEISMIC: a. DESIGN CATEGORY: B b. RISK CATEGORY: II c. EARTHOUASE IMPORTANCE PACTOR: I.O d. SOIL SITE CLASS: D 3.0 GENERAL A. THE STRUCTURAL DOCUMENTS ELUSTRATE THE COMPLETED STRUCTURE WITH ELEMENTS IN THEIR FINAL POSITIONS, PROTERLY SUPPOSITED AND BRACED. THE CONTRACTOR SEEPONSBUE FOR ADDICULATE BRACING AND SHORING A REQUIRED DURING CONSTRUCTION TO WITHSTAND ALL LOUGH, STROCKINES OF MATERIALS AND EQUIPMENT. SUCH BRACING SHALL BE LET! IN PLACE AS LONG AS REQUIRED UNTIL THE CONSTRUCTION OF THE STRUCTURE IS COMPLETED. B. GENERAL CONTRACTOR IS RESPONSIBLE FOR PROTECTION OF PERSONS AND PROPERTY EITHER ON OR ADJACENT TO THE PROJECT AND SHALL PROTECT SAME AGAINST INJURY, DAMAGE OR LOSS DURING CONSTRUCTION.

- D. THE CONTRACTOR SHALL INFORM ARCHITECT AND ENGINEER CLEARLY IN WRITING AND PROVIDE DOCUMENTATION FOR THE REVIEW OF ANY SUBSTITUTIONS OR DEVIATIONS OF REQUIREMENTS OF THE CONTRACT DOCUMENTS. E. THESE PLANS HAVE BEEN ENGINEERED FOR CONSTRUCTION AT ONE SPECIFIC BUILDING SITE. BUILDER ASSUMES ALL RESPONSIBILITY FOR USE OF THESE PLANS AT ANY OTHER LOCATION.
- P. DO NOT SCALE DRAWINGS. WRITTEN DIMENSIONS SHALL TACE PRECEDENCE. PLANS AND DETAILS ARE TO SCALE UNLESS NOTICE. WHILE DRAWINGS SCALE IS DELEVED TO BE RELIABLE. THE ACCURACY AND COMPRETENESS IS NOT CURRANITED BY THE EMPIRIES. CORRESSION THE REMOTE CORRESSION TO REMOTE ARE PROPERLY REPRESENTED WITH PREPARATION OF THE ARCHITECTURAL AND STRUCTURAL PROCESSION OF THE ARCHITECTURAL AND STRUCTURAL PROCESSION OF THE ARCHITECTURAL AND STRUCTURAL DRAWING SCALE AND STRUCTURAL DOCUMENTS BEFORE PROCESSION WITH WORK.
- G. NO STRUCTURAL MEMBERS SHALL BE CUT, NOTCHED OR OTHERWISE PENETRATED UNLESS ALLOWED BY MANUFACTURER, SPECIFICALLY SHOWN ON THESE DOCUMENTS OR APPROVED BY THE ENGINEER IN ADVANCE.
- H. SECTIONS OR DETAILS SHOWN OR NOTED APPLY TO SIMILAR CONDITIONS ELSEWHERE NOT SPECIFICALLY SHOWN OR NOTED.
- THESE CONSTRUCTION DOCUMENTS ARE BASED ON THE WORK BEING COMPLETED IN A WORKMAN LIKE MANNER BY A CONTRACTOR EXPERIENCED WITH SIMILAR CONSTRUCTION.

- 10. EQUIVE A FLUE AT LIVES.
 A THE CRUMANISH HAS BEEN DESIGNED IN ACCORDANCE WITH RECOMMENDATIONS CONTAINED IN THE SOIL REPORT PREVAMED BY KLAWAR AND ASSOCIATES, PROJECT NO. 21 4–275 DATED DECEMBER, 15, 2021.
 B SAND SOIL REPORT IS FREEDY MADIC A PART OF THESE DOCUMENTS AND DICETT WHERE OTHERWISE SPECIFICALLY NOTICE INCIDING. ALL RECOMMENDATIONS AND PRECAUTIONS CONTRIBED AND THAT REPORT SHALL BE ADDRIEDED TO BY THE
- CORRECTOR.

 C. FORMIOS SHALL BE FOUNDED UPON LINDSHARDO NATURAL SOL OR COMPACTED FLL, TESTED AND APPROVED BY A

 MANAMAM PESSON SOL BEARING PESSARE. 2.500 FT.

 MINIMAM DESIGN SOL BLANDAM OF A SECRETINAL PRISERS DEALER PROST DETTIN

 C. POSITIOS SHALL BE, TANIMAM OF AS SECRETINAL PRISERS. DEALER PROST DETTIN

 C. POSITIOS SHALL BE, TANIMAM OF AS SECRETINAL PRISERS. AN REST CONDITION, LIBRIC ONSITE CANALLAR

 SOLAS AS DECORAL SO PERFIT.

- D. PRIOR TO BACKFILLING, THE CONTRACTOR SHALL BE RESPONSIBLE FOR ADEQUATELY BRACING FOUNDATION WALLS TO RETAIN EARTH ACAINST BACKFILLING PRESSURES UNTIL SUPPORTING ELEMENTS INCLUDING FLOOR SLABS ARE IN PLACE
- E. POUNDATION WALLS AND GRADE BEAMS HAVING EARTH PLACED ON BOTH SIDES SHALL HAVE BOTH SIDES FILLED SIMULTANEOUSLY TO MAINTAIN A COMMON ELEVATION.
- F. DO NOT BACKFILL WITH EXPANSIVE SOILS, VERIFY FILL TYPE WITH SOILS ENGINEER PRIOR TO BACKFILLING.
- G. PROVIDE A CONTINUOUS PERMETER DRAIN SYSTEM PER THE SOILS ENGINEER WITH AN INVERT A MINIMUM OF G' BELOW THE BOTTOM OF THE BASEMENT SUAD. EXTEND THE PERMETER DRAIN TO A SUMP OR TO DAYLIGHT. CO-ORDINATE DESIGN WITH ANY RECOMMENDATIONS CONTAINED IN THE SOIL REPORT.
- DESIGN WITH ANY TAXONIC COMMENDATIONS CONTINUED IN THE SOLUTION WALL POOTING BEARING ELEVATIONS SHALL BE ADJUSTED IN THE FIELD TO ACCOMMODATE PHAL ANTICIPATED PHISHED GRADES AND REQUIRED PROST DEPTHS, NOTICY ENGINEER OF CHANGES IN ELEVATION PROM THAT SHOWN ON POLIUDIATION PLAN.
- I. CENTER ALL POOTINGS UNDER WALLS. COLUMNS OR GRIDLINES UNLESS NOTED OTHERWISE ON DOCUMENTS.
- SLOPE THE EXTERIOR GRADE AWAY FROM THE STRUCTURE.

5.0 CONCRETE AND REINFORCEMENT

- B. CONCRETE SHALL CONFORM TO THE APPLICABLE PROVISIONS OF "SPECIFICATIONS FOR STRUCTURAL CONCRETE FOR BUILDINGS" (ACI 301 LATEST EDITION).
- C. COLOGETE SHALL BE LOSALL, WEDET (145 PCT) WITH STONE AGGEGATE AND DEVELOP A MINIMUM 28-DAY CAMPEISMS STENCTH AS TOLLOISS.

 A TOCHNICS AND FOUNDATION WALLS

 SUBSO-INCARDE

 SOURS DO PSI.
- D. CEMENT SHALL BE TYPE I / II /OR TYPE VI CONFORMING TO ASTMICESO
- E. FLY ASH SHALL CONFORM TO ASTM CG I 8, CLASS C OR F. FLY ASH SHALL NOT EXCEED 20% OF THE TOTAL WEIGHT OF CRAPATITICIES MATERIAL
- F. NO ADMIXTURES CONTAINING CALCIUM CHLORIDE SHALL BE PERMITTED IN ANY CONCRETE
- G. COLD WEATHER CONCRETING: WHEN TEMPERATURES DROP BELOW 40 DEGREES AT ANY TIME DURING CONCRETE PLACING AND CURING, THE PROVISIONS OF ACISOGR SHALL BE POLLOWED TO PROTECT CONCRETE FROM PREZIX
- H. HOT WEATHER CONCRETING: PLACE AND CURE CONCRETE IN ACCORDANCE WITH ACI 305. COOL INGREDIENTS BEFORE MIXING TO MAINTAIN CONCRETE SILIMP AT TIME OF PLACEMENT BELOW 90 DEGREES F.
- CONCRETE MUST BE CONTINUOUSLY PLACED WITHOUT HORIZONTAL COLD JOINTS. IF COLD JOINTS ARE NECESSARY, ADEQUATE REINFORCING AND HORIZONTAL KEYS OR A ROUGHEND SUFFACE MUST BE PROVIDED, COORDINATE REQUIREMENTS WITH INCINIERS. ALL REINFORCING STELL SHALL BE CONTINUOUS THROUGH CONSTRUCTION JOINTS.
- DEFORMED REINFORCEMENT: ASTM AG I 5, GRADE GO EXCEPT TIES OR STIRRUPS: ASTM AG I 5, GRADE 40.
- K. REINFORCING BARS TO BE WEIDED SHALL BY ASTM AZOC, GRADE GO.
- L. WELDED WIRE PARKIC: ASTM A185 (LAP ONE FULL MESH AND TIE SECURELY, OUT ALTERNATE WIRES AT CONTROL
- M. REINFORCEMENT SHALL BE PABRICATED AND PLACED AS PER THE LATEST EDITION OF THE ACI "MANUAL OF STANDARD PRACTICE FOR DETAILING CONCRETE STRUCTURES" (ACI-3 15).

- O. MINIMUM CONCRETE COVERAGE FOR REINFORCING STEELa. LINFORMED SURFACE CAST AGAINST EARTH 3'
 b. FORMED SURFACE EXPOSED TO EARTH OR WEATHER
 1. se THROUGH \$1 IS BARS
 2'
 2. \$5 NIO SMALLER BARS
 1 I/2'
 C. FORMED SURFACE NOT EXPOSED TO EARTH OR WEATHER
- PROVIDE 2-#5 EACH SIDE OF ALL WALL OPENINGS OR NOTCHES, U.N.O. VERTICAL BARS SHALL BE FULL-HEIGHT; HORIZONTAL BARS SHALL EXTEND A MINIMUM OF 3"-O" BEYOND THE EDGE OF THE OPENING.
- MAINTAIN CONTINUITY OF ALL HORIZONTAL REINFORCEMENT AT CORNERS, INTERSECTIONS AND AT STEPS IN THE TOP AND BOTTOM OF WALLS OR FOOTINGS.
- S. BASE PLATES, ANCHOR BOLTS, SUPPORT ANGLES AND OTHER STEEL EXPOSED TO EARTH OR GRANULAR FILL SHALL BE COVERED WITH A MINIMUM OF 3 IN. OF CONCRETE.
- PROVIDE SUP JOINT MATERIAL SEPARATING THE FLOOR SLAB FROM THE FIPE COLLINIS AND PLUMBING PENETRATIONS TO ALLOW THE SLAB MOVEMENT INDEPENDENT THE COLLINIS OR PLUMBING. PROTECT STEEL COLLINIS FROM CORROSCION BELOW GRADE.

V. FOR LOCATION, SIZE AND DETAILS OF OPDININGS, SLEEVES, INSERTS, CONDUITS, PIPES SLOTS AND RELATED ITEMS REQUIRED TO BE LOCATED PRIOR TO PLACING CONCRETE, REPER TO ARCHITECTURAL, MECHANICAL, ELECTRICAL AND OTHER DEAWNINGS FOR THIS PROJECT.

- A STATE OF THE PROPERTY OF TH

- MICROLLAM REMAN, LVI. 1 ST, The 2000 pin AS MANUFACTURED BY WETSHELDER OR ATTROMED COLUM UNITED NICTO DITERMINE, FASTEN MALTINE MICROLLAM REAMS IN FLUSH FRANCO CONDITIONS TOCKNER WITH INAIS OR BOUTS PER MANUFACTURES RECOMMENDATIONS UNLESS OTHERWISE NOTED ON PLANS AND DETAILS, ALL LVI. FILE ARE 1 JAY TRICKNESS UNLESS NOTED OTHERWISE.
- ARE 1 48" INLINEDS UNLESS INTEL UNICONO.

 PREPARRICATED LOSS: UNLESS INTEL UNICONO.

 BY WEIGHBAUSER, OR APPROVED COULL. DO NOT INSCHAUGH FOR OTHERWISE, INDICT THE TANGE MATERIAL IN AN ANABIRM. WE PERENTALISES AND ANABIRM. TO PREPARE THE STRUCTURES AND ANABIRM. WE PERENTALISES AS THE TECHNOLOGICAL STRUCTURES AND THE TECHNOLOGICAL STRUCTURES AND THE TECHNOLOGICAL STRUCTURES. THE THE STRUCTURES AND ANABIRM THE FLOOR JOINT STRUCTURES. TO THE STRUCTURES AND ANABIRM THE FLOOR JOINT STRUCTURES AND ANABIRM THE FLOOR JOINT STRUCTURES. THE STRUCTURES AND ANABIRM THE FLOOR JOINT STRUCTURES. THE STRUCTURES AND ANABIRM THE FLOOR JOINT STRUCTURES AND ANABIRM THE STRUCTURES A
- D. PLOOR RIM JOIST MATERIAL: 1 1/4" "TIMBERSTRAND LSL" AS MANUFACTURED BY WEYERHAEUSER OR APPROVED EQUAL PROVIDE PRESSURE TREATED LUMBER OR ICC APPROVED BARRIER AT LOCATIONS WHERE MEMBER IS TO BE IN CONTACT WITH CONCRETE, MASONRY OR SOIL, UNLESS NOTED OTHERWISE.
- CONTRACT WITH CONTRACT, WINDOWS ON A STATE OF MELES AND HANDS OF OR USE WITH ACC TREATED LUMBER SHALL BE GALVANIZED WITH A CI AS COATING OR SHALL BE STAINEDS SITEL, LUMBER IN CONTRACT WITH CONCRETE BUT NOT EXPOSED TO DE
- WILDINGSER, OR PYDOUTE COME, IN CONCENTS SHALL BE CO GRADE WITH CONTRIBUTE ON ACCORDANCE WITH TO U.S. PRODUCT STANDARD PS 1-95 OR PS 2-92. ALL PARIES SHALL BE MARKED WITH AN APA GRADE WARK, WITH AN IDENTIFICATION MORE IN ACCORDANCE WITH THE COVERNING BUILDING, COOL FRADS OF MALES OR CROWNS OF STARLES SHALL NOT PENETRATE THE PACE SKIN OR ADDITIONAL NALING WILL BE REQUIRED.
- ERECTION AND PERMANENT TRUSS BRACING SHALL BE SUPPLIED AND ERECTED AS PER THE TRUSS MANUFACTURES RECOMMENDATIONS. NOTIFY THE STRUCTURAL ENGINEER IF THE ROOT TRUSS PACKAGE AS FABRICATED FOR THIS PROJECT VARIES FROM THAT SHOWN ON THE CONTRICION DOCUMENTS.
- DIAPHRAGM SHEATHING SHALL BE OF THICKNESS AND INDEX NUMBER SHOWN ON THE PLANS, PLACED WITH FACE GRAIN PERFENDICULAR TO SUPPORTS AND END JOINTS SHALL BE STAGGERED.
- J. STRUCTURAL HEADERS SHALL BE (3) 2x8 OR (2) 2x10 UNLESS OTHERWISE NOTED. . ALL TRUSSES, RAPTERS AND PLOOR JOISTS IN TRUSH FRAMED CONDITIONS WITH SPANS EXCEEDING GRO SHALL BEAR IN JOIST HANGERS.
- ALL WALL STUDS SHALL RE CONTINUOUS FROM FLOOR TO FLOOR OR FROM FLOOR TO ROOF.

- M. PROVIDE CRIPPLE STUDS OR SQUASH BLOCKS BELOW SOLID OR BUILT-UP POSTS OR COLLIMINS WITHIN PLOOR SPACES BELOW TO FOUNDATION. PROVIDE CRIPPLE STUDS OR SQUASH BLOCKS WITH EQUIVALENT NUMBER OF STUDS OR AREA OF POST.
- N. PROVIDE DOUBLE PLOOR JOISTS (OR BLOCKING @ 24°O.C.) UNDER PARTITION WALLS RUNNING PARALLEL TO THE DIRECTION OF THE PLOOR FRAMING.
- O. PROVIDE WOOD OR METAL CROSS-BRIDGING AT MID-SPAN OF ALL FLOORS WITH A SPAN EXCEEDING 10'-0' AND/OR IN ACCORDANCE WITH FLOOR JOIST MANUFACTURERS RECOMMENDATIONS. P. BOTTOM FLANGE OF CONTINUOUS JOISTS AT CRAWLSPACE AND UNFINISHED BASEMENT CONDITIONS SHALL BE BRACED BY BLOCKING, BRIDGING OR STRAPPING FOR 1/3 OF THE SPAN EITHER SIDE OF INTERIOR SUPPORT.
- Q. METAL HANGERS AND CONNECTORS SHALL BE "SIMPSON STRONG-TIE" OR AN APPROVED EQUAL. UNLESS NOTED OTHERWISE PROVIDE ALL MANUFACTURER RECOMMENDED PASTENERS FOR THE MAXIMUM CAPACITY OF THE HAN
- R. NAILING SHALL CONFORM TO INTERNATIONAL BUILDING CODE TABLE 2304.10.1, UNLESS MORE OR LARGER NAILING IS OTHERWISE SPECIFIED.

SHOP SUBMITTALS

- A. THE POLLOWING SHALL BE SUBMITTED BY THE CONTRACTOR TO THE ARCHITECT AND THE ENGINEER FOR REVIEW AND APPROVAL PRIOR TO PARRICATION:

 a. REBAR, AND PT. PLACEMENT SHOP DRAWINGS
- 8.0 STRUCTURAL INSPECTIONS
- A. CONSTRUCTION OR WORK FOR WHICH A PERMIT IS REQUIRED SHALL BE SUBJECT TO INSPECTION BY THE BUILDING OPTICAL OR SPECIAL INSPECTORS AND SUCH CONSTRUCTION SHALL REMAIN VISIBLE AND ABLE TO BE ACCESSED FOR INSPECTION PURPOSES UNIT, APPROVED.
- REFECTION FUNDOMES URIL APPROVED.

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DESIGNATION	SHEATHING & NAILING	SILL PLATE	BOTTOM PLATE	TOP PLATE
A x · x	SHEAR WALL A: 1/2" GYPSUM BOARD SHEATHING, BOTH SIDES, ATTACHED WITH 54 COOLER OR WALLBOARD MAIL, MIN. 3(8" HEAD, 114" LONG OR 1G GA. STAPLE, 1 1/2" LONG, AT 7" o.c.	2x 51LL PLATE w/ 1/2*Ø x 10* A.B. @ 48* o.c.	(2) I GJ COMMON @ 16" o.c. OR (2) 3'yO.131" NAILS @ 12" o.c. INTO BLOCKING, RIM BOARD, OR DRAG STRUT BELOW	8J COMMON OR 3'x0.131" TOBNAL @ 6" o.c. FROM BLOCKING, RII BOARD, DRAG TRUSS, OI DRAG STRUT TO PLATE
B		2x SILL PLATE w/ 1/2*0 x 10* A.B. @ 48* o.c.	(2) IG4 COMMON @ IG* o.c. OR (2) 3'x0.131" NAIL5 @ I2" o.c. INTO BLOCKING, RIM BOARD, OR DRAG STRUT BELOW	8J COMMON OR 3'50.131" TOENAL @ 6" o.c. FROM BLOCKING, RI BOARD, DRAG TRUSS, OI DRAG STRUT TO PLATE
C		2x SILL PLATE w/ 1/2*0 x 10* A.B. @ 24* o.c.	(2) 16d COMMON @ 10* o.c. OR (2) 3*0.131* NAILS @ 8* o.c. INTO BLOCKING, RIM BOARD, OR DRAG STRUT BELOW	A35 @ 16" o.c. CONN. TO BLOCKING, RIM BOARD, DRAG TRUSS, OR DRAG STRUT
D		2x SILL PLATE w/ 1/2*Ø x 10* A.B. @ 16* o.c.	(2) 16d COMMON @ 8' o.c. OR (2) 3'40.131" NAILS @ 4" o.c. INTO BLOCKING, RIM BOARD, OR DRAG STRUT BELOW	A35 @ 12" o.c. CONN. TO BLOCKING, RIM BOARD, DRAG TRUSS, OR DRAG STRUT
E TO		2x SILL PLATE w/ 1/2*/0 x 10* A.B. @ 16* o.c.	(2) 1Gd COMMON @ 6" o.c. OR (2) 3"x0.131" NAL5 @ 4" o.c. INTO BLOCKING, RIM BOARD, OR DRAG STRUT BELOW	A35 @ 8" o.c. CONN. TO BLOCKING, RIM BOARD, DRAG TRUSS, OR DRAG STRUT

WALL		ROOF DIAPHR. LESS NOTED OTHERWISE)	AGM SCHEDULE
DIAPHRAGM	SHEATHING (ALL SHEATHING ON SIDE)	EDGE NAILING	FIELD NAILING
EXTERIOR WALLS	7/1G" APA RATED SHEATHING (ONE SIDE), MIN 24/1G SPAN RATING	8d COMMON OR GALVANIZED BOX NAILS @ 6" o.c., OR 15 ga x 1 3/4" MIN. STAPLES @ 4" o.c.	8d COMMON OR GALVANIZED BOX NALS @ 12" o.c., OR 15 ga x 1 3/4" MIN. STAPLES @ 12" o.c.
FLOOR	23/32" T4G APA RATED SHEATHING, MIN 48/24 SPAN RATING	I OJ COMMON OR 3" x 0.131" NAILS @ 6" o.c. (SEE NOTE #4 BELOW)	10d COMMON OR 3" x 0.131" @ 12" o.c.
ROOF	19/32" APA RATED SHEATHING, MIN 40/20 SPAN RATING	I Od COMMONS @ 6º o.c.	10d COMMONS @ 12" o.c.

CAMPRISAD CONTELLE MOTTES.

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(2) PARE EDICES MUST DE MARIET DE A COMMON ELEMENT.
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4. PRODO SPALET PROVIDE MARIEMAND AND A PRINCE SEA. A GORD EN PROVIDE MODIE


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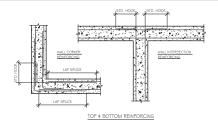
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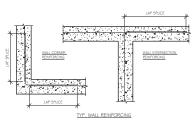
- = NEW
 = EXISTING
 = VERIFY OR PROVIDE
 = ANCHOR BOLT
 = ABOVE
 = BELOW
 = BOTTOM OF FOOTING

- = HEADER = KING STUD = ON CENTER = PERFORATED = TRIM STUD = TO BE DETERMIN = TOP OF FOOTING = TOP OF LEDGE


- = TOP OF STEEL






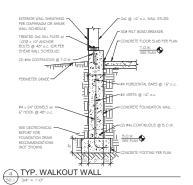

TYP. VALUES: #5 LAP SPLICE = 32°, STD HOOK = 10 #4 LAP SPLICE = 26°, STD HOOK = 8° TYP. CORNER REINFORCEMENT

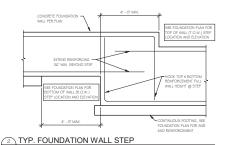

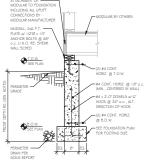

3 TYPICAL CRAWL SPACE WALL
Sol 3/4" = 1'-0"



ASC

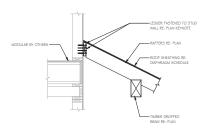
Suite 30 80302 ax: 303,

표 REPERATORY NOT FOR CONSTRUCTION GENERAL NOTES 450 Broadway St Grand Lake, CO MOUNTAIN


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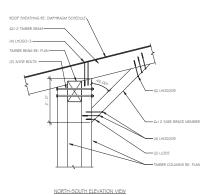
ROCKY

S_{0.1} Sheet 1 of 9





RAFTER TO MODULAR WALL CONNECTION



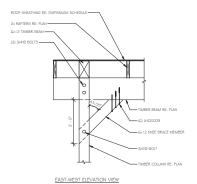

7 KNEE BRACES CONNECTION AT GAZEBO

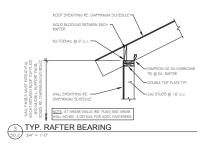


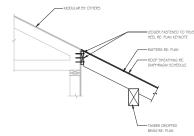


RAFTER TO MODULAR TRUSS CONNECTION

(4) RAFTER TO MODULAR TRUSS CONNECTION


(50.2) 344" = 11-0"

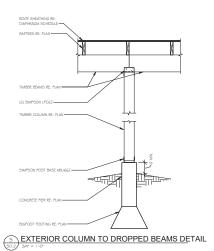

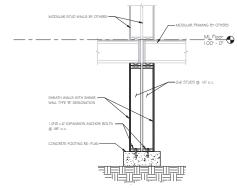

MATING WALLS FOUNDATION

(SO, 2) 3/4" = 1'-O'

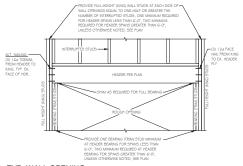

TYP. WALL OPENING

NOT FOR CONSTRUCTION
SIRUCTURAL DEFAILS
ROCKY MOUNTAIN REPERATORY THEATRE


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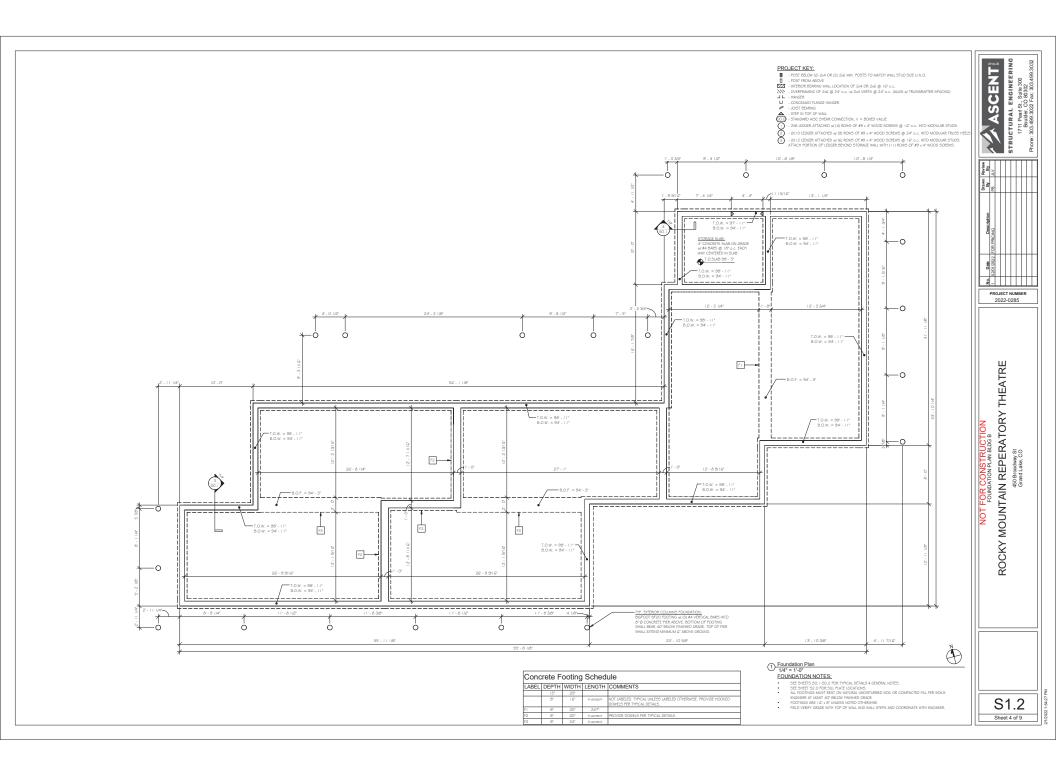
PROJECT NUMBER


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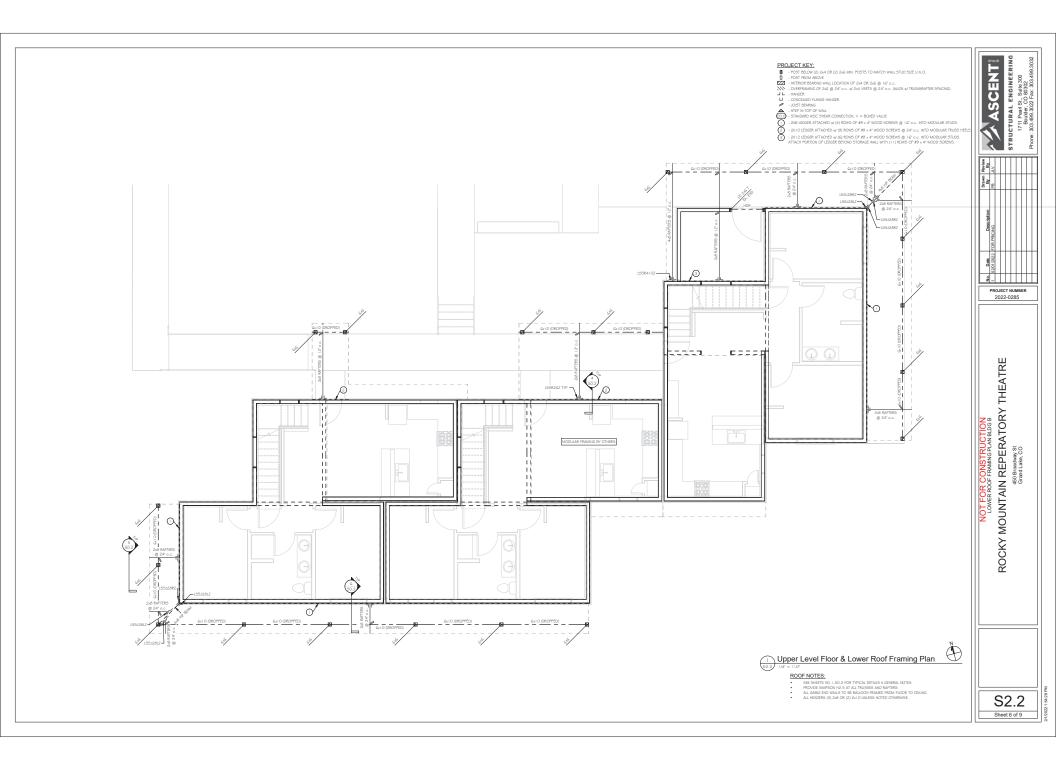
S0.2 Sheet 2 of 9


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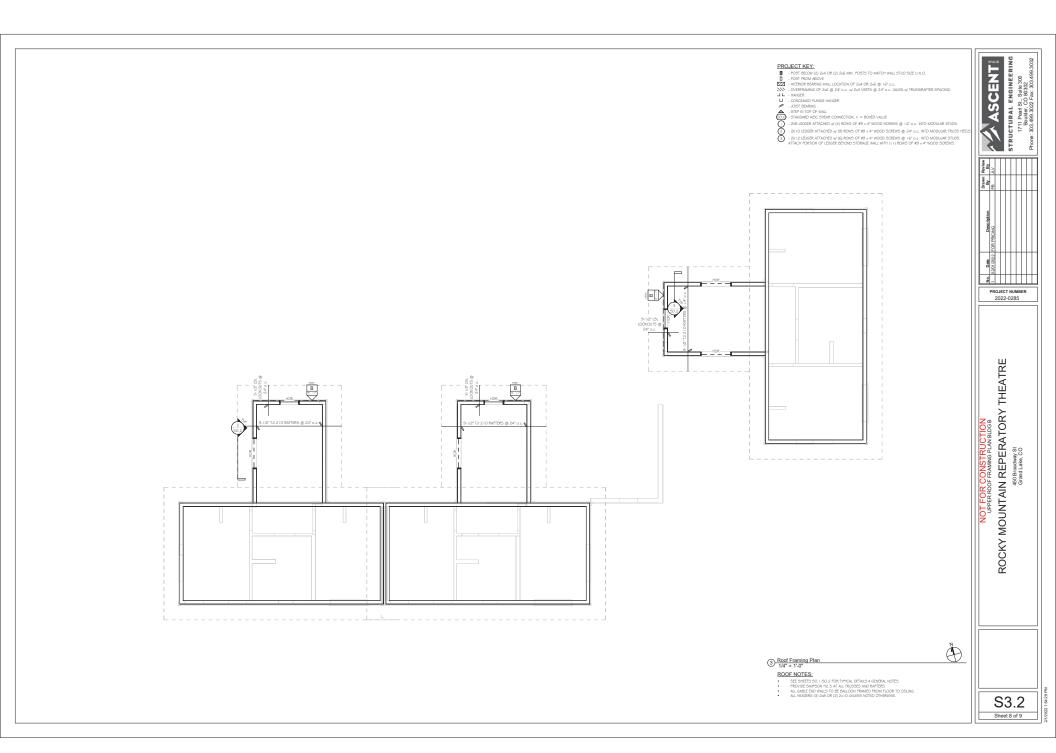








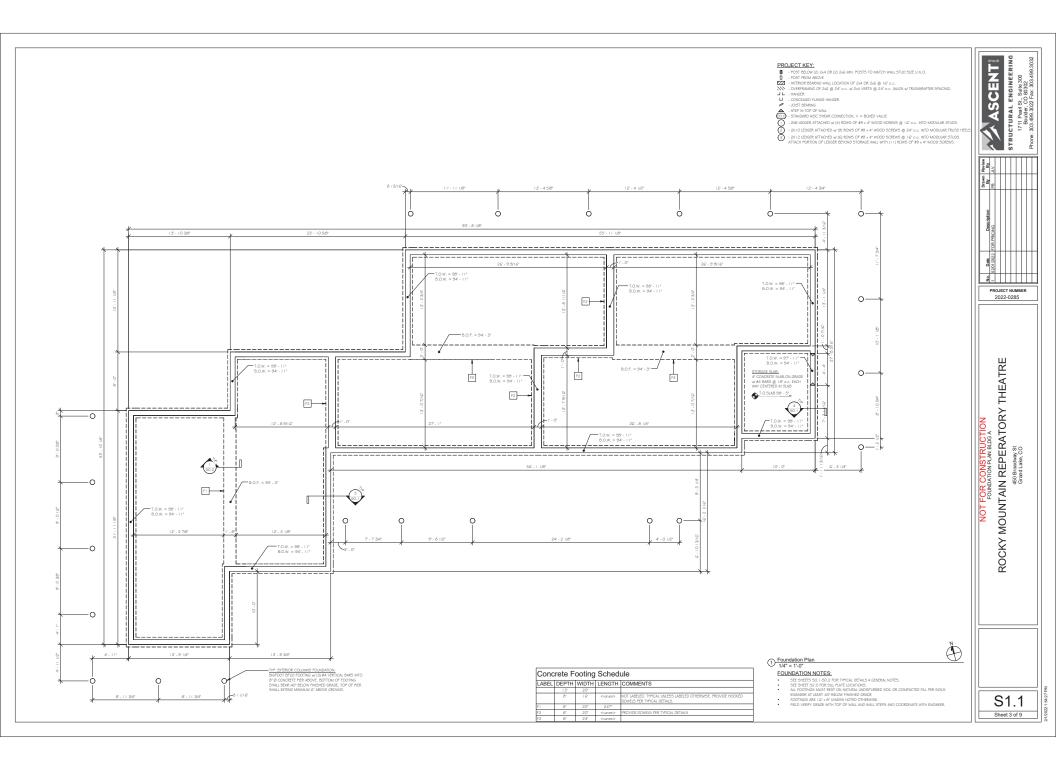

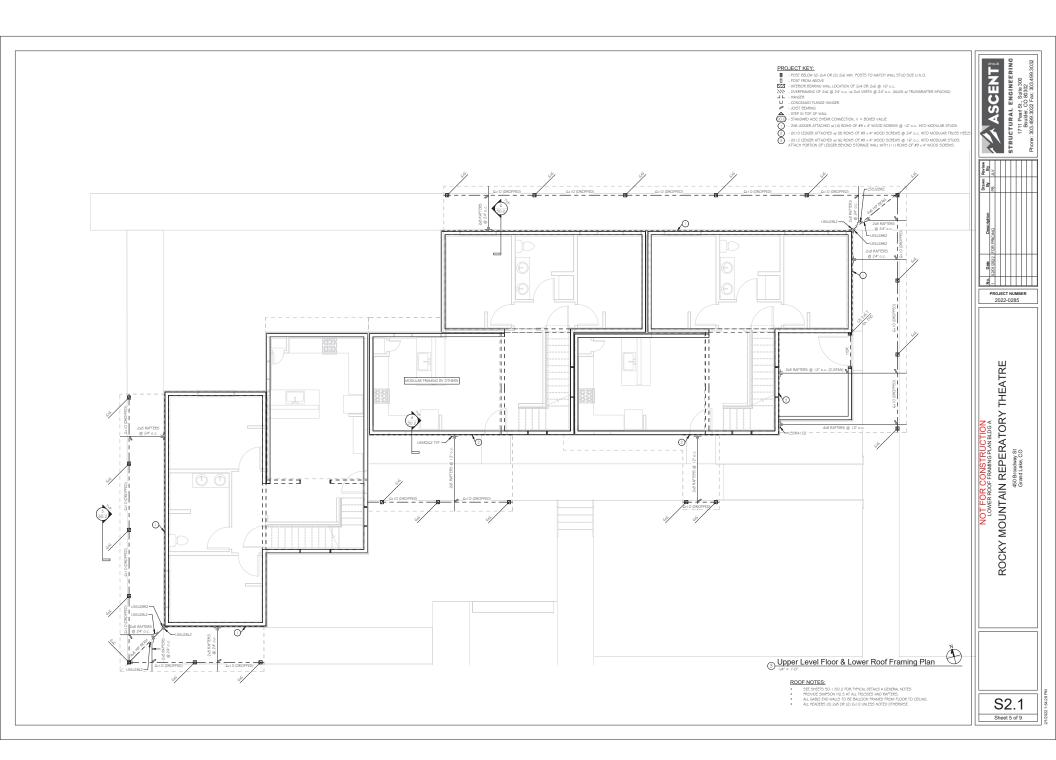

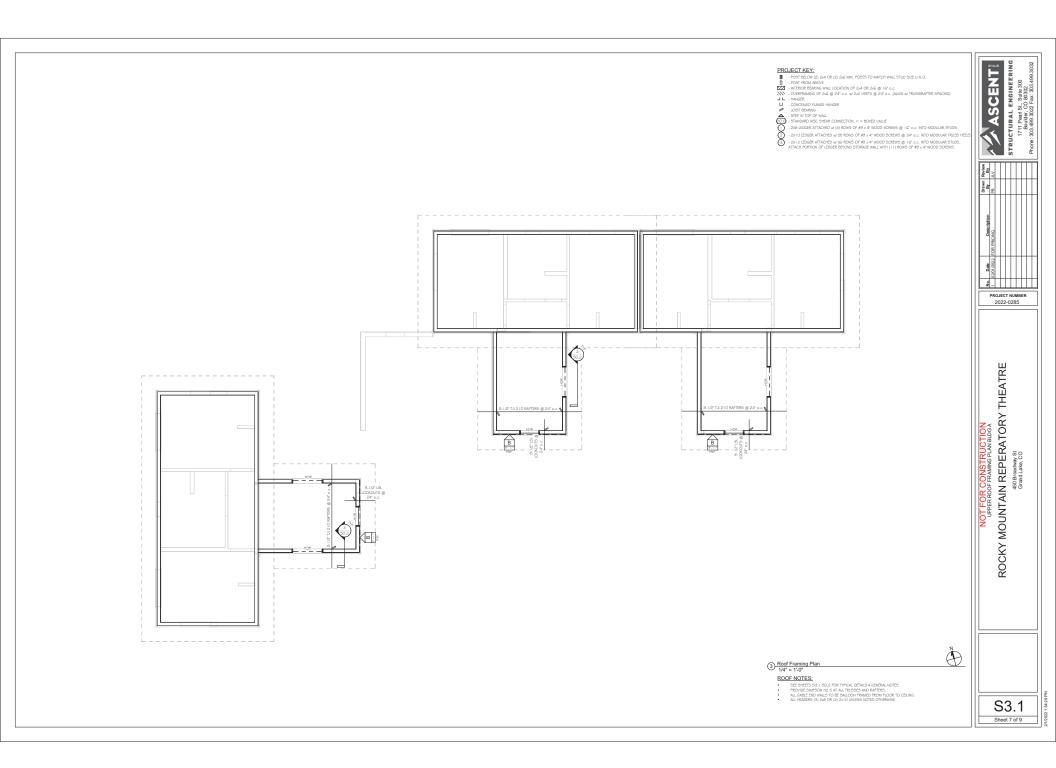

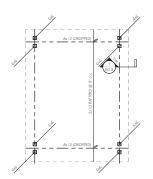

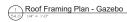

ROOF NOTES:

- SEE SHEETS SO, 1-50, 2 FOR TYPICAL DETAILS 4 GENERAL NOTES.
 PROVIDE SIMPSON H2.5 AT ALL TRUSSES AND RAFTERS.
 ALL GABLE BID WALLS TO BE BALLOON FRAMED FROM FLOOR TO CEILING.
 ALL HEADERS (3) 2.6 OR (2) 2x1 O UNLESS NOTED OTHERWISE.

PROJECT KEY:

PROJECT KEY.

8 FOR 5 EXCH VEY 3A OR (2) 3A GMN, POSTS TO MATCH WALL STUD SIZE U.N.O.

10 FOR FROM ABOVE

22 - INTEROR DEPENDENCE ULCATION OF 2A OR 2A (6) 10° a.c.

11 - THOSE TO CONTROL OF THE STATE OF THE STATE



2022-0285

STRUCTURAL ENGINEERING 1711 Pearl St., Suite 300 Boulder, CO 80302 Phone: 303.489.302 Fax: 303.489.3022

ASCENT

NOT FOR CONSTRUCTION
FOUNDATION AND ROOF FRAMING PLAN GAZEBO
ROCKY MOUNTAIN REPERATORY THEATRE



T.O.W. = 98' - 4* B.O.W. = 94' - 4*



FOUNDATION NOTES:

T.O.W. = 98' - 4" B.O.W. = 94' - 4"

SEC HEETS SO 1.00 2 FOR THYCAL DETAILS 4 GENERAL NOTES.

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LINCOTINGS OF THE ST ON INVIDUAL UNDUSTRIEDS SOIL OR COMPACTED FILL FER SOILS DISCHARE AT LICES A OF SIZE IN PRINCED CRADE.

FOOTINGS ARE 10'-YE UNLESS NOTED OTHERWISE.

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FELD YERPIN FORDER WITH TOP OF WAIL AND WAIL STOPS AND COORDINATE WITH DISCRET.

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