CONTRACT PLANS COMPONENTS

ROADWAY/LANDSCAPE/HARDSCAPE PLANS LIGHTING PLANS

INDEX OF DRAWINGS

INDEX OF DIV	40011003
SHEET NO.	SHEET DESCRIPTION
1	KEY SHEET
2	SIGNATURE SHEET
3 - 4	DRAINAGE MAP
5 - 8	TYPICAL SECTION
9	PROJECT LAYOUT
10	PROJECT CONTROL SHEET
11 - 12	GENERAL NOTES
13 - 15	ROADWAY PLAN-PROFILE
16	CUL-DE-SAC DETAIL
17 - 19	DRAINAGE STRUCTURES
20	DRAINAGE DETAIL
21 - 27	CROSS SECTIONS
28	DRIVEWAY CROSS SECTIONS
29 - 30	EROSION CONTROL PLAN
31 - 32	UTILITY ADJUSTMENT PLAN
33	SIGNALIZATION PLAN
34 - 35	SIGNING AND PAVEMENT MARKING PLAN
36 - 37	GUIDE SIGN WORKSHEET
38	PARKING LOT DRAINAGE MAP
39	PARKING LOT GRADING DETAIL
40 - 41	PARKING LOT DRAINAGE DETAIL
42	PARKING LOT EROSION CONTROL PLAN
43	PARKING LOT DRIVEWAY DETAIL
44	PARKING LOT LAYOUT
45	PARKING LOT UTILITY ADJUSTMENT PLAN
LH-100 - LH-102	HARDSCAPE PLANS
LH-500 - LH-509	HARDSCAPE PLANS
HS-510	HARDSCAPE PLANS
LH-511 - LH-512	HARDSCAPE PLANS
LH-600	HARDSCAPE PLANS BEGIN PROJECT
LP-100 - LP-102	LANDSCAPE PLANS
LP-400 - LP-401	LANDSCAPE SCHEDULE STA. 10+11.91
LP-500 - LP-501	LANDSCAPE DETAILS
LP-502 - LP-503	LANDSCAPE NOTES
IP-100 - IP-102	IRRIGATION PLANS
IP-500 - IP-501	IRRIGATION NOTES AND DETAILS
TD-100 - TD-102	TREE DISPOSITION PLANS

GOVERNING STANDARD PLANS:

Florida Department of Transportation, FY 2022-23 Standard Plans for Road and Bridge Construction and applicable Interim Revisions (IRs).

TREE DISPOSITION PLANS

TREE DISPOSITION PLANS

Standard Plans for Road Construction and associated IRs are available at the following website: http://www.fdot.gov/design/standardplans

APPLICABLE IRs:

TD-500 - TD-502


TD-600

GOVERNING STANDARD SPECIFICATIONS: Florida Department of Transportation, JULY 2022 Standard Specifications for Road and Bridge Construction at the following website: http://www.fdot.gov/programmanagement/Implemented/SpecBooks

CITY OF GREEN COVE SPRINGS



WALNUT ST. IMPROVEMENTS

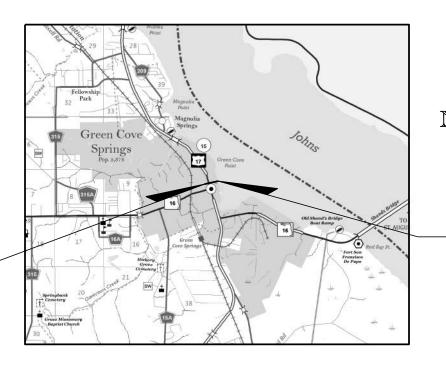

ACOLA FORT WALTON
BEACH
PANAMA
CITY

ST AUGUSTINE
GRID ILLE

LAKE COLOR

ST AUGUSTINE

GRID ILLE

DOCALA

DAYTONA BEACH
DELANDO

TAMPA
ST PETERSBURG

SARASOTA
BRADENTON

WEST PALM
BEACH
MIAMI

KEY WEST

KEY WEST

KEY WEST

PLANS PREPARED BY:

END PROJECT

STA. 23+73.48



WGI, INC. 4371 U.S. HWY 17 SOUTH, SUITE 203 FLEMING ISLAND, FLORIDA 32003 TEL: 904-470-4503

NOTE: THE SCALE OF THESE PLANS MAY HAVE CHANGED DUE TO REPRODUCTION.

PROJECT OWNER:

CITY OF GREEN COVE SPRINGS 321 WALNUT STREET GREEN COVE SPRINGS, FL 32043 TEL: 904-297-7058

CITY OFFICIALS


MATT JOHNSON
CONNIE BUTLER
EDWARD GAW
STEVEN KELLY
THOMAS SMITH
STEVE KENNEDY
MIKE NULL
STEVE THOMAS

MAYOR
VICE MAYOR
COUNCIL MEMBER
COUNCIL MEMBER
COUNCIL MEMBER
CITY MANAGER
PUBLIC WORKS DIRECTOR
ASST. PUBLIC WORKS DIRECTOR

ENGINEER OF RECORD: JOHN D. WESTCOTT

P.E. NO.: 88357

SHEET NO.

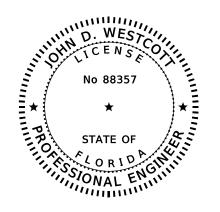

THIS ITEM HAS BEEN DIGITALLY SIGNED AND SEALED BY:


ON THE DATE ADJACENT TO THE SEAL

PRINTED COPIES OF THIS DOCUMENT ARE NOT CONSIDERED SIGNED AND SEALED AND THE SIGNATURE MUST BE VERIFIED ON ANY ELECTRONIC COPIES.

WGI, INC. 4371 U.S. HIGHWAY 17 SOUTH, SUITE 203 FLEMING ISLAND, FL 32003 JOHN D. WESTCOTT, PE NO. 88357

THE ABOVE NAMED PROFESSIONAL ENGINEER SHALL BE RESPONSIBLE FOR THE FOLLOWING SHEETS IN ACCORDANCE WITH RULE 61G15-23.004, F.A.C.

SHEET NO.	SHEET DESCRIPTION
1	KEY SHEET
2	SIGNATURE SHEET
5 - 8	TYPICAL SECTION
9	PROJECT LAYOUT
11 - 12	GENERAL NOTES
13 - 15	ROADWAY PLAN-PROFILE
16	CUL-DE-SAC DETAIL
21 - 27	CROSS SECTIONS
28	DRIVEWAY CROSS SECTIONS
29 - 30	EROSION CONTROL PLAN
31 - 32	UTILITY ADJUSTMENT PLAN
<i>33</i>	SIGNALIZATION PLAN
34 - 35	SIGNING AND PAVEMENT MARKING PLAN
36 - 37	GUIDE SIGN WORKSHEET
43	PARKING LOT DRIVEWAY DETAIL
44	PARKING LOT LAYOUT
45	PARKING LOT UTILITY ADJUSTMENT PLAN

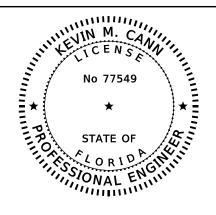

THIS ITEM HAS BEEN DIGITALLY SIGNED AND SEALED BY:


ON THE DATE ADJACENT TO THE SEAL

PRINTED COPIES OF THIS DOCUMENT ARE NOT CONSIDERED SIGNED AND SEALED AND THE SIGNATURE MUST BE VERIFIED ON ANY ELECTRONIC COPIES.

WGI, INC. 4371 U.S. HIGHWAY 17 SOUTH, SUITE 203 FLEMING ISLAND, FL 32003 KEVIN M. CANN, PE NO. 77549

THE ABOVE NAMED PROFESSIONAL ENGINEER SHALL BE RESPONSIBLE FOR THE FOLLOWING SHEETS IN ACCORDANCE WITH RULE 61G15-23.004, F.A.C.

SHEET NO.	SHEEL DESCRIPTION
2 3 - 4	SIGNATURE SHEET DRAINAGE MAP
17 - 19	DRAINAGE STRUCTURES
20	DRAINAGE DETAIL
38	PARKING LOT DRAINAGE MAP
39	PARKING LOT GRADING DETAIL
40 - 41	PARKING LOT DRAINAGE DETAIL
42	PARKING LOT EROSION CONTROL PLAN

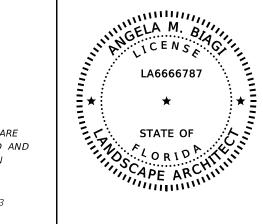

THIS ITEM HAS BEEN DIGITALLY SIGNED AND SEALED BY:

ON THE DATE ADJACENT TO THE SEAL

PRINTED COPIES OF THIS DOCUMENT ARE NOT CONSIDERED SIGNED AND SEALED AND THE SIGNATURE MUST BE VERIFIED ON ANY ELECTRONIC COPIES.

WGI, INC. 2035 VISTA PARKWAY WEST PALM BEACH, FL 33411 ANGELA M. BIAGI, LA6666787

THE ABOVE NAMED PROFESSIONAL ENGINEER SHALL BE RESPONSIBLE FOR THE FOLLOWING SHEETS IN ACCORDANCE WITH RULE 61G10-11.011, F.A.C.

SHEET NO.	SHEET DESCRIPTION
LH-100 - LH-102	HARDSCAPE PLANS
LH-500 - LH-509	HARDSCAPE PLANS
HS-510	HARDSCAPE PLANS
LH-511 - LH-512	HARDSCAPE PLANS
LH-600	HARDSCAPE PLANS
LP-100 - LP-102	LANDSCAPE PLANS
LP-400 - LP-401	LANDSCAPE SCHEDULE
LP-500 - LP-501	LANDSCAPE DETAILS
LP-502 - LP-503	LANDSCAPE NOTES
IP-100 - IP-102	IRRIGATION PLANS
IP-500 - IP-501	IRRIGATION NOTES AND DETAILS
TD-100 - TD-102	TREE DISPOSITION PLANS
TD-500 - TD-502	TREE DISPOSITION PLANS
TD-600	TREE DISPOSITION PLANS



THIS ITEM HAS BEEN DIGITALLY SIGNED AND SEALED BY:

ON THE DATE ADJACENT TO THE SEAL

PRINTED COPIES OF THIS DOCUMENT ARE NOT CONSIDERED SIGNED AND SEALED. THE SIGNATURE MUST BE VERIFIED ON ANY ELECTRONIC COPIES.

WGI, INC. 4371 U.S. HIGHWAY 17 SOUTH SUITE 203, FLEMING ISLAND, FL 32003 RYAN F. KETT, PSM NO. 7113

THE ABOVE NAMED PROFESSIONAL SURVEYOR AND MAPPER SHALL BE RESPONSIBLE FOR THE FOLLOWING SHEETS IN ACCORDANCE WITH RULE 5J-17.062, F.A.C.

SHEET NO.	SHEET DESCRIPTION
2	SIGNATURE SHEET
1 1	PROJECT CONTROL SHEET



JOHN D. WESTCOTT P.E. NO. 88357 WGI, INC. 4371 U.S. HIGHWAY 17 SOUTH, SUITE 203 FLEMING ISLAND, FL 32003



PREPARED FOR

CITY OF

GREEN COVE SPRINGS

SHEET TITLE:


SIGNATURE SHEET


SHEET NO.

WALNUT STREET IMPROVEMENTS

2

REF. DWG. NO.

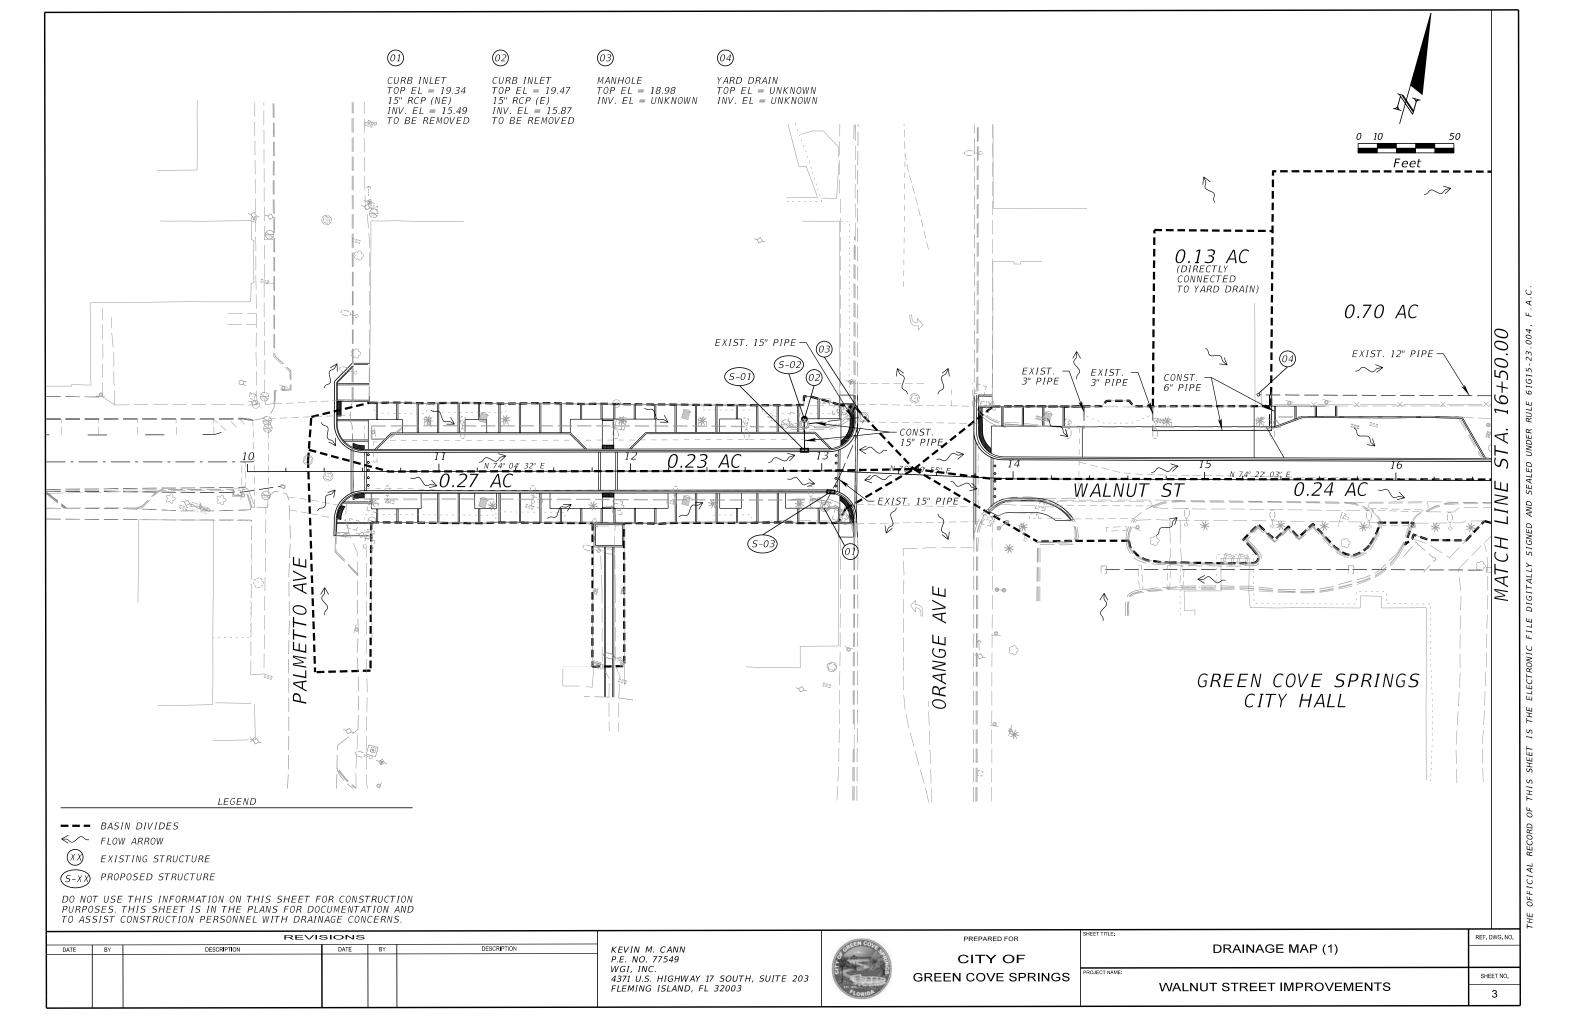

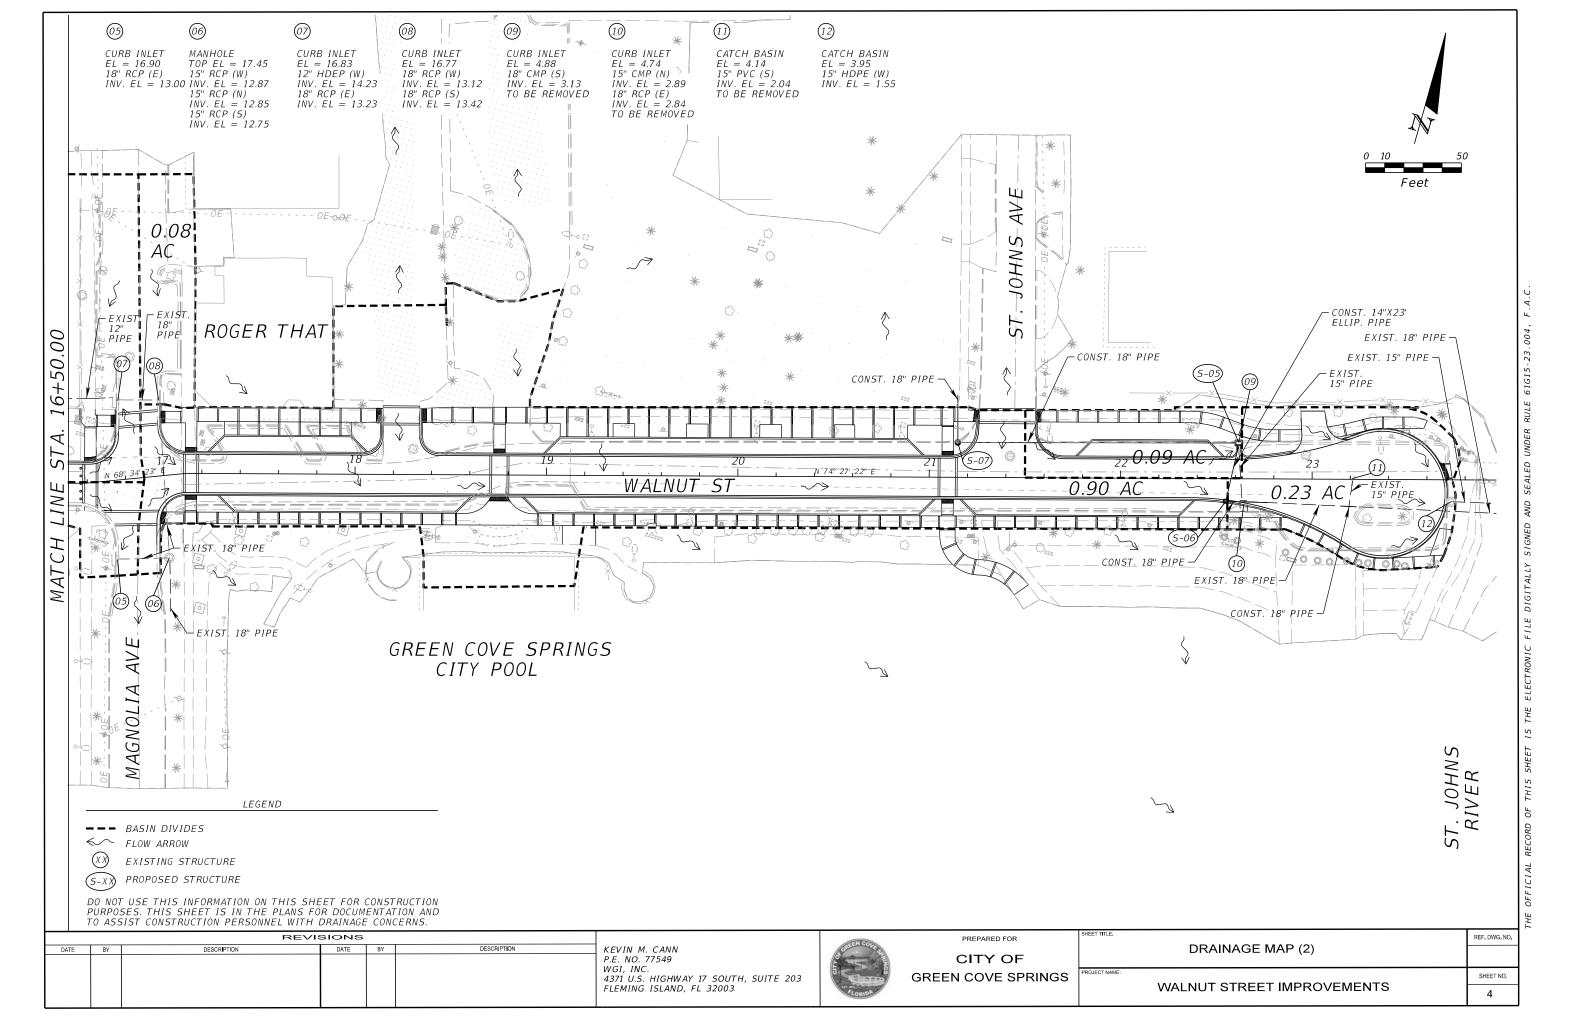


TYPICAL SECTION

WALNUT ST.

STA. 10+45.36 TO STA. 13+18.72

PALMETTO AVE. TO ORANGE AVE.

EXISTING CONDITIONS

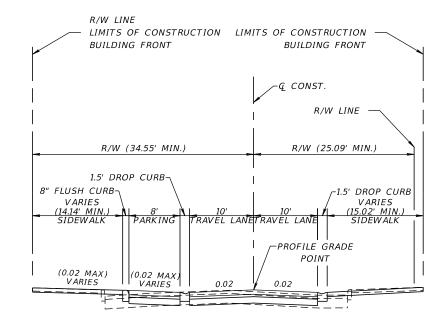

TYPICAL SECTION

WALNUT ST.

STA. 10+45.36 TO STA. 13+18.72

PALMETTO AVE. TO ORANGE AVE.

HARDSCAPE RESURFACING/WIDENING*

OPTIONAL BASE GROUP 1 1.5" SAND SETTING BED AND 2.75" MORTARLESS BRICK PAVING

NOTES:

- BRICKS PAVERS AND EXISTING CURB ARE TO BE REMOVED.
- BRICKS PAVERS ARE TO BE REUSED WHERE POSSIBLE.
- REFER TO COJ CITY STANDARD SPECIFICATIONS P-301 FOR CURB DETAILS.
- TRAFFIC DESIGN SPEED = 25 MPH.

		REVI				
DATE	BY	DESCRIPTION	DATE	BY	DESCRIPTION	JOHN D. WESTCOTT
						P.E. NO. 88357
						WGI, INC.
						4371 U.S. HIGHWAY 17 SOUTH, SUITE 20.
						FLEMING ISLAND, FL 32003



PREPARED FOR

CITY OF

GREEN COVE SPRINGS

S PROJECT NAME

TYPICAL SECTION

REF. DWG, NO.

SHEET NO.

THE OFFICIAL RECORD OF THIS SHEET IS THE ELECTRONIC FILE DIGITALLY SIGNED AND S

TYPICAL SECTION

WALNUT ST.

STA. 13+79.55 TO STA. 15+50.56

ORANGE AVE. TO MAGNOLIA AVE.

₽ CROWN

12.05' - 12.25' TRAVEL LANE

& CENTER STRIPE

R/W LINE

r 1.5'± EXIST. CURB

S/W

-NATURAL GROUND

R/W (22.99' MIN.)

UTILITY

R/W LINE

BUILDING FRONT

R/W (37.67' MIN.)

- 1'± EXIST. CURB

EXISTING CONDITIONS

R/W LINE

R/W LINE

R/W LINE

R/W LINE

R/W LINE

R/W LINE

R/W CROWN

R/W (20.30' MIN.)

TYPICAL SECTION

WALNUT ST.

STA. 15+50.56 TO STA. 16+76.19

ORANGE AVE. TO MAGNOLIA AVE.

EXISTING CONDITIONS

*NOTES:

- BRICKS PAVERS AND EXISTING CURB ARE TO BE REMOVED.
- BRICKS PAVERS ARE TO BE REUSED WHERE POSSIBLE.
- REFER TO COJ CITY STANDARD SPECIFICATIONS P-301 FOR CURB DETAILS.
- TRAFFIC DESIGN SPEED = 25 MPH.


HARDSCAPE RESURFACING/WIDENING*

WALNUT ST.

STA. 13+79.55 TO STA. 15+50.56

ORANGE AVE. TO MAGNOLIA AVE.

OPTIONAL BASE GROUP 1 1.5" SAND SETTING BED AND 2.75" MORTARLESS BRICK PAVING

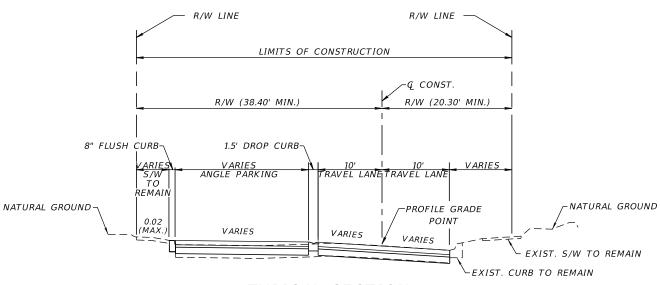

TYPICAL SECTION

WALNUT ST.

STA. 15+50.56 TO STA. 16+76.19

ORANGE AVE. TO MAGNOLIA AVE.

HARDSCAPE RESURFACING/WIDENING*

OPTIONAL BASE GROUP 1 1.5" SAND SETTING BED AND 2.75" MORTARLESS BRICK PAVING

DATE BY DESCRIPTION DATE BY DESCRIPTION

JOHN D. WESTCOTT
P.E. NO. 88357
WGI, INC.
4371 U.S. HIGHWAY 17 SOUTH, SUITE 203
FLEMING ISLAND, FL 32003



CITY OF
GREEN COVE SPRINGS

TYPICAL SECTION

WALNUT STREET

-NATURAL GROUND

THE OFFICE

REF. DWG. NO.

SHEET NO.

TYPICAL SECTION

WALNUT ST.

STA. 16+76.19 TO STA. 17+50.00


STA. 20+25.00 TO STA. 23+73.48

MAGNOLIA AVE. TO ST. JOHNS RIVER

EXISTING CONDITIONS

NOTES:

- EXISTING BRICK PAVERS ARE UNDER EXISTING ASPHALT AND MAY BE ENCOUNTERED DURING MILLING OPERATIONS. IF PAVERS AND BASE ARE DISTURBED DURING MILLING OPERATIONS OR PIPE INSTALLATION, THE AREA DISTURBED MUST BE CONSTRUCTED PER THE WIDENING PAVEMENT DESIGN ON THIS SHEET.
- BRICKS PAVERS AND EXISTING CURB ARE TO BE REMOVED.
- BRICKS PAVERS ARE TO BE REUSED WHERE POSSIBLE.
- REFER TO COJ CITY STANDARD SPECIFICATIONS P-301 FOR CURB DETAILS.
- TRAFFIC DESIGN SPEED = 25 MPH.

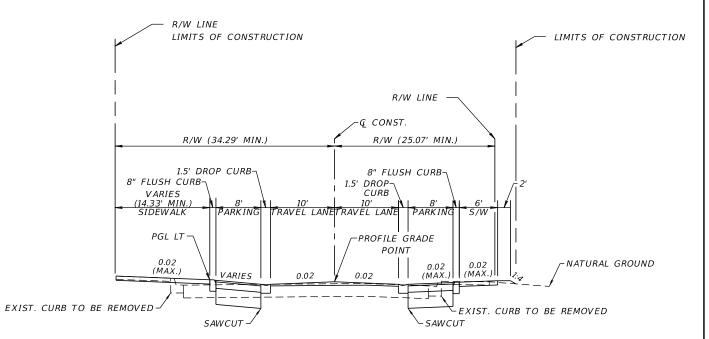

TYPICAL SECTION

WALNUT ST.

STA. 16+76.19 TO STA. 17+50.00

STA. 20+25.00 TO STA. 23+73.48

MAGNOLIA AVE. TO ST. JOHNS RIVER

EXISTING TRAVEL LANES

MILL EXISTING TRAVEL LANES (1.0" DEPTH)

TYPE SP (TRAFFIC B) OVERBUILD (3.5" AVG.)

TYPE SP STRUCTURE COURSE (TRAFFIC B) (1.0") (PG 76-22)

WIDENING

OPTIONAL BASE GROUP 1 WITH
TYPE SP STRUCTURAL COURSE (TRAFFIC B) (1")

| DATE | BY | DESCRIPTION | DATE | BY | DESCRIPTION | JOHN D. WESTCOTT | P.E. NO. 88357 | WGI, INC. | 4371 U.S. HIGHWAY 17 SOUTH, SUITE 203 | FLEMING ISLAND, FL 32003



CITY OF
GREEN COVE SPRINGS


TYPICAL SECTION

TYPICAL SECTION

SHEET NO.

JU I

REF. DWG. NO.

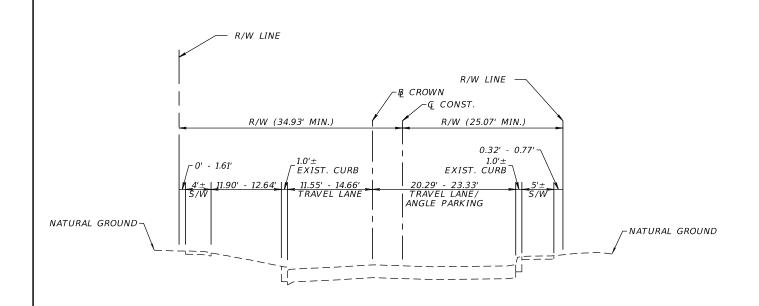

TYPICAL SECTION

WALNUT ST.


STA. 17+50.00 TO STA. 20+25.00

MAGNOLIA AVE. TO ST. JOHNS AVE.

EXISTING CONDITIONS

NOTES

- EXISTING BRICK PAVERS ARE UNDER EXISTING ASPHALT AND MAY BE ENCOUNTERED DURING MILLING OPERATIONS. IF PAVERS AND BASE ARE DISTURBED DURING MILLING OPERATIONS OR PIPE INSTALLATION, THE AREA DISTURBED MUST BE CONSTRUCTED PER THE WIDENING PAVEMENT DESIGN ON THIS SHEET.
- BRICKS PAVERS AND EXISTING CURB ARE TO BE REMOVED.
- BRICKS PAVERS ARE TO BE REUSED WHERE POSSIBLE.
- REFER TO COJ CITY STANDARD SPECIFICATIONS P-301 FOR CURB DETAILS.
- TRAFFIC DESIGN SPEED = 25 MPH.

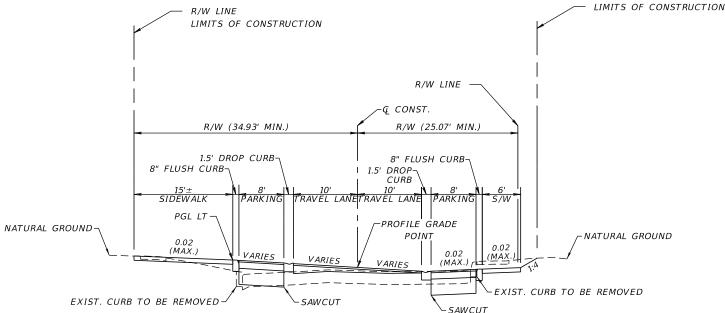

TYPICAL SECTION

WALNUT ST.

STA. 17+50.00 TO STA. 20+25.00

MAGNOLIA AVE. TO ST. JOHNS AVE.

EXISTING TRAVEL LANES

MILL EXISTING TRAVEL LANES (1.0" DEPTH)

TYPE SP (TRAFFIC B) OVERBUILD (5.6" AVG.)

TYPE SP STRUCTURE COURSE (TRAFFIC B) (1.0") (PG 76-22)

WIDENING

OPTIONAL BASE GROUP 1 WITH
TYPE SP STRUCTURAL COURSE (TRAFFIC B) (1")

| DATE | BY | DESCRIPTION | DATE | BY | DESCRIPTION | JOHN D. WESTCOTT | P.E. NO. 88357 | WGI, INC. | 4371 U.S. HIGHWAY 17 SOUTH, SUITE 203 | FLEMING ISLAND, FL 32003



PREPARED FOR

CITY OF


GREEN COVE SPRINGS


PROJECT NAME:

TYPICAL SECTION REF. DWG. NO.

WALNUT STREET IMPROVEMENTS

SHEET NO.

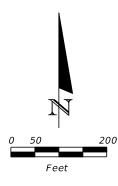

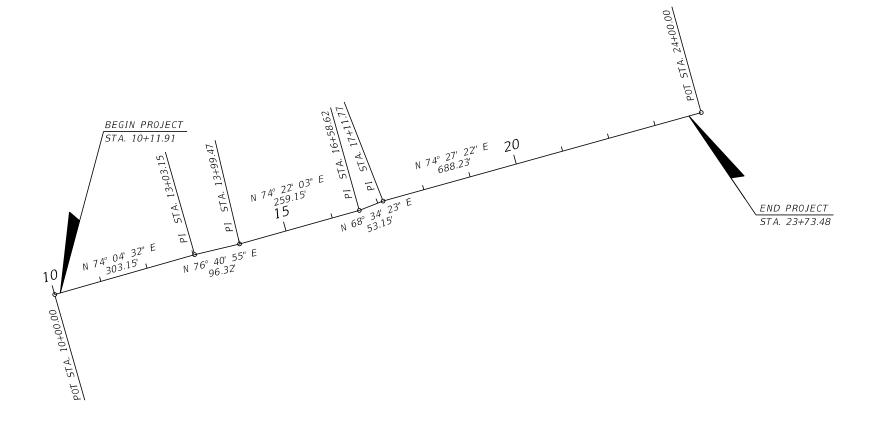

		REVIS				
DATE	BY	DESCRIPTION	DATE	BY	DESCRIPTION	JOHN D. WESTCOTT
						P.E. NO. 88357
						WGI, INC.
						4371 U.S. HIGHWAY 17 SOUTH, SUITE 203 FLEMING ISLAND, FL 32003




PREPARED FOR	SHEET TI
CITY OF	
GREEN COVE SPRINGS	PROJECT

PROJECT LAYOUT						

PROJECT CONTROL POINTS WALNUT STREET (NOT TO SCALE)



<u>A</u> 100

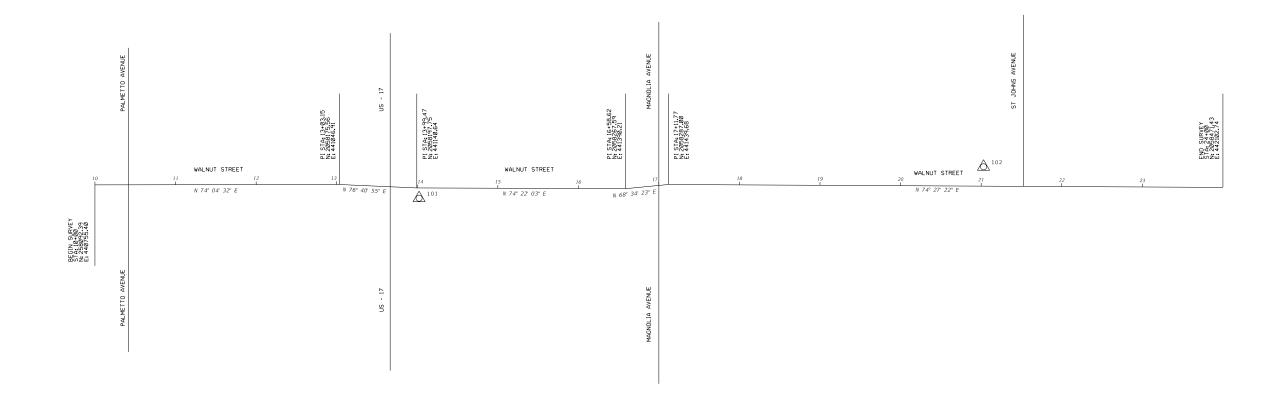

LEGEND

△ = 5/8" IRC LB7055

CR = COUNTY ROAD

IRC = IRON ROD AND CAP

PI = POINT OF INTERSECTION

RD = ROAD

STA = STATION

PRIMARY CONTROL

POINT ID	段 STATION	OFFSET ELEVATION (Z)		DESCRIPTION	NORTHING (Y)	EASTING (X)	LATITUDE	LONGITUDE
100	N/A	N/A	20.22	5/8" I.R. W/ PLASTIC CAP STAMPED TRAV/GPS LB7055	2058047.829	440493.770	N 29° 59' 35.03"	W 81° 40' 52.67"
101	14+02.33	12.71' RT	19.53	5/8" I.R. W/ PLASTIC CAP STAMPED TRAV/GPS LB7055	2058186.284	441146.827	N 29° 59 '36.44"	W 81° 40' 45.25"
102	21+02.80	24.00' LT	11.56	5/8" I.R. W/ PLASTIC CAP STAMPED TRAV/GPS LB7055	2058414.914	441809.986	N 29° 59' 38.74"	W 81° 40' 37.72"
		REVISIONS			SHEET TITLE:			

10	_	21,02.00	2 1.00 L		11.50		3/0 I.N. W, TEASTIC CAL STAINLED	111/4/013 60/03	203071	7.217	TT1005.500	11 23 33 30.74	W O1 70 J	1.12
		REV	ISIONS	s				TEN POD	PREPARED FOR	SHEET TITLE:				REF. DWG. NO.
DATE	BY	DESCRIPTION	DATE	BY		DESCRIPTION	PREPARED BY:	C.			PROJECT (CONTROL SHEET		
							RYAN KETT, PSM 7113		CITY OF					
								GREEN COVE SPRINGS	PROJECT NAME:	OJECT NAME: WALNUT STREET			SHEET NO.	
							FLEMING ISLAND, FLORIDA 32003	FLORIDA			WALNU	UISIREEI		10

GENERAL NOTES:

- ALL WORK AND MATERIALS SHALL BE IN COMPLETE ACCORDANCE WITH ALL RELATIVE SECTIONS OF THE FDOT & GREEN COVE SPRINGS PUBLIC WORKS (G.C.S.P.W) STANDARDS (LATEST REVISION) AND ALL CURRENT CITY & G.C.S.P.W. DETAILS AS WELL AS ALL APPLICABLE STATE AND LOCAL REGULATIONS. THE WORK SHALL ALSO BE PERFORMED AND TESTED IN ACCORDANCE WITH THE FDOT REQUIREMENTS.
- THE CONTRACTOR SHALL BE RESPONSIBLE FOR VISITING THE JOB SITE PRIOR TO PREPARING THE BID FOR THE PURPOSE OF FAMILIARIZING HIMSELF WITH THE NATURE AND THE EXTENT OF THE WORK AND LOCAL CONDITIONS, EITHER SURFACE OR SUBSURFACE, WHICH MAY AFFECT THE WORK TO BE PERFORMED, AND THE EQUIPMENT, LABOR AND MATERIALS REQUIRED. FAILURE TO DO SO WILL NOT RELIEVE THE CONTRACTOR OF COMPLETE PERFORMANCE UNDER THIS CONTRACT. THE CONTRACTOR IS ALSO URGED TO TAKE COLOR PHOTOGRAPHS ALONG THE ROUTE OF THE PROJECT TO RECORD THE EXISTING CONDITIONS PRIOR TO CONSTRUCTION, AND TO AID IN RESOLVING POSSIBLE FUTURE COMPLAINTS THAT MAY OCCUR DUE TO THE CONSTRUCTION OF THE PROJECT.
- IT SHALL BE THE CONTRACTOR'S RESPONSIBILITY TO EITHER CONDUCT ANY FIELD EXPLORATION OR ACQUIRE ANY GEOTECHNICAL ASSISTANCE REQUIRED TO ESTIMATE THE AMOUNT OF UNSUITABLE MATERIAL THAT WILL REQUIRE REMOVAL AND/OR TO ESTIMATE THE AMOUNT OF OFF SITE BORROW THAT WILL BE REQUIRED.
- ALL IMPROVEMENTS SHOWN ARE TO BE WARRANTED BY THE CONTRACTOR TO THE CITY OF G.C.S. FOR A PERIOD OF ONE YEAR FROM DATE OF ACCEPTANCE BY THE OWNER AND CITY OF G.C.S..
- BENCHMARK ELEVATIONS SHOWN ON THE PLANS ARE NORTH AMERICAN VERTICAL DATUM OF 1988
- THE CONTRACTOR SHALL BE RESPONSIBLE FOR OBTAINING ALL NECESSARY PERMITS AND INSURANCE REQUIRED FOR THE PROJECT INCLUDING CITY RIGHT-OF-WAY PERMITS FOR WORK IN CITY OF G.C.S. RIGHT-OF-WAY OR EASEMENT
- THE CONTRACTOR SHALL COORDINATE THE WORK WITHIN CITY OF G.C.S. OR STATE RIGHT-OF-WAY WITH THE PROPER AGENCIES FOR MAINTENANCE OF TRAFFIC AND METHOD OF CONSTRUCTION
- "AS-BUILT" DRAWINGS AS-BUILS TO CITY OF G.C.S. AND THE ST. JOHNS RIVER WATER MANAGEMENT DISTRICT ARE REQUIRED TO BE SIGNED AND SEALED BY A FLORIDA REGISTERED LAND SURVEYOR THEREFORE, IT SHALL BE THE CONTRACTOR'S RESPONSIBILITY TO CONTRACT WITH A LAND SURVEYOR REGISTERED IN THE STATE OF FLORIDA FOR THE PREPARATION, FIELD LOCATIONS, CERTIFICATION AND SUBMITTAL OF "AS-BUILT" DRAWINGS IN ACCORDANCE WITH CURRENT FOOT STANDARDS AND SPECIFICATIONS AND SJRWMD REGULATIONS. IT IS THE CONTRACTOR'S RESPONSIBILITY TO PROCESS THE "AS-BUILT" DRAWINGS FOR APPROVAL
- THE CONTRACTOR SHALL COORDINATE THEIR CONSTRUCTION WITH ALL OTHER CONTRACTORS. IN THE EVENT OF ANY CONFLICT WHATSOEVER, THE CONTRACTOR SHALL NOTIFY THE ENGINEER AND OWNER PRIOR TO PROCEEDING WITH CONSTRUCTION.
- ALL CLEARING AND GRUBBING REQUIRED FOR ALL ROADWAY, UTILITIES, DITCHES, AND BERMS INCLUDED IN THIS PROJECT AND THE CLEARING AND GRUBBING OF ALL RIGHT-OF-WAY OR EASEMENTS SHALL BE CONSIDERED AS PART OF THE PROJECT.
- CONTRACTOR IS RESPONSIBLE FOR PROTECTION OF ALL SURVEY AND PROPERTY MONUMENTS. IF A MONUMENT IS DISTURBED, THE CONTRACTOR SHALL CONTRACT WITH THE SURVEYOR OF RECORD FOR REINSTALLATION OF THE MONUMENT.
- 12. ALL DEBRIS RESULTING FROM ALL ACTIVITIES SHALL BE PROPERLY DISPOSED OF OFF-SITE BY CONTRACTOR
- ALL EXCESS SUITABLE AND UNSUITABLE MATERIAL SHALL BECOME THE PROPERTY OF THE CONTRACTOR AND REMOVED FROM THE SITE BY THE CONTRACTOR UNLESS DIRECTED OTHERWISE BY ENGINEER OR OWNER
- 14. SEE TREE DISPOSITION PLAN FOR STATUS OF TREES.
- BURING OF TREES, BRUSH AND OTHER MATERIALS SHALL BE APPROVED, PERMITTED AND COORDINATED WITH CITY OF CLAY COUNTY FIRE MARSHAL.
- CONTRACTOR SHALL PROVIDE CONTRACTION JOINTS AT 10' INTERVALS AND EXPANSION JOINTS SHALL BE CONSTRUCTED AT 50' INTERVALS AND AT ALL RADIUS POINTS ON ALL CURBING.
- CONTRACTOR SHALL PROVIDE EXPANSION JOINTS AT 18' INTERVALS AND CONTRACTION JOINTS SHALL BE SPACED AT 6' INTERVALS BETWEEN EXPANSION JOINTS
- MAINTENANCE OF TRAFFIC SHALL CONFORM TO F.D.O.T. STANDARD INDEX 102-600 SERIES, LATEST EDITON.
- ALL PIPE UNDER ROADWAY SHALL BE RCP. PIPES NOT UNDER ROADWAY MAY BE RCP OR HDPE.
- CONTRACTOR IS RESPONSIBLE FOR ALL TEMPORARY TRAFFIC CONTROL. WALNUT STREET CAN BE CLOSED TO VEHICULAR TRAFFIC BUT PEDESTRIAN TRAFFIC MUST BE MAINTAINED THROUGHOUT

UTILITY NOTES:

- THE LOCATION OF ALL EXISTING UTILITIES, STRUCTURES AND IMPROVEMENTS SHOWN ON THE DRAWINGS IS BASED ON LIMITED INFORMATION AND MAY NOT HAVE BEEN VERIFIED. THE LOCATIONS ARE APPROXIMATE. THE CONTRACTOR SHALL NOTIFY RESPECTIVE UTILITY OWNERS AND FIELD VERIFY LOCATIONS OF EXISTING UTILITIES AND OTHER IMPROVEMENTS PRIOR TO COMMENCING ANY CONSTRUCTION. IF THE LOCATIONS SHOWN ARE CONTRARY TO THE ACTUAL LOCATIONS, THE CONTRACTOR SHALL NOTIFY THE OWNER AND ENGINEER OF THE DISCREPANCY. THIS DISCREPANCY SHOULD BE RESOLVED PRIOR TO COMMENCING CONSTRUCTION. THE CONTRACTOR SHALL EXERCISE EXTREME CAUTION WHEN WORKING IN AREAS NEAR EXISTING UTILITIES AND IMPROVEMENTS AND SHALL BE RESPONSIBLE FOR AND SHALL REPAIR OR PAY FOR ALL DAMAGE MADE TO EXISTING UTILITIES OR OTHER IMPROVEMENTS. PRIOR TO COMMENCEMENT OF ANY CONSTRUCTION, THE CONTRACTOR SHALL VERIFY ALL GRADES, INVERTS AND TYPE OF MATERIAL OF EXISTING UTILITIES TO WHICH HE SHALL CONNECT.
- THE CONTRACTOR SHALL SUBMIT SHOP DRAWINGS ON ALL MATERIALS, IF REQUIRED, TO THE ENGINEER FOR REVIEW AND APPROVAL, PRIOR TO SUBMITTAL TO CITY OF G.C.S. & G.C.S.P.W., AND PRIOR TO PURCHASE OR CONSTRUCTION OF ANY UTILITY PIPE OR STRUCTURE
- CONTRACTOR SHALL INSURE THAT ALL DRAINAGE STRUCTURES, PIPES, ETC. ARE CLEAN AND FUNCTIONING PROPERLY AT TIME OF ACCEPTANCE.
- ALL DRAINAGE STRUCTURES TO HAVE TRAFFIC BEARING GRATES.
- ALL DRAINAGE PIPE JOINTS IN CITY OF G.C.S. DRAINAGE EASEMENTS, DRAINAGE EASEMENTS BETWEEN PRIVATE LOTS, DRAINAGE RIGHT-OF-WAYS AND UNDER PAVED ROADS ARE TO BE FILTER-WRAPPED.
- TELEVISION INSPECTION SHALL BE REQUIRED ON ALL STORM WATER PIPES. THIS SERVICE SHALL BE PROVIDED BY THE CONTRACTOR AS PART OF THE DRAINAGE CONTRACT. A FULL WRITTEN REPORT AS TO THE CONDITION OF THE PIPE WITH PERTINENT DATA SUCH AS DISTANCE BETWEEN STRUCTURES, LOCATION OF ADJOINING PIPES, ETC. SHALL BE SUBMITTED TO THE OWNER AND ENGINEER PRIOR TO ACCEPTANCE, AND ONE COPY OF THE VIDEO TAPES SHALL BE SUBMITTED TO THE CITY OF G.C.S.. ALL DEFECTIVE AREAS AND ITEMS SHALL BE REPLACED OR REPAIRED PRIOR TO FINAL ACCEPTANCE. ALL REPAIRED SECTION MUST BE REINSPECTED PRIOR TO ACCEPTANCE. INSPECTION SHALL BE PERFORMED AT COMPLETION OF CONSTRUCTION.

UTILITY CONTACTS

KNOWN UTILITY OWNERS WITHIN THE PROJECT LIMITS AND CONTACT INFORMATION ARE LISTED BELOW:

AT&T OF FLORIDA CITY OF GREEN COVE SPRINGS ELECTRIC CITY OF GREEN COVE SPRINGS WATER & SEWER COMCAST COMMUNICATIONS MCI/VERIZON QUANTA TELECOMMUNICATIONS TECO PEOPLES GAS UNITI FIBER/SOUTHERN LIGHT

CONTACT PERSON

PK PATFI 904-727-1568 JOE HANSFORD 386-643-8131 SCOTT SCHULTZ 904-297-7061 JAMES GRAHAM 904-380-6341 904-633-5481 MARVIN FISHER ANDREW RATTEREE 678-836-5610 BRAD GUAGLIARDO 407-420-6674 BOB MENSCHING 904-718-8152

PP5963@ATT.COM JHANDSFORD@GREENCOVESPRINGS.COM SSCHULTZ@GREENCOVESPRINGS.COM JAMES GRÄHAM@CABLE.COMCAST.COM

MARVIN.FISHER@VERIZON.COM ARATTEREE@QUANTATELCOM.COM BGUAGLIARDO@TECOENERGY.COM BOB.MENSHCING@UNITI.COM

REVISIONS DATE BY DESCRIPTION DESCRIPTION JOHN D. WESTCOTT P.E. NO. 88357 4371 U.S. HIGHWAY 17 SOUTH, SUITE 203 FLEMING ISLAND, FL 32003

CITY OF

PREPARED FOR

GREEN COVE SPRINGS

GENERAL NOTES

CONTACT NUMBER E-MAIL ADDRESS

REF. DWG. NO. SHEET NO.

WALNUT STREET

CITY GENERAL REQUIREMENTS:

- CITY OF G.C.S. DEPARTMENT OF ENGINEERING REQUIRES TWENTY-FOUR (24) HOUR NOTICE ON ALL MEETINGS AND OR TESTING MEASURES RELATED TO SAID PROJECT.
- CONSTRUCTION WARNING SIGNS ARE TO BE POST MOUNTED AND ERECTED BEFORE CONSTRUCTION CAN COMMENCE. THESE AND ALL TRAFFIC CONTROL DEVICES SHALL FOLLOW THE STANDARDS SET FORTH BY THE MANUAL OF UNIFORM TRAFFIC CONTROL DEVICES (MUTCD) AS WELL AS THE FLORIDA DEPARTMENT OF TRANSPORTATION (FDOT) STANDARD INDEXES.
- ALL SUB BASE SHALL BE FIRM AND UNYIELDING.
- ALL JOINTS OF PIPE, REGARDLESS OF MATERIAL TYPE, SHALL BE WRAPPED WITH FABRIC FILTER CLOTH PER FLORIDA DEPARTMENT OF TRANSPORTATION (FDOT) STANDARD INDEX 430-001
- ALL DISTURBED CITY OF G.C.S. RIGHTS-OF-WAY SHALL BE SODDED TO THE DISCRETION AND APPROVAL OF THE CITY OF G.C.S. ENGINEERING DEPARTMENT.
- THE CURB SHALL BE CHECKED FOR FLOW DESIGN AT ANY STAGE OF THE PROJECT. A WATER TRUCK IS TO BE PROVIDED AT THE FINAL INSPECTION IN ORDER TO CHECK FLOW DESIGN.
- ALL INFORMATION REQUESTED BY THE CITY SHALL BE IN HAND AT THE TIME OF THE FINAL INSPECTION. NO CONDITIONAL CERTIFICATES OF OCCUPANCY SHALL BE GIVEN.
- THE CONTRACTOR SHALL VERIFY ALL UTILITY LOCATIONS PRIOR TO EXCAVATION AND TAKE ALL MEASURES NECESSARY TO PROTECT UTILITIES DURING CONSTRUCTION. SHOULD ANY UTILITY LINE OR COMPONENT BECOME DAMAGED OR REQUIRE RELOCATION THE CONTRACTOR SHALL IMMEDIATELY NOTIFY THE RESPONSIBLE UTILITY COMPANY, THE ENGINEER, AND THE CITY.

 A COPY OF THE CONTRACTORS' GENERAL LICENSE AND OR UNDER GROUND UTILITY LICENSE SHALL
- BE PROVIDED AT THE TIME OF THE PRE-CONSTRUCTION CONFERENCE.
- 10. THERE SHALL BE A MINIMUM THREE (3) DAYS NOTICE GIVEN FOR SCHEDULING THE FINAL INSPECTION.
- 11. DETECTABLE WARNINGS WILL UTILIZE PAVERS UNLESS ALTERNATIVE IS APPROVED BY CITY.

CITY EROSION CONTROL NOTES:

- 12. PURSUANT TO COMPREHENSIVE PLAN POLICY 9:1 OF THE CONSERVATION ELEMENT, THE USE OF ONE OR MORE EROSION CONTROL MEASURES, AS REQUESTED BY THE CITY OF G.C.S. ENGINEERING DEPARTMENT, SHALL BE USED DURING CONSTRUCTION. THESE WILL BE, BUT NOT LIMITED TO, ITEMS SUCH AS TEMPORARY GRASS COVER, SEDIMENT BASINS OR PONDS, MULCHING, TEMPORARY FENCES, DIVERSION CHANNELS AND
- PURSUANT TO COMPREHENSIVE PLAN POLICY 9:1 OF THE CONSERVATION ELEMENT, SCHEDULING OF CONSTRUCTION SHALL BE GIVEN SPECIAL CONSIDERATION TO MINIMIZE EXPOSURE OF BARE SOIL. THE CONTRACTOR WILL FORMULATE A CONSTRUCTION SCHEDULE TO BE GIVEN TO THE CITY REPRESENTATIVE.
- THE CONTRACTOR SHALL CHECK EACH DAY TO INSURE THAT ALL EROSION CONTROL DEVICES ARE IN PLACE AND WORKING PROPERLY.
- ALL EROSION CONTROL MEASURES SHALL BE IN COMPLIANCE WITH THE RULES, REGULATION AND STANDARDS OF THE ST. JOHNS RIVER WATER MANAGEMENT DISTRICT (SJRWMD), THE FLORIDA DEPARTMENT OF ENVIRONMENTAL PROTECTION (FDEP) AND THE UNITED STATE ARMY CORP OF ENGINEERS.
- THE CONTRACTOR SHALL TAKE WHATEVER MEANS NECESSARY TO PREVENT THE EROSION OF SOIL AND DEPOSITION OF SEDIMENT ON ADJACENT AND DOWNSTREAM PROPERTIES.
- 17. ALL EROSION CONTROL MEASURES SHALL BE INSTALLED PRIOR TO CONSTRUCTION.

CITY PUBLIC SAFETY NOTES:

- 18. BLUE, ALL DIRECTIONAL HIGHWAY-STYLE REFLECTIVE MARKERS SHALL BE PROVIDED ON ALL ROADWAYS, ALLEYS, ACCESS ROADS AND ALL PAVED AREA IN FRONT OF EACH HYDRANT. SAID MARKERS SHALL BE LOCATED IN THE LANE OF TRAVEL ON THE SAME SIDE AS THE HYDRANT. THESE MARKERS SHALL BE IN PLACE AT THE TIME OF FINAL INSPECTION OR APPROVAL.
- COMPACTION DENSITIES FOR ALL ROADWAY CROSSINGS ARE TO BE TAKEN IN ONE-FOOT (1') LIFTS. STORM SEWER PIPE DENSITIES WILL START AT THE HAUNCHES OF THE PIPE AND BE TAKEN EVERY 6" UNTIL IS REACHED 1' ABOVE THE PIPE.
- ALL STORM SEWER PIPES SHALL BE CUT FLUSH WITH THE INTERIOR WALL OF ANY TYPE MANHOLE OR CURB AND DITCH BOTTOM INLETS.
- 21. THE ASPHALT SHALL BE CORED FOR THICKNESS AND WILL BE GIVEN A ONE-QUARTER INCH (1/4") TOLERANCE. IF HOWEVER THE CITY'S REPRESENTATIVE IS PRESENT AT POUR AND FEELS COMFORTABLE WITH THE REQUIREMENTS THEN HE OR SHE MAY WAVE THIS POLICY.
- 22. LBR'S FOR SUBGRADE AT FORTY (40) AND LIME ROCK OR ALTERNATIVE BASE COURSE AT ONE HUNDRED (100). THERE WILL BE NO UNDER TOLERANCE.
- 23. ALL MATERIAL USED FOR BACK FILL SHALL BE SAND (A3) FREE DRAINING.
- 24. THERE ARE TO BE NO OPENED TRENCHES AT DAY'S END.
- ALL DIRT AND DEBRIS TRACKED OUT OF THE PROJECT SHALL BE CLEANED DAILY AND TO THE DISCRETION OF THE CITY OF G.C.S. ENGINEERING DEPARTMENT.
- 26. ALL ROAD CLOSURES MUST BE APPROVED WITH 24 HOUR NOTICE

REVISIONS DESCRIPTION DESCRIPTION JOHN D. WESTCOTT P.E. NO. 88357 4371 U.S. HIGHWAY 17 SOUTH, SUITE 203 FLEMING ISLAND, FL 32003




CITY OF GREEN COVE SPRINGS


PREPARED FOR


GENERAL NOTES


REF. DWG. NO.


SHEET NO. WALNUT STREET

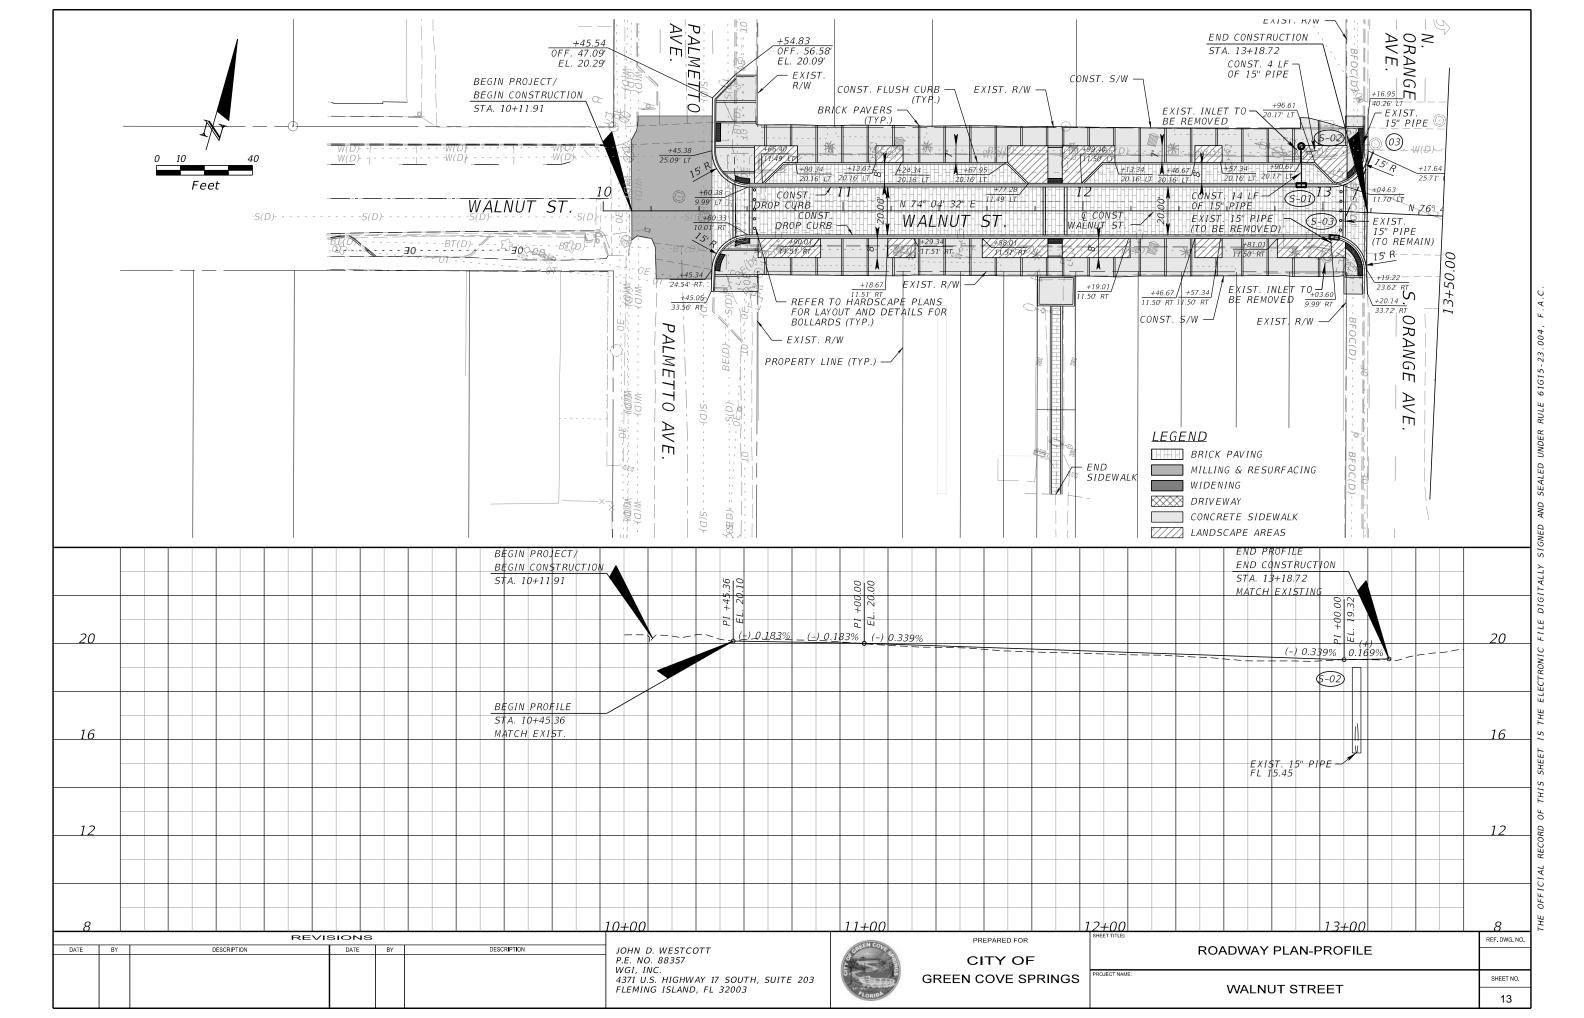


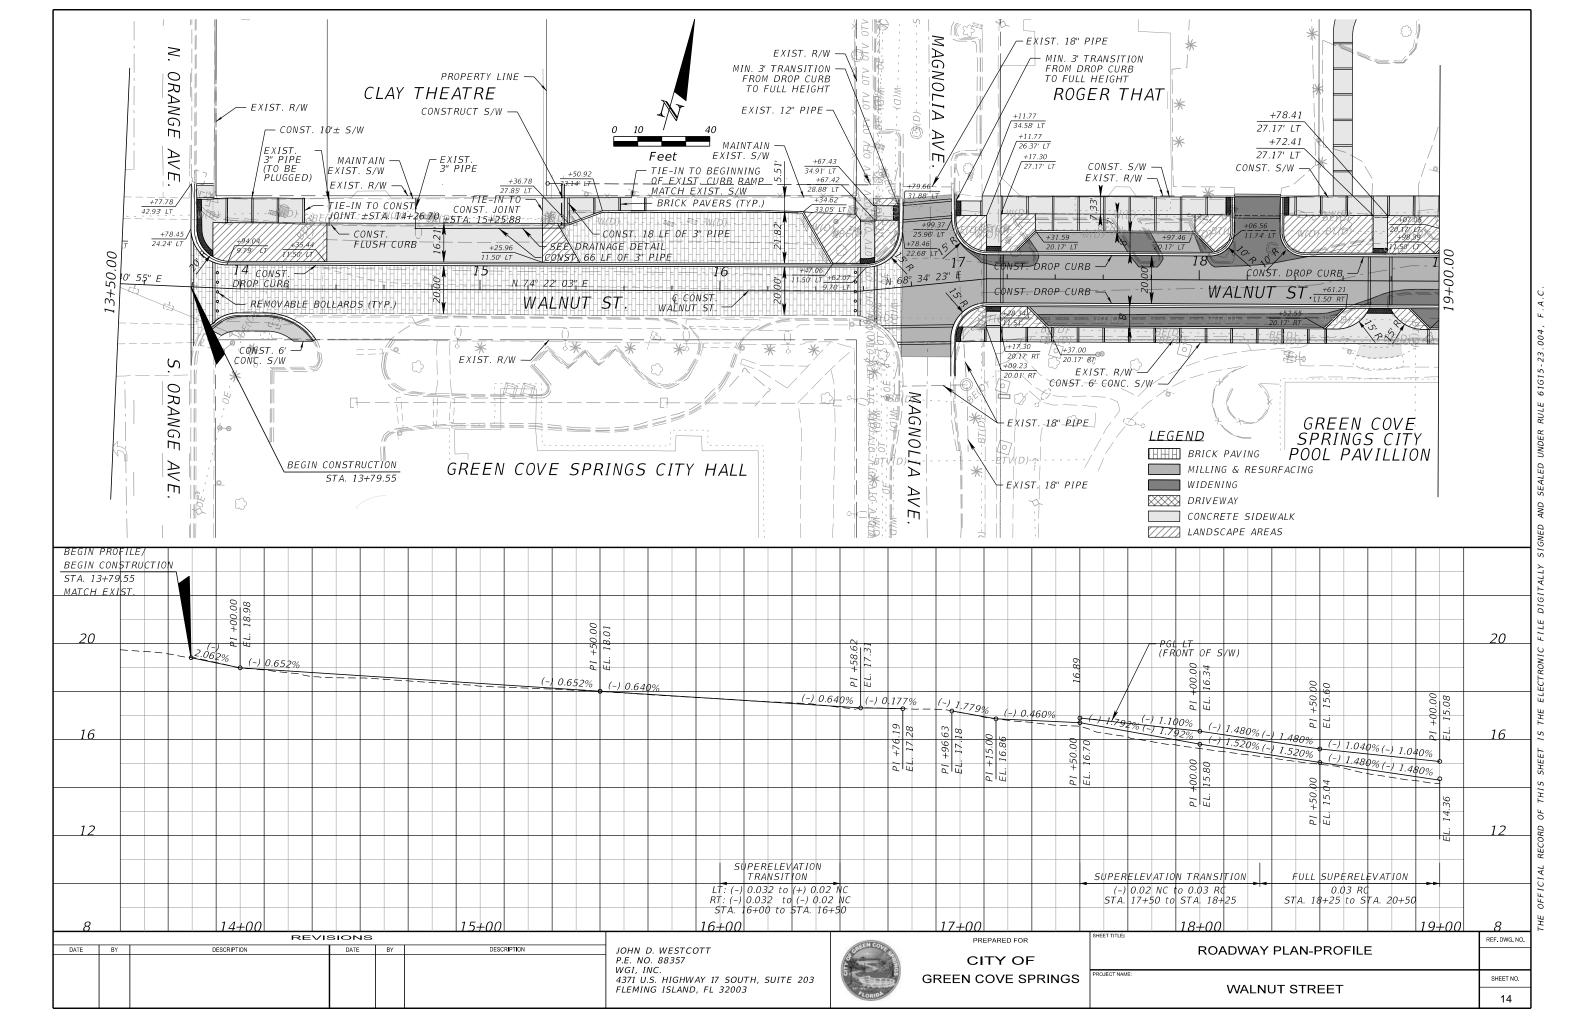


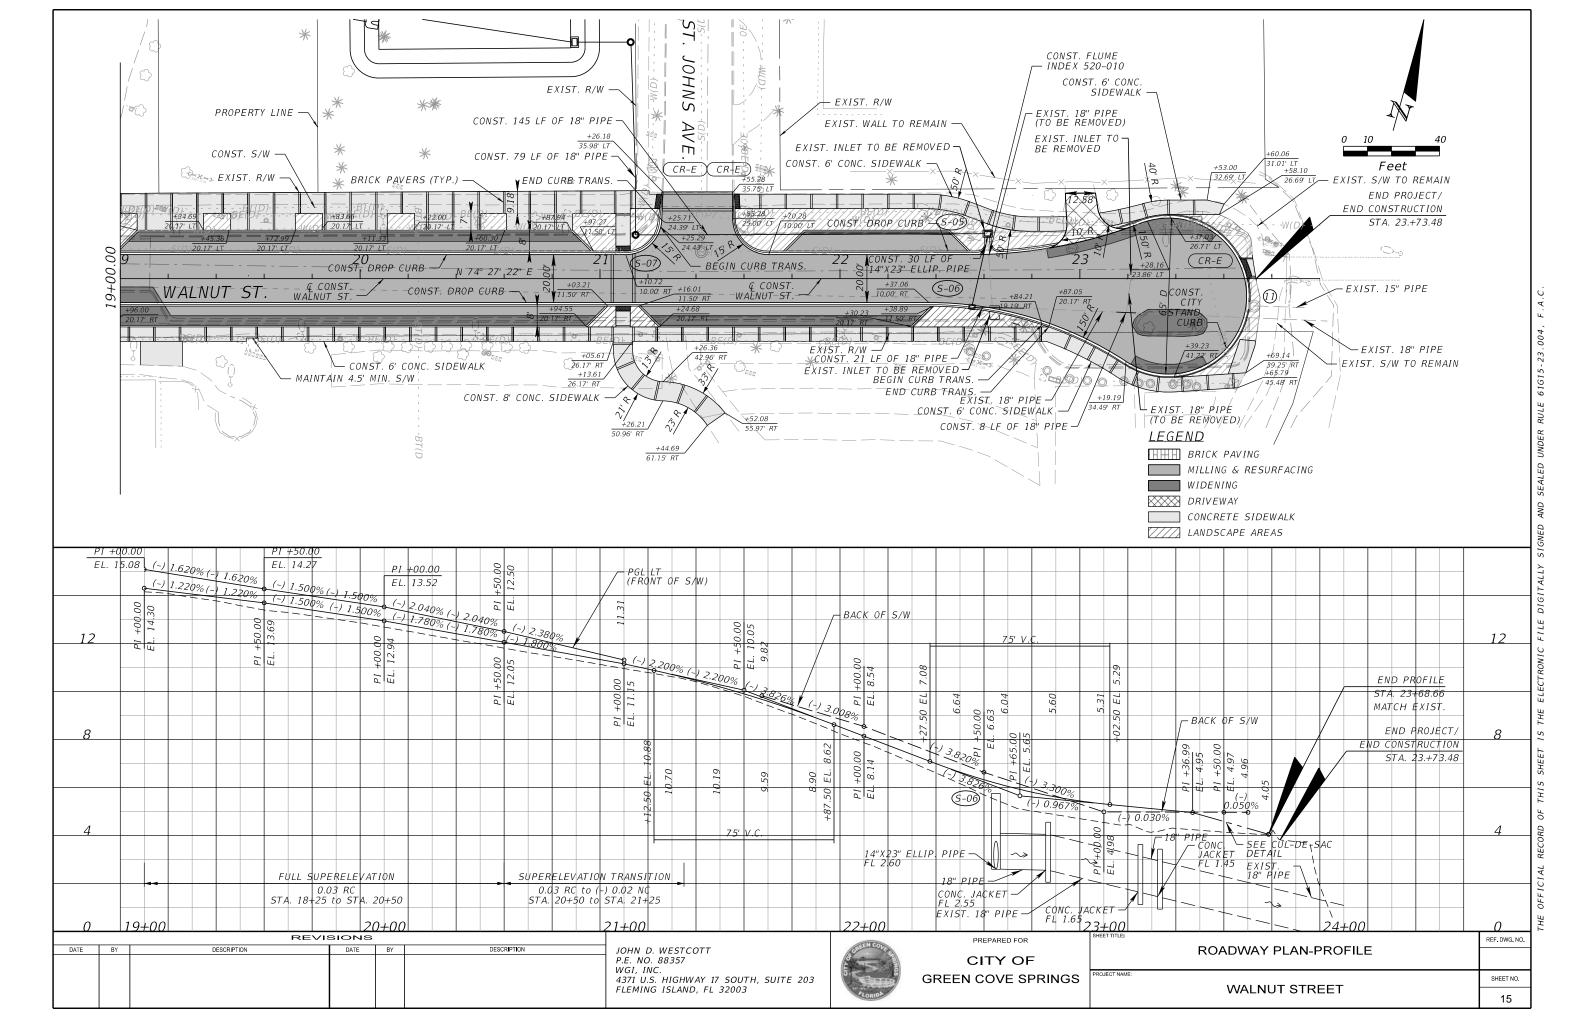


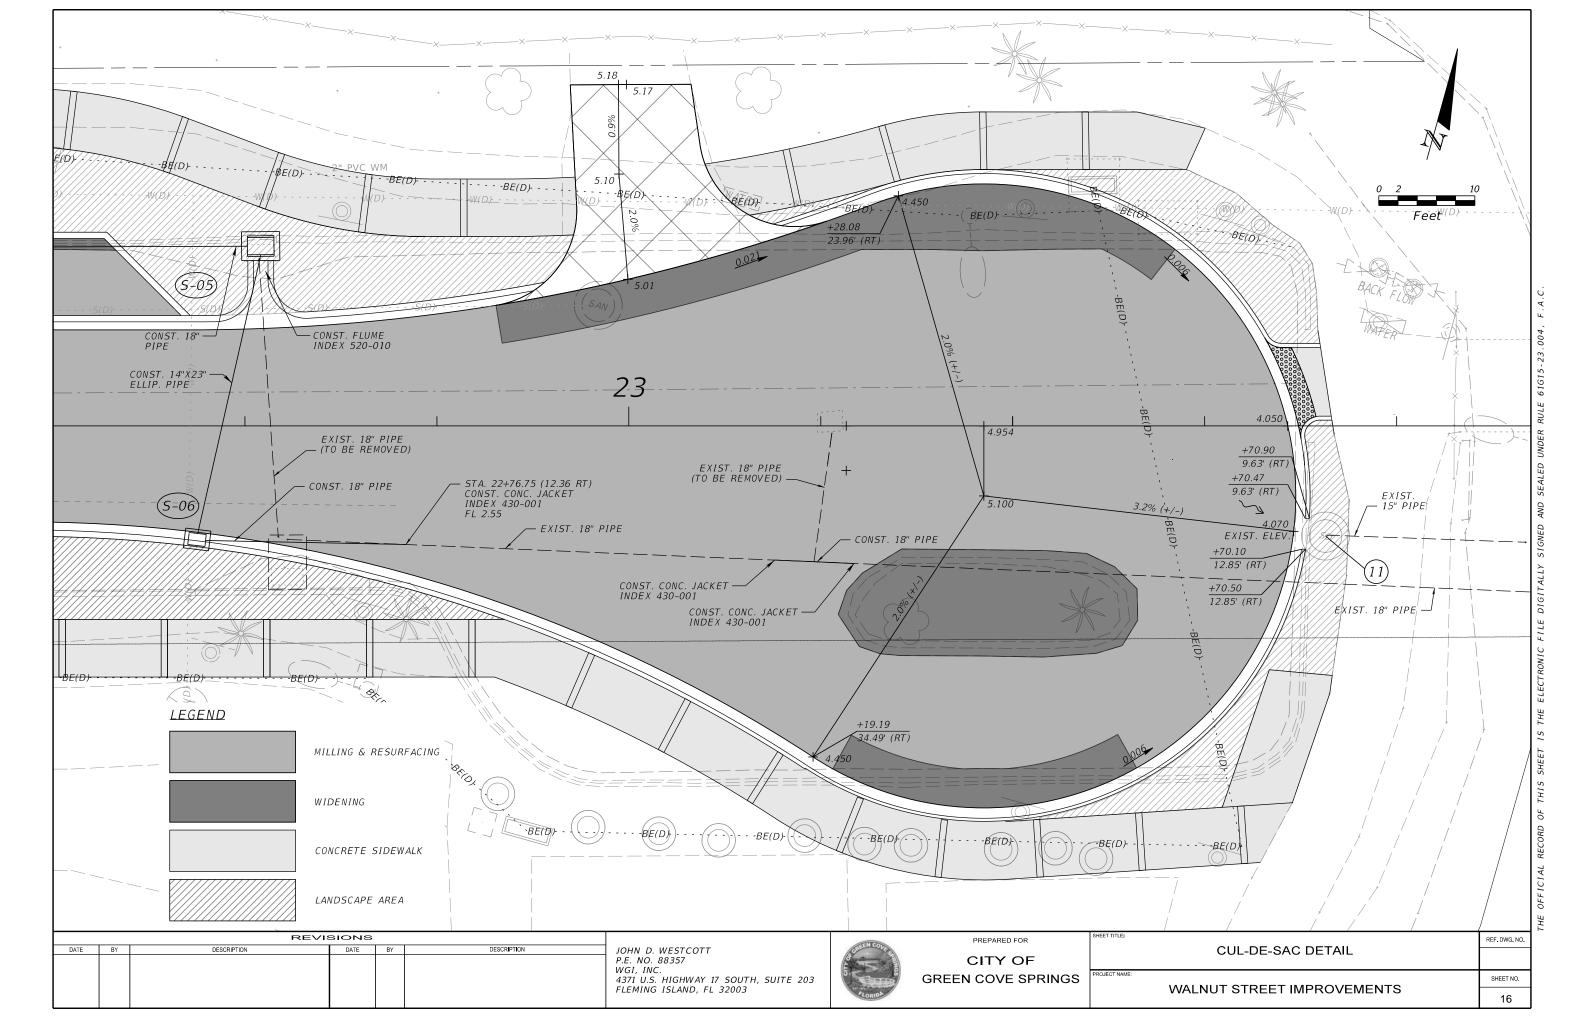


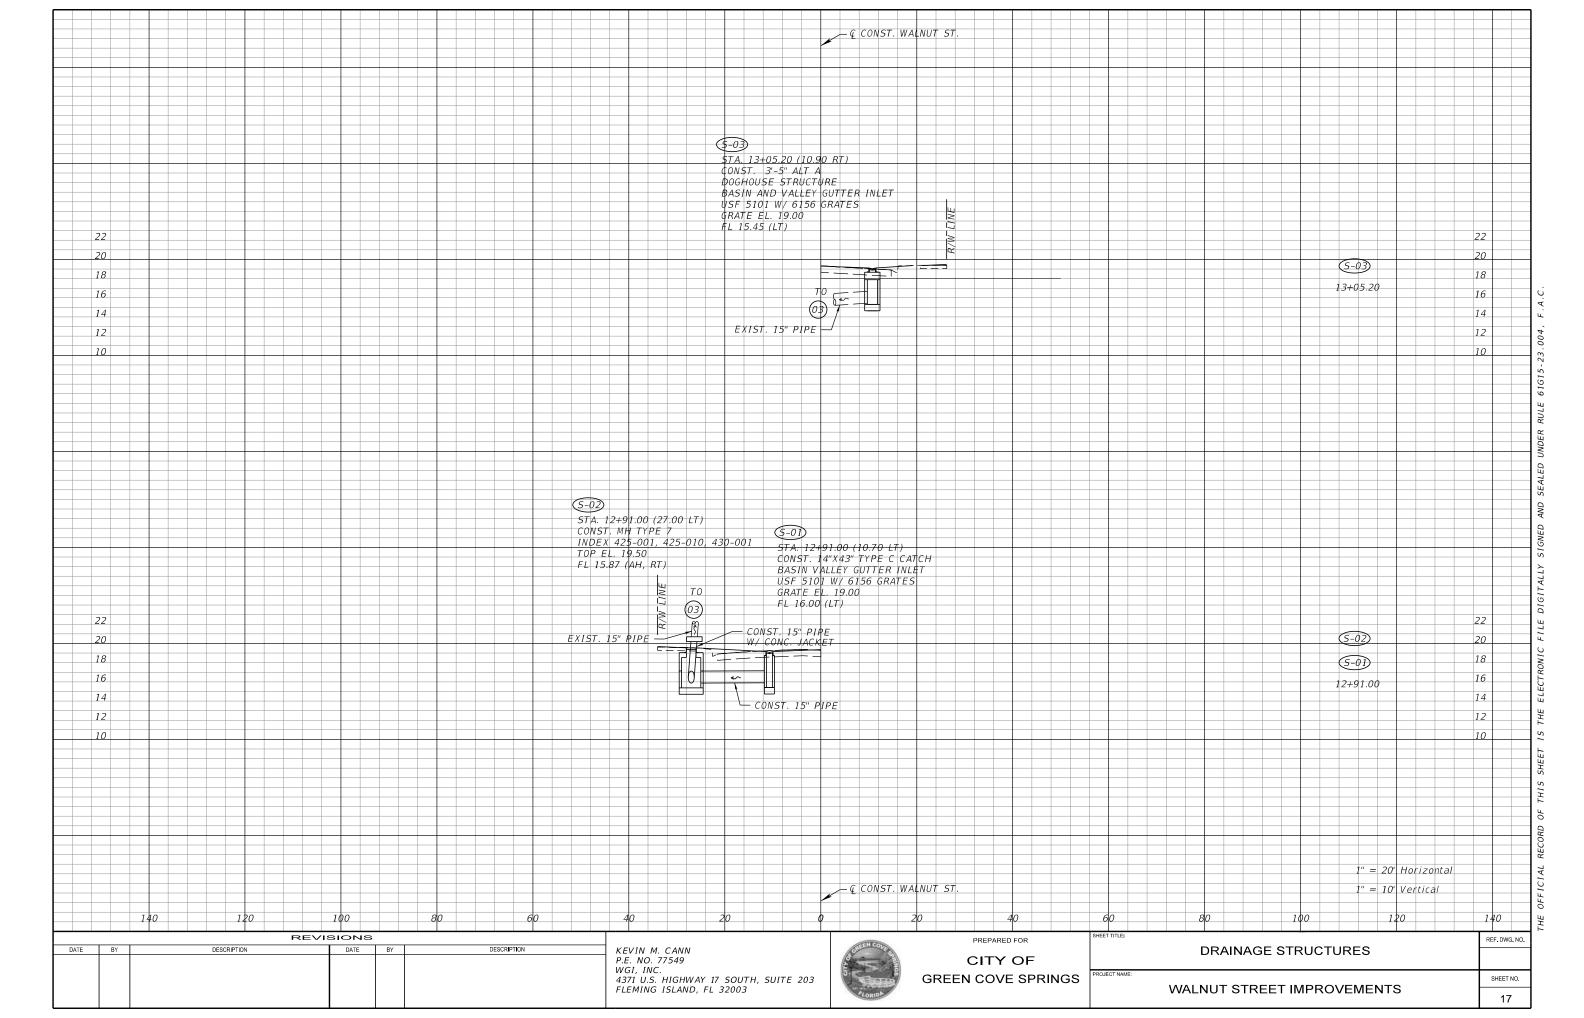


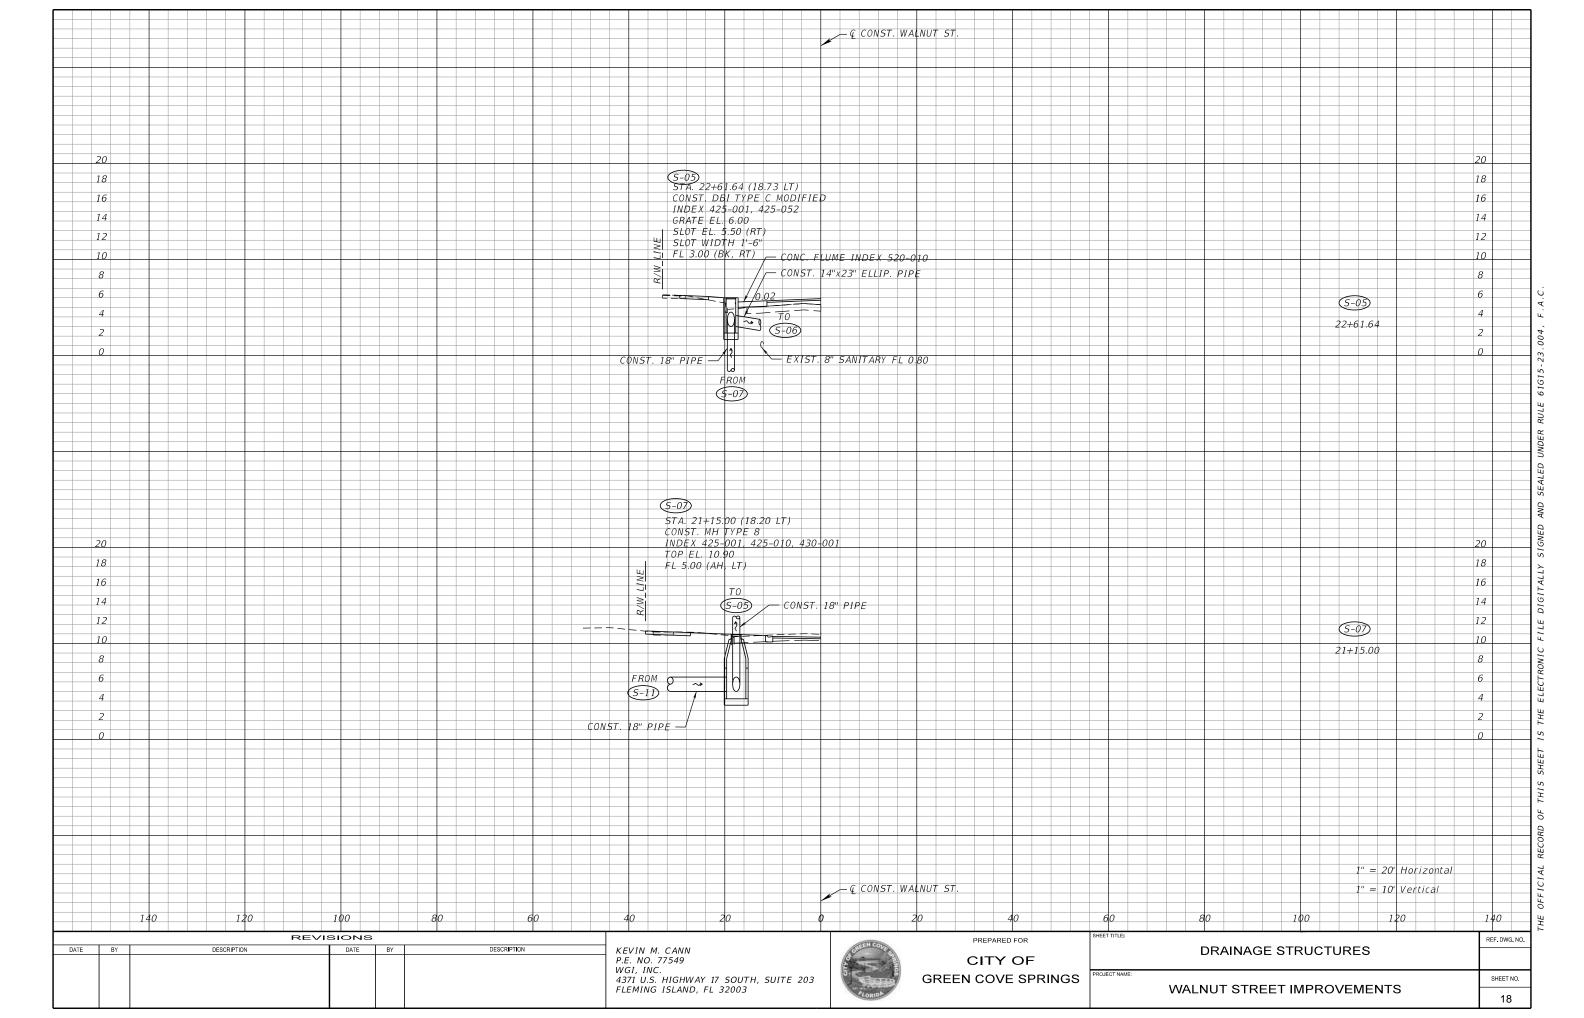


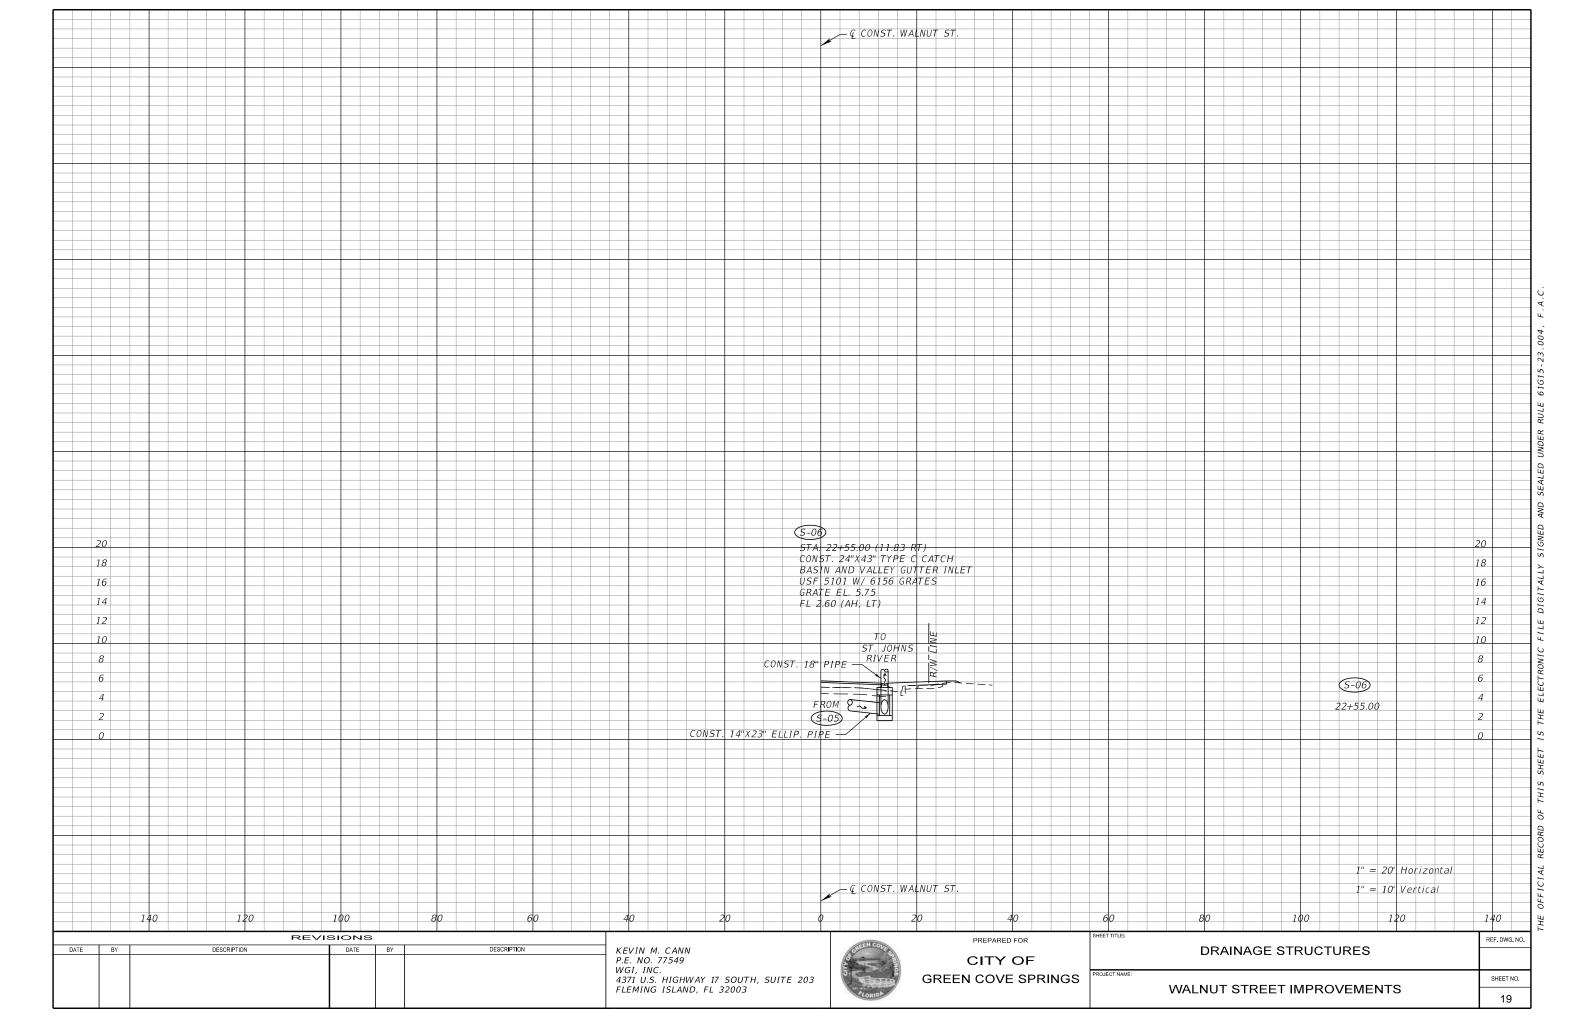


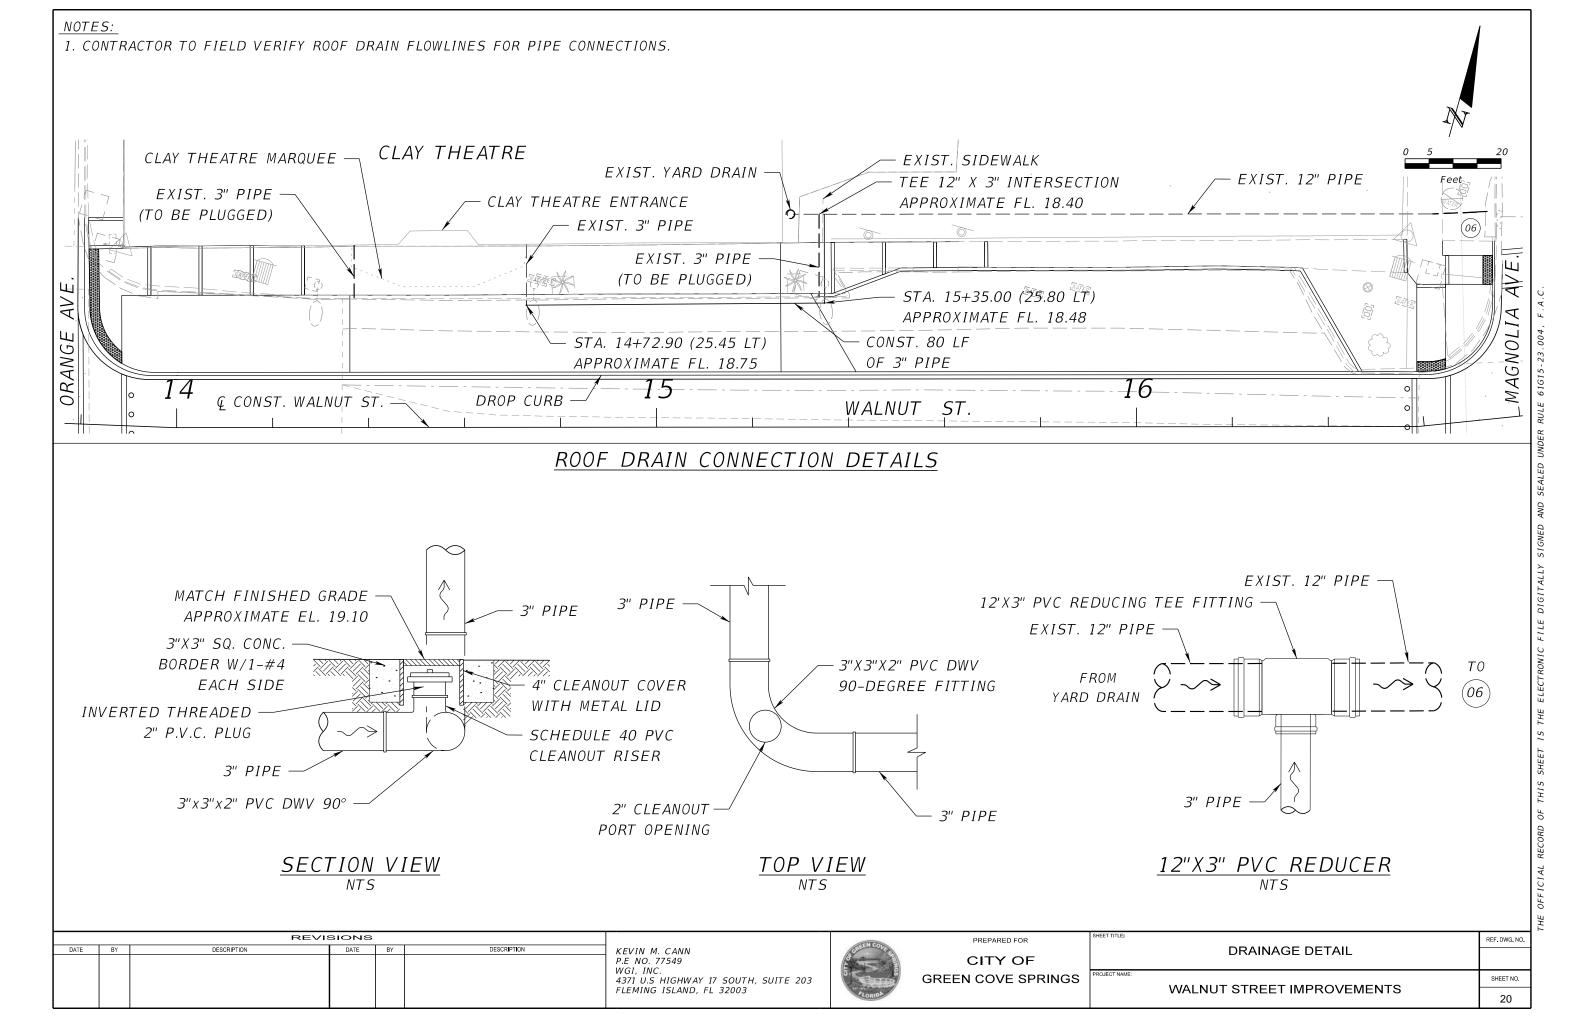


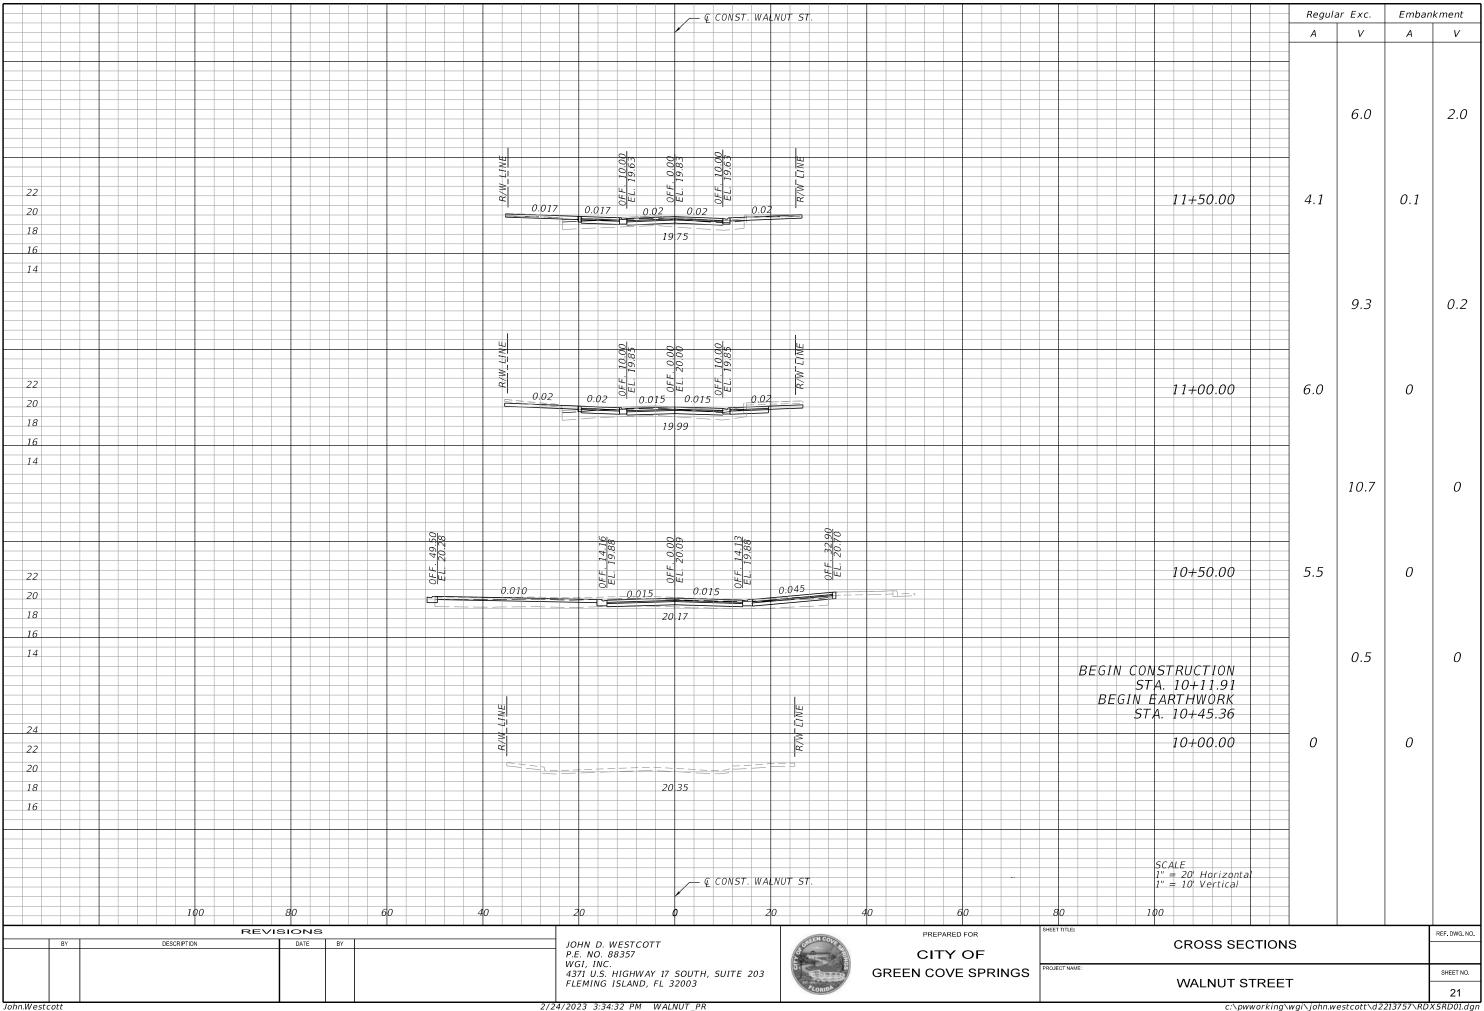


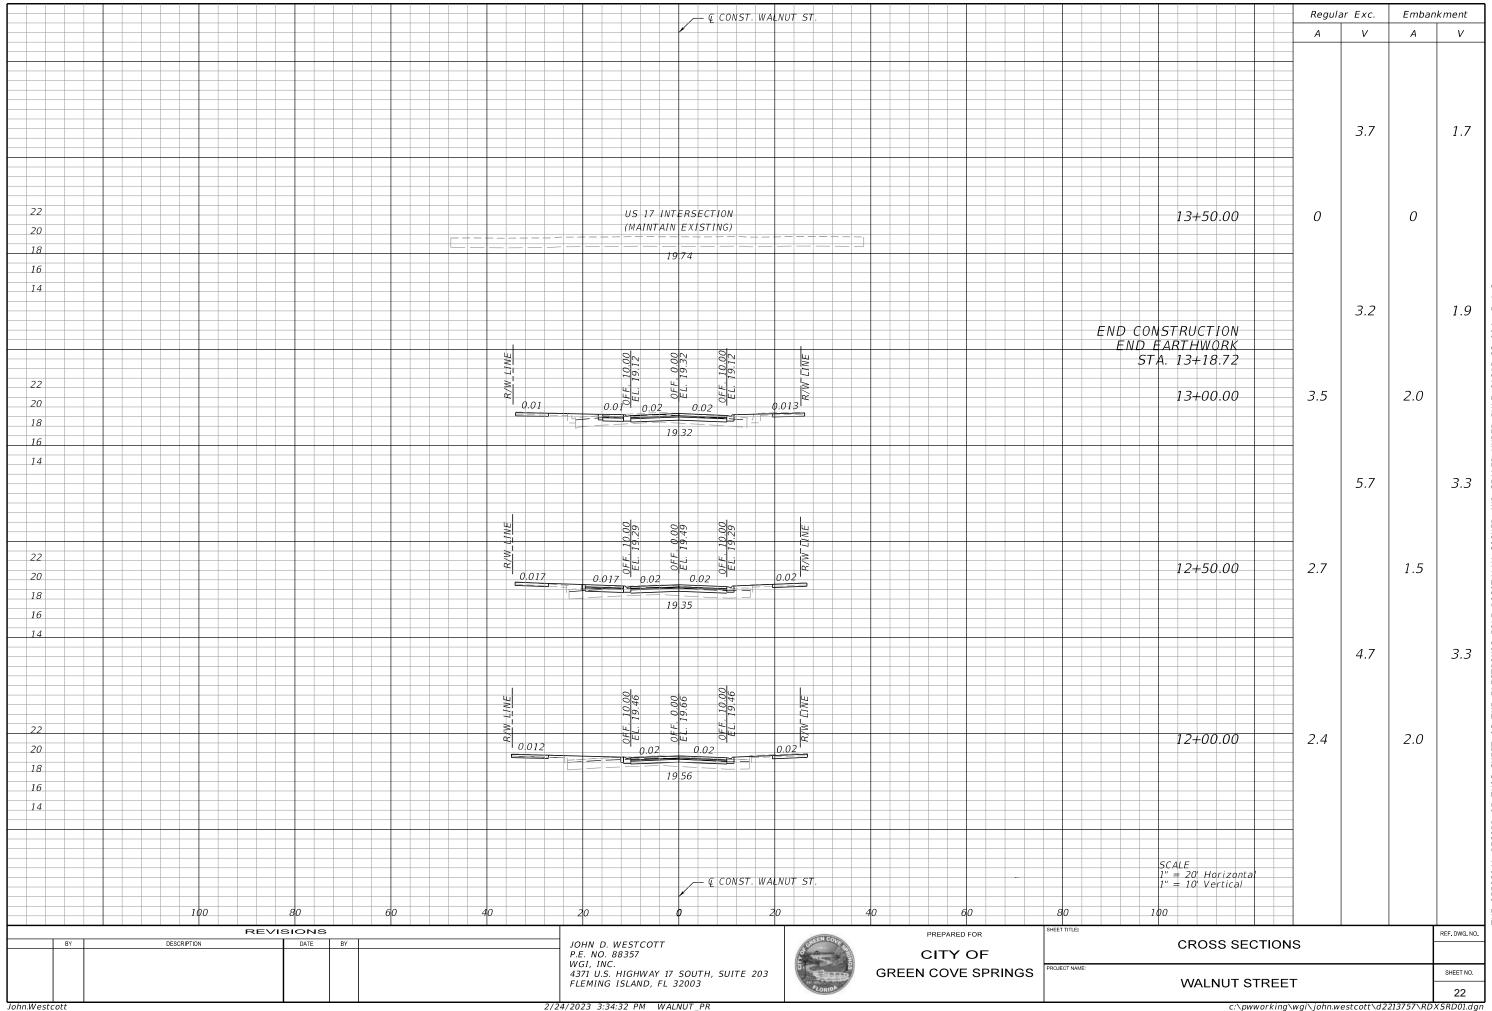


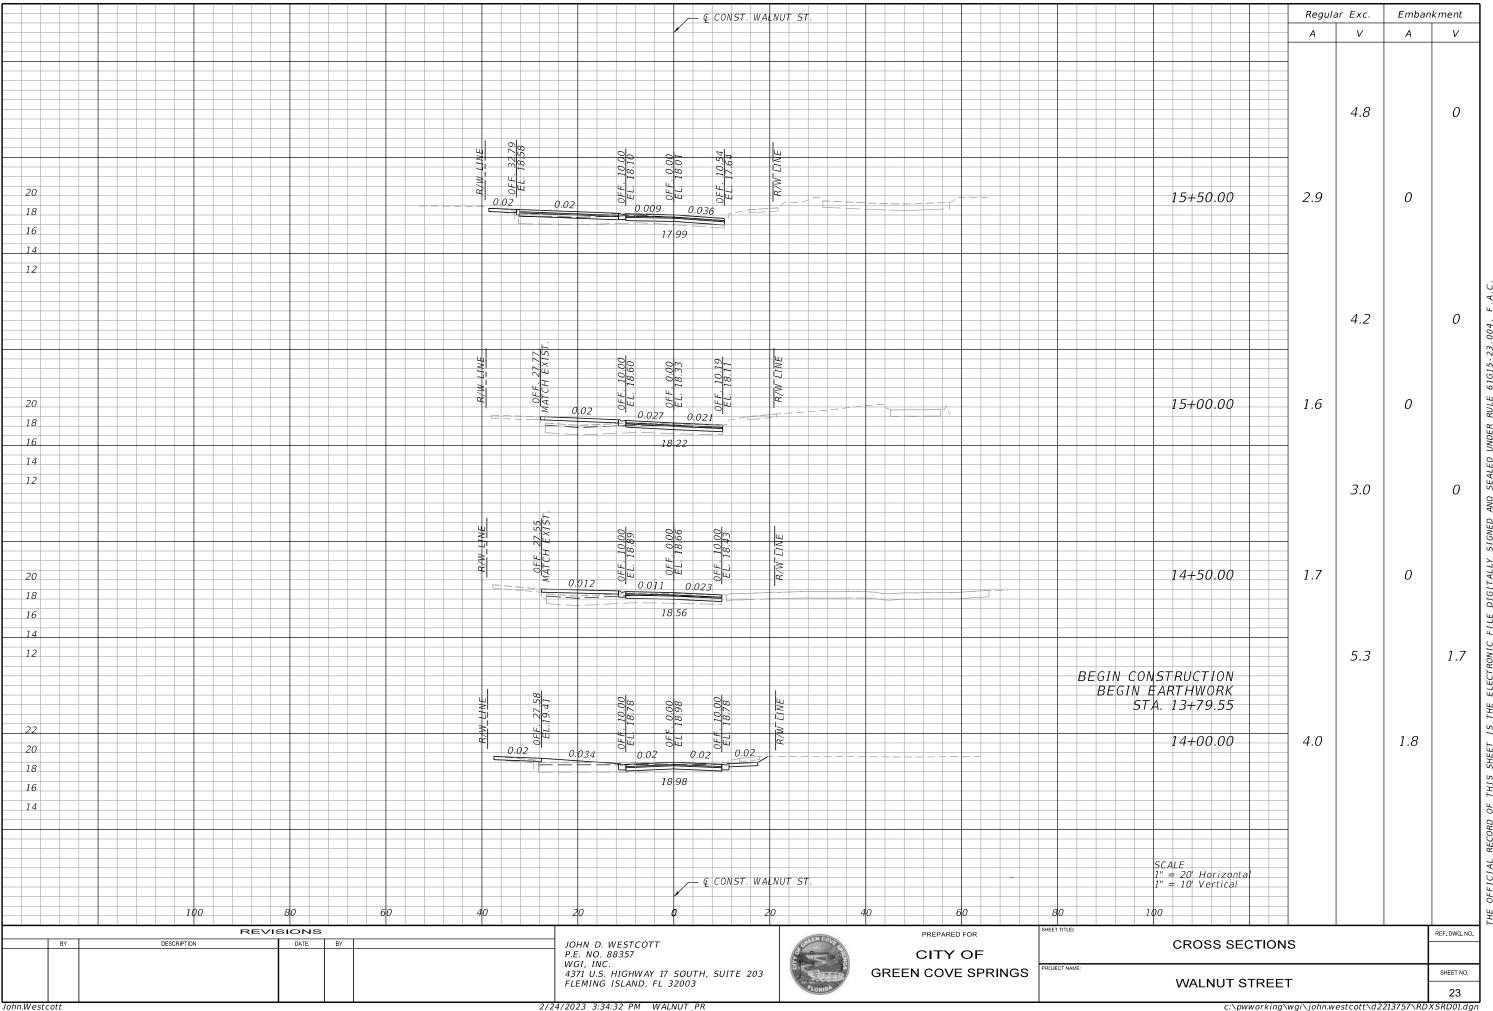


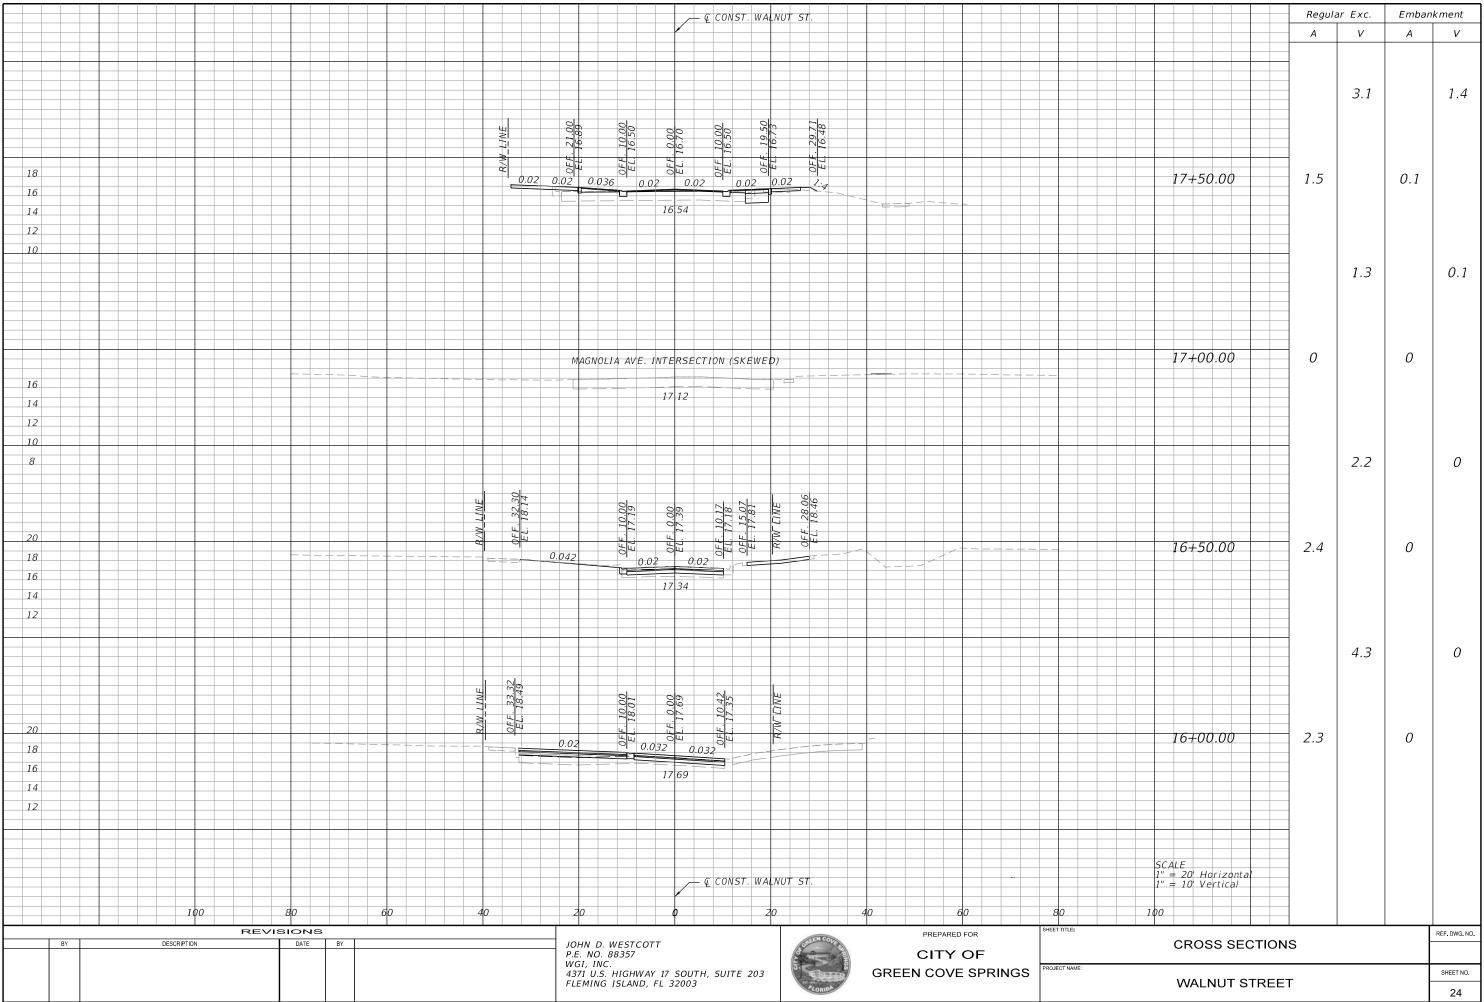


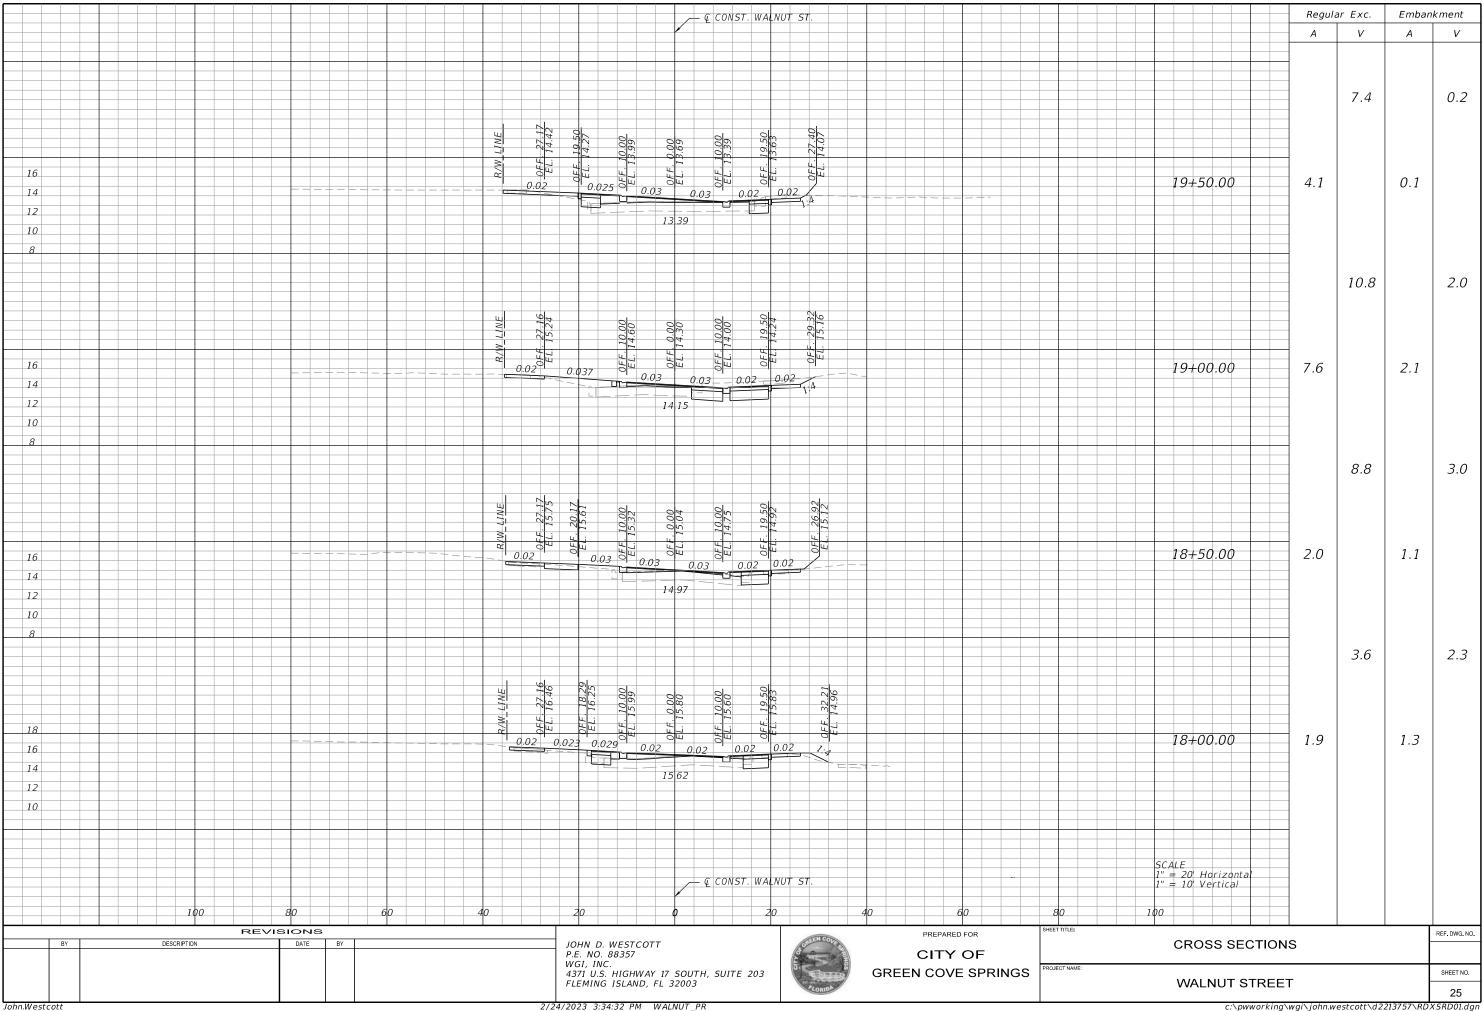


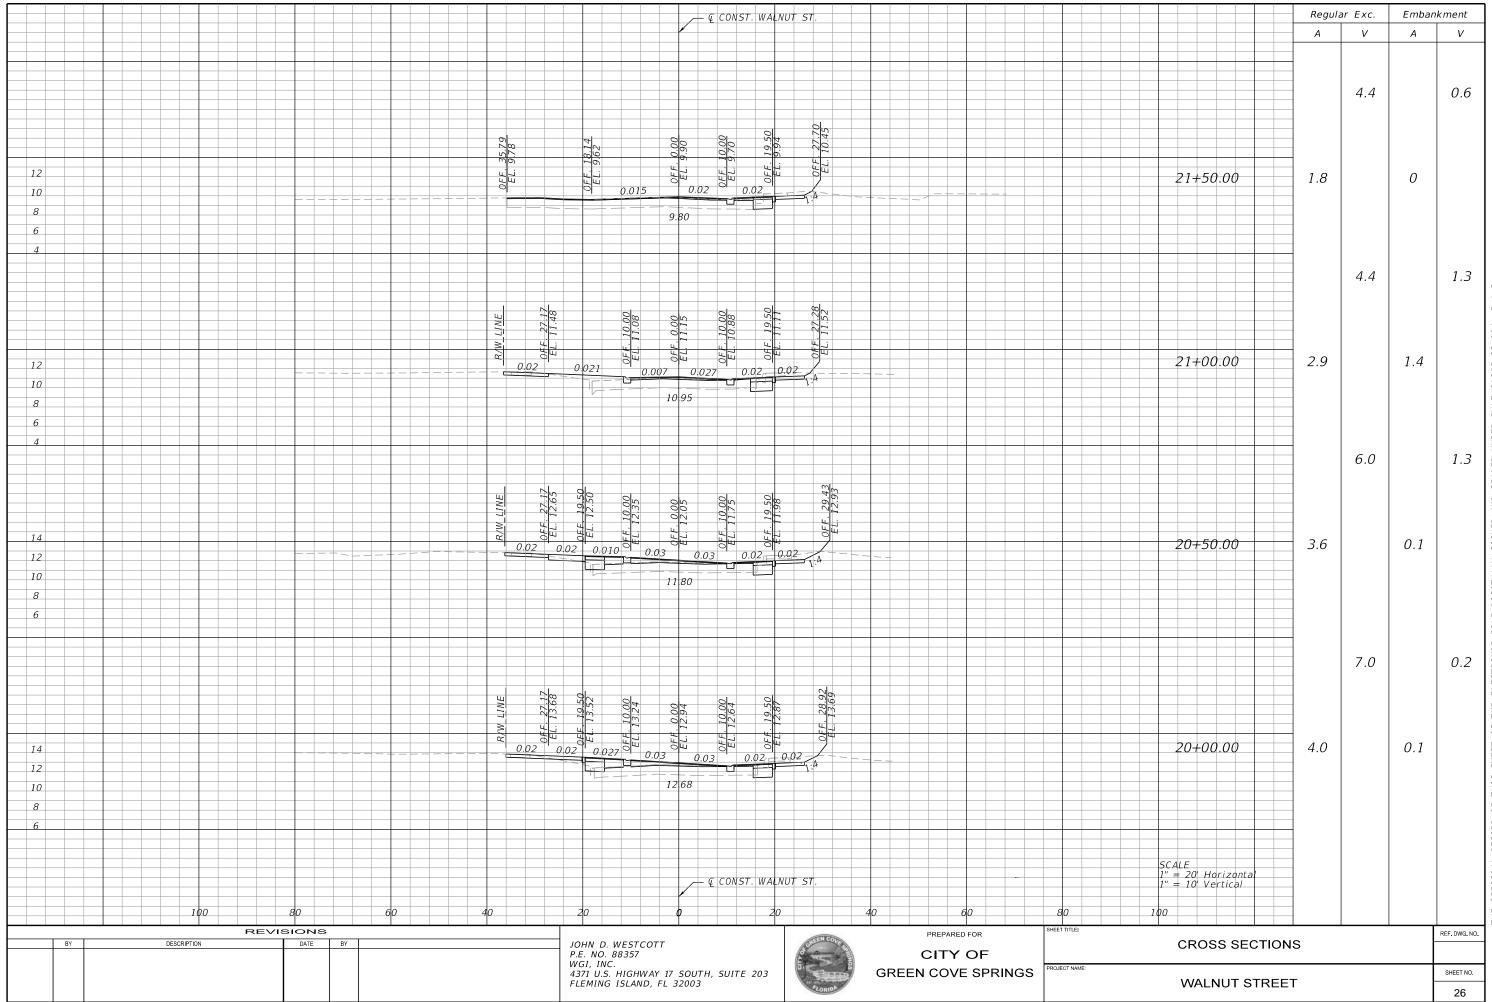

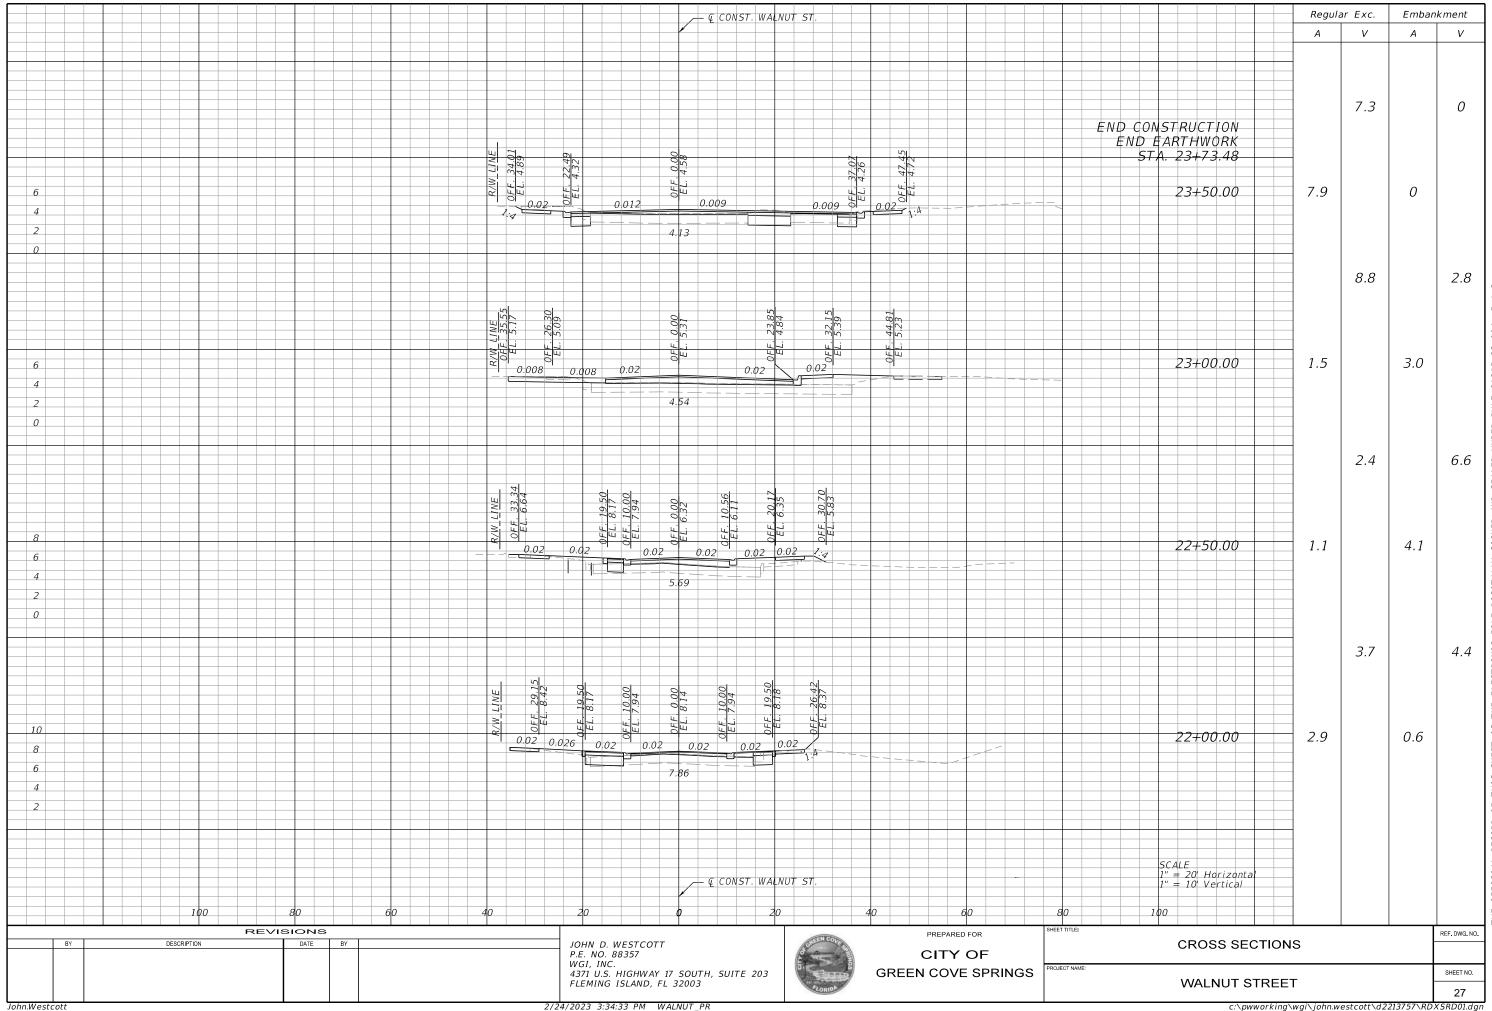

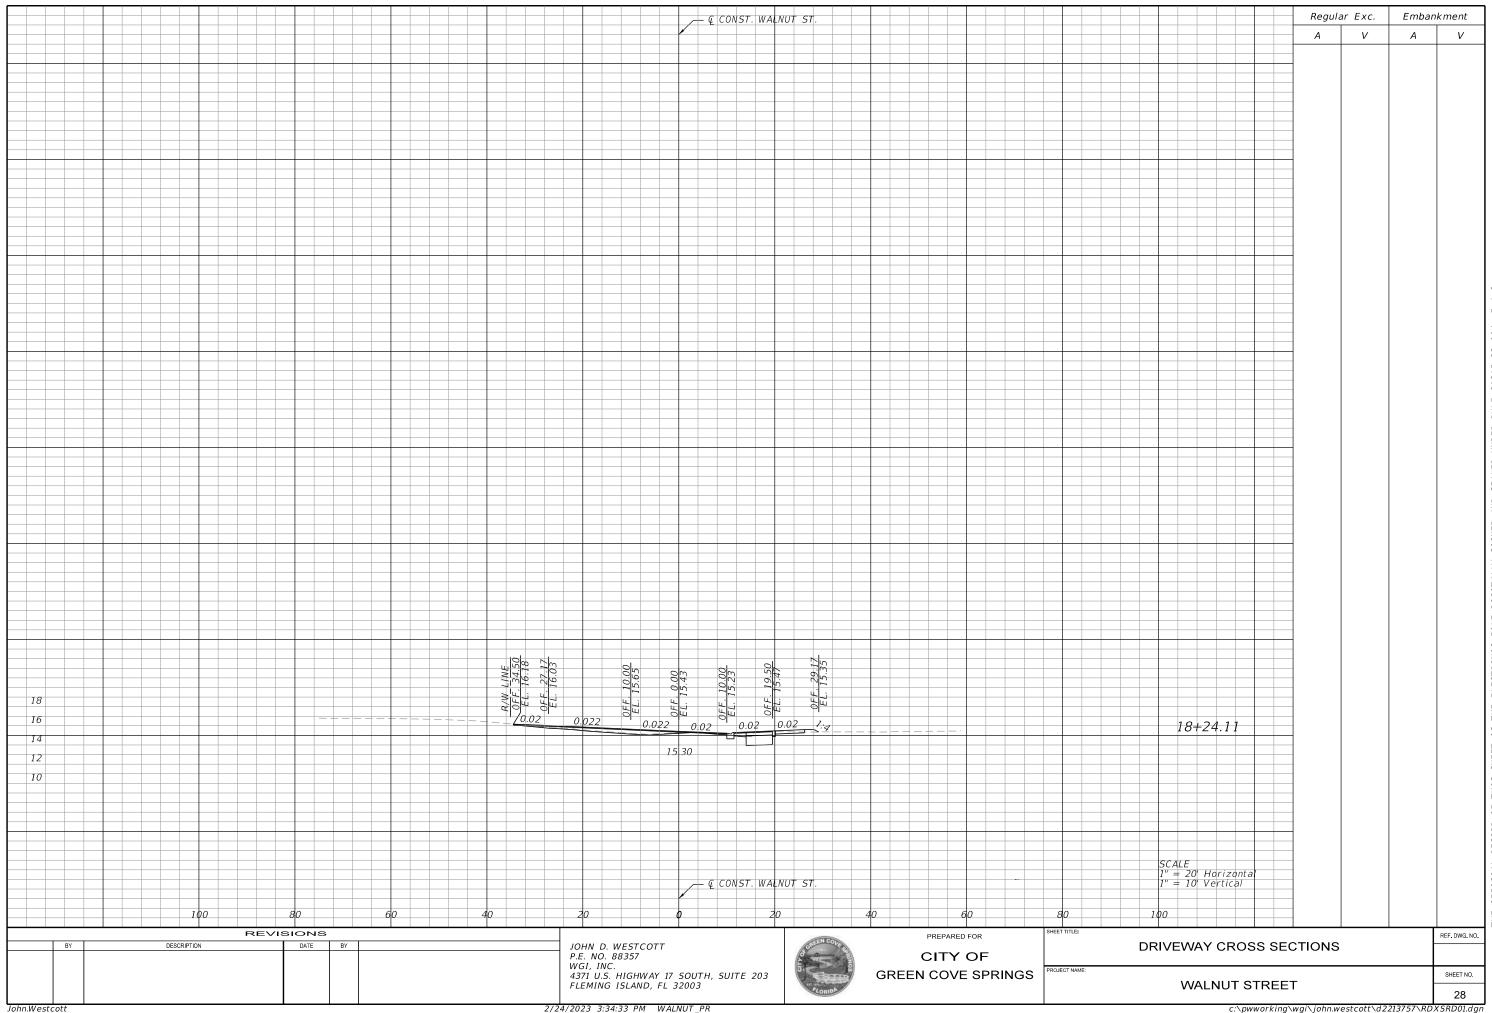

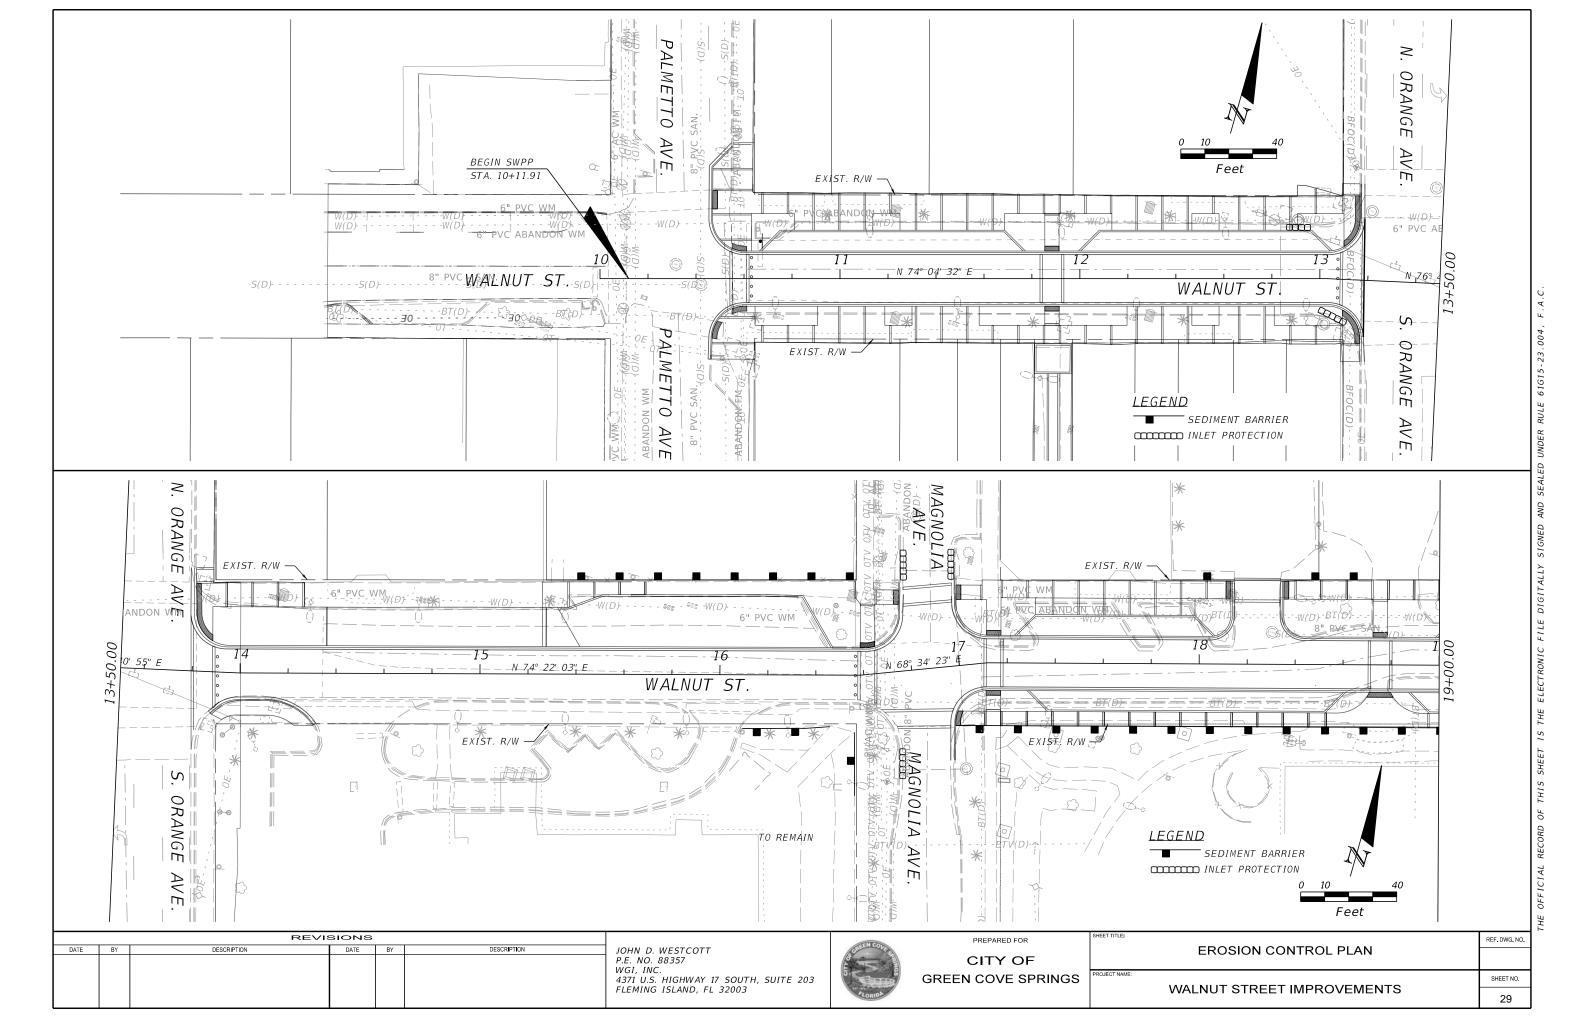

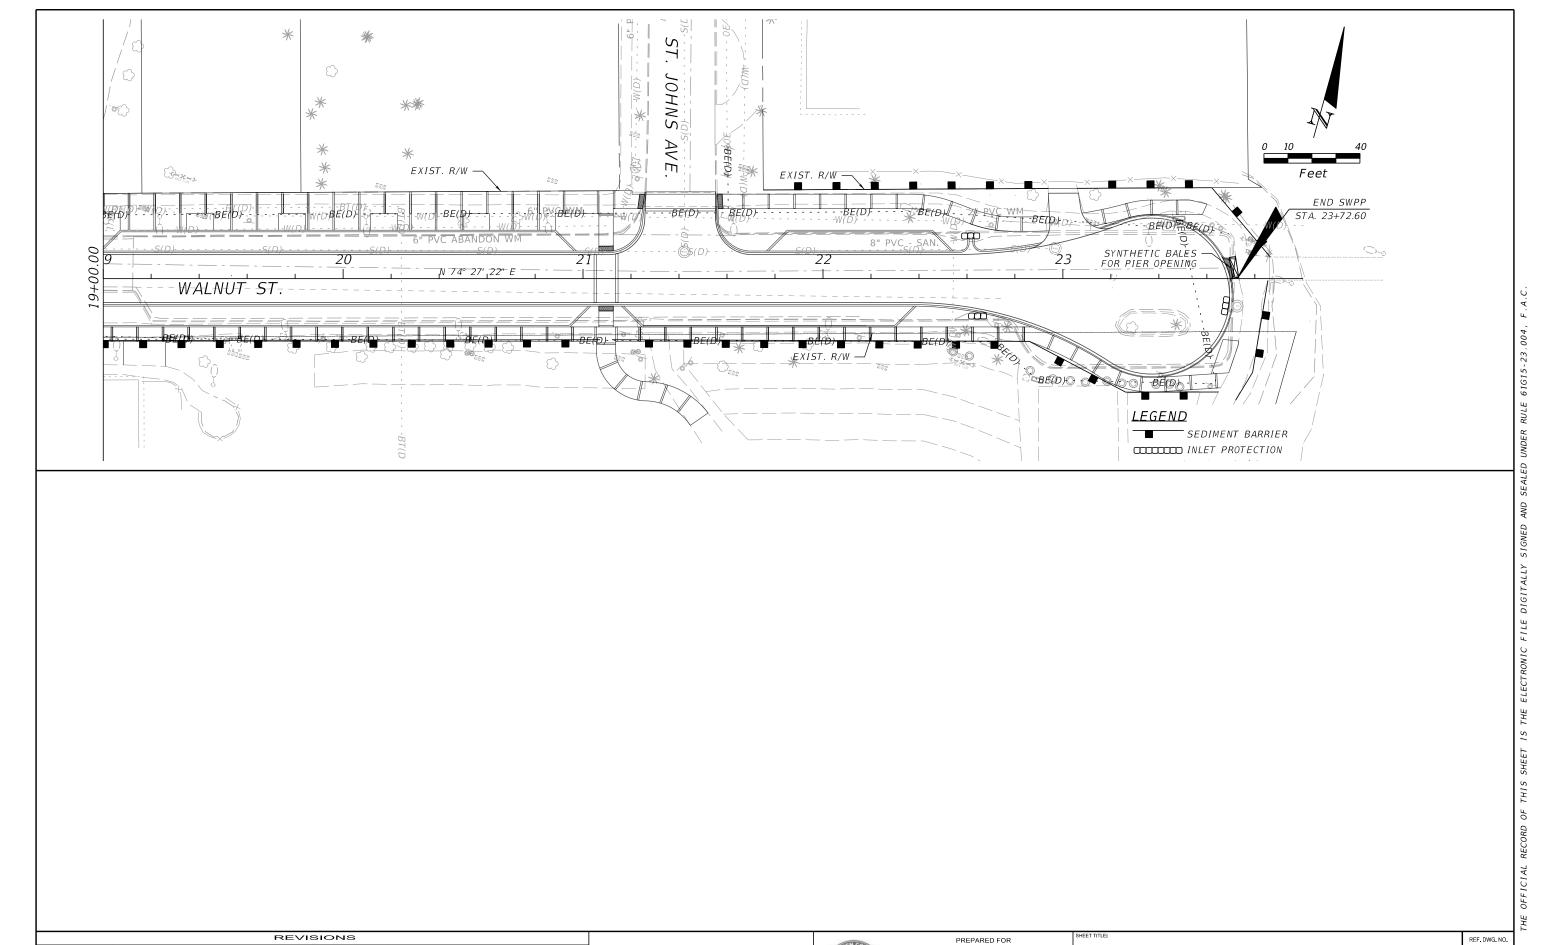

BY DESCRIPTION DATE BY DESCRIPTION JOHN D. WESTCOTT P.E. NO. 88357 WGI, INC. 4371 U.S. HIGHWAY 17 SOUTH, SUITE 203 FLEMING ISLAND, FL 32003



PREPARED FOR


CITY OF


GREEN COVE SPRINGS

EROSION CONTROL PLAN

WALNUT STREET IMPROVEMENTS 30

SHEET NO.

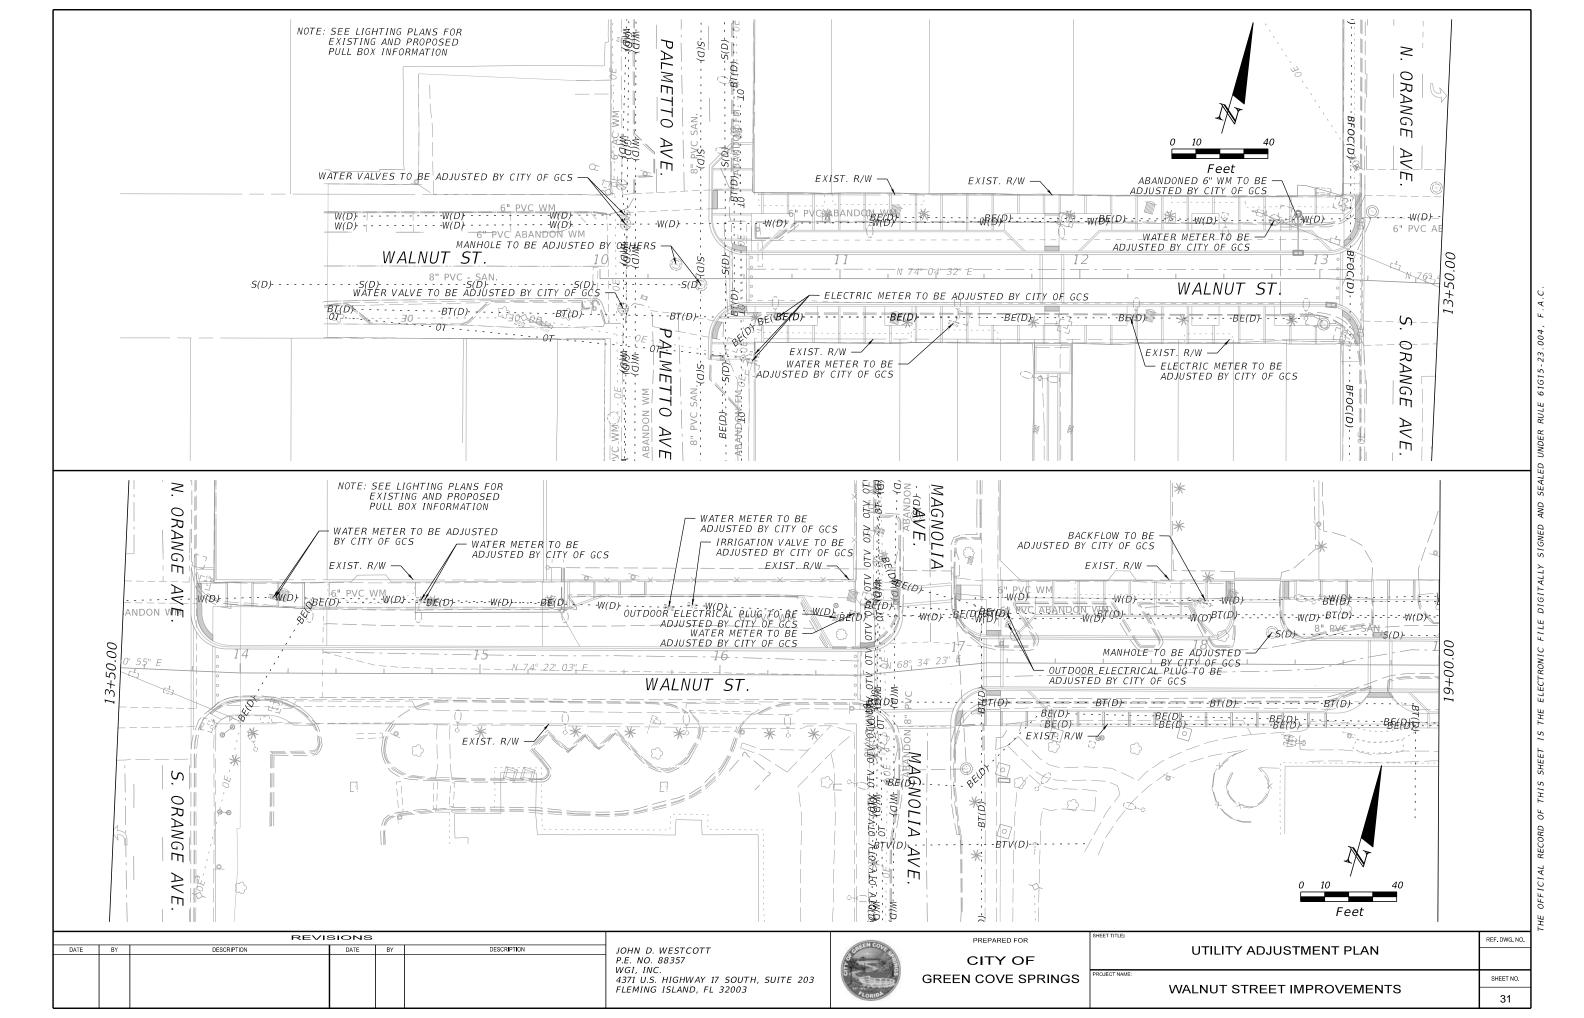

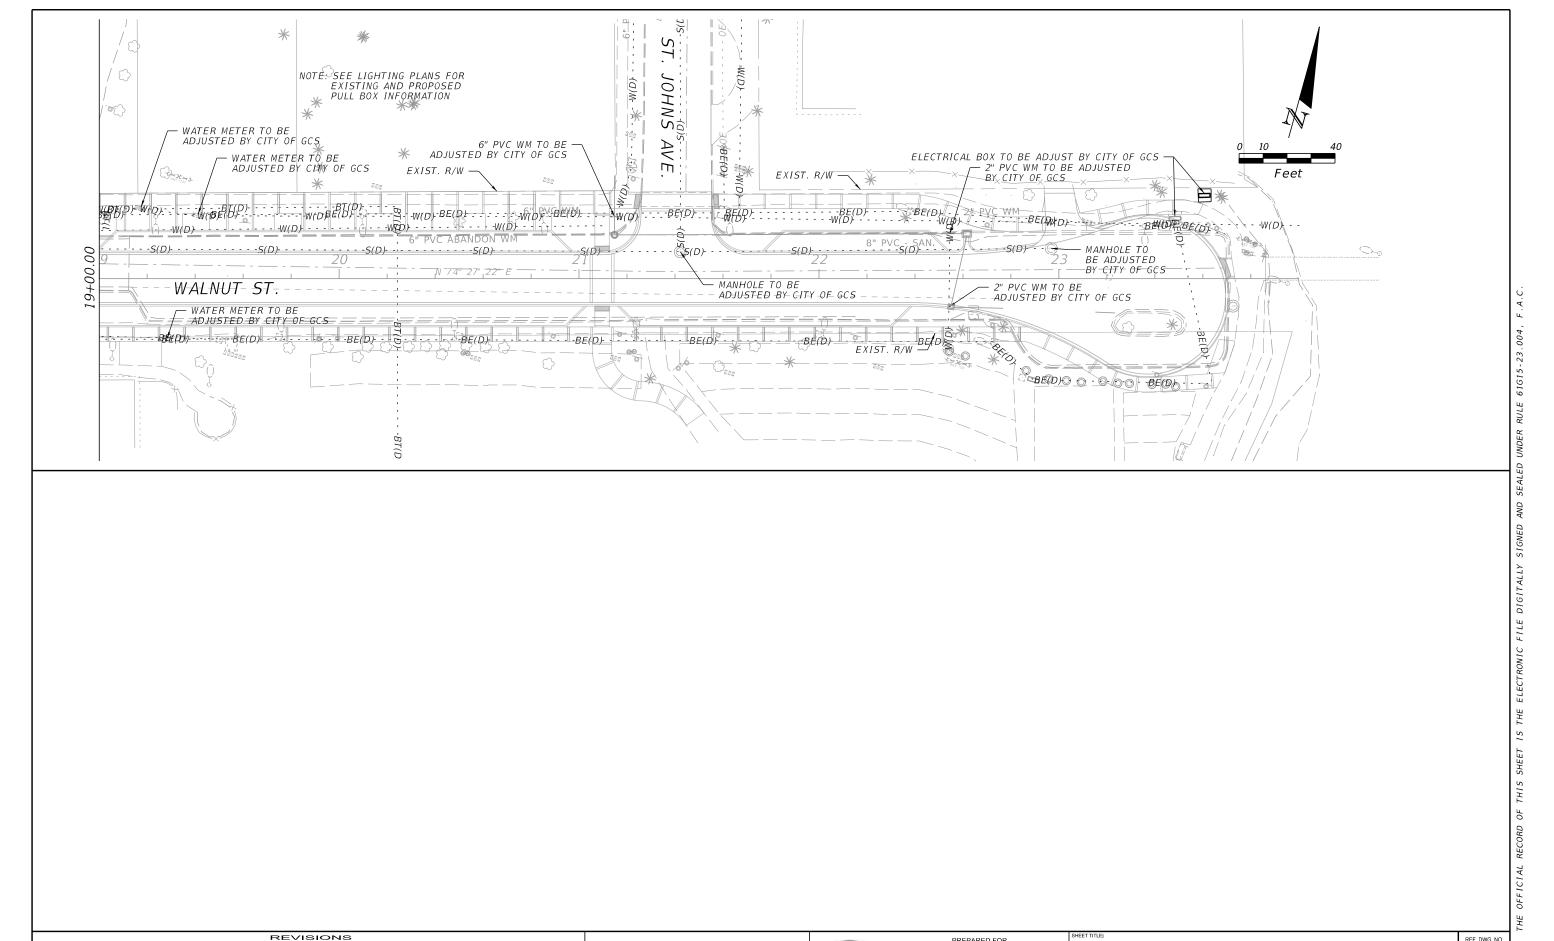

DESCRIPTION

JOHN D. WESTCOTT P.E. NO. 88357

4371 U.S. HIGHWAY 17 SOUTH, SUITE 203 FLEMING ISLAND, FL 32003

DESCRIPTION


CITY OF GREEN COVE SPRINGS


PREPARED FOR


UTILITY ADJUSTMENT PLAN

SHEET NO. WALNUT STREET IMPROVEMENTS 32


REF. DWG. NO.

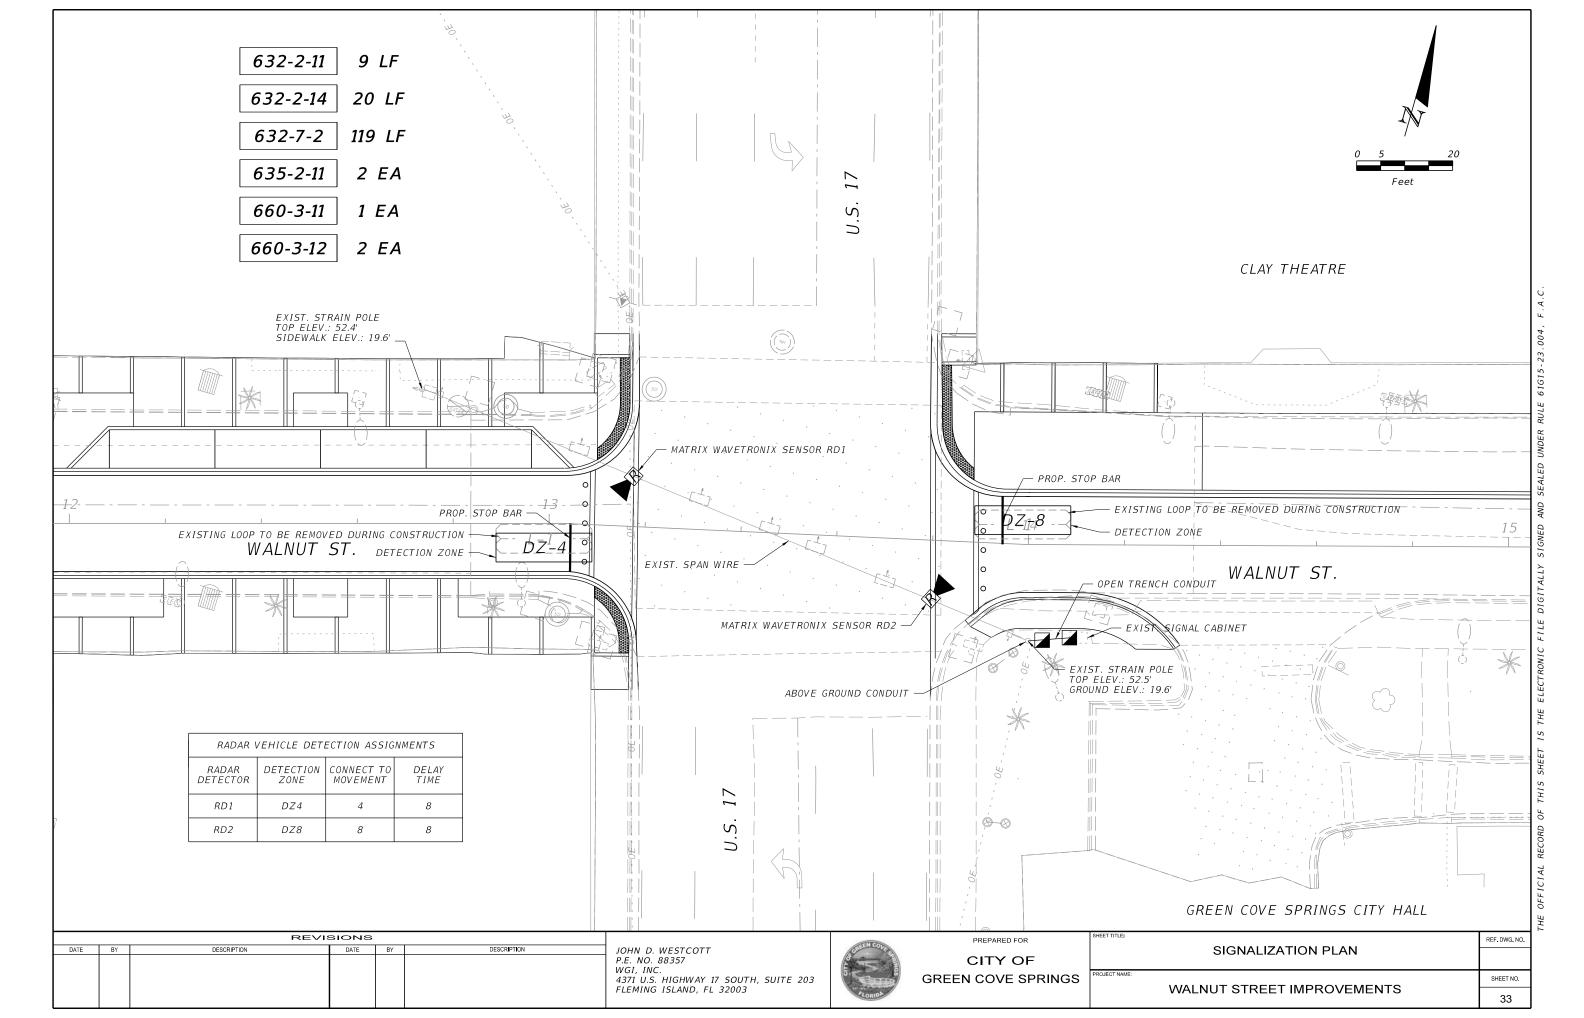

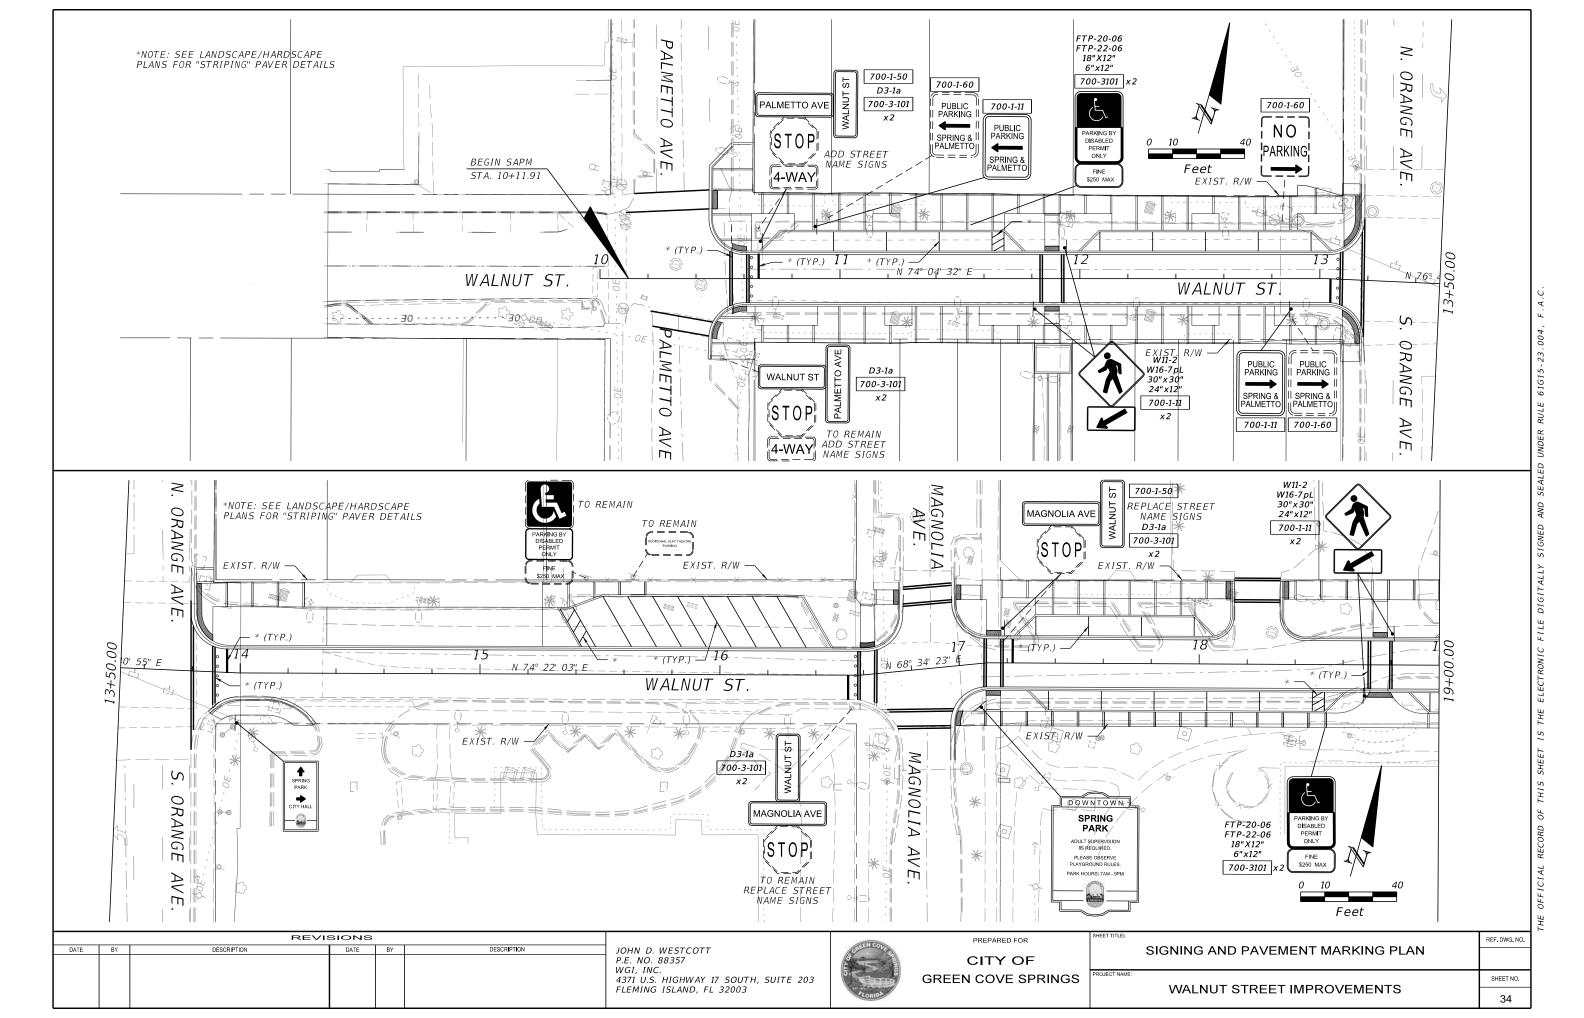

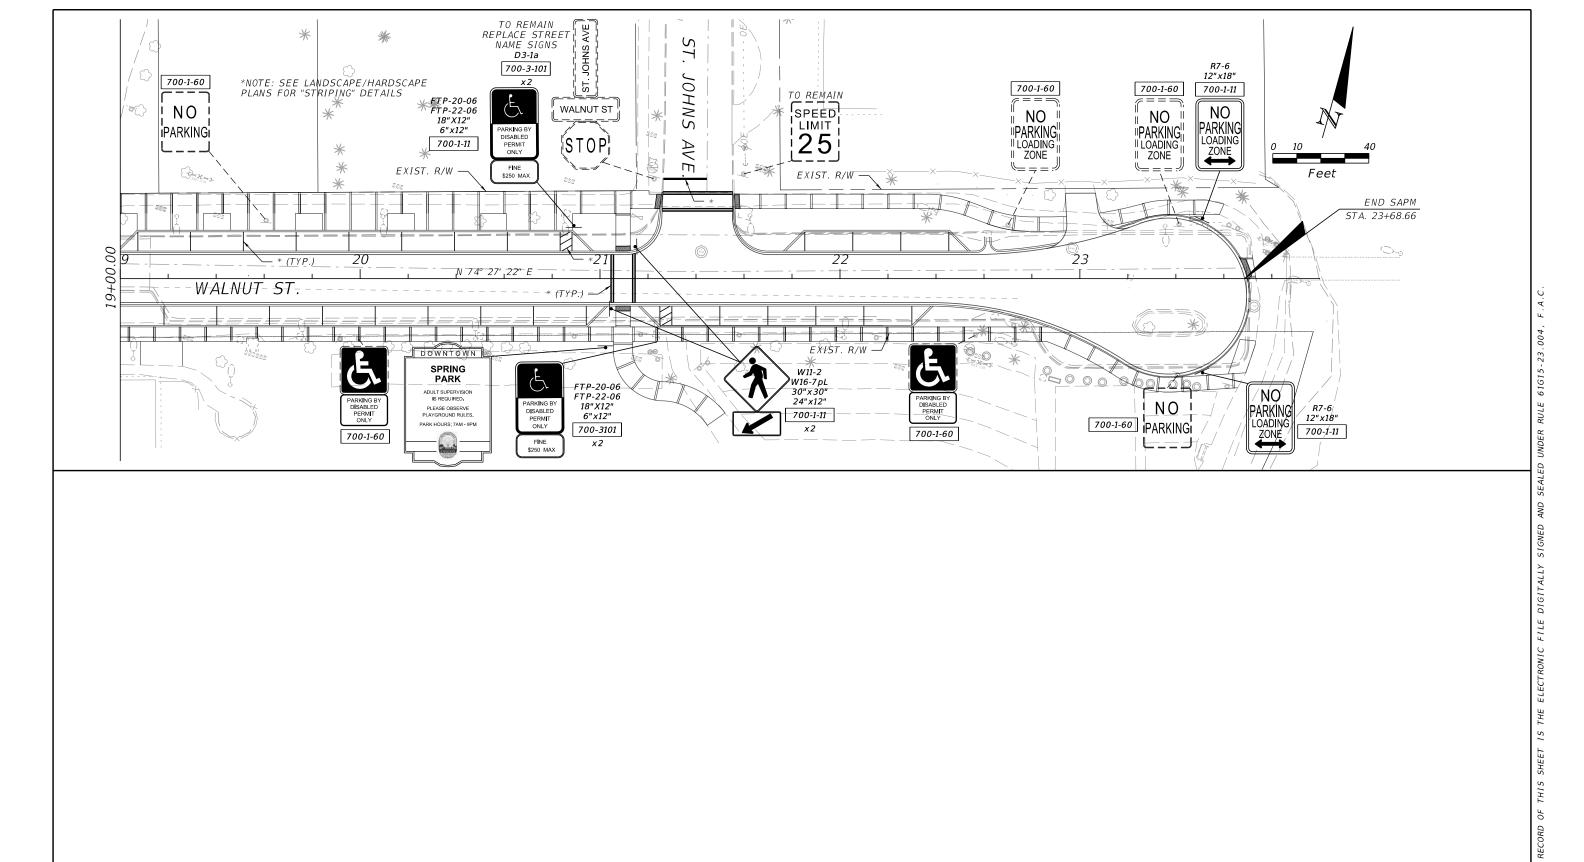


L												╛┢
Γ		R	EVISIONS	•				PREPARED FOR	SHEET TITLE:		REF. DWG. NO.	1
	DATE	BY DESCRIPTION	DATE	BY	DESCRIPTION	JOHN D. WESTCOTT	CHERICO			SIGNING AND PAVEMENT MARKING PLAN		1
					P.E. NO. 88357	2	CITY OF				ı	
						WGI, INC. 4371 U.S. HIGHWAY 17 SOUTH, SUITE 203	5	GREEN COVE SPRINGS	PROJECT NAME:		SHEET NO.	1
						FLEMING ISLAND, FL 32003	FLORIDA			WALNUT STREET IMPROVEMENTS	35	1

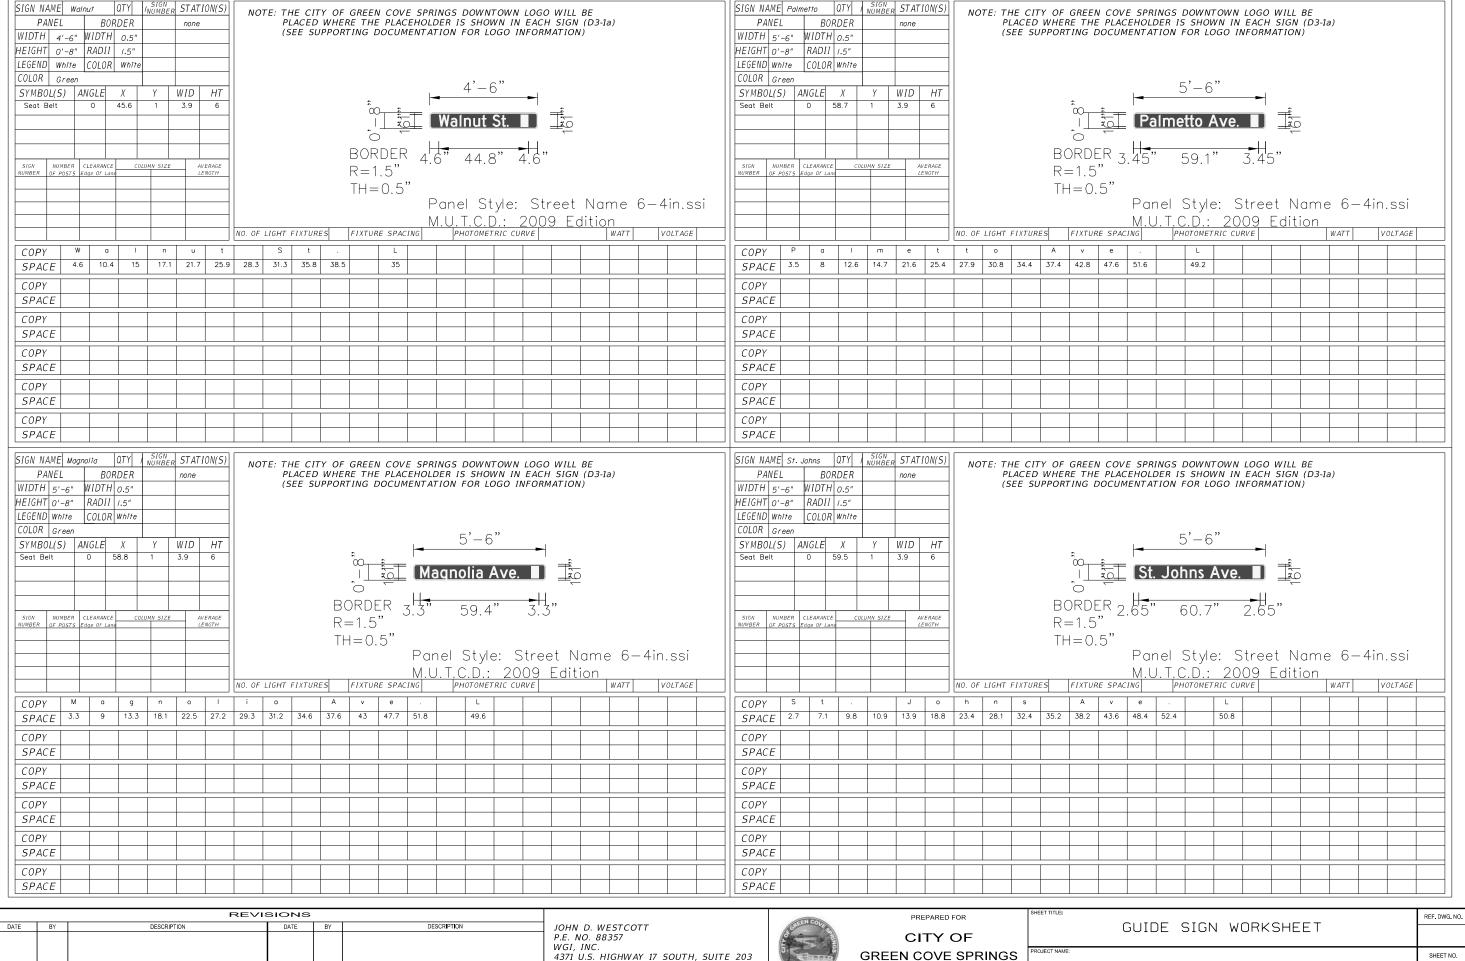



FLEMING ISLAND, FL 32003


SHEET NO.


WALNUT STREET

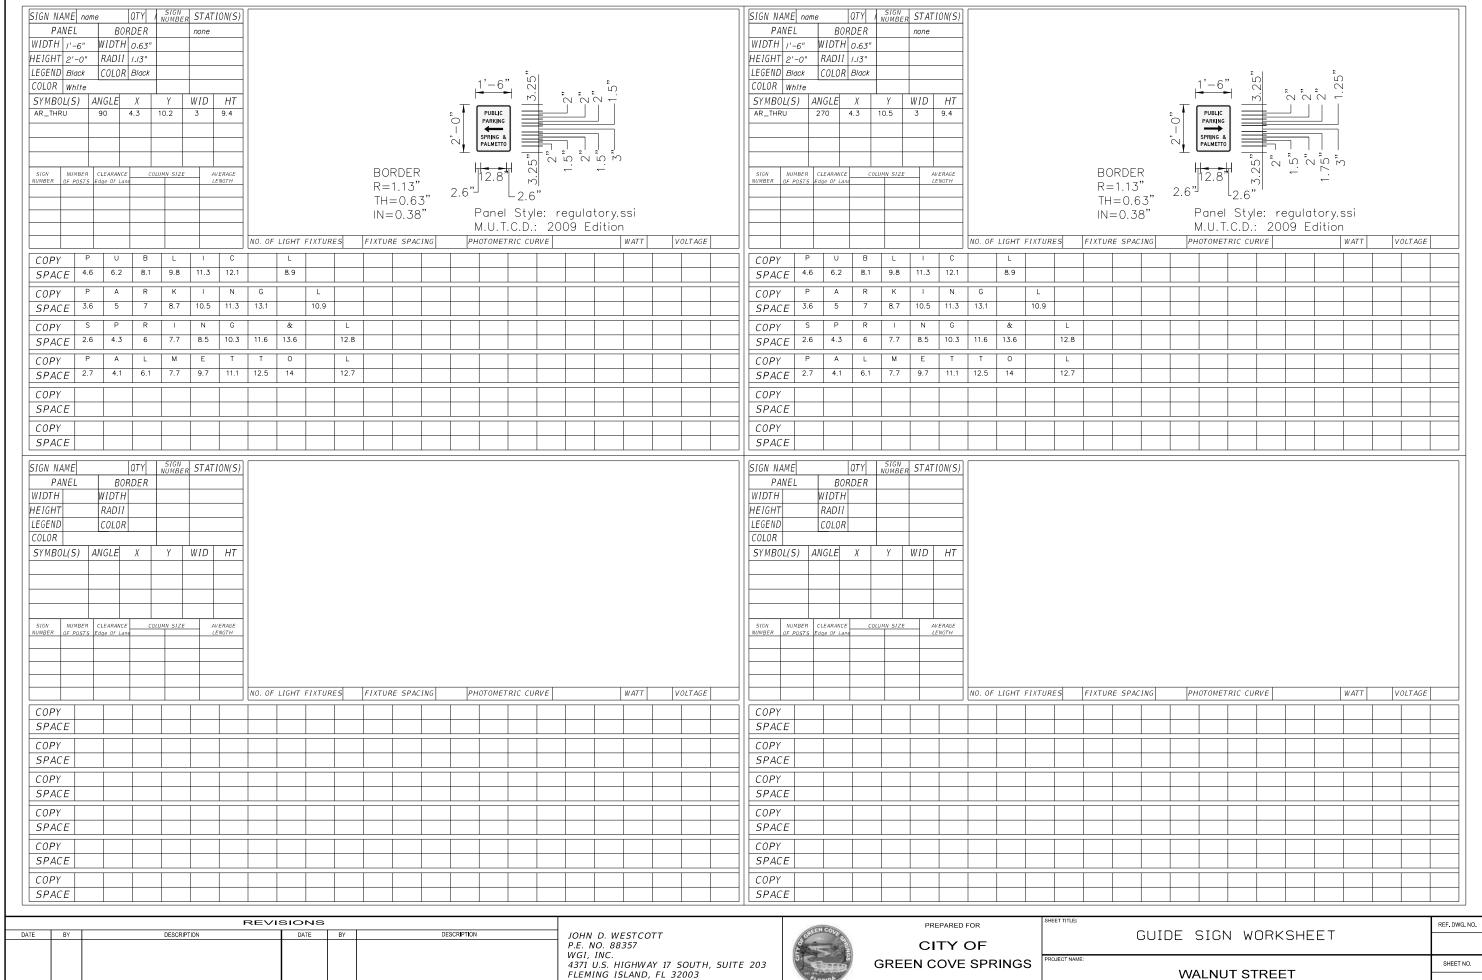


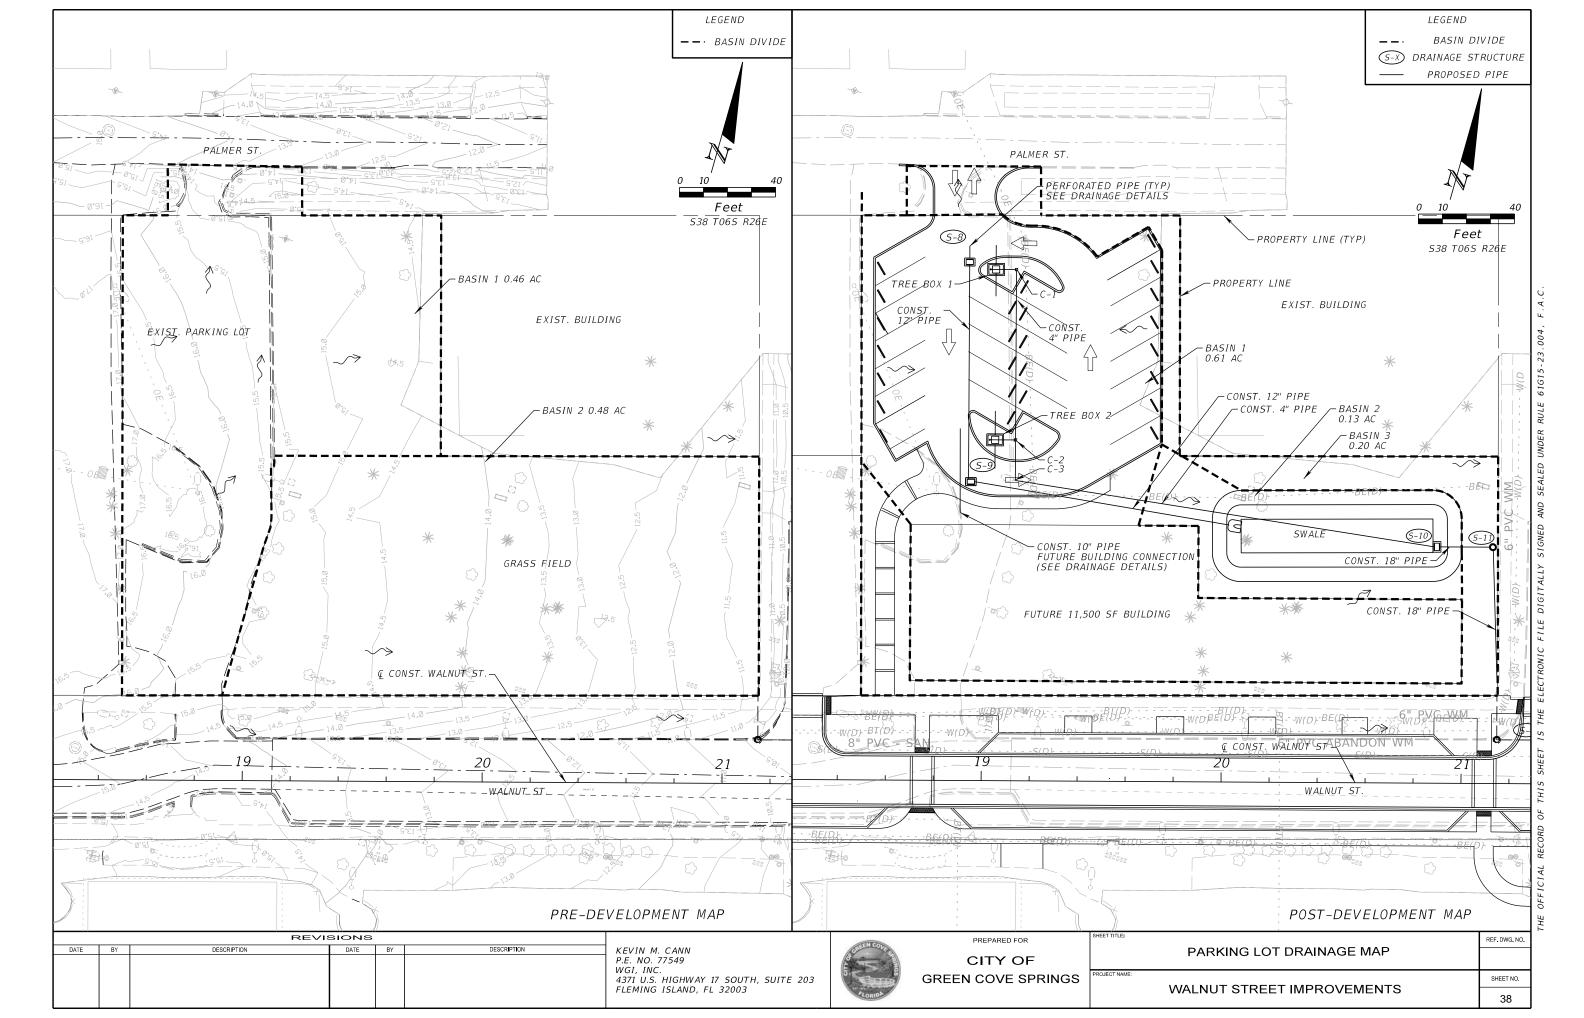


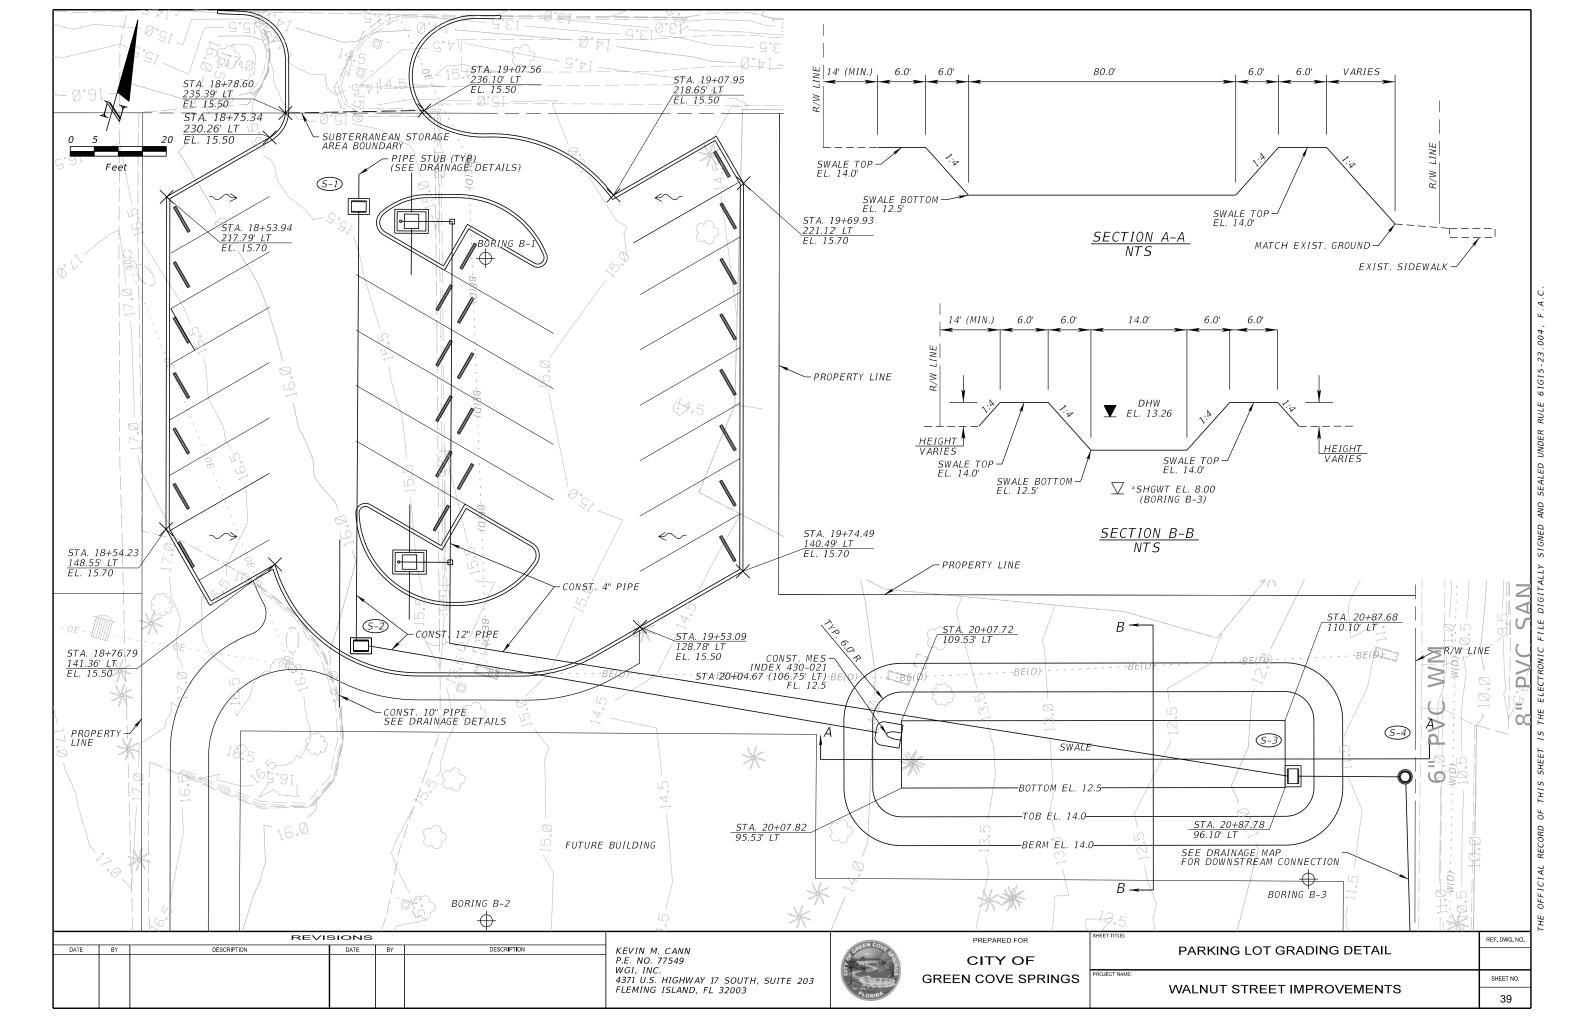


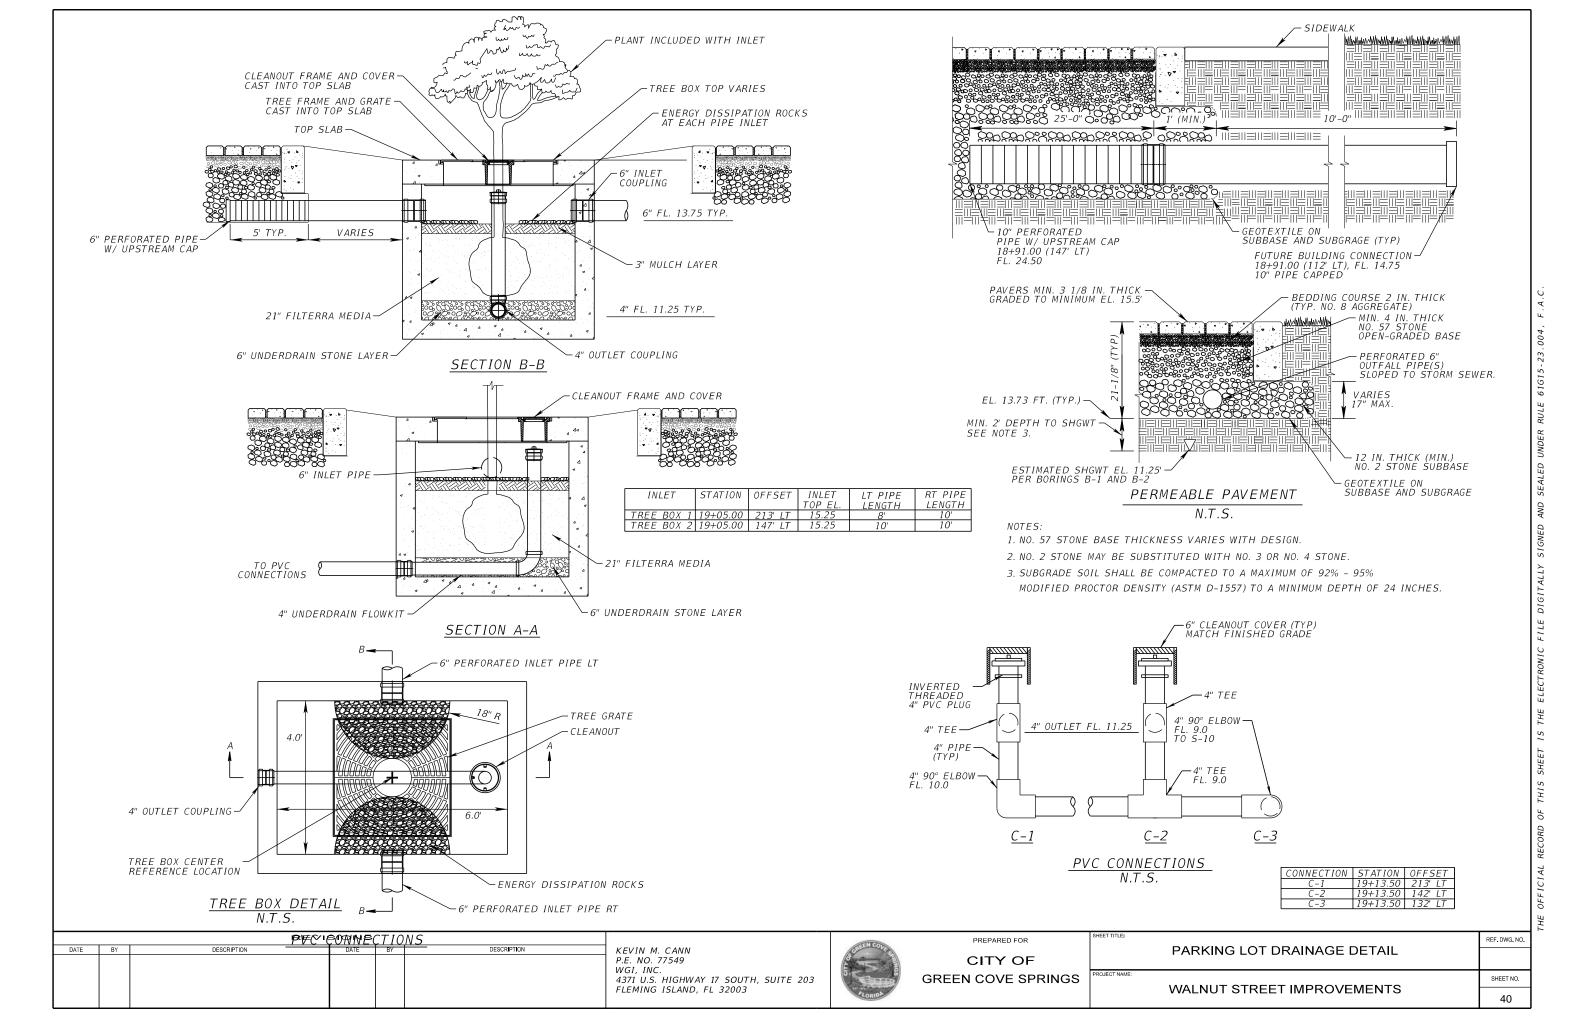


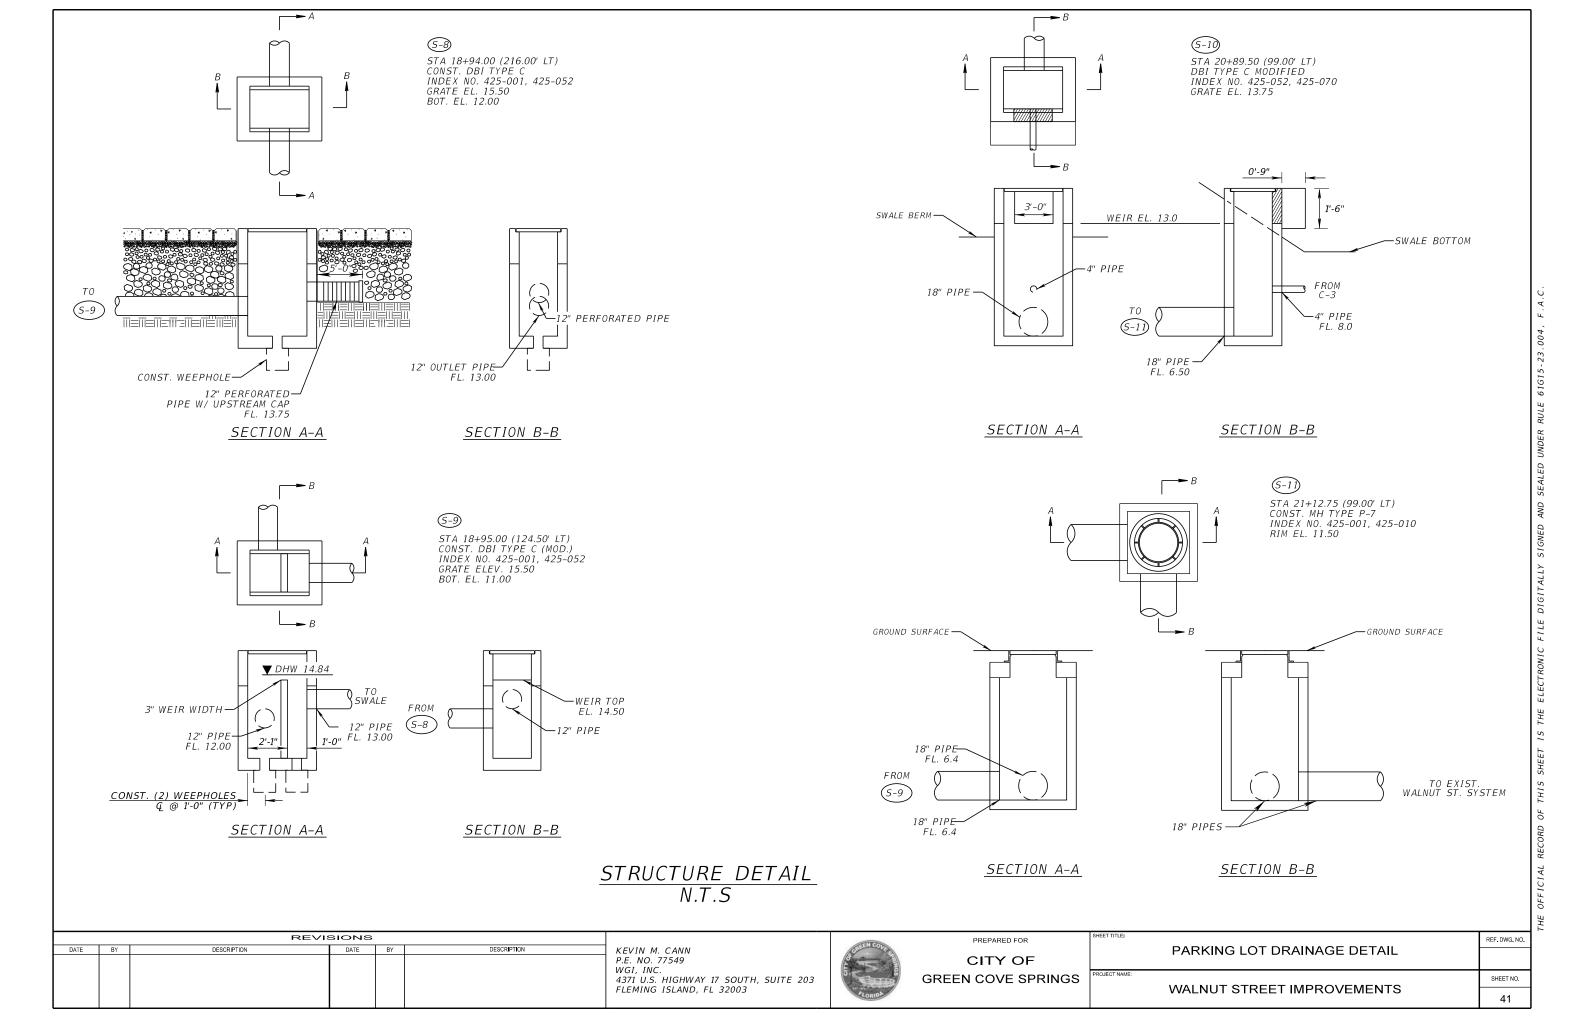


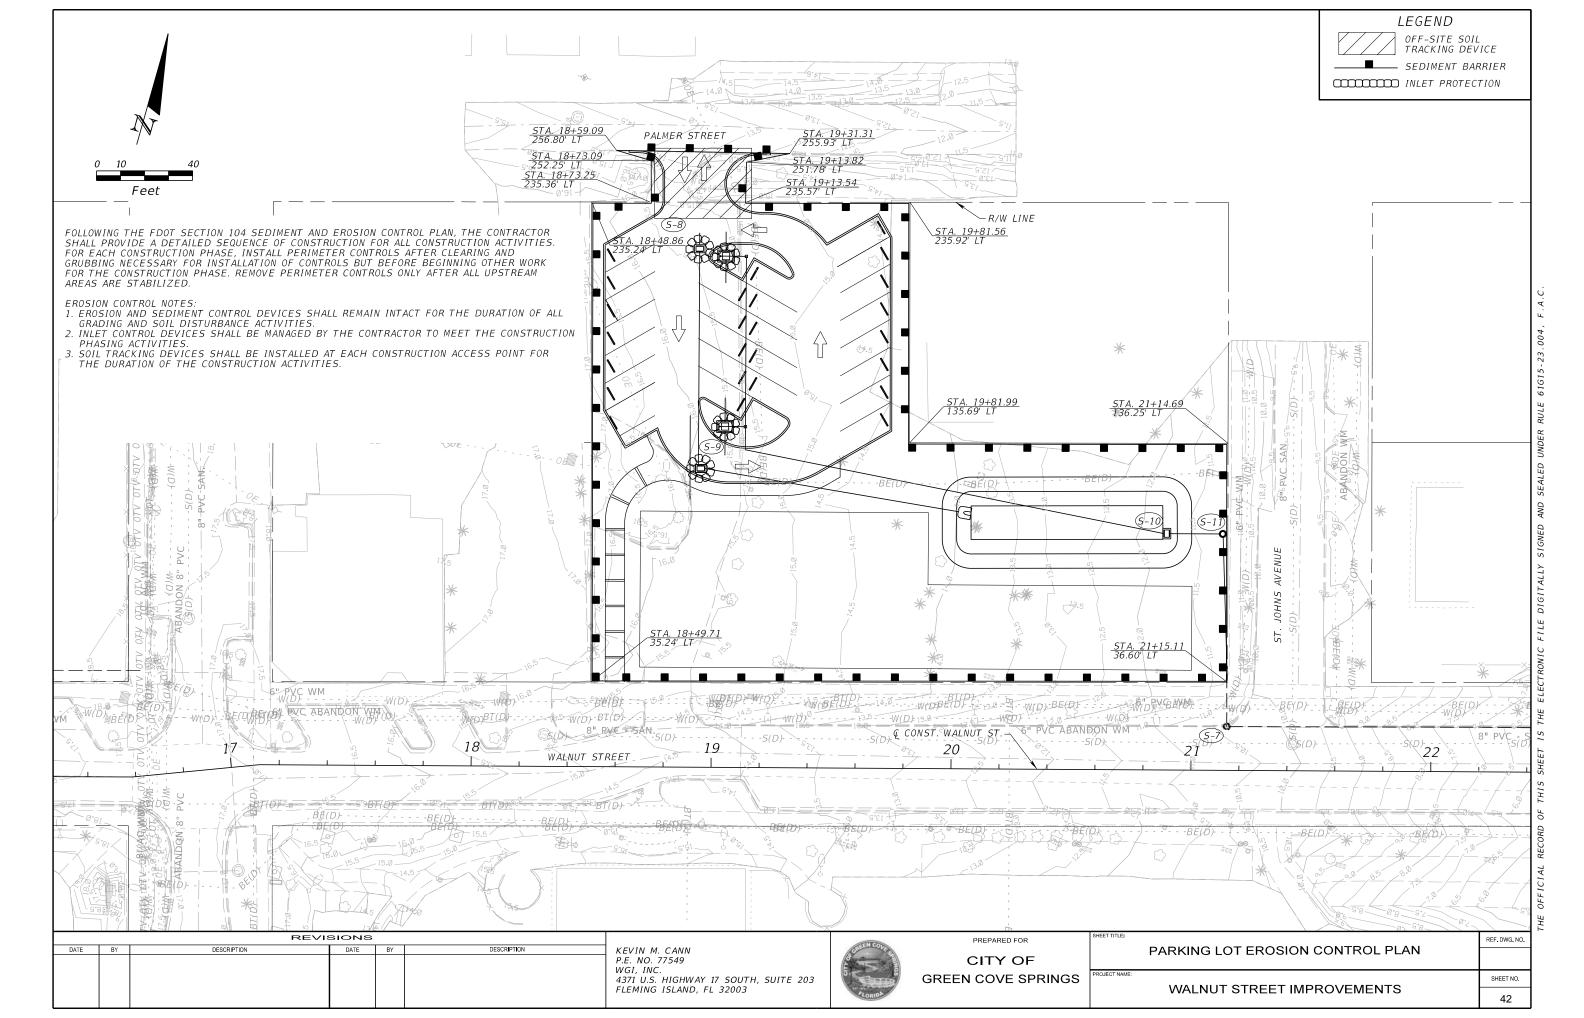


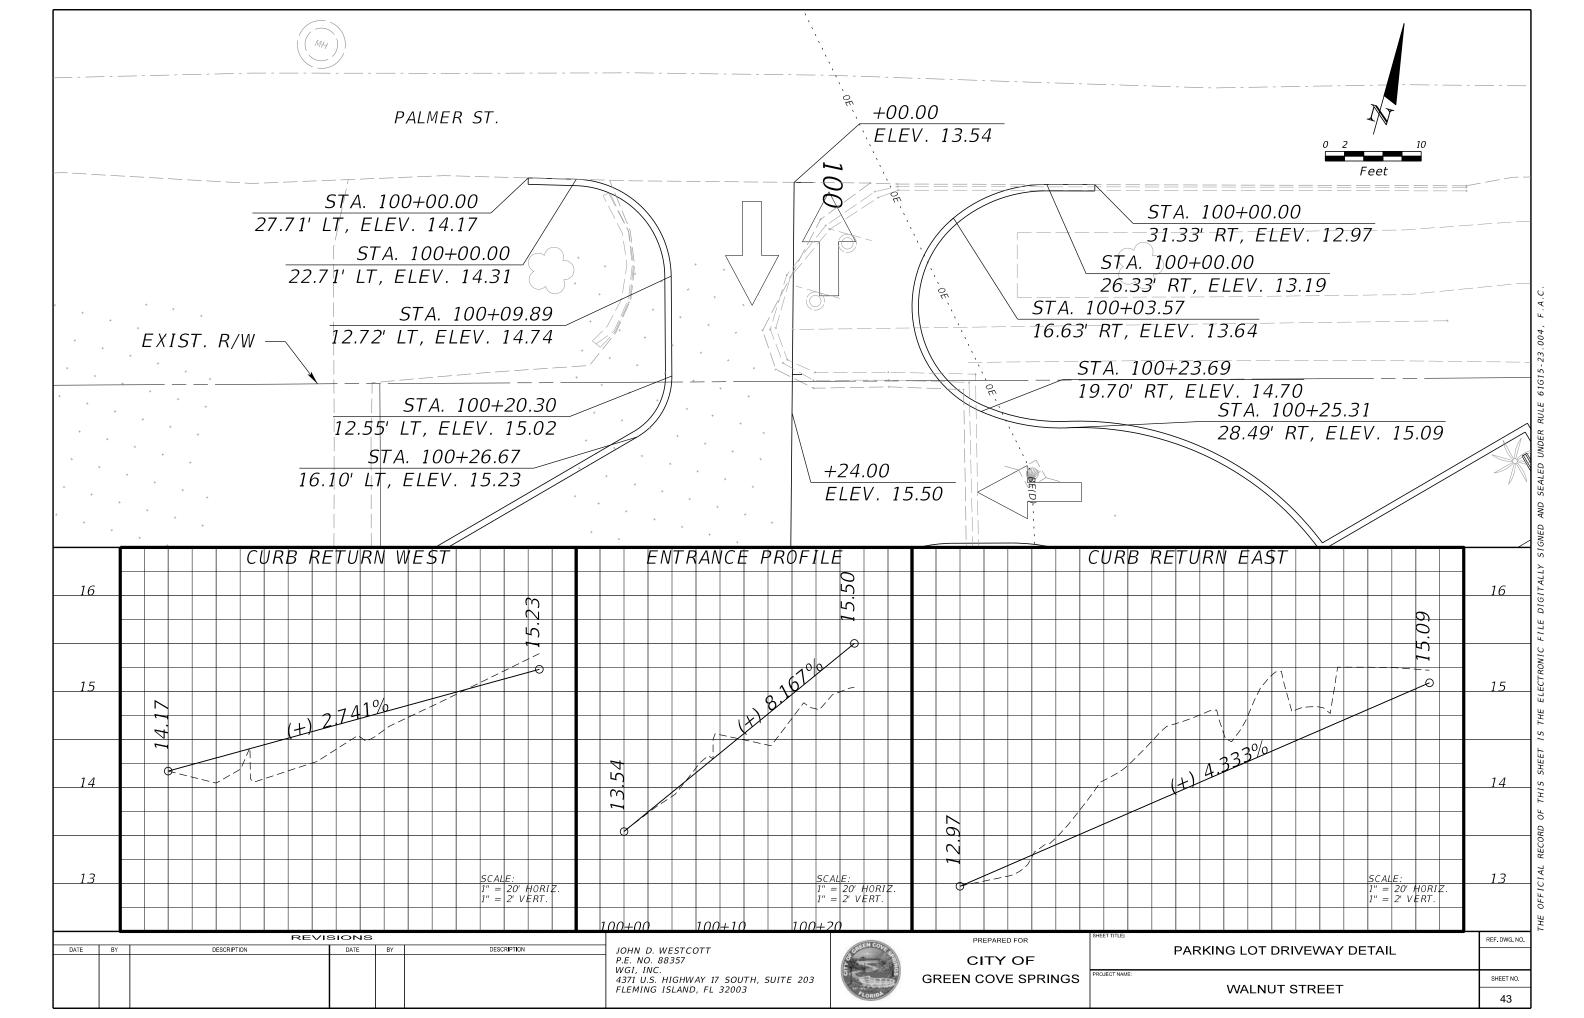


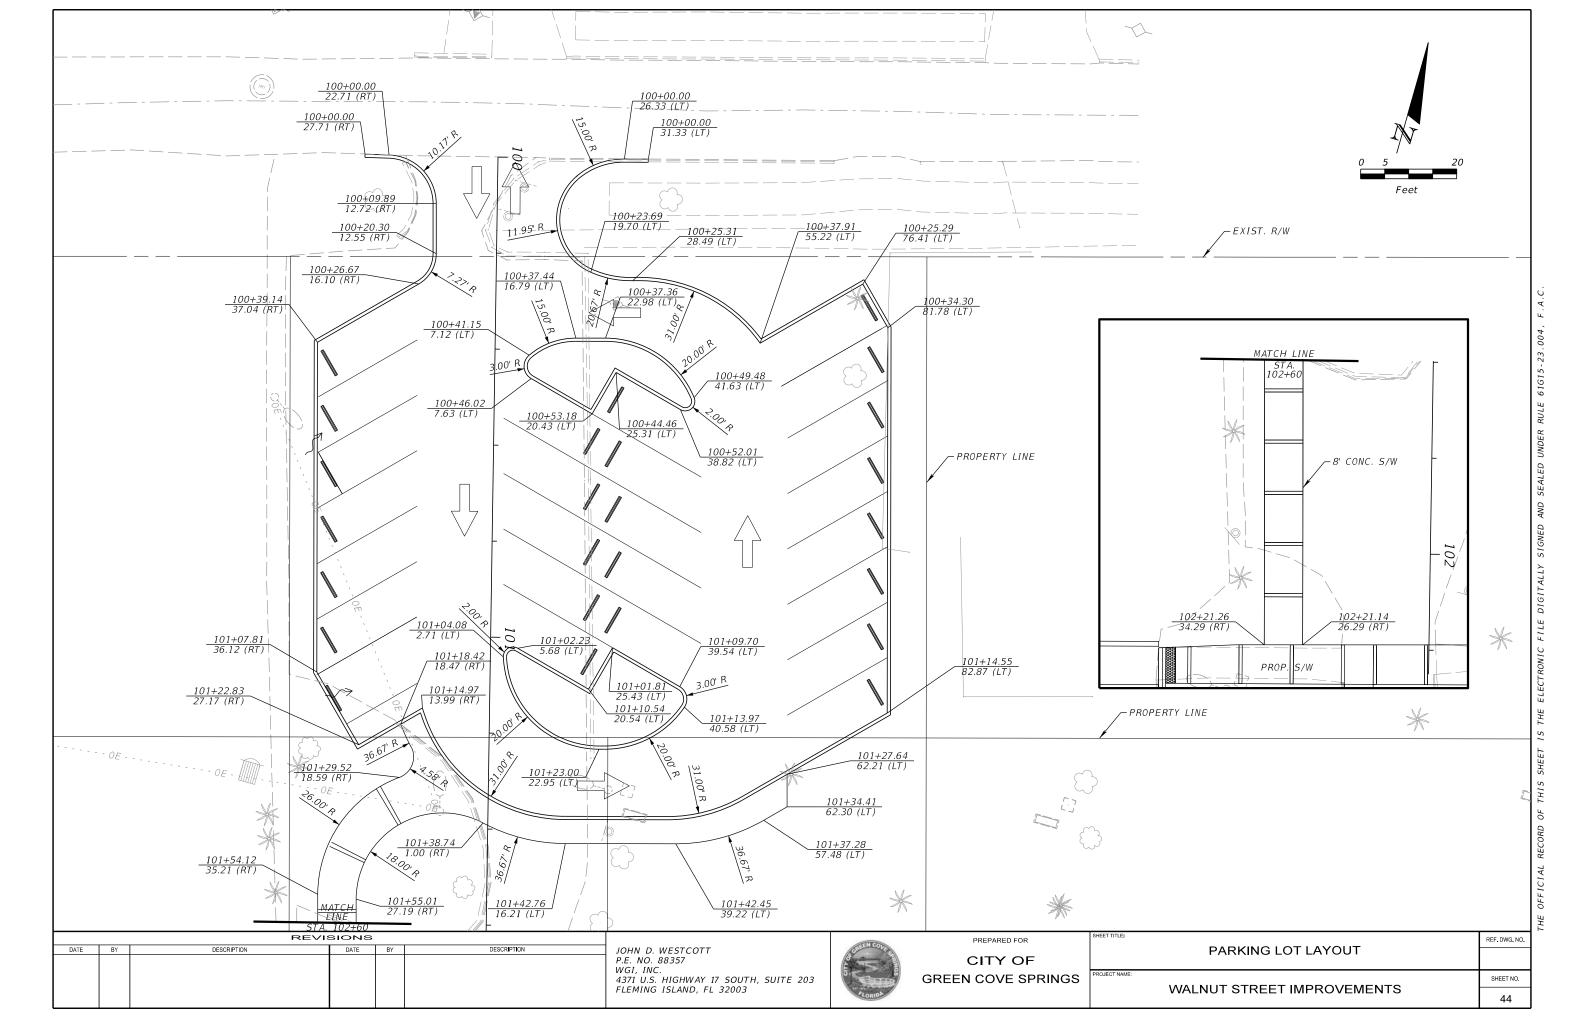


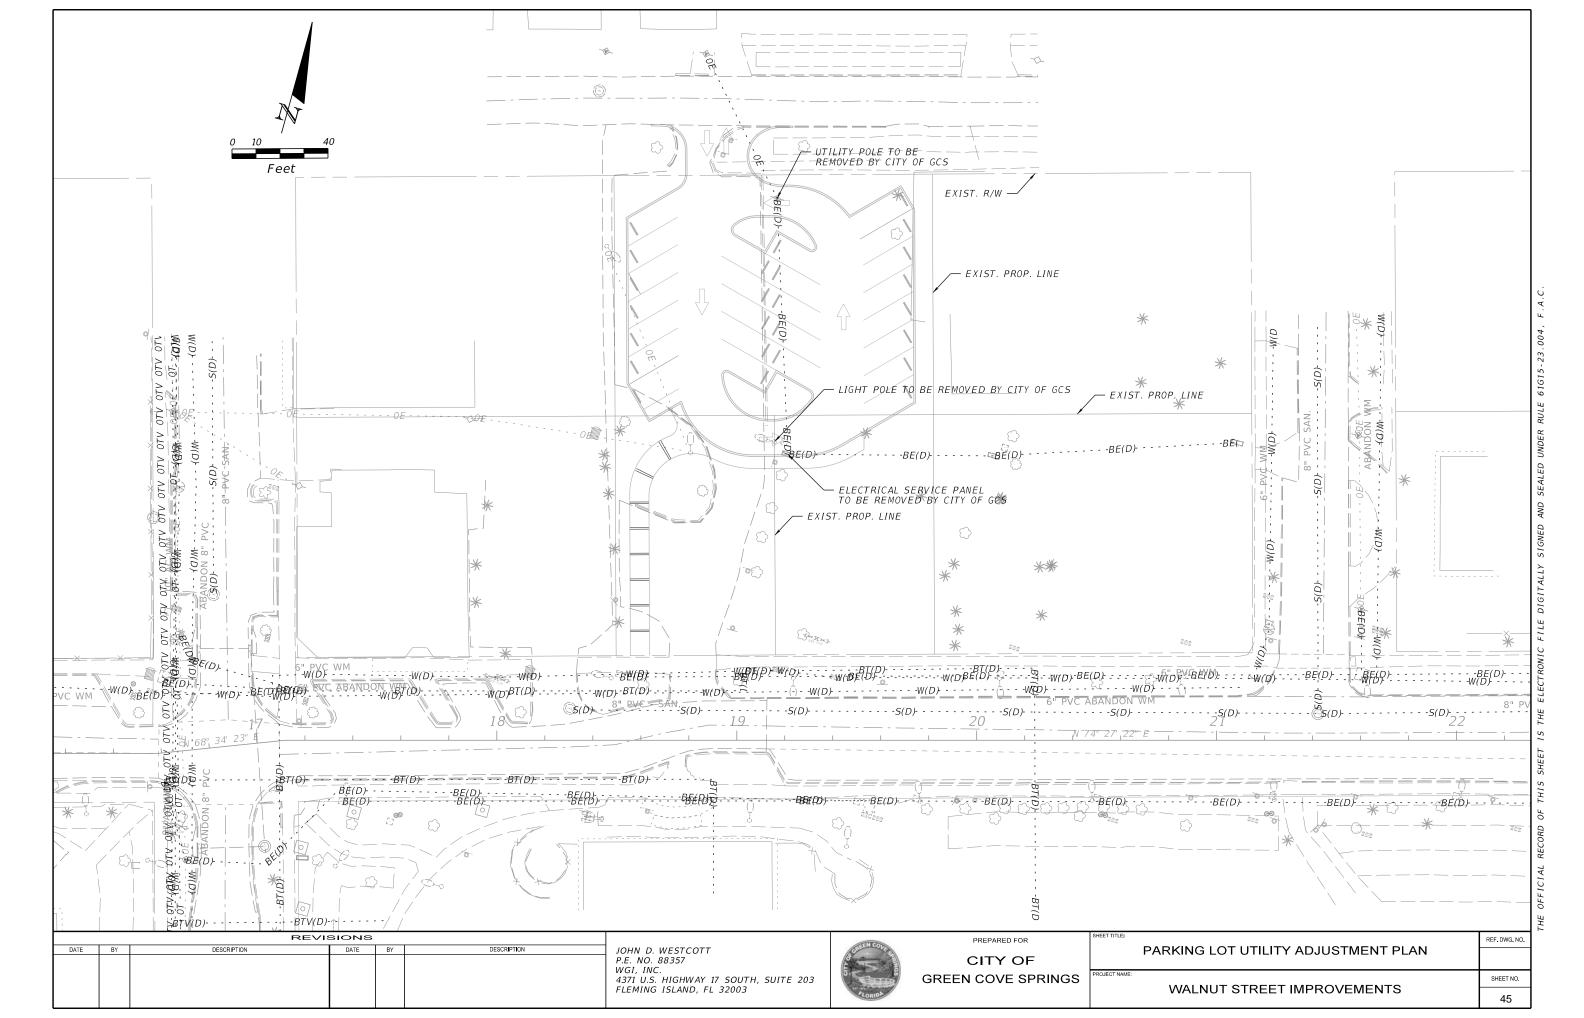


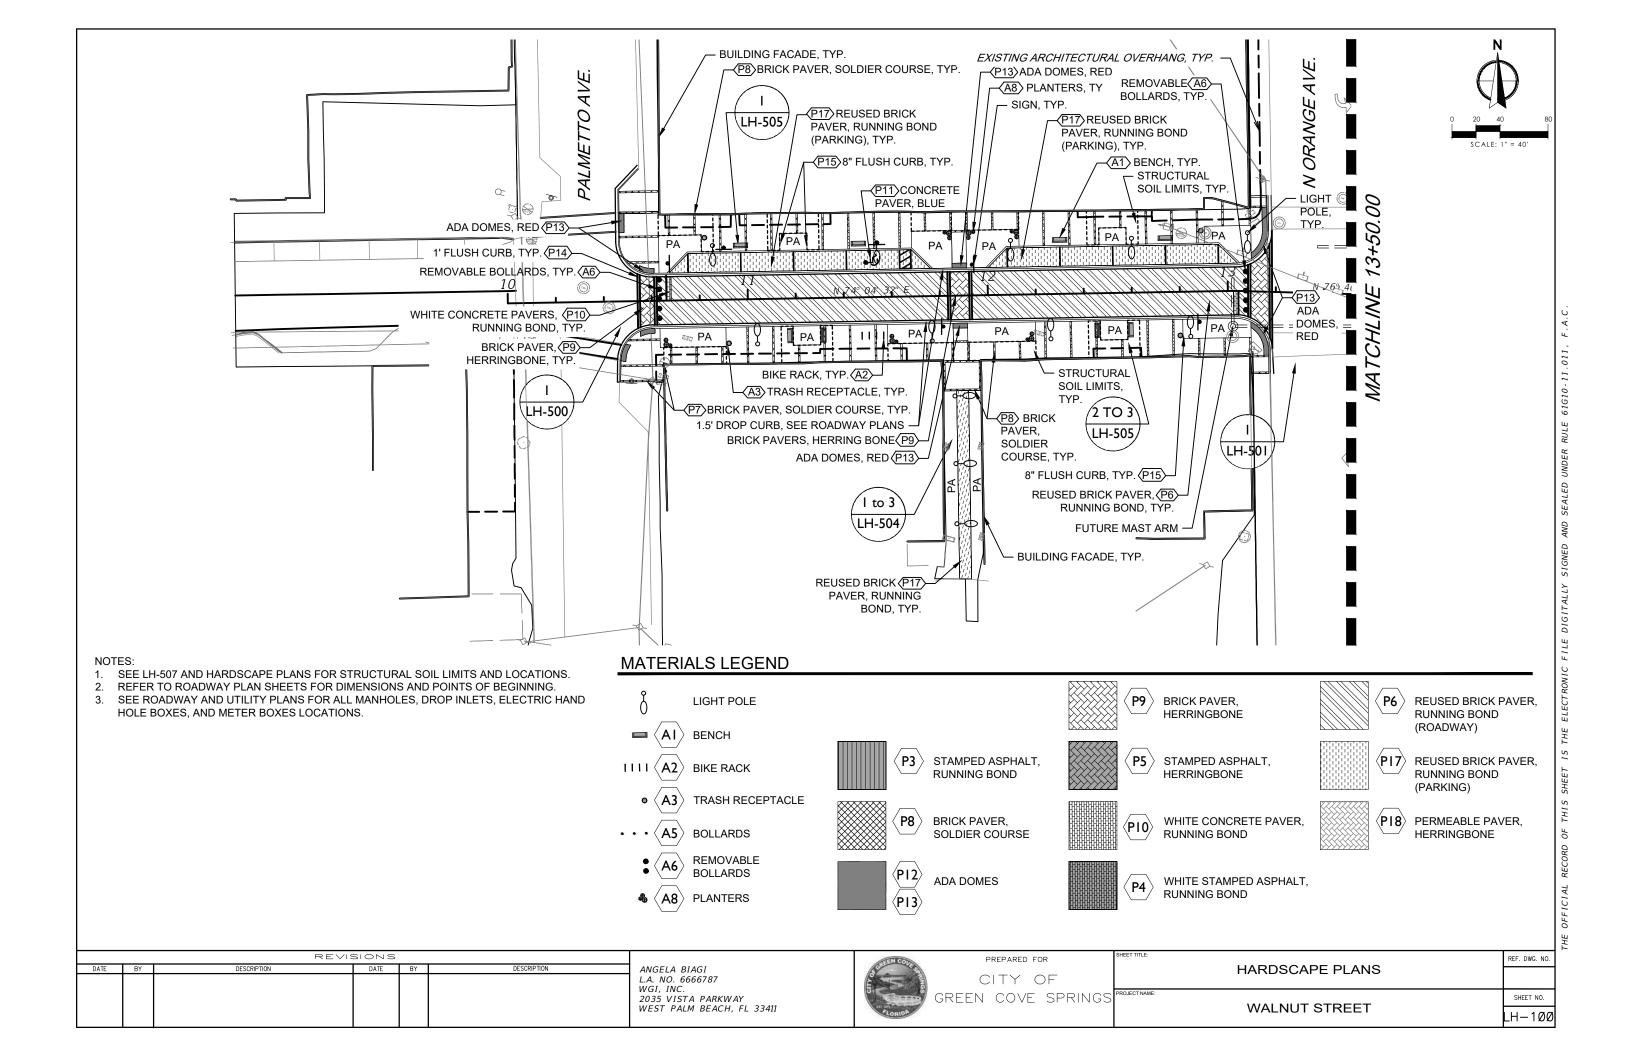


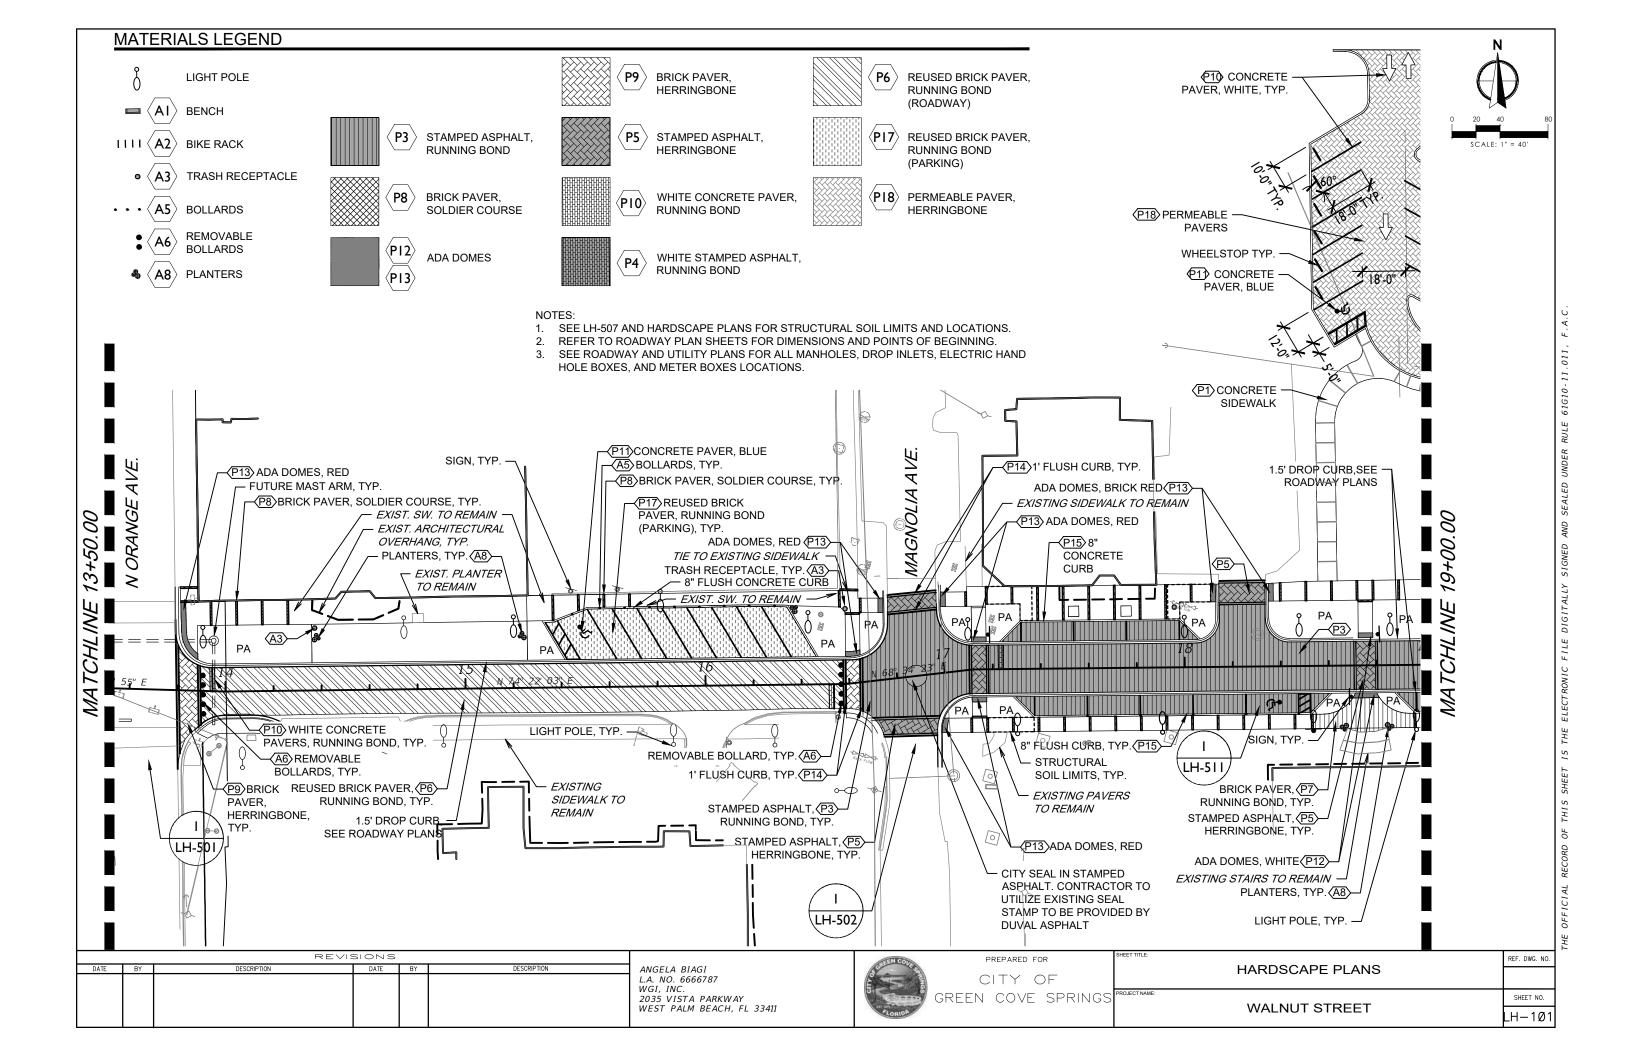


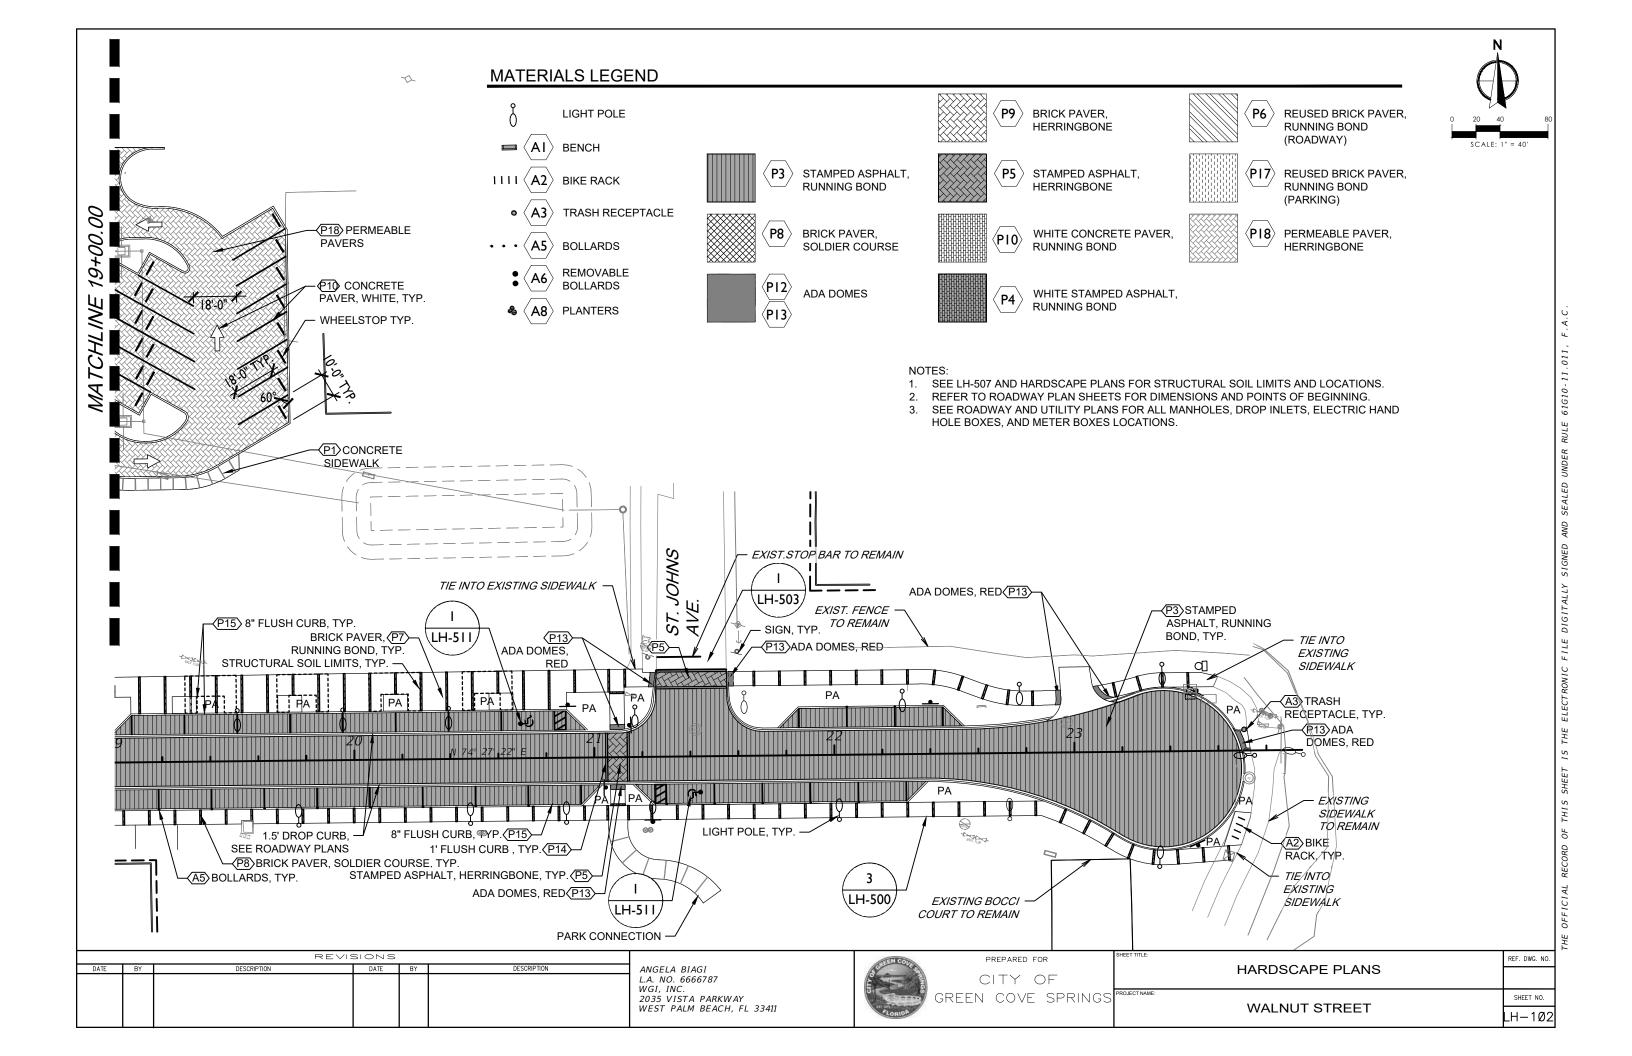


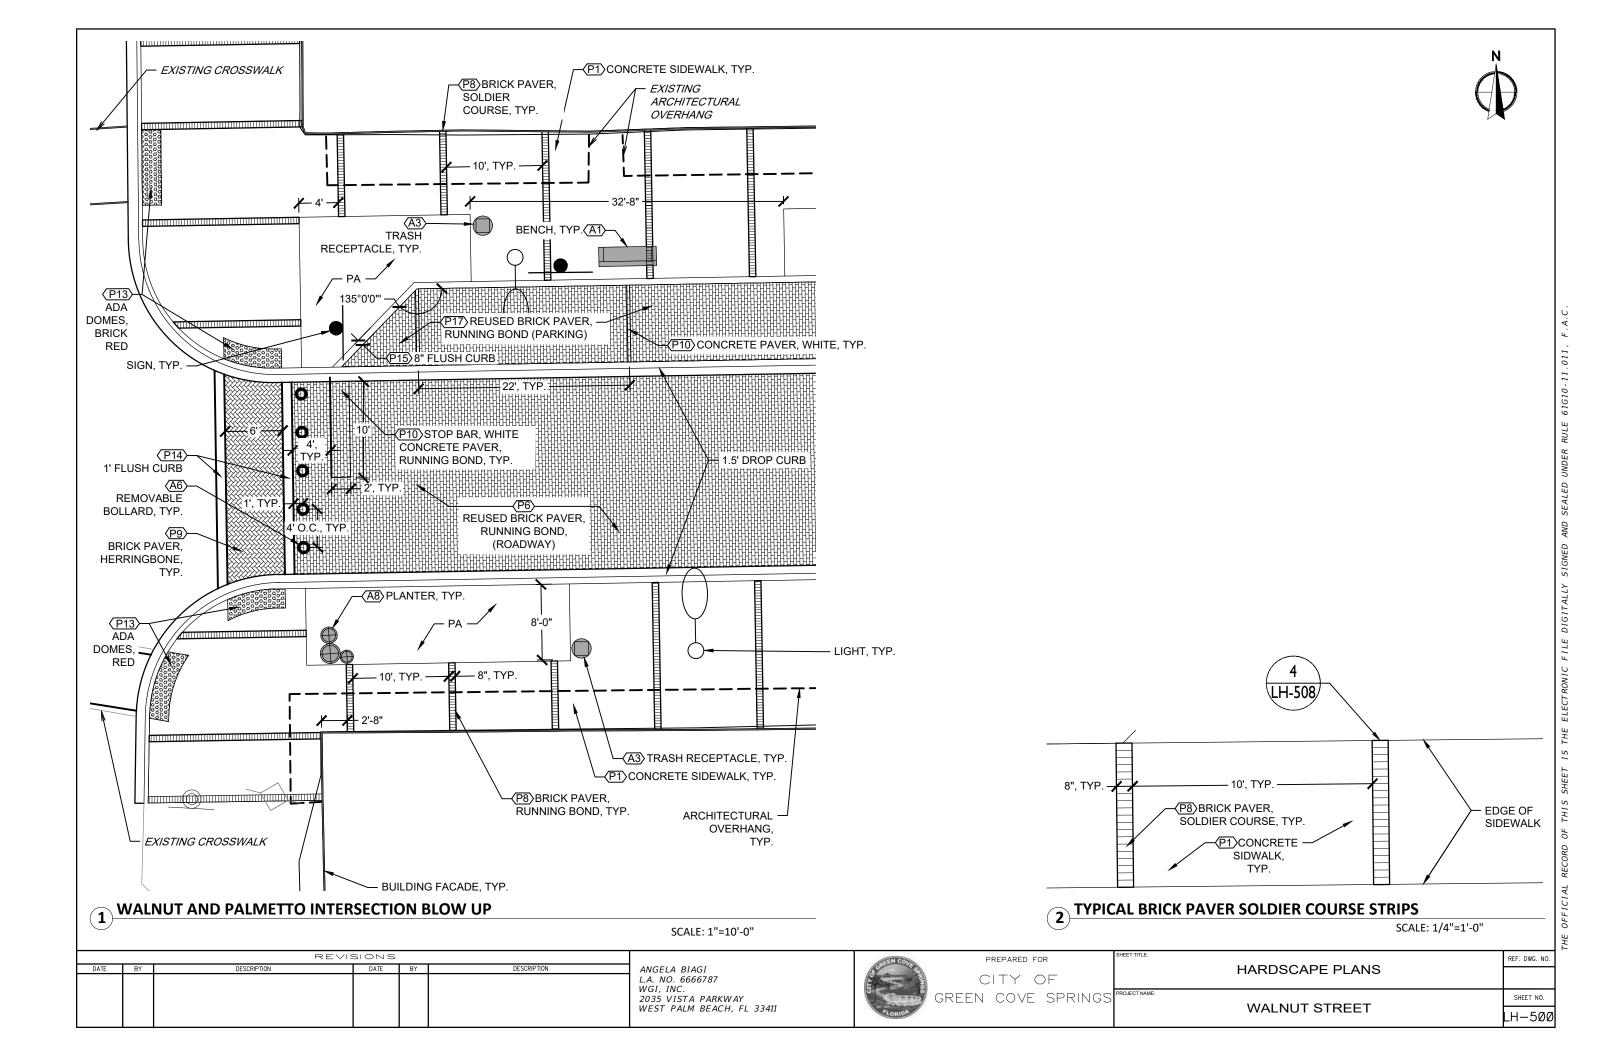

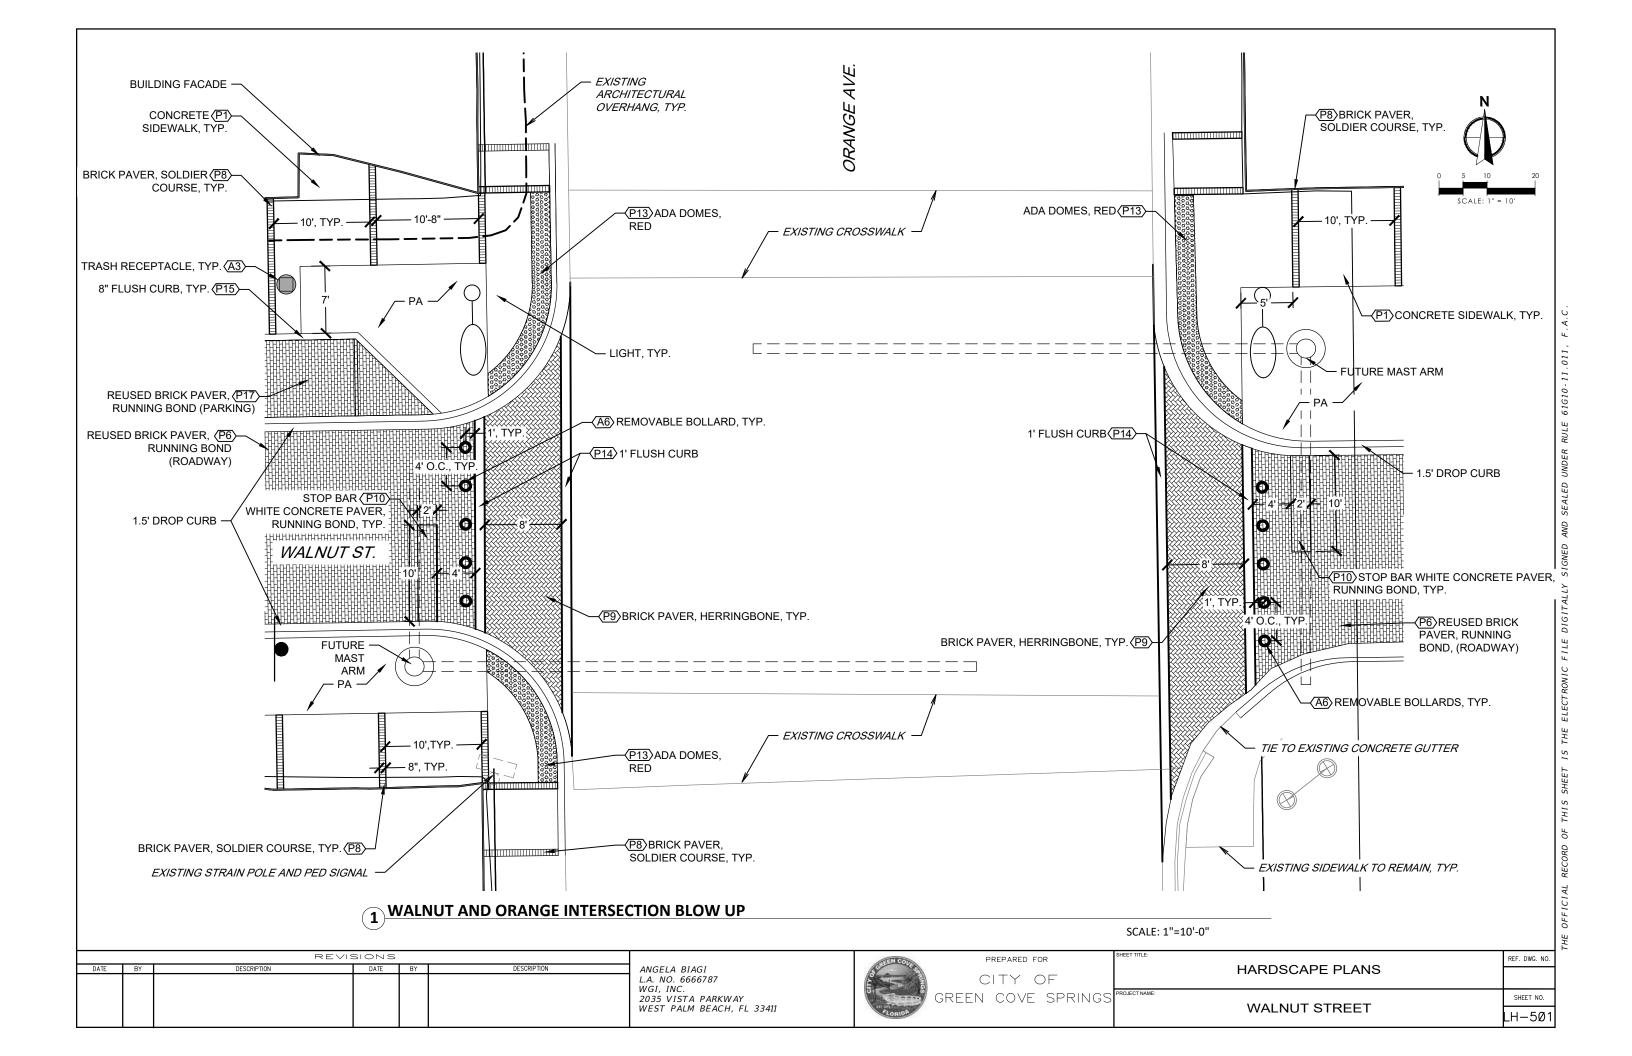


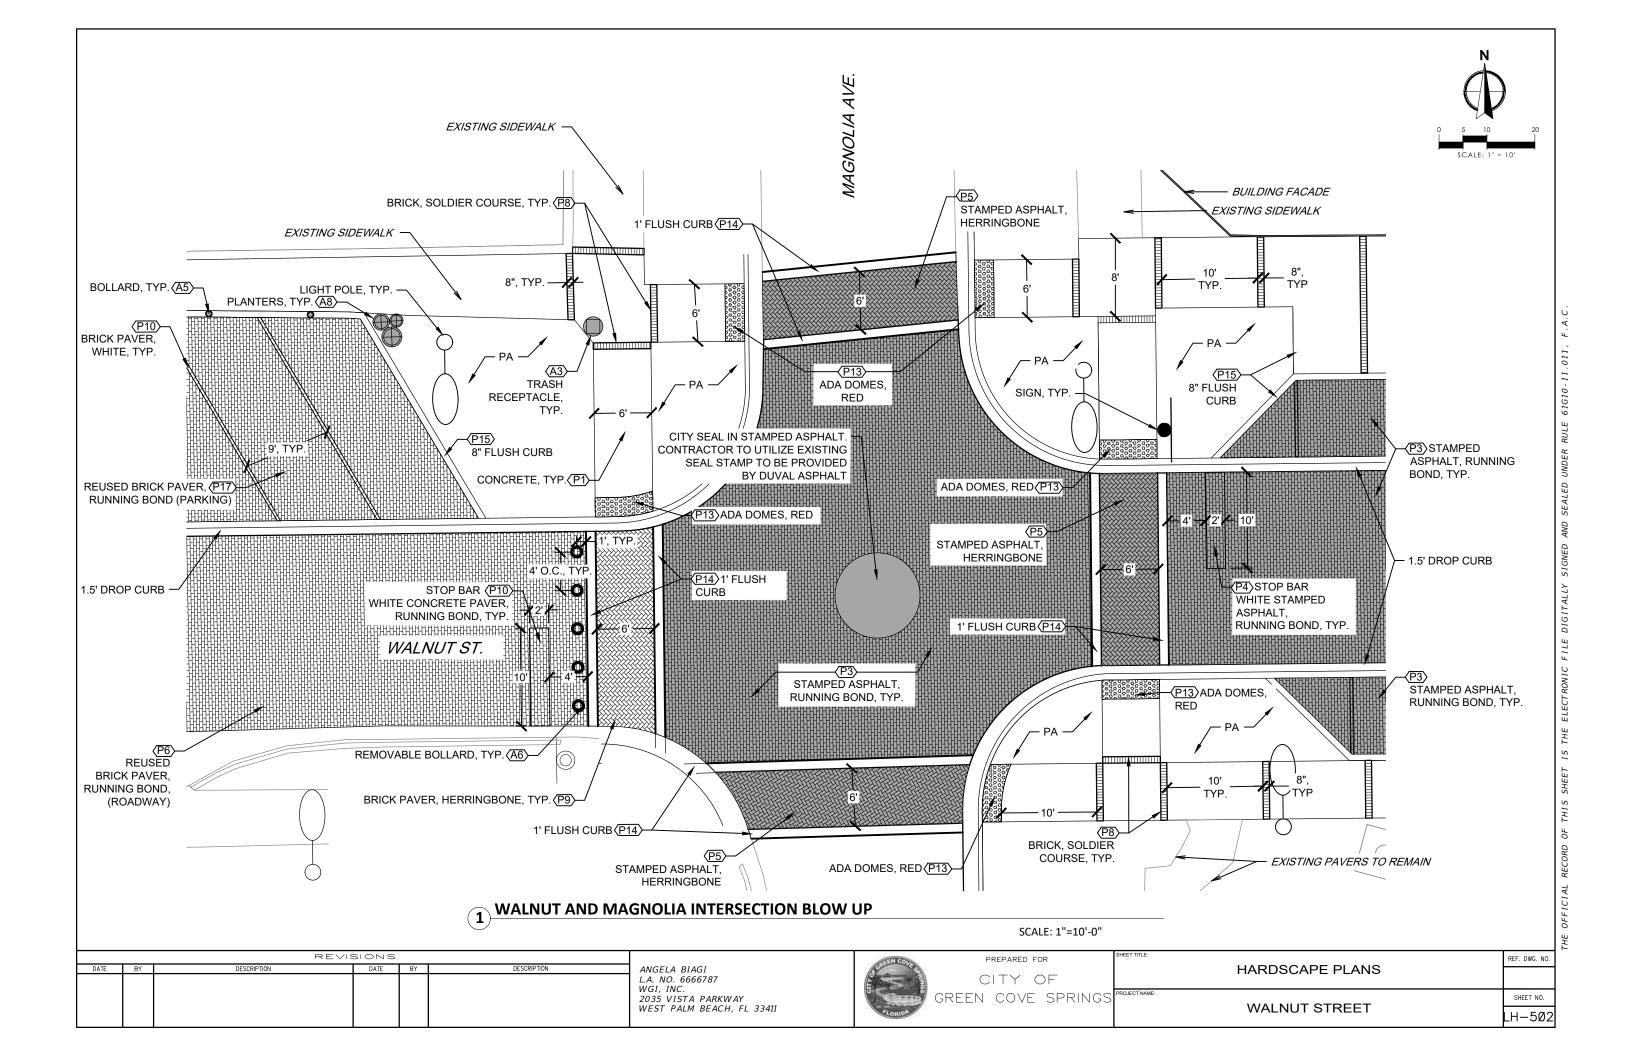


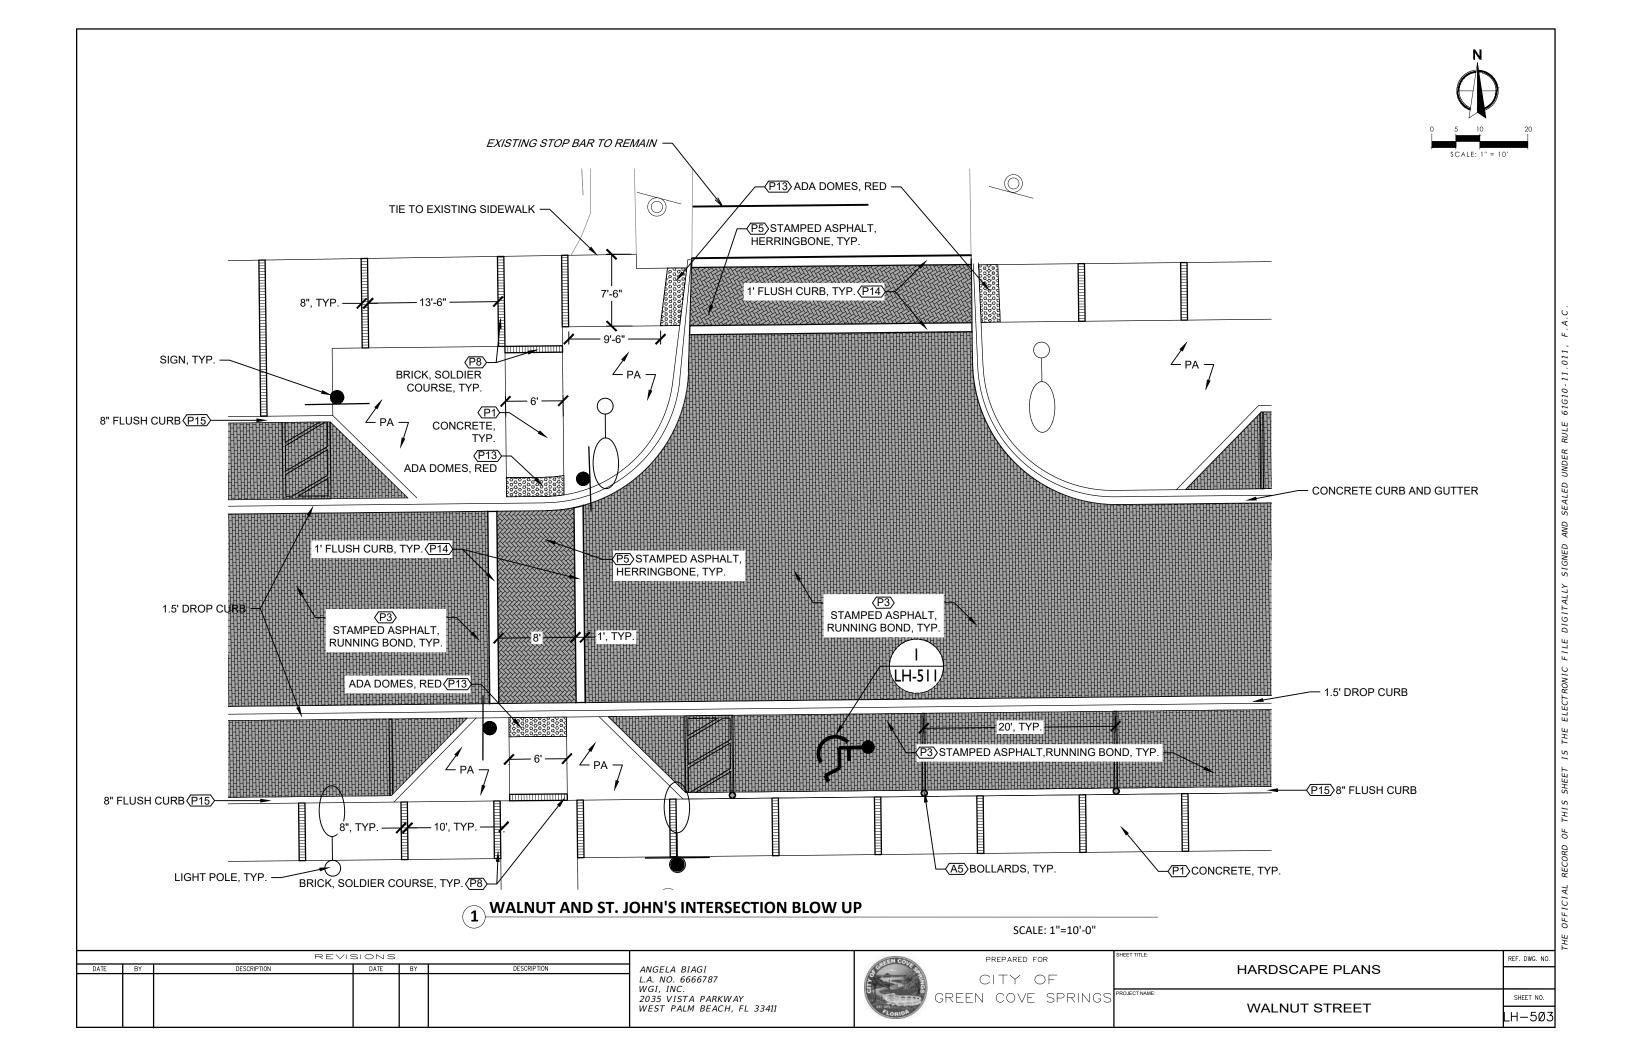


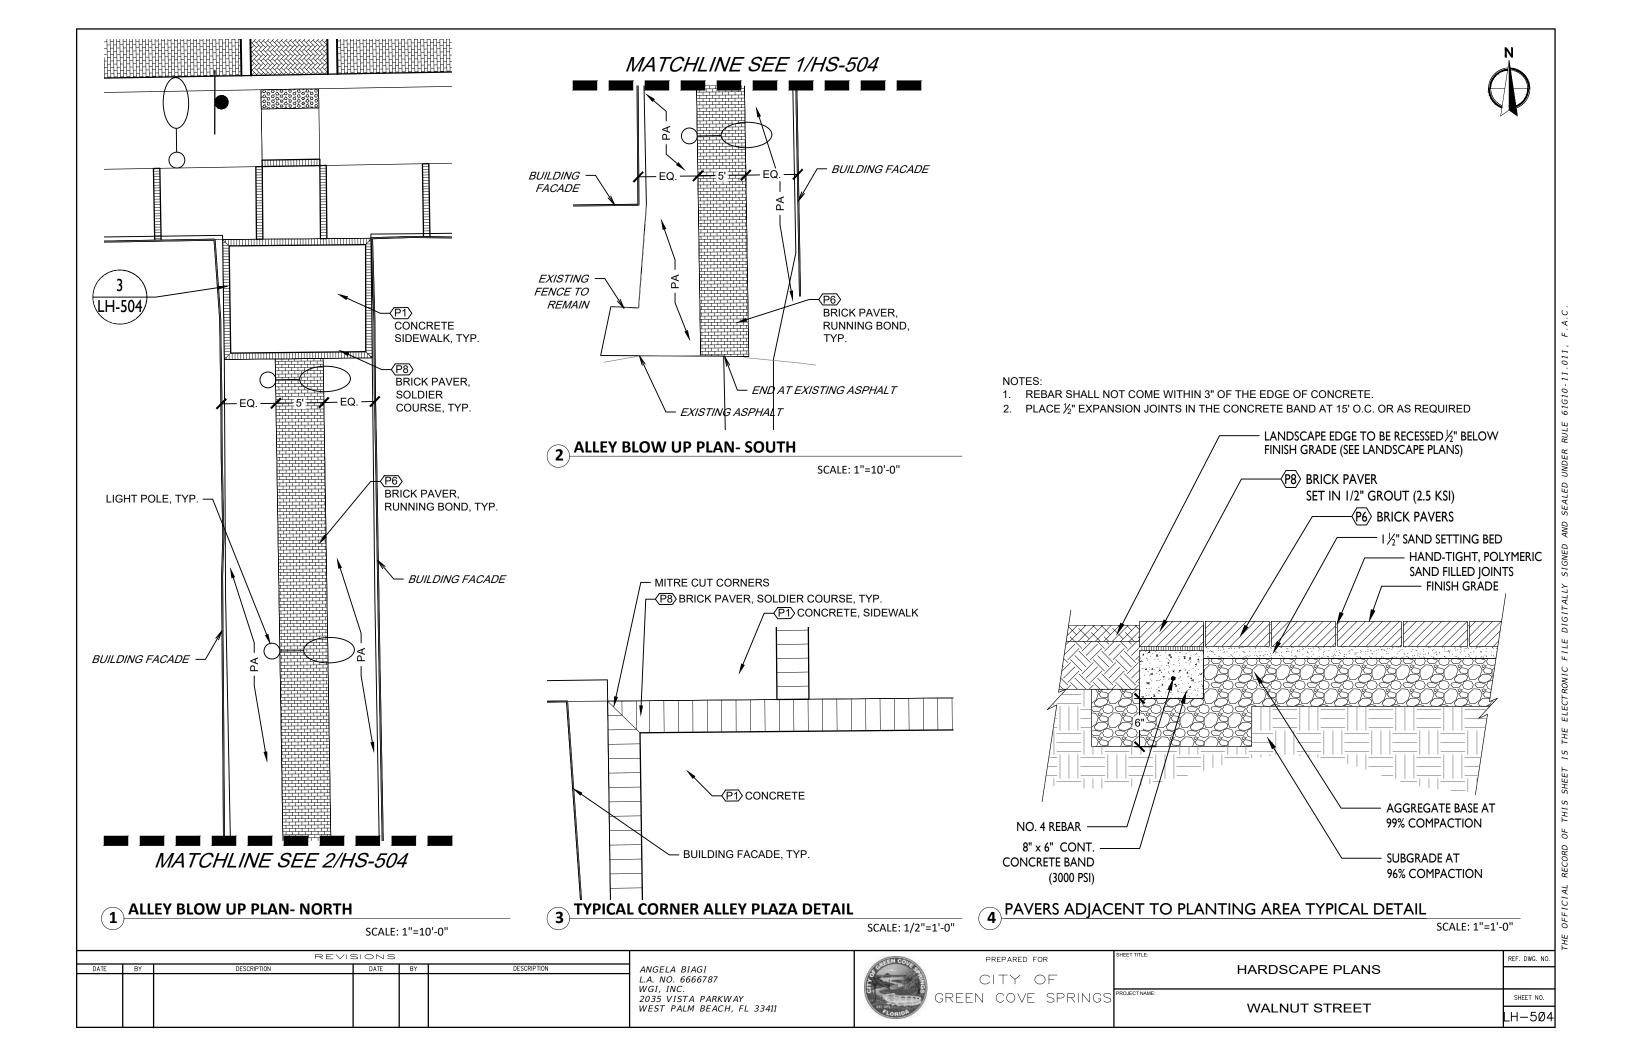



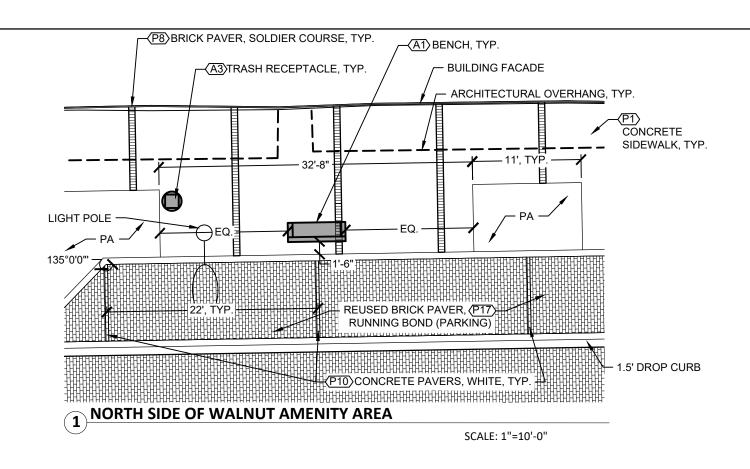

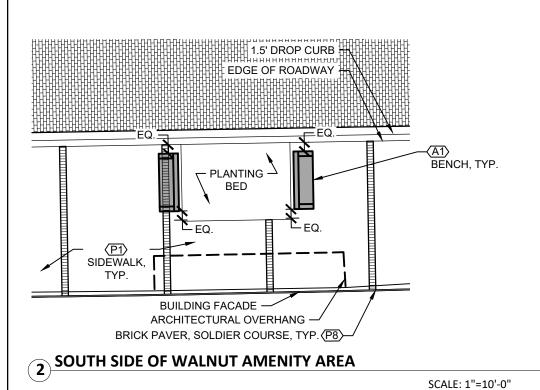

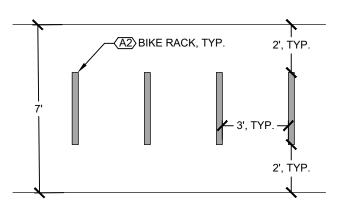

3 TYPICAL BIKE RACK SPACING

DATE	BY	DESCRIPTION	DATE	BY	DESCRIPTION	ANGELA BIAGI
						L.A. NO. 6666787 WGI, INC. 2035 VISTA PARKWAY WEST PALM BEACH, FL 33411

I	GREEN COVE	PREPARED FOR
	PLORIDA STATE	CITY OF Green cove springs

	HARDSCAPE PLANS	REF. DWG. N
AME:	MALAULT OTDEET	SHEET NO.
	WALNUT STREET	LH-5Ø

SCALE: 1/4"=1'-0"

P.O. DRAWER 330 - DUNKIRK, MD 20754 USA
TOLL FREE: (800) 368-2573 (USA & CANADA)
TEL (301) 855-8300 - FAX (410) 257-7579
WEB SITE: HTTP://WWW.VICTORSTANLEY.COM

* ALL DIMENSIONS ARE IN INCHES *

Greate a timeless moment. FRONT WELDS ARE POLISHED UNTIL THEY DISAPPEAR, FORMING A CONTINUOUS SURFACE STEEL SLATS ARE FORMED FROM 1/4" x 1-1/2" SOLID STEEL BARS SEAT HEIGHT 24-3/8" FINISHED END UNIT IS MADE FROM 1/2" x 2" SOLID STEEL BAR CLEARANCE FOR 1/2" ANCHOR BOLTS TO BE SURFACE MOUNTED. -5/16" TUBULAR STEEL USED FOR ADDITIONAL SUPPORT 3/8" x 1" SOLID STEEL BARS ARE WELDED UNDERNEATH FOR ADDITIONAL SUPPORT FINISHED END UNITS JOIN TO SEATING SECTION WITH FASTENERS

AVAILABLE OPTIONS

POWDER COATING

10 STANDARD COLORS, 2 OPTIONAL METALLIC COLORS, CUSTOM COLORS (INCLUDING THE RAL RANGE)

INTERMEDIATE & CENTER ARMRESTS

4' 6' & 8' AVAILABLE WITH OPTIONAL

4', 6', & 8' AVAILABLE WITH OPTIONAL SOLID STEEL ARMRESTS NOTES:

STANDARD 4'
STANDARD 6' (AS SHOWN)

NOTES:

1. DRAWINGS NOT TO SCALE. DO NOT SCALE DRAWINGS.

2. ALL FABRICATED METAL COMPONENTS ARE STEEL SHOTBLASTED, ETCHED, PHOSPHATIZED, PREHEATED, AND ELECTROSTATICALLY
POWDER-COATED WITH T.G.I.C. POLYESTER POWDER COATINGS. PRODUCTS ARE FULLY CLEANED AND PRETREATED, PREHEATED AND
COATED WHILE HOT TO FILL CREVICES AND BUILD COATING FILM. COATED PARTS ARE THEN FULLY CURED TO COATING MANUFACTURER'S
SPECIFICATIONS. THE THICKNESS OF THE RESULTING FINISH AVERAGES 8-10 WILS (200-250 MICRONS).

I FNGTHS

- IT IS NOT RECOMMENDED TO LOCATE ANCHOR BOLTS UNTIL BENCH IS IN PLACE. THIS VICTOR STANLEY, INC. PRODUCT MUST BE PERMANENTLY AFFIXED TO THE GROUND. CONSULT YOUR LOCAL CODES FOR REGULATIONS.
- 4. ANCHOR BOLTS NOT PROVIDED BY VICTOR STANLEY, INC.
- 5. FOR HIGH SALT ABUSIVE CLIMATES, HOT-DIP GALVANIZING BEFORE POWDER COATING IS AVAILABLE. HOT-DIP GALVANIZING IS PERFORMED FOR VICTOR STANLEY, INC. BY AN EXPERIENCED QUALIFIED FIRM TO WHICH PRODUCTS ARE SHIPPED FOR GALVANIZING. HOT-DIP GALVANIZING INCLUDES AN AGGRESSIVE PRE-TREATMENT AND IMMERSION IN A TANK OF CHARGED LIQUID ZINC AT OR AROUND 860°F (460°C). THE RESULTING SURFACE IS RESISTANT TO RUST BUT HAS SOME UNEVENNESS RESULTING FROM THE BONDING OF THE ZINC TO THE STEEL SURFACE. AS A RESULT, THE POWDER-COATING SURFACE FINISH OVER THAT GALVANIZED SURFACE MAY EXHIBIT BUMPS, UNEVENNESS, AND MAY NOT BE AS SMOOTH AS THE STANDARD FINISH; THIS UNEVEN AND INCONSISTENT FINISH IS NORMAL FOR GALVANIZING. CONTACT MANUFACTURER FOR DETAILS.
- 6. ALL SPECIFICATIONS ARE SUBJECT TO CHANGE. CONTACT MANUFACTURER FOR DETAILS.
- 7. THIS PRODUCT IS SHIPPED PARITALLY UNASSEMBLED.

ALL STEEL CONTOURED BENCH SHOWN: STANDARD 6-FOOT LENGTH

1 BENCH

STEELSITES RB (RB-28)

NOT TO SCALE

DATE BY DESCRIPTION DATE BY DESCRIPTION


ANGELA BIAGI
L.A. NO. 6666787
WGI, INC.
2035 VISTA PARKWAY
WEST PALM BEACH, FL 33411

VIGTOR STANLEY

Create a timeless moment.

* ALL DIMENSIONS ARE IN INCHES *

P.O. DRAWER 330 - DUNKIRK, MD 20754 USA TOLL FREE: (800) 368-2573 (USA & CANADA) TEL (301) 855-8300 - FAX (410) 257-7579 WEB SITE: HTTP://WWW.VICTORSTANLEY.COM

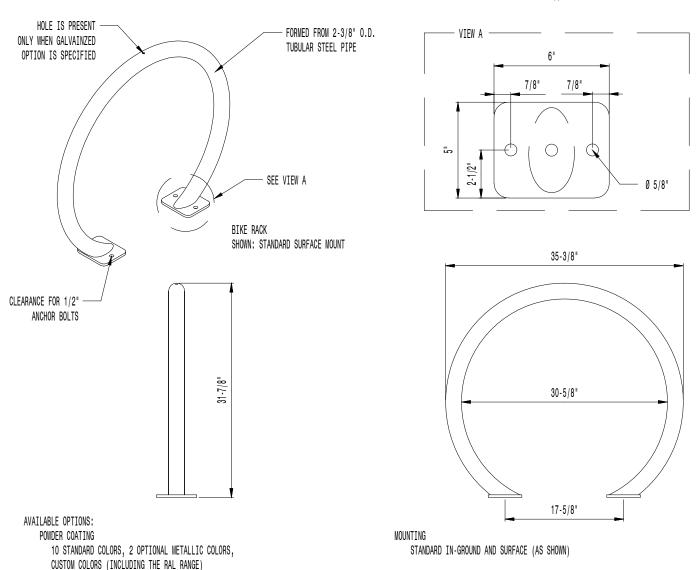


NOTES:

- 1. DRAWINGS NOT TO SCALE. DO NOT SCALE DRAWINGS.
- ALL FABRICATED METAL COMPONENTS ARE STEEL SHOTBLASTED, ETCHED, PHOSPHATIZED, PREHEATED, AND ELECTROSTATICALLY POWDER-COATED WITH T.G.I.C. POLYESTER POWDER
 COATINGS. PRODUCTS ARE FULLY CLEANED AND PRETREATED, PREHEATED AND COATED WHILE HOT TO FILL CREVICES AND BUILD COATING FILM. COATED PARTS ARE THEN FULLY
 CURED TO COATING MANUFACTURER'S SPECIFICATIONS. THE THICKNESS OF THE RESULTING FINISH AVERAGES 8-10 MILS (200-250 MICRONS).
- 3. IT IS NOT RECOMMENDED TO LOCATE ANCHOR BOLTS UNTIL BIKE RACK IS IN PLACE. THIS VICTOR STANLEY, INC. PRODUCT MUST BE PERMANENTLY AFFIXED TO THE GROUND. CONSULT YOUR LOCAL CODES FOR REGULATIONS.
- 4. ANCHOR BOLTS NOT PROVIDED BY VICTOR STANLEY, INC.
- 5. FOR HIGH SALT ABUSIVE CLIMATES, HOT-DIP GALVANIZING BEFORE POWDER COATING IS AVAILABLE. HOT-DIP GALVANIZING IS PERFORMED FOR VICTOR STANLEY, INC. BY AN EXPERIENCED QUALIFIED FIRM TO WHICH PRODUCTS ARE SHIPPED FOR GALVANIZING. HOT-DIP GALVANIZING INCLUDES AN AGGRESSIVE PRE-TREATMENT AND IMMERSION IN A TANK OF CHARGED LIQUID ZINC AT OR AROUND 860°F (460°C). THE RESULTING SURFACE IS RESISTANT TO RUST BUT HAS SOME UNEVENNESS RESULTING FROM THE BONDING OF THE ZINC TO THE STEEL SURFACE. AS A RESULT, THE POWDER-COATING SURFACE FINISH OVER THAT GALVANIZED SURFACE MAY EXHIBIT BUMPS, UNEVENNESS, AND MAY NOT BE AS SMOOTH AS THE STANDARD FINISH; THIS UNEVEN AND INCONSISTENT FINISH IS NORMAL FOR GALVANIZING. CONTACT MANUFACTURER FOR DETAILS.
- 6. ALL SPECIFICATIONS ARE SUBJECT TO CHANGE, CONTACT MANUFACTURER FOR DETAILS
- 7. THIS PRODUCT IS SHIPPED FULLY ASSEMBLED.

BIKE RACK


CYCLE SENTRY (BRHS-101)


NOT TO SCALE

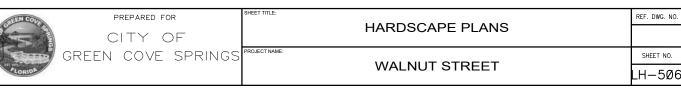

NOTES:

1. STRUCTURAL SOIL LAYOUT VARIES PER TREE AND SITE CONDITIONS. SEE HARDSCAPE PLANS FOR LOCATIONS AND LIMITS.

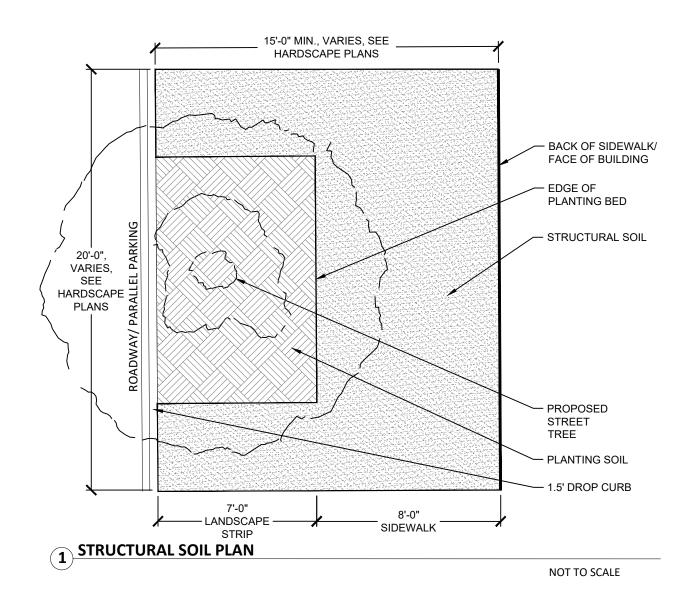

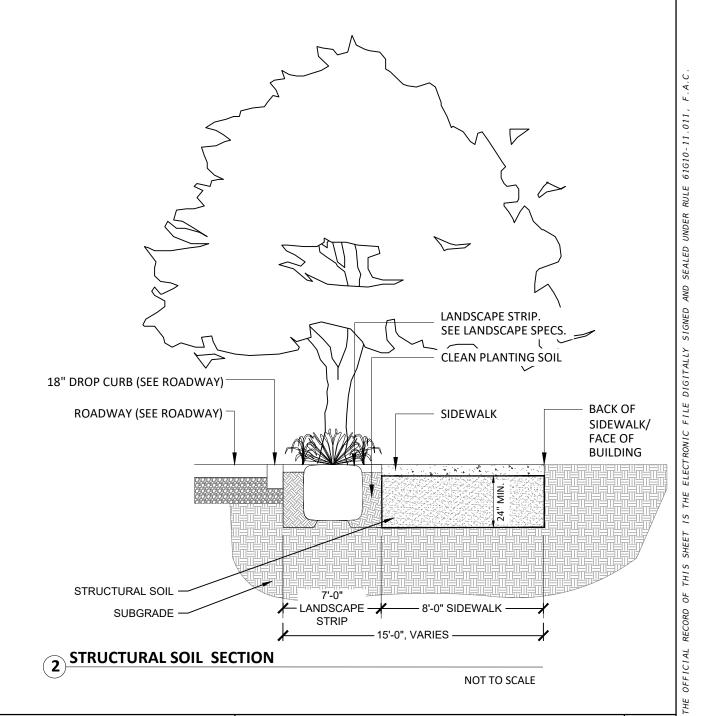

DATE BY DESCRIPTION DATE BY DESCRIPTION

ANGELA BIAGI
L.A. NO. 6666787
WGI, INC.
2035 VISTA PARKWAY
WEST PALM BEACH, FL 33411

CHILD CONTRACTOR CONTR

PREPARED FOR

CITY OF

GREEN COVE SPRINGS


HARDSCAPE PLANS


WALNUT STREET

SHEET NO.

LH-5Ø7


REF. DWG. NO.

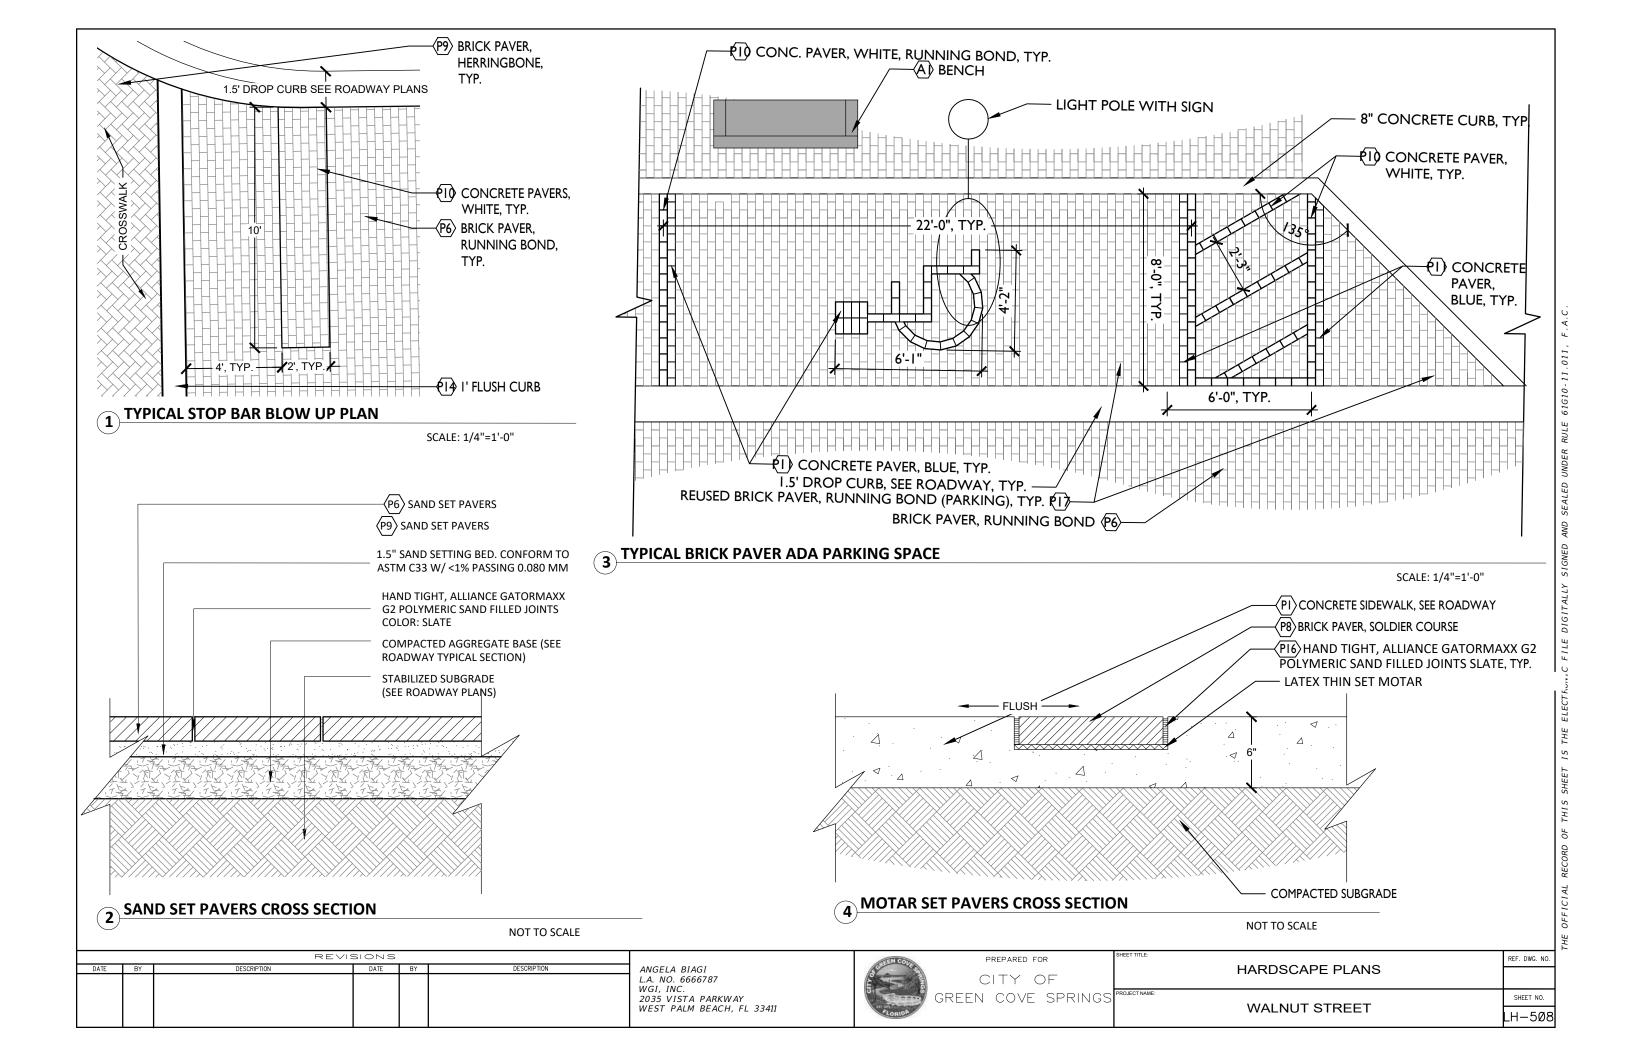

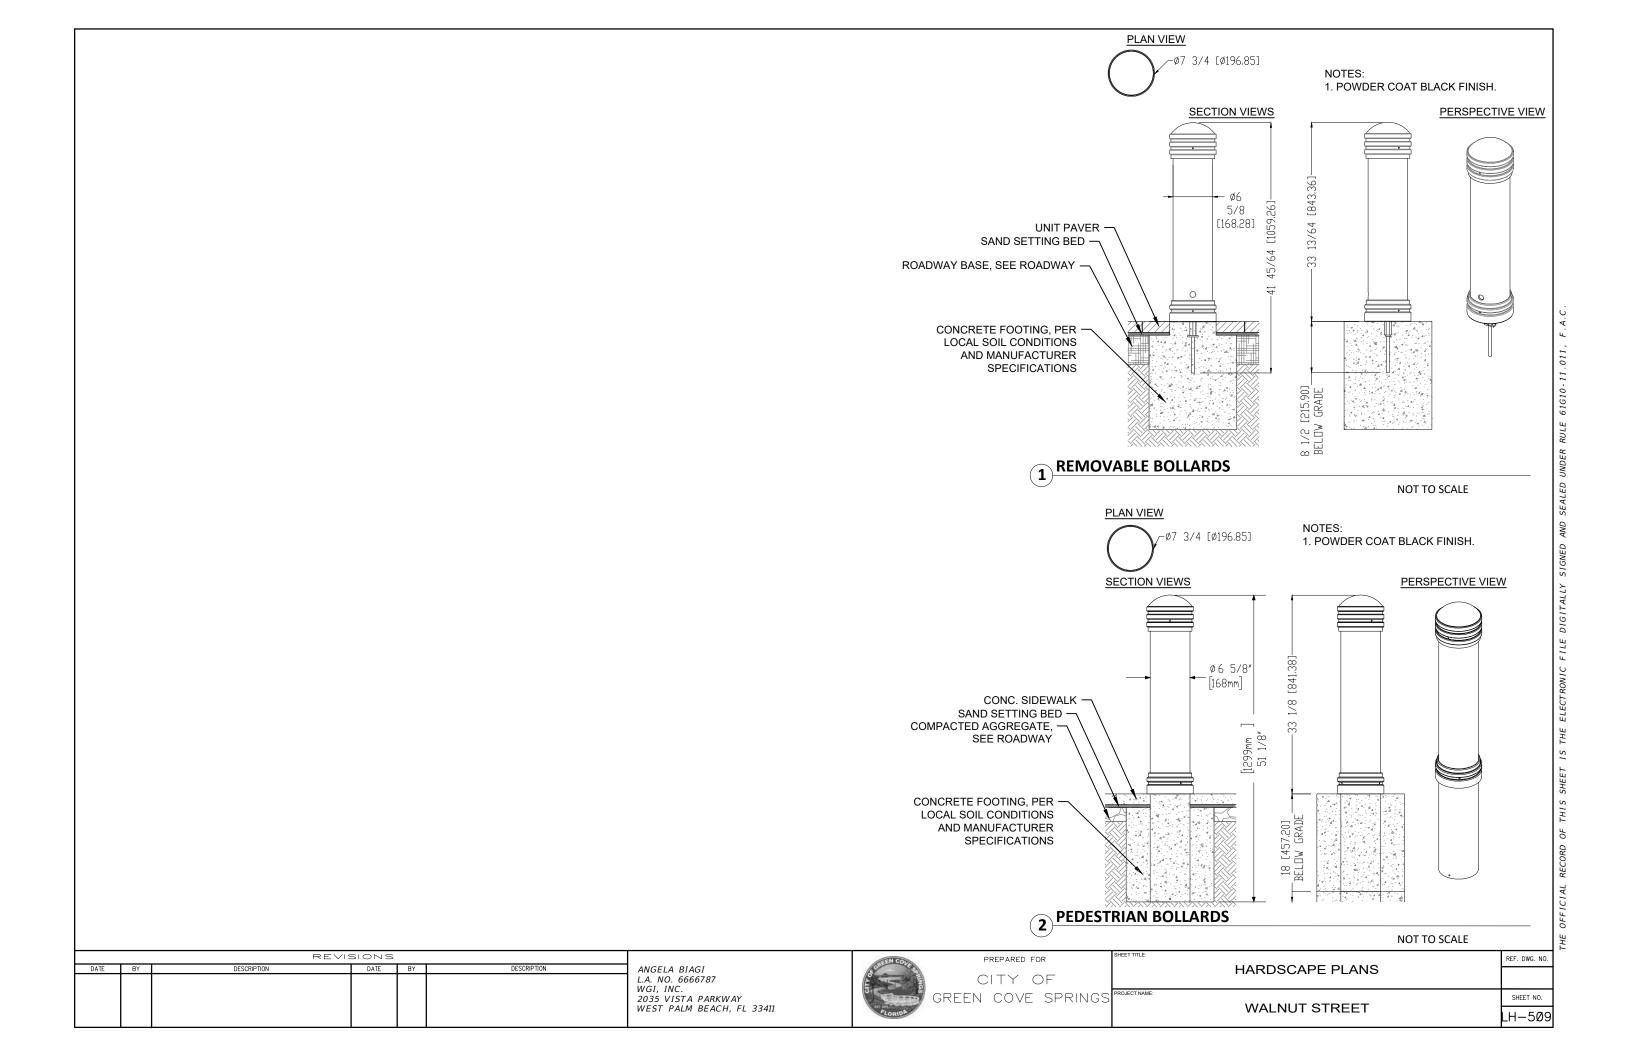

EARTHPLANTER 13 PULASKI STREET AUBURN, NY 13021 PHONE: (877) 815-9276 www.earthplanter.com



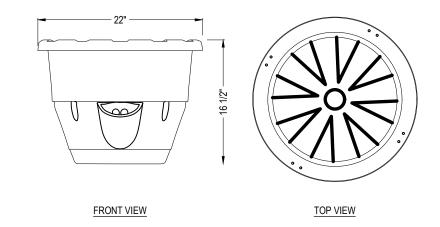

FEATURES:

- EARTHPLANTER QUALITY THERMOFORMED CONSTRUCTION ENSURES YEARS OF
- OUTSTANDING PERFORMANCE IN THE TOUGHEST COMMERCIAL ENVIRONMENTS - INDUSTRY LEADING WICKING SYSTEM - PROVIDES SUPERIOR BOTTOM FEEDING
- WHILE REGULATING WATER DELIVERY BASED ON SOIL CONDITIONS - SIDE FILL PORT - PROVIDES EASY ACCESS AND ALLOWS WORKERS TO HOOK INTO
- THE PORT WITH MOST COMMERCIAL SPRAYER HEADS
- UNMATCHED WARRANTY 10 YEARS ON PLANTER, 5 YEARS ON WICK **SPECIFICATIONS**

DIMENSIONS: 22" TOP OUTSIDE DIAMETER X 16 1/2" H

PLANTING TRAY DEPTH: 8" WATER CAPACITY: 4 GALLONS

SIDE VIEW

SOIL CAPACITY: APPROX. 1.0 CUBIC FEET – PRO MIX BX OR EQUIVALENT SOIL REQUIRED PRODUCT WEIGHT: 10 LBS. (SHIP WEIGHT) / APPROX. 70 LBS. WITH FULL RESERVOIR, & WET SOIL

WATERING CYCLE: ONCE EVERY 5-7 DAYS (VARIES BASED ON LOCATION AND WEATHER CONDITIONS)

MATERIAL: THERMOFORMED HIGH-DENSITY POLYETHYLENE

CHAINS: 20" STAINLESS POWDER COATED BLACK 200 LB. CAPACITY PER CHAIN

COLOR: BLACK STACKABLE: YES

INCLUDES: BASKET, PLANTING TRAY WITH INTEGRATED WICK, (4) CHAINS, (4) U-HOOKS WITH PLATES & BOLTS, (1) S-HOOK NOTES:

- 1. INSTALLATION TO BE COMPLETED IN ACCORDANCE WITH MANUFACTURER'S SPECIFICATIONS.
- 2. DO NOT SCALE DRAWING.
- 3. THIS DRAWING IS INTENDED FOR USE BY ARCHITECTS, ENGINEERS, CONTRACTORS, CONSULTANTS AND DESIGN PROFESSIONALS FOR PLANNING PURPOSES ONLY. THIS DRAWING MAY NOT BE USED FOR CONSTRUCTION.
- 4. ALL INFORMATION CONTAINED HEREIN WAS CURRENT AT THE TIME OF DEVELOPMENT BUT MUST BE REVIEWED AND APPROVED BY THE PRODUCT MANUFACTURER TO BE CONSIDERED ACCURATE.




PRO-SERIES SELF WATERING HANGING BASKET (EPPS22)

NOT TO SCALE



- SELECT DESIRED SIZE:
- STANDARD
- (FITS MOST POLES 4-5" IN DIAMETER)

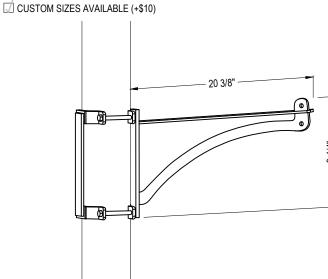

PERSPECTIVE

FEATURES:

- EARTHPLANTER CERTIFIED TO HOLD OVER 300 LBS.
- MADE FROM 1/4" HOT ROLLED STEEL
- REQUIRES 35-40% LESS POLE SPACE THAN COMPETITIVE PRODUCTS
- FINISH: BLACK POWDER COAT
- POLE BRACKETS AND HARDWARE INCLUDED
- 10 YEAR WARRANTY

SPECIFICATIONS

ALL SPECS ARE PER BRACKET ARM

BRACKET ARM: LENGTH 20 3/8" X 8 3/4" HEIGHT (PER ARM)

POLE BRACKET: 9 1/4" HEIGHT

WEIGHT: 5 LBS. (6 LBS. WITH BRACKET) SKU: EPBDA20

NOTES:

ANGELA BIAGI

L.A. NO. 6666787


2035 VISTA PARKWAY WEST PALM BEACH, FL 33411

- INSTALLATION TO BE COMPLETED IN ACCORDANCE WITH MANUFACTURER'S SPECIFICATIONS.
- DO NOT SCALE DRAWING.
- THIS DRAWING IS INTENDED FOR USE BY ARCHITECTS, ENGINEERS, CONTRACTORS, CONSULTANTS AND DESIGN PROFESSIONALS FOR PLANNING PURPOSES ONLY. THIS DRAWING MAY NOT BE USED FOR CONSTRUCTION.
- ALL INFORMATION CONTAINED HEREIN WAS CURRENT AT THE TIME OF DEVELOPMENT BUT MUST BE REVIEWED AND APPROVED BY THE PRODUCT MANUFACTURER TO BE CONSIDERED ACCURATE.

HANGING BASKET BRACKET (2

SINGLE ARM BRACKET (EPBDA-4R)

NOT TO SCALE

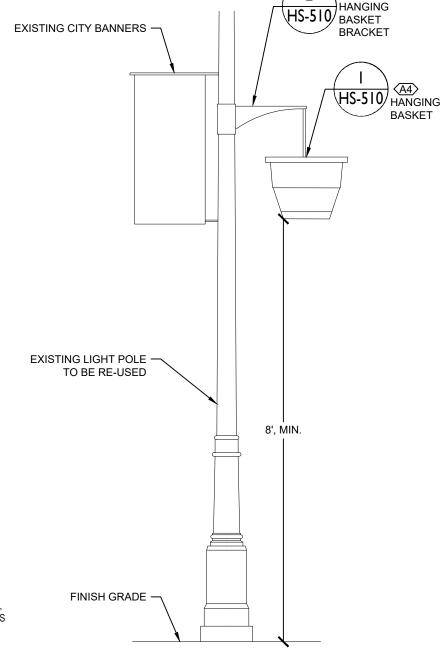


(3) HANGING ON LIGHT POLE

NOT TO SCALE

REVISIONS DATE BY DESCRIPTION DATE

PREPARED FOR CITY OF

REF. DWG. NO. HARDSCAPE PLANS GREEN COVE SPRINGS SHEET NO. **WALNUT STREET** HS-51@

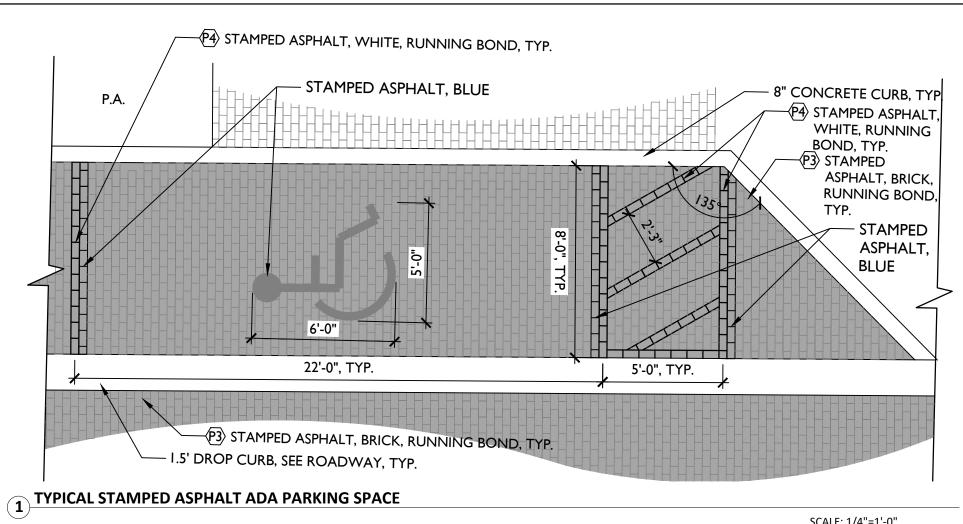

SCALE: 1/4"=1'-0"



2 PLANTERS

NOT TO SCALE

REVISIONS REF. DWG. NO. PREPARED FOR ANGELA BIAGI L.A. NO. 6666787 WGI, INC. 2035 VISTA PARKWAY WEST PALM BEACH, FL 33411 DATE BY DESCRIPTION DATE HARDSCAPE PLANS CITY OF GREEN COVE SPRINGS SHEET NO. WALNUT STREET LH-511

- THESE CONSTRUCTION DOCUMENTS ARE ONLY INTENDED TO CONVEY OVERALL DESIGN INTENT, FORM, AND FINISHES. THE CONTRACTOR IS
 RESPONSIBLE TO INSTALL ALL WORK IN ACCORDANCE WITH THE RELEVANT AND APPLICABLE SECTIONS OF THE CSI, ASTM, AND/OR OTHER AIA/ASLA
 RECOGNIZED TRADE AGENCY, OR ANY LOCAL, COUNTY, OR STATE BUILDING CODES. THE LANDSCAPE ARCHITECT SHALL BEAR NO RESPONSIBILITY FOR
 ANY CONTRACTOR'S METHODS OF WORK.
- 2. THE CONTRACTOR SHALL VISIT THE SITE TO UNDERSTAND THE SCOPE AND EXISTING CONDITIONS PRIOR TO SUBMITTING A BID. NO ALLOWANCES WILL BE MADE DUE TO A FAILURE TO THOROUGHLY UNDERSTAND EXISTING CONDITIONS.
- 3. ALL DRAWINGS SHALL BE READ IN CONJUNCTION WITH THE TECHNICAL SPECIFICATIONS.
- 4. QUANTITIES PROVIDED ARE FOR REFERENCE ONLY, IT IS THE CONTRACTOR'S RESPONSIBILITY TO VERIFY ALL QUANTITIES PRIOR TO SUBMITTING A BID.
- 5. CONTRACTOR SHALL GUARANTEE THE PERFORMANCE OF ALL WORK FOR THE PERIOD OF ONE YEAR FROM THE DATE OF FINAL ACCEPTANCE.
- 6. CONTRACTOR SHALL SECURE ANY AND ALL NECESSARY PERMITS FOR THE WORK PRIOR TO COMMENCING OF THEIR OPERATIONS ON-SITE. INCLUDING THE LOCAL MUNICIPALITY, COUNTY, AND STATE IN WHICH THE SITE IS LOCATED. COPIES OF THE PERMITS SHALL BE SENT TO THE OWNER AND KEPT ON-SITE BY THE GENERAL CONTRACTOR.
- 7. ALL WORK SHALL CONFORM WITH GOVERNING JURISDICTIONS.
- 8. ANY WORK IN THE RIGHT-OF-WAY SHALL CONFORM TO THE STANDARDS AND SPECIFICATIONS OF LOCAL AND/OR STATE HIGHWAY JURISDICTION.
- 9. THE APPROPRIATE UTILITY COMPANIES SHALL BE NOTIFIED BY THE CONTRACTOR (SUNSHINE 811) AT LEAST 48 HOURS IN ADVANCE OF ANY EXCAVATION. CONTRACTOR TO COORDINATE FIELD VISITS WITH UTILITY REPRESENTATIVES TO LOCATE UTILITIES AND INVESTIGATE FOR CONFLICTS WITHIN THE PROJECT LIMITS.
- 10. LOCATIONS OF UNDERGROUND UTILITIES ARE APPROXIMATE ONLY, DETERMINING EXACT ELEVATIONS, ALIGNMENTS AND POSSIBLE CONFLICTS ARE THE RESPONSIBILITY OF THE CONTRACTOR. THIS UNCERTAINTY SHALL BE FACTORED IN THE BID OF THE CONTRACTOR.
- 11. ALL MATERIALS, PRODUCTS, AND EQUIPMENT SHALL BE STORED IN AN ORGANIZED FASHION AS DIRECTED BY THE OWNER.
- 12. CONTRACTOR RESPONSIBLE FOR LEGAL REMOVAL AND DISPOSAL OF DEMOLISHED CONCRETE, SUB-BASE AND COMPACTED ROAD ROCK.
- 13. CONTRACTOR IS RESPONSIBLE FOR PRESERVING AND PROTECTING ALL EXISTING LANDSCAPE MATERIAL AS NOTED PER THE PLANS. IF ANY OF THE PROTECTED, PRESERVED, OR RELOCATED TREES DIE DURING CONSTRUCTION OR THE WARRANTY PERIOD, THE CONTRACTOR SHALL REPLACE THE LANDSCAPE MATERIAL IN KIND.
- 14. ALL SLEEVES ON THE PLANS FOR WALL PENETRATIONS, AND UNDER PAVEMENT SHALL BE SIZED TWO PIPE SIZES GREATER THAN THE PIPE IT CARRIES.
- 15. CONTRACTOR RESPONSIBLE FOR ACHIEVING ADEQUATE PERCOLATION RATE (AS DESCRIBED ON THE LANDSCAPE NOTES) AND BACK FILLING WITH SPECIFIED SOIL/MATERIAL.
- 16. EXISTING UTILITIES, MANHOLE & HANDHOLE COVERS, UTILITY VAULTS, VALVE BOXES, METER BOXES, DRAINAGE STRUCTURES, ETC. SHALL BE SET ADJUSTED TO NEW GRADE ELEVATION, UNLESS OTHERWISE NOTED.
- 17. RESTORE ALL DISTURBED AREAS TO ORIGINAL OR BETTER CONDITION.
- 18. PROPOSED SIDEWALK IS TO CONNECT TO EXISTING SIDEWALK AND MATCH EXISTING GRADE, WHERE APPLICABLE.
- 19. ALL PRODUCTS SHALL BE AS SPECIFIED, IF AN EQUIVALENT PRODUCT IS TO BE USED, IT MUST BE APPROVED BY THE LANDSCAPE ARCHITECT.
- 20. CONSTRUCTION ACCESS AND STAGING AREAS TO BE DETERMINED AT THE PRE-CONSTRUCTION MEETING.
- 21. CONTRACTOR SHALL MAINTAIN A SAFE AND CLEAN WORK SITE AT ALL TIMES WITH NO ACCESS TO THE PUBLIC. IF WORK IS TO BE COMPLETED IN THE RIGHT-OF-WAY THE CONTRACTOR SHALL PROVIDE SAFE ACCESS AND PROTECTION AROUND THE CONSTRUCTION SITE AT ALL TIMES.
- 22. CONTRACTOR SHALL BE RESPONSIBLE FOR OBTAINING THE NECESSARY TESTING TO ASSURE THAT PROPER COMPACTION HAS BEEN ACHIEVED ON SUBGRADES. BASE MATERIALS. ETC. AS PER THE PLANS AND PROVIDE COPIES TO THE OWNER, UPON REQUEST.
- 23. PRIOR TO CONSTRUCTION OR INSTALLATION, SHOP DRAWINGS/SUBMITTALS/ENGINEERING DRAWINGS SHALL BE PROVIDED TO THE LANDSCAPE ARCHITECT FOR REVIEW AND APPROVAL.
- 24. CONTRACTOR SHALL MAINTAIN A COMPLETE SET OF PROGRESS RECORD DRAWINGS (AS-BUILTS) ON-SITE DURING CONSTRUCTION INCLUDING ALL
- 25. CONTRACTOR SHALL PROVIDE THE OWNER WITH ONE (1) DIGITAL COPY AND FIVE (5) SETS OF RECORD DRAWINGS (AS-BUILTS) UPON PROJECT COMPLETION. REFER TO THE CONTRACT GENERAL CONDITIONS FOR SPECIFIC REQUIREMENTS.
- 26. SHALL THERE BE QUESTION AS TO WHICH FINISH MATERIAL IS SPECIFIED FOR ANY SURFACE SHOWN IN THE DRAWING SET, IT IS UP TO THE CONTRACTOR TO REACH OUT TO THE LANDSCAPE ARCHITECT IN THE FORM OF AN RFP, FOR CLARIFICATION. ANY USE OF MATERIAL THAT IS NOT SPECIFIED IS SUBJECT TO REMOVAL AND REPLACEMENT.
- 27. DRAINAGE AND IRRIGATION SHALL BE PROVIDED TO ALL PLANTING AREAS. INSIDE OF ALL RETAINING WALLS AND RAISED PLANTERS SHALL BE SEALED WITH AN APPROPRIATE WATER-PROOFING SUBSTANCE, AND SHALL NOT BE VISIBLE ONCE SOIL IS BACKFILLED.
- 28. PROPOSED PLANT MATERIAL SHALL TAKE PRECEDENCE WHEN DETERMINING UNDERGROUND PIPING AND UTILITY LOCATIONS, UNLESS OTHERWISE NOTED. CONTRACTOR SHALL PROVIDE CLEARANCES NECESSARY TO INSTALL PROPOSED LANDSCAPE/HARDSCAPE ELEMENTS.
- 29. CONTRACTOR SHALL RELOCATE OR ADJUST ANY UTILITIES/PIPING THAT INTERFERES WITH THE INSTALLATION OF PLANT MATERIALS AT HIS OWN EXPENSE.
- 30. CONTRACTOR SHALL BE RESPONSIBLE FOR PROVIDING MINIMUM TWO (2) SLEEVES TO ACCOMMODATE IRRIGATION/ELECTRICAL/DRAINAGE AS NEEDED TO ANY ISOLATED PLANTING AREA.

- 31. FINAL GRADING SHALL BE REVIEWED OR COMPLETED BY A CIVIL ENGINEER.
- 32. MAINTAIN EXISTING GRADE TO THE DRIP LINE OF EXISTING TREES.
- 33. NEW EARTHWORK SHALL BE BLENDED INTO ADDITIONAL GRADE.
- 34. 'PA' INDICATES PLANTING AREA. IN THESE AREAS, THE FILL SOIL SHALL BE OF A QUALITY OF SANDY LOAM ABLE TO SUPPORT PLANT LIFE, AS DETERMINED BY THE LANDSCAPE ARCHITECT, AND SHALL BE FREE OF ROCKS, SHELLS, OR RUBBLE.
- 35. INSTALL ALL HARDSCAPE ELEMENTS IN ACCORDANCE WITH ENGINEERS DRAWINGS INCLUDING DRAINAGE, WALLS, STEPS, POOLS, SPAS, OR ANY OTHER STRUCTURES.
- 36. CAPSTONES SHALL BE SECURED WITH AN EXTERIOR RATED CONCRETE CONSTRUCTION ADHESIVE. OR AS RECOMMENDED BY THE MANUFACTURER
- 37. CONCRETE, UNLESS OTHERWISE NOTED BY ENGINEER, SHALL MEET THE FOLLOWING REQUIREMENTS.
- 37.1. 28-DAY COMPRESSIVE STRENGTH:

37.1.1.SIDEWALKS 2500 PSI

37.1.2.FOUNDATIONS AND PATIO SLABS* 3000 PSI - FIBER REINFORCED

37.1.3.COLUMNS, BEAMS, AND SLABS 4000 PSI

- 37.2. SLAB SURFACE FINISH: UNLESS OTHERWISE NOTED, ALL CONCRETE SLABS AND WALKWAYS SHALL RECIEVE A NON-SKID, LIGHT BROOMED FINISH. FINISH AND COLOR SHALL BE UNIFORM AND CONSISTENT OVER THE ENTIRE SURFACE. TOOL EDGES OF PAVEMENT, GUTTERS, CURBS, AND JOINTS.
- 37.3. PROVIDE GROOVED OR CONTROL JOINTS AS NOTED BY ENGINEERS SPECIFICATIONS, OR EVERY 6' O.C. SAWCUT JOINTS SHALL NOT BE ALLOWED
- 38. A WEEP HOLE SHALL BE PROVIDED FOR EVERY 3-5 FEET LENGTH OF A WALL. WHERE WEEP HOLES EMIT INTO A LANDSCAPE BED, THEY SHALL EMIT 4-6"
 ABOVE FINISHED GRADE UNLESS OTHERWISE NOTED. WHERE WEEP HOLES EMIT ONTO A PAVED AREA, EVERY POSSIBLE ATTEMPT SHALL BE TAKEN TO
 HIDE THE PRESENCE OF THE WEEP HOLE, INCLUDING ENDING THE PIPE BEHIND THE FINISH MATERIAL, AND PROVIDING A SMALL GAP OR HOLE IN THE
 FINISH MATERIAL TO LET WATER ESCAPE.
- 39. ONCE GRADING OPERATIONS ARE COMPLETED, ALL DISTURBED AREAS SHALL BE STABILIZED BY FINE GRADING.
- 40. ALL SEDIMENT WILL BE PREVENTED FROM ENTERING ANY STORM DRAINAGE SYSTEM THROUGH THE USE OF, BUT NOT LIMITED TO, THE FOLLOWING MEASURES: SILT FENCES, STRAW BALES, GRAVEL, BOARDS, GUTTER GUARDS, DRAIN GUARDS. THE CONTRACTOR SHALL BE RESPONSIBLE FOR MITIGATING ALL SEDIMENT LEAVING THE SITE AND TAKE APPROPRIATE CORRECTIVE MEASURES.

LAYOUT NOTES

- THE CONTRACTOR IS RESPONSIBLE FOR ACCURATELY SURVEYING AND LAYING OUT THE PROPOSED WORK FOR CONSTRUCTION. ANY DISTURBED OR LOST SURVEY MARKERS TO BE REPLACED AS REQUIRED BY THE CONTRACTOR. THE CONTRACTOR IS RESPONSIBLE FOR VERIFYING GRADES, LINES, DIMENSIONS, EXISTING CONDITIONS AND REPORT ANY ERRORS, OMISSIONS, OR INCONSISTENCIES TO THE LANDSCAPE ARCHITECT PRIOR TO COMMENCING WORK.
- 2. DO NOT SCALE THE DRAWINGS. CONTRACTOR SHALL VERIFY AND BE RESPONSIBLE FOR ALL DIMENSIONS AND CONDITIONS ON THE JOB AND THE LANDSCAPE ARCHITECT SHALL BE INFORMED OF ANY VARIATIONS FROM THE DIMENSIONS AND CONDITIONS SHOWN ON THE DRAWINGS PRIOR TO CONTINUING WITH THE WORK.
- 3. CONTRACTOR MAY REQUEST DIGITAL DRAWING FILES FOR CONSTRUCTION LAYOUT PURPOSES.
- 4. THE LIMIT OF WORK LINE SHOULD BE STAKED TO ESTABLISH THE DISTURBED AREAS. ANTI-SILTATION BARRIERS AND FILTERS TO BE PLACED AT LOW POINTS TO PREVENT CONSTRUCTION SITE RUN-OFF FROM CONTAMINATING ADJACENT LAND AND WATER BODIES.

GREN COVE DE LA COVE D	prepared for	HARDSCAPE PLANS		
	GREEN COVE SPRINGS	PROJECT NAME: WALNUT STREET		

REF. DWG. NO

SHEET NO

_H-51

			MATERIALS SCHEDULE						
PAVING SURFACING									
CODE	MATERIAL	MANUFACTURER OR DISTRIBUTOR	SERIES, MODEL, SIZE	COLOR, FINISH, AND PATTERN	RECOMMENDATIONS AND NOTES				
P1	CONCRETE SIDEWALK	SEE ROADWAY	SEE ROADWAY	SEE ROADWAY	SEE ROADWAY				
P2	ASPHALT	SEE ROADWAY	SEE ROADWAY	SEE ROADWAY	SEE ROADWAY				
P3	STAMPED ASPHALT (ROADWAY)	ATLANTIC PAVING, (30S)- S13- 8632	STREET BRICK XL OR APPROVED EQUAL	BRICK, OFFSET BRICK					
	STAMPED ASPHALT (STOP BAR AND PARKING		STREET BRICK XL						
P4	STRIPING)	ATLANTIC PAVING, (30S)- S13- 8632	OR APPROVED EQUAL	WHITE, OFFSET BRICK					
PS	STAMPED ASPHALT (CROSSWALK)	ATLANTIC PAVING, (30S)- S13- 8632	STREET BRICK XL OR APPROVED EQUAL	BRICK, HERRINGBONE					
P6	REUSED CLAY BRICK PAVER (ROADWAY)	REUSED	APPROX. 8-S/8"x 3.2"x 3.98" DEPTH	SALVAGE FROM ROADWAY, RUNNING BOND	SAND SET				
P8	CLAY BRICK PAVERS (SIDEWALK)	CASH BUILDING MATERIALS, 904-3SS-66S1	22SO424 – PINE HALL RED BRICK OR APPROVED EQUAL	NEW TO MATCH REUSED, BRICK RED, SOLDIER COURSE, MORTAR SET	MORTAR SET				
P9	CLAY BRICK PAVERS (CROSSWALK)	CASH BUILDING MATERIALS, 904-3SS-66S1	22S0424 – PINE HALL RED BRICK OR APPROVED EQUAL	NEW TO MATCH REUSED, BRICK RED, HERRINGBONE	SAND SET				
P10	CONCRETE PAVERS (STOP BAR AND PARKING STRIPING)	LOWCOUNTRY BLOCK & PAVER, 866-468-3S61	PARKING PAVERS OR APPROVED EQUAL	WHITE, CLASSIC, RUNNING BOND	SAND SET				
P11	CONCRETE PAVERS (ADA PARKING)	LOWCOUNTRY BLOCK & PAVER, 866-468-3S61	PARKING PAVERS OR APPROVED EQUAL	BLUE, CLASSIC, RUNNING BOND	SAND SET				
P12	CONCRETE ADA DOMES	LOWCOUNTRY BLOCK & PAVER, 866-468-3S61	ADA PAVERS OR APPROVED EQUAL	WHITE	IN CONCRETE LANDING, MORTAR SET				
P13	CONCRETE ADA DOMES	LOWCOUNTRY BLOCK & PAVER, 866-468-3561	ADA PAVERS OR APPROVED EQUAL	RED	IN CONCRETE LANDING, MORTAR SET				
P14	FLUSH CURB (CROSSWALKS)	SEE ROADWAY	1' CONCRETE	SEE ROADWAY	SEE ROADWAY				
P1S	FLUSH CURB	SEE ROADWAY	8" CONCRETE	SEE ROADWAY	SEE ROADWAY				
P16	POLYMERIC SAND	ALLIANCE GATOR	SUPERSAND G2 POLYMERIC SAND OR APPROVED EQUAL	SLATE GRAY					
P17	REUSED CLAY BRICK PAVER (PARKING)	REUSED	APPROX. 8-7/16"x 3.91"x 3.03" DEPTH	SALVAGE FROM SIDEWALKS AND EDGE OF ROADWAY, RUNNING BOND	SAND SET				
P18	PERMEABLE PAVERS (PARKING)	BELGARD ECO HOLLAND	80 MM 4" x 8" 3 1/8" OR APPROVED EQUAL	RED, HERRINGBONE	SEE DRAINAGE PLANS				

	SITE AMENITIES										
KEYNOTE											
CODE	QTY.	MATERIAL	MANUFACTURER OR DISTRIBUTOR	SERIES, MODEL, SIZE	COLOR, FINISH, AND PATTERN	RECOMMENDATIONS AND NOTES					
			VICTOR STANLEY, BECKY MCNAMARA, 301-855-8300,		FLUSH PER MANUFACTURES RECOMMENDATIONS,						
A1	8	BENCH	BRITTANYD@VICTORSTANLEY.COM	STEELSITES RB, RB-28, 6'	POWDER COAT GREEN	REFER TO DETAIL 1/LH-S06					
			VICTOR STANLEY, BECKY MCNAMARA, 301-8SS-8300,	CYCLE SENTRY, BRHS-101, IN-GROUND	FLUSH MOUNT PER MANUFACTURES						
A2	8	BIKE RACK	BRITTANYD@VICTORSTANLEY.COM	MOUNT	RECOMMENDATIONS, POWDER COAT GREEN	REFER TO DETAIL 2/LH-S06					
А3	8	TRASH RECEPTACLE				REUSE EXISTING					
				PRO-SERIES SELF WATERING HANGING							
				BASKET, EPPS22, BRACKETS - SINGLE							
				POLE BRACKET #EPBSA20-		1 BASKET AND BRACKET PER LIGHT FIXTURE, MOUNT					
A4	44	HANGING BASKETS WITH BRACKETS	EARTH PLANTER, 877-81S-9279	OR APPROVED EQUAL	BLACK	OVER SIDEWALK, REFER TO DETAIL 1-3/LH-S10					
			MAGLIN, KETT PHOMMASENH, 1-800-716-SS06	6S0 BOLLARD BASE TYPE 1, MTB6S0-B1							
AS	29	BOLLARDS	x1102, KETT.PHOMMASENH@MAGLIN.COM	OR APPROVED EQUAL	POWDER COAT BLACK	REFER TO DETAIL 2/LH-S09					
			MAGLIN, KETT PHOMMASENH, 1-800-716-SS06	6SO BOLLARD BASE TYPE 3, MTB6SO-B3							
A6	20	BOLLARDS REMOVABLE	x1102, KETT.PHOMMASENH@MAGLIN.COM	OR APPROVED EQUAL	POWDER COAT BLACK	REFER TO DETAIL 1/LH-S09					
				MOONSTONE, MN2S29, 3 SIZES- 16.5"							
			OLD TOWN FIBERGLASS, SEAN SMITH, 917-716-9242,	DIAM., 20.5" DIAM., 25" DIAM.		MIX 1 OF EACH SIZE AT ELEVEN LOCATIONS, REFER					
A8	33	PLANTERS (GROUPS OF 3 AT 11 LOCATIONS)	SEAN@JETTY14.COM	OR APPROVED EQUAL	WHITE 1S O	TO DETAIL 2/LH-S11					

DATE	BY	DESCRIPTION	DATE	BY	DESCRIPTION	ANGELA BIAGI
						L.A. NO. 6666787 WGI, INC.
						2035 VISTA PARKWAY WEST PALM BEACH, FL 33411




HARDSCAPE PLANS


WALNUT STREET


SHEET NO.

LH-6ØØ

REF. DWG. NO.

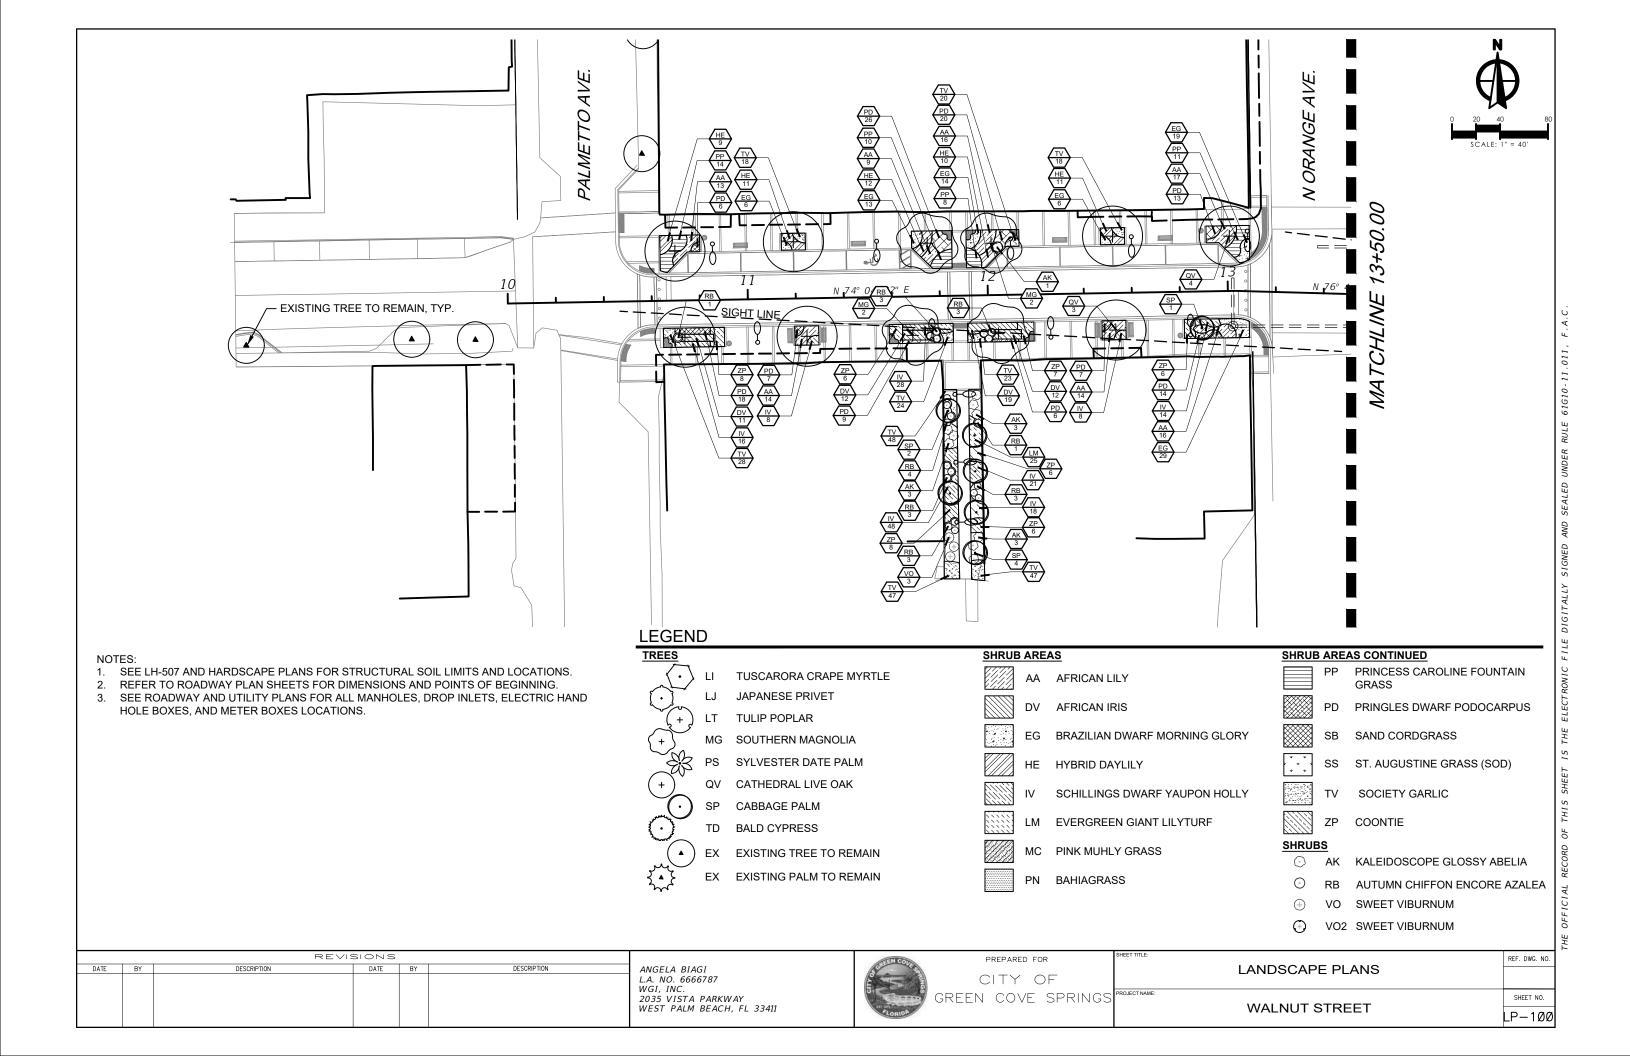

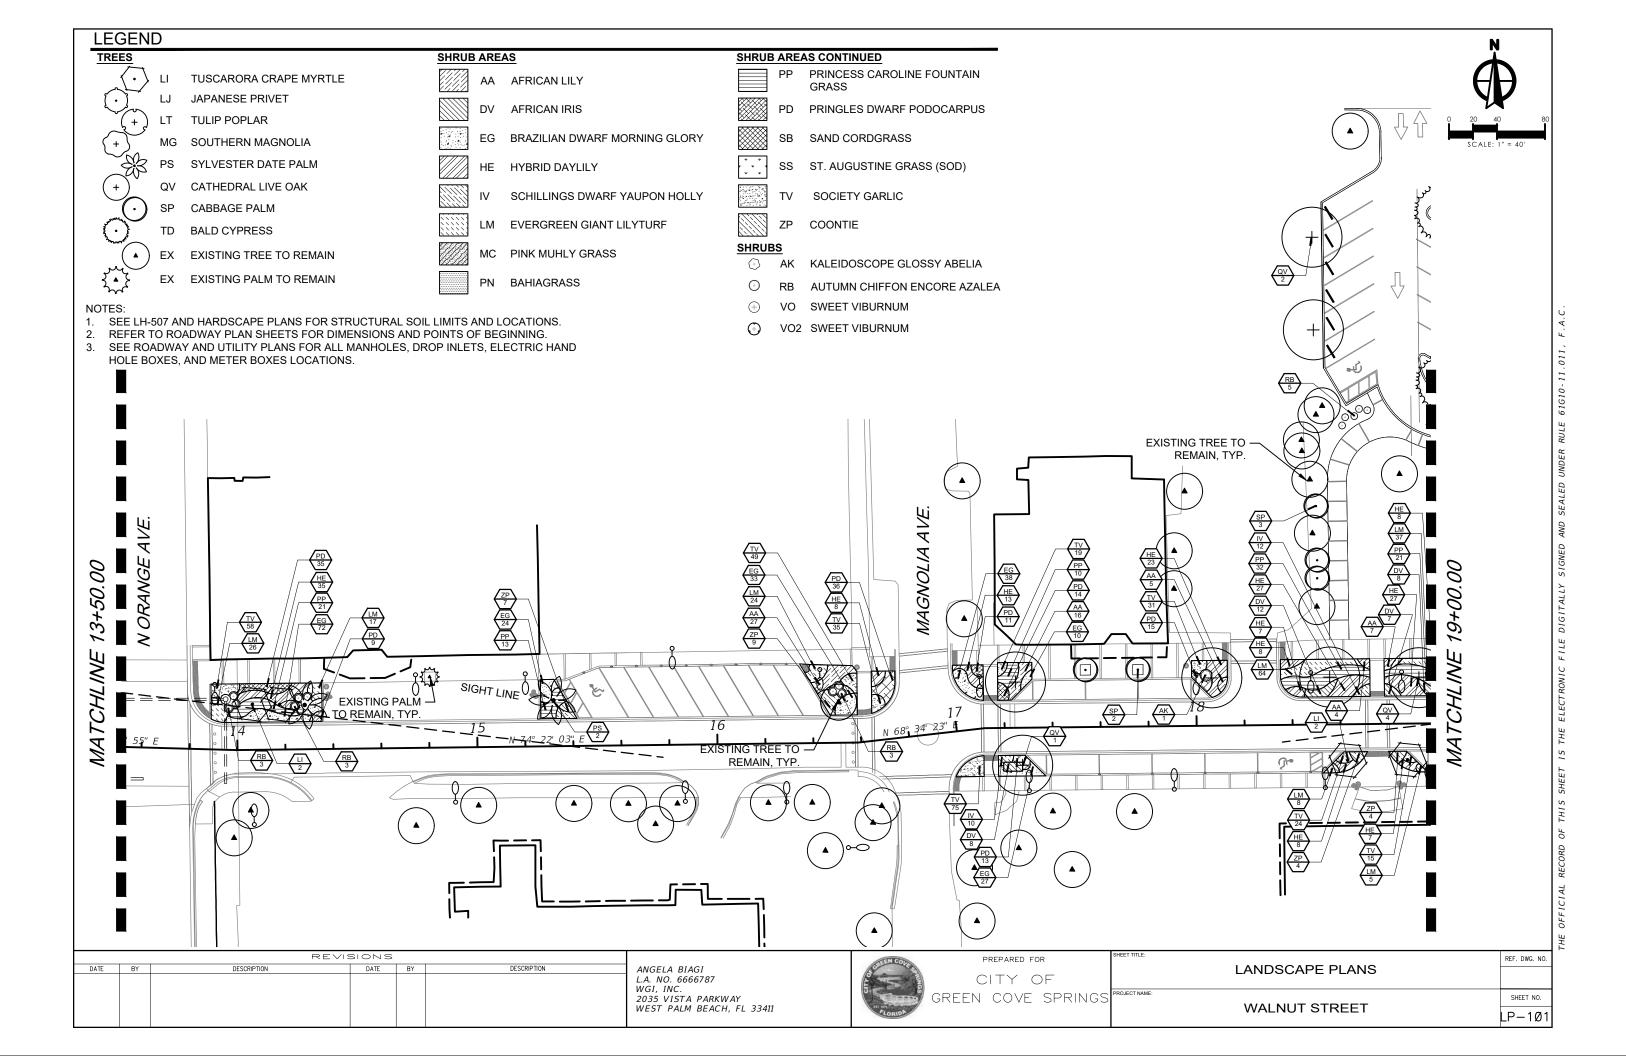

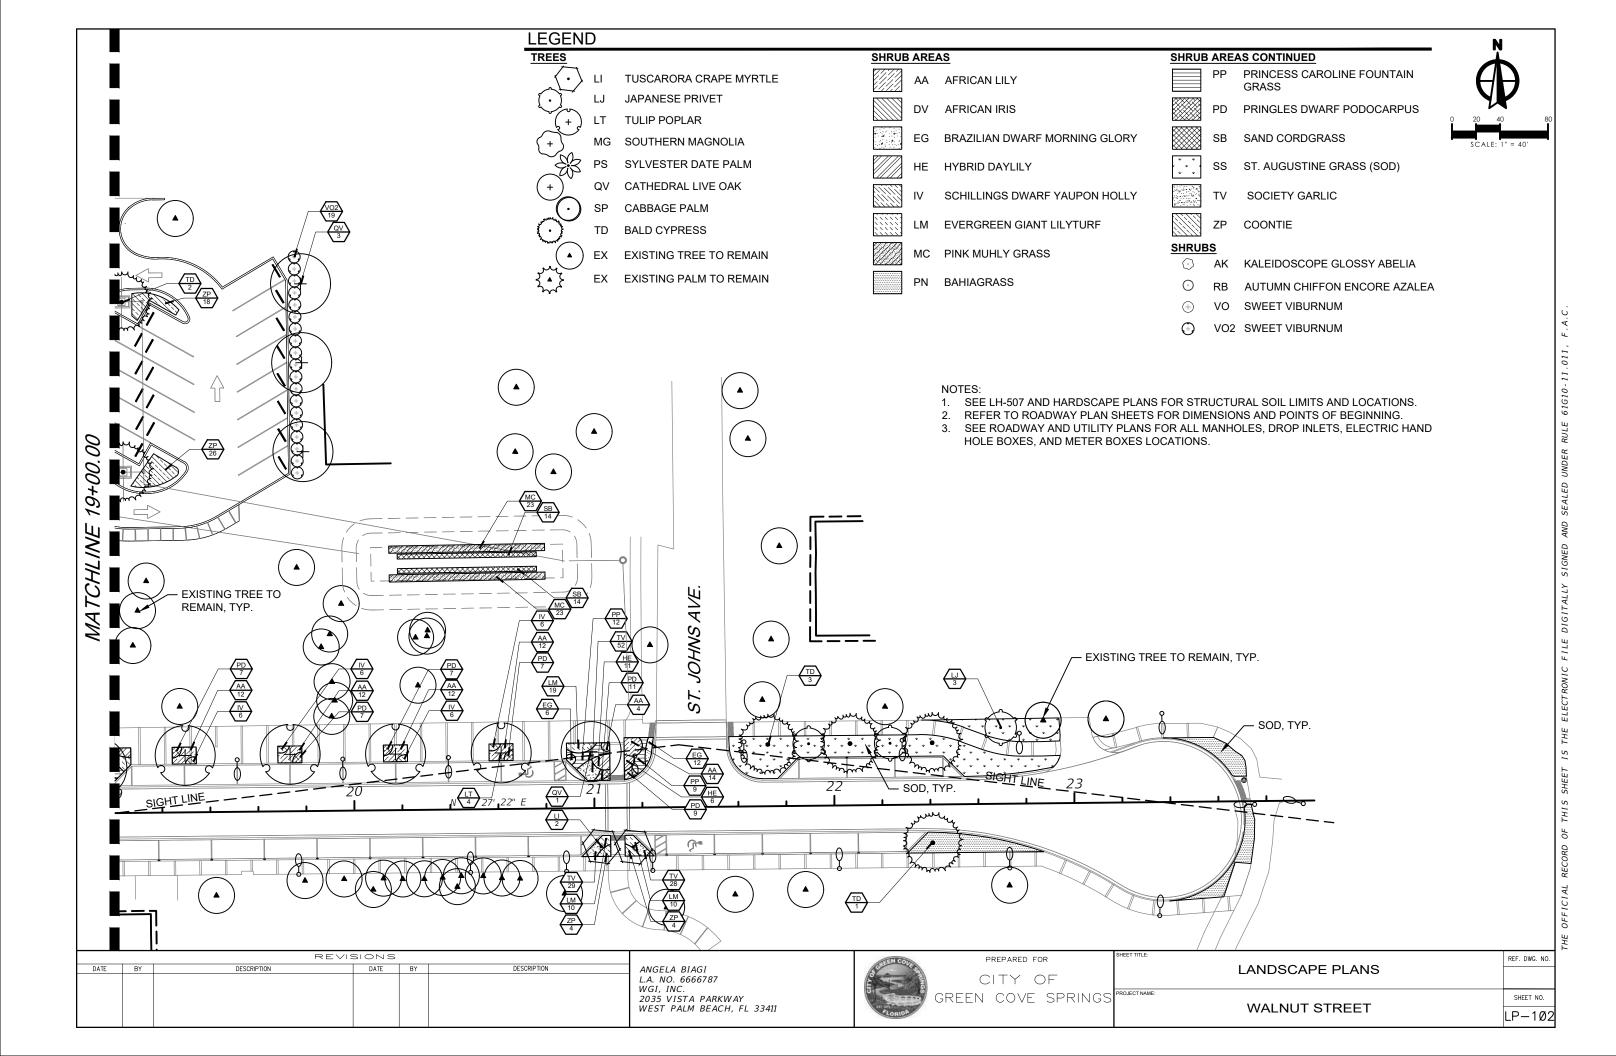

PLANT SCHEDULE

TREES	CODE	QTY	COMMON NAME	BOTANICAL NAME	REMARKS
•	LI	6	Tuscarora Crape Myrtle	Lagerstroemia indica x fauriei `Tuscarora`	10' O.A., MULTI-TRUNK
	LJ	3	Japanese Privet	Ligustrum japonicum	6-7' O.A., MULTI-TRUNK
+	LT	4	Tulip Poplar	Liriodendron tulipifera	12' ht., 2.5" cal.
+	MG	4	Southern Magnolia	Magnolia grandiflora	12' ht., 2.5" cal.
2.3	PS	2	Sylvester Date Palm	Phoenix sylvestris	14' c.t.
(+)	QV	18	Cathedral Live Oak	Quercus virginiana 'Cathedral'	20' ht., 6" cal.
	SP	12	Cabbage Palmetto	Sabal palmetto	RELOCATED
33 - C	TD	6	Bald Cypress	Taxodium distichum	12' ht., 2.5" cal.
SHRUBS	CODE	<u>QTY</u>	COMMON NAME	BOTANICAL NAME	REMARKS
	AK	11	Kaleidoscope Glossy Abelia	Abelia x grandiflora `Kaleidoscope`	24" x 24", a,s.
0	RB	35	Autumn Chiffon® Encore® Azalea	Rhododendron x `Robled`	24" x 24", a.s.
+	VO	3	Sweet Viburnum	Viburnum odoratissimum	36" x 36", a.s.
+	VO2	19	Sweet Viburnum	Viburnum odoratissimum	72" x 48", a.s.

DATE	BY	DESCRIPTION	DATE	BY	DESCRIPTION	ANGELA BIAGI
						L.A. NO. 6666787 WGI, INC. 2035 VISTA PARKWAY WEST PALM BEACH, FL 33411

PREPAR	RED FOR
5	y of)ve springs

HEET TITLE:		
	LANDSCAPE SCHEDULE	
ROJECT NAME:		
	WALNUT STREET	

REF. DWG. NO.

SHEET NO.

LP-400

PLANT SCHEDULE								
SHRUB AREAS	CODE	QTY	COMMON NAME	BOTANICAL NAME	REMARKS			
	AA	224	African Lily	Agapanthus africanus	24" x 24" @ 2' o.c.			
	DV	89	African Iris	Dietes vegeta	24" x 24" @ 2' o.c.			
	EG	309	Brazilian Dwarf Morning Glory	Evolvulus glomeratus 'Blue Daze'	12" x 12" @ 18" o.c.			
	HE	241	Hybrid Daylily	Hemerocallis x	24" x 24" @ 2' o.c.			
	IV	207	Schillings Dwarf Yaupon Holly	llex vomitoria 'Schillings Dwarf'	10" x 10" @ 2' o.c.			
	LM	245	Evergreen Giant Lilyturf	Liriope muscari 'Evergreen Giant'	12" x 12" @ 18" o.c.			
	МС	46	Pink Muhly Grass	Muhlenbergia capillaris	18" x 12" @ 36" o.c.			
	PN	689 sf	Bahiagrass	Paspalum notatum	SOD			
	PP	161	Princess Caroline Fountain Grass	Pennisetum purpureum `Princess Caroline`	18" x 18" @ 2.5' o.c.			
	PD	307	Pringles Dwarf Podocarpus	Podocarpus macrophyllus 'Pringles'	12" x 12" @ 1.5' oc			
	SB	28	Sand Cordgrass	Spartina bakeri	18" x 12" @ 36" o.c.			
\(\psi\) \(\	SS	1,734 sf	St. Augustine Grass	Stenotaphrum secundatum	SOD			
	TV	688	Society Garlic	Tulbaghia violacea	10" x 10" @ 1' o.c.			
	ZP	123	Coontie	Zamia pumila	12" x 12" @ 30" o.c.			
	NOTES:							

TBD ANNUAL PLANTING/ SEASONAL COLOR- MIX TO BE PROVIDED IN EVERY PLANTER AND HANGING BASKET. CITY TO APPROVE PLANT SELECTION.

DATE	BY	DESCRIPTION	DATE	BY	DESCRIPTION	ANGELA BIAGI
						L.A. NO. 6666787 WGI, INC. 2035 VISTA PARKWAY WEST PALM BEACH, FL 33411


GREEN COVE	F	PREPARED	FOR
O CORIDA	C GREEN	COVI	

ARED FOR	SHEET TITLE:
Y OF	
OVE SPRINGS	PROJECT NAME:

SHEET TITLE:	
	LANDSCAPE S
PROJECT NAME:	


REF. DWG. NO. SCHEDULE WALNUT STREET

SHEET NO. LP-4Ø1

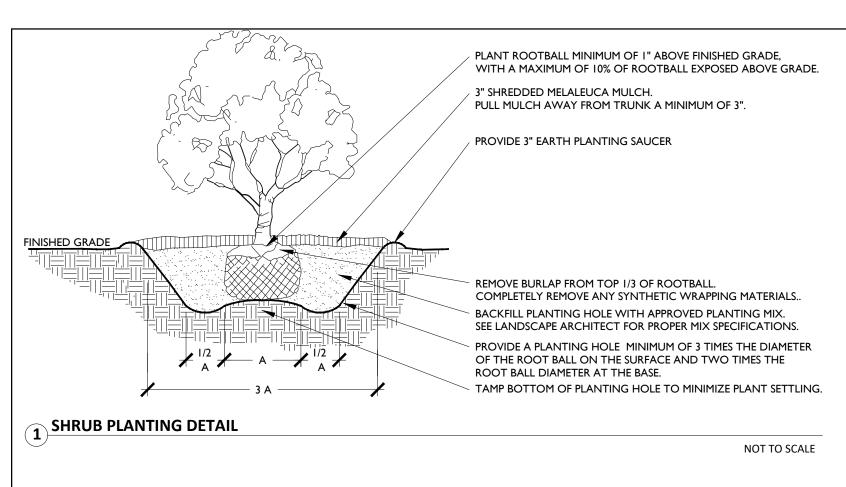


LANDSCAPE NOTES:

- I. STRUCTURAL ELEMENTS AND HARDSCAPE FEATURES INDICATED ON LANDSCAPE PLANS ARE FOR INFORMATIONAL PURPOSES ONLY. LANDSCAPE PLANS ARE TO BE UTILIZED FOR LOCATION OF LIVING PLANT MATERIAL ONLY. LANDSCAPE PLANS SHOULD NOT BE UTILIZED FOR STAKING AND LAYOUT OR LOCATION OF ANY STRUCTURAL SITE FEATURES INCLUDING BUT NOT LIMITED TO: BUILDINGS, SIGNAGE, PATHWAYS, EASEMENTS, BERMS, WALL, FENCES, UTILITIES OR ROADWAYS.
- 2. CONTRACTOR SHALL ACQUIRE ALL APPLICABLE FEDERAL, STATE, LOCAL, JURISDICTIONAL OR UTILITY COMPANY PERMITS REQUIRED PRIOR TO REMOVAL, RELOCATION, AND/OR INSTALLATION OF LANDSCAPE MATERIALS INDICATED WITHIN PLAN DOCUMENTS. THE CONTRACTOR SHALL HAVE PERMITS "IN HAND" PRIOR TO STARTING WORK. LANDSCAPE ARCHITECT SHALL BEAR NO RESPONSIBILITY FOR WORK PERFORMED WITHOUT PERMITTED DRAWINGS. THE CONTRACTOR SHALL BE RESPONSIBLE FOR ALL CHANGES TO THE WORK, AT NO ADDITIONAL COST TO THE OWNER, AS A RESULT OF UNAUTHORIZED WORK PRIOR TO RECEIPT OF PERMIT.
- TREES SHOWN ON THIS PLAN ARE FOR GRAPHIC REPRESENTATION ONLY. TREE SPACING IS BASED ON DESIGN REQUIREMENTS AND THE TREES SHOWN ON THESE PLANS ATTEMPT TO ACCOMPLISH THAT SPACING WHILE MAINTAINING THE REQUIRED SETBACKS FROM UTILITIES. IN THE EVENT OF A CONFLICT, AFFECTED PLANT MATERIAL SHALL BE FIELD ADJUSTED WITH THE APPROVAL OF THE LANDSCAPE ARCHITECT TO AVOID CONFLICTS WITH THE WITH EXISTING AND PROPOSED UTILITIES, LIGHT POLES, DRAINAGE STRUCTURES OR LINES, OR OTHER AFFECTED SITE FEATURES.
- 4. ANY PLANTING WITHIN THE SIGHT TRIANGLES SHALL PROVIDE UNOBSTRUCTED VIEWS AT A LEVEL BETWEEN 30" AND 8' ABOVE THE PAVEMENT.
- IN CASE OF DISCREPANCIES PLANS TAKE PRECEDENCE OVER PLANT LIST.
- LANDSCAPE CONTRACTOR RESPONSIBLE FOR VERIFICATION OF ALL QUANTITIES PRIOR TO BIDDING.
- 7. REMOVAL OF EXISTING VEGETATION IS RESPONSIBILITY OF LANDSCAPE CONTRACTOR.
 - ALL PLANT MATERIAL TO BE FLORIDA GRADE #1 AT TIME OF INSTALLATION UNLESS OTHERWISE NOTED.

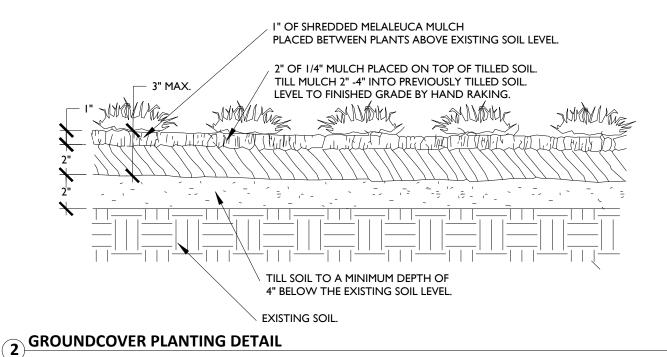

SP	'ACING "D"	ROW "A"
	6" O.C.	5.2"
	8" O.C.	6.93"
	10" O.C.	8.66"
	12" O.C.	10.4"
	18" O.C.	15.6"
	24" O.C.	20.8"
	30" O.C.	26.0"
	36" O.C.	31.2"
	48" O.C.	41.6"

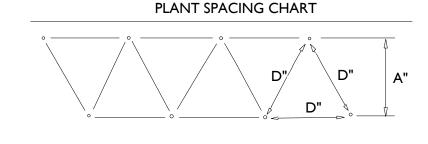

PLANT SPACING DETAIL

NOT TO SCALE

NOT TO SCALE

LP-500

		REVIS	SIONS			
DATE	BY	DESCRIPTION	DATE	BY	DESCRIPTION	ANGELA BIAGI
						L.A. NO. 6666787 WGI, INC. 2035 VISTA PARKWAY WEST PALM BEACH, FL 33411




SHEET TITLE:

LANDSCAPE DETAILS

PROJECT NAME:

WALNUT STREET

SHEET NO.

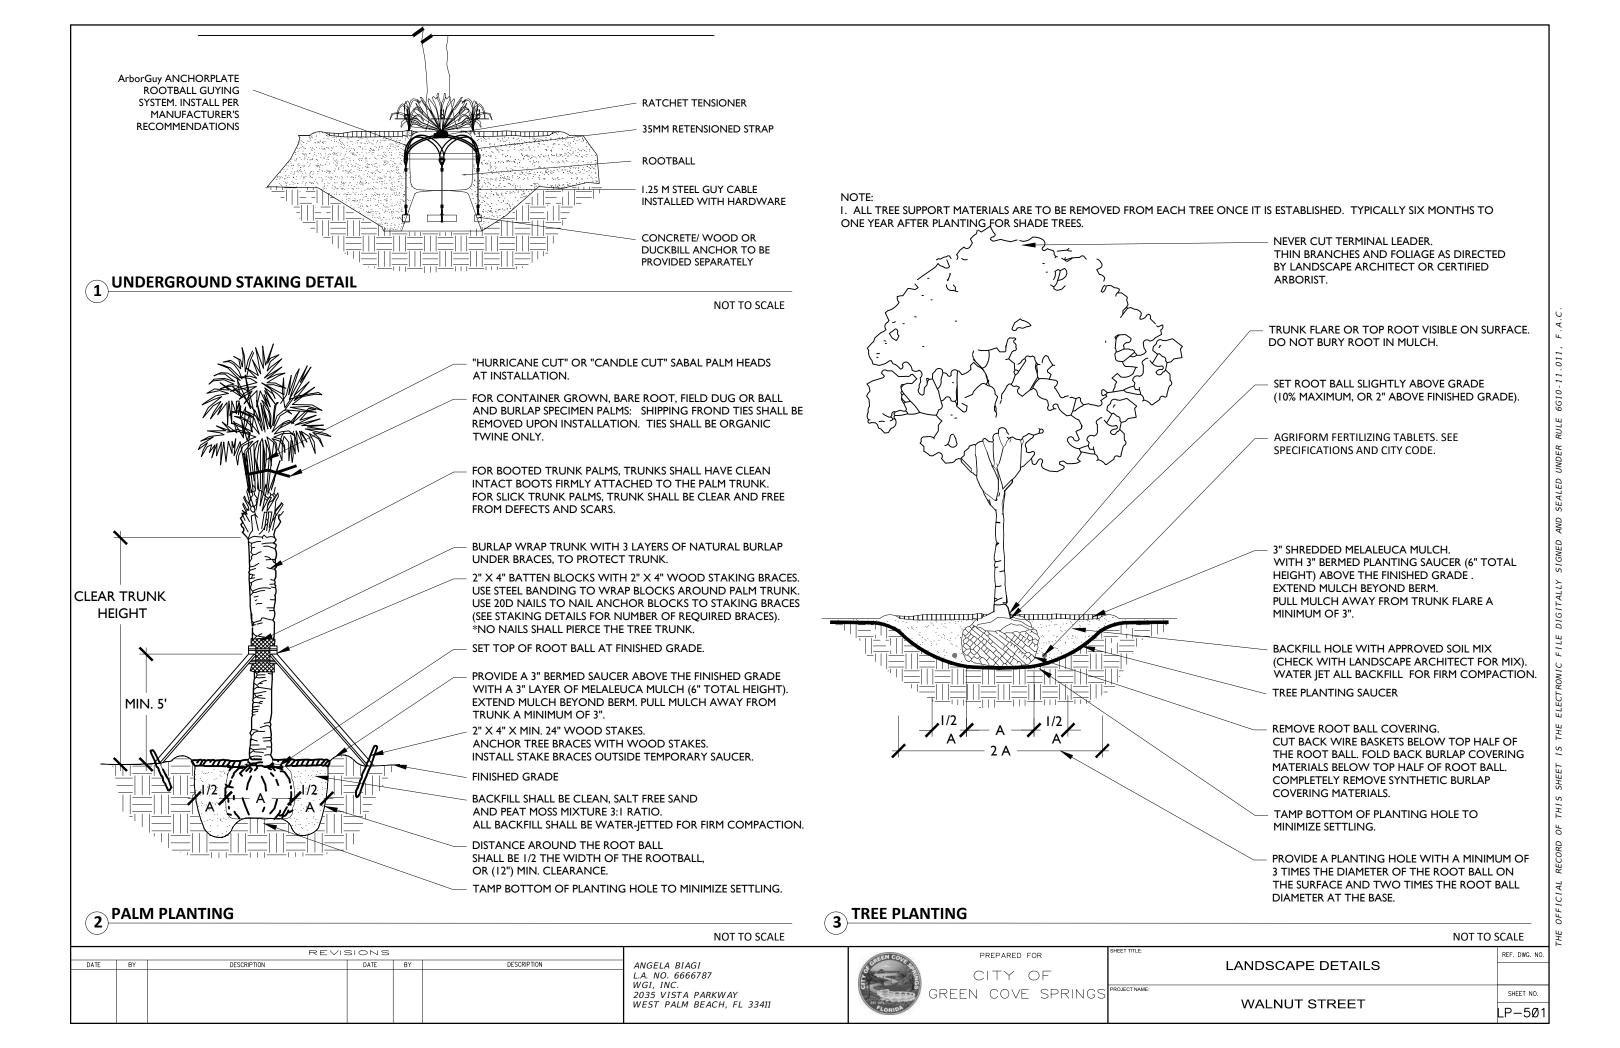

D OF THIS SHEET IS THE ELECTRONIC FILE DIGITALLY SIGNED AND SEALED UNDER RULE 6G10-11.011, F.A

Landscape Planting - Part I. General

- I. Description of Work
- A.Provide all exterior planting as shown on the drawings or inferable therefrom and/or as specified in accordance with the requirements of the Contract Documents. Landscape plans provided indicate the proposed location of living plant material only. Structural elements and hardscape features indicated on the landscape plans are for information purposes only. Landscape plans are not to be utilized for staking and layout or location of any structural site features including but not limited to, buildings, signage, pathways, easements, utilities or roadways.
- B. These specifications include standards necessary for and incidental to the execution and completion of planting as indicated on the prepared drawings and specified herein.
- C.All applicable federal, state and local permits shall be attained prior to the removal, relocation, or installation of plant materials indicated within the plan documents.
- D. Protection of existing features. During construction, protect all existing trees, shrubs, and other specified vegetation, site features and improvements, structures, and utilities specified herein and/or on submitted drawings. Removal or destruction of existing plantings is prohibited unless specifically authorized by the owner, and with permit as required by associated federal, state and local government agencies.
- II. Applicable Standards
- A. American National Standards for Tree Care Operations, ANSI A300. American National Standards Institute, 11 West 42nd Street, New York, N.Y. 10036.
- B. American Standard for Nursery Stock, ANSI Z60.1. American Nursery and Landscape Association, 1250 Eye Street. NW, Suite 500, Washington, D.C. 20005.
- C.Hortus Third, The Staff of the L.H. Bailey Hortorium. 1976. MacMillan Publishing Co., New York.
- D.Florida Department of Agriculture "Grades and Standards for Nursery Plants", most recent addition.
- E. National Arborist Association- Pruning Standards for Shade Trees
- F. All standards shall include the latest additions and amendments as of the date of advertisement for bids
- III. Qualifications
- A.Landscape planting and related work shall be performed by a firm with a minimum of five years experience specializing in this type of work. All contractors and their sub-contractors who will be performing any landscape work included in this section of the specification shall be approved by the landscape architect.
- B. Landscape Contractor shall be licensed and shall carry any necessary insurance and shall protect the Landscape Architect and Owner against all liabilities, claims or demands for injuries or damage to any person or property growing out of the performance of the work under this contract. All workers shall be covered by Workman's Compensation Insurance.
- IV. Requirements of Regulatory Agencies
- A. Certificates of inspection shall accompany the invoice for each shipment of plants as may be required by law for transportation. File certificates with the landscape architect prior to acceptance of the material. Inspection by federal or state authorities at place of growth does not preclude rejection of the plants at the site.
- V Submittal
- A.Manufacturer's Data: Submit copies of the manufacturer's and/or source data for all materials specified, including soils, soil amendments and fertilizer materials. Comply
- with regulations applicable to landscape materials.
- B. Samples: Submit samples of all topsoil, soil mixes, mulches, and organic materials. Samples shall weigh 1 kg (2 lb) and be packaged in plastic bags. Samples shall be typical of the lot of material to be delivered to the site and provide an accurate indication of color, texture, and organic makeup of the material.
- C.Nursery Sources: Submit a list of all nurseries that will supply plants, along with a list of the plants they will provide and the location of the nursery. For each species, submit a typical photo from the supplier's yard, taken with a ruler or yardstick showing the height and breadth of the plant.
- D. Soil Test: Submit soil test analysis report for each sample of topsoil and planting mix from a soil testing laboratory approved by the landscape architect.
 - 1. Provide a particle size analysis, including the following gradient of mineral content:

USDA Designation Size in mm +2 mm Gravel Very Course Sand 1-2 mm Coarse Sand 0.5-1 mm Medium Sand 0.25-0.5 mm Fine Sand 0.1-0.25 mm 0.05-0.1 mm Very fine sand Silt 0.002-0.05 mm Clay smaller than 0.002

- 2. Provide a chemical analysis, including the following:
- a. pH and buffer pH
- b. Percentage of organic content by oven-dried weight.
- c. Nutrient levels by parts per million, including phosphorus, potassium magnesium, manganese, iron, zinc, and calcium. Nutrient test shall include the testing laboratory recommendations for supplemental additions to the soil based on the requirements of horticultural plants.
- d. Soluble salt by electrical conductivity of a 1:2, soil: water, sample measured in millimho per cm.
- e. Cation exchange capacity (CEC).
- E. Material Testing: Submit the manufacturers particle size analysis, and the pH analysis and provide a description and source location for the content material of all organic materials.
- F. Maintenance Instructions: Prior to the end of maintenance period, Landscape Contractor shall furnish three copies of written maintenance instructions to the Landscape Architect for transmittal to the Owner for maintenance and care of installed plants through their full growing season.
- VI. Utility Verification
- A. The contractor shall contact the local utility companies for verification of the location of all underground utility lines in the area of the work. The contractor shall be responsible for all damage resulting from neglect or failure to comply with this requirement.

Part 2. Materials

- A.Plants shall be true to species and variety specified and nursery-grown in accordance with good horticultural practices under climatic conditions similar to those in the locality of the project for at least two years. They shall have been freshly dug.
- 1. All plant names and descriptions shall be as defined in Hortus Third.
- 2. All plants shall be grown and harvested in accordance with the American Standard for Nursery Stock and Florida Department of Agriculture Grades and Standards for Nursery Plants.
- 3. Unless approved by the landscape architect, plants shall have been grown at a latitude not more than 325 km (200 miles) north or south of the latitude of the project unless the provenance of the plant can be documented to be compatible with the latitude and cold hardiness zone of the planting location.
- B. Unless specifically noted, all plants shall be exceptionally heavy, symmetrical, and so trained or favored in development and appearance as to be unquestionably and outstandingly superior in form, compactness, and symmetry. They shall be sound, healthy, vigorous, well branched, and densely foliated when in leaf; free of disease and insects, eggs, or larvae; and shall have healthy, well-developed root systems. They shall be free from physical damage or other conditions that would prevent vigorous growth.
 - 1. Trees with multiple leaders, unless specified, will be rejected. Trees with a damaged or crooked leader, bark abrasions, sunscald, disfiguring knots, insect damage, or cuts of limbs over 20 mm (3/4 in.) in diameter that are not completely closed will be rejected.
- C. Plants shall conform to the measurements specified, except that plants larger than those specified may be used if approved by the landscape architect. Use of larger plants shall not increase the contract price. If larger plants are approved, the root ball shall be increased in proportion to the size of the plant.
 - 1. Caliper measurements shall be taken on the trunk 150 mm (6 in.) above the natural ground line for trees up to and including 100 mm (4 in.) in caliper, and 300 mm (12 in.) above the natural ground line for trees over 100 mm (4 in.) in caliper. Height and spread dimensions specified refer to the main body of the plant and not from branch tip to branch tip. Plants shall be measured when branches are in their normal position. If a range of sizes is given, no plant shall be less than the minimum size, and no less than 50 percent of the plants shall be as large as the maximum size specified. Measurements specified are minimum sizes acceptable after pruning, where pruning is required. Plants that meet measurements but do not possess a standard relationship between height and spread, according to the Florida Department of Agriculture Grades and Standards for Nursery Plants, shall be rejected.
- D. Substitutions of plant materials will not be permitted unless authorized in writing by the landscape architect. If proof is submitted in writing that a plant specified is not obtainable, consideration will be given to the nearest available size or similar variety, with a corresponding adjustment of the contract price.
- E. The plant schedule provided at the end of this section, or on the drawing, is for the contractor's information only, and no guarantee is expressed or implied that quantities therein are correct or that the list is complete. The contractor shall ensure that all plant materials shown on the drawings are included in his or her bid.
- F. All plants shall be labeled by plant name. Labels shall be attached securely to all plants, bundles, and containers of plant materials when delivered. Plant labels shall be durable and legible, with information given in weather-resistant ink or embossed process lettering.
- G. Selection and Tagging
 - 1. Plants shall be subject to inspection for conformity to specification requirements and approval by the landscape architect at their place of growth and upon delivery. Such approval shall not impair the right of inspection and rejection during progress of the work.
 - 2. A written request for the inspection of plant material at their place of growth shall be submitted to the landscape architect at least ten calendar days prior to digging. This request shall state the place of growth and the quantity of plants to be inspected. The landscape architect may refuse inspection at this time if, in his or her judgment, sufficient quantities of plants are not available for inspection or landscape architect deems inspection is not required.
- H. Anti-Desiccants

I Plants

- 1. Anti-desiccants, if specified, are to be applied to plants in full leaf immediately before digging or as required by the landscape architect. Anti-desiccants are to be sprayed so that all leaves and branches are covered with a continuous protective film.
- I. Balled and Burlapped (B&B) Plant Materials
 - 1. Trees designated B&B shall be properly dug with firm, natural balls of soil retaining as many fibrous roots as possible, in sizes and shapes as specified in the Florida Department of Agriculture Grades and Standards for Nursery Plants. Balls shall be firmly wrapped with synthetic, natural, or treated burlap, and/or wire. All synthetic fabric should be removed from the rootball prior to planting. True biodegradable burlap can be left around the root ball. The root collar shall be apparent at surface of ball. Trees with loose, broken, processed, or manufactured root balls will not be accepted, except with special written approval before planting.
- J. Container Plants
 - 1. Plants grown in containers shall be of appropriate size for the container as specified in the most recent edition of the Florida Department of Agriculture Grades and Standards for Nursery Plants and be free of circling roots on the exterior and interior of the root ball.
 - 2. Container plants shall have been grown in the container long enough to have established roots throughout the growing medium.
- K. Bareroot and Collected Plants
 - 1. Plants designated as bareroot or collected plants shall conform to the American Standard for Nursery Stock.
 - 2. Bareroot material shall not be dug or installed after bud break or before dormancy.
 - 3. Collected plant material that has not been taken from active nursery operations shall be dug with a root ball spread at least 1/3 greater than nursery grown plants. When specified or approved, shall be in good health, free from disease, insect or weed infestation and shall not be planted before inspection and acceptance at the site. Testing may be required at the discretion of the Landscape Architect and/or the Owner and shall be provided at no additional cost.
- L. Specimen Material: Plant material specified as specimens are to be approved by the Landscape Architect before being brought to the site. Unless otherwise noted on the drawings, these plants shall be Florida Fancy.

DEEN COVE	PREPARED FOR	HEET TITLE:			
	CITY OF	LANDSCAPE NOTES			
	GREEN COVE SPRINGS	PROJECT NAME:	SHEET NO.		
FLORIDA		WALNUT STREET	LP-5Ø2		

ATE	BY	DESCRIPTION	DATE	BY	DESCRIPTION	ANGELA BIAGI
						L.A. NO. 6666787 WGI, INC. 2035 VISTA PARKWAY WEST PALM BEACH, FL 33411

M.Palms

- 1. Coconut Palms shall be grown from a certified seed.
- 2. All palm species except Sabal palmetto shall have roots adequately wrapped before transporting.
- 3. Sabal palms shall have a hurricane cut. Sabal palms shall be installed on site at the earliest opportunity in the construction process.
- 4. For booted trunk palms, trunks shall have clean intact boots firmly attached to the palm trunk. For slick trunk palms, trunk shall be clear and free from defect and scars
- 5. The Contractor shall treat all palms as required to prevent infestation by the palmetto weevil.

N.Sod

- Sod shall be graded #1 or better. Sod shall be loam or muck grown with a firm, full texture and good root development. Sod shall be thick, healthy and free from defects and debris including but not limited to dead thatch, insects, fungus, diseases and contamination by weeds, other grass varieties or objectionable plant material.
- 2. Sod shall be sufficiently thick to insure a dense stand of live grass. Sod shall be live, fresh, and uninjured at the time of planting. Plant sod within 48 hours after harvesting.
- 3. Sod area shall be all areas not otherwise identified and shall include the area beyond the property line to the edge of pavement and/or edge of water.
- O. Immediately after harvesting plants, protect from drying and damage until shipped and delivered to the planting site. Rootballs shall be checked regularly and
 - watered sufficiently to maintain root viability.
- P. Transportation and Storage of Plant Material
 - 1. Branches shall be tied with rope or twine only, and in such a manner that no damage will occur to the bark or branches.
 - 2. During transportation of plant material, the contractor shall exercise care to prevent injury and drying out of the trees. Should the roots be dried out, large branches broken, balls of earth broken or loosened, or areas of bark torn, the landscape architect may reject the injured tree(s) and order them replaced at no additional cost to the owner. All loads of plants shall be covered at all times with tarpaulin or canvas. Loads that are not protected will be rejected.
 - 3. All bareroot stock sent from the storage facility shall be adequately covered with wet soil, sawdust, woodchips, moss, peat, straw, hay, or other acceptable moisture-holding medium, and shall be covered with a tarpaulin or canvas. Loads that are not protected in the above manner may be rejected.
 - 4. Plants must be protected at all times from sun or drying winds. Those that cannot be planted immediately on delivery shall be kept in the shade, well protected with soil, wet mulch, or other acceptable material, and kept well watered. Plants shall not remain unplanted any longer than three days after delivery. Plants shall not be bound with wire or rope at any time so as to damage the bark or break branches. Plants shall be lifted and handled with suitable support of the soil ball to avoid damaging it.
- Q. Mechanized Tree Spade Requirements

Trees may be moved and planted with an approved mechanical tree spade. The tree spade shall move trees limited to the maximum size allowed for a similar B&B root-ball diameter according to the American Standard for Nursery Stock or the manufacturer's maximum size recommendation for the tree spade being used, whichever is smaller. The machine shall be approved by the landscape architect prior to use. Trees shall be planted at the designated locations in the manner shown in the plans and in accordance with applicable sections of the specifications.

II. Materials for Planting

DATE BY

- A.Mulch: Except as otherwise specified, mulch shall be shredded Melaleuca. It shall not contain more than 10% bark (by volume). Shreds and chips shall not be larger the ¾" diameter and 1½" in length. Mulch shall be free of weeds, seeds, and any other organic or inorganic material other than Texas hardwood and bark. It shall not contain stones or other foreign material that will prevent its eventual decay. This shall be applied to all planted areas where indicated so that, after installation, the mulch thickness will not be less than 3". Submit sample for approval. Cypress Mulch: Shall not be used.
- B. Gravel Mulch: Use only where specifically indicated on the plans of the size and type shown. Unless otherwise specified it shall be water-worn, hard durable gravel,
 - washed free of loam, sand, clay and other foreign substances. It shall be a minimum of 3" deep and shall be contained with edging or other approved
 - gravel stop as indicated on the plans. It shall be a maximum of 1 1/2", a minimum of 3/4" and of a readily-available natural gravel color range. Provide geotextile filter fabric below aggregate rock.
 - Submit sample for approval.
- C.Root Barrier: Where specified, root barriers shall be installed on all tree and palm material in accordance with the root barrier detail provided within the plan drawings.
 - Root barriers shall comply with all requirements of the municipality within which they are located as well as with any utility holder requirements of any affected utilities. In the event that conflicting requirements exist between the root barrier detail provided within the plan documents and the municipality/utility holder requirements, the more stringent of the requirements shall be applicable.

DESCRIPTION

ANGELA BIAGI

L.A. NO. 6666787

2035 VISTA PARKWAY

WEST PALM BEACH, FL 33411

D. Planter Edging: Use only where specifically indicated on plans. Edging shall be the color black.

REVISIONS

DATE

DESCRIPTION

E. Anti-desiccant: shall be an emulsion specifically manufactured for agricultural use, which provides a protective film over plant surfaces.

Anti-desiccants shall be delivered in containers of the manufacturer and shall be mixed according to the manufacturer's directions. Submit manufacturer literature for approval.

III. Materials for Soil Amendment

- A.Pine Bark: Horticultural-grade milled pine bark, with 80 percent of the material by volume sized between 0.1 and 15.0 mm.
 - 1. Pine bark shall be aged sufficiently to break down all woody material. Pine bark shall be screened.
 - 2. pH shall range between 4 and 7.0.
 - 3. Submit manufacturer literature for approval.
- B. Organic Matter: Leaf matter and yard waste composted sufficiently to break down all woody fibers, seeds, and leaf structures, and free of toxic and nonorganic matter.
 - Organic matter shall be commercially prepared compost. Submit 0.5 kg (1 lb) sample and suppliers literature for approval.
- C. Course Sand: Course concrete sand, ASTM C-33 Fine Aggregate, with a Fines Modulus Index of 2.75 or greater.
 - 1. Sands shall be clean, sharp, natural sands free of limestone, shale and slate particles.
 - 2. Provide the following particle size distribution:

Sieve	Percentage Passin
3/8 in (9.5 mm)	100
No. 4 (4.75 mm)	95-100
No. 8 (2.36 mm)	80-100
No. 16 (1.18 mm)	50-85
No. 30 (0.60 mm)	25-60
No. 50 (0.30 mm)	10-30
No. 100 (0.15 mm)	2-10

- D. Lime: shall be ground, palletized, or pulverized lime manufactured to meet agricultural standards and contain a maximum of 60 percent oxide (i.e. calcium oxide plus
 - magnesium oxide). Submit manufacturer literature for approval.
- E. Sulfur: shall be flowers of sulfur, pelletized or granular sulfur, or iron sulfate. Submit manufacturer literature for approval.
- F. Fertilizer: Agricultural fertilizer of a formula indicated by the soil test. Fertilizers shall be organic, slow-release compositions whenever applicable. Submit manufacturer literature for approval.
- IV. Planting Mix
- A.Planting Mix
 - 1. Planting Mix for Trees, Shrubs, Groundcovers and vines: Check with landscape architect for appropriate mixture.
 - 2. Planting Mix for Palms: Mixture of course sand and peat mixed to the following proportion:

Component Percent by Volume
Coarse Sand 50%
Peat 50%

- B. Planting mix shall be thoroughly mixed, screened, and shredded.
- C. Prior to beginning the mixing process, submit a 1-kg (2-lb) sample of the proposed mix with soil test results that indicate the mix ratio and the results achieved.
- D. During the mixing process but prior to installing the mix, submit a 1-kg (2-lb) sample for each 200 cubic meters (250 cubic yards) of planting mix, taken randomly from the finished soil mix, with soil test results for approval. In the event that the test results do not meet the required particle size distribution, remix and resubmit a revised planting mix.
- E. Make all amendments of lime/sulfur and fertilizer indicated by the soil test results at the time of mixing.
- F. All mixing shall take place in the contractors yard, using commercial mixing equipment sufficient to thoroughly mix all components uniformly
- G. Protect the planting mix from erosion prior to installation.

prepared for

CITY OF

GREEN COVE SPRINGS PRINGS


LANDSCAPE NOTES


WALNUT STREET


SHEET NO.


LP-503


ON SHEET I

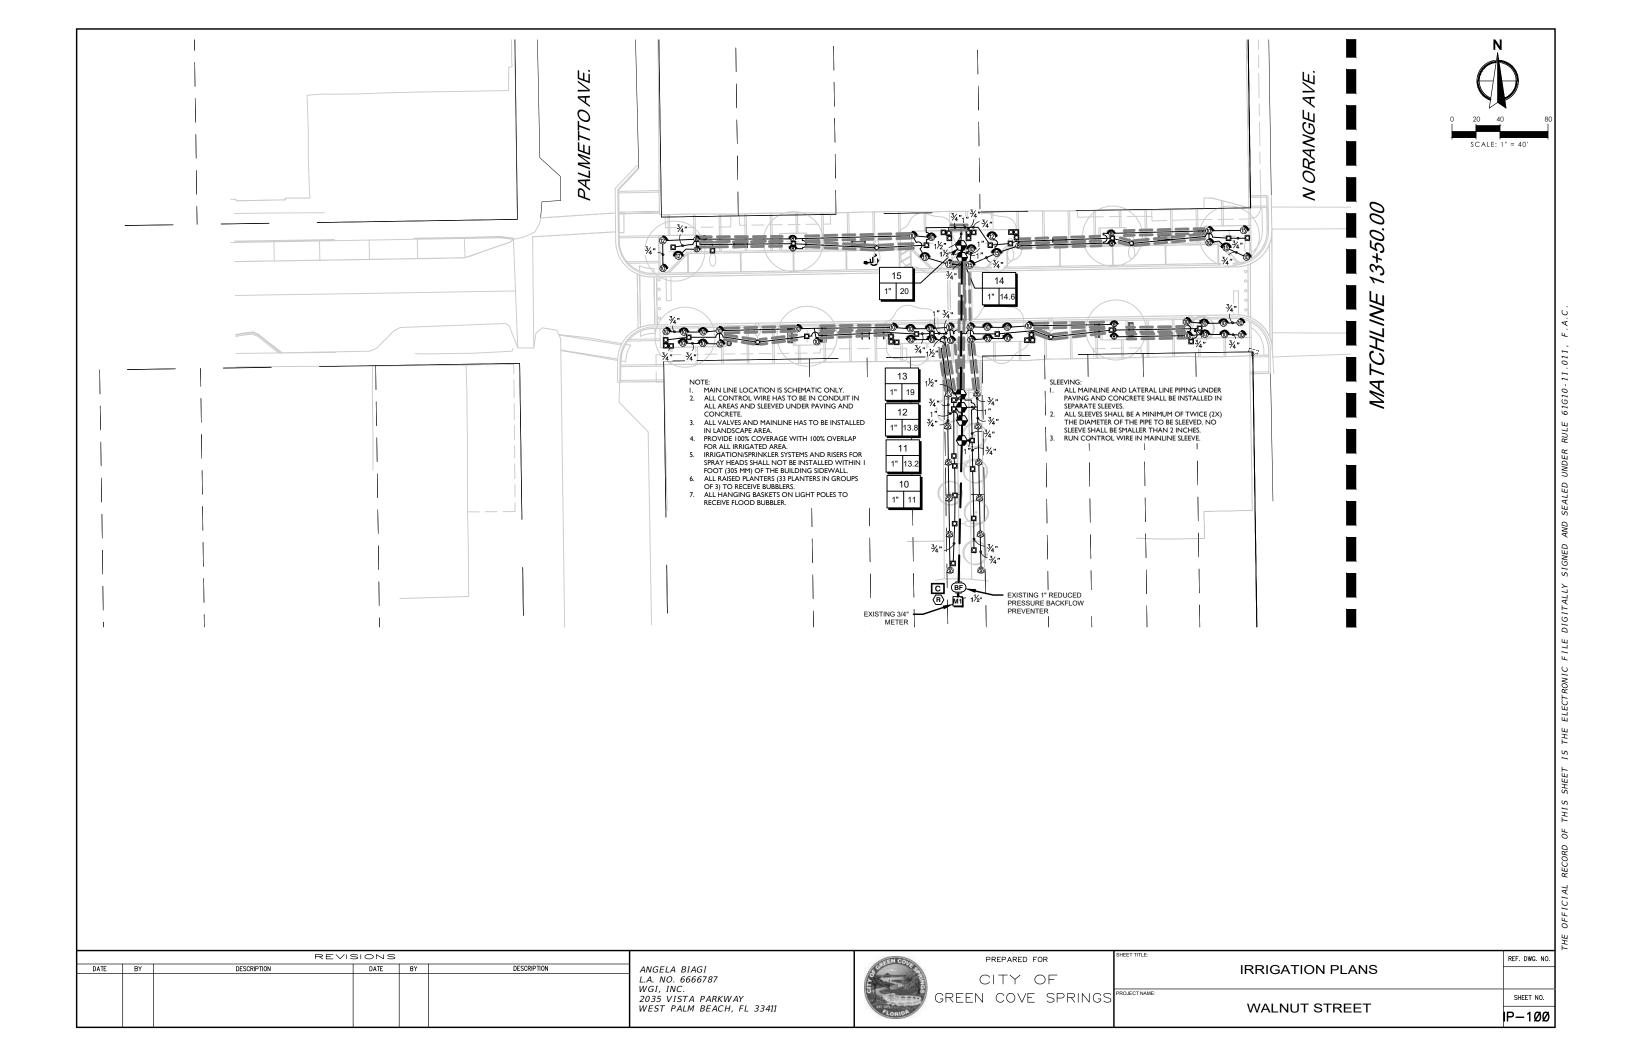

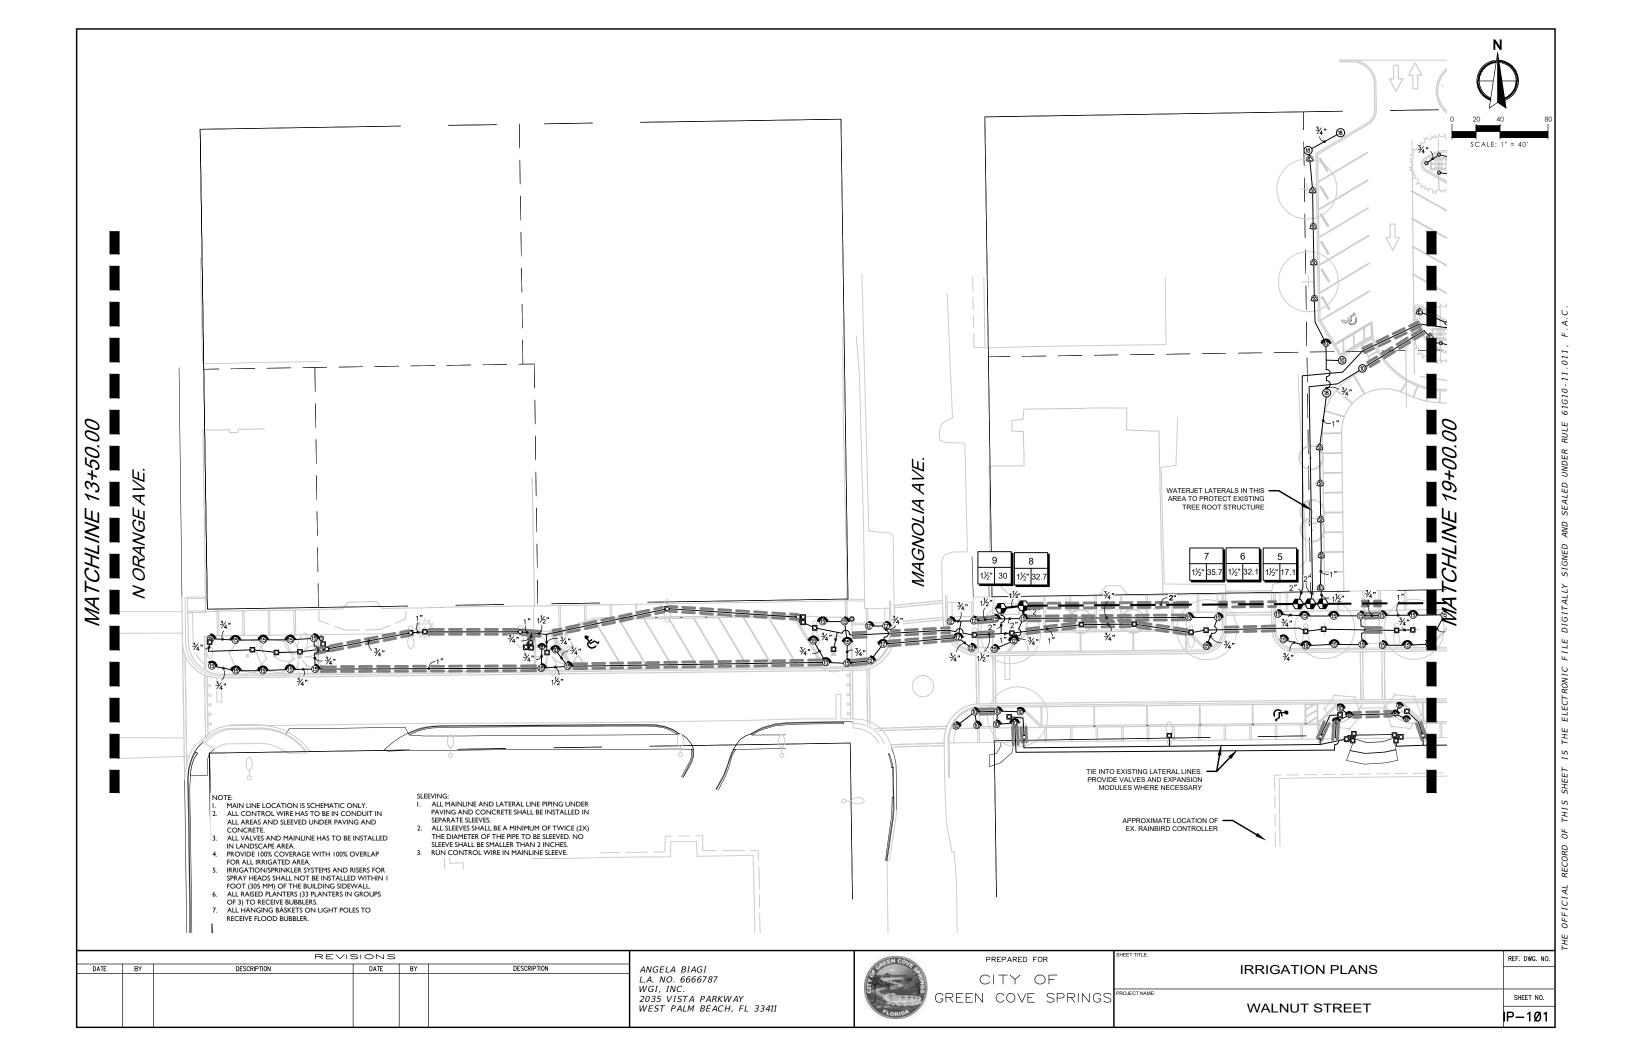

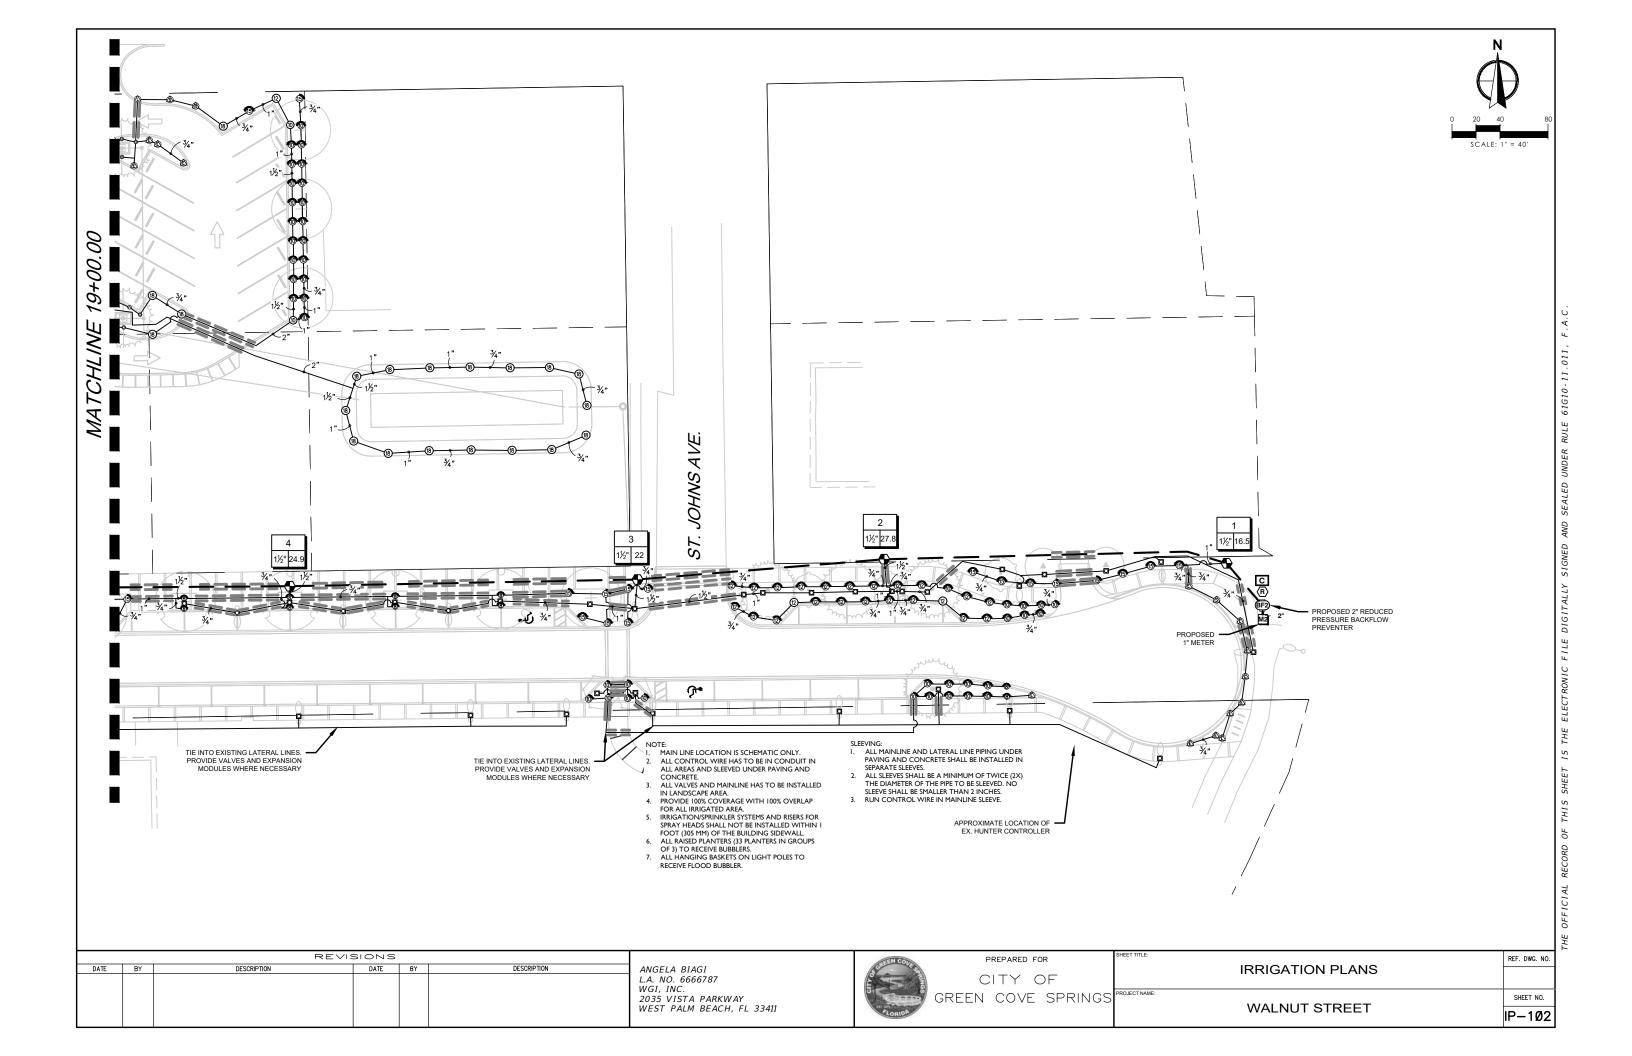

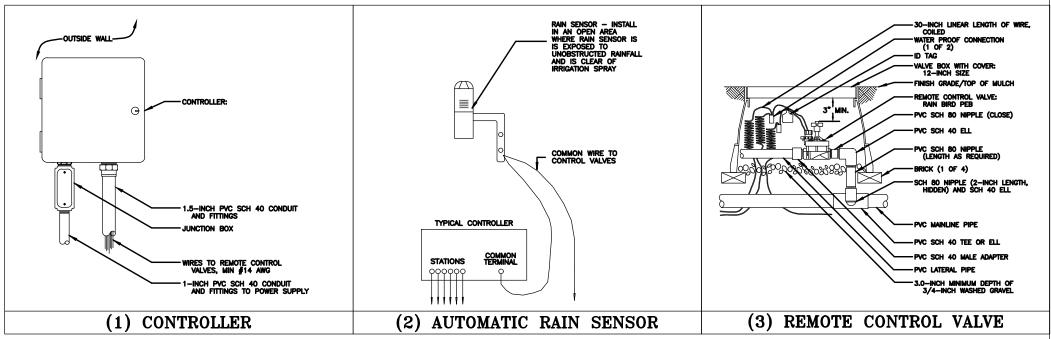

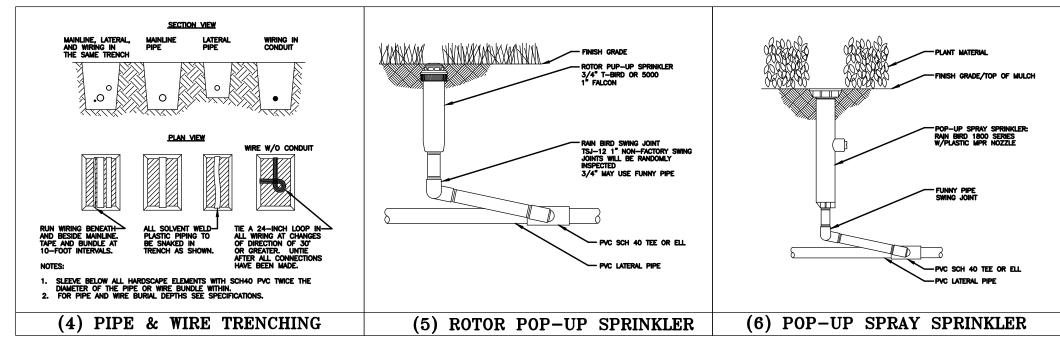


CONTRACTOR MUST COMPLY WITH FLORIDA BUILDING CODE AMENDED APPENDIX F:

NO PRODUCT SUBSTITUTIONS OR CHANGES WILL BE ALLOWED WITHOUT THE EXPESSED WRITTEN CONSENT OF THE OWNER AND THE IRRIGATION CONSULTANT.

GENERAL NOTES

- All mainline, lateral line and control wire conduit under paying shall be installed in separate sleeves. Sleeves shall be a minimum of twice (2X) the diameter of the pipe to be sleeved.
- 2. Pipe sizes shall conform to those shown on the drawings. No substitutions of smaller pipe sizes shall be permitted, but substitutions of larger sizes may be approved. All damaged and rejected pipe shall be removed from the site at the time of said rejection.
- Install all backflow prevention devices and all piping between the point of connection and the backflow preventer as per local codes.
- Final location of the backflow preventer and automatic controller shall be approved by the owner's authorized representative.
- 120 VAC electrical power source at controller location shall be provided by others. The electrical contractor shall make the final connection from the electrical source to the controller.
- 6. All sprinkler heads shall be set perpendicular to finish grade unless otherwise specified.
- The irrigation contractor shall flush and adjust all sprinkler heads and valves for optimum spray with minimal overspray onto walks, streets, walls, etc.
- This design is diagramatic. All piping, valves, etc., shown within paved areas is for design clarification only and shall be installed in planting areas wherever possible. The contractor shall locate all valves in shrub areas where possible.
- 9. It is the responsibility of the irrigation contractor to familiarize himself with all grade differences, location of walls, retaining walls, structures and utilities. The irrigation contractor shall repair or replace all items damaged by his work. He shall coordinate his work with other contractors for the location and installation of pipe sleeves through walls, under roadways and paving, etc.
- 10. Do not willingly install the sprinkler system as shown on the drawings when it is obvious in the field that unknown obstructions, grade differences or differences in the area dimensions exist that might not have been considered in the engineering, such obstructions or differences should be brought to the attention of the owner's authorized representative. In the event this notification is not performed, the irrigation contractor shall assume full responsibility for any revisions necessary.
- 11. All sprinkler equipment not otherwise detailed or specified shall be installed as per manufacturer's recommendations and specifications.
- 12. The irrigation contractor shall install check valves on all heads in areas where finish grade exceeds 4:1, where post valve shut-off draining, of the irrigation head occurs or as directed by the owner's authorized representative.
- 13. The contractor shall provide 1800 PCS (pressure compensating screens) as necessary to reduce or eliminate overspray onto streets, walks or other areas as directed by the owner's authorized representative.
- 14. All remote control valves, gate valves, quick couplers, control wire and computer cable pull points shall be installed in approved valves boxes with covers. All shall be marked indicating controller and station numbers for control valve boxes and/or titled in the equipment legend with 1" white heat braided letters.
- 15. All control wires shall be installed in PVC conduit, min #14 AWG.
- 16. Installer is required to conduct final testing and adjustment to achieve design specification prior to completion of the system and acceptance by the owner or owner's representative.
- 17. Contractor to provide owner with post construction documentation, including as—built drawings, recommended maintenance schedules and activities, operational schedule, design precipitation rates, system adjusting methods for decreasing water once landscape is established, water source and shutoff method and all operational guides for controller.
- 18. A map of the system shall be kept in a readily available location with details for operation.
- 19. If the water supply for irrigation system is a well water, a constant pressure flow control device of pressure tank is required to minimize pump "cycling".
- Check valves must be installed at irrigation heads as needed to prevent low head drainage and pudding.
 Nozzle precipitation rates for all heads within each valve circuit must be matched to within 20% of one another.

												┚⊦
	REVISIONS						THEN COTT	PREPARED FOR	SHEET TITLE:		REF. DWG. NO.	,.]
F	DATE BY	DESCRIPTION	DATE	BY	DESCRIPTION	ANGELA BIAGI L.A. NO. 6666787	E COLUMN TO THE PARTY OF THE PA	CITY OF		IRRIGATION NOTES AND DETAILS		1
						WGI, INC. 2035 VISTA PARKWAY WEST PALM BEACH, FL 33411	FLORIDA	GREEN COVE SPRINGS	PROJECT NAME:	WALNUT STREET	SHEET NO. IP-5ØØ] 8

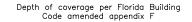

FOR NONTRAFFIC AND NONCULTIVATED AREAS:

Pipe Diameter

6" and larger


Minimum


30" - 36"

½" through 1 ¼" 6" - 12" 1 ½" through 2" 12" - 18" 18" - 24" 2 ½" through 3" 6" and larger 24" - 36"

FOR VEHICLE TRAFFIC AREAS:

Pipe Diameter depth of Cover 18" - 24" ½" through 2½" 3" through 5" 24" - 30"

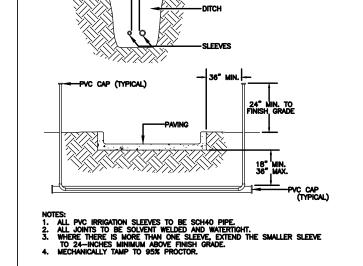

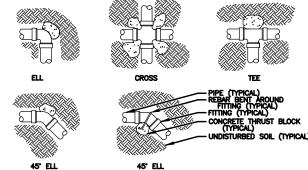


- 2. SEE SPECIFICATIONS FOR CONCRETE TO BE USED

(7) DEPTH OF COVERAGE

(8) SLEEVING

(9) THRUST

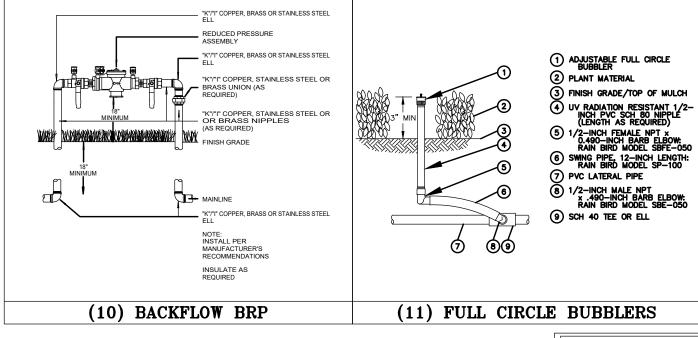

	2Q 2H 2F 4Q 4H 4F	Side and Bottom Inlet. 1/2" NPT Female Threaded Inlet.	
TEE	€	Rain Bird 1812 15 Strip Series Shrub Spray 12.0" Pop-Up Sprinkler with Co-Molded Wiper Seal. Side and Bottom Inlet. 1/2" NPT Female Threaded Inlet.	42
PIPE (TYPICAL) REBAR BENT AROUND FITTING (TYPICAL)	8 8 8 8 Q T H F	Rain Bird 1812 8 Series MPR Shrub Spray 12.0" Pop-Up Sprinkler with Co-Molded Wiper Seal. Side and Bottom Inlet. 1/2" NPT Female Threaded Inlet.	25
FITTING (TYPICAL) CONCRETE THRUST BLOCK (TYPICAL)	◎ ◎ ◎ ◎ ◎ ○ ○ ○ ○ ○ ○ ○ ○ ○ ○ ○ ○ ○ ○ ○	Rain Bird 1812 10 Series MPR Shrub Spray 12.0" Pop-Up Sprinkler with Co-Molded Wiper Seal. Side and Bottom Inlet. 1/2" NPT Female Threaded Inlet.	91
UNDISTURBED SOIL (TYPICAL)	@ @ @ @ @ Q T H TQ F	Rain Bird 1812 12 Series MPR Shrub Spray 12.0" Pop-Up Sprinkler with Co-Molded Wiper Seal. Side and Bottom Inlet. 1/2" NPT Female Threaded Inlet.	33
	(B) (B) (B) (B) (C) (C) (C) (C) (C) (C) (C) (C) (C) (C	Rain Bird 1812 15 Series MPR Shrub Spray 12.0" Pop-Up Sprinkler with Co-Molded Wiper Seal. Side and Bottom Inlet. 1/2" NPT Female Threaded Inlet.	61
s in diameter and	⊕ © ® 4∨ 6∨ 18∨	Rain Bird 1812 ADJ Shrub Spray 12.0" Pop-Up Sprinkler with Co-Molded Wiper Seal. Side and Bottom Inlet. 1/2" NPT Female Threaded Inlet.	23
CONCRETE THRUST	8 08HE-VAN 12 12HE-VAN 10 10HE-VAN 15 15HE-VAN	Rain Bird 1812 HE-VAN Series Shrub Spray 12.0" Pop-Up Sprinkler with Co-Molded Wiper Seal. Side and Bottom Inlet. 1/2" NPT Female Threaded Inlet.	7
FOR THRUST BLOCK.	1401 1402 1404 1408	Rain Bird 1812-1400 Flood 1401 Flood Bubbler 12.0" popup.	125
	SYMBOL	MANUFACTURER/MODEL/DESCRIPTION	QTY
BLOCKS	•	Rain Bird PEB 1", 1-1/2", 2" Plastic Industrial Valves. Low Flow Operating Capability, Globe Configuration.	15
	₿	Watts U009 1" Existing Reduced Pressure Backflow Preventer	1
	€P	Watts U009 2" Reduced Pressure Backflow Preventer	1
	C	Rain Bird ESP-TM2 12 Station Outdoor Smart Modular Control System for Residential and Light Commercial Use.	2
	R	Rain Bird RSD-CEx Rain Sensing Device, conduit mount. With threaded adapter, extension wire.	2
	M2	Water Meter 1"	1
	М1	Water Meter 3/4" Existing	1
		Irrigation Lateral Line: PVC Class 160 SDR 26	6,844 l.f.
		Irrigation Mainline: PVC Schedule 40	821.0 l.f.
	=======	Pipe Sleeve: PVC Schedule 40	2,211 l.f.

IRRIGATION SCHEDULE

MANUFACTURER/MODEL/DESCRIPTION

Rain Bird 1812 SQ Series Shrub Spray 12.0" Pop-Up Sprinkler with Co-Molded Wiper Seal. Side and Bottom Inlet. 1/2" NPT Female Threaded Inlet.

WATERING SCHEDULE

NUMBER	MODEL	TYPE	PRECIP	IN./WEEK	MIN./WEEK	GAL./WEEK	GAL./DAY
1	Rain Bird PEB	Shrub Spray	1.05 in/h	1	58	957	319
2	Rain Bird PEB	Shrub Spray	1.75 in/h	1	35	972	324
3	Rain Bird PEB	Bubbler	3.43 in/h	2	35	770	257
4	Rain Bird PEB	Shrub Spray	1.32 in/h	1	46	1,144	381
5	Rain Bird PEB	Shrub Spray	0.95 in/h	1	63	1,078	359
6	Rain Bird PEB	Shrub Spray	1.39 in/h	1	44	1,412	471
7	Rain Bird PEB	Shrub Spray	0.96 in/h	1	63	2,247	749
8	Rain Bird PEB	Shrub Spray	1.46 in/h	1	42	1,371	457
9	Rain Bird PEB	Bubbler	3.86 in/h	2	32	960	320
10	Rain Bird PEB	Bubbler	3.56 in/h	2	34	374	125
11	Rain Bird PEB	Shrub Spray	1.5 in/h	1	40	530	177
12	Rain Bird PEB	Shrub Spray	1.51 in/h	1	40	550	183
13	Rain Bird PEB	Bubbler	4.12 in/h	2	30	570	190
14	Rain Bird PEB	Shrub Spray	1.25 in/h	1	48	703	234
15	Rain Bird PEB	Bubbler	4.16 in/h	2	29	580	193
		TOTALS:			639	14,217	4,739

NUMBER	MODEL	SIZE	TYPE	GPM	WIRE	PSI	PSI @ POC	PRECI
1	Rain Bird PEB	1-1/2"	Shrub Spray	16.5	30.6	26.1	40.7	1.05 in.
2	Rain Bird PEB	1-1/2"	Shrub Spray	27.76	174.0	24.7	43.4	1.75 in
3	Rain Bird PEB	1-1/2"	Bubbler	22	277.1	26.4	43.4	3.43 in
4	Rain Bird PEB	1-1/2"	Shrub Spray	24.86	422.0	26.9	45.9	1.32 in
5	Rain Bird PEB	1-1/2"	Shrub Spray	17.12	540.4	33.8	49.9	0.95 in
6	Rain Bird PEB	1-1/2"	Shrub Spray	32.09	545.6	26.6	50.5	1.39 in
7	Rain Bird PEB	1-1/2"	Shrub Spray	35.67	550.8	33.0	59.5	0.96 in
8	Rain Bird PEB	1-1/2"	Shrub Spray	32.65	665.2	27.5	52.9	1.46 in
9	Rain Bird PEB	1-1/2"	Bubbler	30	674.5	26.5	50.2	3.86 in
10	Rain Bird PEB	1"	Bubbler	11	75.7	23.0	37.5	3.56 in
11	Rain Bird PEB	1"	Shrub Spray	13.24	84.0	24.5	39.5	1.5 in/h
12	Rain Bird PEB	1"	Shrub Spray	13.75	89.5	24.7	39.8	1.51 in
13	Rain Bird PEB	1"	Bubbler	19	95.0	25.0	42.2	4.12 in
14	Rain Bird PEB	1"	Shrub Spray	14.64	152.1	23.7	39.5	1.25 in
15	Rain Bird PEB	1"	Bubbler	20	157.0	24.4	42.7	4.16 in
	Common Wire				821.0			

	REVISIONS								
DATE	BY	DESCRIPTION	DATE	BY	DESCRIPTION				


ANGELA BIAGI L.A. NO. 6666787 2035 VISTA PARKWAY WEST PALM BEACH, FL 33411





PREPARED FOR CITY OF GREEN COVE SPRINGS **IRRIGATION NOTES AND DETAILS**

REF. DWG. NO. SHEET NO. WALNUT STREET

IP-5Ø1

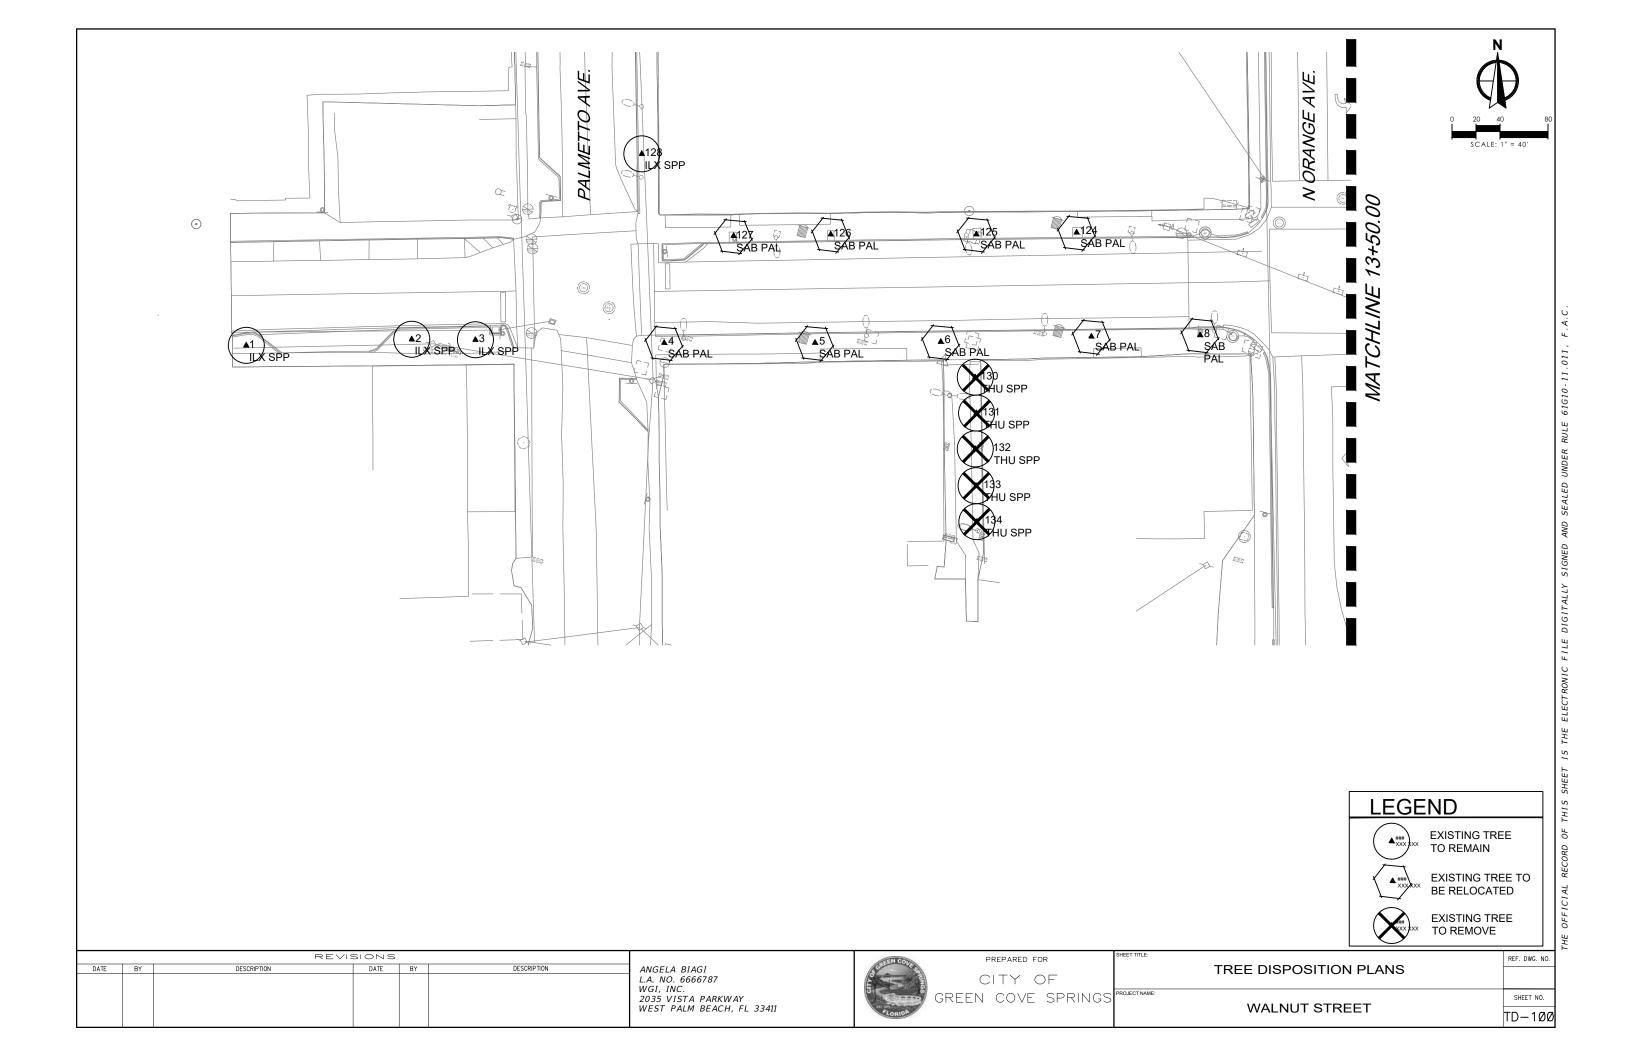

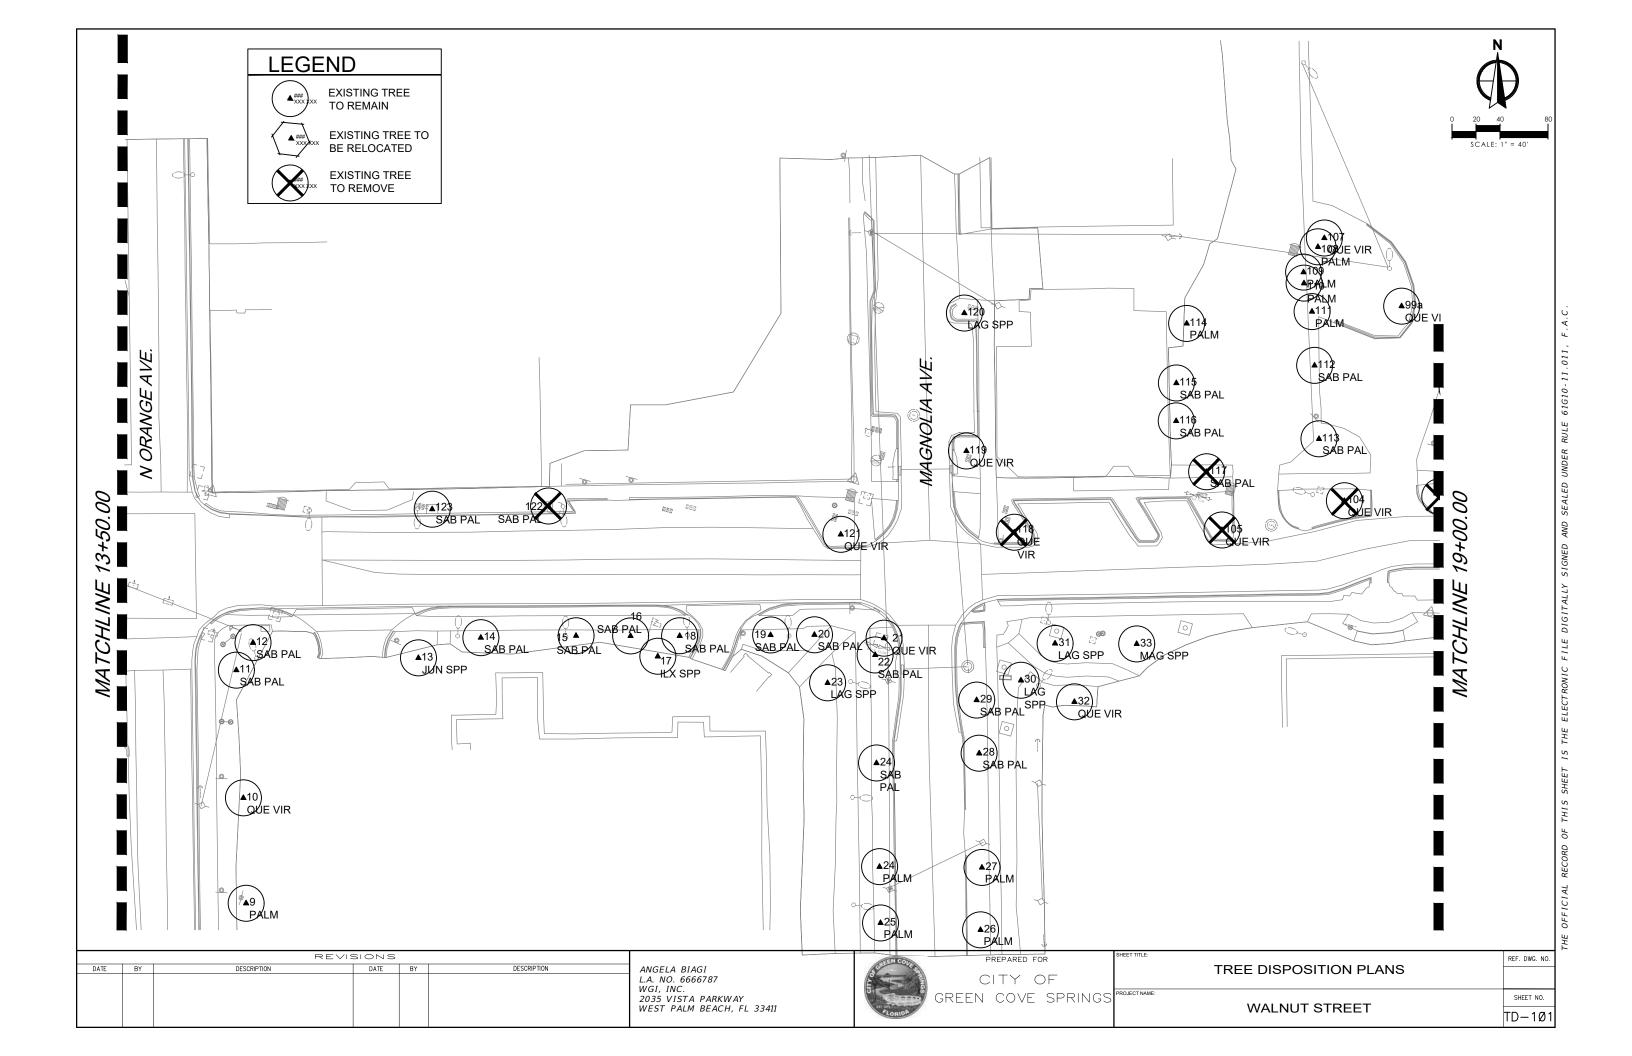

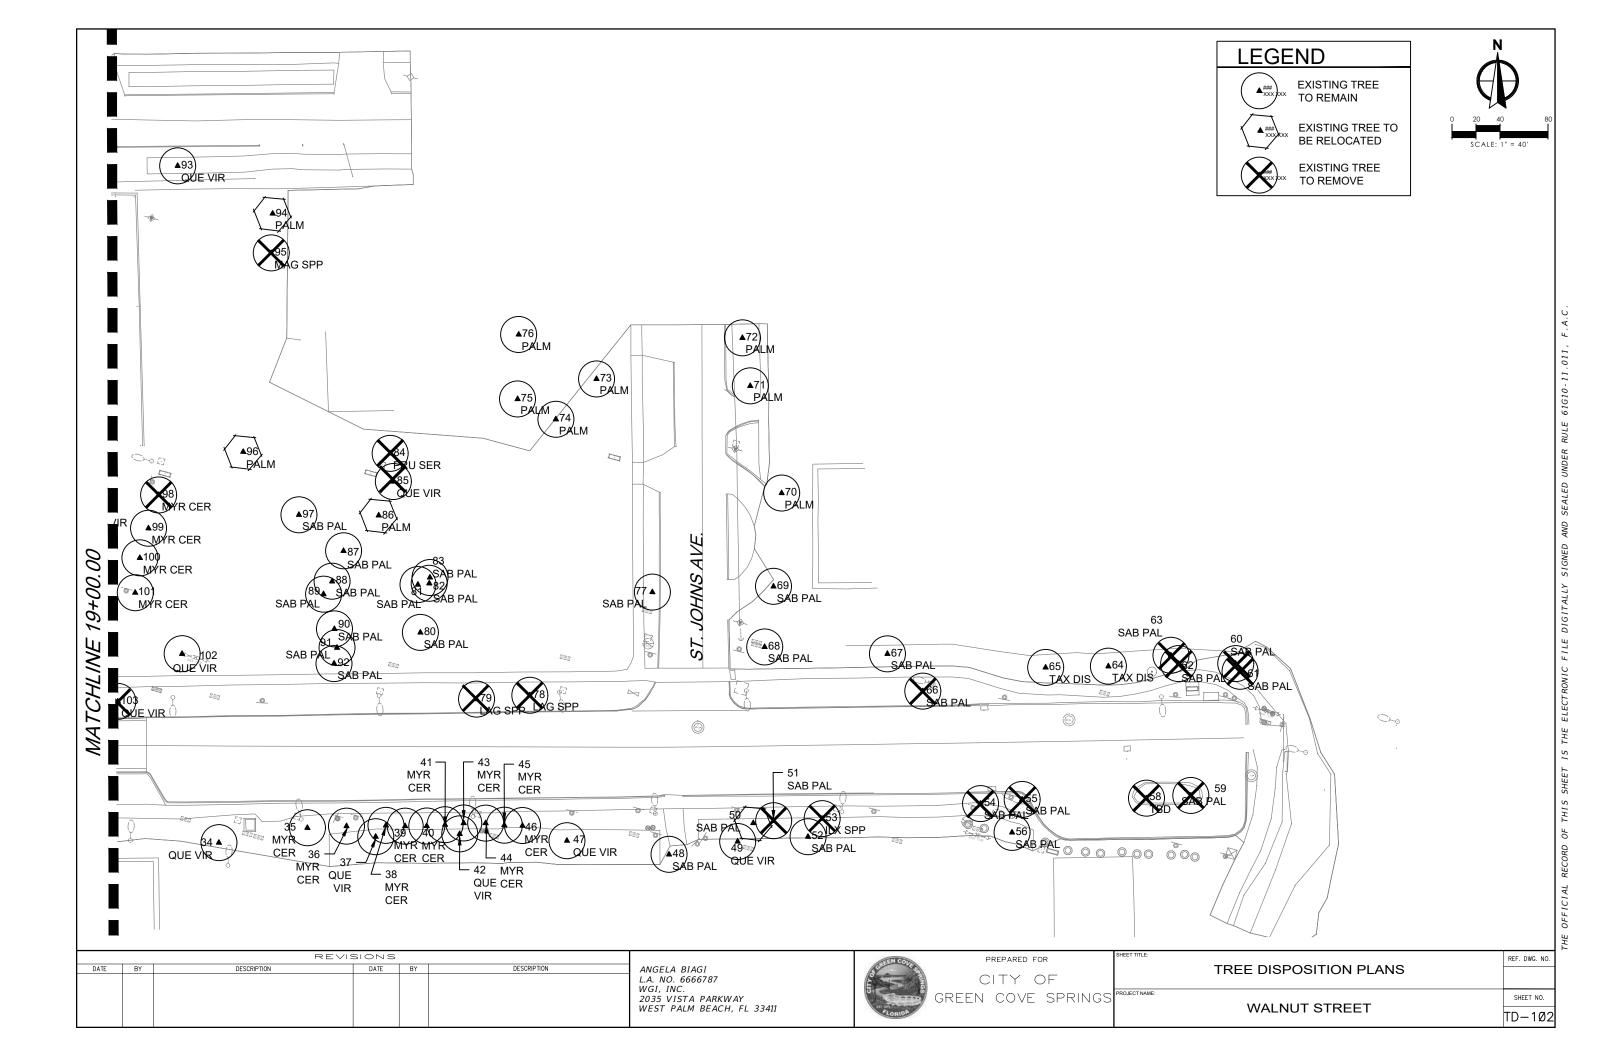

	TREE INVENTORY LIST								
Tag#	Common Name	Scientific Name	Caliper (DBH)*	Spread (sq-ft)	Condition Rating	Disposition	Notes		
1	Holly	Ilex x spp.	6"	N/A	N/A	PRESERVE			
2	Holly	llex x spp.	5"	N/A	N/A	PRESERVE			
3	Holly	Ilex x spp.	5"	N/A	N/A	PRESERVE			
4	Cabbage Palmetto	Sabal palmetto	14"	N/A	N/A	RELOCATE			
5	Cabbage Palmetto	Sabal palmetto	10"	N/A	N/A	RELOCATE			
6	Cabbage Palmetto	Sabal palmetto	9"	N/A	N/A	RELOCATE			
7	Cabbage Palmetto	Sabal palmetto	10"	N/A	N/A	RELOCATE			
8	Cabbage Palmetto	Sabal palmetto	8"	N/A	N/A	RELOCATE			
9	Cabbage Palmetto	Sabal palmetto	10"	N/A	N/A	PRESERVE			
10	Live Oak	Quercus virginiana	18"	N/A	N/A	PRESERVE			
11	Cabbage Palmetto	Sabal palmetto	N/A	N/A	N/A	PRESERVE			
12	Cabbage Palmetto	Sabal palmetto	N/A	N/A	N/A	PRESERVE			
13	Cedar	Juniperus x spp.	15"	N/A	N/A	PRESERVE			
14	Cabbage Palmetto	Sabal palmetto	11"	N/A	N/A	PRESERVE			
15	Cabbage Palmetto	Sabal palmetto	11"	N/A	N/A	PRESERVE			
16	Cabbage Palmetto	Sabal palmetto	16"	N/A	N/A	PRESERVE			
17	Holly	llex x spp.	N/A	N/A	N/A	PRESERVE			
18	Cabbage Palmetto	Sabal palmetto	10"	N/A	N/A	PRESERVE			
19	Cabbage Palmetto	Sabal palmetto	14"	N/A	N/A	PRESERVE			
20	Cabbage Palmetto	Sabal palmetto	12"	N/A	N/A	PRESERVE			
21	Live Oak	Quercus virginiana	N/A	N/A	N/A	PRESERVE			
22	Cabbage Palmetto	Sabal palmetto	11"	N/A	N/A	PRESERVE			
23	Crepe Myrtle	Lagerstroemia spp.	16"	N/A	N/A	PRESERVE			
24	Cabbage Palmetto	Sabal palmetto	13"	N/A	N/A	PRESERVE			
25	Cabbage Palmetto	Sabal palmetto	12"	N/A	N/A	PRESERVE			
26	Cabbage Palmetto	Sabal palmetto	10"	N/A	N/A	PRESERVE			
27	Cabbage Palmetto	Sabal palmetto	8"	N/A	N/A	PRESERVE			
28	Cabbage Palmetto	Sabal palmetto	11"	N/A	N/A	PRESERVE			
29	Cabbage Palmetto	Sabal palmetto	10"	N/A	N/A	PRESERVE			
30	Crepe Myrtle	Lagerstroemia spp.	3"	N/A	N/A	PRESERVE			
31	Crepe Myrtle	Lagerstroemia spp.	N/A	N/A	N/A	PRESERVE			
32	Live Oak	Quercus virginiana	4"	N/A	N/A	PRESERVE			
33	Magnolia	Magnolia x spp.	6"	N/A	N/A	PRESERVE			
34	Live Oak	Quercus virginiana	6"	N/A	N/A	PRESERVE			
35	Privet	Ligustrum japonicum	10"	N/A	N/A	PRESERVE			
36	Privet	Ligustrum japonicum	10"	N/A	N/A	PRESERVE			
37	Live Oak	Quercus virginiana	24"	N/A	N/A	PRESERVE			
38	Privet	Ligustrum japonicum	10"	N/A	N/A	PRESERVE			
39	Privet	Ligustrum japonicum	10"	N/A	N/A	PRESERVE			
40	Privet	Ligustrum japonicum	10"	N/A	N/A	PRESERVE			
41	Privet	Ligustrum japonicum	10"	N/A	N/A	PRESERVE			
42	Live Oak	Quercus virginiana	22"	N/A	N/A	PRESERVE			
43	Privet	Ligustrum japonicum	10"	N/A	N/A	PRESERVE			
44	Privet	Ligustrum japonicum	10"	N/A	N/A	PRESERVE			
45	Privet	Ligustrum japonicum	10"	N/A	N/A	PRESERVE			
46	Privet	Ligustrum japonicum	10"	N/A	N/A	PRESERVE			
47	Live Oak	Quercus virginiana	9"	N/A	N/A	PRESERVE			
48	Cabbage Palmetto	Sabal palmetto	15"	N/A	N/A	PRESERVE			
49	Cabbage Palmetto	Sabal palmetto	15"	N/A	N/A	PRESERVE			
50	Cabbage Palmetto	Sabal palmetto	22"	N/A	N/A	RELOCATE			

DATE	BY	DESCRIPTION	DATE	BY	DESCRIPTION	ANGELA BIAGI
						L.A. NO. 6666787 WGI, INC. 2035 VISTA PARKWAY WEST PALM BEACH, FL 33411

THE WOOD TO THE	C
FLORIDA	

A	PREPARED FOR	SHE
	CITY OF	
	GREEN COVE SPRINGS	PRO
/		ı

HEET TITLE:	TREE DISPOSITION P
ROJECT NAME:	

REF. DWG. NO. PLANS SHEET NO. WALNUT STREET

TD-500

	TREE INVENTORY LIST								
Tag#	Common Name	Scientific Name	Caliper (DBH)*	Spread (sq-ft)	Condition Rating	Disposition	Notes		
51	Cabbage Palmetto	Sabal palmetto	9"	N/A	N/A	REMOVE	0.001.0.401.000		
52	Cabbage Palmetto	Sabal palmetto	12"	N/A	N/A	PRESERVE			
53	Holly	llex x spp.	10"	N/A	N/A	REMOVE			
54	Cabbage Palmetto	Sabal palmetto	13"	N/A	N/A	REMOVE			
55	Cabbage Palmetto	Sabal palmetto	12"	N/A	N/A	REMOVE			
56	Cabbage Palmetto	Sabal palmetto	12"	N/A	N/A	PRESERVE			
57	NOT USED	out an pulliform		1,117,	7.07	THEOLITIC			
58	Pecan	Carya x spp.	24"	N/A	N/A	REMOVE			
59	Cabbage Palmetto	Sabal palmetto	12"	N/A	N/A	REMOVE			
60	Cabbage Palmetto	Sabal palmetto	12"	N/A	N/A	REMOVE			
61	Cabbage Palmetto	Sabal palmetto	20"	N/A	N/A	REMOVE			
62	Cabbage Palmetto	Sabal palmetto	13"	N/A	N/A	REMOVE			
63	Cabbage Palmetto	Sabal palmetto	10"	N/A	N/A	REMOVE			
64	Bald Cypress	Taxodium distichum	23"	N/A	N/A	PRESERVE			
65	Bald Cypress	Taxodium distichum	24"	N/A	N/A	PRESERVE			
66	Cabbage Palmetto	Sabal palmetto	11"	N/A	N/A	REMOVE			
67	Cabbage Palmetto	Sabal palmetto	7"	N/A	N/A	PRESERVE			
68	The state of the s	Sabal palmetto	18"	N/A	N/A	PRESERVE			
- 02220	Cabbage Palmetto	Sabal palmetto	10"	N/A N/A	N/A				
69	Cabbage Palmetto	Control of the contro	Section 1	The state of the s		PRESERVE			
70	Cabbage Palmetto	Sabal palmetto	11"	N/A	N/A	PRESERVE			
71	Cabbage Palmetto	Sabal palmetto	12"	N/A	N/A	PRESERVE			
72	Cabbage Palmetto	Sabal palmetto	8"	N/A	N/A	PRESERVE			
73	Cabbage Palmetto	Sabal palmetto	15"	N/A	N/A	PRESERVE			
74	Cabbage Palmetto	Sabal palmetto	13"	N/A	N/A	PRESERVE			
75	Cabbage Palmetto	Sabal palmetto	16"	N/A	N/A	PRESERVE			
76	Cabbage Palmetto	Sabal palmetto	13"	N/A	N/A	PRESERVE			
77	Cabbage Palmetto	Sabal palmetto	8"	N/A	N/A	PRESERVE			
78	Crepe Myrtle	Lagerstroemia spp.	8"	N/A	N/A	REMOVE			
79	Crepe Myrtle	Lagerstroemia spp.	8"	N/A	N/A	REMOVE			
80	Cabbage Palmetto	Sabal palmetto	15"	N/A	N/A	PRESERVE			
81	Cabbage Palmetto	Sabal palmetto	15"	N/A	N/A	PRESERVE			
82	Cabbage Palmetto	Sabal palmetto	15"	N/A	N/A	PRESERVE			
83	Cabbage Palmetto	Sabal palmetto	15"	N/A	N/A	PRESERVE			
84	Black Cherry	Prunus serotina	10"	N/A	N/A	REMOVE			
85	Live Oak	Quercus virginiana	24"	N/A	N/A	REMOVE			
86	Cabbage Palmetto	Sabal palmetto	12"	N/A	N/A	RELOCATE			
87	Cabbage Palmetto	Sabal palmetto	N/A	N/A	N/A	PRESERVE			
88	Cabbage Palmetto	Sabal palmetto	14"	N/A	N/A	PRESERVE			
89	Cabbage Palmetto	Sabal palmetto	14"	N/A	N/A	PRESERVE			
90	Cabbage Palmetto	Sabal palmetto	15"	N/A	N/A	PRESERVE			
91	Cabbage Palmetto	Sabal palmetto	15"	N/A	N/A	PRESERVE			
92	Cabbage Palmetto	Sabal palmetto	13"	N/A	N/A	PRESERVE			
93	Live Oak	Quercus virginiana	33"	N/A	N/A	PRESERVE			
94	Cabbage Palmetto	Sabal palmetto	20"	N/A	N/A	RELOCATE			
95	Magnolia	Magnolia x spp.	24"	N/A	N/A	REMOVE			
96	Cabbage Palmetto	Sabal palmetto	11"	N/A	N/A	RELOCATE			
97	Cabbage Palmetto	Sabal palmetto	12"	N/A	N/A	PRESERVE			
98	Wax Myrtle	Myrica cerifera	N/A	N/A	N/A	REMOVE			
99	Wax Myrtle	Myrica cerifera	N/A	N/A	N/A	PRESERVE			
100	Wax Myrtle	Myrica cerifera	N/A	N/A	N/A	PRESERVE			

DATE	BY	DESCRIPTION	DATE	BY	DESCRIPTION	ANGELA BIAGI
						L.A. NO. 6666787 WGI, INC. 2035 VISTA PARKWAY WEST PALM BEACH, FL 33411

OUTEN CONFIGNATION	GRE
CALL TO SERVICE OF THE PROPERTY OF THE PROPERT	

	PREPARED FOR	SHE
SPAINC	CITY OF	
8 3	GREEN COVE SPRINGS	PRO
/		

TREE DISPOSITION P

REF. DWG. NO. PLANS SHEET NO. WALNUT STREET TD-5Ø1

	TREE INVENTORY LIST							
Tag #	Common Name	Scientific Name	Caliper (DBH)*	Spread (sq-ft)	Condition Rating	Disposition	Notes	
99A	Live Oak	Quercus virginiana	36"	N/A	N/A	PRESERVE		
101	Wax Myrtle	Myrica cerifera	N/A	N/A	N/A	PRESERVE		
102	Live Oak	Quercus virginiana	N/A	N/A	N/A	PRESERVE		
103	Live Oak	Quercus virginiana	10"	N/A	N/A	REMOVE		
104	Live Oak	Quercus virginiana	14"	N/A	N/A	REMOVE		
105	Live Oak	Quercus virginiana	12"	N/A	N/A	REMOVE		
106	Live Oak	Quercus virginiana	48"	N/A	N/A	PRESERVE		
107	Live Oak	Quercus virginiana	24"	N/A	N/A	PRESERVE		
108	Cabbage Palmetto	Sabal palmetto	18"	N/A	N/A	PRESERVE		
109	Cabbage Palmetto	Sabal palmetto	18"	N/A	N/A	PRESERVE		
110	Cabbage Palmetto	Sabal palmetto	20"	N/A	N/A	PRESERVE		
111	Cabbage Palmetto	Sabal palmetto	20"	N/A	N/A	PRESERVE		
112	Cabbage Palmetto	Sabal palmetto	18"	N/A	N/A	PRESERVE		
113	Cabbage Palmetto	Sabal palmetto	13"	N/A	N/A	PRESERVE		
114	Cabbage Palmetto	Sabal palmetto	N/A	N/A	N/A	PRESERVE		
115	Cabbage Palmetto	Sabal palmetto	12"	N/A	N/A	PRESERVE		
116	Cabbage Palmetto	Sabal palmetto	14"	N/A	N/A	PRESERVE		
117	Cabbage Palmetto	Sabal palmetto	13"	N/A	N/A	REMOVE		
118	Live Oak	Quercus virginiana	N/A	N/A	N/A	REMOVE		
119	Live Oak	Quercus virginiana	9"	N/A	N/A	PRESERVE		
120	Crepe Myrtle	Lagerstroemia spp.	9"	N/A	N/A	PRESERVE		
121	Live Oak	Quercus virginiana	14"	N/A	N/A	PRESERVE		
122	Cabbage Palmetto	Sabal palmetto	11"	N/A	N/A	REMOVE		
123	Cabbage Palmetto	Sabal palmetto	10"	N/A	N/A	PRESERVE		
124	Cabbage Palmetto	Sabal palmetto	8"	N/A	N/A	RELOCATE		
125	Cabbage Palmetto	Sabal palmetto	10"	N/A	N/A	RELOCATE		
126	Cabbage Palmetto	Sabal palmetto	9"	N/A	N/A	RELOCATE		
127	Cabbage Palmetto	Sabal palmetto	10"	N/A	N/A	RELOCATE		
128	Holly	llex x spp.	5"	N/A	N/A	PRESERVE		
129	Holly	llex x spp.	8"	N/A	N/A	PRESERVE		
130	Arborvitae	Thuga x spp.	N/A	N/A	N/A	REMOVE		
131	Arborvitae	Thuga x spp.	N/A	N/A	N/A	REMOVE		
132	Arborvitae	Thuga x spp.	N/A	N/A	N/A	REMOVE		
133	Arborvitae	Thuga x spp.	N/A	N/A	N/A	REMOVE		
134	Arborvitae	Thuga x spp.	N/A	N/A	N/A	REMOVE		

r	REVISIONS						
	DATE	BY	DESCRIPTION	DATE	BY	DESCRIPTION	ANGELA BIAGI
							L.A. NO. 6666787 WGI, INC. 2035 VISTA PARKWAY WEST PALM BEACH, FL 33411

GREEN COVE	PREPARED FOR
PLORIDA	CITY OF Green cove springs

SHEET TITLE:	ET TITLE:				
TREE DISPOSITION PLANS					
PROJECT NAME:		SHEET NO.			
	WALNUT STREET				
WALNOT STREET					

POST TRANSPLANT WATERING TO PROVIDE MOISTURE AND REDUCE ANY EXCESSIVE STRESS DUE TO DESSICATION. WATERING TO BE ADJUSTED ACCORDING TO CONDITIONS AND AT

THE SUPERVISION AND DIRECTION OF THE ISA CERTIFIED ARBORIST TRANSPLANTING HOLE TO BE AT LEAST 1/3 LARGER THAN MAN THE AREA THAT WAS TRENCHED TRANSPLANTING.

PROVIDE MOISTURE AND REDUCE

ANY EXCESSIVE STRESS DUE TO

DESSICATION. WATERING TO BE

Supervision and direction of

1/3 LARGER THAN THE AREA THAT WAS

THE ISA CERTIFIED ARBORIST.

ADJUSTED ACCORDING TO

CONDITIONS AND AT THE

TRANPLANT OPERATIONS TO BE SUPERVISED BY AN ISA CERTIFIED ARBORIST.

WOOD BATTENS FOR SUPPORT. BRACES DO NOT NAIL TO PALM.

WOOD BRACES PROVIDED - A MINIMUM OF THREE - TO BRACE AND SUPPORT PALM. THE CONTRACTOR SHALL BE RESPONSIBLE TO ADD BRACING NECESSARY TO PROVIDE FULL SUPPORT AND CHECK REGULARLY. RE-BRACE AS NEEDED. 4" X 4" AS NEEDED FOR ROYAL PALMS

SET THE PALM NO DEEPER THAN ITS ORIGINAL CONDITION

RECYCLED MULCH - 3" DEEP

SAUCER ALL AROUND FOR WATER RETENTION

BACKFILL WITH A MIXTURE OF 50% NATIVE SOIL AND 50% OF 50:50 TOPSOIL: SAND MIXTURE

WATER TO ELIMINATE WATER POCKETS WITH WATER HOSE APPLICATION OF FLOOD WATERING.

PALM TRANSPLANT DETAIL

REF: "THE LANDSCAPE MANUAL" DADE CO. DEPT OF PLANNING & ZONING 2001 POST TRANSPLANT WATERING TO

> TRANPLANT OPERATIONS TO BE SUPERVISED BY AN ISA CERTIFIED ARBORIST.

WOOD BATTENS FOR SUPPORT. BRACES DO NOT NAIL TO

WOOD BRACES PROVIDED - A MINIMUM OF THREE - TO BRACE AND SUPPORT TREE. THE CONTRACTOR SHALL BE RESPONSIBLE TO ADD BRACING NECESSARY TO PROVIDE FULL SUPPORT AND CHECK REGULARLY. RE-BRACE AS NEEDED. 4" X 4" AS NEEDED FOR LARGE OAKS SET THE TREE NO DEEPER THAN ITS ORIGINAL CONDITION

RECYCLED MULCH - 3" DEEP

SAUCER ALL AROUND FOR WATER RETENTION

BACKFILL WITH A MIXTURE OF 50% NATIVE SOIL AND 50% OF 50:50 TOPSOIL: SAND MIXTURE


WATER TO ELIMINATE WATER POCKETS WITH WATER HOSE TRANSPLANTING HOLE TO BE AT LEAST APPLICATION OF FLOOD WATERING.

TREE TRANSPLANT DETAIL

REF: "THE LANDSCAPE MANUAL" DADE CO. DEPT OF PLANNING & ZONING 2001

N.T.S.

N.T.S.

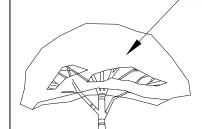

TREE TO BE LIGHTLY PRUNED BY HAND

WORK TO BE SUPERVISED BY AN ISA CERTIFIED ARBORIST OR A COMPANY WITH A CERTIFIED ISA ARBORIST ON STAFF. **NOTES:**

BACKFILL.

1. SEE SHEET LANDSCAPE PLANS FOR THE PROPOSED TREE AND PALM LOCATIONS

WORK WHICH WILL BE IMPACTED BY ANY OTHER TREES OR PALMS TO REMAIN.

SITE AND MAINTENANCE SHALL GUARANTEE CONTROL OF RE-INVASION.

PROJECT MANAGER FOR REVIEW AND APPROVAL PRIOR TO RELOCATION.

MINIMIZE ROOT DAMAGE DURING THE RECUPERATION PERIOD.

UTILITIES AND LIMITS OF PROPERTY.

AND PALMS AT THE FINAL GRADE OF SITE.

PRACTICES AND ANY APPLICABLE LOCAL CODES.

TREE TRANSPLANTING

ESTABLISHMENT.

2. THE CONTRACTOR SHALL REMOVE ALL TREES AND HEDGES AS PER PLANS AND AS APPROVED BY THE LOCAL GOVERNING AGENCIES (CITY OF GREEN COVE SPRING). TREE PALM AND HEDGE MATERIAL SHALL INCLUDE ALL TRUNKS, STUMPS, AND ROOTS. ALL EXCESS DEBRIS SHALL BE REMOVED FROM THE SITE AND DISPOSED OF AT AN APPROVED SITE. ALL HOLES AND DEPRESSIONS SHALL BE BACKFILLED WITH CLEAN APPROVED

3. LOCATIONS SHOWN FOR THE EXISTING TREES AND PALMS ARE APPROXIMATE. EXACT LOCATIONS ARE TO

BE FIELD VERIFIED BY A REGISTERED LAND SURVEYOR (RLS) PRIOR TO ANY PAVING OR ANY OTHER SUCH

EXOTIC PEST PLANT COUNCIL'S LIST OF FLORIDA'S MOST INVASIVE SPECIES SHALL BE REMOVED FROM THE

5. ALL TREES AND PALMS TO BE RELOCATED SHALL BE ROOT PRUNED AND CANOPY PRUNED ACCORDING TO

POST-TRANSPLANT OPERATIONS SHALL BE COORDINATED WITH THE UTMOST CARE TO MINIMIZE DAMAGE

ALL ACCEPTED STANDARDS AS DEFINED BY THE NATIONAL ARBORIST ASSOCIATION. AND ALL PRE AND

AND TRANSPLANT SHOCK. WATERING-IN AND WATERING SCHEDULES SHALL BE SUBMITTED TO THE

6. ALL TREES AND PALMS TO BE RELOCATED SHALL BE STAKED AND BRACED TO INSURE STABILITY AND

7. CONTRACTOR SHALL VERIFY WITH THE PROJECT SUPERINTENDENT THE PROPOSED LANDSCAPE AREAS

PRIOR TO TREE AND PALM RELOCATION TO ENSURE PROPER RELOCATION AND MINIMIZE ANY FIELD

10. SEE "ROOT PRUNING DETAIL" AND "TREE TRANSPLANT DETAIL AS SHOWN ON PLANS.

4. ALL INVASIVE EXOTIC VEGETATION AND ANY OTHER PLANTS LISTED AS CATEGORY I, ON THE FLORIDA

ROOT PRUNING MUST BE DONE A MINIMUM OF 8 WEEKS PRIOR TO TRANSPLANTING.

WATERING MUST PROVIDE SUFFICIENT WATER TO MAINTAIN A MOIST CONDITION IN THE ROOTS. ONCE A WEEK OR MORE ACCORDING TO CONDITIONS.

TAKE EXTRA CARE NOT TO DAMAGE THE TRUNK OR BRANCHES


TRENCH TO BE LIGHTLY FILLED WITH FIBROUS MATERIAL SUCH AS LEAVES OR WOOD SHAVINGS. TRENCH SHALL SHARP INSTRUMENTS OR MACHINERY. RIPPING OR TEARING OF THE ROOTS IS STRICLY PROHIBITED.

ALL TORN ROOTS MUST BE TRIMMED TO SOLID WOOD WITH CLEAN, SHARP INSTRUMENTS.

DEPTH TO BE 18" MIN. TO 36" - VARIES WITH SIZE OF TREE.

ROOT PRUNING DETAIL

DRIP LINE

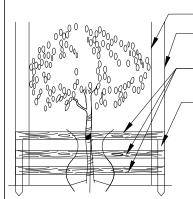

BARRIER TO FORM A CONTINUOUS CIRCLE AROUND THE TREE OR GROUP OF TREES.

FENCE TO EXTEND TO THE EDGE OF THE DRIPLINE OR MORE WHERE POSSIBLE

THREE ROWS OF RAIL FENCING (2" X 4") SPACED EQUALLY TO BE PLACED ARAOUND ALL EXISTING TREES TO REMAIN.

WOODEN STAKES (2" X 4" X 5" MIN.) ON 5' CENTERS - TO SUPPORT RAIL FENCING.

CONTRACTOR TO INSTALL PROTECTIVE FENCE BARRIER AROUND ALL EXISTING TREES TO REMAIN - AT THE START OF THE PROJECT - FENCE TO REMAIN IN PLACE THROUGHOUT THE DURATION OF THE PROJECT.

CONTRACTOR SHALL TAKE EXTRA CARE DURING EARTHWORK AND UTILITY OPERATIONS. TO PROTECT ALL EXISTING TREES - AND SHALL BE RESPONSIBLE TO REPLACE ANT TREES DAMAGED DURING CONSTRUCTION.

TREE PROTECTION DETAIL

N.T.S.

A TREE REMOVAL PERMIT IS REQUIRED FROM GREEN COVE SPRINGS PRIOR TO REMOVAL OF ANY TREES FROM THE SITE.

SEE SHEET TD-500-502 FOR TREE INVENTORY.

SEE LANDSCAPE PLANS FOR PROPOSED LANDSCAPE PLANTINGS, LANDSCAPE LEGEND, SPECIFICATIONS, NOTES, DETAILS, ETC.

Sunshine 811
State 811
One Call
NATIVE TREE DISPOSITION PLAN

				i
DESCRIPTION	DATE	BY	DESCRIPTION	ANGELA BIAGI
				L.A. NO. 6666787
				WGI, INC.
				2035 VISTA PARKWAY
				WEST PALM BEACH, FL 33411



GREEN COVE SPRINGS

TREE DISPOSITION PLANS

SHEET NO **WALNUT STREET** TD-600

8. CONTRACTOR SHALL ESTABLISH AN IRRIGATION SYSTEM TO PROVIDE FOR PRE AND POST-TRANSPLANT IRRIGATION SCHEDULING. TREE AND PALM FERTILIZATION SHALL BE ESTABLISHED CONCURRENTLY WITH IRRIGATION PRE AND POST-FERTILIZATION, THIS PROCEDURE SHALL BE CONDUCTED TO OPTIMIZE PLANT 9. CONTRACTOR SHALL COORDINATE WITH THE PROJECT SUPERINTENDENT TO PLANT ALL RELOCATED TREES ALL STANDARDS SHALL MEET OR EXCEED THE ANSI A300 (PART 6)-2005 (TRANSPLANTING) STANDARD CONTRACTOR SHALL EMPLOY AN ISA CERTIFIED ARBORIST WITH VERIFIABLE TREE TRANSPLANT EXPERIENCE SHALL PROVIDE A TREE RELOCATION PLAN FOR APPROVAL BY THE OWNERS AGENT BEFORE ANY WORK CAN

REF. DWG. NO

COMMENCE. SHALL MAKE SITE VISITS PRIOR TO ANY RELOCATION WORK TO INSPECT THAT THE PROPER PREPARATION

PROCEDURAL SPECIFICATIONS

PURPOSE: TO MAXIMIZE THE SUCCESS OF TREE TRANSPLANTING OPERATIONS.

AS THE "EXPERT ARBORIST OF RECORD" TO CARRY OUT THE FOLLOWING DUTIES:

WORK IS PERFORMED TO THE TREE RELOCATION GUIDELINES.

SHALL MAKE SITE VISITS DURING RELOCATION WORK TO INSURE WORK IS BEING PERFORMED TO THE TREE RELOCATION GUIDELINES.

SHALL DOCUMENT ALL INSPECTIONS AND PROVIDE REPORT TO THE OWNER'S AGENT WITHIN 5 BUSINESS DAYS OF THE SITE VISIT.

SHALL SUBMIT PRIOR TO FINAL ACCEPTANCE BY OWNER'S AGENT, A POST-TRANSPLANT CARE GUIDE FOR UP TO THREE YEARS THAT INCLUDES WATERING, FERTILIZATION, PRUNING, PEST CONTROL, STAKING, ETC, FOR APPROVAL.