LANDSCAPE IRRIGATION TO BE PROVIDED BY AUTOMATIC IRRIGATION SYSTEM. BUBBLERS SHALL BE INSTALLED BY EACH TREE AS PART OF THE IRRIGATION SYSTEM.

KNOW WHAT'S

ALWAYS CALL 811

BEFORE YOU DIG

It's fast, It's free, it's the law.

Call <u>811</u> two business days before digging

PLANT QUANTITIES SHOWN ARE FOR PERMITTING PURPOSES ONLY. IT IS THE RESPONSIBILITY OF THE CONTRACTOR TO CONFIRM ALL QUANTITIES SHOWN ON THE PLAN.

ALL PLANT MATERIAL TO BE FLORIDA NO.1 OR BETTER, GRADED IN ACCORDANCE WITH THE STATE OF FLORIDA DEPARTMENT OF AGRICULTURE, DIVISION OF PLANT INDUSTRY'S 'GRADES AND STANDARDS FOR NURSERY PLANTS', CURRENT EDITION AT THE TIME PLANS ARE ISSUED. CALL LANDSCAPE ARCHITECT PRIOR TO PURCHASING ANY PLANT MATERIAL FOR AN ON SITE INSPECTION AND REVIEW OF LANDSCAPE PLAN.

GRASSING
ALL DISTURBED AND UNPAVED AREAS TO BE GRASSED WITH SOD THAT IS FREE OF NOXIOUS WEEDS INCLUDING TROPICAL SODA APPLE OR SHALL BE SEEDED AND MULCHED. SEE CIVIL SITE PLANS FOR ADDITIONAL RELATED INFORMATION.


REFER TO CIVIL PLANS FOR TREE BARRICADE DETAILS AND INFORMATION. INVASIVE EXOTIC PLANT MATERIAL ALL INVASIVE PLANT SPECIES TO BE REMOVED FROM SITE PRIOR TO ISSUANCE OF THE CERTIFICATE OF OCCUPANCY.

AND SOD AREAS PRIOR TO LANDSCAPE INSTALLATION. IF ENCOUNTERED DURING CONSTRUCTION OR INSTALLATION, THESE SHALL BE EXCAVATED AND REMOVED FROM THE SITE. PLANTING DEPTH OF SOIL IN SUCH AREAS SHOULD BE AT LEAST 3'. IF FILL MUST BE ADDED, IT MUST BE FLORIDA CLEAN DEEP FILL (FREE OF WEED SEEDS) WITH pH 6.0 - 7.5. ALL LANDSCAPED AREAS SHALL BE MULCHED WITH 3" THICKNESS OF MULCH. PINE BARK MULCH SHALL BE USED IN ALL AREAS. NEW TREES OUTSIDE OF MULCHED LANDSCAPED BEDS WILL BE PROTECTED FROM MOWER AND STRING TRIMMER DAMAGE WITH 10" OF PLASTIC DRAIN TUBING. LEADER SHOOTS AND MAIN STRUCTURAL LIMBS OF TREES SHALL NOT BE TOPPED OR PRUNED. TREES WILL BE STAKED AS NEEDED. GUYLINES WILL BE OF NON-SYNTHETIC BIODEGRADABLE

ALL ASPHALT, LIMEROCK, AND CONSTRUCTION DEBRIS SHALL BE REMOVED FROM PLANTING BEDS

NEW TREES TO BE ADDED EXISTING TREES TO REMAIN

GENERAL NOTES

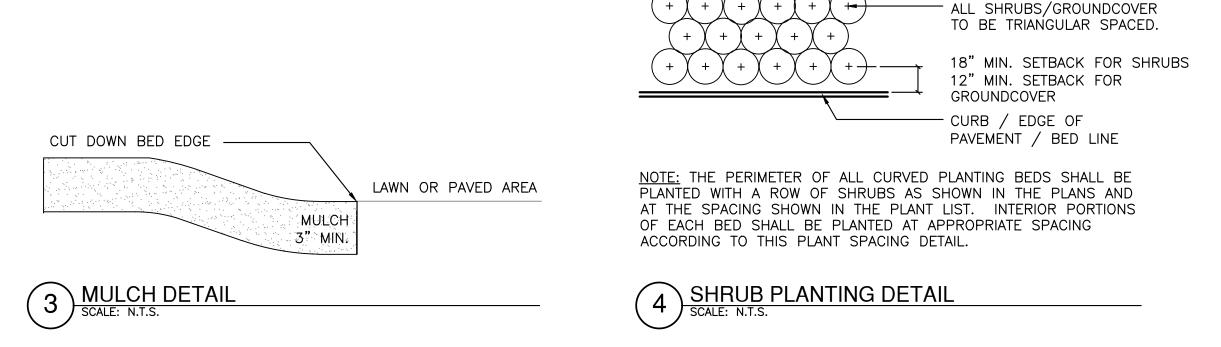

4" HIGH & 8" WIDE ROUND TOPPED SOIL BERM ABOVE ROOTBALL SURFACE SHALL BE CONSTRUCTED AROUND THE ROOT BALL. BERM SHALL BEGIN AT ROOT BALL PERIPHERY. 3" LAYER OF MULCH. -NO MORE THAN 1" OF MULCH PRIOR TO MULCHING, LIGHTLY TAMP ON TOP OF ROOT BALL. SOIL AROUND THE ROOT BALL IN 6" LIFTS TO BRACE SHRUB. DO NOT FINISHED GRADE— SLOPE SIDES OF HOLE HAS BEEN BACKFILLED, POUR LOOSENED SOIL.-WATER AROUND THE ROOT BALL TO SETTLE THE SOIL. ROOT BALL RESTS ON EXISTING OR 3X WIDEST RECOMPACTED SOIL--DIMENSION OF----THE AREA AND DEPTH SHOWN. ROOT BALL.

TREE PLANTING DETAIL

SCALE: N.T.S.

OVER COMPACT. WHEN THE PLANTING -LOOSENED SOIL. DIG AND TURN THE SOIL TO REDUCE THE COMPACTION TO

TOP OF ROOT BALL SHALL BE 2" ABOVE FINISHED GRADE. - PRIOR TO MULCHING, LIGHTLY TAMP SOIL AROUND THE ROOT BALL IN 6" LIFTS TO BRACE TREE. DO NOT OVER COMPACT. WHEN THE PLANTING HOLE HAS BEEN BACKFILLED, POUR WATER 10" PLASTIC AROUND THE ROOT BALL TO SETTLE THE SOIL. DRAIN TUBING--LOOSENED SOIL. DIG AND TURN THE ROUND-TOPPED SOIL BERM 4" SOIL TO REDUCE COMPACTION TO THE HIGH X 8" WIDE ABOVE ROOT ----AREA AND DEPTH SHOWN. BALL SURFACE SHALL BE — 3" LAYER OF MULCH. CONSTRUCTED AROUND THE NO MORE THAN 1" OF MULCH ON ROOT BALL. BERM SHALL BEGIN TOP OF ROOT BALL. AT ROOT BALL PERIPHERY. SLOPE SIDES OF -FINISHED GRADE LOOSENED SOIL.-3X WIDEST DIMENSION OF ROOT BALL.

CATEGORY	MITIGATION CALCULATIONS		
INCH-FOR-INCH REPLACEMENT	REMOVED LIVES OAKS DBH/SPECIES 10" LO 12" LO 13" LO TOTAL REMOVED LIVE OAK INCHES		
REPLACEMENT	REMOVED TREES ABOVE 12" DBH/SPECIES 18" PALM 18" PALM 15" PALM 20" PALM TOTAL REMOVED TREE INCHES		
TOTAL TREE MITIGATION INCHES REQUIRED			

REE MITIGATI	ON CALCULATIONS Sec. 113-279(a)		
CATEGORY	MITIGATION CALCULATIONS		
NCH-FOR-INCH REPLACEMENT	REMOVED LIVES OAKS DBH/SPECIES 10" LO 12" LO 13" LO TOTAL REMOVED LIVE OAK INCHES		
REPLACEMENT	REMOVED TREES ABOVE 12" DBH/SPECIES 18" PALM 18" PALM 15" PALM 20" PALM TOTAL REMOVED TREE INCHES		
TOTAL TREE MITIGATION	TOTAL MITIGATION INCHES REQUIRED		

PERIMETER	PERIMETER LANDSCAPING CALCULATIONS Sec. 113-244(b)(1)					
LOCATION	BUFFER LENGTH	REQUIRED LANDSCAPE	PROVIDED LANDSCAPE			
NORTHERN PERIMETER ALONG ORANGE AVE	250 L.F.	1 SHADE TREE PROVIDED EVERY 50 LINEAR FEET & CONTINUOUS SHRUB = 5 SHADE TREES & CONTINOUS HEDGE	5 SHADE TREES CONTINOUS HEDGE			
SOUTHERN PERIMETER ALONG PALMETTO AVE	215 L.F.	1 SHADE TREE PROVIDED EVERY 50 LINEAR FEET & CONTINUOUS SHRUB = 4 SHADE TREES & CONTINOUS HEDGE	4 TREE CREDITS CONTINOUS HEDGE			

...63,600 S.F.

....7 TREES

...13 TREES

...20 TREES

INTERIOR LANDSCAPING CALCULATIONS Sec. 113-244(b)(2)

PROJECT SITE AREA.....

PROJECT SITE AREA)....

TOTAL REQUIRED TREES..

TOTAL REQUIRED INCHES

TOTAL PROVIDED INCHES

(FROM APPLIED TREE CREDITS) ..

TOTAL REMAINDER TREE CREDITS...

(AT 2"/TREE)......

(FOR THE FIRST 10,500 S.F.

OF THE PROJECT SITE AREA)...

(FOR THE REMAINDER OF THE

TOTAL REQUIRED TREES PER 1,500 S.F.

TOTAL REQUIRED TREES PER 4,000 S.F.

TREE CREDITS Sec. 113-279(b)			
TREES PRESERVED ABOVE 12"			
DBH/SPECIES 32" LO	TREE CREDITS 48" 35" 11" 12" 7"		
	= 113" TOTAL TREE CREDITS AGAINST LANDSCAPE REQUIREMENTS		



Professional Consultants

11801 RESEARCH DRIVE ALACHUA, FL 32615 T: 352.331.1976 F: 352.331.2476 LA0001683

MITCHELL GULLEDGE ENGINEERING, INC. 204 SW 4TH AVENUE **GAINESVILLE, FL 32601** FL LICENSE EB-31501 T: 352.745.3991

www.mitchellgulledge.com

9133 R.G. SKINEER PARKWAY, SUITE 1

DESCRIPTION

CLAY COUNTY

ECONOMIC

DEVELOPMENT

SERVICES

FACILITY

633 N. ORANGE AVE.

KEY PLAN

DRAWING TITLE:

GREEN COVE SPRINGS, FL 32043

LANDSCAPE DETAILS,

NOTES, AND

CALCULATIONS

LS-1

CHECKED BY: JMS

PROJECT NO.: 23-0204 DRAWN BY:

100% CONSTRUCTION DOCUMENTS

REVISION

JACKSONVILLE, FL

ISSUE DATE:


6/19/2024









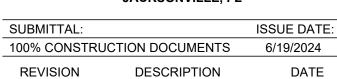

CLAY COUNTY ECONOMIC DEVELOPMENT SERVICES FACILITY

633 N. ORANGE AVE. GREEN COVE SPRINGS, FL 32043

KEY PLAN

DRAWING TITLE:

GRAPHIC SCALE


0 10 20 40


LANDSCAPE PLAN

PROJECT NO.: 23-0204 DRAWN BY: LR

CHECKED BY: JMS

LS-2

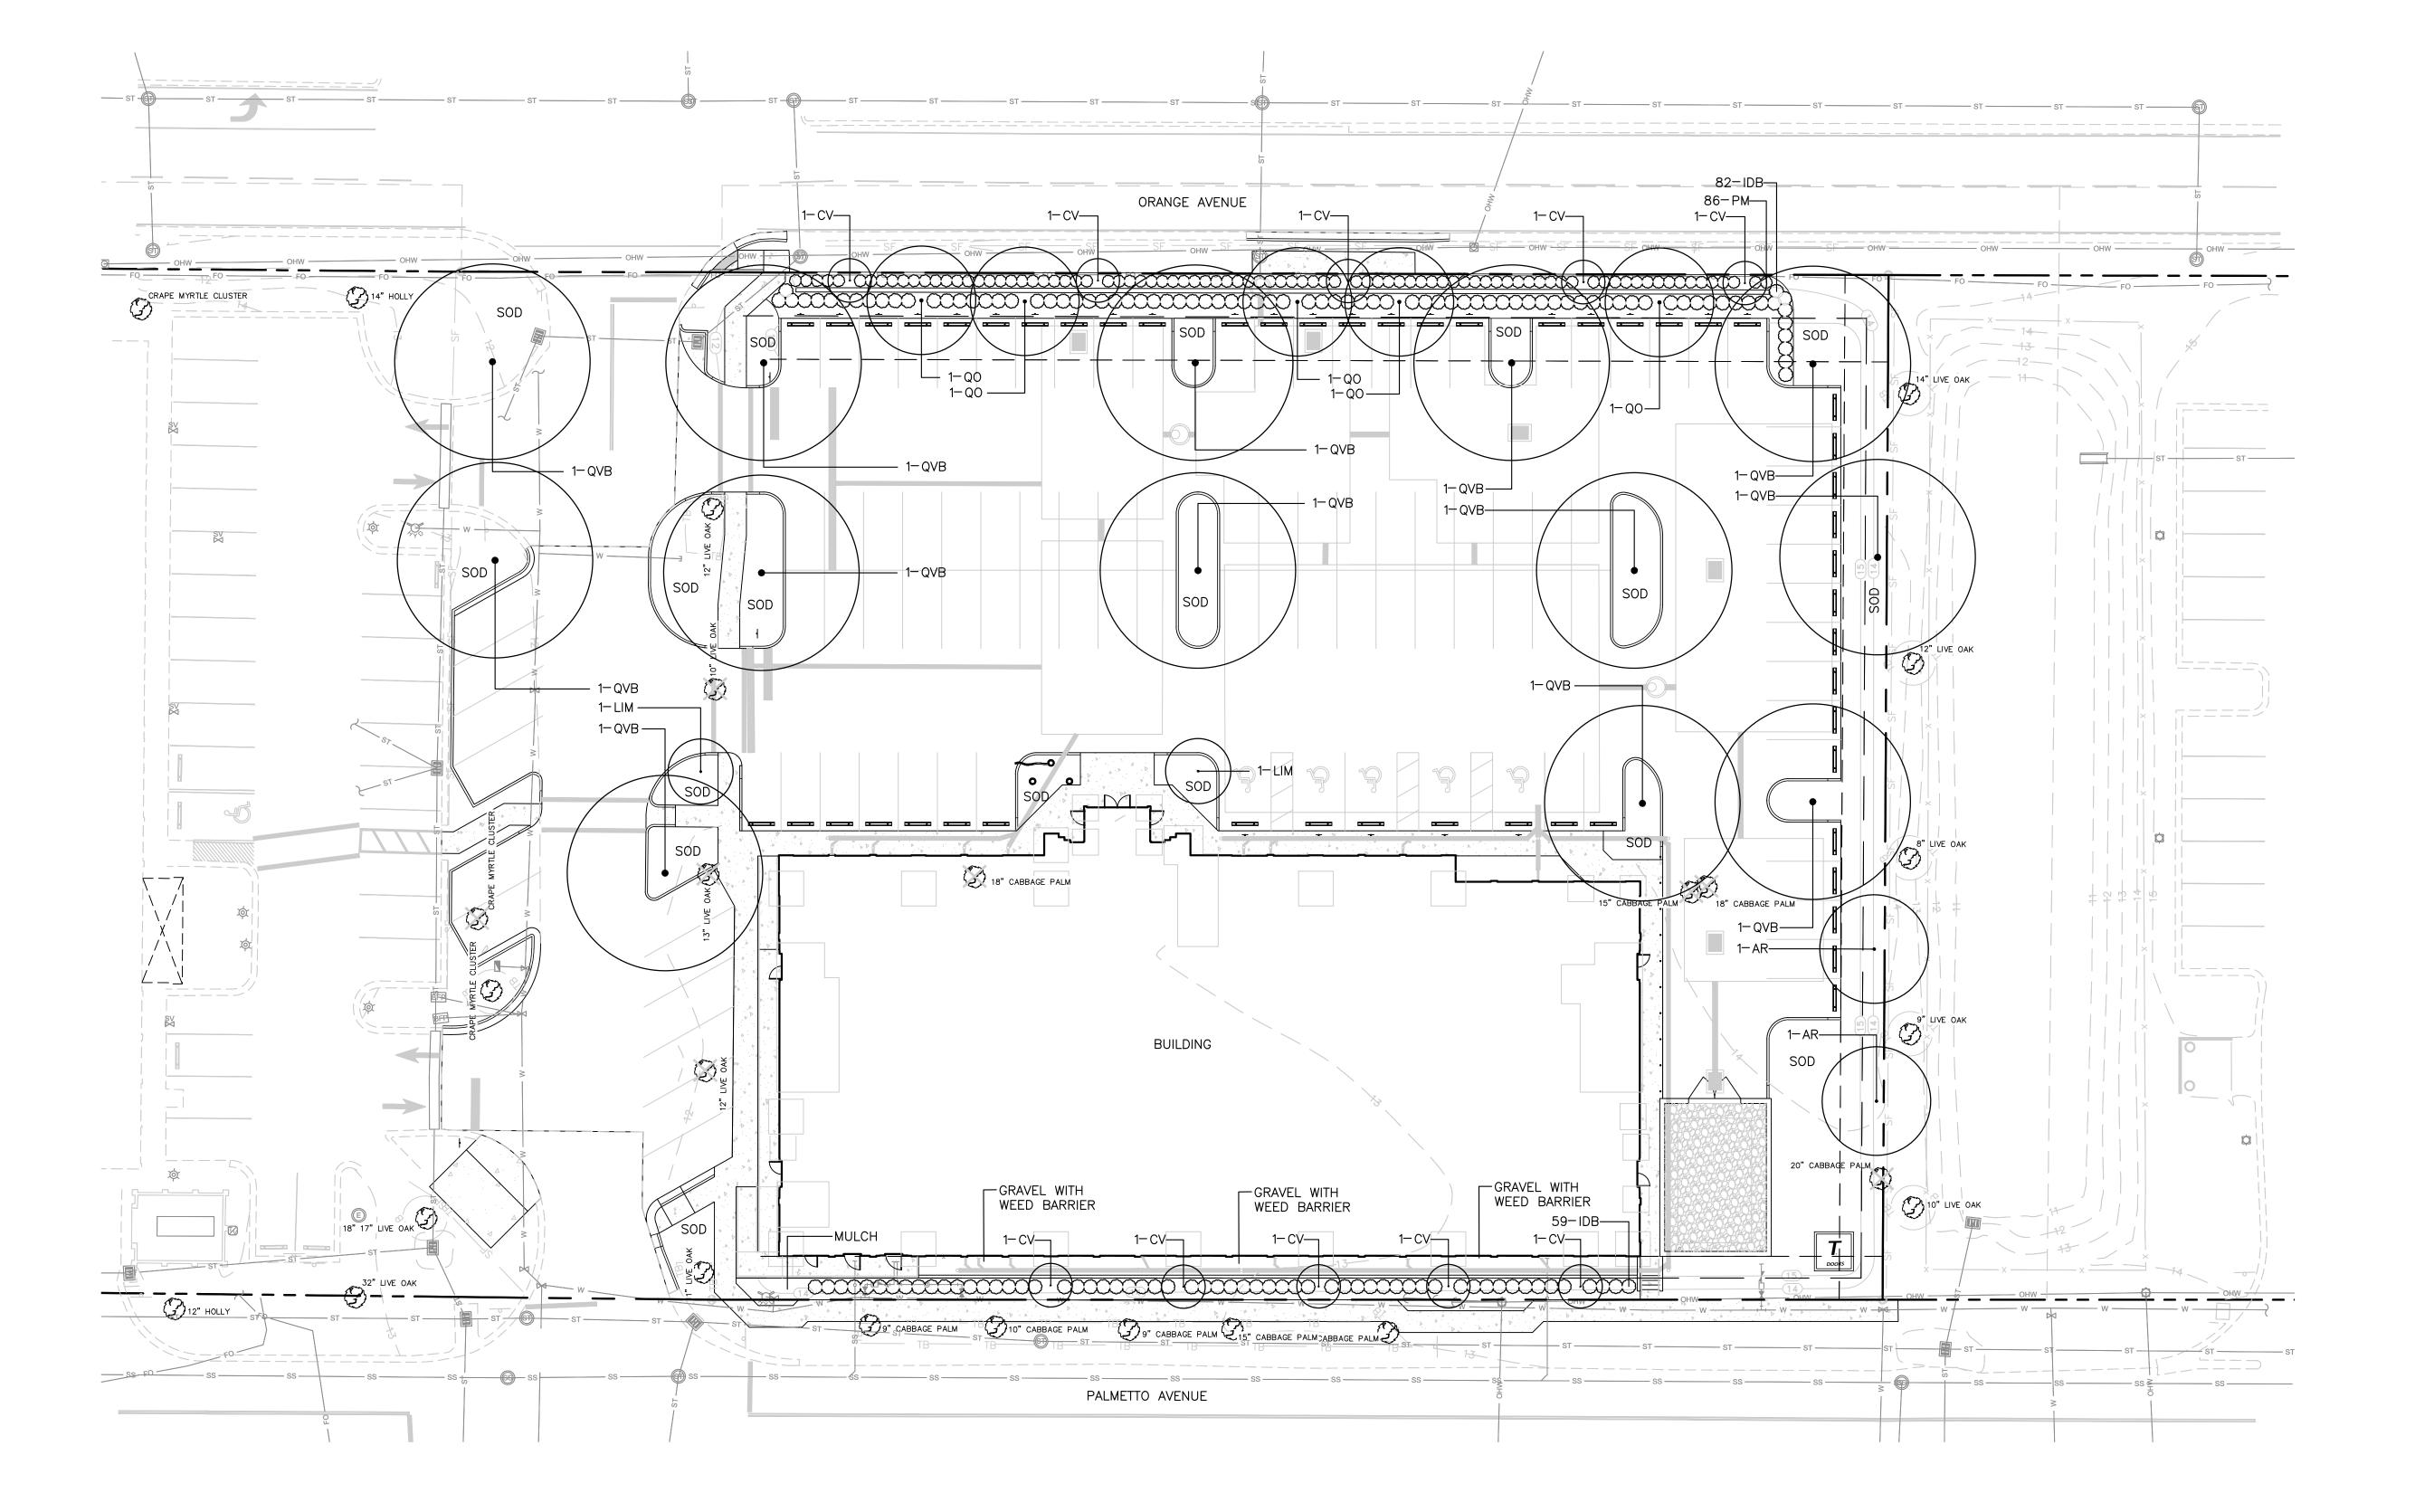

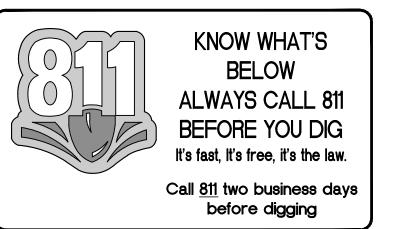

PLANT SCHEDULE

SIZE CODE QTY BOTANICAL NAME COMMON NAME FLORIDA FLAME RED MAPLE 30 GAL, 11' HT, 3' SPR, 2" CAL 15 GAL., 9'HT., 30" SPR., 1-1/2"CAL WHITE FRINGETREE CHIONANTHUS VIRGINICUS 30 GAL, 10' HT, 4' SPR, 2" CAL MUSKOGEE CRAPE MYRTLE LAGERSTROEMIA INDICA 'MUSKOGEE' BASKET OAK 30 GAL, 12' HT, 42" SPR, 2" CAL QUERCUS MICHAUXII 30 GAL, 12' HT, 54" SPR, 2" CAL BOARDWALK LIVE OAK QUERCUS VIRGINIANA 'BOARDWALK' ILEX CORNUTA 'DWARF BURFORDII' DWARF BURFORD HOLLY 3 GAL, 24" HT, 16" SPR PODOCARPUS MACROPHYLLUS 'DWARF PRINGLES' DWARF PRINGLES PODOCARPUS 3 GAL., 24" HT., 18"SPR. SIZE **COMMON NAME** BOTANICAL NAME WEED FREE AND SAND GROWN SOD PASPALUM NOTATUM 'ARGENTINE' BAHIA GRASS

