

## NORTH WELD COUNTY WATER DISTRICT GREELEY INTERCONNECT AT HARMONY

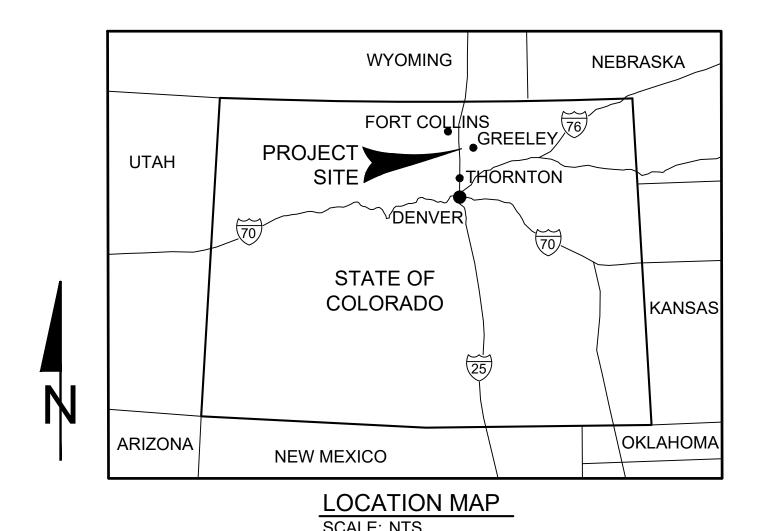

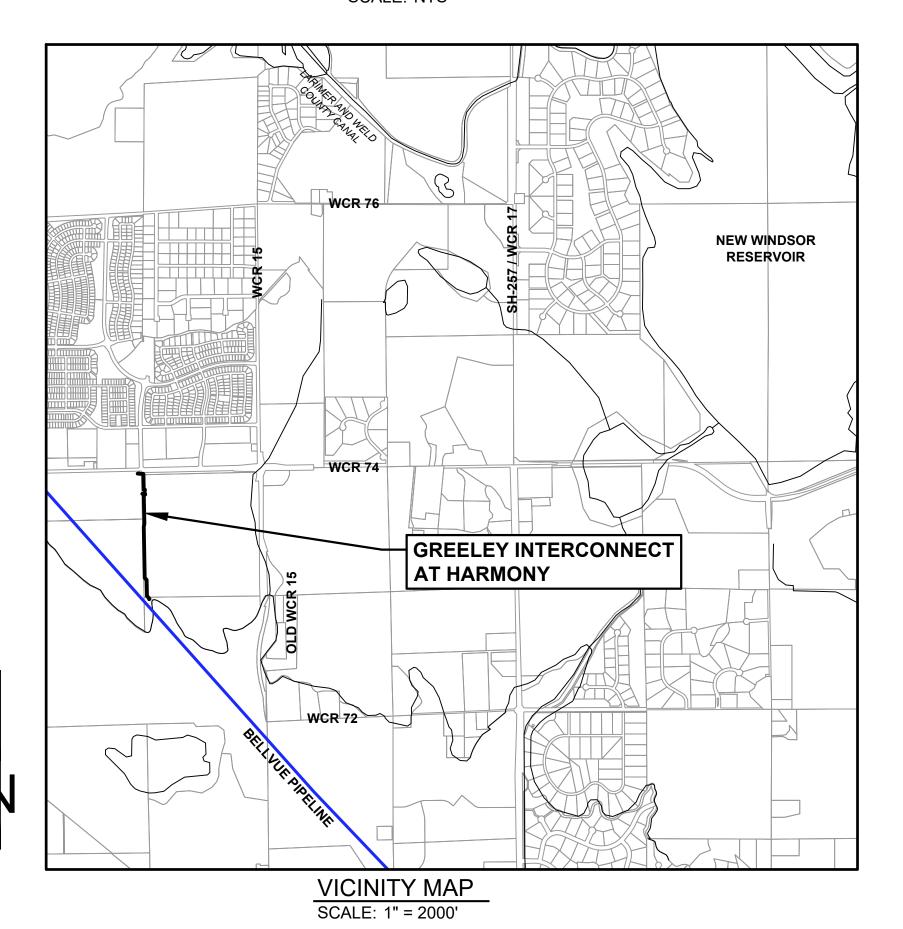

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1	G-001	COVER SHEET			
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PLAN AND PROFILE -	GREELEY TERRY	RANCH PIPELINE			
4	PP-001	PLAN AND PROFILE STA 100+00 TO STA 111+00			
5	PP-002	PLAN AND PROFILE STA 111+00 TO STA 122+00			
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CIVIL - GREELEY TERRY RANCH PIPELINE					
7	C-401	ENLARGED PLAN - BELLVUE PIPELINE CONNECTION			
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8	PP-101	PLAN AND PROFILE - STA 100+00 TO 100+75			
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CIVIL - NWCWD INTERCONNECT					
11	C-501	RISER DETAIL			

**IGA / PRICING SET NOT FOR CONSTRUCTION DECEMBER 28, 2022** 

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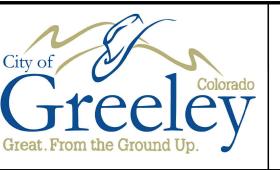
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NORTH WELD COUNTY WATER DISTRICT

**GREELEY INTERCONNECT** AT HARMONY

DESIGNED BY: **COVER SHEET** APPROVED BY: SHEET: 1 OF 11 G-001

## **GENERAL NOTES:**

- 1. PIPELINE STATIONING AND LENGTHS OF PIPE ARE BASED ON THE HORIZONTAL PROJECTION OF THE PIPE CENTERLINE AS SHOWN ON THE DRAWINGS.
- 2. UNLESS OTHERWISE INDICATED, PIPELINE DIAMETERS ARE FINISHED INSIDE DIAMETERS AFTER INSTALLATION OF CEMENT MORTAR LINING.
- 3. ALL PIPELINE ELEVATIONS ARE REFERENCED TO THE TOP OF THE PIPE UNLESS OTHERWISE
- 4. AT THE CLOSE OF EACH WORKING SHIFT, WHERE THE NEXT SHIFT WILL NOT IMMEDIATELY FOLLOW, PROTECT AND SECURE OPEN EXCAVATION.
- 5. LOCATIONS, ELEVATIONS, AND DIMENSIONS OF EXISTING UTILITIES, STRUCTURES, AND OTHER FEATURES ARE SHOWN ACCORDING TO THE BEST INFORMATION AVAILABLE AT THE TIME OF THE PREPARATION OF THESE DRAWINGS. BUT DO NOT PURPORT TO BE ABSOLUTELY CORRECT OR ACCURATE. THE CONTRACTOR SHALL VERIFY THE LOCATIONS, ELEVATIONS, AND DIMENSIONS OF ALL EXISTING UTILITIES, STRUCTURES, AND OTHER FEATURES AFFECTING THE WORK. SHOULD THE CONTRACTOR IDENTIFY ANY UTILITIES, STRUCTURES OR FEATURES NOT SHOWN ON THE PLANS, THE CONTRACTOR SHALL NOTIFY THE ENGINEER IMMEDIATELY
- 6. THE CONTRACTOR SHALL REVIEW THE SITE TO DETERMINE EXISTING CONDITIONS, ANYTHING NOT SHOWN ON THESE DRAWINGS SHALL BE BROUGHT TO THE ATTENTION OF THE ENGINEER IMMEDIATELY AND SHALL NOT CONSTITUTE AN EXTRA. UNLESS APPROVED BY THE ENGINEER.
- 7. CONTACT THE ENGINEER IMMEDIATELY OF ANY CONFLICTS ARISING DURING THE CONSTRUCTION OF ANY IMPROVEMENTS SHOWN ON THESE DRAWINGS.
- 8. TAKE ALL PRECAUTIONS NECESSARY TO PROTECT EXISTING FACILITIES. ALL SUCH IMPROVEMENTS OR STRUCTURES DAMAGED BY THE CONTRACTOR'S OPERATIONS SHALL BE IMMEDIATELY REPAIRED OR RECONSTRUCTED TO A NEW CONDITION AT THE CONTRACTOR'S EXPENSE.
- REMOVE, REPLACE, FLAG OR RELOCATE ALL OVERHEAD INTERFERENCE WHICH MAY AFFECT THE CONTRACTOR'S OPERATION DURING CONSTRUCTION. AVOID DAMAGE TO SAME. USE EXTREME CAUTION WHEN WORKING NEAR OVERHEAD OR UNDERGROUND POWER, GAS, OR OTHER UTILITIES TO SAFELY PROTECT ALL PERSONNEL AND EQUIPMENT. THE CONTRACTOR SHALL BE RESPONSIBLE FOR ALL COSTS AND LIABILITY IN CONNECTION WITH THIS WORK.
- 10. COORDINATE UNDERGROUND UTILITY MARKINGS WITH EXISTING UTILITIES BY CONTACTING THE UTILITY NOTIFICATION CENTER OF COLORADO (811 OR 1-800-922-1987) A MINIMUM OF 72 HOURS PRIOR TO CONSTRUCTION OR GROUND DISTURBANCE IN ORDER TO OBTAIN LOCATES.
- 11. ALL UTILITIES SHALL BE KEPT IN OPERATION EXCEPT WITH THE EXPRESS WRITTEN CONSENT OF THE UTILITY OWNER. IT IS THE CONTRACTOR'S RESPONSIBILITY TO PRESERVE EXISTING UTILITIES. ANY AND ALL DAMAGE TO EXISTING UTILITIES AS A RESULT OF THE CONTRACTOR'S ACTIONS, SHALL BE REPAIRED IMMEDIATELY AT THE CONTRACTOR'S EXPENSE.
- 12. PRESERVE ALL SURVEY MARKERS AND MONUMENTATION. THOSE REQUIRING REMOVAL SHALL BE REESTABLISHED BY A PROFESSIONAL LAND SURVEYOR IN ACCORDANCE WITH THE LOCAL GOVERNING AUTHORITY.
- 13. ALL SPECIFICATIONS, DRAWINGS, AND DETAILS INCLUDED IN THE CONTRACT DOCUMENTS SHALL FULLY APPLY TO THE WORK WHETHER SPECIFICALLY REFERENCED OR NOT.
- 14. LIMIT CONSTRUCTION OPERATIONS TO WITHIN THE RIGHT-OF-WAY AND EASEMENTS AND DESIGNATED WORK AREAS AS SHOWN. THE CONTRACTOR SHALL BE RESPONSIBLE FOR RESTORING THE AREA WITHIN THE CONSTRUCTION LIMITS TO A RESTORED CONDITION. CONSTRUCTION LIMITS ARE DELINEATED ON THE PLAN AND PROFILE DRAWINGS.
- 15. THE CONTRACTOR SHALL REPLACE ALL PAVING. STABILIZED EARTH, FENCES, DRIVEWAYS. SIDEWALKS, FIELD ROADS, ETC., WITH THE SAME TYPE OF MATERIAL THAT WAS REMOVED DURING CONSTRUCTION, AS DIRECTED BY THE ENGINEER, OR AS REFERENCED IN THE SPECIFICATIONS.
- 16. ALL BARRICADING AND TEMPORARY TRAFFIC CONTROL DEVICES OR METHODS USED DURING CONSTRUCTION SHALL BE IN ACCORDANCE WITH FEDERAL. STATE. AND LOCAL STANDARDS. SUBMIT TRAFFIC CONTROL PLAN TO APPLICABLE AGENCIES AS REQUIRED AND OBTAIN PERMITS PRIOR TO CLOSURE OR DISRUPTION OF ANY ROADS.
- 17. RESTORE ALL AREAS DISTURBED BY CONSTRUCTION ACTIVITIES PER SPECIFICATION SECTIONS 01 41 00 AND 32 90 10.
- 18. SEE SPECIFICATION SECTIONS 01 41 00 AND 02 01 20 FOR PERMITTING, UTILITY, AND COORDINATION REQUIREMENTS AND CONTACTS.
- 19. ALL FUGITIVE DUST SHALL BE CONTROLLED ON SITE. ONLY AREAS SCHEDULED FOR IMMEDIATE CONSTRUCTION SHALL BE CLEARED OR STRIPPED OF VEGETATION. CLEARING OF VEGETATION SHALL ONLY PRECEDE CONSTRUCTION BY A MAXIMUM OF 2,500 FEET. WATERING OR OTHER PRIOR APPROVED MEANS OF DUST CONTROL SHALL BE EMPLOYED TO PREVENT DUST FROM LEAVING THE SITE. PERMANENT GRASSING, LANDSCAPING AND OTHER RESTORATION WORK SHALL BE INCORPORATED WITHIN 2 WEEKS OF SURFICIAL SOIL REPLACEMENT DURING THE MONTHS OF MARCH, APRIL, SEPTEMBER, AND OCTOBER.
- 20. ALL TREES LOCATED ALONG THE CONSTRUCTION ROUTE ARE TO REMAIN AND SHALL BE PROTECTED DURING CONSTRUCTION, UNLESS REMOVAL IS SPECIFICALLY SHOWN AND APPROVED BY THE OWNER.

- 21. ALL AREAS SHALL BE GRADED AND LANDSCAPED, AS INDICATED ON THE DRAWINGS, IN ACCORDANCE WITH THE SPECIFICATIONS AND AS REQUIRED BY APPLICABLE PERMITS.
- 22. TRAFFIC CONTROL SHALL BE THE RESPONSIBILITY OF THE CONTRACTOR.
- 23. ACCESS TO ALL PROPERTIES SHALL BE MAINTAINED AT ALL TIMES FOR SUPPORT SERVICE BY EMERGENCY VEHICLES.
- 24. DIMENSIONS OF VALVES, FITTINGS, AND OTHER EQUIPMENT MAY VARY DEPENDING UPON MANUFACTURER. CONTRACTOR SHALL REVIEW SHOP DRAWINGS AND MAKE ANY NECESSARY ADJUSTMENTS BEFORE SETTING BASES, SUPPORTS, ETC.
- 25. ALL ALUMINUM SURFACES IN CONTACT WITH CONCRETE OR OTHER METALS SHALL HAVE A HEAVY BITUMASTIC COATING OR NEOPRENE INSULATING MATERIAL TO PREVENT CORROSION.
- 26. WHERE NECESSARY TO DEFLECT PIPE, EITHER HORIZONTALLY OR VERTICALLY, PIPE JOINT DEFLECTION SHALL NOT EXCEED 75% OF THE MANUFACTURERS RECOMMENDED DEFLECTION ANGLE. OR AS NOTED IN THE SPECIFICATIONS.
- 27. IN ACCORDANCE WITH THE GENERAL CONDITIONS AND GENERAL REQUIREMENTS SECTIONS OF THE CONTRACT DOCUMENTS, VIOLATION OF ANY AND ALL ENVIRONMENTAL REGULATIONS AND PERMIT CONDITIONS IS NOT PERMITTED AND WILL RESULT IN CONTRACTOR PAYMENT OF LIQUIDATED DAMAGES
- 28. EXCAVATION WITHIN ESTABLISHED LIMITS OF CONSTRUCTION SHALL BE ACCOMPLISHED BY STRIPPING THE EXISTING DEPTH OF TOPSOIL FROM THE FULL WIDTH OF THE AREA TO BE DISTURBED AND STOCKPILING THE SURFICIAL SOILS (TOPSOIL) SEPARATELY. THE REMAINING EXCAVATIONS NECESSARY FOR PIPE INSTALLATION SHALL BE TEMPORARILY PLACED ADJACENT TO THE PIPE TRENCH. THE EXCAVATED MATERIAL THAT WILL NOT BE REUSED FOR BACKFILL SHALL BE STOCKPILED SEPARATELY FROM SURFICIAL SOILS OUTSIDE OF JURISDICTIONAL AREAS A MINIMUM DISTANCE OF 200 FEET FROM A WETLAND. BACKFILLING OPERATIONS SHALL PROCEED SUCH THAT SURFICIAL SOILS WILL BE REPLACED LAST AND SHALL BE SPREAD ACROSS THE ENTIRE DISTURBED AREA TO HELP PROMOTE NATIVE VEGETATIVE GROWTH. SURFICIAL SOILS SHALL NOT BE LEFT STOCKPILED IN EXCESS OF TWO WEEKS. FINE GRADING AND THE REPLACEMENT OF TOPSOIL SHALL OCCUR IMMEDIATELY AND SHALL NOT LAG CONSTRUCTION BY MORE THAN 500 FEET. ALL WETLAND CROSSINGS THAT ARE DISTURBED DURING CONSTRUCTION. SHALL HAVE AN ADEQUATE AMOUNT OF FILL REMOVED SO THAT THE WETLAND IS RESTORED TO THE ORIGINAL LINE. GRADE. AND CROSS-SECTION AS INDICATED BY THESE DRAWINGS.
- 29. ALL DELETERIOUS SUBSURFACE MATERIAL, E.G., MUCK, PEAT, BURIED DEBRIS, SHALL BE EXCAVATED IN ACCORDANCE WITH THE PLANS AND SPECIFICATIONS, OR AS DIRECTED BY THE ENGINEER. DELETERIOUS MATERIAL IS TO BE REMOVED FROM THE SITE IMMEDIATELY AND PROPERLY DISPOSED OF AT THE CONTRACTOR'S EXPENSE. EXCAVATED AREAS ARE TO BE BACKFILLED WITH APPROVED MATERIALS AND COMPACTED AS SHOWN ON THESE PLANS.
- 30. PROTECT EXCAVATIONS AGAINST COLLAPSE AND PROVIDE BRACING, SHEETING, OR SHORING AS NECESSARY. TRENCHES SHALL BE KEPT COMPLETELY DRY WHILE PIPE AND APPURTENANCES ARE BEING PLACED PER SPECIFICATION SECTION 31 23 43. CONTRACTOR SHALL BE RESPONSIBLE FOR DEWATERING AND PERMITTING OF DISCHARGE FLOWS IN ACCORDANCE WITH THE SPECIFICATIONS.
- 31. PROVIDE A  $\frac{3}{4}$ " TO 1" BITUMINOUS EXPANSION JOINT MATERIAL WITH SEALER AT ABUTMENT OF CONCRETE AND OTHER MATERIALS (ASPHALT, BUILDING, OTHER POURED CONCRETE, ETC.)
- 32. TRIM. TACK, AND MATCH EXISTING PAVEMENT AT LOCATIONS WHERE NEW PAVEMENT IS TO BE INSTALLED.
- 33. PROVIDE EROSION CONTROL/SEDIMENTATION BARRIER (SILT FENCE) WHERE INDICATED ON THE EROSION AND SEDIMENT CONTROL DRAWINGS TO PREVENT SILT FROM MIGRATING TO ADJACENT PROPERTIES, STREETS, STORM SEWERS AND WATERWAYS. IN ADDITION, CONTRACTOR SHALL PLACE AND MAINTAIN TRACKING CONTROL PADS AT ALL LOCATIONS WHERE CONSTRUCTION RELATED TRAFFIC IS TO ENTER AND EXIT THE SITE.

**IGA / PRICING SET** NOT FOR CONSTRUCTION **DECEMBER 28, 2022** 

PROVIDENCE INFRASTRUCTURE CONSULTANTS 300 PLAZA DR., SUITE 320 HIGHLANDS RANCH, CO 80129

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NORTH WELD COUNTY WATER DISTRICT


**GREELEY INTERCONNECT** AT HARMONY

GENERAL NOTES

PROJECT: 220002 DRAWN BY B. BOHI DESIGNED BY: D. PYTLI APPROVED BY: D. PYTLIK SHEET: 2 OF 11

G-002 DRAWING:

1775 E 69TH AVE DENVER, CO 80229 (303) 287-7700 www.reynoldscon.com

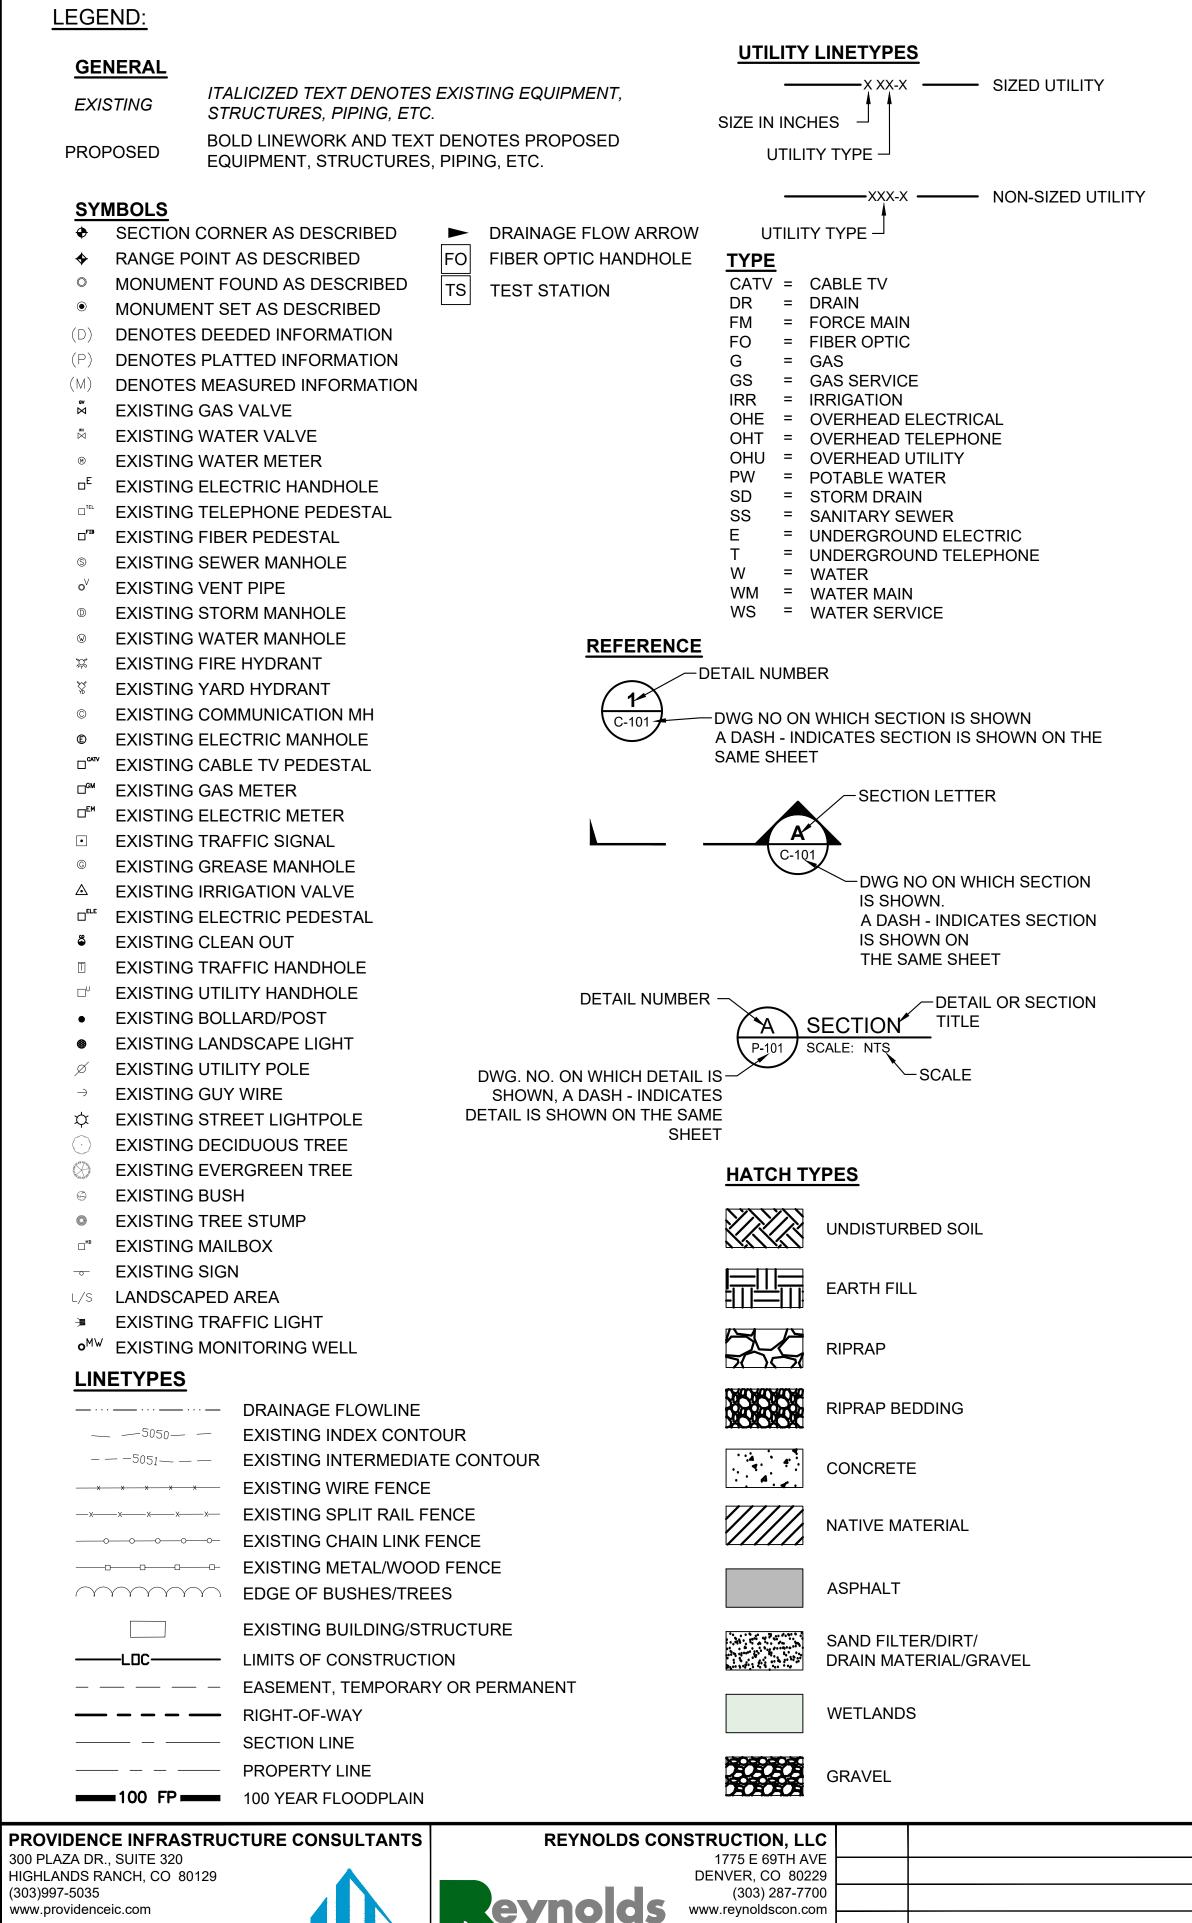

## **ABBREVIATIONS:** ACP ACS ALUM APX, APPROX ASSY AWG AWWA B, BOT ВО BFLY BFV BLK ВМР CARV CATV CDOT CB CL CTL CLSM CMP COMM CONC CONN CONST CONT COG CPLG CPP CYL DI DIA, Ø DIP DNF DNPH DR DTL DWLJ ECMP EL, ELEV ELEC ESC EXT FLG'D GALV GBR GDR **HCBO**

ASPHALT CONCRETE, ACRE

ASBESTOS CEMENT PIPE

AMERICAN WIRE GAUGE

AMERICAN WATER WORKS ASSOCIATION

ACCESS

ALTERNATE

ALUMINUM

ASSEMBLY

BOTTOM

**BLOWOFF** 

BLIND FLANGE

**BUTTERFLY VALVE** 

**CROSSING BORING** 

COMMUNICATION

CONCRETE

REVISED BY

CONNECTION

CONSTRUCTION

CITY OF GREELEY

CORRUGATED METAL PIPE

CONTINUOUS, CONTINUATION

BEST MANAGEMENT PRACTICE

COMBINATION AIR/VACCUUM VALVE ASSEMBLY

CTL THOMPSON (GEOTECHNICAL ENGINEERING FIRM)

COLORADO DEPT. OF TRANSPORTATION

CONTROLLED LOW STRENGTH MATERIAL

CONTROL POINT, CATHODIC PROTECTION

BUTTERFLY

BORE HOLE

BLOCK

CABLE TV

CAST IRON CENTERLINE

APPROXIMATE

	COUPLING			
			PC	
_	CORRUGATED PLASTIC PIPE		PE	
	CYLINDER		PL	
	DUCTILE IRON		PR'	V
	DIAMETER		PSI	
	DUCTILE IRON PIPE		PV	C
	DID NOT FIND		PVI	
	DID NOT POTHOLE		PW	1
	DRIVE, DRAIN		R	
	DETAIL		R/V	V, ROW
	DOUBLE WELDED LAP JOINT		RC	P
	EAST, EASTING, ELECTRIC		RE	INF
	EACH		RE	Q'D
	EROSION CONTROL		RH	W
	EROSION CONTROL BLANKET		RPI	MP
	ELLIPTICAL CORRUGATED META	AL PIPE	RR	
	ELEVATION		RW	1
	ELECTRIC		S	
	EQUAL		SD	
	EROSION & SEDIMENTATION CO	NTROL	SH	
	EXISTING		SIM	1
	EXTENSION		SPI	EC
	FIELD BORING		SQ	
	FLANGE INSULATING KIT		SS,	, SAN
	FLOW LINE, FLANGE		ST	
	FLANGED		STA	4
	FORCE MAIN		STI	D
	FIBER OPTIC		STI	L
	FIBERGLASS REINFORCED PLAS	STIC	STI	М
	FOOT, FEET		ST	RUCT
	GAS		SW	/LJ
	GAUGE		SW	/MP
	GALVANIZED		sw	/R
	GEOTECHNICAL BASELINE REPO	ORT	SY	
	GEOTECHNICAL DATA REPORT		t	
	GAS SERVICE		Т	
	GATE VALVE		T/	
	GROUNDWATER		TCI	E
	HIGH CAPACITY BLOW OFF		TEI	L
	HEAVY DUTY		TE	MP
	CO ESTABLISHED 1962 S.A.	City of Colored Colore	Vorado	VERIFY SCALE  BAR IS ONE INCH ON ORIGINAL DRAWING  IF NOT ONE INCH ON THIS SHEET, ADJUST SCALES ACCORDINGLY

HDPE

HGL

HWY		GHWAY
D		SIDE DIAMETER
N	ING	
NV		/ERT
RR	IRI	RIGATION
JTS	JO	INTS
_	LE	NGTH
_B/LBS	PC	UND(S)
_D	LIC	SHT DUTY
_F	LIN	IEAR/LINEAL FOOT/FEET
_OC	LIN	MITS OF CONSTRUCTION
MAX	MA	XIMUM
MFR	MA	NUFACTURER
МН	MA	NHOLE
MIN	MI	NIMUM
MJ		CHANICAL JOINT
MW		DNITORING WELL (GROUNDWATER), MANWAY
N		PRTH, NORTHING
NGS		TIONAL GEODETIC SURVEY
VIC		OT IN CONTRACT
NOM 		MINAL
NPT		TIONAL PIPE THREAD
NTS		OT TO SCALE
OC		I CENTER
OD		ITSIDE DIAMETER
OHE OUT		ERHEAD ELECTRIC
OHT OHU		ERHEAD TELEPHONE
OHU ORNG		ERHEAD UTILITY
OPNG OPR		PENING PERATOR
OZ		INCE
<u>Э</u> РВ		PELINE BORING
ъс 		ESSURE CLASS
 PE		RMANENT EASEMENT
 PL		OPERTY LINE, PLATE
- PRV		ESSURE REDUCING VALVE
PSI	PC	UNDS PER SQUARE INCH
PVC	PC	LYVINYL CHLORIDE
PVI	PC	INT OF VERTICAL INTERSECTION
ΡW	PC	TABLE WATER
₹	RA	DIUS
R/W, ROW	RIG	GHT OF WAY
RCP	RE	INFORCED CONCRETE PIPE
REINF	RE	INFORCED/REINFORCEMENT
REQ'D	RE	QUIRED
RHW	WI	RE INSULATION (MOISTURE RESISTANT)
RPMP	RE	INFORCED PLASTIC MORTAR PIPE
RR	RA	ILROAD
RW	RE	SILIENT WEDGE
3	SC	UTH
SD		ORM DRAIN
SH		ATE HIGHWAY
SIM		MILAR
SPEC		ECIFICATION
SQ 0411		UARE
SS, SAN		NITARY SEWER
STA		ATION
STA		ATION
STD		ANDARD
STL STM		EEL ORM
STRUCT		
SWLJ		RUCTURE  NGLE WELDED LAP JOINT
SWMP		ORMWATER MANAGEMENT PLAN
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		NORTH WELD COUNTY
VERIFY	'SCALE	WATER DISTRICT

HIGH DENSITY POLYETHYLENE

HYDRAULIC GRADE LINE

TH	TEST HOLE (SOIL BORING)		
	· · · · · · · · · · · · · · · · · · ·		
TYP	TYPICAL		
UG	UNDERGROUND		
VCP	VITRIFIED CLAY PIPE		
VERT	VERTICAL		
W, WTR	WEST, WATER		
W/	WITH		
WCR	WELD COUNTY ROAD		
WE	WATERLINE EASEMENT		
WM	WATER MAIN		
WL	WATER LINE		
WPA	WORK PACKAGE A		
WS	WATER SERVICE		
WSP	WELDED STEEL PIPE		
WT	WEIGHT		
WWF	WELDED WIRE FABRIC		

**IGA / PRICING SET NOT FOR CONSTRUCTION DECEMBER 28, 2022** 

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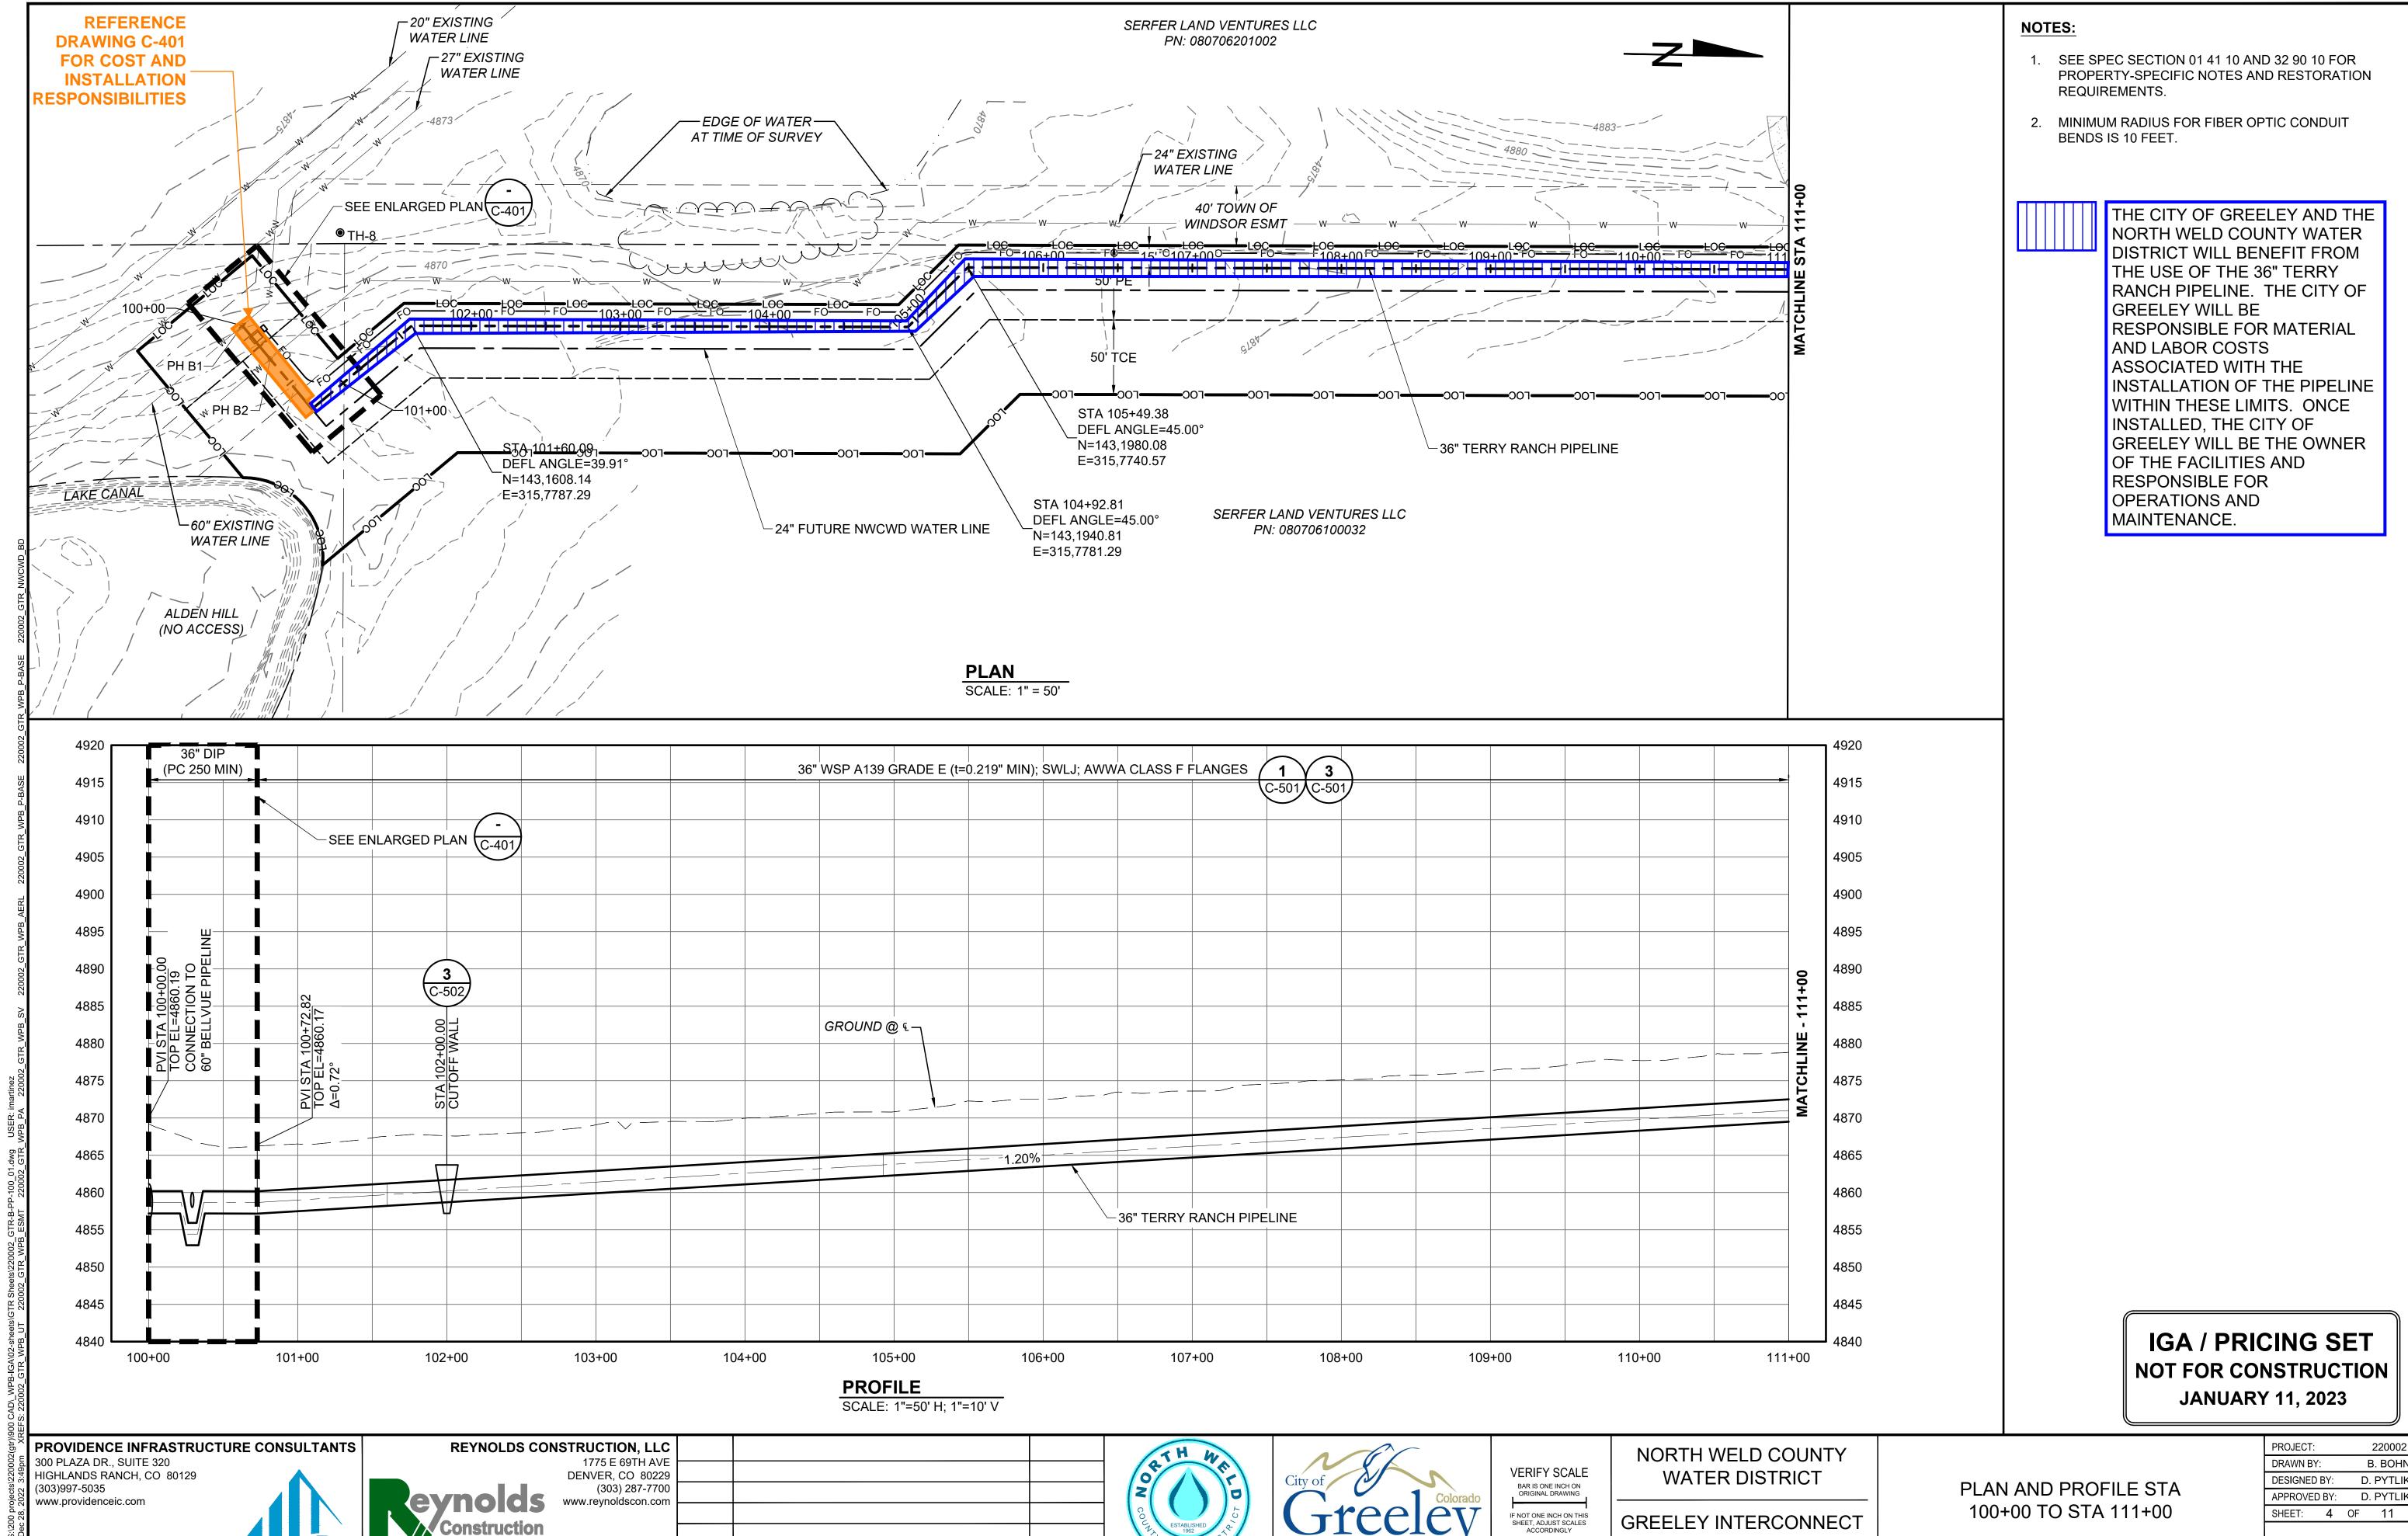
WATER DISTRICT

**GREELEY INTERCONNECT** AT HARMONY

SYMBOLS AND ABBREVIATIONS

PROJECT: DRAWN BY B. BOHI **DESIGNED BY:** D. PYTLI APPROVED BY: D. PYTLIK SHEET: 3 OF 11 G-003

DRAWING:



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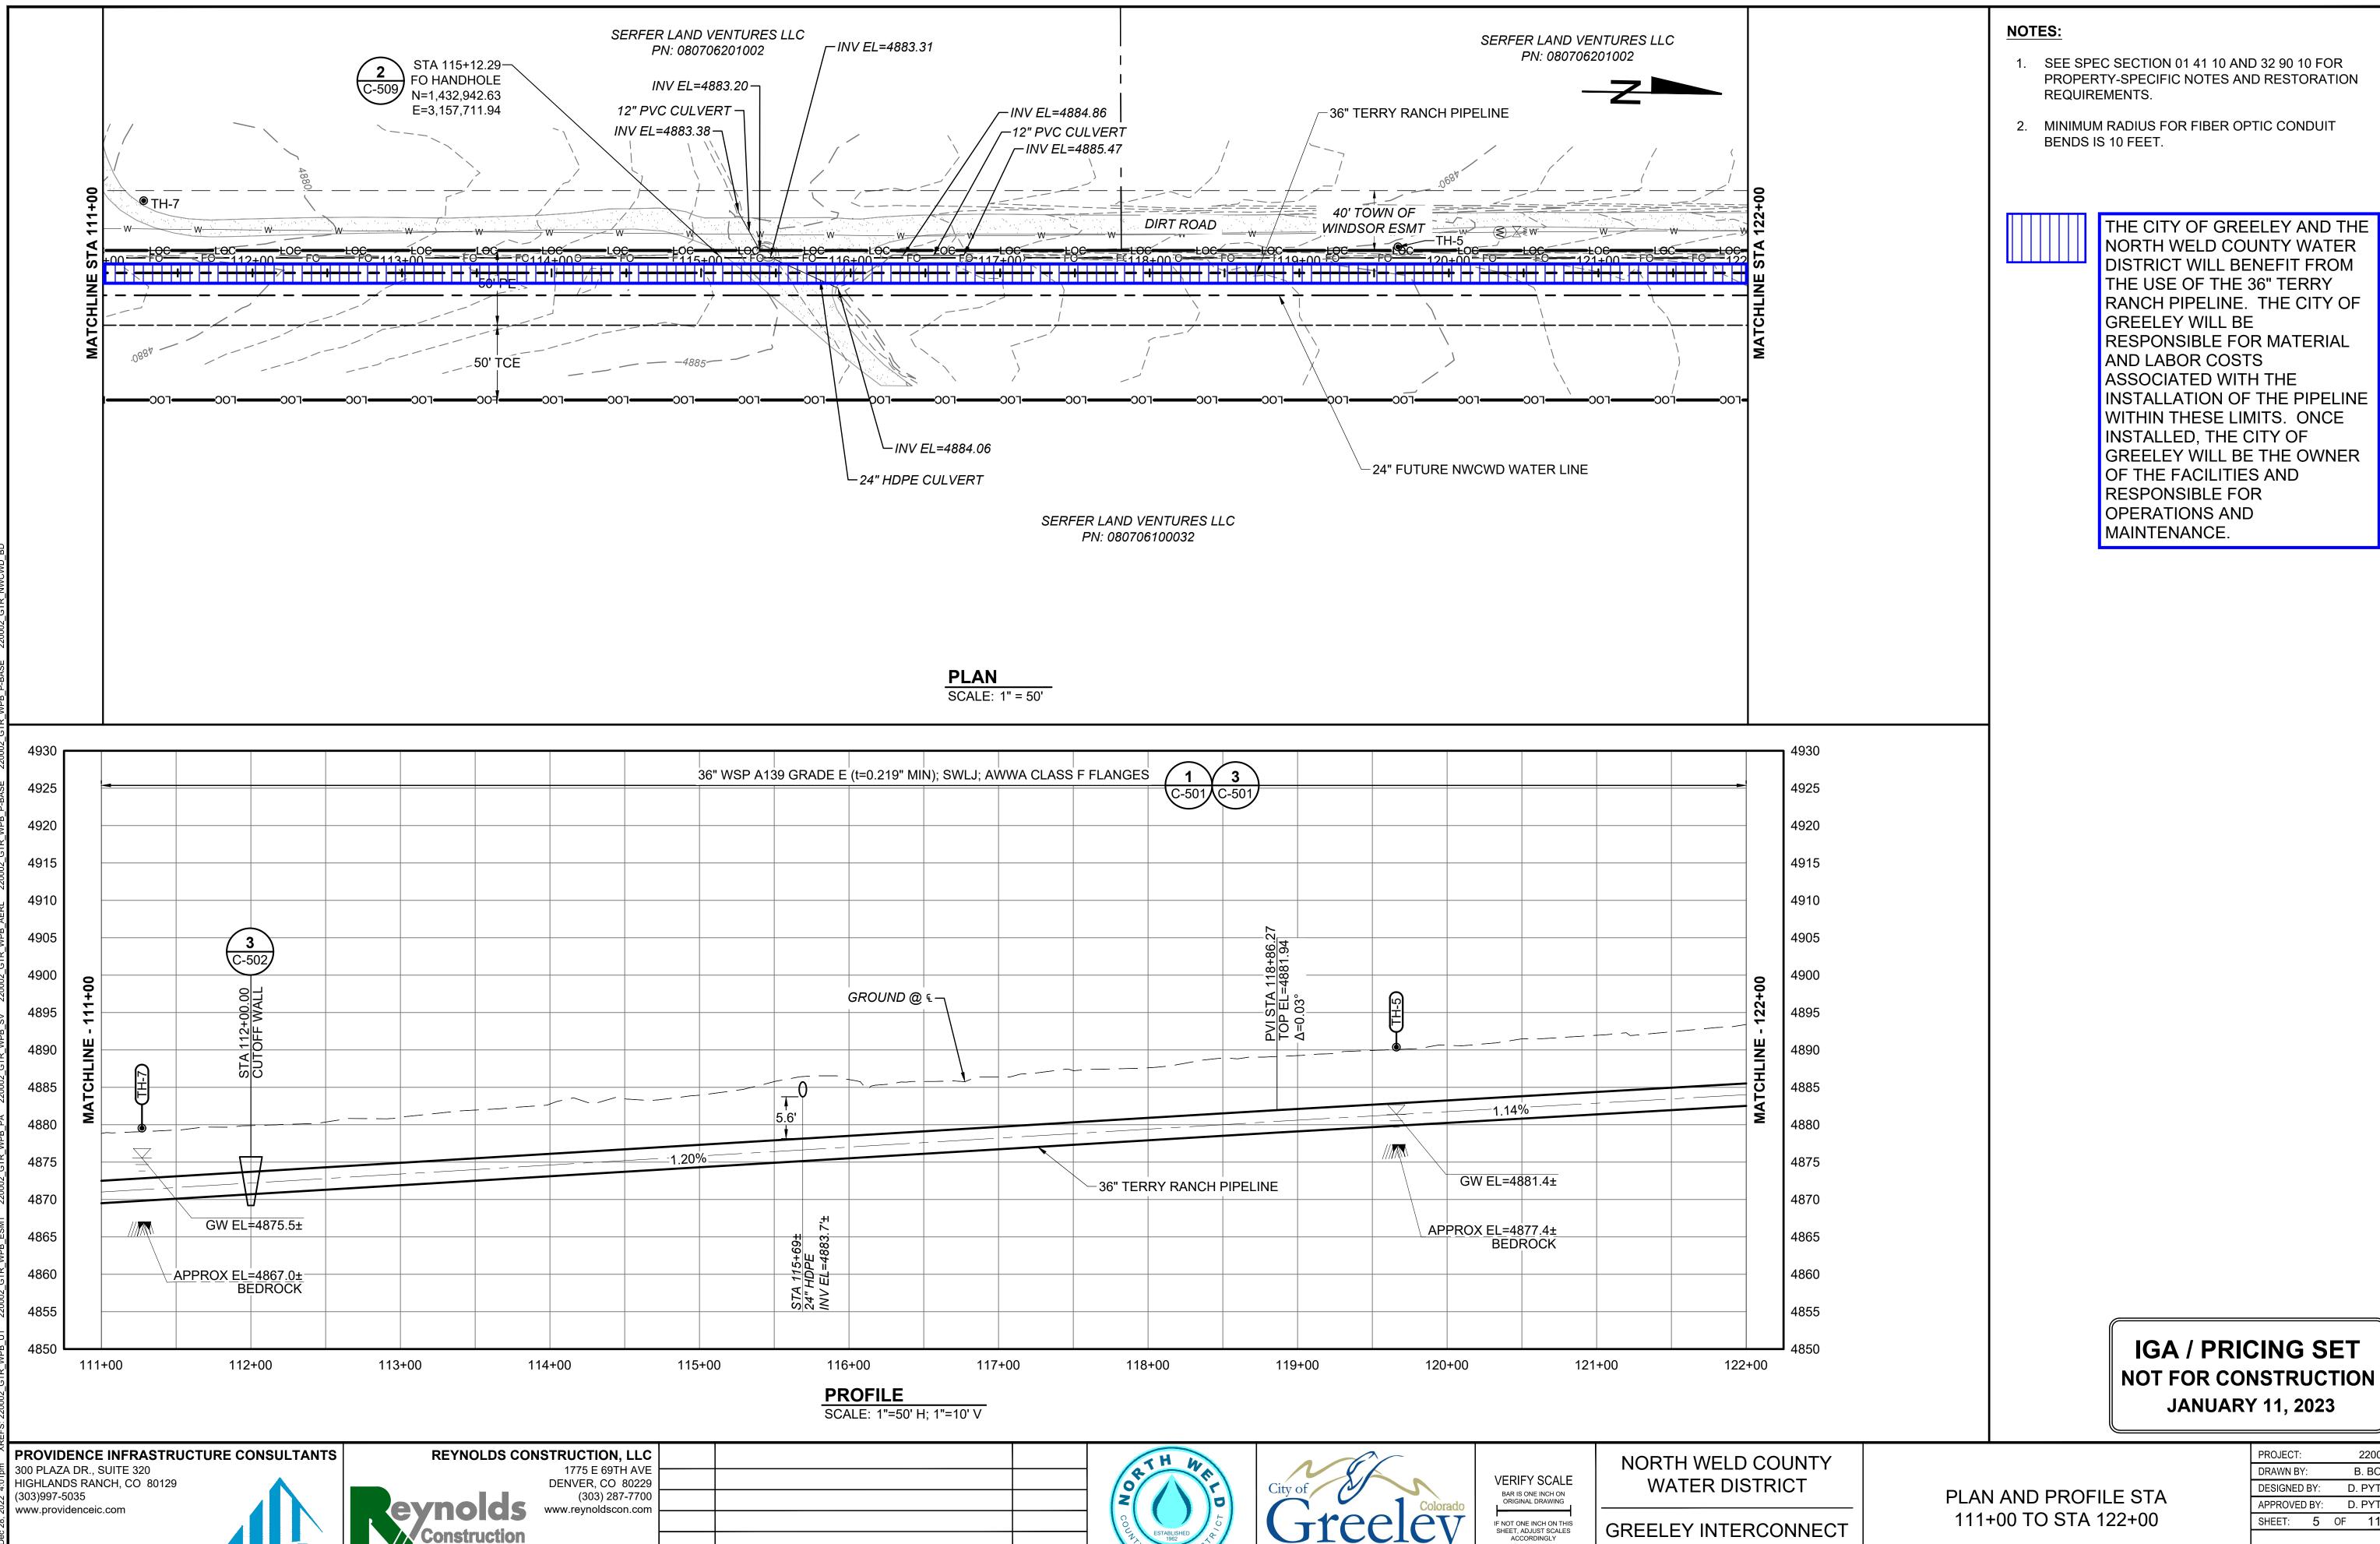
REVISION

**REVISED BY** 

D. PYTLIK

DRAWING: PP-001

AT HARMONY



REVISION


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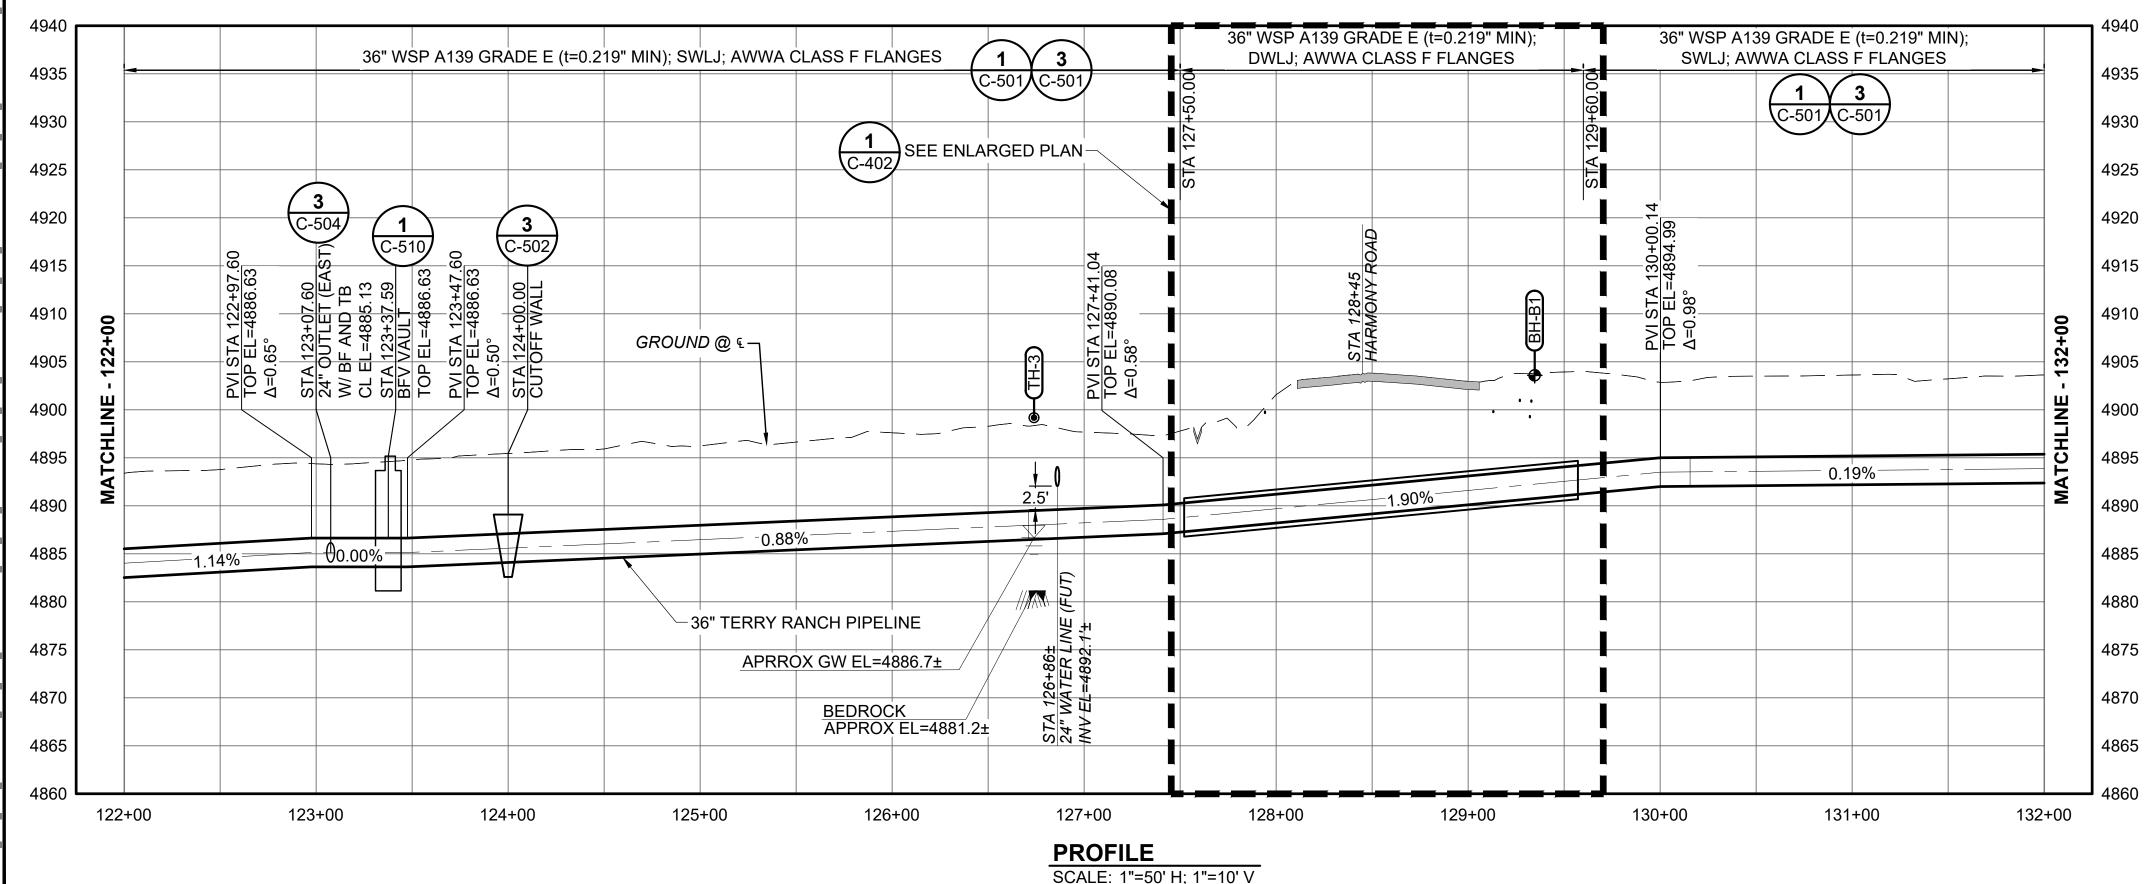
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PROJECT: 220002 DRAWN BY: B. BOHI DESIGNED BY: D. PYTLII D. PYTLIK APPROVED BY: SHEET: 5 OF 11

DRAWING: PP-002


AT HARMONY



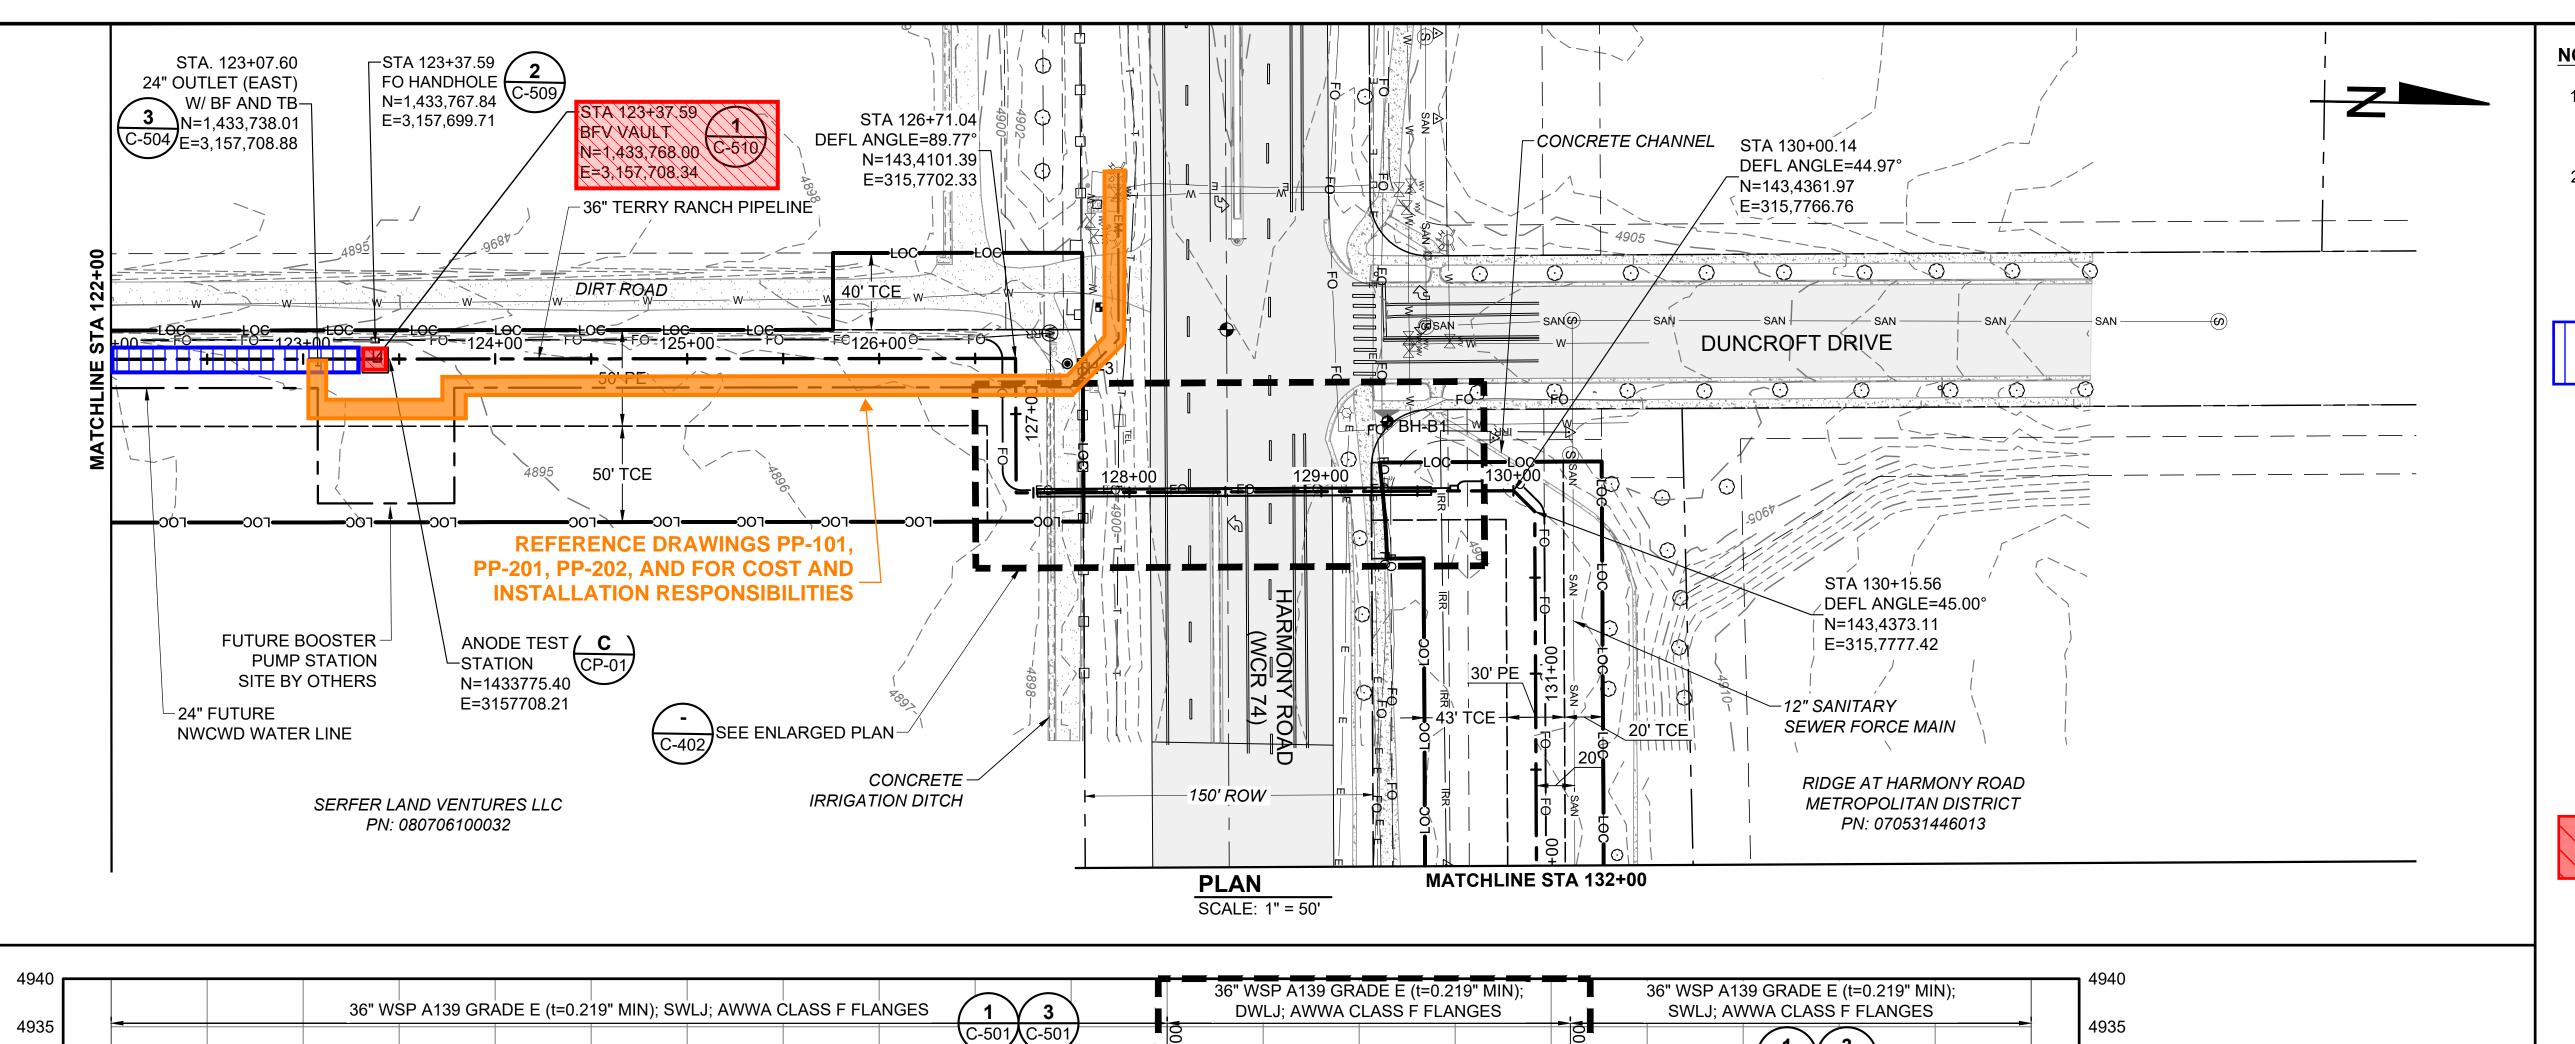

**NOTES:** 

- SEE SPEC SECTION 01 41 10 AND 32 90 10 FOR PROPERTY-SPECIFIC NOTES AND RESTORATION REQUIREMENTS.
- 2. MINIMUM RADIUS FOR FIBER OPTIC CONDUIT BENDS IS 10 FEET.

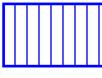

THE CITY OF GREELEY AND THE NORTH WELD COUNTY WATER DISTRICT WILL BENEFIT FROM THE USE OF THE 36" TERRY RANCH PIPELINE. THE CITY OF GREELEY WILL BE RESPONSIBLE FOR MATERIAL AND LABOR COSTS ASSOCIATED WITH THE INSTALLATION OF THE PIPELINE WITHIN THESE LIMITS. ONCE INSTALLED, THE CITY OF GREELEY WILL BE THE OWNER OF THE FACILITIES AND RESPONSIBLE FOR OPERATIONS AND MAINTENANCE.



NORTH WELD COUNTY WATER DISTRICT WILL BE RESPONSIBLE FOR REIMBURSING THE CITY OF GREELEY FOR THE COSTS ASSOCIATED WITH MATERIALS AND INSTALLATION OF THE BUTTERFLY VAULT ON THE TERRY RANCH PIPELINE AS THE FACILITY IS NEEDED TO DIRECT FLOW TO NORTH WELD COUNTY WATER DISTRICT'S INTERCONNECT INFRASTRUCTURE. THE MATERIALS PROCUREMENT AND INSTALLATION LABOR ASSOCIATED WITH THIS VAUL WILL BE PROVIDED BY REYNOLDS CONSTRUCTION. ONCE INSTALLED, THE CITY OF GREELEY WILL BE THE OWNER OF THE FACILITIES AND RESPONSIBLE FOR OPERATIONS AND MAINTENANCE.

**IGA / PRICING SET** NOT FOR CONSTRUCTION **JANUARY 11, 2023** 

PROVIDENCE INFRASTRUCTURE CONSULTANTS 300 PLAZA DR., SUITE 320

HIGHLANDS RANCH, CO 80129 (303)997-5035 www.providenceic.com



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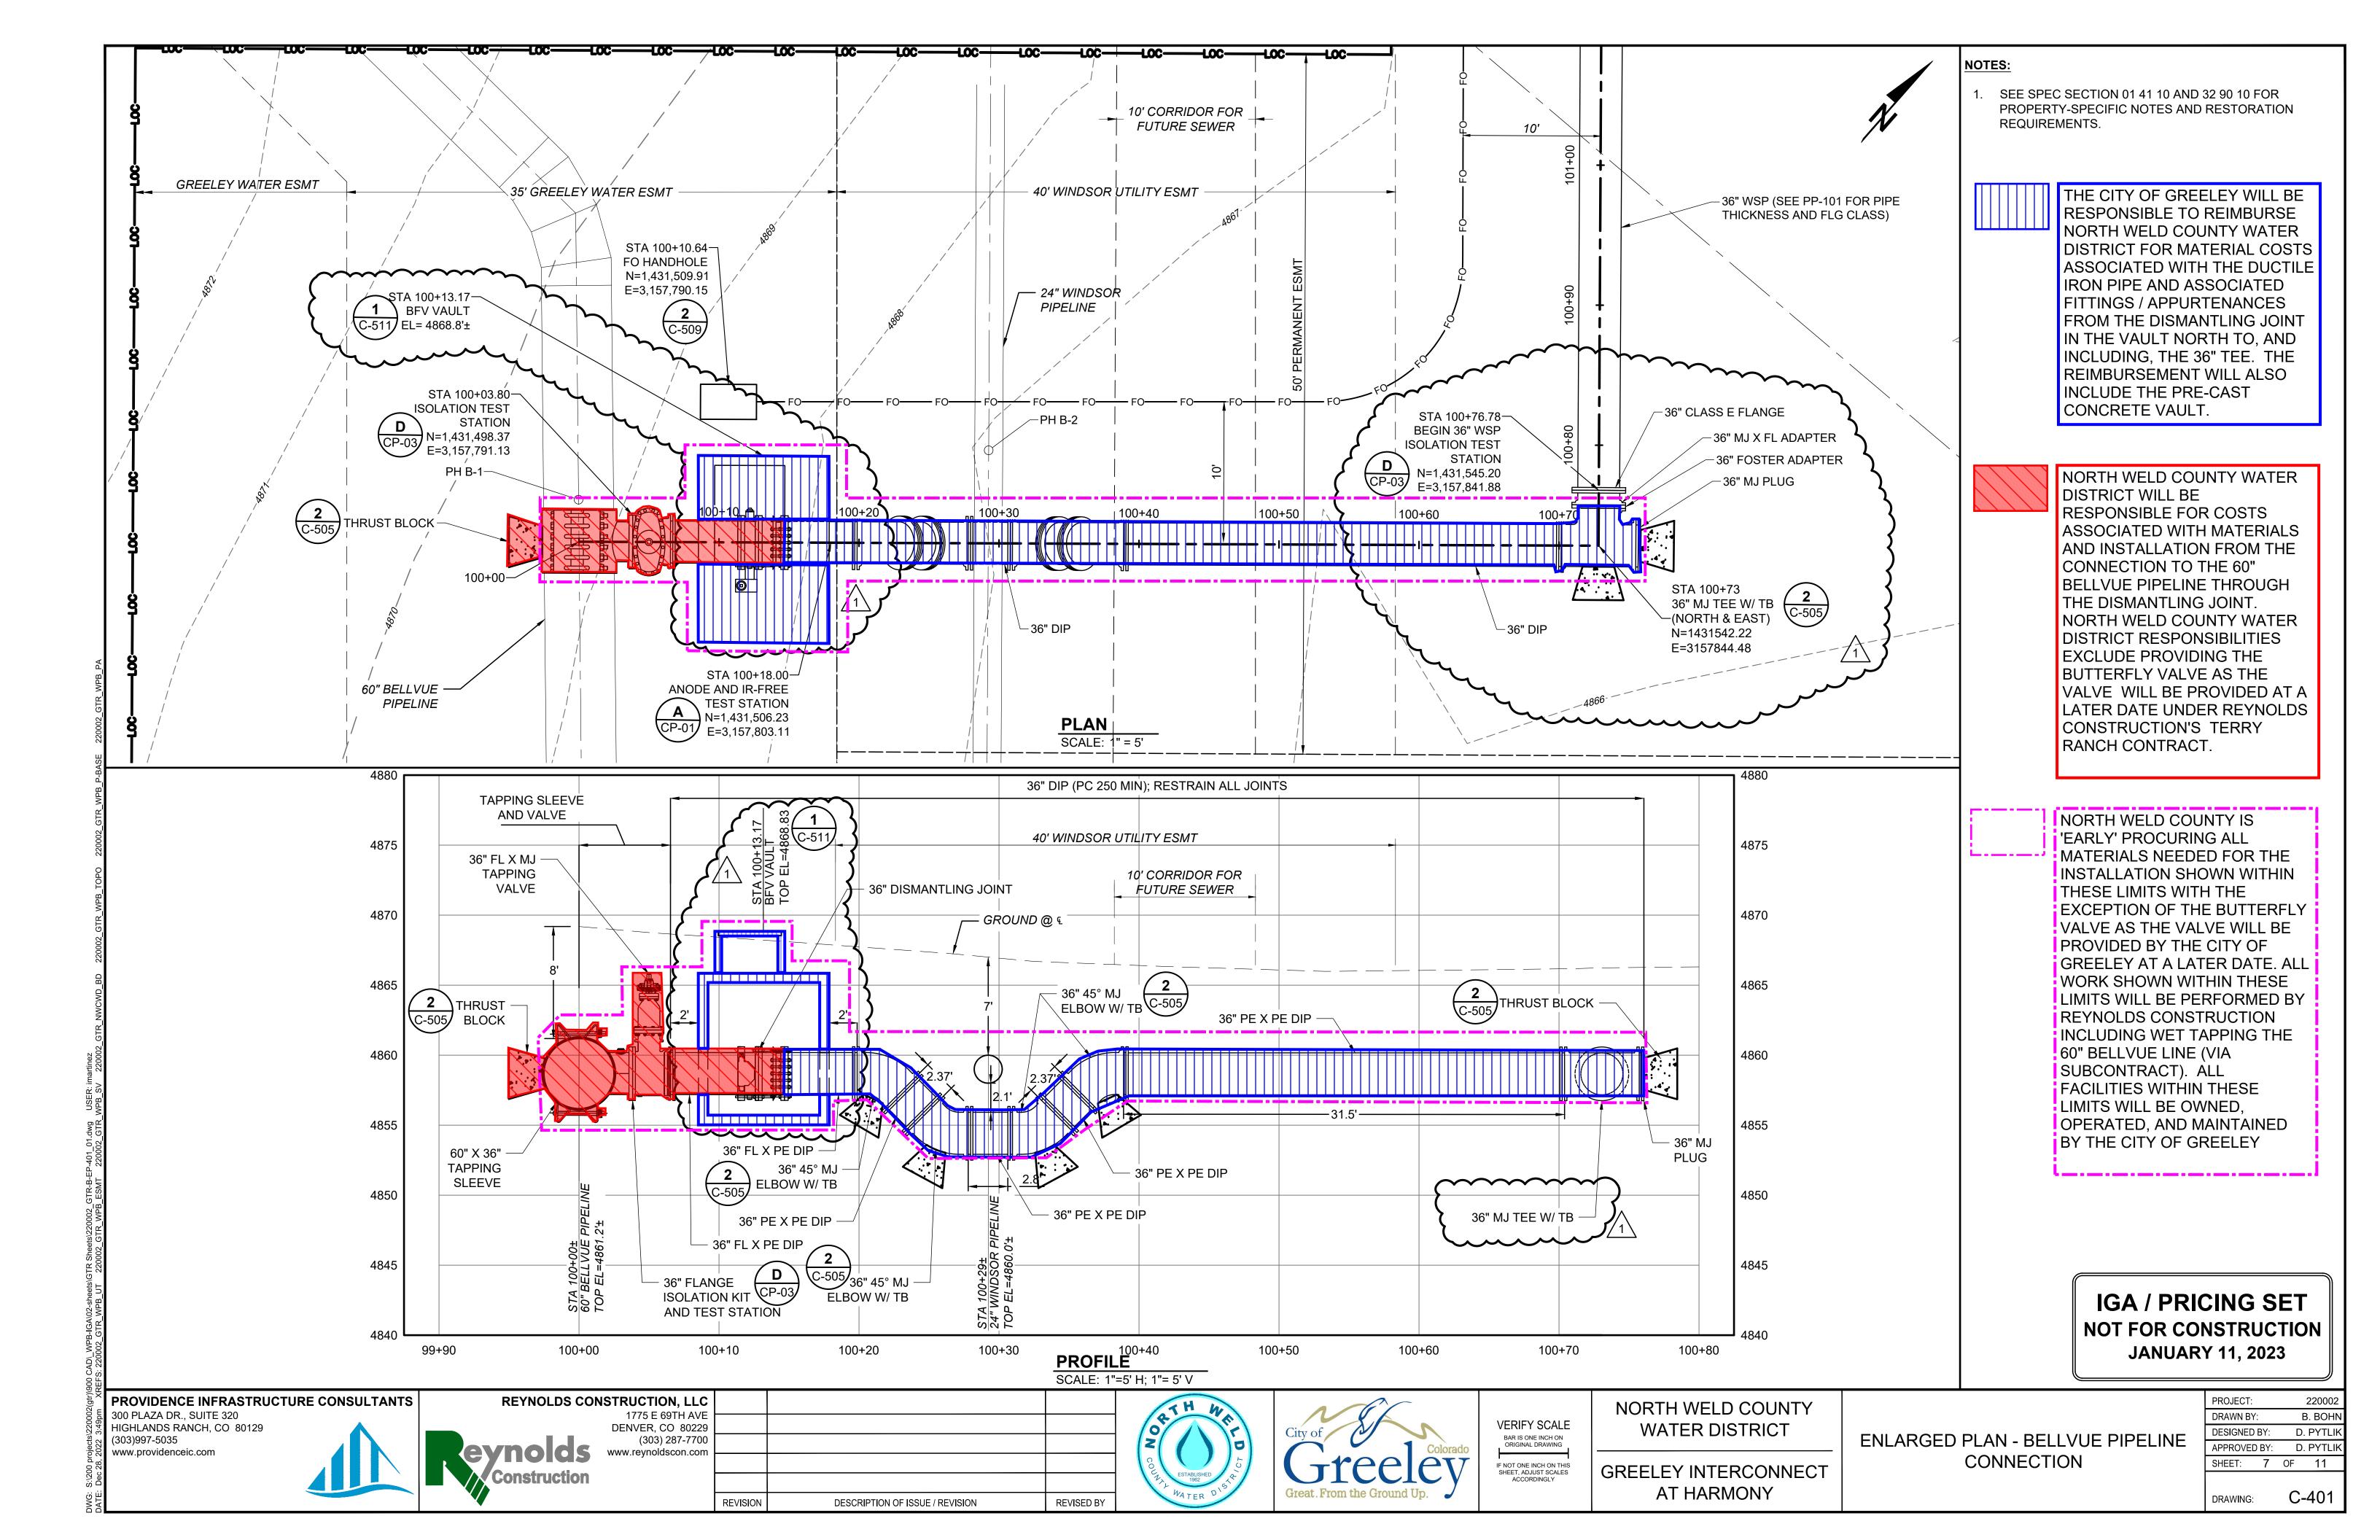
NORTH WELD COUNTY WATER DISTRICT


**GREELEY INTERCONNECT** AT HARMONY

PLAN AND PROFILE STA 122+00 TO STA 132+00

PROJECT:	220002			
DRAWN B	B. BOHN		1	
DESIGNED BY:		D	. PYTLIŁ	<
APPROVE	D BY:	D	. PYTLIŁ	<
SHEET:	6	OF	11	

DRAWING: PP-003



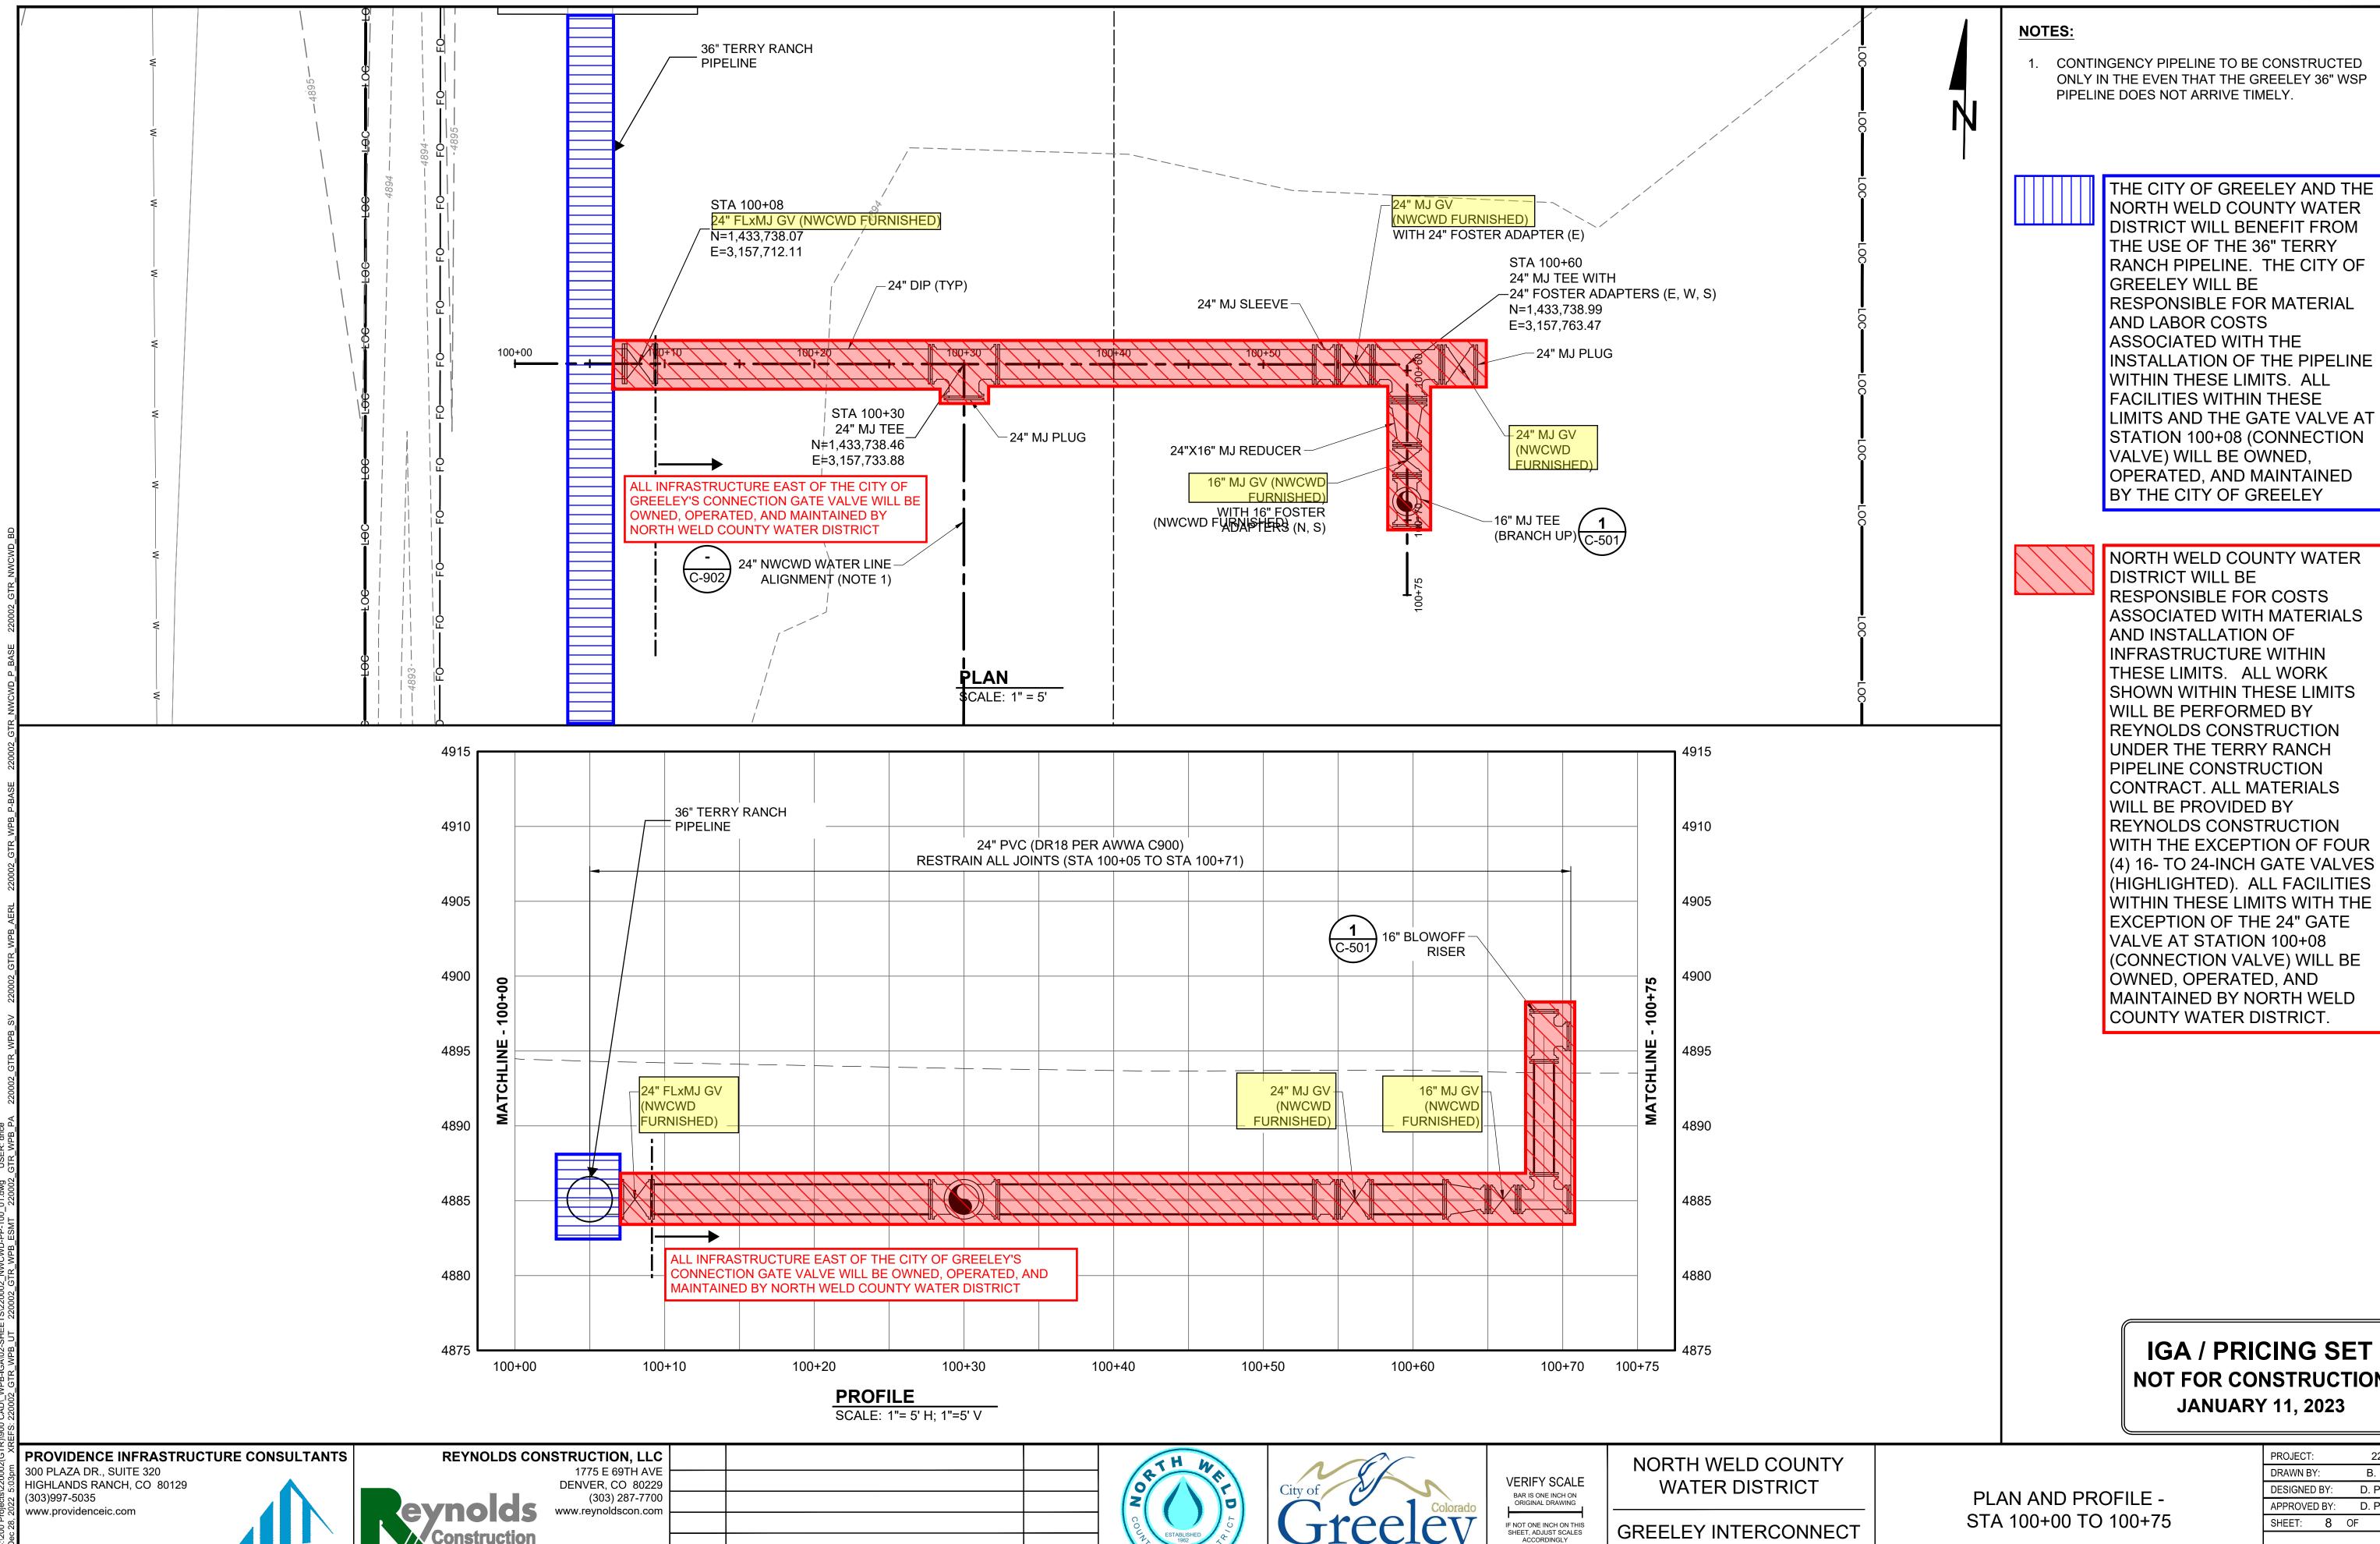

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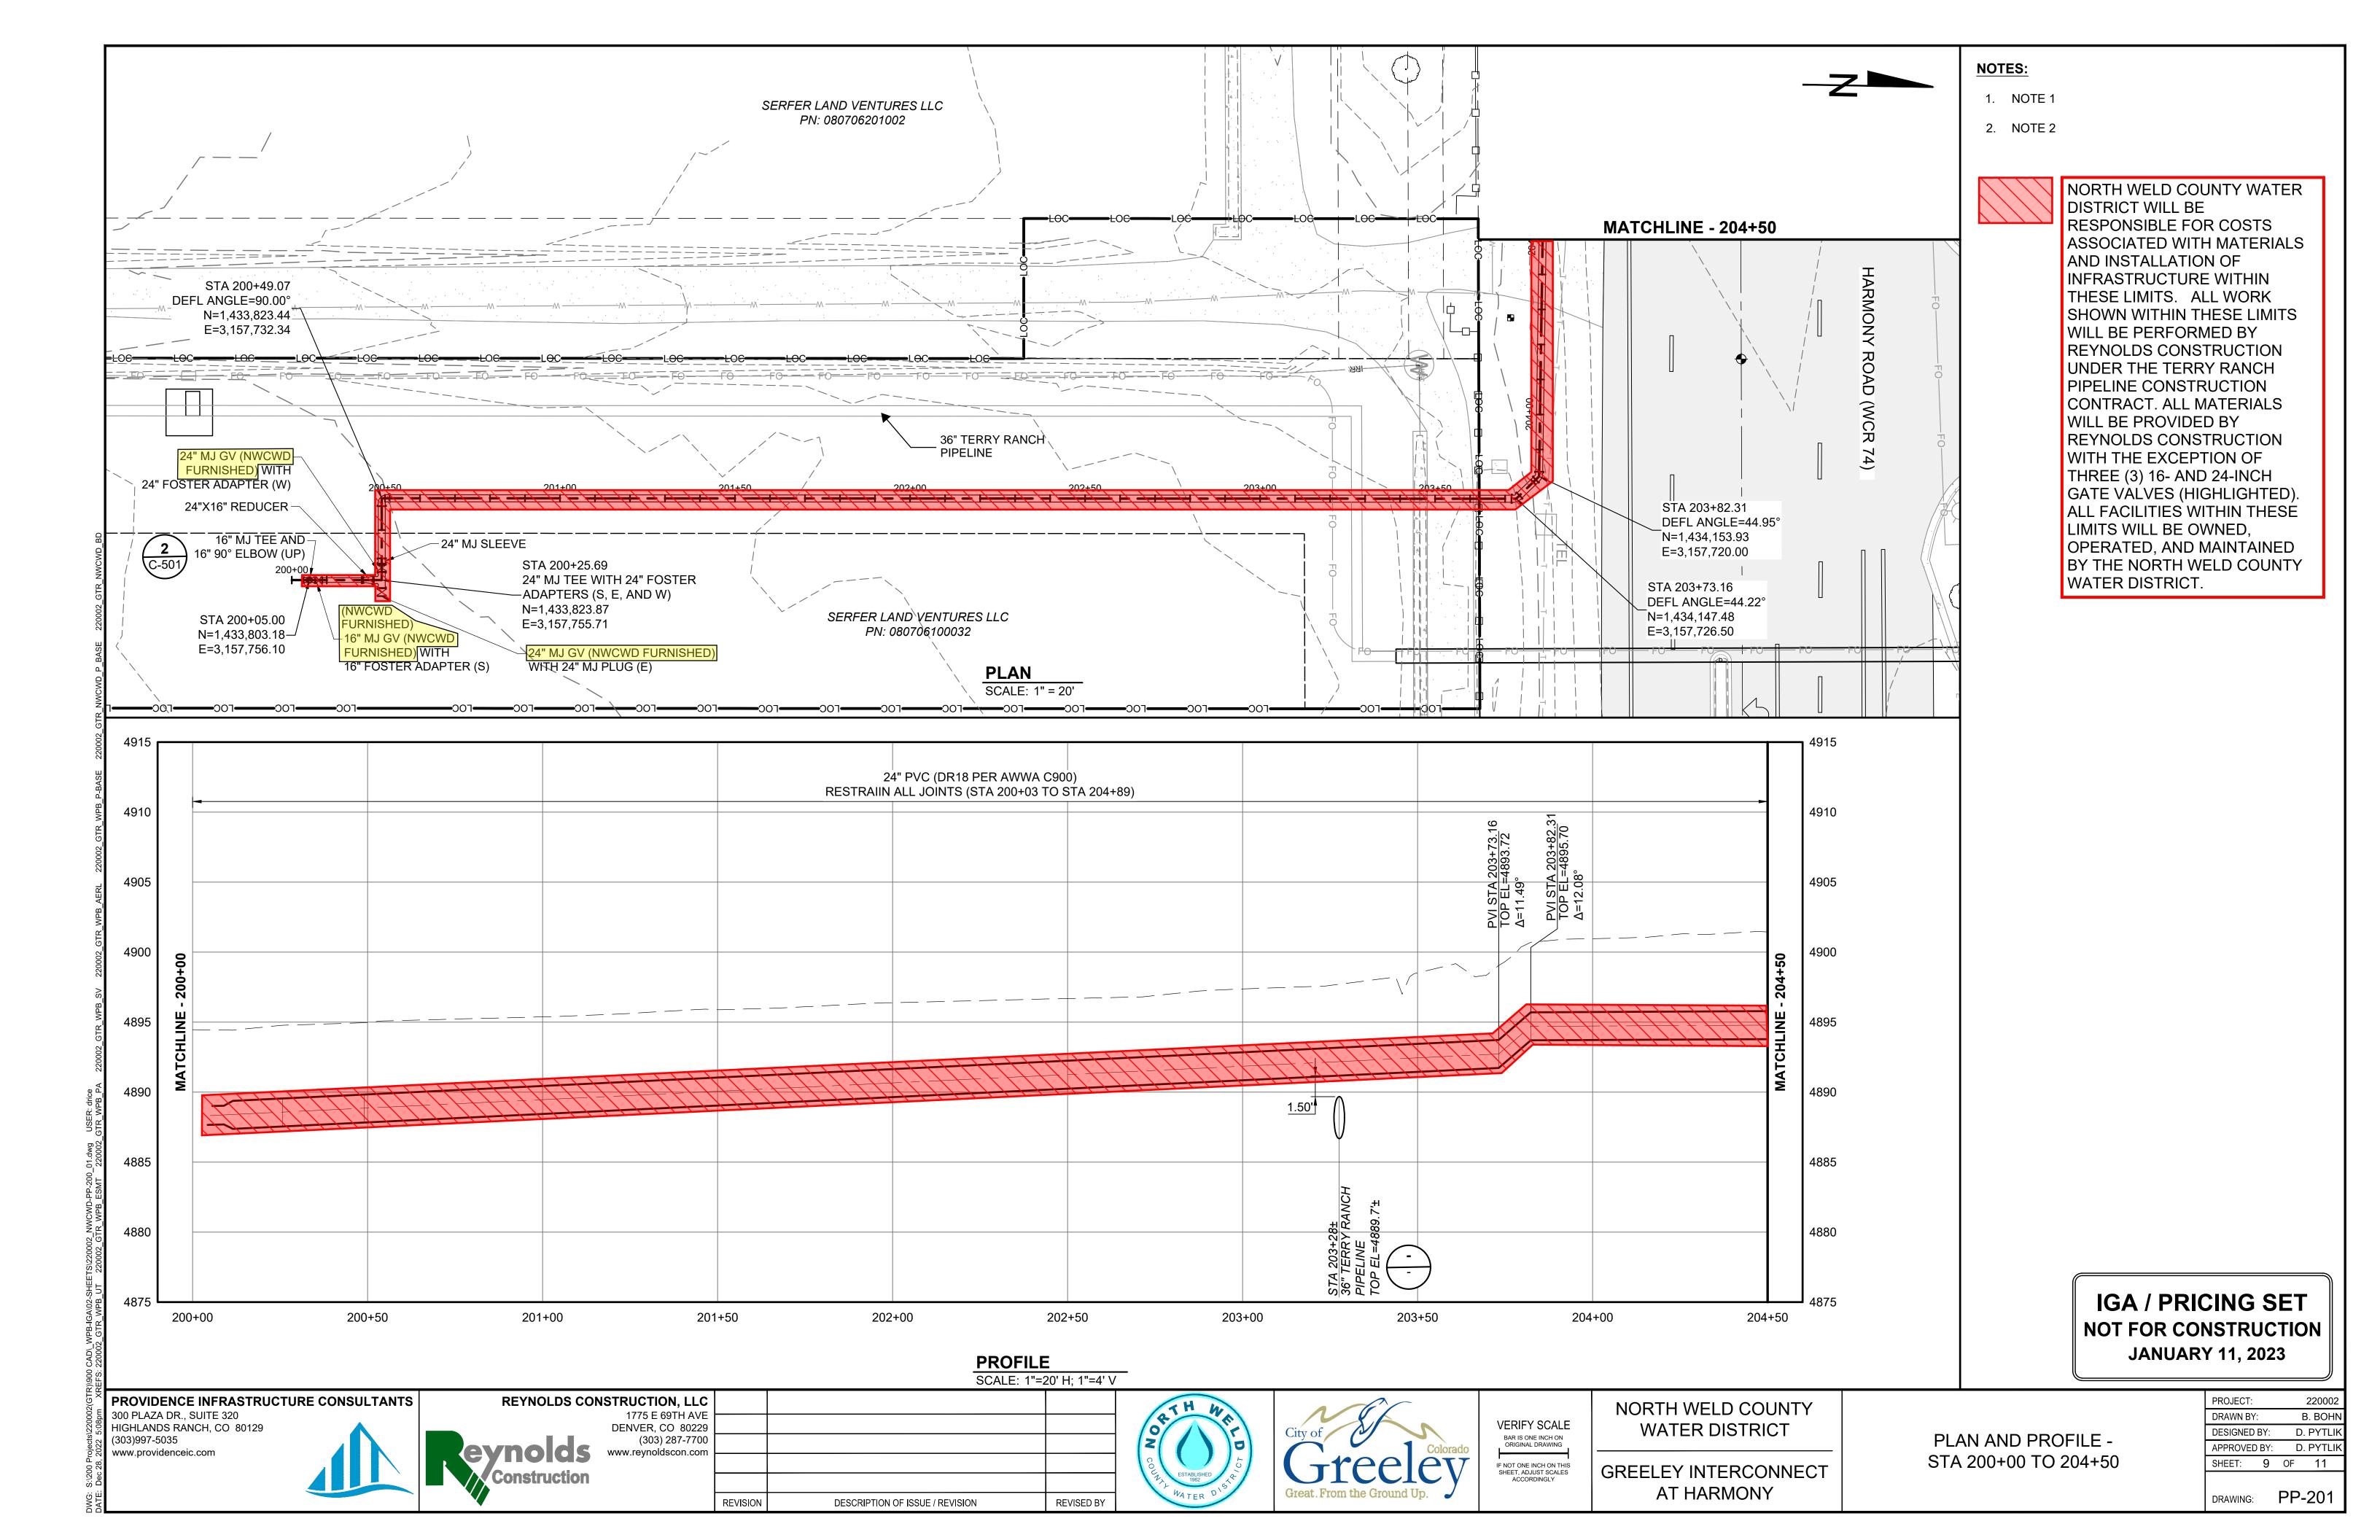




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AT HARMONY

PROJECT:			220002
DRAWN BY:			B. BOHN
DESIGNED B	3Y:	D	. PYTLIK
APPROVED	BY:	D	. PYTLIK
SHEET:	8	OF	11
DRAWING:		PP.	-101



## NOTES: FENCE — BOLLARD -24" WINDSOSR WATER -- WINDSOR MASTER METER STATION **MASTER METER** (NWCWD) ACCESS HATCH GRAVEL PAD — STA 204+59.85 DEFL ANGLE=44.95° -*12" WATER* N=1,434,153.64 E=3,157,642.46 ELECTRIC METER -- BOLLARD *- 4901 - -*– BOLLARD \_ HYDRANT - HYDRANT 24"X12" MJ REDUCER — STA 204+89.32 -24" WATER LINE 24" MJ TEE WITH 24" FOSTER -ADAPTERS (N, S, AND E) N=1,434,159.79 24" MJ SLEEVE — E=3,157,615.78 NOTE 1 \_\_\_\_T\_\_\_T\_\_\_\_T\_\_\_\_T STA 204+85.86 -RELOCATE EXISTING 24" MJ GV (NWCWD FURNISHED) 24" MJ SLEEVE WITH 24" FOSTER (E)-AND TIE IN TO N=1,434,159.87 STA 204+69.43 EXISTING NWCWD 24" PVC — — — E=3,157,619.23 DEFL ANGLE=46.47° N=1,434,160.39 E=3,157,635.66 -NOTE 2 **PLAN** SCALE: 1" = 5' 4925 24" PVC (DR18 PER AWWA C900) RESTRAIN ALL JOINTS (STA 200+03 TO STA 204+89) 4920 4920 4915 4915 4910 4910 4905 4905 - EXISTING GROUND 24" MJ GV 4900 4900 (NWCWD FURNISHED) 4895 4895 -24" WATER LINE 4890 4890 204+50 205+00 **PROFILE** SCALE: 1"= 5' H; 1"=5' V REYNOLDS CONSTRUCTION, LLC 1775 E 69TH AVE DENVER, CO 80229 PROVIDENCE INFRASTRUCTURE CONSULTANTS NORTH WELD COUNTY 300 PLAZA DR., SUITE 320 HIGHLANDS RANCH, CO 80129 (303)997-5035 VERIFY SCALE BAR IS ONE INCH ON ORIGINAL DRAWING WATER DISTRICT (303) 287-7700 www.reynoldscon.com www.providenceic.com

- 1. CONTRACTOR TO VERIFY LOCATION. COORDINATE WITH CENTURY LINK FOR ½" DIRECT BURY FIBER OPTIC LINE PROTECTION PRIOR TO CONSTRUCTION. BURY DEPTH IS APPROXIMATELY 2.0'.
- 2. PROTECT IN PLACE. CONTRACTOR TO VERIFY LOCATION PRIOR TO CONSTRUCTION. USE CAUTION WHILE EXCAVATING AROUND ELECTRIC LINE.



NORTH WELD COUNTY WATER DISTRICT WILL BE RESPONSIBLE FOR COSTS ASSOCIATED WITH MATERIALS AND INSTALLATION OF INFRASTRUCTURE WITHIN THESE LIMITS. ALL WORK SHOWN WITHIN THESE LIMITS WILL BE PERFORMED BY REYNOLDS CONSTRUCTION UNDER THE TERRY RANCH PIPELINE CONSTRUCTION CONTRACT. ALL MATERIALS WILL BE PROVIDED BY REYNOLDS CONSTRUCTION WITH THE EXCEPTION OF ONE (1) 24-INCH GATE VALVE (HIGHLIGHTED). ALL FACILITIES WITHIN THESE LIMITS WILL BE OWNED, OPERATED, AND MAINTAINED BY THE NORTH WELD COUNTY WATER DISTRICT.

**IGA / PRICING SET NOT FOR CONSTRUCTION JANUARY 11, 2023** 



DESCRIPTION OF ISSUE / REVISION REVISION



REVISED BY



IF NOT ONE INCH ON THIS SHEET, ADJUST SCALES ACCORDINGLY

**GREELEY INTERCONNECT** AT HARMONY

PLAN AND PROFILE -STA 204+50 TO 204+89.32

PROJECT	:		220002
DRAWN B	Y:	E	B. BOHI
DESIGNE	D BY:	D.	PYTLI
APPROVE	D BY:	D.	PYTLI
SHEET:	10	OF	11

DRAWING: PP-202

