Sherman Williams Retail Paint

Development Review and Lot Line Adjustment

- 1. Vicinity and Aerial Map
- 2. Applications Universal and Lot Line Adjustment
- 3. Lot line Adjustment Exhibit
- 4. Project Plans:
 - a. Overall Site Plan
 - b. Elevations/Renderings
 - c. Landscape Plan
 - d. Lighting Details

Aerial Map- 035-600-007

Nevada County GIS

Parcel APN: 035-600-007

N/A

Land Value: \$13,022.00

Improvement Value: \$0.00

Acreage: Unknown

Zoning: C-2 GVCity

General Plan: C GVCity

Fire District: Grass Valley

Elementary Sch. Dist: Grass Valley

Water District:

Nevada Irrigation Dist: NID Water - Zone 1.0

Public Utility:

Park District:


Service Area: Solid Waste Grass Valley - Csa 32

Snow Load: 49 lbs/sqft


Wind Exposure: C
Climate Zone: 11

Elevation: 2,647 feet


Overview

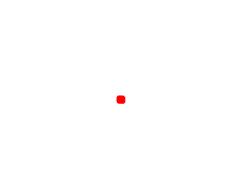


December 1, 2023 © 2022 Nevada County GIS Scale: 1:1,128

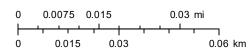

Vicinity Map- 035-600-007

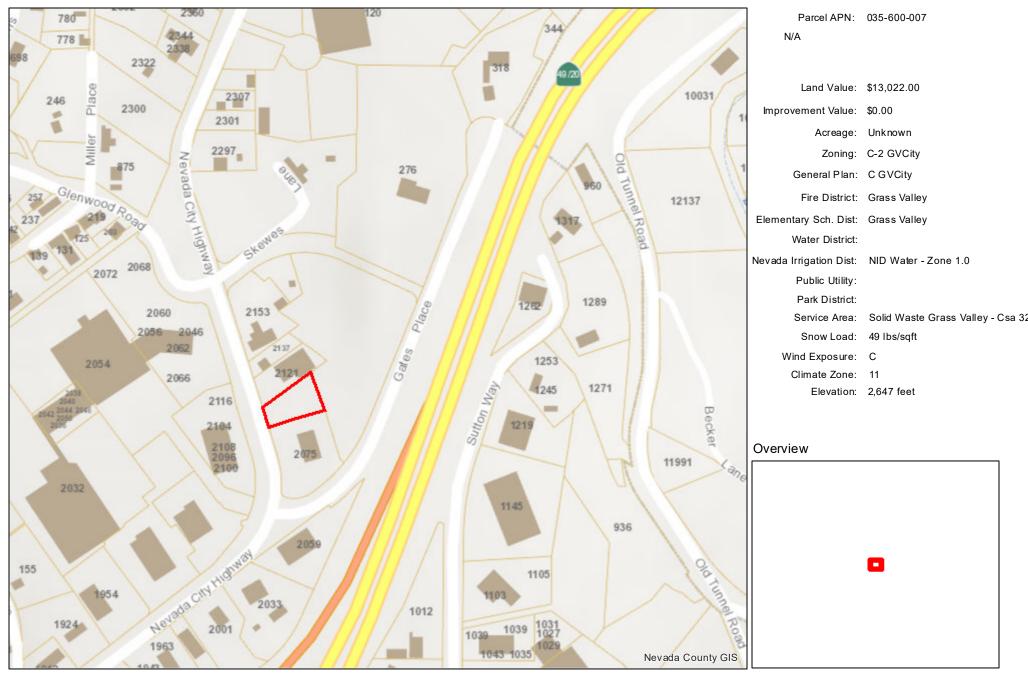

December 1, 2023 © 2022 Nevada County GIS Scale: 1:4,514 0

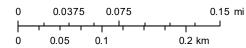

CITY OF GRASS VALLEY Community Development Department 125 E. Main Street Grass Valley, California 95945 (530) 274-4330 (530) 274-4399 fax

DEVELOPMENT REVIEW



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	⊏.	
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(3) Landscaped area 21,790 Sq. Ft. 54 % of site (4) Left in open space Sq. Ft. % of site		· · · <u> </u>
(4) Left in open space Sq. Ft % of site Total Sq. Ft. 100 %		

	G.	Construction phasing: If the project is a portion of an overall larger project, describe future phases or extension. Show all phases on site plan. The project only involves the construction of the Sherwin Williams building and associated parking, drive aisles, etc and will be completed in one phase. There will be excess land after a Lot Line Adjustment.							
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	J.	Total number of parking spaces provided: 18							
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	A.	Type of use:							
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	В.	Area devoted to outdoor use (shown on site plan)							
		Square feet/acres Percentage of site							
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	_								

SITE PLAN REQUIREMENTS DEVELOPMENT REVIEW CHECKLIST

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B. Site Plan

- Fifteen (15) Copies of Plan Sets for **Major** Development Review or Eight (8) Copies of Plan Sets for **Minor** Development Review on standard 24" x 36" size paper fan-folded to 9" x 12", one (1) reduced copy at 8 1/2" x 11" and e-mail electronic .pdf version which includes the following information:
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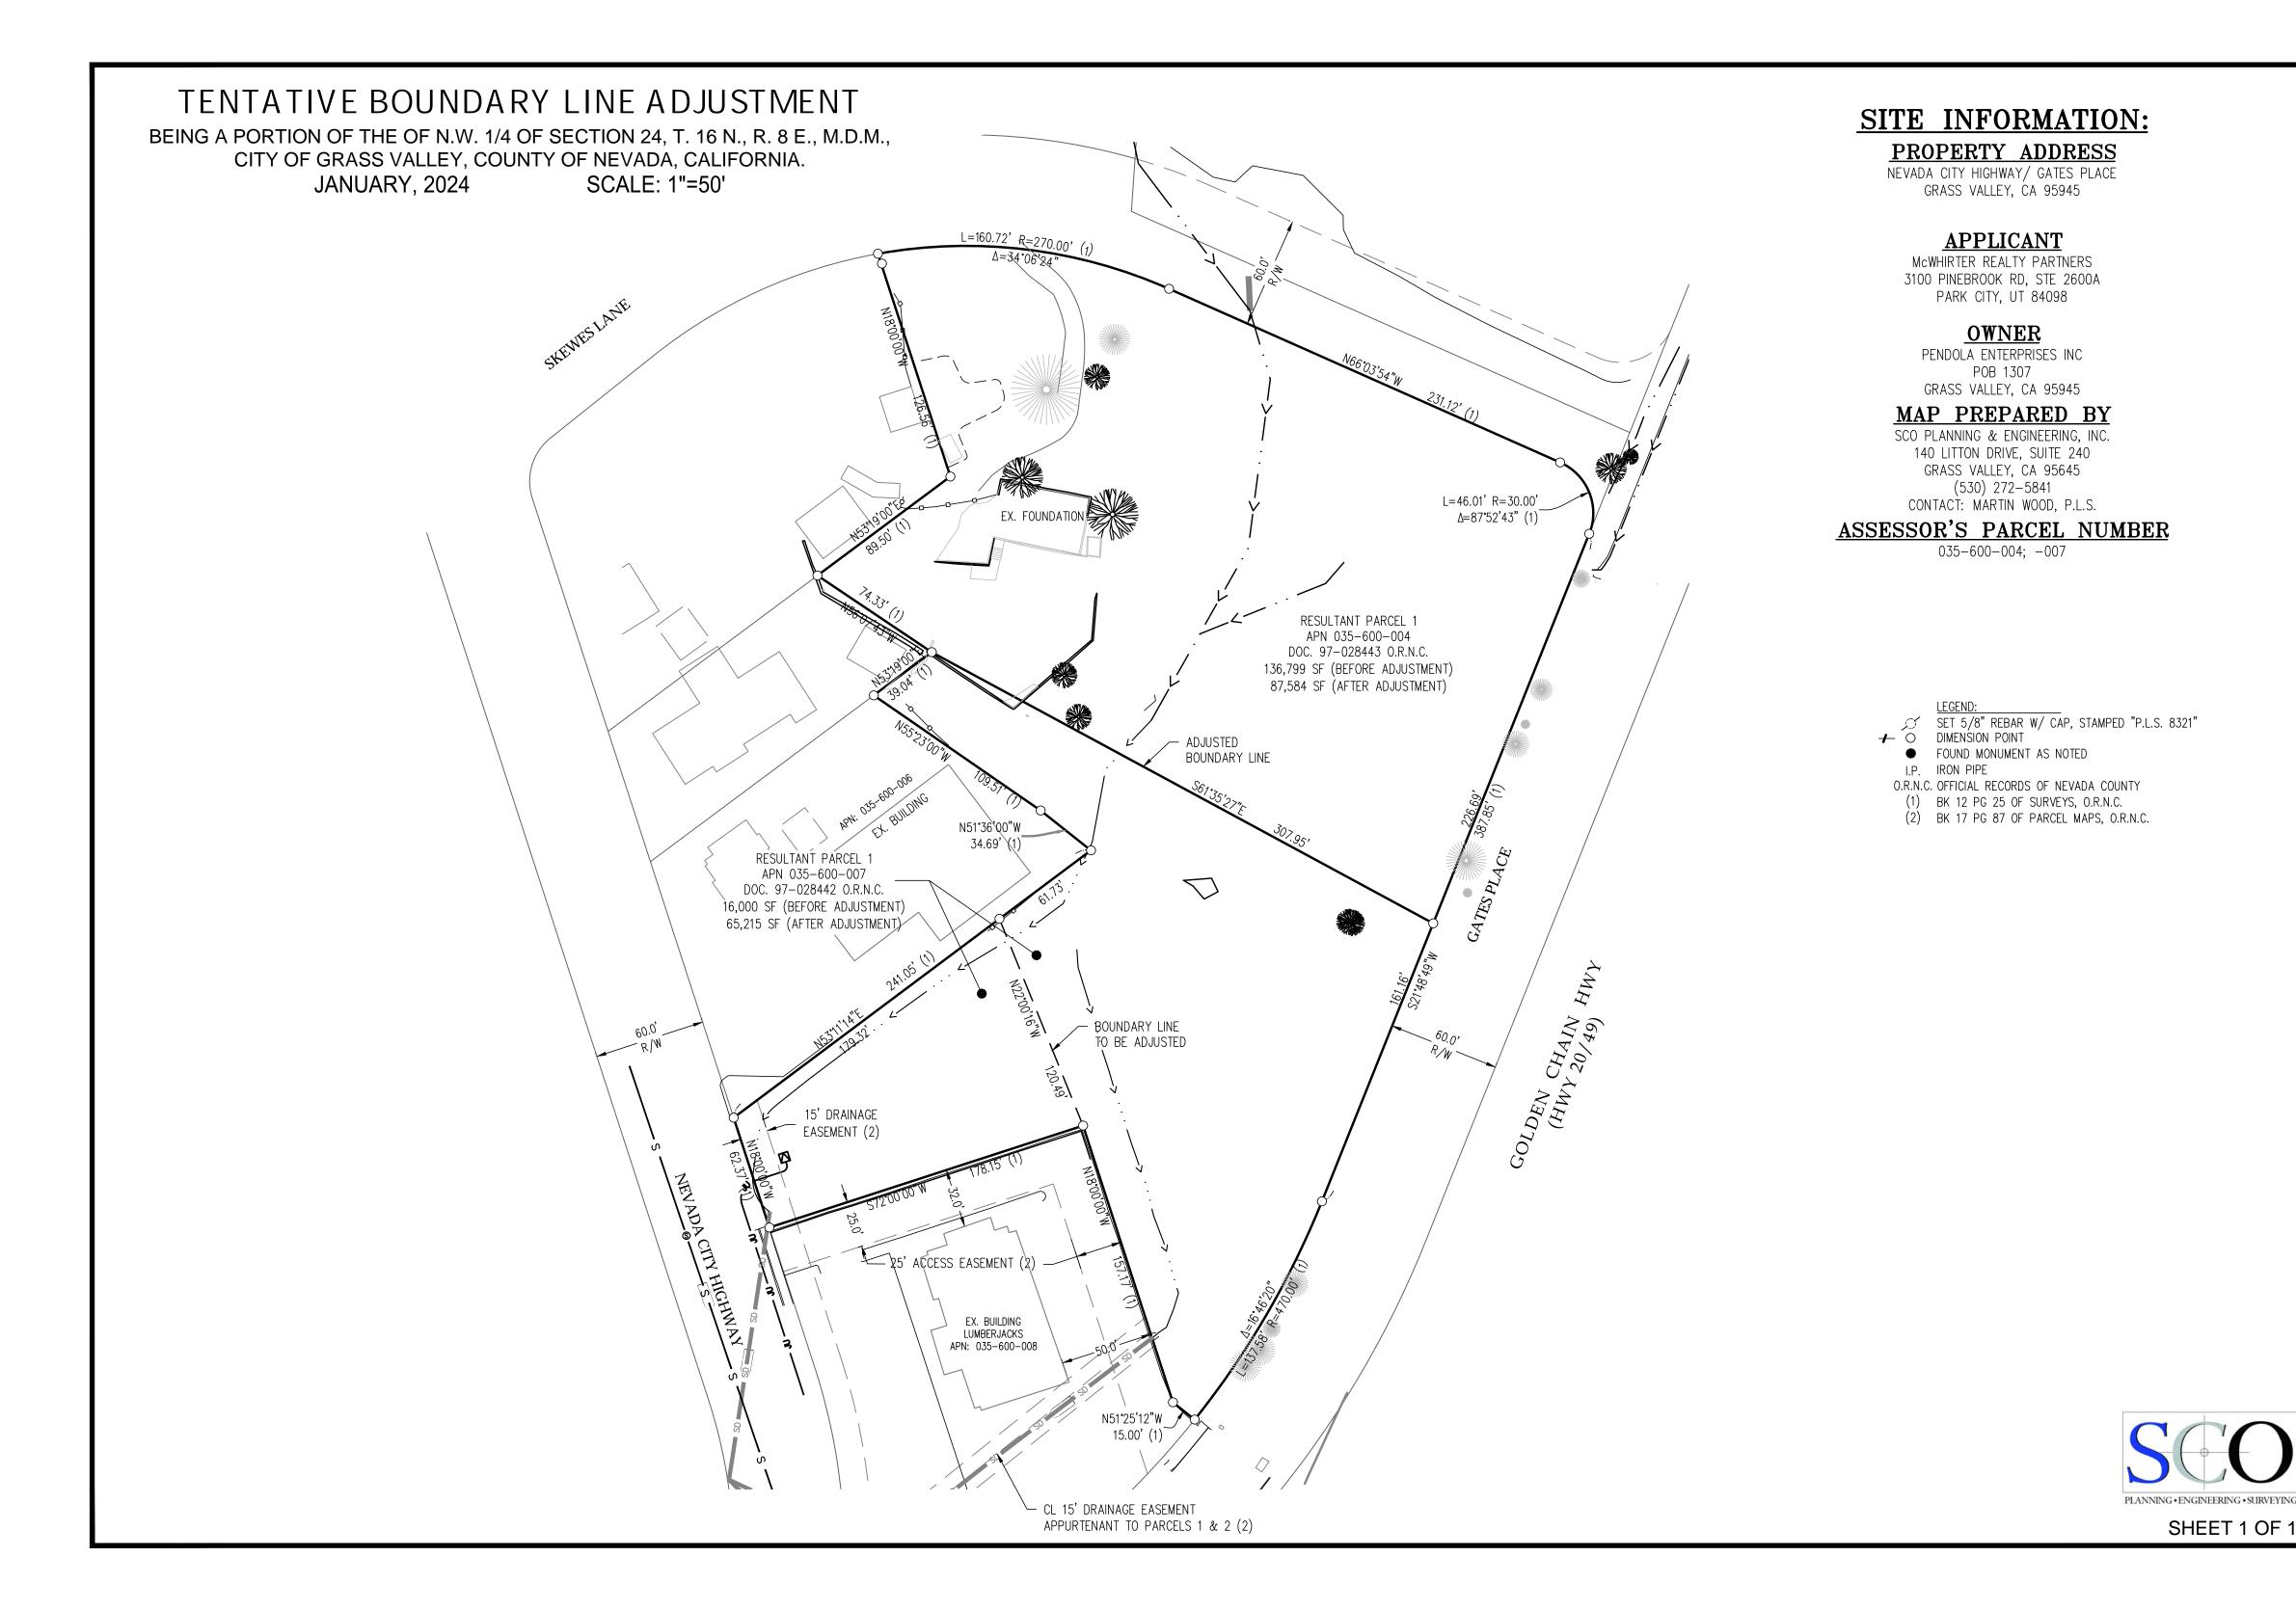
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C.





SITE STATISTICS						
	SF	AC	%			
Buildings	4,365	0.10	6.69%			
AC	12,170	0.28	18.66%			
Concrete	1,750	0.04	2.68%			
Landscape	46,930	1.08	71.96%			
	65,215	1.50	100.00%			

SITE INFORMATION:

PROPERTY ADDRESS NEVADA CITY HIGHWAY/ GATES PLACE

GRASS VALLEY, CA 95945

APPLICANT

McWHIRTER REALTY PARTNERS
3100 PINEBROOK RD, STE 2600A
PARK CITY, UT 84098

OWNER

PENDOLA ENTERPRISES INC

POB 1307

GRASS VALLEY, CA 95945


MAP PREPARED BY
SCO PLANNING & ENGINEERING, INC.
140 LITTON DRIVE, SUITE 240
GRASS VALLEY, CA 95645
(530) 272-5841
CONTACT: MARTIN WOOD, P.L.S.


ASSESSOR'S PARCEL NUMBER 035-600-004; -007

LOT AREA

3.14 AC; 0.37 AC (BEFORE LLA)


1.50 AC (PER LLA)

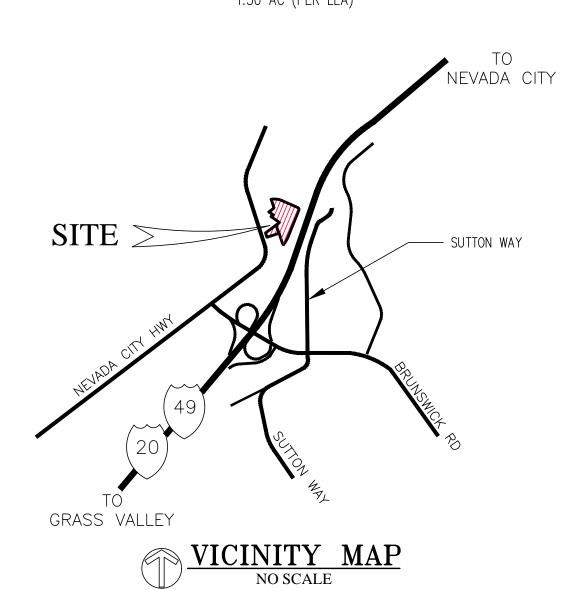

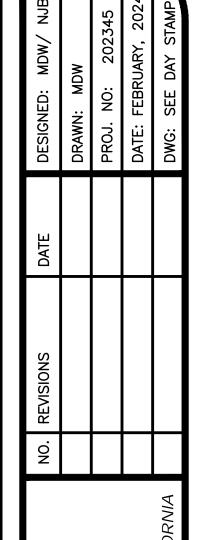




(530) 272-5841 TRUCKEE (530) 582-4043

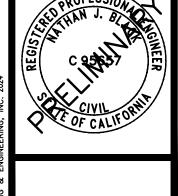

OF 3

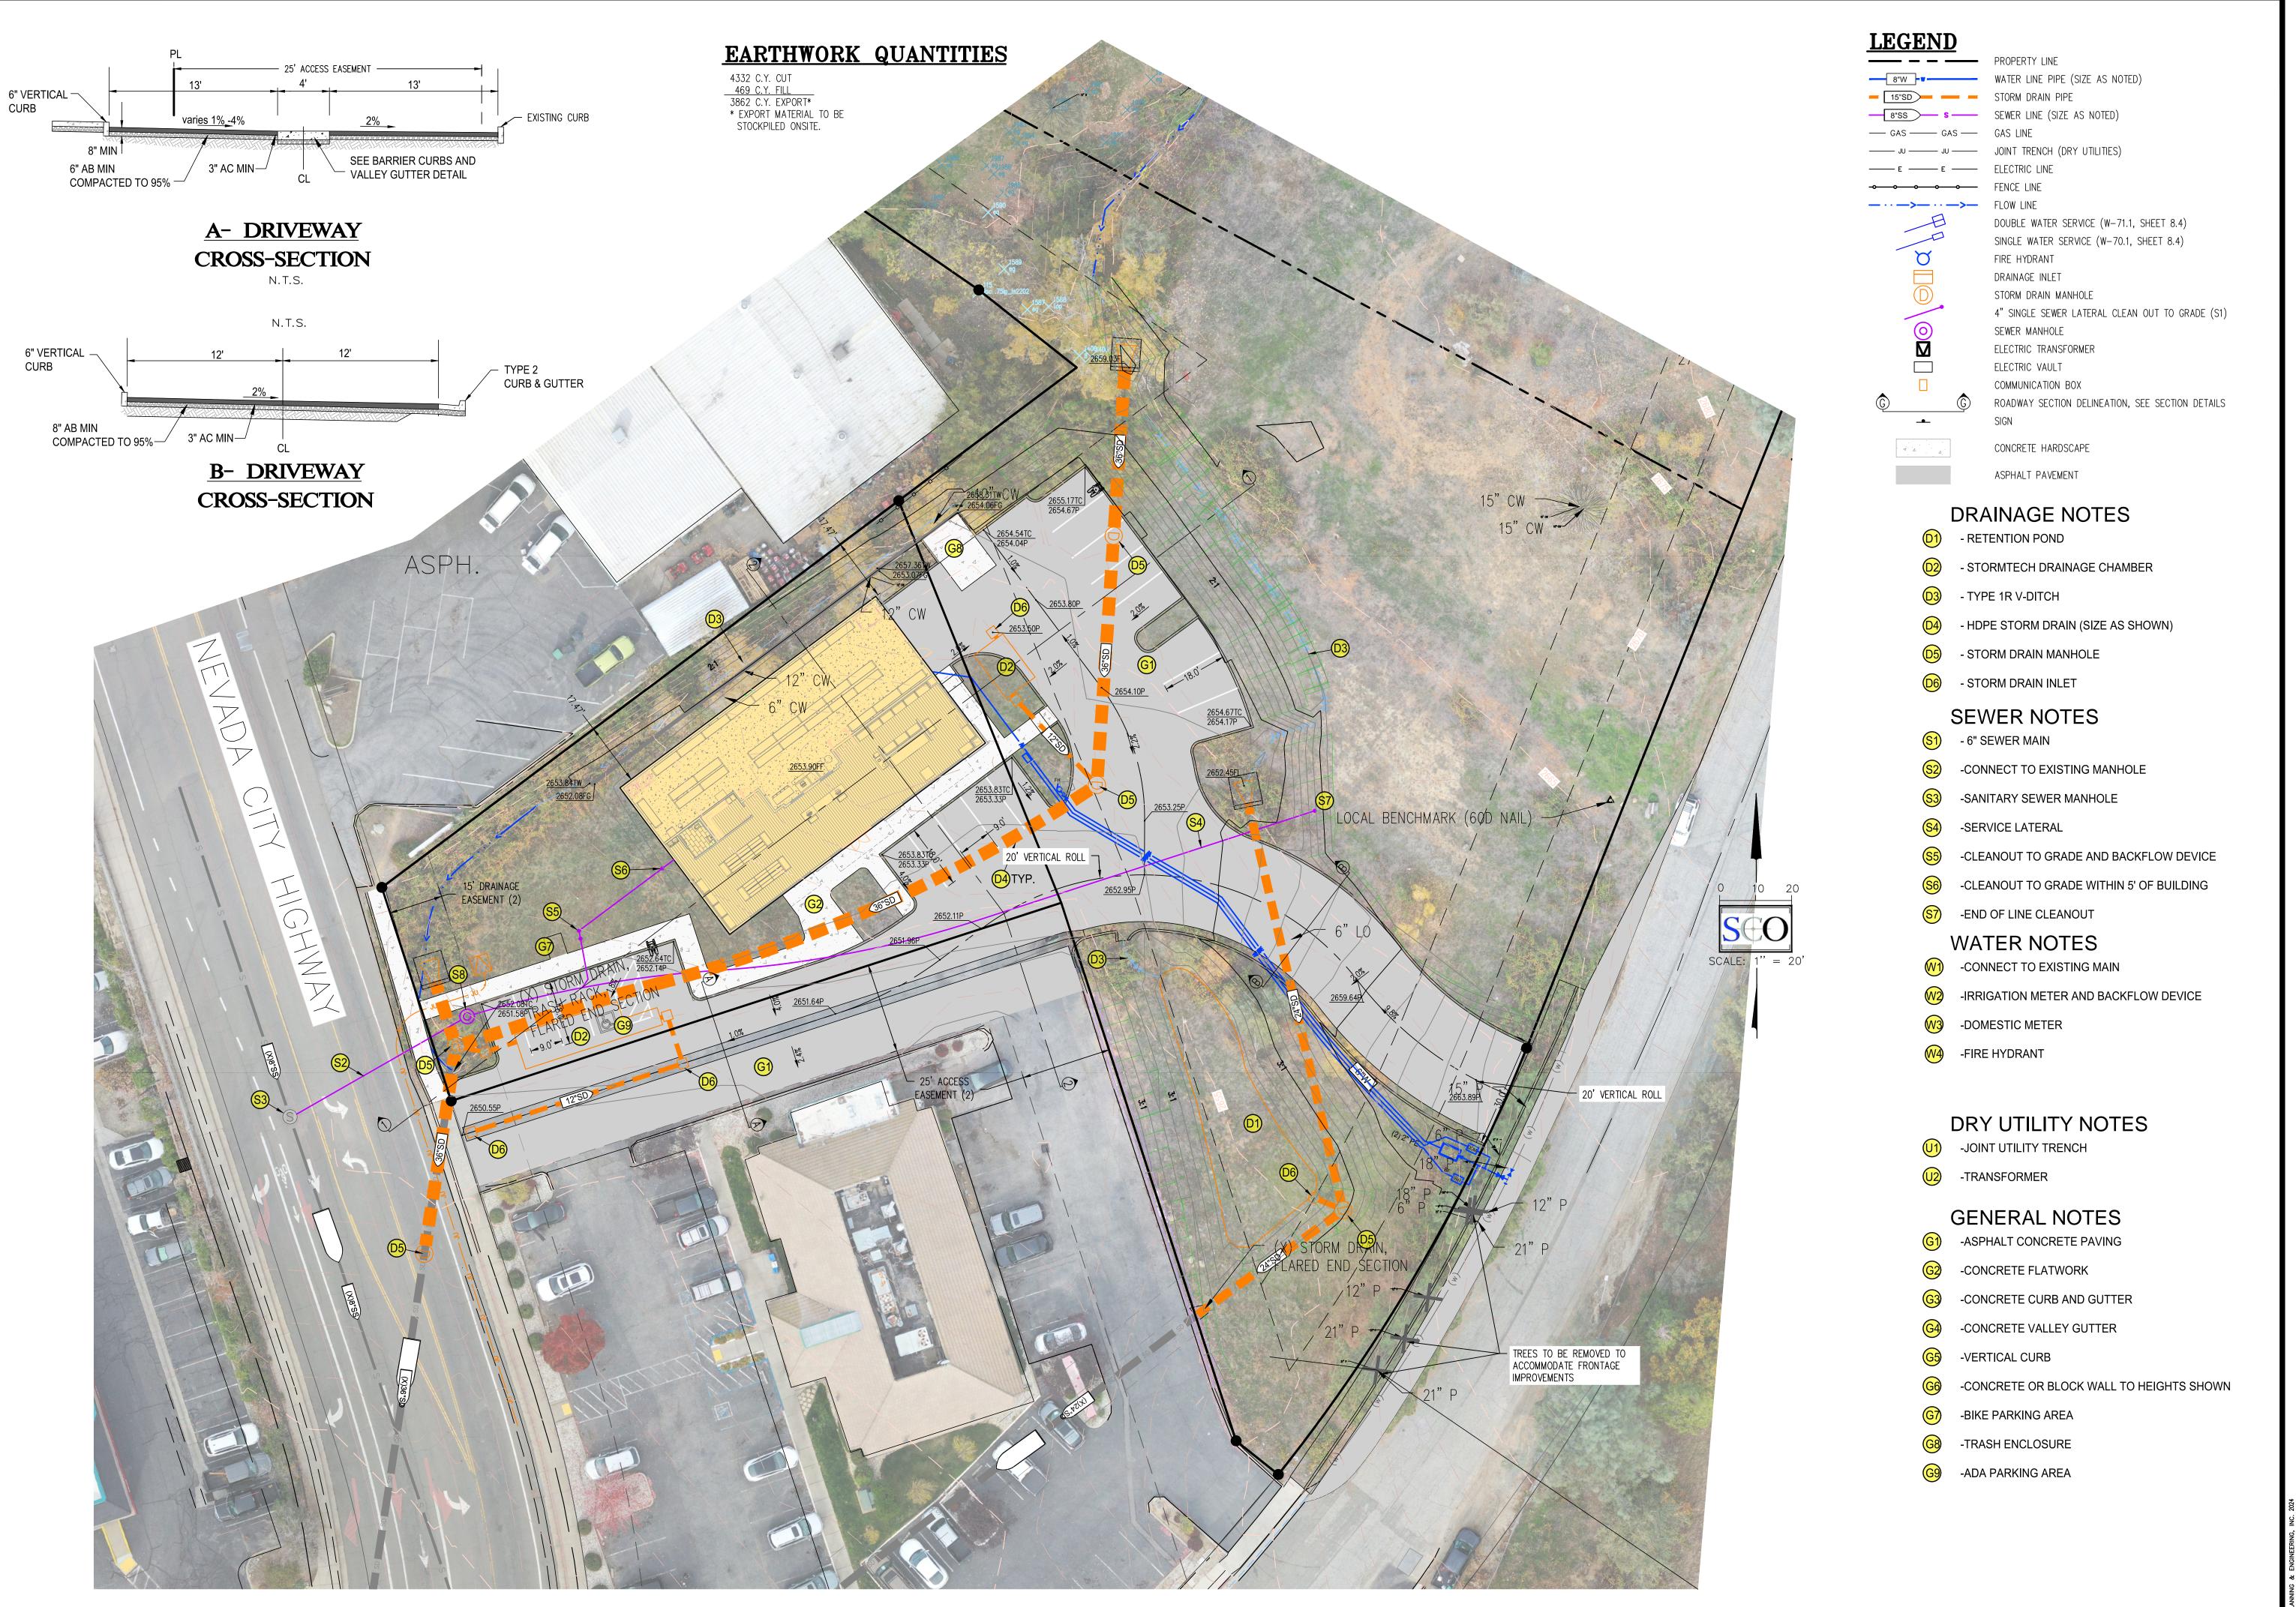

 NO.
 REVISIONS
 DATE
 DESIGNED: MDW/ NJB

 PROJ: NO:
 202345

 PROJ: NO:
 202345


 DATE: FEBRUARY, 2024

 DWG: SEE DAY STAMP

DEVELOPMENT REVIEW SHER M/N - M/LL/AMS PRELIMINARY GRADING, DRAINAGE, UTILITY PLAI


PLANNING • ENGINEERING • SURVEYING

GRASS VALLEY (530) 272-5841 TRUCKEE (530) 582-4043

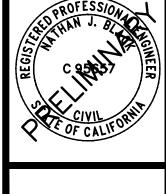


2 OF 3



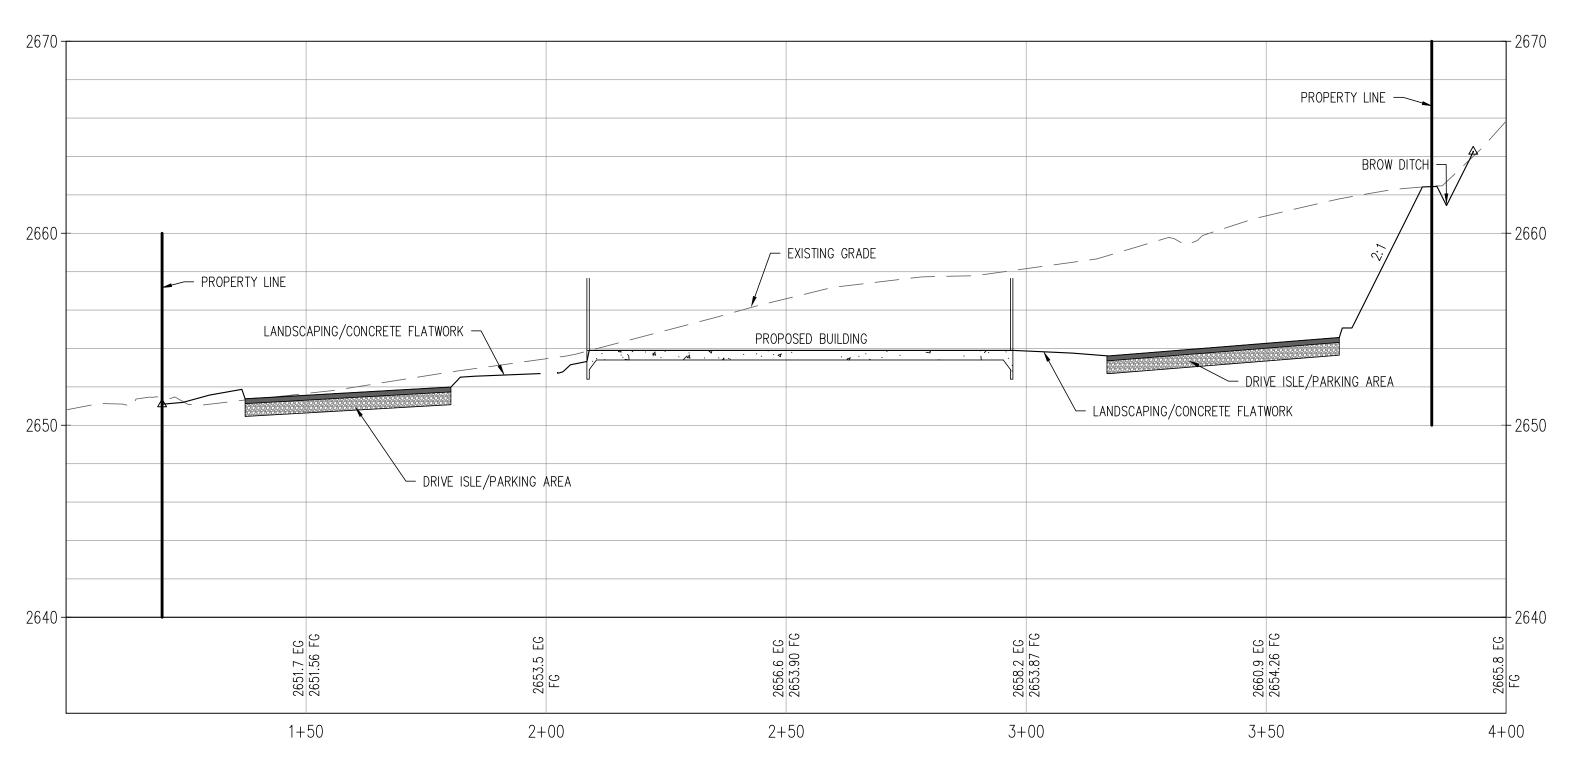

PROFILE VIEW SITE SECTION WEST EAST 1-1, STA: 1+00 - 4+00 SCALE: 1" =20' HORIZ. 1"=5' VERT.

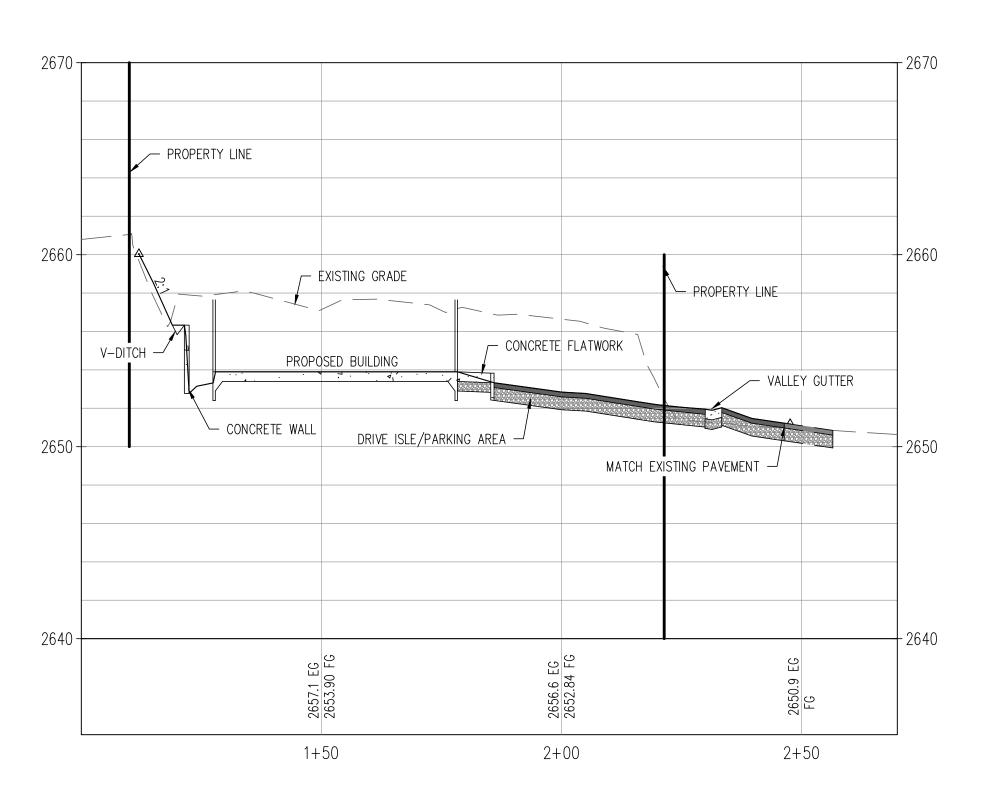

PROFILE VIEW SITE SECTION NORTH SOUTH 2-2, STA: 1+00 - 2+70 SCALE: 1" =20' HORIZ. 1"=5' VERT.

(530) 272-5841



3 OF 3

SHERWIN WILLIAMS

GRASS VALLEY, CA


Parapet 1 22' - 6"




— TYPICAL SIGNAGE AREA (UNDER SEPARATE PERMIT)


Parapet 2 24' - 6"



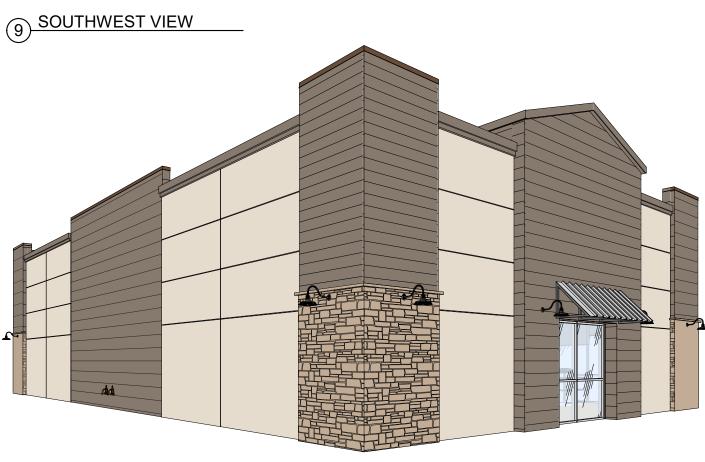

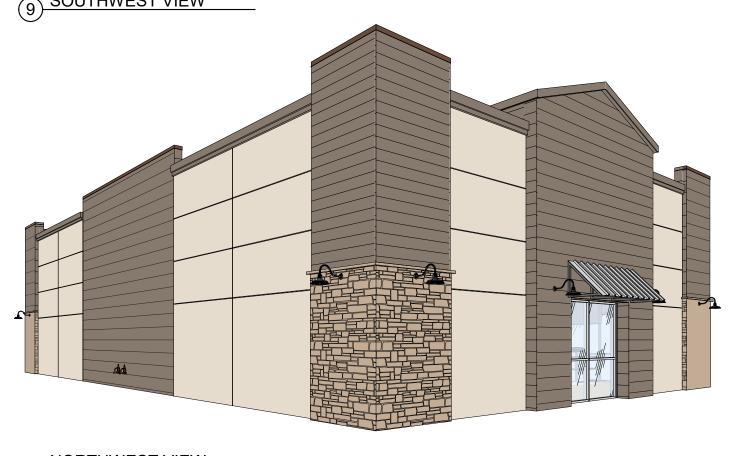

ROOFTOP UNIT ROOF LINE BEYOND PARAPET E-2 E-3 M-2 S-1

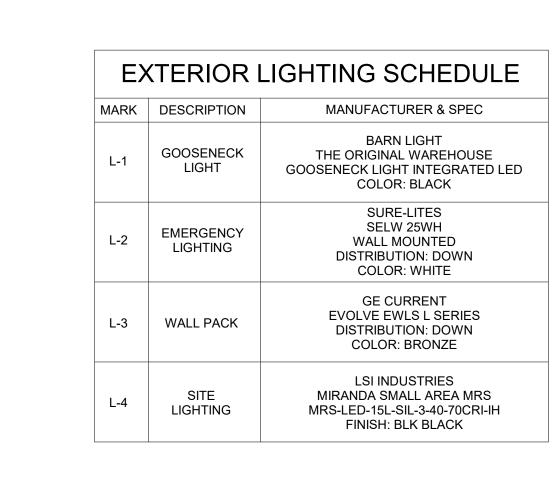

EXTERIOR FINISH SCHEDULE

COLOR: SHERWIN-WILLIAMS

SERIES: OUTSULATION PLUS MD TEXTURE: SANDPEBBLE FINE

COLOR: SHERWIN-WILLIAMS

COLOR: SHERWIN-WILLIAMS

SERIES: HARDIE ARTISAN SIDING PRODUCT: ARTISAN SQUARE CH

SW 6105 DIVINE WHITE

SW 7025 BACKDROP

JAMES HARDIE

COLOR: PRIMED

STACKED STONE

TO MATCH)

ANODIZED | COLOR: DARK BRONZE ALUMINUM (PARAPET COPING)

COLOR: ALDERWOOD

TEXTURE: CHISELED FACE

COLOR: CLEAR ALUMINUM (STOREFRONT & AWNINGS

E-1 EIFS - FIELD SERIES: OUTSULATION PLUS MD TEXTURE: SANDPEBBLE FINE

E-3 | EIFS - BAY | SERIES: OUTSULATION PLUS MD | TEXTURE: SANDPEBBLE FINE

SW 7506 LOGGIA

MANUFACTURER & SPEC

SAMPLE

MARK DESCRIPTION

EIFS - BAY

S-1 FC SIDING

FASCIA

STONE

VENEER

ANODIZED ALUMINUM

M-3 STANDING COLOR: SILVER



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CHECKED BY: MP SCHEMATIC ELEVATIONS - 1/31/2024

SHERWIN WILLIAMS

STORE #: XXXX

GRASS VALLEY, CA

SCHEMATIC FLOOR PLAN & **ELEVATIONS**


SHEET NUMBER:

A1



S-2 M-3 S-1

TRASH ENCLOSURE WALL SECTION 1/2" = 1'-0"
NOTE: SEE PLAN FOR LOCATION CONC. WASH 6" DIAMETER TYP. CONC. FILL JOINT FILLER CONC. WASH CONC. SLAB / ASPHALT
UNDISTURBED /COMPACTED SOIL 1'-6" A4 BOLLARD DETAIL 1/2" = 1'-0"

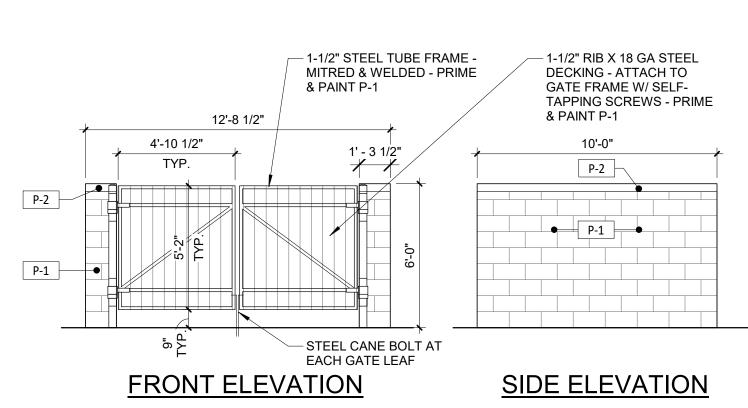

C5 TRASH ENCLOSURE ELEVATIONS
1/4" = 1'-0"

- METAL FLASHING CAP PAINTED P2 PER A1

T.O. MASONRY 6'-0" A.F.F.

- 8" DEEP CONTINUOUS BOND


BEAM W/ (2) CONTINUOUS #5'S -HOOK WALL VERT INTO TOP BOND BEAM W/ STANDARD 90° HOOK

— 8" CMU W/ #5 VERTS @ 24" O.C. MAX IN GROUTED FULL CORES -PROVIDE MATCHING DOWELS INTO FOUNDATION - PAINT P-1 PER SHEET A1

- 1/2" EXPANSION MATERIAL

— ALL CMU BELOW GRADE TO BE GROUTED FULL

T.O. SLAB
PER CIVIL

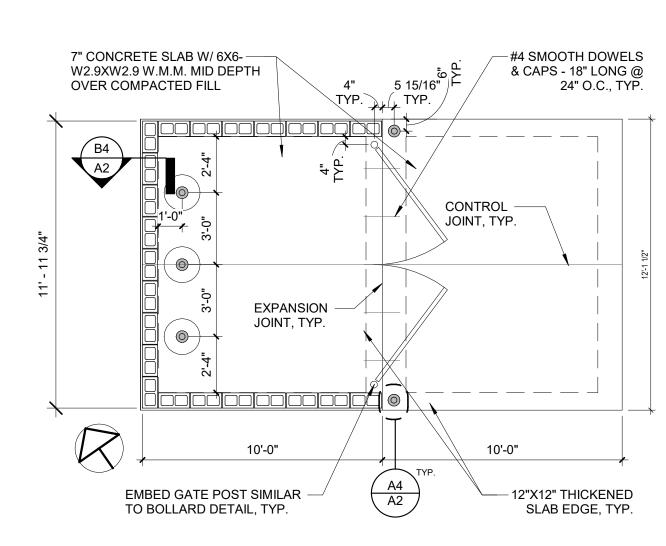

B5 TRASH ENCLOSURE PLAN
1/4" = 1'-0"

SHERWIN WILLIAMS

		- WELD HINGE STRAP TO 1-1/2" TUBE	STORE #: XXXX
	— 3-1/2" STEEL PIPE HINGE POST — 4" STEEL PIPE SWIVEL	FRAME	ADDRESS:
2" 4"	— 1/4" STEEL BAR - WELD TO GATE FRAME	- 1-1/2" RIB X 18 GA. STEEL DECKING - SCREW ATTACH TO FACE OF GATE FRAME W/ SELF TAPPING SCREWS - PRIME & PAINT	SHEET TIT
	— 4" DIAM. STEEL PIPE STATIONARY		

ELEVATION

A5 HINGE DETAIL
1 1/2" = 1'-0"

SHEET TITLE: TRASH ENCLOSURE

<u>PLAN</u>

SHEET NUMBER:

GRASS VALLEY, CA

DETAILS

LINGLEDESIGNGROUP,INC

158 WEST MAIN STREET LENA, IL 61048 815.369.9155

1764 BLAKE ST DENVER, CO 80202 303.974.5875

WWW.LINGLEDESIGN.COM

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SCHEMATIC ELEVATIONS - 1/3/2024

CHECKED BY: MP



Estimated Total Water use (ETWU).

ETWU= (ETo)) (Conversion factor) ((ETAF) (Area))

(52.66) (.62)

=150,009 GALLONS

OLIVE STREET P.O. Box 2083 Petaluma CA 94952 707-280-8990 OliveStreetLandscape.com rod@olivestreetlandscape.com


Checked					
Drawn					
Designed					

Designe	-						
Description	11-18-23 PLANNING	1-30-24 PLANNING RE-SUBMITTAL	2-14-24 PLANNING RE-SUBMITTAL				
Date	11-18-23	1-30-24	2-14-24				

City Of Grass Valley County Of Placer

Prepared Under the Direction of:


State Of California

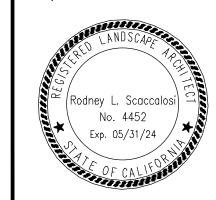


Sheet	L1	
Scale:		
Date:		
Project Nu	ımber:	-
		I

Plan File:

Valley water conservation standards.

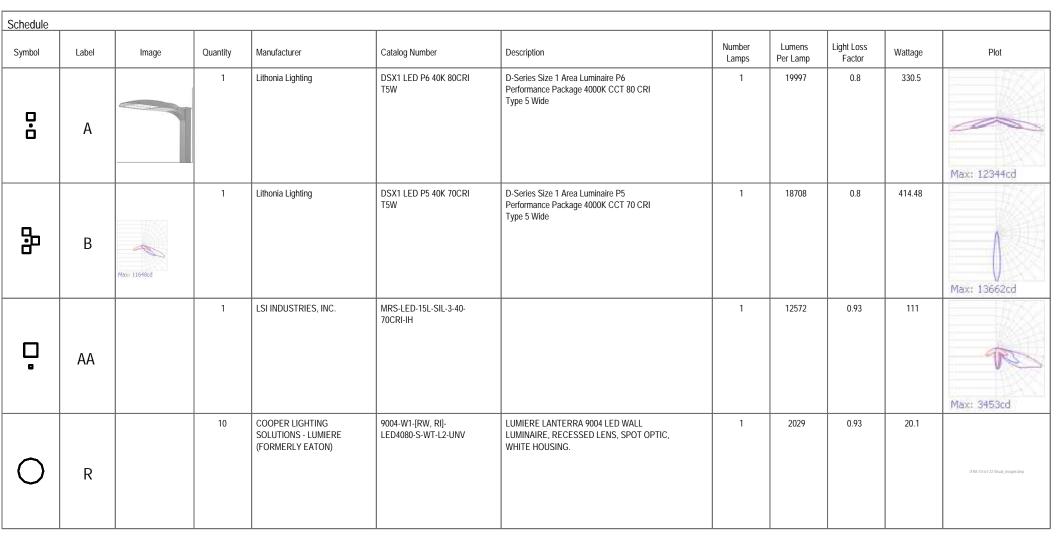

Statistics						
Description	Symbol	Avg	Max	Min	Avg/Min	Max/Min
Calc Zone #2	+	1.8 fc	13.8 fc	0.0 fc	N/A	N/A

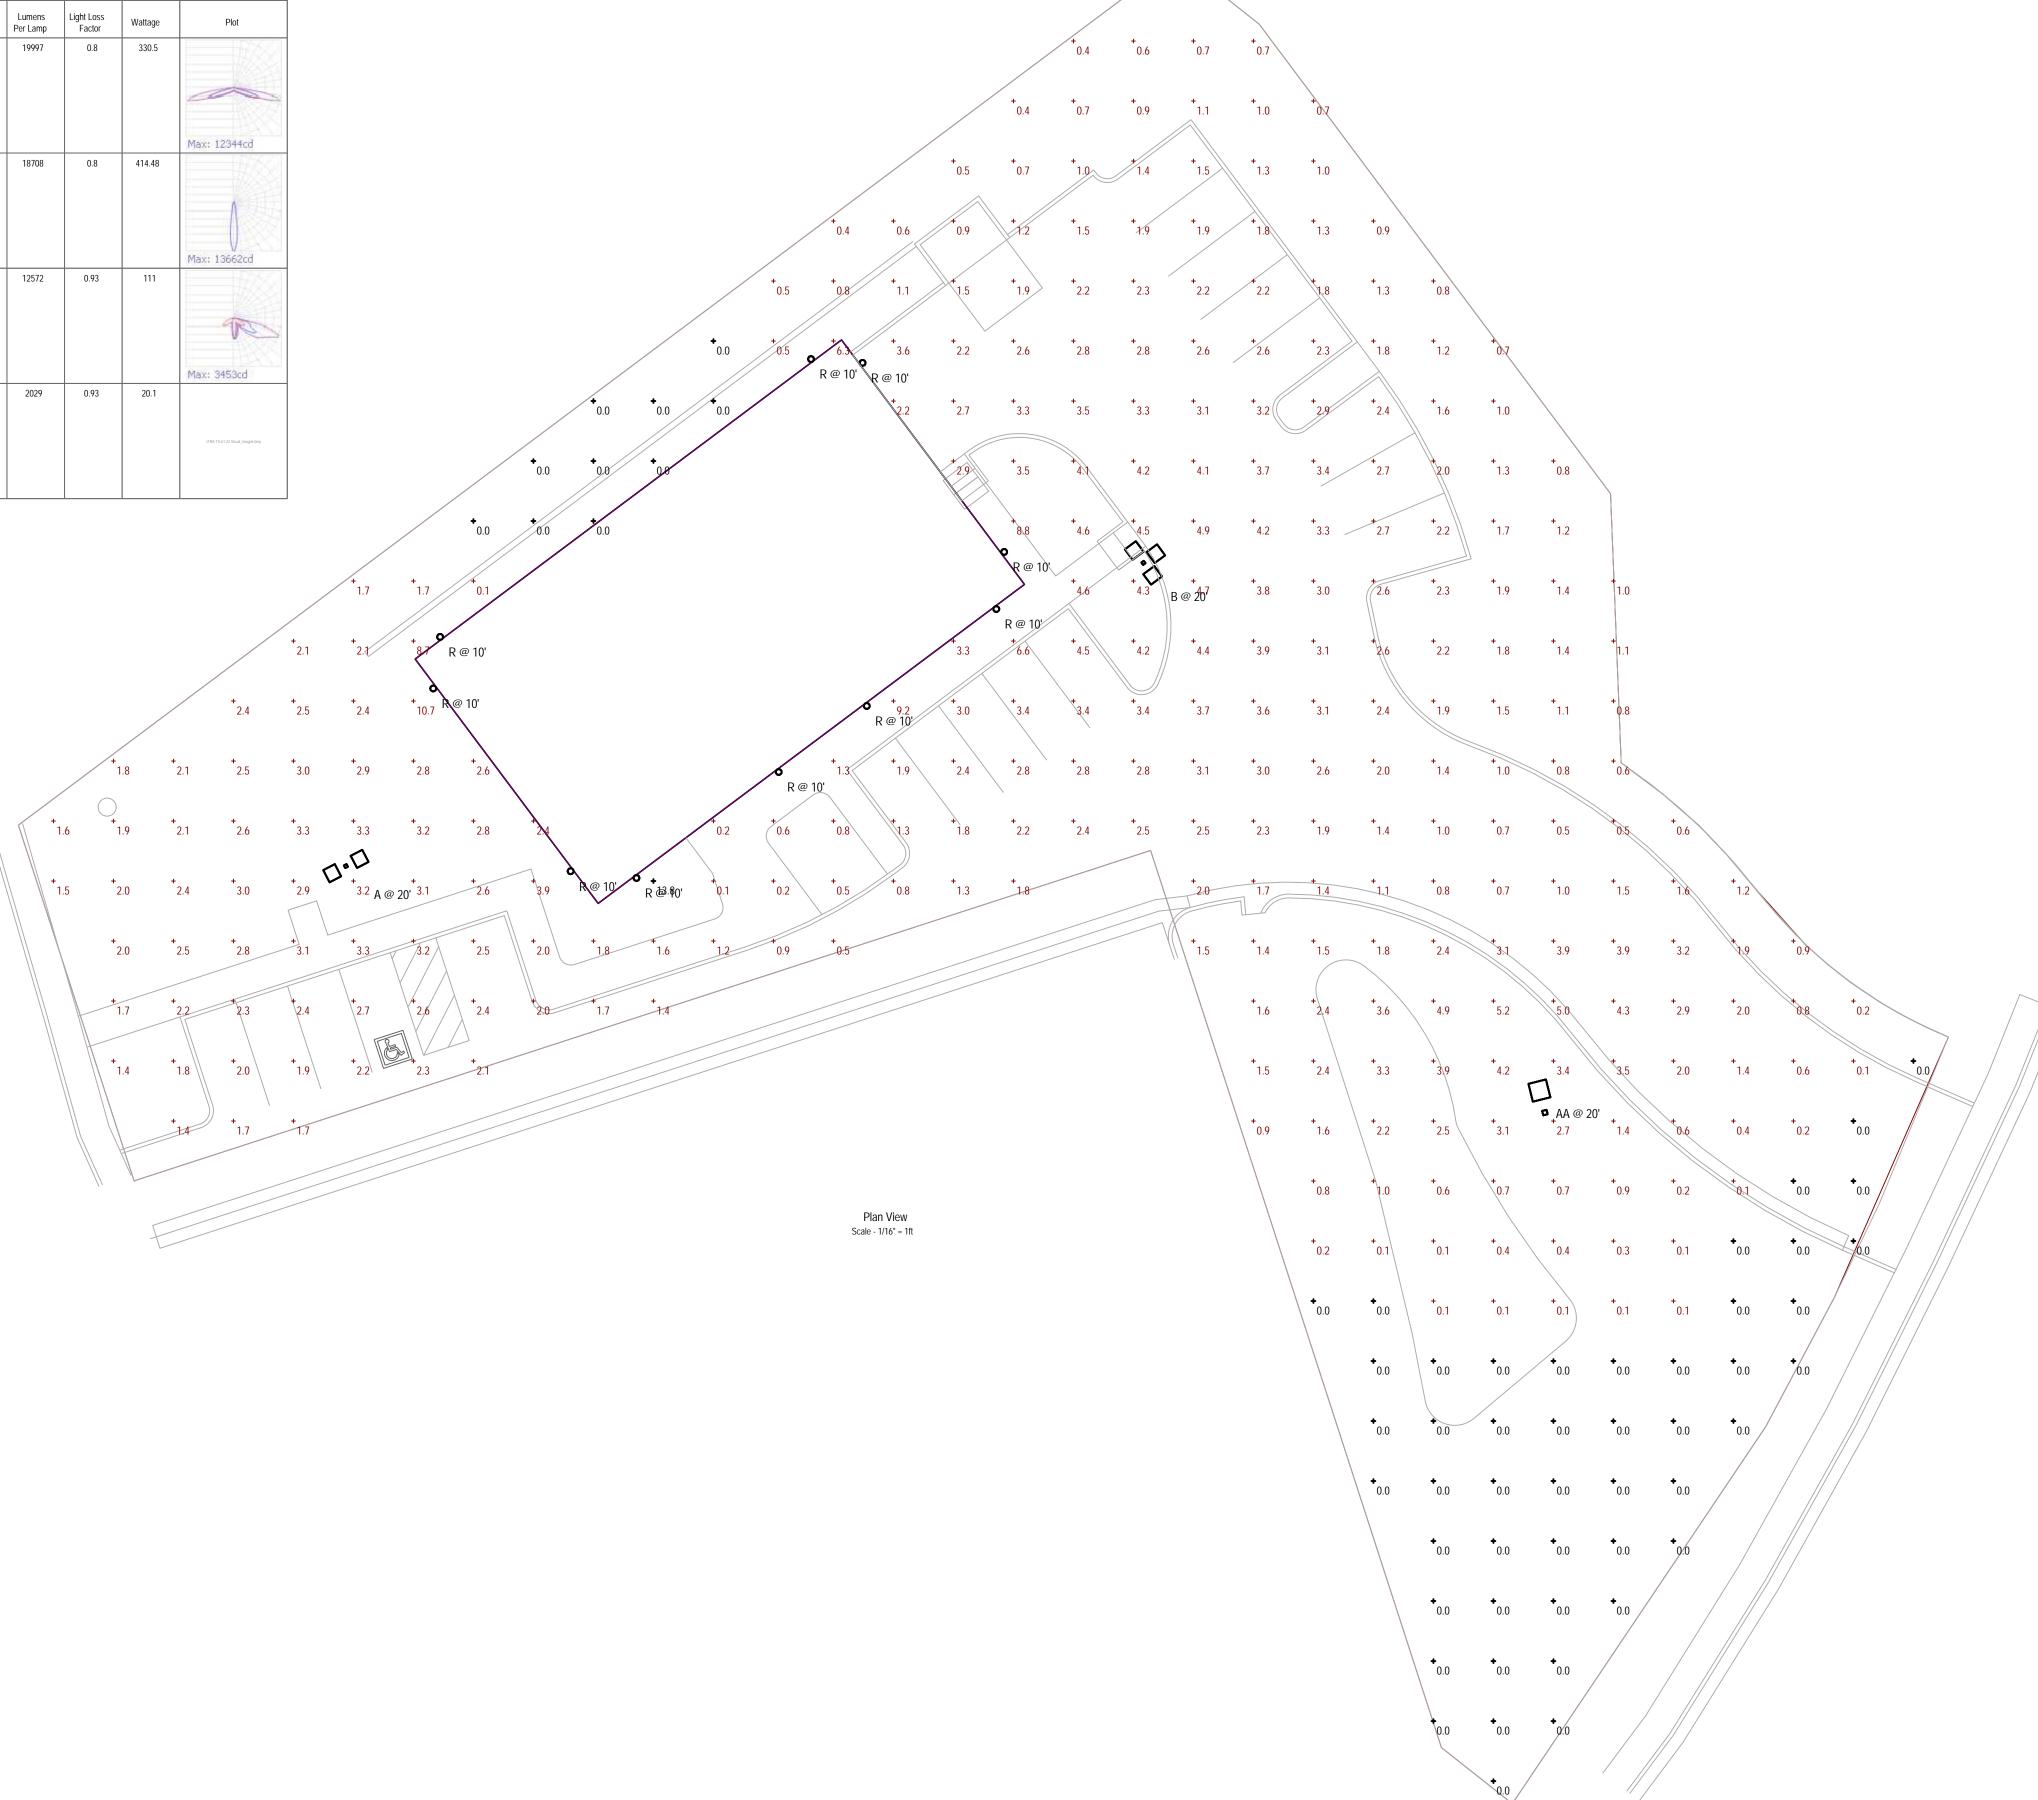



LingleDesignGroup,Inc 158 West Main Street Lena, IL 61048 815.369.9155 1764 BLAKE ST DENVER, CO 80202 303.974.5875 www.lingledesign.com

St. Louis, MO 63026

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CERTIFICATE OF AUTHORITY NO. F-20080

PLANNING SUBMITTAL - 09/27/23

SHERWIN WILLIAMS

SHEET TITLE:

SITE PHOTOMETRIC PLAN

SHEET NUMBER:


E002



SPS-0448 REV C

THE ORIGINAL™ INTEGRATED LED SERIES

FIXTURE TYPE:

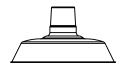

BLE -	G	- WHS12	- 150	- G22	- 150	- NA	- NA -
	A	В	С	D	E	F	G
	NA	- NA	- LED38	- 3000K	- DL		
	Н	I	J	K	L		
Order E	xample: BLE - G	- WHS16 - 600 - G22 - 9	80 - NA - ACR - 600 - N	NA - LED38 - 2700K - DL			

A - MOUNTING STYLE

С	Cord Hung
CN	Chain Hung
F	Flush Mount ¹
G	Gooseneck
S	Stem Mount

B - SHADE SIZE

THE ORIGINAL™:

WHS12	12" Shade
WHS14	14" Shade
WHS16	16" Shade
WHS18	18" Shade
WHS20 ²	20" Shade

C - SHADE FINISH

150

PORCELAIN FINISHES3: Black

	Diacit
250	White
350	Vintage Green
355	Jadite
455	Cherry Red
550	Yellow
650	Bronze
750	Cobalt Blue
765	Delphite Blue
850	Graphite
950	Metallic Chrome

4

730	Metallic Chronie
POWDER	COAT FINISHES
100	Black
105	Textured Black
106	Matte Black
200	White
206	Matte White
300	Dark Green
307	Emerald Green
311	Jadite
370	Mint
380	Chartreuse
390	Teal
400	Barn Red
420	Orange
470	Watermelon
480	Blush Pink
490	Magenta
495	Sherbet Orange
500	Buttery Yellow
570	Sunflower
600	Bronze
601	Chocolate

Rust

Oil-Rubbed Bronze

605

615

C - SHADE FINISH (CONTINUED)

POWDER COAT FINISHES4: Royal Blue

700

705	Navy
710	Cobalt Blue
715	Delphite Blue
790	Lavender
800	Industrial Grey
805	Charcoal Granite
810	Graphite
975	Galvanized

NATURAL METALS⁵:

995	Raw Copper
996	Weathered Copper
997	Raw Brass
998	Weathered Brass
999	Oil-Rubbed Copper

D - MOUNTING

Please Note: If Flush Mount [F] is selected in Section A, please select NA

NA	Not Applicable
INA	пот Аррисавіе

CSA LISTED CORDS:

SBK	Standard Black
SWH	Standard White
CSB	Black Cloth
CSW	White Cloth
CMG	Grey Cloth
CSR	Red Cloth
CRZ	Red Chevron Cloth
CSBB	Black & Brown Cloth
CSRW	Red & White Cloth
CSGW	Gold & White Cloth
CSBG	Black & Gold Cloth
CSBW	Black & White Cloth
CSBP	Black & Pink Cloth
CSUW	Blue & White Cloth

CHAIN MOUNT OPTIONS2:

TAIN M	OUNT OPTION
CN36	3' of Chain
CN48	4' of Chain
CN60	5' of Chain
CN72	6' of Chain

D - MOUNTING (CONTINUED)

GOOSEN	IECK OP	TIONS:
G1 ²	G11 ²	G26 ²
G2 ²	G12 ²	G32
G3 ^{2,6}	G13	G34 ²
G46	G14	G35 ²
G5 ²	G15	G36 ²
G6	G16 ²	G64 ²
G7	G17	G65 ²
G8	G22	
G9	G24	
G10	G25	

STEM MOUNT OPTIONS:

ST506 5" Stem Mount 6"2

31300	.5 Stelli Mourit, 0 -
ST512	.5" Stem Mount, 12"2
ST518	.5" Stem Mount, 18"2
ST524	.5" Stem Mount, 24"2
ST536	.5" Stem Mount, 36"2
ST548	.5" Stem Mount, 48"2
ST706	.75" Stem Mount, 6"
ST712	.75" Stem Mount, 12"
ST718	.75" Stem Mount, 18"
ST724	.75" Stem Mount, 24"
ST736	.75" Stem Mount, 36"
ST748	.75" Stem Mount, 48"

E - MOUNTING FINISH

Please Note: See Section C for Finish Options. 980-Brushed Aluminum is also available for Gooseneck (Except G36, G64 & G65) and Stem mounting styles. If a Porcelain shade finish is selected, mounting will be powder coat painted-to-match. Porcelain shade finishes are not available with a Natural Metal mounting finish

(I) If Cord Hung [C], selection identifies canopy finish

(II) If Chain Hung [CN] Mounting Style, selection identifies chain and canopy finish. Natural Metals are not applicable

(III) If Stem Mount [S] Mounting Style, selection identifies stem and canopy finish

(IV) If Flush Mount [F] Mounting Style, selection identifies hex coupler and canopy finish. Natural Metals are not applicable

980 **Brushed Aluminum**

F - CORDS7

Please Note: See **Section D** for all applicable CSA Listed Cord Options

NA Not Applicable

G - SHADE ACCESSORIES²

NA	None
WC	Wire Cage
ACR	Acrylic Diffuser ^{8,9}

H - SHADE ACCESSORY FINISH

Please Note: See Section C for Finish Options. Natural Metals not applicable. If Porcelain Finish is selected, accessory will be powder coat painted-to-match

Not Applicable

I - MOUNTING ACCESSORY

Please Note: Mounting Accessories below are only applicable with select Mounting Styles. Please refer to product listings on our website for further detail.

NA	None/Not Applicable
HSC	Hang Straight Canopy ^{2,10}
LDBPC	LED Decorative Backing Plate Cover ^{11,12}

LDCHX LED Decorative Backing Plate Cover & Hex Cover^{11,12}

J - LIGHT SOURCE

LED11	850 Lumen, 11W LED
LED16	1250 Lumen, 16W LED
LED27	2000 Lumen, 27W LED
LED38	3000 Lumen, 38W LED
LED43	4000 Lumen, 43W LED1

K - COLOR TEMPERATURE

2700K	2700K, Warm White
3000K	3000K, Neutral White
3500K	3500K, Bright White
4000K	4000K, Cool White


L - LED LENS

DL	Domed Lens
FL	Flat Lens

IMPORTANT: (1) Not available with Acrylic Diffuser shade accessory (2) Not available in Natural Metals (3) All Porcelain Enamel finished shades feature a white interior and a black outer rim (4) All Powder Coat finished shades, Galvanized excluded, feature a white interior (5) Natural Metals have a longer estimated manufacturing time, please check the website for exact lead time. There are no returns accepted on Natural Metals (6) Not compatible with 16" shade size and larger (7) Only applicable if Chain Hung Mounting Style selected in Section A, select NA if another Mounting Style is selected (8) Acrylic Diffuser limits the maximum lumen selection as well as reduces lumens delivered and LPW. Selection Limits: 2000 Max for 12" and 14" shades; 3000 Max for 16" through 20" shades (9) Fixture is CSA Listed for Damp Location with Acrylic Diffuser (10) Only applicable if Stem Mounting Style is selected in Section A (11) Not available with G3, G4, G11, G15, G26, & G36 Gooseneck option (12) Only applicable if Gooseneck Mounting Style is selected in Section A


MOUNTING STYLE

HIGH LUMEN CANOPY FOR PENDANT & FLUSH MOUNT

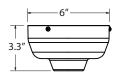


Required if LED 27, 38, 43 Light Source selected in Section J

CHAIN HUNG PENDANT (CN)

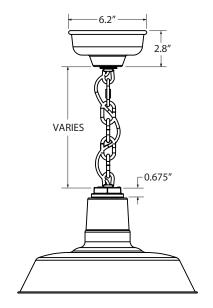


Canopy shown required if LED 11 & 16 Light Source selected in Section J

CORD HUNG PENDANT (C)

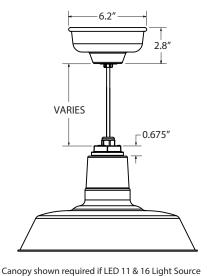


selected in Section J

FLUSH MOUNT (F)

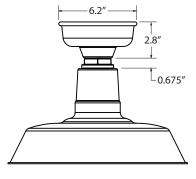


Canopy shown required if LED 11 & 16 Light Source selected in Section J

STEM MOUNT PENDANT (S)

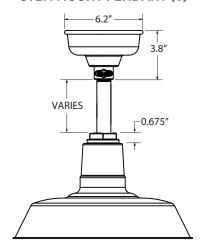


Canopy shown required if LED 11 & 16 Light Source selected in Section J

GOOSENECK (G)

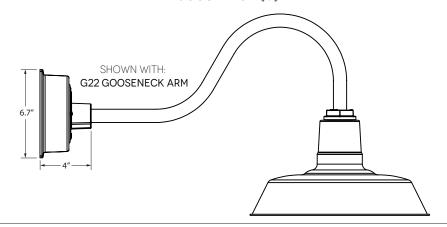

LUMINAIRE DIMENSIONS

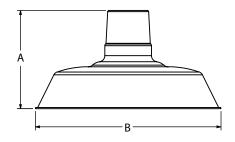

SHADE CODE	HEIGHT (A)	DIAMETER (B)
WHS12	7"	12"
WHS14	7.5″	14"
WHS16	7.75"	16"
WHS18	8.5"	18"
WHS20	9.25"	20"

LIGHT SOURCE


All published luminaire photometric testing performed to IESNA LM-79-08 standards by a NVLAP accredited laboratory. Data is considered to be representative of the configurations shown, within the tolerances allowed by Lighting Facts. To obtain an IES file specific to your project, please contact the factory.

	LUMENS	850		1250)	2000)	3000)	4000)
	Wattage	11		16		27		38		43	
	Optics	Lumens	LPW								
WHS12	FLAT	846	74	1244	78	1997	74	2996	79	3995	93
VVI1312	DOMED	824	72	1212	76	1936	72	2904	76	3872	90
WHS14	FLAT	845	74	1243	77	1982	73	2973	78	3964	92
WIISIT	DOMED	823	72	1210	75	1904	71	2856	75	3808	88
WHS16	FLAT	845	74	1243	77	1982	73	2973	78	3964	92
***************************************	DOMED	822	72	1209	75	1902	70	2854	75	3805	88
WHS18	FLAT	843	74	1240	77	1978	73	2967	78	3956	92
VVIISIO	DOMED	819	72	1204	75	1895	70	2843	75	3791	88
WHS20	FLAT	841	74	1237	77	1973	73	2959	78	3945	91
WH320	DOMED	815	72	1199	75	1887	70	2830	74	3773	87


*Acrylic Diffuser option reduces lumens delivered and LPW

LIGHT DISTRIBUTION

DOMED LENS (DL)

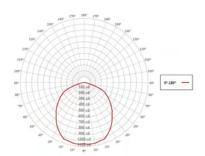


Shown above with 16" Shade (WHS16), White Interior (200-White) and 3000 Lumen (LED38)

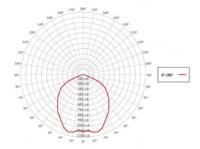


Shown above with 20" Shade (WHS20), White Interior (200-White) and 3000 Lumen (LED38)

FLAT LENS (FL)

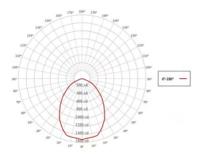

Shown above with 16" Shade (WHS16), White Interior (200-White) and 3000 Lumen (LED38)

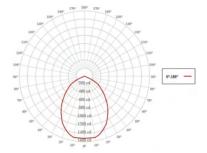

Shown above with 20" Shade (WHS20), White Interior (200-White) and 3000 Lumen (LED38)

SPECIFICATIONS

CERTIFICATIONS, LISTINGS & WARRANTY

MADE IN THE USA

Manufactured and Hand-Crafted in Our 60,000 Square Foot Facility Located in Titusville, FL

CSA LISTED FOR WET LOCATIONS

Includes All Gooseneck, Stem and Flush Mounting Styles Acrylic Diffuser is CSA Listed for Damp Locations for Gooseneck and Stem Mounting Styles

CSA LISTED FOR DAMP LOCATIONS

Includes All Chain and Select Cord Hung Mounting Styles Acrylic Diffuser is CSA Listed for Damp Locations for Chain and Cord Hung Mounting Styles

LIMITED WARRANTY

For Additional Information on Our Limited Warranty, Please See Our Terms & Conditions

OPERATING TEMPERATURE -30°C to 40°C

CONSTRUCTION & FINISH

POWDER COAT SHADE

Hand-Spun from High Purity 3003-O Temper Aluminum

GALVANIZE SHADE

Hand Spun from High Quality Galvanized Steel

PORCELAIN SHADE

Hand-Spun from 20 Gauge Porcelain Steel

POWDER COAT FINISHES

Polyester Powder Coat Finishes Are Electro-Statically Applied and Thermocured

PORCELAIN FINISHES

Applied by Hand and Fired in a High Temperature Oven

COPPER

Hand-Spun from High Purity C11000-O60 ETP Copper

BRASS

Hand-Spun from High Purity C2600-O60 Brass

STEM

1/2" Nominal (0.84" Actual) or 3/4" Nominal (1.05" Actual) Sch 40, 6063 Aluminum Mounting Stem. Custom Lengths Available upon Request.

GOOSENECK

1/2" Nominal (0.84" Actual) or 3/4" Nominal (1.05" Actual) Sch 40, 6063 Aluminum Gooseneck

CORE

Cord-Hung Pendants Include 7' of Standard Cord or 5' of Cloth Cord, +/- For Socket Orientation

CHAIN

4-Gauge Chain Complete with Quick Link for On-Site Adjustments to Chain's Length

LED LIGHT SOURCE

LED TYPE: CREE LMH2 MODULE

INITIAL LUMENS DELIVERED: UP TO 4000 LUMENS

L90(6K) > 36,300 HOURS

AVAILABLE CCT: 2700K, 3000K, 3500K, 4000K Custom Temperatures Available upon Request

90+ CRI

2 STEP MACADAMS ELLIPSE

EFFICACY: UP TO 93 LPW

High Efficacy Available upon Request, Consult Factory for Additional Information

ELECTRICAL/LED DRIVER

DRIVER TYPE: ERP ESS/T & ESP/T

POWER FACTOR > 0.9

EFFICIENCY: UP TO 87% TYPICAL

INPUT VOLTAGE: 120-277 VAC (SEE DIMMING SECTION)

CLASS 2 POWER SUPPLY

LED DRIVER LIFETIME: > 100,000 HOURS (@ 25 DEG C AMBIENT)

IP64 MINIMUM RATING CASE WITH SILICONE-BASED POTTING

PROTECTIONS

Output Open Load, Over-Current and Short-Circuit (hiccup), and Over-Temperature with Auto Recovery

CONDUCTED AND RADIATED EMI

Compliant with FCC CFR Title 47 Part 15 Class B (120 Vac), Class A (277 Vac) and EN55015 (CISPR 15) at 220, 230 and 240 Vac

COMPLIANT WITH

Complies with Energy Star® DLR (DesignLight Consortium®) and CA Title 24 Technical Requirements

DIMMING

TRI-MODE DIMMING™

Compatible with TRIAC (forward-phase or leading-edge), ELV (reverse-phase or trailing-edge) and 0-10 V Dimmers

DIMMING RANGE 1-100%

The Dimming Range Is Dependent on Each Specific Dimmer. May Not Be Able to Achieve 1% Dimming with Some Dimmers.

TRIAC AND ELV DIMMING ONLY AT 120 VAC

ELV DIMMING AT 230 VAC

Available by Request

COMPATIBLE DIMMERS

Consult Factory for Additional Information on Dimming

EVOLVE

CUSTOMER NAME	
PROJECT NAME	
DATETYPE	
CATALOG NUMBER	

EWLS L Series

LED Wall Pack

The Evolve® LED L Series Wall Pack (EWLS), The Evolve LED L-Series Wall Pack, EWLS, is a designed replacement for 50W to 250W HID, while offering significant energy savings in a long-life LED wall pack. Two-screw housing design enables a fast and simplified installation. The low-watt Egress package is designed to meet recommended illuminance requirements for egress applications such as side and rear exit doors in commercial buildings. Available with Emergency Battery Backup option.

Construction

Aluminum die cast enclosure. Integral heat sink for Housing: maximum heat transfer Impact resistant tempered glass Lens: Corrosion resistant polyester powder paint, minimum 2.0 mil thickness Paint: Color: Black, Dark Bronze, Gray & White (RAL & custom colors available) Optional = Coastal Finish Weight: 8.5lbs (4 kg)

Optical System

Lumens:	1,700 to 7,000
Distribution:	Asymmetric Forward
Efficacy:	117- 148 LPW
CCT:	2700, 3000K, 4000K, 5000K
CRI:	≥70

Electrical

Input Voltage:	120-277V & 347V
Input Frequency:	50/60Hz
Power Factor:	> 90% at rated watts
Total Harmonic Distortion:	≤ 20% at rated watts

Surge Protection

Surge Protection 10kV/5kA (Standard) 3kV/1.5kA (EMBB)

*Per ANSI C136.2-2015

Lumen Maintenance

Projected Lxx per IES TM-21-11 at 25°C

LUMEN DISTRIBUTION		LXX(10K) @ HOURS		
CODES	ES DISTRIBUTION	25,000 HR	50,000 HR	60,000 HR
17, 25 & 40	AF	L99	L99	L99
70	AF	L94	L87	L85

Note: Projected Lxx based on LM80 (≥ 10,000 hour testing). Accepted Industry tolerances apply to initial luminous flux and lumen maintenance measurements.

Luminaire Ambient Temperature Factor


AMBIENT TEMP (°C)	INITIAL FLUX FACTOR	AMBIENT TEMP (°C)	INITIAL FLUX FACTOR
10	1.02	30	0.99
20	1.01	40	0.98
25	1.00	50	0.97

Ratings

Operating Temperature:	-40°C to 50°C
Vibration:	3G per ANSI C136.31-2010
LM-79: Testing in accordance with IESNA Standards	
Controls	

Dimming:	Standard - 0-10V
Sensors:	Photo Electric Sensors (PE) available Motion Sensor

Warranty

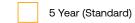

Emergency Battery Backup

Provides reliable emergency operations when there is a loss to normal power, supported by Independent Secondary Battery.

- Hold-Up Time: 90 minutes @ 1,400 lumens.
- Meet egress light level and uniformity requirements
- Not available in 347V
- Operating Temperature (for EMBB models) 0° to 40°C

• 3kV/1.5kA surge protection for EMBB models.

Not all product variations listed on this page are DLC qualified. Visit www.designlights.org/search to confirm qualifications.















LED.com



Catalog # :	Project :
Prepared By:	Date :

Mirada Small Area (MRS)

Outdoor LED Area Light













OVERVIEW		
Lumen Package	6,000 - 30,000	
Wattage Range	39 - 209	
Efficacy Range (LPW)	112 - 163	
Weight lbs(kg)	20 (9.1)	
Control Options	IMSBT, ALB, ALS, 7-Pin, PCI	



QUICK LINKS

Ordering Guide Performance Photometrics Dimensions

FEATURES & SPECIFICATIONS

Construction

- Rugged die-cast aluminum housing contains factory prewired driver and optical unit. Cast aluminum wiring access door located underneath.
- Fixtures are finished with LSI's DuraGrip* polyester powder coat finishing process.
 The DuraGrip finish withstands extreme weather changes without cracking or peeling. Other standard LSI finishes available. Consult factory.
- Shipping weight: 27 lbs in carton.

Optical System

- State-of-the-Art one piece silicone optic sheet delivers industry leading optical control with an integrated gasket to provide IP66 rated seal.
- Proprietary silicone refractor optics provide exceptional coverage and uniformity in distribution types 2, 3, 4, 5W, FT, and LC/RC.
- Silicone optical material does not yellow or crack with age and provides a typical light transmittance of 93-95%.
- · Zero uplight.
- Available in 5000K, 4000K, and 3000K color temperatures per ANSI C78.377
- Minimum CRI of 70.
- Integral louver (IL) and integral half louver (IH) options available for enhanced backlight control.

Electrical

- High-performance driver features overvoltage, under-voltage, short-circuit and over temperature protection.
- 0-10V dimming (10% 100%) standard.
- Standard Universal Voltage (120-277 VAC) Input 50/60 Hz or optional High Voltage (347-480 VAC).
- L70 Calculated Life: >60k Hours
- Total harmonic distortion: <20%
- Operating temperature: -40°C to +50°C (-40°F to +122°F). 30L lumen packages rated to +40°C.
- Power factor: >.90
- · Input power stays constant over life.
- Field replaceable 10kV surge protection device meets a minimum Category C Low operation (per ANSI/IEEE C62.41.2).
- High-efficacy LEDs mounted to metal-core circuit board to maximize heat dissipation
- Driver is fully encased in potting material for moisture resistance and complies with FCC standards. Driver and key electronic components can easily be accessed.

Controls

- Optional integral passive infrared Bluetooth™ motion and photocell sensor. Fixtures operate independently and can be commissioned via iOS or Android configuration app.
- LSI's AirLink™ wireless control system options reduce energy and maintenance costs while optimizing light quality 24/7.

Installation

- Designed to mount to square or round poles.
- A single fastener secures the hinged door, underneath the housing and provides quick & easy access to the electrical compartment.
- Included terminal block accepts up to 12 ga.
- Utilizes LSI's traditional B3 drill pattern.

Warranty

 LSI luminaires carry a 5-year limited warranty. Refer to https://www.lsicorp.com/resources/terms-conditions-warranty/ for more information.

Listings

- Listed to UL 1598 and UL 8750.
- Meets Buy American Act requirements.
- IDA compliant; with 3000K color temperature selection.
- Title 24 Compliant; see local ordinance for qualification information.
- Suitable for wet locations.
- IP66 rated Luminaire per IEC 60598-1.
- 3G rated for ANSI C136.31 high vibration applications are qualified.
- IK08 rated luminiare per IEC 66262 mechanical impact code
- DesignLights Consortium® (DLC) qualified product. Not all versions of this product may be DLC qualified. Please check the DLC Qualified Products List at www.designlights.org/QPL to confirm which versions are qualified.

