### **ABBREVIATIONS:**

AR ANCHOR BOLT AB. AGGREGATE BASE ABV. ABOVE ACOUST ACOUSTICAL AD. AREA DRAIN ADJ. ADJUSTABLE AHJ. AUTHORITY HAVING ALUM. ALUMINUM ALT ALTERNATE ARCH. ARCHITECT(URAL) BITUM, BITUMINOUS BLDG, BUILDING BLK, BLOCK BLKG. BLOCKING BM. BEAM BTM. BOTTOM BD. BOARD BUR. BUILT-UP ROOF CAB, CABINET CB. CATCH BASIN CEM. CEMENT CER. CERAMIC CFCI. CONTRACTOR FURNISHEDCONTRACTOR INSTALLED CEOL CONTRACTOR FURNISHEDOWNE INSTALLED CJ. CONSTRUCTION (CONTROL) CL CENTER LINE CLG CEILING CMU. CONCRETE MASONRY COL. COLUMN

CNTR. COUNTER

CTR. CENTER

DIA DIAMETER DIAG DIAGONAL

DISP DISPENSER

DEG. DRAWING

EL ELEVATION

ENCLENCLOSURE

EQUIP. EQUIPMENT

EXIST. (E) EXISTING

EXP. EXPANSION

F.A. FIRE ALARM

F.D. FLOOR DRAIN FDN. FOUNDATION

F.F. FINISH FLOOR

FIN. FINISH FLASH. FLASHING

SCREW

FLR. FLOOR

F.E. FIRE EXTINGUISHER

H.C. FIRE HOSE CABINET

F.H.W.S. FLAT HEAD WOOD

FLOUR. FLUORESCENT F.O.C. FACE OF CONCRETE

FR. FRAME F.T. FIRE-RETARDANT TREATED

F.O.F. FACE OF FINISH

F.O.S. FACE OF STUD

FT. FOOT OR FEET FURR. FURRING

GALV. GALVANIZED G.I. GALVANIZED IRON

GND. GROUND GWB. GYPSUM WALLBOARD

GYP, BD, GYPSUM BOARD

I.D. INSIDE DIAMETER (DIM.)

GA. GAUGE

GL GLASS

GYP, GYPSUM

H.B. HOSE BIBE H.C. HOLLOW CORE

HOWD HARDWOOD

H.M. HOLLOW METAL

HORIZ, HORIZONTAL

INSUL INSULATION

HE HOUR

EQ. EQUAL

COOLER

ELEC. PNL. ELECTRICAL PANEL E.W.C. ELECTRIC WATER

JAN. JANITOR JT. JOINT LAM. LAMINATE LAV. LAVATORY LBS POUNDS LVR. LOUVER MACH. MACHINE MATLMATERIAL MAX. MAXIMUM M.B. MACHINE BOLT M.C. MEDICINE CABINET MECH. MECHANICAI MFR. MANUFACTURER MIN. MINIMUM MIR. MIRROR MISC. MISCELLANEOUS M.O. MASONRY OPENING MTD. MOUNTED MTL METAL NEW NORTH N.J.C. NOT IN CONTRACT NO. OR # NUMBER NOM. NOMINAL N.T.S. NOT TO SCALE O.C. ON CENTER OUTSIDE DIAMETER (DIM.) OFFICE OWNER FURNISHED OWNER INSTALLED OPENING OPP. OPPOSITE P.D.F. POWDER DRIVEN FASTENER PERF.PERFORATED PNL PANEL PL PLATE PLAS.LAM. PLASTIC LAMINATE PLYWOOD P.T.D. PAPER TOWEL DISPENSER P.T.D./R COMBINATION PAPER TOWEL DISPENSER & RECEPTACLE PART.PARTITION PIR PAPER TOWEL RECEPTACLE Q.T. QUARRY TILE RISER/RADIUS ROOF DRAIN REF. REFERENCE REFERENCERATOR REINFORCE(D). (ING) REQD. REQUIRED REQUIREMENTS
RESIL. RESILIENT R.O. ROUGH OPENING RWD. REDWOOD R.W.L. RAIN WATER R.W.L. LEADER S.C. SOLED CORE S.C.D.DEAR COVER DISPENSER SCHED. SCHEDULE S.A. SOAP DISPENSER SECT.SECTION SH. SHELF SHWR. SHOWER SHT. SHEET SIM. SIMILAR S.N.D.SANITARY NAPKIN DISPENSER S N R SANITARY NAPKIN RECEPTACLE SPEC. SPECIFICATION E.C. FIRE EXTINGUISHER SQUARE STL STAINLESS STEEL

STL STEEL

STRUCTURAL

STOR. STORAG STRUCT. OR STR. STORAGE

T. TREAD
T.D. TRENCH DRAIN

T. & G. TONGUE AND

T.O.P.TOP OF PAVEMENT

TOW TOP OF WALL T.P.D. TOILET PAPER

T.S.B. TOP SET BASE

TYP. TYPICAL U.N.O. UNLESS NOTED OTHERWISE

V.C.T. VINYL COMPOSITION TILE

T.V. TELEVISION

TEL. TELEPHONE

GROOVE THK. THICK(NESS) T.O.B.TOP OF BEAM

F.O.C. TOP OF T.O.S.TOP OF SLAB

DISPENSER TRANS. TRANSFORMER

UR URINAL

LI/S LINDERSIDE

VERT.VERTICAL

VEST. VESTIBULE

W/WITH W.C. WATER CLOSET

SUSPEND(ED)

TOP OF CURB

CONC. CONCRETE CONN. CONNECTION CONT. CONTINUOUS CORR. CORRIDOR CSK. COUNTERSUNK DEPT. DEPARTMENT D.F. DRINKING FOUNTAIN DN. DOWN DWR. DRAWER DS. DOWNSPOUT EA. EACH EJ. EXPANSION JOINT ELEC. ELECTRICAL ELEV. ELEVATOR

**GENERAL NOTES:** 

#### CONTRACTOR RESPONSIBILITIES

- THE CONTRACTOR SHALL EXAMINE THE DRAWINGS AND SPECIFICATIONS AND SHALL NOTIFY THE ARCHITECT OF ANY DISCREPANCIES HE MAY FIND BEFORE PROCEEDING WITH THE WORK.
  THE CONTRACTOR SHALL VERIFY CONDITIONS AT THE SITE AND REPORT ANY DISCREPANCIES
- TO THE ARCHITECT REFORE PROCEEDING WITH THE WORK.
- THE CONTRACTOR SHALL NOTIFY UNDERGROUND SERVICE ALERT PRIOR TO ANY EXCAVATING. THE CONTRACTOR SHALL VERIFY THE LOCATION OF ALL EXISTING UTILITIES BELOW GRADE AND RELATED SERVICE CONNECTIONS WITH UNDERGROUND SERVICE ALERT (USA), UTILITY
- THE CONTRACTOR SHALL COORDINATE REMOVAL, ABANDONMENT AND/OR RELOCATION OF EXISTING UTILITIES ABOVE OR BELOW GRAND WITH THE RESPECTIVE UTILITY PROVIDER AND
- THE CONTRACTOR SHALL PERFORM ALL WORK WITHIN STREET TIGHT-OF-WAYS ACCORDING TO THE APPROVED CITY STANDARD PLANS AND SPECIFICATIONS.
- THE CONTRACTOR SHALL PROVIDE TEMPORARY BRACES, SHORES, AND GUYS REQUIRED TO SUPPORT ALL LOADS TO WHICH THE BUILDING STRUCTURES AND COMPONENTS, ADJACENT SOILS, AND STRUCTURES, UTILITIES, AND RIGHT-OF-WAYS MAY BE SUBJECT TO DURING
- FLOOR AND WALL OPENINGS, SLEEVES, VARIATIONS IN THE STRUCTURAL SLAB ELEVATIONS, DEPRESSED AREAS, AND ALL OTHER ARCHITECTURAL, MECHANICAL, CONTRACTOR PROCEEDS

#### CONSTRUCTION DOCUMENTS

- ALL DRAWINGS, ISSUED SEPARATELY AS CONSTRUCTION PACKAGES INCLUDING ALL DETAILS, SPECIFICATIONS, AND SCHEDULES, BOUND SEPARATELY, ARE PART OF THE CONTRACT
- 2. ITEMS MARKED "N.I.C." ARE NOT IN CONTRACT, SUCH ITEMS ARE INCLUDING IN THE DOCUMENTS WHEN CONTRACTORS COORDINATION FOR CONSTRUCTION IS REQUIRED
- DIMENSIONS: A) IN NO CASE SHALL WORKING DIMENSIONS BE SCALED FROM PLANS, SECTIONS, OR DETAILS ON DRAWING. B) ALL DIMENSIONS TO OPENINGS ARE TO THE FINISHED FACE UNLESS NOTED OTHERWISE. C) ALL DIMENSIONS TO STUD PARTITIONS ARE TO THE FACE OF FINISH UNLESS NOTED F.O.S. (FACE OF STUD). D) CEILING HEIGHT DIMENSIONS ARE FROM FINISH FLOOR TO FINISH FACE OF CEILING. E) ALL DIMENSIONS SHALL BE VERIFIED IN THE FIELD REFORE PROCEEDING WITH THE WORK
- DETAILS MARKED "TYPICAL" SHALL APPLY IN ALL CASES UNLESS SPECIFICALLY NOTED OTHERWISE.
- WHERE NO SPECIFIC DETAIL IS SHOWN, THE FRAMING, OR CONSTRUCTION SHALL BE IDENTICAL
- OR SIMILAR TO THAT INDICATED FOR LIKE CASES OF CONSTRUCTION ON THE PROJECT.
  PROVIDE AND INSTALL U.L. APPROVED FIRE STOPPING AND WRAPS AT ALL PENETRATIONS PER CHAPTER 7 OF THE CALIFORNIA BUILDING CODE AND THE CA FIRE CODE. SEE DRAWINGS FOR TYPICAL DETAILS.
  7. DOOR SIZES INDICATED ON DOOR SCHEDULE ARE DOOR DIMENSIONS. ALLOWANCES FOR
- THRUSH HOLDS SHALL BE TAKEN OFF DOOR HEIGHT.
  REGARDLESS OF OCCUPANT LOAD, THERE SHALL BE A FLOOR OR LANDING ON EACH SIDE OF THE DOOR. THE FLOOR LANDING SHALL NOT BE MORE THAN  $\frac{1}{2}$  " LOWER THAN THE THRUSH HOLD
- OF THE DOORWAY.

  9. THE PRECISE DIMENSIONS AND LOCATIONS OF ALL DOOR LOUVERS AND WINDOW OPENINGS SHALL BE DETERMINED FROM ARCHITECTURAL PLANS AND DETAILS. OTHER WALL AND FLOOR OPENINGS AS REQUIRED BY MECHANICAL, ELECTRICAL, OR SIMILAR REQUIREMENTS SHALL BE VERIFIED FROM SHOP DRAWINGS, EQUIPMENT DATA, ETC. AS REQUIRED.
- 10. DOOR OPENINGS NOT LOCATED BY DIMENSIONS SHALL BE CENTERED IN WALLS AS SHOWN OR
- DOOR OF HINGS NOT COATED BY MINENSIONS BRINGLES CONTINUED AS LOCATED 5" FROM FINISH WALL TO FINISH JAMB UNLESS OTHERWISE NOTED.

  11. SEE ARCHITECTURAL CEILING PLANS FOR DIMENSIONS LOCATED LIGHT FIXTURES, DIFFUSERS, AND SPEAKERS. ARCHITECTURAL REFLECTED CEILING PLANS DO NOT. INDICATE WALL MOUNTED FIXTURES. REFER TO ELECTRICAL DRAWINGS FOR ALL LIGHTING FIXTURE - RECESSED, SURFACE, OR WALL MOUNTED.
- 12. CEILING SUSPENSION SYSTEM SHALL PROVIDE FOR CEILING SYSTEM ONLY. ADDITIONAL INDEPENDENT FRAMING FOR LIGHTING FIXTURE, EXIT SIGNS, GRILLES, AIRBARS, AND AIR CONDITIONING DIFFUSERS SHALL BE REQUIRED. ATTACHMENT OF HANGERS OR FRAMING TO DUCTWORK IS PROHIBITED.
- 13. WHERE LARGER STUDS OR FURRING ARE REQUIRED TO COVER DUCTS, PIPING, CONDUITS, ETC., THE LARGER STUD SIZE OR FURRING TO EXTEND FULL WIDTH OF WALL SURFACE WHERE FURRING OCCURS.
- SURFACE WHERE FORMING OCCURS.

  PROVIDE ADEQUATE ANCHORAGE, BLOCKING, BACKING, AND FRAMING FOR FIRE SPRINKLERS, PIPING, LIGHT FIXTURES, ELECTRICAL UNITS, HVAC EQUIPMENT, DRAPERY, AND CEILING TRACKS AS REQUIRED FOR A COMPLETE INSTALLATION.
- AND CEILING I HAVING AS REQUIRED FOR A COMPLETE INSTRUCTION OF A CARRIED AND A CARRIED WITH ONE HOUR OR TWO HOURS FIRE RESISTIVE CONSTRUCTION AS REQUIRED, ELECTRICAL PANELS AND/OR WIRING SYSTEMS SHALL NOT BE LOCATED IN CORRIDOR OR SHAFT WALLS.
- ALL STEEL STUD SIZES AND SPACING IN GYPSUM BOARD WALLS HALL BE IN ACCORDANCE WITH UNDERWRITER LABORATORIES, INC. FOR RATED ASSEMBLIES. SUBMIT DATA FOR APPROVAL
- SUBMIT DATA FOR APPROVAL.

  ALL SINGLE LAYER GYPSUM BOARD WALLS CONTINUOUS AND CONTIQUOUS WITH
  DOUBLE LAYER GYPSUM BOARD SHALL MAINTAIN ONE CONTINUOUS OUTER LAYER OF
  GYPSUM BOARD AT THE SANE FACE OF FINISH. METAL STUDS AND FURRING CHANNELS SHALL BE OFFSET ACCORDINGLY. WALL AND COLUMN GYPSUM BOARD FACING ON OTHER THAN FIRE AND SOUND
- RATED WALLS SHALL EXTEND 6' MINIMUM ABLE CEILING HEIGHT.
- 19. GYPSUM BOARD ON INTERIOR METAL STUDS SHALL BE \$" THICK UNLESS NOTED OTHERWISE.

#### MECHANICAL AND PLUMBING

- 1 CEILING ACCESS PANELS SHALL BE PROVIDED BY THE MECHANICAL FIRE SPRINKLER AND CHILING ACCESS PARELS SHALL BE PROVIDED BY THE MILE SHAPERS, PUCTWORK, FIRE DAMPERS, ETC., AND AS REQUIRED OR AS DIRECTED BY THE ARCHITECT.
  FIRE SPRINKLERS SHALL BE REVIEWED AND APPROVED BY THE FIRE MARSHALL AND
- DESIGN TEAM PRIOR TO INSTALLATION.
  3. PIPE SLEEVES IN MECHANICAL EQUIPMENT ROOMS SHALL EXTEND 2" ABOVE THE FLOOR LINE. ELECTROLYSIS PROTECTION SHALL BE PROVIDED BETWEEN ALL DISSIMILAR METALS WHEREVER THE TWO ARE IN CONTACT.

#### TYPICAL NOTES

- "SIMILAR" MEANS COMPARABLE CHARACTERISTICS FOR THE CONDITIONS NOTED. VERIFY DIMENSIONS AND/OR ORIENTATIONS ON PLAN AND/OR ELEVATIONS. DIMENSIONS ARE NOT ADJUSTABLE WITHOUT APPROVAL OF ARCHITECT IN WRITING.
- 3 UNDERCUT ALL DOORS TO CLEAR TOP OF CARPET !" MAXIMUM

## CONTINUALLY OF ABBREVIATION:

VD. YARD WOW WINDOW &.AND @.AT CENTERLINE W.P WATERPROOF WNSCT.WAINSCOT WT. WEIGHT Ø.DIAMETER OR ROUND #. ROUND OR NUMBER \*.SQUARE FOOT (FEET) W.W.F. WELDED WIRE FABRIC

#### SYMBOLS:



COLUMN LINE LETTERS IN ONE DIRECTION NUMBERS IN THE

99.9999

CLOUD AND REVISION

SECTION A1.01/ DRAWING WHERE DETAIL IS DRAWN

DETAIL IDENTIFICATION

INTERIOR ELEVATION(S)

ELEVATION IDENTIFICATION (UNFOLD ELEVATIONS CLOCKWISE)

ROOM IDENTIFICATION

OCCUPANCY -----USE

## **MATERIALS:**

A1.01













WOOD FRAMING



PLYWOOD













INSULATION, BATT

DOOR SYMBOL

WORK POINT. CONTROL POINT, OR DATUM POINT

REVISION

SECTION IDENTIFICATION

DETAIL

DETAIL BACK REFERENCE

DETAIL BACK REFERENCE











WOOD FRAMING THROUGH MEMBERS



WOOD, FINISH



GLASS





**PROJECT** 

LOCATION

DRIVE THRU RESTAURANT PARKING 8 TOTAL PARKING -40 STALLS DRIVE THRU RESTAURANT STALL PARKING-C-STORE BUILDING AREA 3200/250 SF REQUIRED PARKING 12 STALL EXPRESS CARWASH AREA 2,400 SF

ACCESSIBLE STALLS REQUIRED -2 STANDARD STALLS -6

EV, PARKING -2 DETAIL GARAGE PARKING- 2 SPACES

EXPRESS CAR-WASH VACUUM STATION

4 SPACE FOR EACH SERVICE SPACE FOR OFFICE DRIVE TRUE RESTAURANTS 1,740 SF

SHEET INDEX:

PARKING:

PARKING -8 SPACES MPD, PARKING -12

SHEET NUMBER SHEET TITLE T-1.0 TITLE AND CODE SHEET

GENERAL INFORMATION G-1.0 CIVIL: TOPOGRAPHIC SURVEY EXISTING SITE PLAN NEIGHBORHOOD SITE PLAN C-1.1 C-1.2 EROSION PLAN

ACCESSIBLE PARKING PLAN C-2.0 C- 2.1 NEW PROPOSED SITE PLAN C- 3.0 ADA COMPLIANCE RESTROOM ADA INFORMATIONAL NOTES LANDSCAPE PLAN

ARCHITECTURAL

GENERAL

A-1.0 C-STORE FLOOR PLAN AND ELEVATIONS ,ROOF PLAN AND DRIVE TRUE RESTAURANT

A-2.0 EXPR.CARWASH BUILDING PLAN, ELEVATIONS & ROOF PLAN
A-3.0 DETAILING GARAGE PLAN , ROOF PLAN & ELEVATIONS

A-4.0 GAS STATION PLAN & ELEVATIONS A-5.0 TRASH INCLOSURE A-6.0 COLOR ELEVATION

APPLICABLE CODES:

2021 CALIFORNIA BUILDING CODE

2021 CALIFORNIA MECHANICAL CODE

2021 CALIFORNIA ELECTRICAL CODE

2021 CALIFORNIA PLUMBING CODE

2021 CALIFORNIA GREEN BUILDING

ORDINANCE NO. 2020-0029

STANDARDS SACRAMENTO CITY

2018 NFPA 10 STANDARDS FOR PORTABLE

2016 EDITION NFPA 24 INSTALLATION OF

2016 NFPA 13 STANDARD FOR INSTALLATION

PRIVATE FIRE SERVICE MAINS AND THEIR

**AUTHORITIES HAVING JURISDICTION:** 

2021 CALIFORNIA ENERGY CODE

FIRE EXTINGUISHER

OF FIRE SPRINKLERS

APPURTENANCES

CITY OF GRASS VALLEY

2021 CALIFORNIA FIRE CODE

ELECTRICAL: OUTSIDE LIGHTING SITE PLAN

MECHANICAL NOT USED PLUMBING

NOT USEFD

SAND/ MORTAR/ PLASTER



CONCRETE COST-IN-PLACE



INTERRUPTED MEMBERS

ACOUSTICAL TILE OR BOARD

PROJECT INFORMATION: 035-300-007-000

**PROJECT TEAM:** 

Dn & B Inc 1912 Nevada City Hwy, Grass Valley, CA

APPLICANT/ENGINEER:

BOULEVARD CONSTRUCTION INC.

Sacramento, CA 95834

Phone: 916-529-398

OWNER:1 Sr Grass Valley LLC.

2649 GIOMO WAY

LOT SQ FT 18731

OWNER: 2

CITY OF GRASS VALLEY

ZONING: SUMMARY:

DEMOLITION OF EXISTING C- STORE, CAR SERVICE STATION AND EXTENSION OF MPDs FROM THREE TO SIX DEMOCRITION OF EASIMGE & STORE, LARK SERVICE STATION AND EXTENSION OF MYDS FROM THREE MYPDS, EXTENSION OF CANOPY UP TO 29/12 SF, EXTENSION OF CASTORE BUILDING UP TO 4286 SF CONSTRICTION OF NEW AUTO EXPRESS CAR WASH WITH 100FT TURNEL, NEW QSR.

PROJECT AREA:

OCCUPANCY GROUP: M-B

SPRINKLER EXIST VES

CONSTRUCTION TYPE: Type -V

EXISTING BUILDING AREA (SF): = 2.088 SF C-STORE BUILDING AREA
DRIVE TRUE RESTAURANTS -3200 SF = 1740 SF EYPRESS CARWASH AREA = 2400 SF DETAILING SHOP BUILDING VACCUM PARKING CANOPY 1- LOT AREA (SF): = 18.731 SF 2- LOT AREA (SF): = 37462 S TOTAL LOT AREA

C-12648 06-30-2023 OF CALIFOR Robert A Massette

PROJECT\_MANAGER: Zaman Hamim 4080 Truxel Road armento, Ca. 95834 (916) 529-3982

ARCHITECT OF RECORD. 

ANRO TRUXEL ROAD SACRAMENTO, CA 95834 PHONE: (916) 892-9949 FAX: (916) 283-7501

pm@theboulevard.us www.boulevard.com

TATION / H CENTER Y HWY A 95945 <u></u> ₹

SED GAS STA S CARWASH C NEVADA CITY I PROPOSE EXPRESS ( 1912 NE' GRASS V **PROJE**(



CURRENT ISSUE DATE 12/14/22 ISSUED FOR PERMIT REVIEW

DRAWN BY: BOULEVARD APPROVED:

TITLE AND CODE SHEET

SHEET #

T-1.0

**ATTACHMENT 5** 

#### **GENERAL CONDITIONS**

- ALL WORK SHALL COMPLY WITH LOCAL CODES AND ORDINANCES. EXCLUSION OF SAID ITEMS FROM DRAWINGS OR SPECIFICATIONS DOES NOT RELEASE. THE CONTRACTOR FROM COMPLIANCE WITH ABOVE MENTIONED CODES. AND ORDINANCES.
- 2. VERIFY ALL CONDITIONS ON SITE, NOTIFY ARCHITECT IN WRITING OF ANY DISCREPANCY BETWEEN ACTUAL
- 3. ALL NAILING PER CBC CURRENT EDITION
- 4. DOORS EXTERIOR
  A. HOLLOW METAL WITH PRESSED METAL FRAME.
  - ALL EXTERIOR DOORS TO BE WEATHERSTRIPPED.
  - DOORS INTERIOR:
- PRE-HUNG VERTICAL GRAIN DOUGLAS FIR SOLID STILE AND RAIL MULTIPLE PANEL.
- CASEWORK
  PROVIDE ALL WOOD CASEWORK AND CABINETS AS INDICATED COMPLYING WITH WIC MANUAL OF MILLWORK,
  LATEST EDITION FOR CUSTOM GRADE, FINISH AS DETERMINED BY OWNER. PARTICLE BOARD AND HARDWOOD
  PLYWOOD SHALL COMPLY WITH LOW FORMALDEHYDE EMISSION STANDARDS.
- INSTALLATION PER MANUFACTURERS RECOMMENDATIONS
- WOOD INTERIOR TRIM
  INCLUDES ALL STANDING AND RUNNING WOOD TRIM MEMBERS WHICH ARE NOT STRUCTURAL IN NATURE,
  MILLWORK, INTERIOR JAMBS, AND RAILINGS. SPECIES: PINE, WIC GRADE CUSTOM, FINISH AS DETERMINED BY OWNER.
  MINIMUM STANDARDS FOR FINISH CARPENTRY AND MILLWORK SHALL COMPLY WITH MANUAL OF MILLWORK STANDARDS
  OF INDUSTRY ADOPTED BY WIC, LATEST EDITION. PARTICLE BOARD HARDWOOD PINOD SHALL COMPLY WITH LOW FORMALDEHYDE EMISSIONS STANDARDS
- EXISTING HYAC
  SELECT EQUIPMENT PER ACCA 38-S AND SIZE DUCTS PER ACCA 29-D. VERIFY LOCATION OF
  REGISTERS PRIOR TO INSTALLATION. PROVIDE CERTIFICATION OF TITLE 24 ENERGY COMPLIANCE.
- PAINT
  WOOD, AND RESTROOM WALLS AND CEILINGS: ALKYD ENAMEL, ALL OTHER WALLS AND CEILINGS: LATEX ENAMEL.
  ALL PAINTS, STAINS AND OTHER COATINGS SHALL COMPLY WITH VOC LIMITS.
  - OIL AND WAX SHALL COMPLY WITH VOC LIMITS.
- 10. VERIFY ALL ELECTRICAL FIXTURE LOCATIONS PRIOR TO INSTALLATION.
- THE CONTRACTOR SHALL GUARANTEE ALL WORK IN GENERAL FOR ONE YEAR FROM THE DATE OF ACCEPTANCE BY THE OWNER. DEGREE OF DEFECTIVES TO BE DETERMINED BY THE OWNER.
- THE ARCHITECT SHALL NOT BE RESPONSIBLE FOR CONSTRUCTION MEANS, METHODS, TECHNIQUES, SEQUENCES OR PROCEDURES OR FOR SAFETY PRECAUTIONS IN CONNECTION WITH THE WORK AND SHALL NOT BE RESPONSIBLE FOR THE CONTRACTOR'S 9. FAILURE TO CARRY OUT CORDANCE WITH THE CONTRACT DOCUMENTS.

### **ACCESSIBILITY NOTES**

- THE ARCHITECT HAS VERIFIED THAT THE ENTIRE IS GRADED/PAVED TO FULLY COMPLAINT WITH THE CODE ACCESSIBILITY THE MAXIMUM SLOPE IN ANY DIRECTIONS BEING 1.5% OR LESS, THEREFORE, SUCH SITE IS HAVE ACCESSIBLE ROUTES THROUGHOUT THE ENTIRE AREAS
- POT INDICATED ON THE SITE PLAN IS THE MOST PRACTICAL AND DIRECT ROUTE BETWEEN SITE ARRIVAL POINT AND ALL EXTERIOR PEDESTRIAN DOORS AT NEW BUILDING. EXACT LOCATION OF POT MUST BE FIELD VERIFIED, RELOCATED OR
- POT INDICATED ON THE SITE PLAN IS ALSO THE MOST PRACTICAL AND DIRECT ROUTE BETWEEN ACCESSIBLE PARKING AND ALL EXTERIOR PEDESTRIAN DOORS AT NEW BUILDING. EXACT LOCATION OF POT MUST BE FIELD VERIFIED. RELOCATED OR
- POT MUST BE MIN. 50 INCHES WIDE WITH MIN.80 INCHES HEAD CLEARANCE.
- 5. IF ANY POT IS LESS THAN 60 INCHES WIDE, THEN PASSING SPACE AT LEAST 60 INCHES X 60 INCHES MUST BE LOCATED AT
- 6. ANY POT WITH CONTINUOUS GRADIENTS MUST HAVE CLEAR LEVEL AREA WITH MAX. 2% SLOPE IN ALL DIRECTIONS AT LEAST 5 FEET IN LENGTH AT INTERVALS OF 400 FEET MAX.
- 7. EXCEPT FOR ANY REQUIRED CLEAR AREAS, POT MAY HAVE MAX. 5% SLOPE IN THE DIRECTION OF TRAVEL AND MAX. 2% CROSS
- 8. POT MAY HAVE MAX. ½ INCH LEVEL CHANGE WITHE MAX. 1.2 SLOPE. LEVEL CHANGE NOT EXCEEDING ½ INCH MAY BE VERTICAL. ANY LEVEL CHANGES EXCEEDING ½ OR ANY SLOPE IN THE DIRECTION OF TRAVEL EXCEEDING 5% MUST BE ACCOMMODATED BY CODE-COMPLAINT CURB RAMP OR RAMP.
- 9. POT SURFACES MUST BE FIRM, STABLE, SLIP-RESISTANT, W/O LOOSE GRAVELS, SAND, CHIPS, ETC.
- 10. IF ANY GRATINGS ARE LOCATED IN POT, GRID OPENINGS IN GRATINGS MUST BE LIMITED TO  $\frac{1}{2}$  INCH IN THE DIRECTION OF TRAFFIC
- 11. ABRUPT CHANGE IN LEVEL EXCEEDING 4 INCHES BETWEEN POT AND ADJACENT SURFACES (EXCLUDING STREET AND DRIVEWAY)
  DR FEATURE MUST BE IDENTIFIED BY MIN. G-INCH HIGH WARNING CURB, OR BY A GUARD OR HANDRAIL WITH A GUIDE RAIL
  CENTERED MIN.2 INCHES AND MAX. 4 INCHES ABOVE THE SURFACE OF POT.
- 12. ALL BLOG. DOORS MUST HAVE CLEAR, UNDBSTRUCTED LEVEL AREAS ON BOTH SIDES WITH MAX. 2.5% SLOPE IN ANY DIRECTION.
  CLEAR LEVEL AREA AT DOOR FRONT APPROACH IN THE DIRECTION OF DOOR SWING MUST BE MIN. BINCHES BEEP X 60 INCHES WIDE (INCLUDING MIN. 24 INCHES PASS DOOR STRIKE EDGE) ON THE EXTERIOR BOOR AND MIN.60 INCHES DIED FE XEVERIOR DOOR, AND MIN.60 INCHES DIED FY SHINCHES WIDE (INCLUDING MIN.18 INCHES PASS DOOR STRIKE EDGE) ON THE EXCENSION SIDE OF EXTERIOR DOOR, AND MIN.60 INCHES DIED X 30 UND LEGOOR WIDDIT FOR DOUBLE DOORS.
  10. CLEAR LEVEL AREA AT DOOR FRONT APPROACH IN THE DIRECTION OPPOSITE DOOR SWING MUST BE MIN.48 INCHES DEEP X 30 INCHES WIDE (INCHES WIDE) (INCHES WIDE) (INCHES PASS DOOR STRIKE EDGE) IF DOOR NAS INCHES WIDE (INCHES WIDE) (INCHES PASS DOOR STRIKE EDGE) IF DOOR NAS INCHES WIDE (INCHES WIDE) (INCHES DEEP X 30 INCHES WIDE) (INCHES WIDE) (I
- 14. ANY LEVEL CHANGES AT THE DOORWAY, INCLUDING THRESHOLD THICKNESS, MUST BE MAX. 2 INCH WMAX. 1:2 SLOPE, ANY LEVEL EEDING INCH MAY BE VERTICAL

#### CITY OF GRASS VALLEY DEPARTMENT OF UTILITIES STANDARD EROSION AND SEDIMENT

- THE CONTRACTOR SHALL FOLLOW THE GUIDELINES FOR THE CITY OF SACRAMENTO'S 'ADMINISTRATIVE AND TECHNICAL PROCEDURES SEDIMENT CONTROL' FOR THE MEASURES SHOWN OR STATED ON THESE FLANS.
- CONTRACTOR MUST ENSURE THAT THE CONSTRUCTION SITE IS PREPARED PRIOR TO THE ONSET OF ANY STORM. CONTRACTOR SHALL HAVE ALL EROSION AND CONTROC, MEASURES IN PLACE FOR THE WINTER MONTHS PRIOR TO OCTOBER 1.
- ALL EROSION AND SEDIMENT CONTROL MEASURES SHALL BE MAINTAINED UNTIL DISTURSED AREAS ARE STABILIZED. CHANGES TO THIS EROSION AND SEDIMENT CONTROL
  PLAN SHALL BE MADE TO MEET FIELD CONDITIONS ONLY WITH THE APPROVAL OF OR AT THE DIRECTION OF A REPRESENTATIVE OF THE DEPARTMENT OF UTILITIES.
- 4. THIS PLAN MAY NOT COVER ALL THE SITUATIONS THAT ARISE DURING CONSTRUCTION DUE TO UNANTICIPATED FIELD CONDITIONS, VARIATIONS MAY BE MADE TO THE PLAN IN THE FIELD SUBJECT TO THE APPROVAL OF OR AT THE DIRECTION OF A REPRESENTATIVE OF THE DEPARTMENT OF UTILITIES.
- ALL EROSION AND SEDIMENT CONTROL MEASURES SHALL BE CHECKED BEFORE AND AFTER ALL STORMS TO ENSURE MEASURES ARE FUNCTIONING PROFERLY.
- CONTRACTOR SHALL MAINTAIN A LOG AT THE SITE OF ALL INSPECTIONS OR MAINTENANCE OF BMPS, AS WELL AS, ANY CORRECTIVE CHANGES TO THE BMPS OR EROSION AND
- IN AREAS WHERE SOIL IS EXPOSED, PROMPT REPLANTING WITH NATIVE COMPATIBLE, DROUGHT-RESISTANT VEGETATION SHALL BE PERFORMED. NO AREAS WILL BE LIEFT EXPOSED OVER THE WINTER SEASON.
- THE CONTRACTOR SHALL INSTALL THE STABILIZED CONSTRUCTION ENTRANCE PRIOR TO COMMENCEMENT OF GRADINAL LOCATION OF THE ENTRANCE MAY BE ADJUSTED BY E CONTRACTOR TO PACILITATE GRADING OPERATIONS, ALL CONSTRUCTION TRAFFIC BUTTENING THE PAYED ROAD MLST GROSS THE STABILIZED CONSTRUCTION ENTRANCE. THE WILLIED CONSTRUCTION ENTRANCE SHALL REMAIN IN PLACE UNIT. THE ROAD BASE ROCK COURSE S COMPLETED.
- ALL SEDIMENT DEPOSITED ON PAVED ROADWAYS SHALL BE SWEPT AT THE END OF EACH WORKING DAY OR AS NECESSARY
- 10. CONTRACTOR SHALL PLACE AROUND ALL, NEW DRAINAGE STRUCTURE OPENINGS IMMEDIATELY AFTER THE STRUCTURE OPENING IS CONSTRUCTED. THESE SHALL BE MAINTAINED AND REMAIN IN PLACE UNTIL CONSTRUCTION IS COMPLETED.
- CONTRACTOR SHALL IMPLEMENT HOUSEKEEPING PRACTICES AS FOLLOWS:
- : MANAMENTH: GIONATED WASTE COLLECTION AREAS AND CONTAINERS. ARRANGE FOR REGULAR REMOVAL AND DISPOSAL CLEAR SITE OF TRASH INCLIDING ORGANIC DEERIS, IATERIALS, SCRAP OR SURFLUS BUILDING MATERIALS AND DOMESTIC WASTE DALY.
- MATERIAL BELIVERY AND STORAGE:
  PROVIDE A DESIGNATED MATERIAL STORAGE AREA WITH SECONDARY CONTAINMENT SUCH AS BERUING, STORE MATERIAL ON PALLETS AND PROVIDE COVERING FOR SOLUBLE MATERIALS, RELOCATE STORAGE AREA INTO BUILDING SHELL WHEN POSSIBLE INSPECT AREA WEBSLY.
  CONCRIETE WASTER.

Last undated: 09/23/21

MATERIALS. RELOCATE STORAGE AREA INTO BUILDING S'ELL WHEN PUSSIEL INVESTED AND WEST. AND WEST.

CONCISETE WASTER TO MAKE A TRAIN PARK AND A TEATHORAGY FIT. TO BE USED FOR CONCISETE TRUCK WASH-OUT, DISPOSE OF HARDERD CONCRETE OF SITE. AT NO TIME S'HUL. A
PROVIDE IN BESIGNOUS TO WASTER AND CLEAN ITS TRUCK INTO THE CITY STORM DRAINS VIA CURS AND GUITTER. INSPECT DALY TO CONTROL RUNOFF, AND WESTLY FOR
RESIGNOU, OF HANDERD CONCISETE.

D. PAINT AND PAINT SUPPLIES:
PROVIDE INSTRUCTION TO DE URINO YESS AND SUSCONTRACTORS REGARDING REDUCTION OF POLLUTANTS INCLUDING MATERIAL STORAGE, USE, AND CLEAN UP, INSPECT SITE
WESTLY FOR EVIDENCE OF IMPROPER DISPOSAL.

VERICLE FULLING, MAINTENANCE AND CLEANING.

PROVIDE IN DESIGNATED FULLING AREA WITH SECONDARY CONTAINMENT SUCH AS BERWING. DO NOT ALLOW MOBILE FUELING OF EQUIPMENT, PROVIDE EQUIPMENT WITH DRIP
PINS, RESTRICT ONSITE MAINTENANCE AND CLEANING OF EQUIPMENT TO A MINIBILAR REPECT AREA WESTLY.

FOR THE PROVIDE OF POLITANTS FROM HAZARDOUS WASTES TO THE DRAININGS SYSTEM THROUGH PROPER MATERIAL USE, WASTE DESCORAL AND TRAINING OF
EMPLOYEES. A PESTICIDES, SOIL STABILIZATION PRODUCTS, ASPHALT PRODUCTS AND CONCRETE CLEANO PRODUCTS.

#### GRADING NOTES:

- ALL CONSTRUCTION SHALL CONFORM TO THESE FLANS AND THE LATEST EDITION OF THE CITY OF SACRAMENTO STANDARD SPECIFICATIONS NOVEMBER 2020, WHICH IS AT
- CITY WEB-SITE: HTTP://WWW.CITYOFSACRAMENTO, ORO/UTILITIES/RESOURCESS/F, CS-AND-DRAWING THE CONTRACTOR SHALL OBTAIN AND USE ALL APPLICABLE ADDENDUMS.
- 3 ALL CONSTRUCTION SHALL BE PERFORMED IN ACCORDANCE WITH FHA STANDARDS
- 4. ALL GRADING SHALL BE IN CONFORMANCE WITH THE CITY OF SACRAMENTO GRADING, EROSION AND SEDEMENT CONTROL ORDINANCE (ORD. NO. 93-088).
- 5. ALL GRADING SHALL COMPLY WITH THE RECOMMENDATIONS OF THE SOIL AND GEOLOGICAL INVESTIGATION PREPARED BY:
- ALL APPLICABLE FEES TO BE PAID AND FERMITS REQUIRED SHALL BE OBTAINED BY THE CONTRACTOR BEFORE COMMENCEMENT OF CONSTRUCTION.
- ALL SLOPE BANKS ARE 2:1 MAXIMUM UNLESS OTHERWISE NOTED
- MAXIMUM TOLERANCE FROM PAD ELEVATIONS SHALL BE +/-02 FEET.
- THE CONTRACTOR IS HERBY NOTIFIED THAT PRIOR TO COMMENCING CONSTRUCTION, HE IS RESPONSIBLE FOR CONTACTING THE UTILITY COMPANIES INVOLVED AND REQUESTING A VERLIFICATION AT THE CONSTRUCTION SITE OF THE LOCATIONS OF THEIR UNDERGROUND UTILITIES WHERE SUCH TACHTER MAY PASSIBLY CONFIDENTIAL THAT HE REPORT OF THE PRIOR OF T
- 10. ALL FILL WITHIN PAVED AREAS SHALL BE 95% COMPACTION. ALL OTHER FILL SHALL BE 90% COMPACTION. UNLESS OTHERWISE NOTED IN THE GEOTECHNICAL REPORT.
- 11. SOIL DENSITIES SHALL BE CERTIFIED BY THE GEOTECHNICAL ENGINEER. THE GEOTECHNICAL ENGINEER SHALL SUBMIT WRITTEN CERTIFICATION TO THE CONSULTING ENGINEER, THE OWNER, AND THE CITY ENGINEER.
- 12 THE CONTRACTOR IS RESPONSIBLE FOR TEMPORAY EXCISION CONTROL, SHIGHLED THE PROBEST BE LIVERED CONTROLLED METWERS OCTIONE IN AN APRIL IS TEMPORARY ENGINENCE OF THE PROBEST BE LIVERED OF THE PROBEST OF THE PROBEST OF THE PROBEST OF THE PROBEST OF THE PROPERTY AS A RESILED OF THE CONSTRUCTION OF THE PROBEST. SHOWN AS A RESILED OF THE PROPERTY AS A RESILED OF THE CONSTRUCTION OF THE PROBEST. SHOWN AS A RESILED OF THE PROBEST OF THE PROBEST
- SHOULD ANY PREHISTORIC (ARROWHEADS, MORTAR, HUMAN BONES) OR HISTORIC ARTHACTS (GLASS, CERAMICS, METALS, NAILS) BE EXPOSED DURING EXCAVATION, GRADING OR CONSTRUCTION OPERATIONS, ALL WORK SHALL CLASS BAMEDIATELY WITHIN 50 MEDIES OF THE FORM MATERIAL(S) AND THE COMMUNITY DEVELOPME DEPARTMENT SHALL BE IMMEDIATELY OF COMMUNITY DEVELOPME DEPARTMENT SHALL BE IMMEDIATELY OF COMMUNITY DEVELOPMENT OF COMMUNITY DEVELOPMENT OF COMMUNITY DEVELOPMENT OF COMMUNICATION COMMUNICATION OF COMMUNICATION OF COMMUNICATION COMMUNICATION OF COMMUNICAT
- 14. GRADING, TRENCHING, CUTTING AND/OR FILLING WITHIN THE DRIP LINE OF THOSE TREES, DESIGNATED ON THE SITE FLAN FOR PRESERVATION, SHALL NOT OCCUR. NO ACTIONS SHALL BE TAKEN THAT WILL HARM THE HEALTH, VITALITY OR LONGEVITY OF THOSE TREES IDENTIFIED ON THE SITE FLAN FOR PRESERVATION.
- 15. NO REPULING, LUBRICANTION OR MAINTENANCE OF EARTHMOVING OR OTHER CONSTRUCTION VEHICLES SHALL BE DONE ANYWHERE ON THE SITE EXCEPT WITHIN APPROADED CONSTRUCTION STAGMAN APPRA

#### I.G. ANY GRADING DEFRATIONS DETRIDE OF GRADIVISION ROUNDARY SHALL REQUIRE A PROST STATE. GENERAL WATER NOTES

- TYPE OF WATER SOURCE/SLIN USE: SURFACE WATER
- NAME & GENERAL LOCATION OF SOURCE(S) LITTLE DEER CREEK WATERSHED, NEVADA IRRIGATION DISTRICT DS CANAL DRINKING WATER SOURCE ASSESSMENT INFORMATION:
  THE CITY OF NEVADA CITY WATER SYSTEM IS LOCATED IN NEVADA COUNTY CA, SERVING A POPULATION OF 3,010, WITH
- APPROXIMATELY 1,252 SERVICE CONNECTIONS, WATER FOR THE SYSTEM IS PROVIDED BY SURFACE WATER IN LITTLE DEER CREEK
  WATERSHED, AND BY THE NEVADA IRRIGATION DISTRICTS DS CANAL GENERAL LAND USES IN THE WATERSHED ARE RESIDENTIAL
  DWELLINGS, MANAGED FORESTS AND UNDEVELOPED LAND. A SURFACE WATER SOURCE ASSESSMENT WAS COMPETED FOR THE LITTLE
- DIEER CREEK WATERSHED IN FEBRUARY 2012. THIS SURFACE WATER SOURCE IS CONSIDERED TO BE VULNERABLE TO STORM DRAIN DISCHARGE; HISTORIC MINING, PROPANE STORAGE TAINGS, SEPTIC SYSTEMS, USE OF PESTICIDES AND HERBICIDES, FERTILIZERS, MANAGED FORESTS, STREETS, ROADS, AND WATER SUPPLY WELLS. A COMPLETE COPY OF NID'S COMPLETE ASSESSMENT IS AVAILABLE
- FOR REVIEW AT NEVADA CITY HALL, 317 BROAD ST., NEVADA CITY CA 98959, YOU MAY ALSO CONTACT THE STATE WATER RESCURCES CONTROL BOARD, DIVISION OF DRINKING WATER, 1001 I STREET, SACRAMENTO, CA, 95814 TO REVIEW EITHER OF THE
- SOURCE WATER ASSESSMENT REPORTS.
- TIME AND PLACE OF REGULARLY SCHEDULED BOARD MEETINGS FOR PUBLIC PARTICIPATION; CITY COUNCIL MEETINGS ARE HELD ON THE 2ND AND 4TH WEDNESDAYS OF EACH MONTH,
- STARTING AT 6:30 PM
  - FOR MORE INFORMATION CONTACT: MICHAEL R FAUDOA, CHIEF PLANT OPERATOR PHONE: (530) 265-8668

- FOR MORE, INFORMATION, CONTROL'S MOPINEL R PAUDON, OTHER PLANT OF EVOLUTION PROME, ISSUI ZEROSEED ADDITIONAL GENERAL INFORMATION OR DETINION WATER, INCLUDING BOTTLED WATER, MAY REASONABLY BE EXPECTED TO CONTAIN AT LEAST SMALL AMOUNTS OF SOME CONTAININATS. THE PRESENCE OF CONTAININATE DESIGN NOT NECESSARILY INDICATE THAT THE WATER POSES A HEALTH RISK MORE INFORMATION ABOUT CONTAINMANTS AND POTENTIAL HEALTH EFFECTS CAN BE OBTAINED BY CALLING THE USEPA'S SAFE DRINKING WATER
- INFORMATION ABOUT CONTINUINATIS AND POTENTIAL REPORTS GRAVE CONTINUINATIS AND POTENTIAL REPORTS GRAVE CONTINUINATIS AND POTENTIAL REPORTS GRAVE PROPRIED TO CONTAMINANTS IN DRINKING WATER THAN THE GENERAL POPULATION. IMMUNO:COMPROMISED PERSONS SUCH AS PERSONS WITH CANCER UNDERGOING CHEMOTHERAPY, PERSONS WHO HAVE UNDERGONE ORGAN TRANSPLANTS, PEOPLE WITH HIVIAIDS OR OTHER IMMUNE SYSTEM DISORDERS, SOME ELDERLY, AND INFANTS CAN BE PARTICULARLY AT RISK
- FROM INFECTIONS. THESE PEOPLE SHOULD SEEK ADVICE ABOUT DRINKING WATER FROM THEIR HEALTH CARE PROVIDERS. USEPACENTERS
  FOR DISEASE CONTROL (COC) GUIDELINES ON APPROPRIATE MEANS TO LESSEN THE RISK OF INFECTION BY CRYPTOSPORIDUM AND OTHER
  MICROBIAL CONTAMINANTS ARE AVAILABLE FROM THE SAFE DRINKING WATER HOTLINE (1-800-428-4781).

- MICROBIAL CONTANINANTS ARE AVAILABLE FROM THE SAFE DRINKING WATER HOTLINE (1-800-426-4781).

  LEAD-SPECIFIC LANGUAGE FOR COMMUNITY WATER SYSTEMS: IF PRESENT, ELEVATED LEVELS OF LEAD CAN CAUSE SERIOUS HEALTH

  PROBLEMS, ESPECIALLY FOR PREGNANT WOMEN AND YOUNG CHILDREN. LEAD IN DRINKING WATER IS PRIMARILY FROM MATERIALS AND

  COMPONENTS ASSOCIATED WITH SERVICE LINES AND HOME PLUMBING. THE NEVADA CITY WATER TREATMENT PLANT IS RESPONSIBLE FOR

  PROVIDING HIGH QUALITY DRINKING WATER, BUT CANNOT CONTROL THE VARIETY OF MATERIALS SEN DILUMBING COMPONENTS. WHEN

  YOUR WATER HAS BEEN SITTING FOR SEVERAL HOURS, YOU CAN MINIMIZE THE POTENTIAL FOR LEAD EXPOSURE BY FLUSHING YOUR TAP FOR 30

  SECONDS TO 2 MINITES BEFORE USING WATER FOR DRINKING OR COOKING. [OPTIONAL: IF YOU DO SO, YOU MAY WISH TO COLLECT THE
- FLUSHED WATER AND REUSE IT FOR ANOTHER BENEFICIAL PURPOSE, SUCH AS WATERING PLANTS.] IF YOU ARE CONCERNED ABOUT LEAD IN YOUR
- WATER, YOU MAY WISH TO HAVE YOUR WATER TESTED. INFORMATION ON LEAD IN DRINKING WATER, TESTING METHODS, AND STEPS YOU CAN TAKE TO MINIMIZE EXPOSURE IS AVAILABLE FROM THE SAFE DRINKING WATER HOTLINE OR AT HTTP://WWW.EPA.GOV/LEAD.

MANDATORY NOTES: ON-SITE

- ALL CONSTRUCTION MATERIALS AND WORKMANSHIP SHALL CONFORM TO THE CITY OF SACRAMENTO STANDARD SPECIFICATIONS, DATED NOVEMBER 2020. THE CONTRACTOR SHALL OBTAIN AND USE ALL APPLICABLE ADDENDUMS.
- THE CONTRACTOR IS RESPONSIBLE FOR DETERMINING THE EXACT LOCATION OF ALL EXISTING UTILITIES AND FOR THE PROTECTION OF AND REPAIR OF DAMAGE TO THEM. CONTACT UNDERGROUND SERVICE ALERT 1-800-642-2444, 48 HOURS BEFORE WORK IS TO BEGIN.
- POR ALL TRENCH EXCAVATIONS 5 FEET OR MORE IN DEPTH, THE CONTRACTOR SHALL OBTAIN A PERMIT FROM THE DIVISION
  OF INDUSTRIAL SAFETY (2422 ANDEN WAY, SUITE 165, SACRAMENTO, PHONE 263-2800) FRUOR TO BEGINNING ANY
  EXCAVATION. A COPY OF THIS PERMIT SHALL BE AVAILABLE AT THE CONSTRUCTION SITE AT ALL TIMES.
- 4. THE CONTRACTOR SHALL BE RESPONSIBLE FOR AND FURNISH, INSTALL, AND MAINTAIN TEMPORARY SIGNS, BRIDGES, BARRICADES, FLAGMEN, AND OTHER FACILITIES TO ADEQUATELY SAFEGUARD THE GENERAL PUBLIC AND WORK, AND TO PROVIDE FOR THE PROPER ROUTING OF VEHICULAR AND PEDESTRIAN TRAFFIC. CONSTRUCTION OPERATIONS SHALL COMPLY WITH THE WORK AREA TRAFFIC CONTROL HANDBOOK (WATCH).
- 5. THE CONTRACTOR SHALL BE RESPONSIBLE FOR THE PROTECTION OF ALL EXISTING SURVEY MONUMENTS OR MARKERS
- THE CONTRACTOR SHALL MAINTAIN ALL EXISTING DRAINAGE AND SEWER FACILITIES WITHIN THE CONSTRUCTION AREA UNTIL NEW DRAINAGE AND SEWER IMPROVEMENTS ARE IN PLACE AND FUNCTIONING.
- 7. IF UNUSUAL AMOUNTS OF BONE, STONE OR ARTIFACTS ARE UNCOVERED, WORK WITHEN SOMETERS OF THE AREA SHALL CEASE IMMEDIATELY AND A QUALIFIED ARCHEOLOGIST AND A REPRESENTATIVE OF THE NATIVE AMERICAN FERTIAGE COMMISSION SHALL BE CONSULTED TO DEVISIOP, IF NECESSARY, MITICATION HEAGREST ORDOZOGY ARCHAEOLOGICAL IMPACT TO A LESS TRAN SIGNIFICANT EFFECT BEFORE CONSTRUCTION RESUMES IN THE AREA.
- COST TO REMOVE AND REPLACE EXISTING PAVEMENT OVER THE WATER, STORM AND SANITARY LINE TRENCHES SHALL BE INCLUDED BY THE PRICE BID FOR PIPE IN PLACE. REPLACEMENT SHALL BE 4" AC AND 12" AB, MINIMUM, OR INDICATED ON
- 9. PIPE AND MANHOLE DIMENSIONS ARE TO THE CENTERLINE, UNLESS OTHERWISE NOTED.

- 10. ALL TAPS 24 INCHES AND SMALLER INTO SEWER & DRAIN MANHOLES SHALL BE CORE BORED WITH KORN-SEAL TAPS OR APPROVED EQUAL II. ANY WATER ENTERING THE SANITARY SEWER SYSTEM TO BE CONSTRUCTED UNDER THISSE PLANS SHALL NOT BE DISCHARGED TO THE EXISTING SYSTEM FLUES MINTS BE INSTALLED IN EXISTING HOUSES AS RECESSARY TO PERMIT PUMPING THE NEW SYSTEM CLEAR OF WATER AND DEBRIS PRIOR TO ACCEPTANCE. CARE SHALL BE EXCENSED IN LOCATING PLUES TO AVOID INTERRUPTION SERVICES TO EXISTING CONNECTIONS. MORTAR OR BRICK PLUES MIST BE USED, INFLATABLE EVICES ARE NOT SATISFACTORY.
- 12. DRAIN PIPE MATERIAL SHALL BE REINFORCED CONCRETE PIPE C-76 CL III, NON-REINFORCED CONCRETE PIPE C-14 CL III, PVC SDR 35, OR AS SPECIFIED ON PLANS. IN ALL CASES, JOINTS FOR CONCRETE PIPE SHALL BE RUBBER GASKETED JOINTS.
- 13. DRAIN INLET LEADS SHALL BE PVC C-900 CL 150, RCP C-76 CL III, OR NON-REINFORCED CONCRETE C-14 CL III.
- 14. SANITARY SEWER PIPE MAINS SHALL BE CONSTRUCTED OF V.C.P., A.B.S. OR P.V.C. UNLESS OTHERWISE SPECIFIED ON THE
- 15. AGGREGATE SUBBASE SHALL CONFORM TO CALTRANS SPECIFICATIONS DATED: JULY, 1992 ASB, SECTION 25
- 16. A STORMWATER PERMIT MUST BE OBTAINED WHEN CONSTRUCTION ACTIVITY RESULTS IN SOIL DISTURBANCE OF ONE (I) OR MORE ACRES. THE STATE WATER RESOURCES CONTROL BOARD, DIVISION OF WATER QUALITY, STORMWATER PERMIT, P.O. BOX 1977, SACRAMENTO, CA 95812-1977, SHALL BE CONTACTED TO OBTAIN THE PERMIT PROR TO BEGINNING CONSTRUCTION.
- 17. IF WORK SHOWN ON THESE PLANS HAS NOT COMMENCED WITHIN TWO YEARS FROM THE DATE OF THE CITY'S ACCEPTANCE OF THE PLANS, A SUBSEQUENT FLAN REVIEW AT THE CITY'S DISCRETION AND THE DEVELOPERS EXPENSE MAY BE
- THE CONTRACTOR SHALL COMPLY WITH THE CITY OF SACRAMENTO ADMINISTRATIVE AND TECHNICAL MANUAL FOR GRADINGEROSION AND SEDIMENT CONTROL. CONTRACTOR SHALL HAVE ALL APPROPRIATE EROSION AND SEDIMENT CONTROL MEASURES IN PLACE FOR THE WINTER MONTHS PRIOR TO OCTOBER IAND MUST ENSURE THAT THE CONSTRUCTION SITE IS PREPARED PRIOR TO THE ONSET OF ANY STORM.

SED ARCHITA C-12648 06-30-2023 THE OF CALIFOR Robert A Massette

PROJECT MANAGER: Zaman Hamim 4080 Truxel Road Secomento, Co. 95834 (916) 529-3982 zaman\_hamim@vahoo.com

ARCHITECT, OF RECORD

#### 

4080 TRUXEL ROAD SACRAMENTO,CA 95834 PHONE: (916) 892-9949 FAX: (916) 283-7501

pm@theboulevard.us www.boulevard.com

PROPOSED GAS STATION / EXPRESS CARWASH CENTER 1912 NEVADA CITY HWY GRASS VALLEY ,CA 95945

PROJEC



12/12/22 ISSUED FOR PERMIT REVIEW


DRAWN BY: BOULEVARD

SHEET TITLE GENERAL INFORMATION

APPROVED:

SHEET #

G-1.0

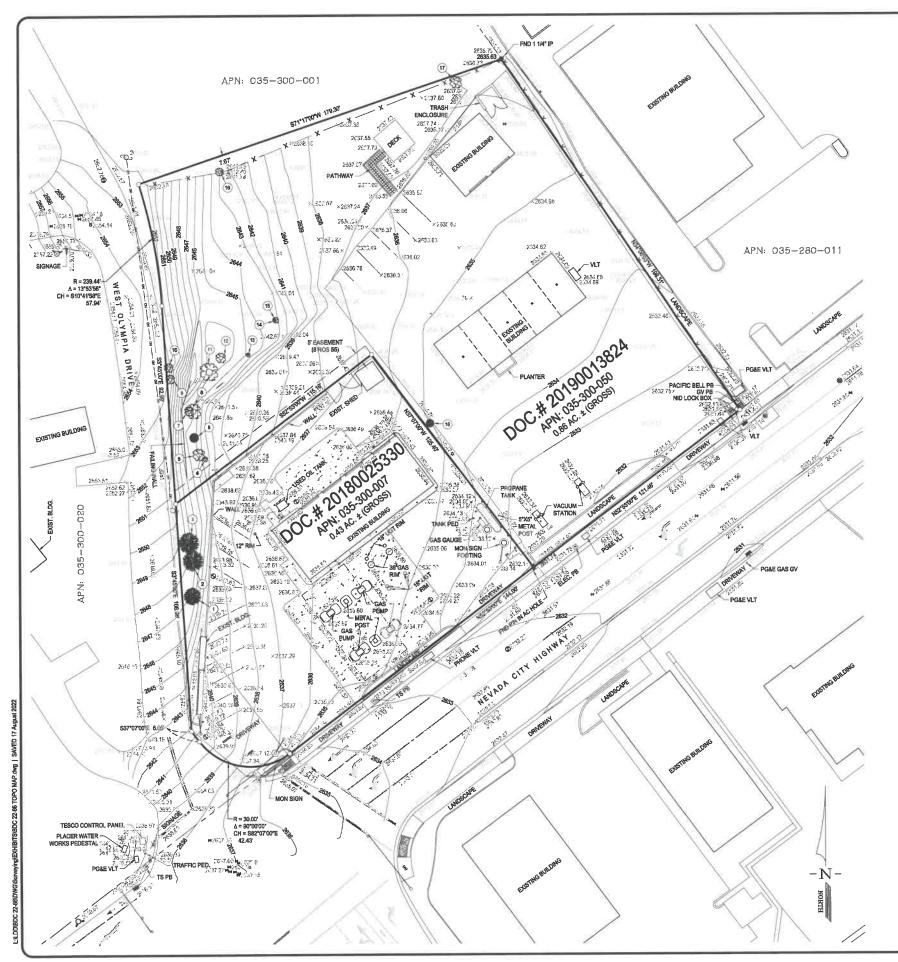

# TOPOGRAPHIC SURVEY 1912 & 1924 NEVADA CITY HWY, GRASS VALLEY

COUNTY OF NEVADA STATE OF CALIFORNIA APN: 035-300-050 & -007

### LEGEND

•	BOLLARD
11	CURB INLET WITH GRATE
0	DIMENSION POINT NOTHING FOUND, NOTHING
	DRAIN INLET
₩.	FIRE HYDRANT
ø	FOUND MONUMENT AS NOTED
7	GATE
M	GATE VALVE
×2637.07	GROUND SHOTS
<b>0 0 0 0 0</b> 0 0 0 0 0 0 0 0 0 0 0 0 0 0	LIGHT
•	MONITORING WELL
P	POWER POLE
PB	PULL BOX
	ROLL UP DOOR
•	SANITARY SEWER MANHOLE
	SIGN
	STORM DRAIN MANHOLE
	TRAFFIC SIGNAL
❸ ●	TREE
5253	TRUNCATED DOME
∘ 🗌 🖂	UTILITY AS NOTED
W	WATER METER
	CONCRETE
	ADJACENT PROPERTY
	EASEMENT
	EDGE OF PAVEMENT
—— x ——	FENCE
<del></del>	MAJOR CONTOUR
2834	MINOR CONTOUR
	OVERHANG ROOF
— он — он —	OVERHEAD POWER LINES
	PROPERTY LINE
	RIGHT OF WAY

AC	- ASPHALT CONCRETE
AC.	- ACRE
APN	- ASSESSOR PARCEL NUMB
DOC#	- DOCUMENT NUMBER
BLDG.	- BUILDING
ELEC.	- ELECTRICAL
EXIST.	- EXISTING
FND	- FOUND
GV	- GATÉ VALVE
IP.	- IRON PIPE
MON	- MONUMENT
PB	- PULL BOX
PED	- PEDESTAL
ROS	- RECORD OF SURVEY
TS	- TRAFFIC SIGNAL
UGT	- UNDERGROUND GAS TAN
<b>VLT</b>	- VAULT

NO.	DESCRIPTION	DIAMETER
1	PINE	30"
2-3	PINE	36"
4	TREE	10"
5	TREE	24"
6	PINE	16"
7	X2 REDWOOD	18"

NO.	DESCRIPTION	DIAMETER
8	REDWOOD	30"
9	TREE	18"
10	OAK	18"
11	REDWOOD	36"
12	TREE	20"
13	TREE	8"

NO.	DESCRIPTION	DIAMETER
14	TREE	6"
15	X2 TREE	12"
16	TREE	16"
17	TREE	24"
18	PINE	14"

#### **BENCHMARK:**

9M ID: KS0833 ELEV. = 2413.88' (NAVD 88)

A STANDARD DISK, STAMPED GRASS VALLEY 1934 AND SET VERTICALLY. THE BUILDING THE MARK IS SET IN IS NO LONGER THE POST OFFICE. IS IT NOW MARKED "OLD POST OFFICE" AND "UBS PAINE WEBBER" AND IS LOCATED AT THE NE CORNER OF BANK STREET AND S. AUBURN STREET IN GRASS VALLEY. TO REACH FROM THE NEW POST OFFICE, PROCEED WEST ON THE MAIN STREET, TURN LEFT ON S. AUBURN, MARK IN ON THE LEFT. GRAYITY BASE STATION "GRASS VALLEY.", C 95, WAS 1.4 FEET BELOW DISK UNTIL INSTALLATION OF HANDICAP RAMP.

## BASIS OF BEARINGS:

THE BASIS OF BEARINGS OF THIS SURVEY IS IDENTICAL TO THAT CERTAIN RECORD OF SURVEYS RECORDED IN BOOK 8 OF SURVEY AT PAGE 55 NEVADA COUNTY RECORDS.

NOTE:

SOUTHWEST PROPERTY BOUNDARY IS NOT SHOWN ON RECORD MAP. BOUNDARY AND EASEMENT SHOWN ARE BEST INTERPRETATION OF PROVIDED TITLE REPORTS AND DEEDS. A RECORD OF SURVEY & FURTHER RESEARCH WILL BE REQUIRED TRESOLVE AND LOCATE PRECISE POSITION OF BOUNDARY AND EASEMENTS.





DRAWN 1. VIRAY
CHECKED 1. BLAIR
DATE 06-17-2022
SCALE 1"= 20"


NO REVISION DESCRIPTION DATE BY

1912 & 1924 NEVADA CITY HWY, GRASS VALLEY
TOPOGRAPHIC SURVEY
AP.IN.: 035-300-050 & -007
COUNTY OF NEDAVA,
CONLIFORNIA

L COMPANIES
71L • SGI 3D • SURVEYORS GROUP, INC.
6.0. 68747

SGI CIVIL • SGI 3 9001 Foothills Blvd., Roseville, CA 95747 (916) 789-0822 Events, Selection of the selectio

SHEET <u>1</u> OF <u>1</u> JOB NO. BDC 22-86

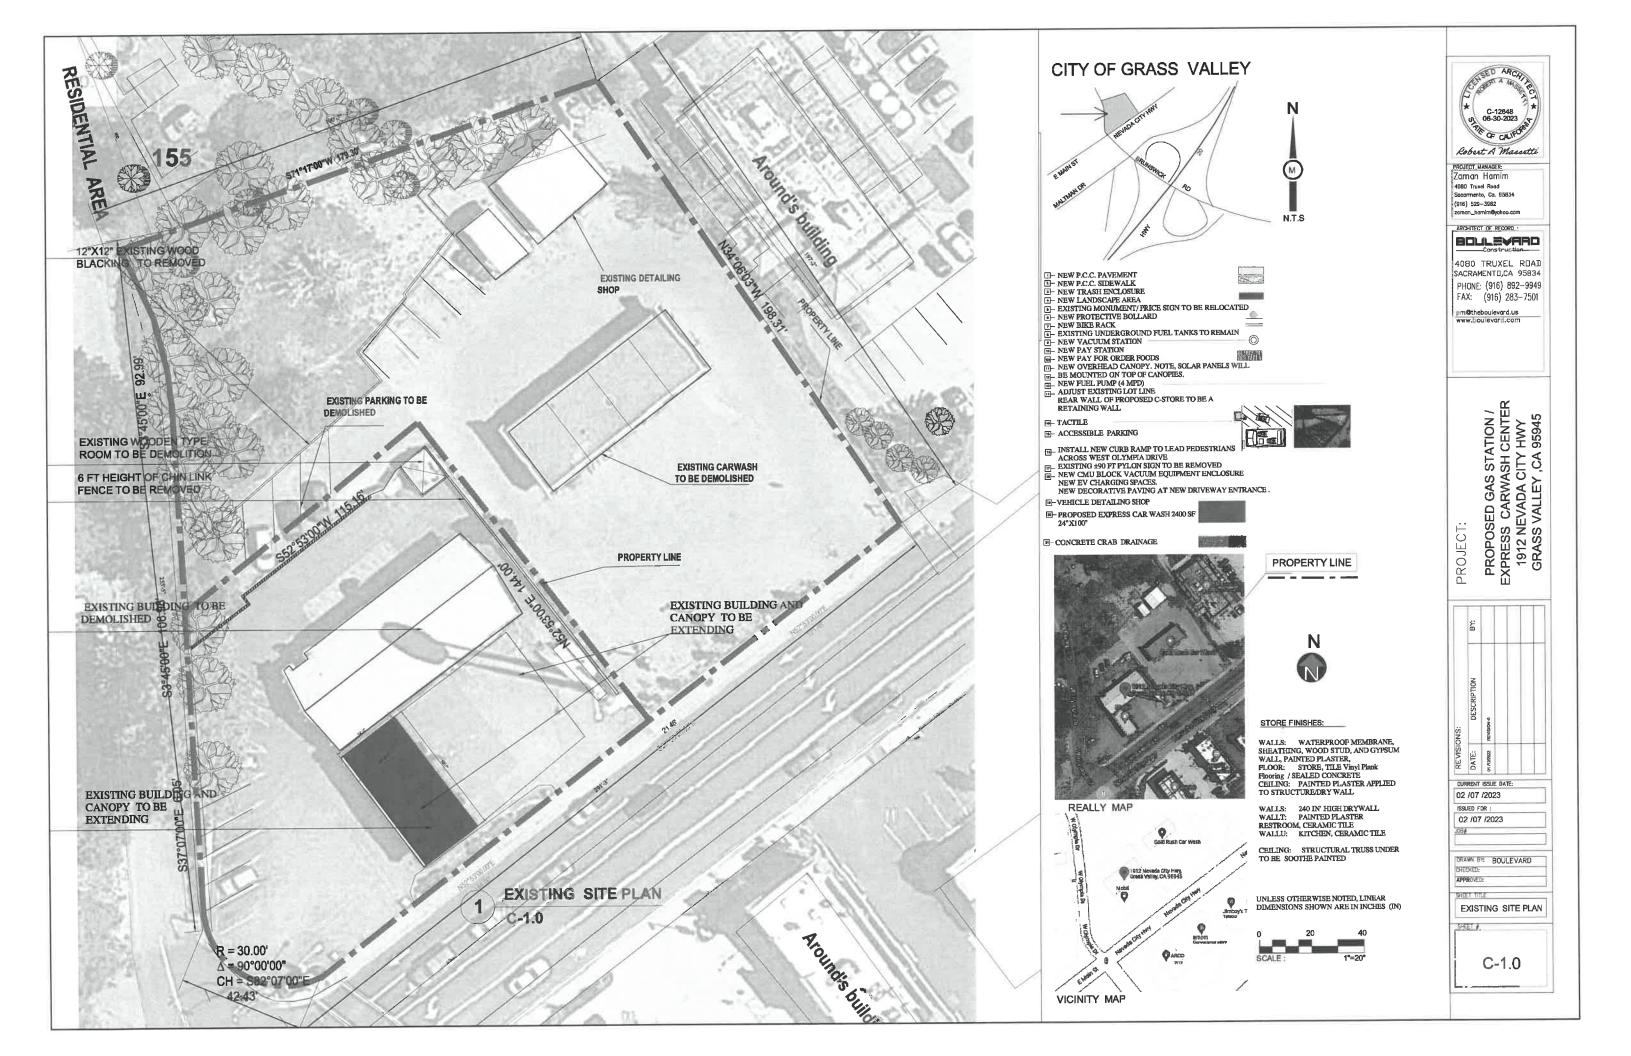







PROJECT MANAGE:
Zaman Hamim
4080 Truxel Read
Socormente, Co. 95834
(916) 529-3982
zaman\_hamim@yahoo.com

ARCHITECT OF RECORD :

4080 TRUXEL ROAD SACRAMENTO,CA 95834 PHONE: (916) 892-9949 FAX: (916) 283-7501

pm@theboulevard.us www.boulevard.com

> ON / VTER A

PROPOSED GAS STA KPRESS CARWASH ( 1912 NEVADA CITY



CURRENT ISSUE DATE:

02 /07 /2023


ISSUED FOR:

02 /07 /2023

DRAWN BY: BOULEVARD
DIECKED:
APPROVED:

NEIGHBORHOOD SITE PLAN

C-1.1

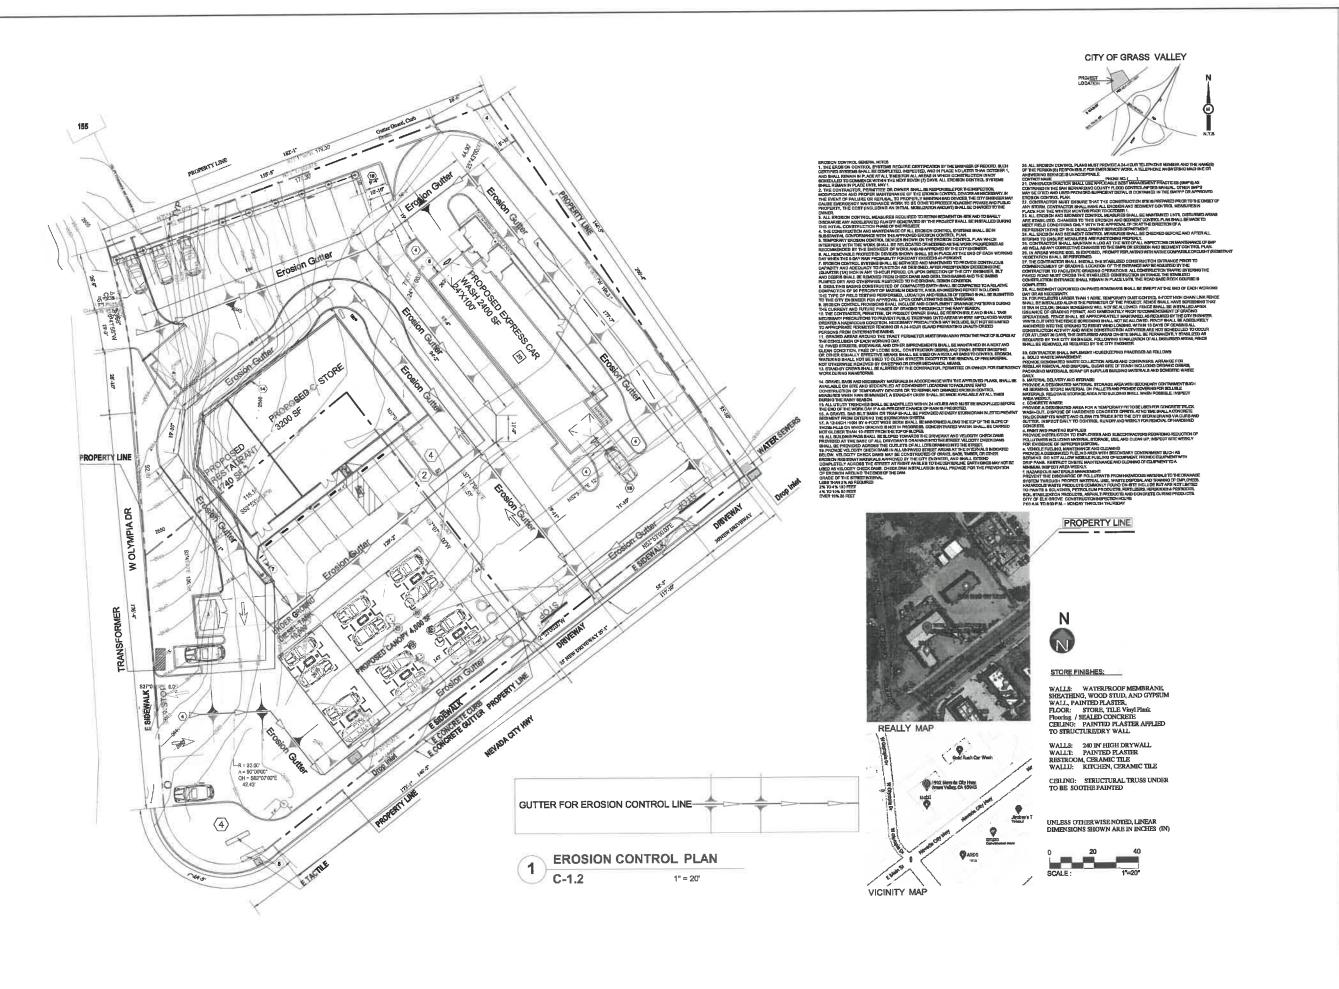



PROJECT\_MANAGER: Zaman Hamim 4080 Truxel Road Sacarmento, Co. 95834 (916) 529-3982 zaman\_hamim@yahao.co

#### ARCHITECT OF RECORD .

4080 TRUXEL RDAD SACRAMENTO,CA 95834 PHONE: (916) 892-9949 FAX: (916) 283-7501

pm@theboulevard.us www.boulevard.com

PROPOSED GAS STATION / EXPRESS CARWASH CENTER 1912 NEVADA CITY HWY GRASS VALLEY ,CA 95945

PROJECT:

CURRENT ISSUE DATE:


ISSUED FOR : 02 /07 /2023 JOB#


MANN ET: BOULEVARD APPROVED:


SHET TITLE


EROSION PLAN


C-1.2

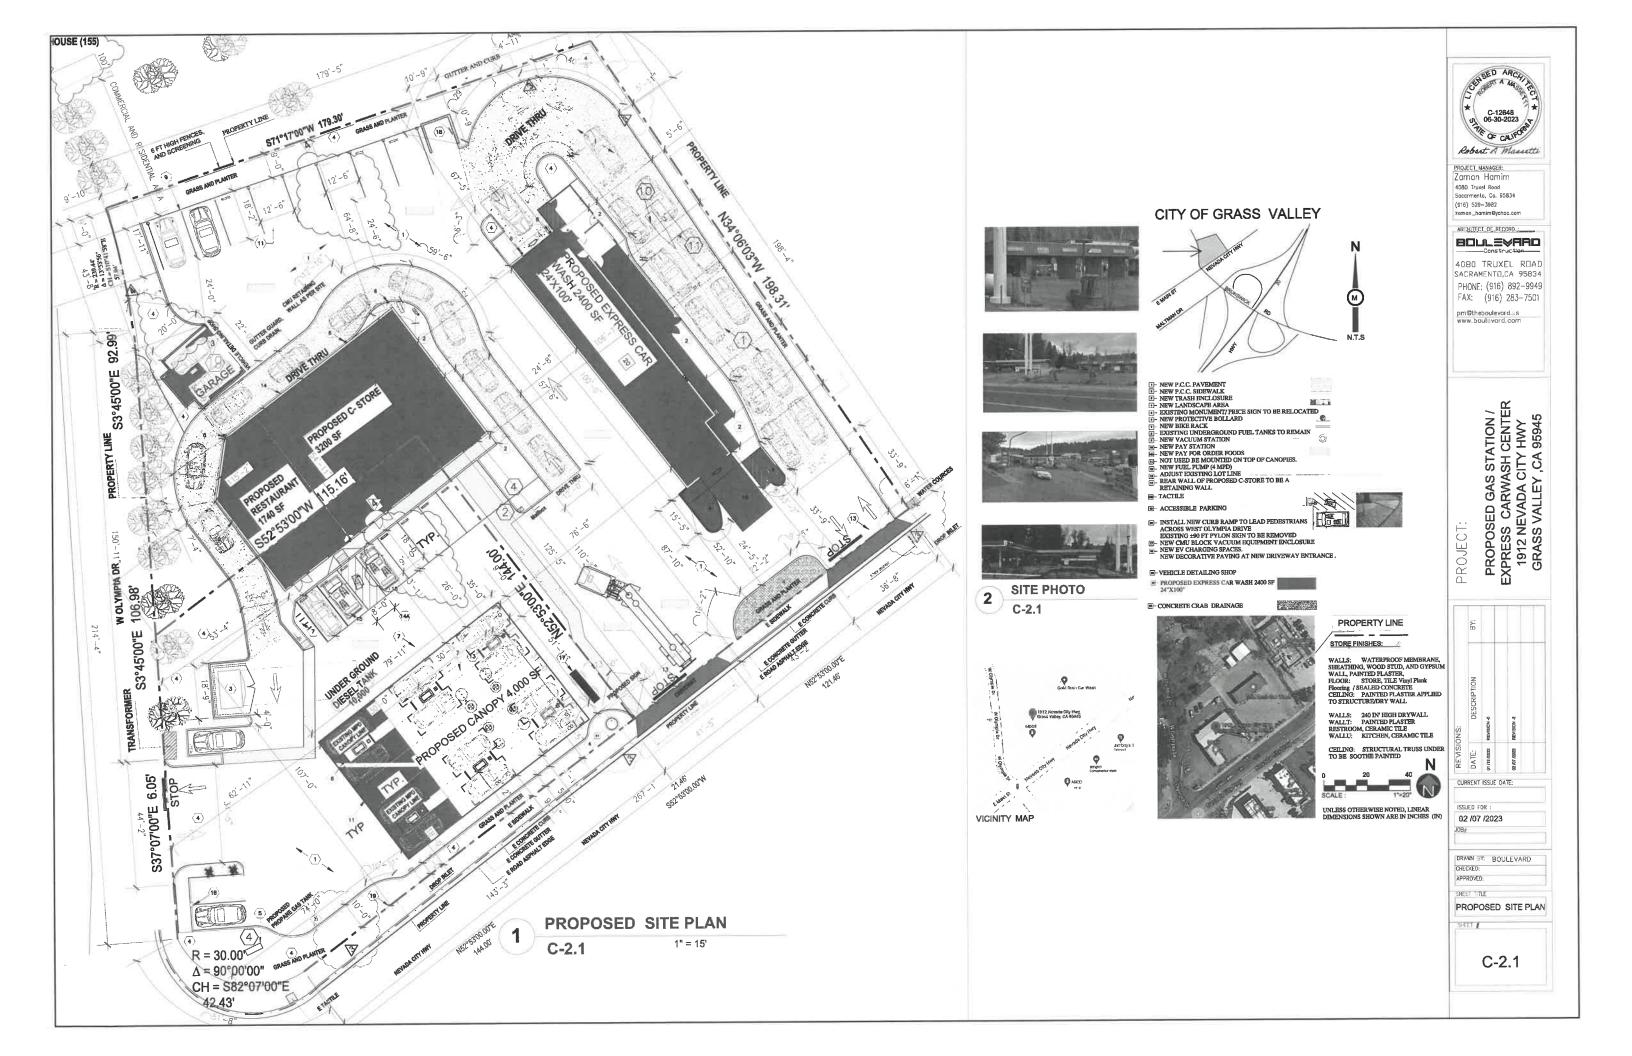


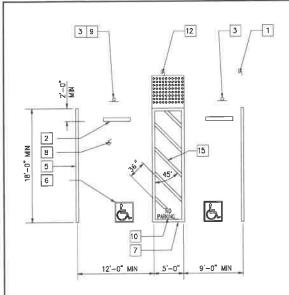

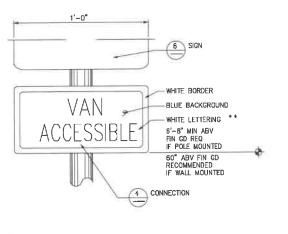

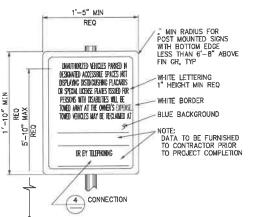

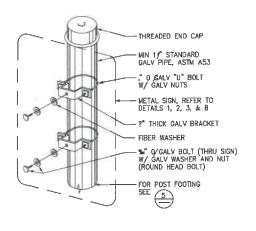

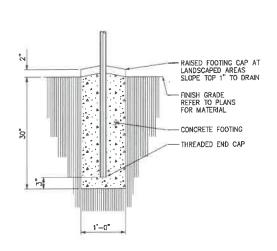

4080 Truxel Road Socomento, Ca. 95834 (916) 529-3982 zaman\_hamim@yahoo.cam ARCHITECT OF RECORD 4080 TRUXEL ROAD SACRAMENTO,CA 95834 PHONE: (916) 892-9949 FAX: (916) 283-7501

PROJECT\_MANAGER:

Zaman Hamim

pm@theboulevard.us www.boulevard.com

FIR OF CALFO

Robert A Massetti

PROPOSED GAS STATION / EXPRESS CARWASH CENTER 1912 NEVADA CITY HWY GRASS VALLEY ,CA 95945

CURRENT ISSUE DATE: 02/07/23

PERMIT REVIEW

DRAWN BY: BOULEVARD APPROVED:

SHEET TITLE

ACCESSIBLE PARKING PLAN SHEET #

C-2.0

ALL LISTED SIGN SIZES ARE RECOMMENDED STANDARD SIZES, UNLESS OTHERWISE NOTED AS REQUIRED. ALL MOUNTING HEIGHTS ARE RECOMMENDED, UNLESS OTHERWISE NOTED AS REQUIRED.

2 ACCESSIBLE VAN PARKING SIGN NOT TO SCALE 3 UNAUTHORIZED VEHICLES PARKING SIGN NOT TO SCALE 4 SIGN CONNECTION

NOT TO SCALE

SIGN POST FOOTING

0

0 0

TD 2.4

0 0

0

NOT TO SCALE

0.45"- 0.47"

BASE DIA

DOME

1 ACCESSIBLE PARKING STALL NOT TO SCALE 4 CONNECTION WHITE PICTOGRAM ¥ g BLUE BACKGROUND PARKING WHITE BORDER WHITE LETTERING \*\* TI II MINIMUM 6'-8" MIN ABV FINE \$250 FIN GD REQ IF POLE MOUNTED 60" ABV FIN GD RECOMMENDED IF WALL MOUNTED

REFER TO SITE PLAN FOR LOCATIONS. REFER TO SHE MEAN FUR CUCHIONS.

COMBO SIGN MAY BE USED.

\* MIN AREA 70 SQ IN REQ

\* 2" MIN H TREQ FOR UP TO 10'—0"

MOUNTING HT FROM BASELINE OF
HIGHEST LETTER TO FIN GO.


3" MIN HT REQ FOR MOUNTING HT OVER 10'—0".

6 ACCESSIBLE PARKING SIGN

NOT TO SCALE

# KEYED NOTE LEGEND

- 1. CONCRETE WALKWAY (WHERE OCCURS). SEE PLANS FOR WIDTH, LAYOUT (MAY VARY), FINISH, JOINTS AND ELEVATIONS.
- 2. PARKING BUMPER (AWAY FROM ACCESS AISLE). SEE SPECIFICATIONS. 3. ACCESSIBLE PARKING SPACE PAVEMENT MARKING.
- SEE DETAIL 8. 5. 4" WIDE WHITE PARKING STALL DESIGNATION STRIPE.
- SEE SITE PLAN(S) FOR ADDITIONAL STALL STRIPING. 6. ACCESSIBLE PARKING SURFACE IDENTIFICATION PAINTED ON PAVEMENT.
- SEE DETAIL 7. 7. 4" WIDE BLUE BORDER DESIGNATING NON-PARKING ACCESS AISLE TO CURB RAMP
- 8. MAXIMUM SLOPE ON PARKING STALL AND ACCESS AISLE TO BE 2%.
- 9. VAN ACCESSIBLE SIGNAGE.
- SEE DETAIL 2. ACCESS AISLE SHALL BE ON PASSENGER SIDE ONLY.
- 10. "NO PARKING" IN MIN 12" HIGH WHITE LETTERS TO BE PLACED WITHIN ACCESS AISLE TO CURB RAMP. SEE DETAIL 8.
- 11. LEVEL LANDING -2% MAX SLOPE W/36" DEEP DETECTABLE WARNING SURFACE ADJOINING ACCESS AISLE OR VEHICULAR WAY.
- DETECTABLE WARNING SURFACE TO EXTEND FULL WIDTH AND MIN 36" DEEP FROM FRONT EDGE OF SIDEWALK.
- 15. 4" WIDE WHITE HATCHED LINES TO CONTRAST WITH ASPHALT SURFACE. USE BLUE HATCHED LINES FOR LIGHT-COLOR CONCRETE SURFACE.

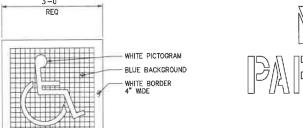

REFER TO DETAIL 1 FOR LOCATIONS.


ACCESSIBLE PARKING SURFACE IDENTIFICATION NOT TO SCALE

8 ACCESS AISLE PAVEMENT MARKING NOT TO SCALE


2% MAX FLUSH TRANSITION PARALLEL CURB RAMP

DETECTABLE WARNING SURFACE - TRUNCATED DOMES

# ACCESSIBLE PARKING

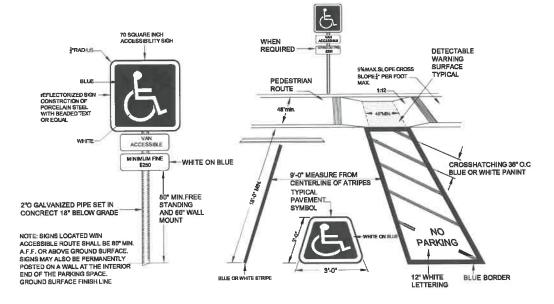


ACCESSIBLE PARKING PLAN

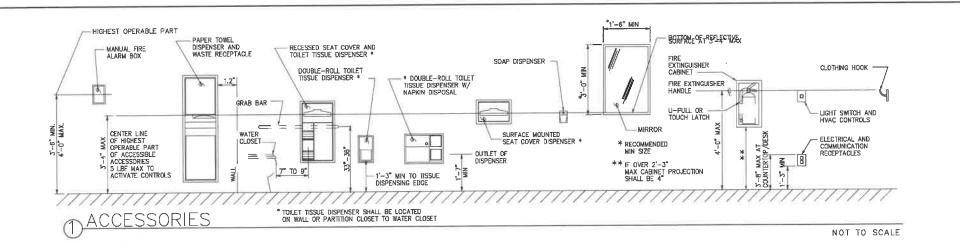

# PLUMBING FIXTURE CALCULATION


PER CPC TABLE 4A AND TABLE 422.1

TOTAL AREA: 11,230 SF/700 =16 SALES AND 1,532SF/300 OFFICE SF =5 TOTAL REQUIRED TOILET ARE: 2 FOR MALE AND FEMALE

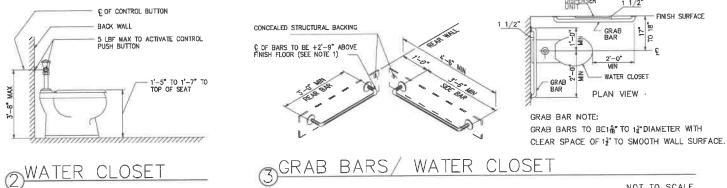


GRAB BARS/ WATER CLOSET

NOT TO SCALE

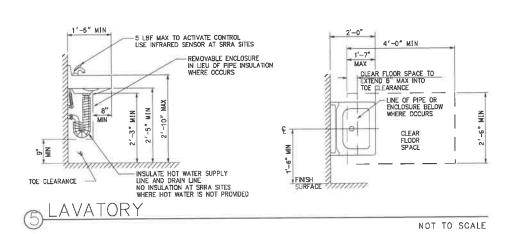

NOT TO SCALE

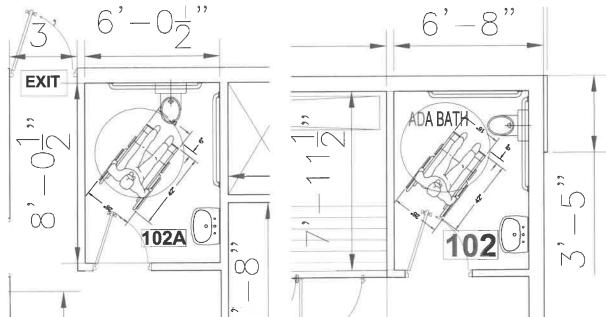

FOR ACCESSIBLE TOILET STALLS AND ABULATORY STALL DOORS SHALL BE SELF-CLOSING WITH DOOR HARDWARE COMPLYING WITH CBC SECTION 11B-309.4

1/4" = 1'-0"



PROJECT MANAGER: Zaman Hamim 4080 Truxel Road Securmento, Co. 95834 (916) 529-3982 zamon\_hamim@yahoo.com

ARCHITECT\_OF\_RECORD\_: BOLLEVARD

4080 TRUXEL ROAD SACRAMENTO,CA 95834

PHONE: (916) 892-9949

FAX: (916) 283-7501 pm@theboulevard.us www.boulevard.com

PROPOSED GAS STATION / EXPRESS CARWASH CENTER 1912 NEVADA CITY HWY GRASS VALLEY ,CA 95945

PROJECT:


REVISI DATE: CURRENT ISSUE DATE: 02/07/23


ISSUED FOR PERMIT REVIEW

DRAWN BY: BOULEVARD APPROVED:

SHEET TILE ADA COMPLIANCE Restroom

C-3.0

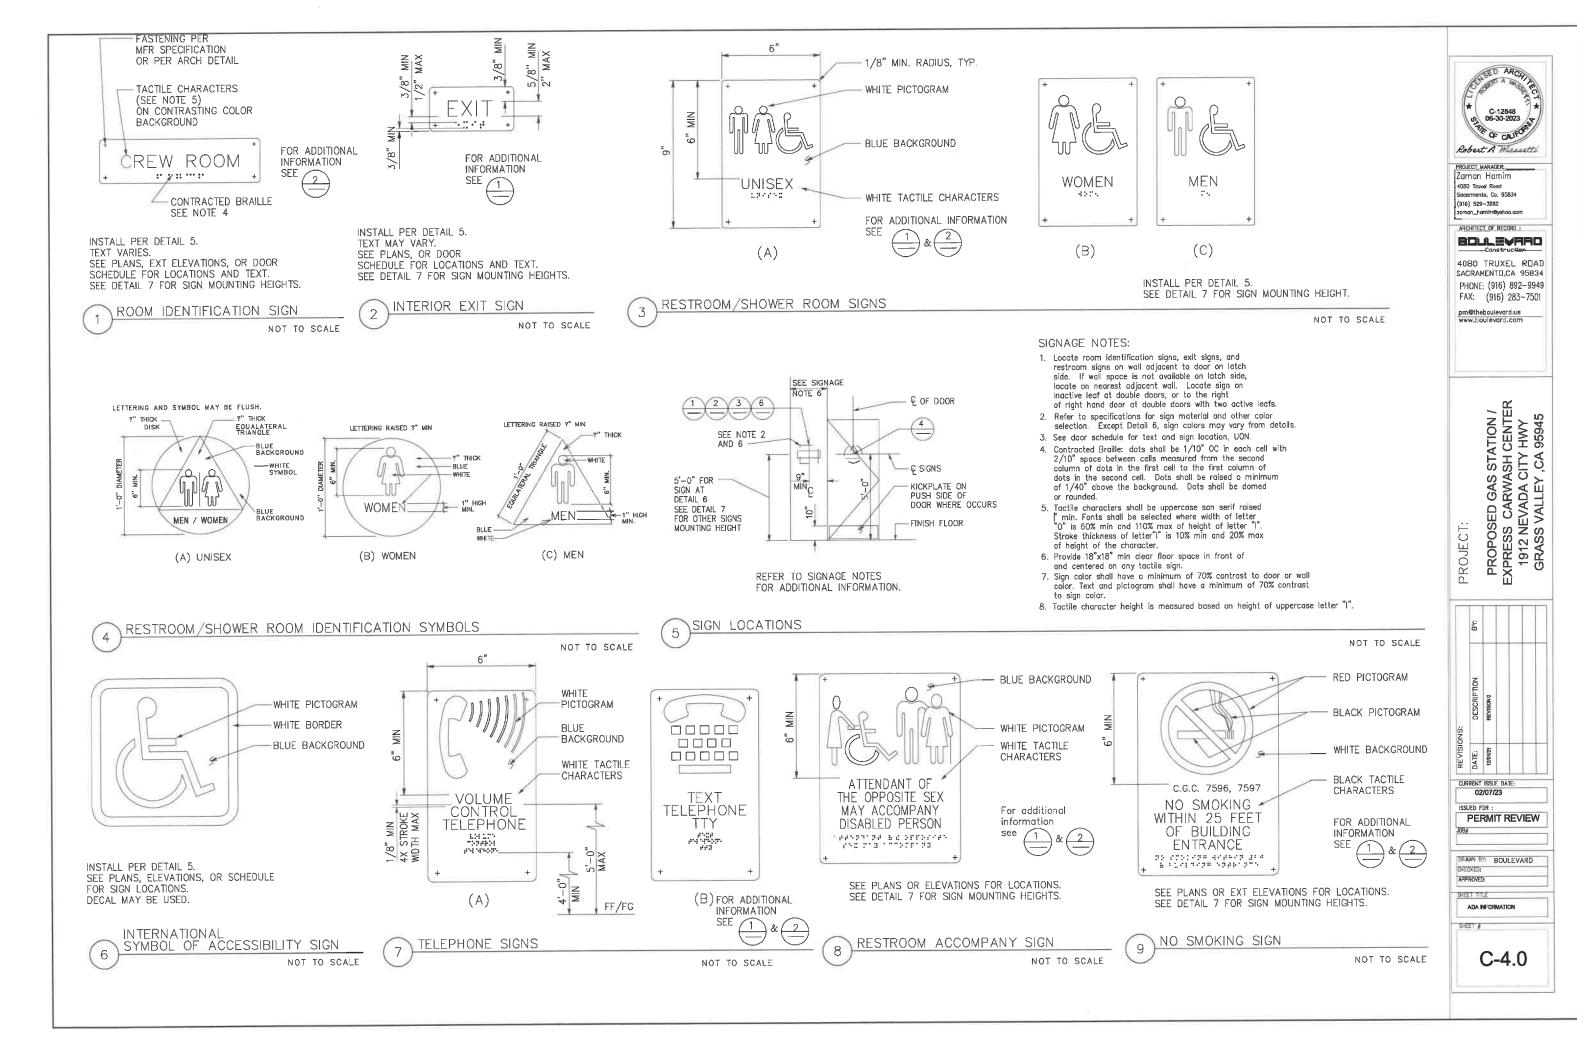

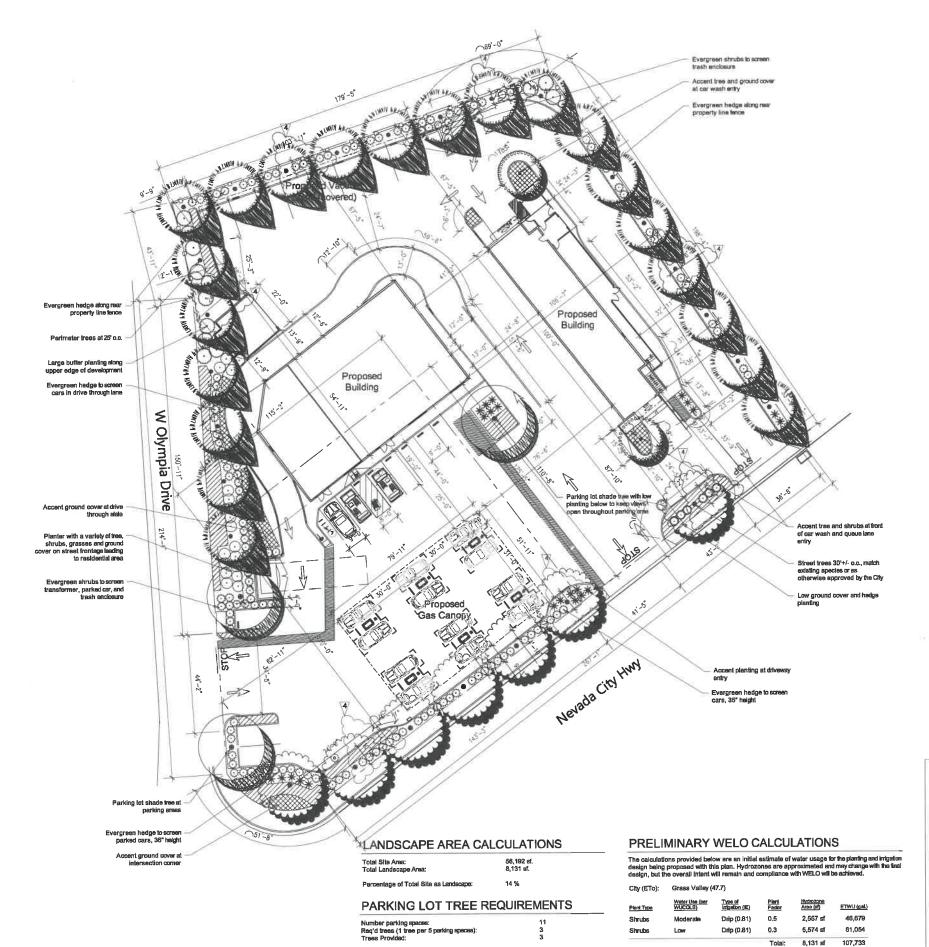

#### CONCEPT PLANT SCHEDULE

/		PARKING LOT SHADE TREE Decidious shade tree at parking areas to meet minimum City requirement (1 free	3		
(	• )	/ 5 spaces) Acer fruncatum x platanoides 'Warrenred' / Pacific Sunset® Maple Pistacia chinensia 'Keith Davey' / Keith Davey Chinese Pistache		15 gal. 15 gal.	
MINING NAMES		SHADE / PERIMETER TREE Shade tree along perimeter to meet City requirements (1 tree @ 25° o.c.) Calocadrus decurrens / Incanse Cedar Umbellularia californica / Bay Laurel	21	15 gal. 15 gal.	
گر ر	The same of the sa	STREET TREE Tree along street frontage to meet City minimum requirements (1 free each 30') Acer rubrum "October Glory" / October Glory Red Maple Lagerstroemia Indica / Crape Myrile	7	15 gal. 15 gal.	
000000000	aconorda de la constanta de la	ACCENT TREE Small for medium tree with Interesting form or flowers. Acer palmatum / Japanese Maple Cercis occidentalis / Western Redbud	2	15 gal. 15 gal.	
	0	EVERGREEN SHRUB / HEDGE Small to medium evergreen shrub, 3'-5' height llex vomtloria "Nana" / Dwarf Yaupon Holly Rhaphiotepis umbellata "Minor" / Dwarf Yedda Hawthorn	174	5 gal. 5 gal.	
	0	BUFFER SHRUB Medium to large shrubs for mass planting and buffers Arctostaphylos densifiors 'Howard MoMinn' / Howard McMinn Vine Hill Manzanita Heteromeles arbuttolia / Toyon Rhamnus californica 'Eve Case' / Eve Case Coffeeberry	14	5 gal. 5 gal. 7 gal.	
	*	ACCENT SHRUB Small to medium shrub with interesting form or color, for use at entries and high visibility areas Dietas infolioties / Fortnight Lily Kniphorifa uvaria / Red Hot Poker Sahvia microyitylis / Gratian Sage Sahvia xi 'Celestial Blue' / Celestial Blue Sage	25	5 gal. 5 gal. 5 gal. 5 gal. 5 gal.	
	$\odot$	INFILL SHRUB Small to medium shrub for mass planting Callistemon viminalis 'Little John' / Little John Weeping Bottlebrush Multienbergla capillaris / Pirk Muhiy Grass Muhlenbergla rigens / Deer Grass	18	5 gal. 5 gal. 5 gal.	
		LOW EVERGREEN GROUND COVER Evergreen ground cover for mass planning, 6*-18* tall Arctostaphylos x 'Emeratid Carpet' / Emeratid Carpet Maruzanita Baccharts pilularis 'Pilgono Polit' / Pigeon Polit' Cryote Rush Rosmarinus officinalis 'Huntington Carpet' / Huntington Carpet Rosemary	1,792 sf 207 75 117	1 gal. 1 gal. 1 gal.	36" oc 60" oc 48" oc
		ACCENT GROUND COVER Ground cover with interesting flowers or texture, 12*-24" height Salvia sonomensis / Creeping Sage Zeuschneria californica / California Fuchsia	739 sf 48 86	1 gal. 1 gal.	48" oc 36" oc


### WELO COMPLIANCE

This project has been designed to conform with the State's Model Water Efficient Landscape Ordinanos (MMELO).

IRRIGATION DESIGN
The irrigation on the site will use drip irrigation, will meet the City's requirements, and will comply with
the requirements of WELO. Equipment will include dedicated irrigation mater, smart controller, weather
sensor, and efficient irrigation emitters, nozzles, and other equipment.

### PLANTING DESIGN

FLAN INVOLUESION
The landscape design uses water-wise plant species suitable for file region and that are low maintenance and dutable, uses trees to shade paved areas, and plants have been grouped into hydro-zones. References used for the landscape design include published information from the local jurisdiction, Sunset Western Garden Book and WUCOLS.

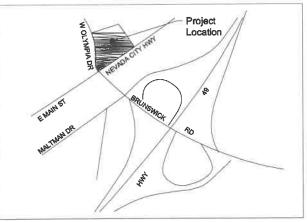



Estimated Total Water Use (FTWII):

Estimated Average ETAF:

Maximum Allowable ETAF:

Maximum Applied Water Allowance (MAWA):

107.733 gal.

18,210 gal.

0.45





Sam Harned Landscape Architecture Oakdale, CA 95361 209-380-7376







WASH ర HWY, GRASS VALLEY, CAR AND STATION 1912 NEVADA CITY GAS


18 Nov 2022 RSH Checked: Project No.: 22-059 1" = 20'-0"


> Preliminary Landscape Plan


> > L1

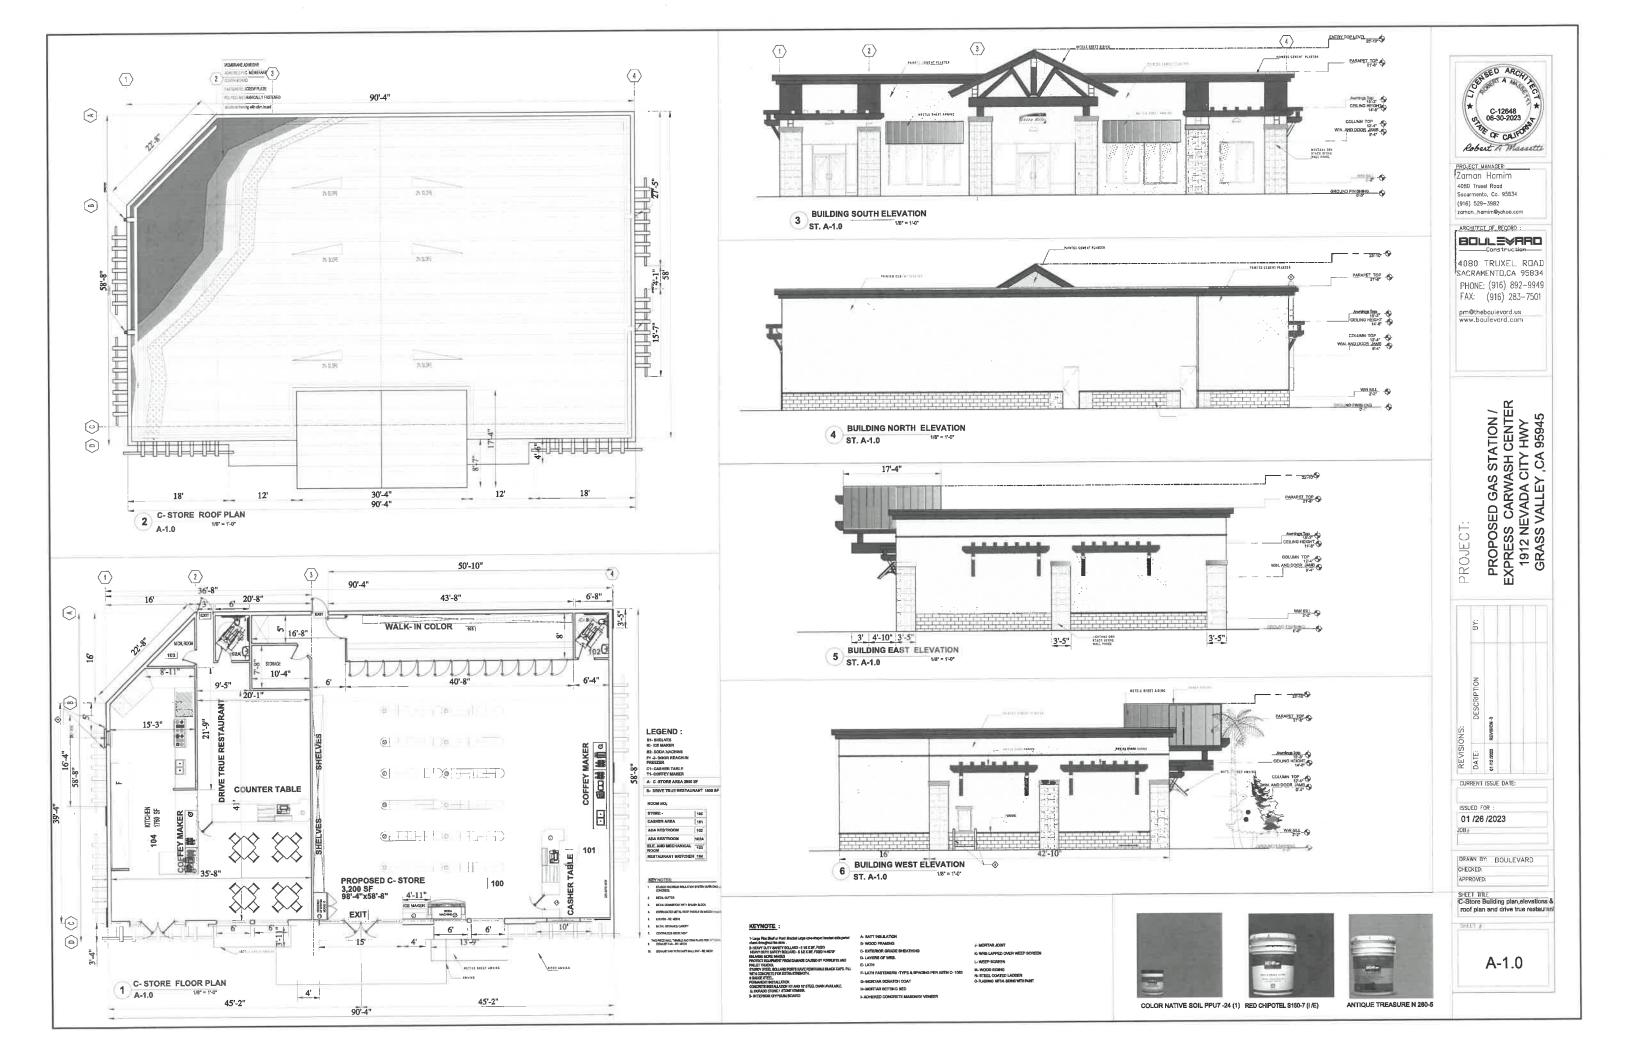

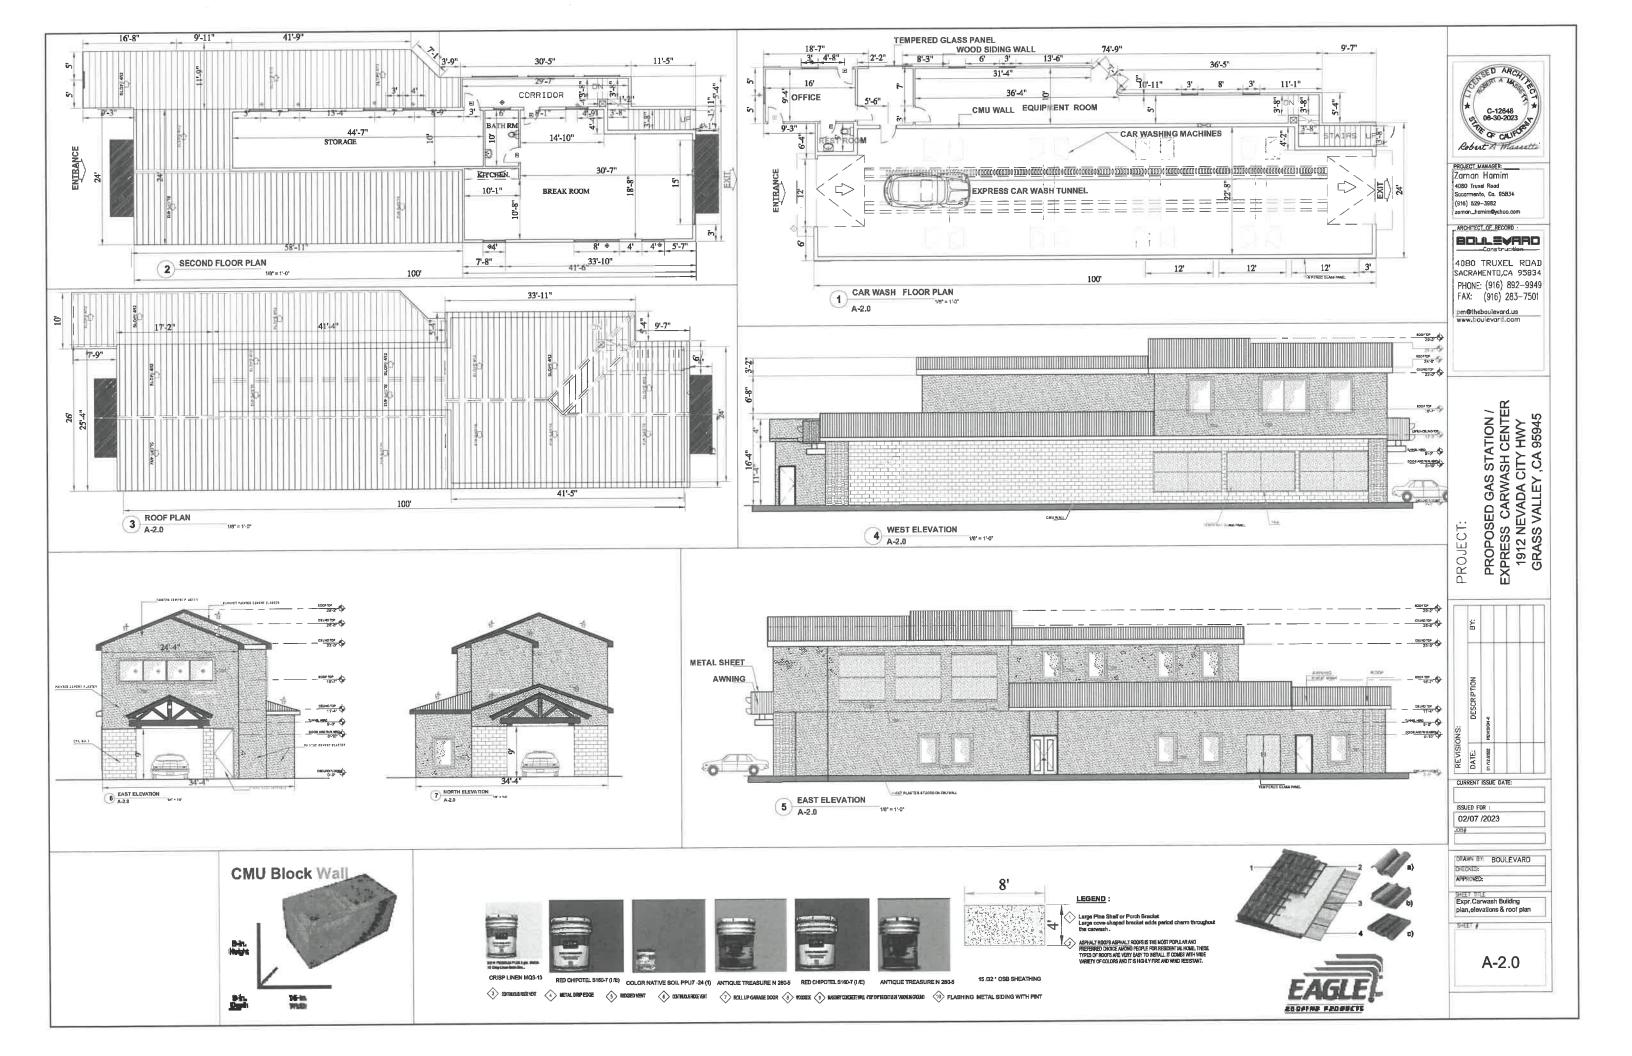

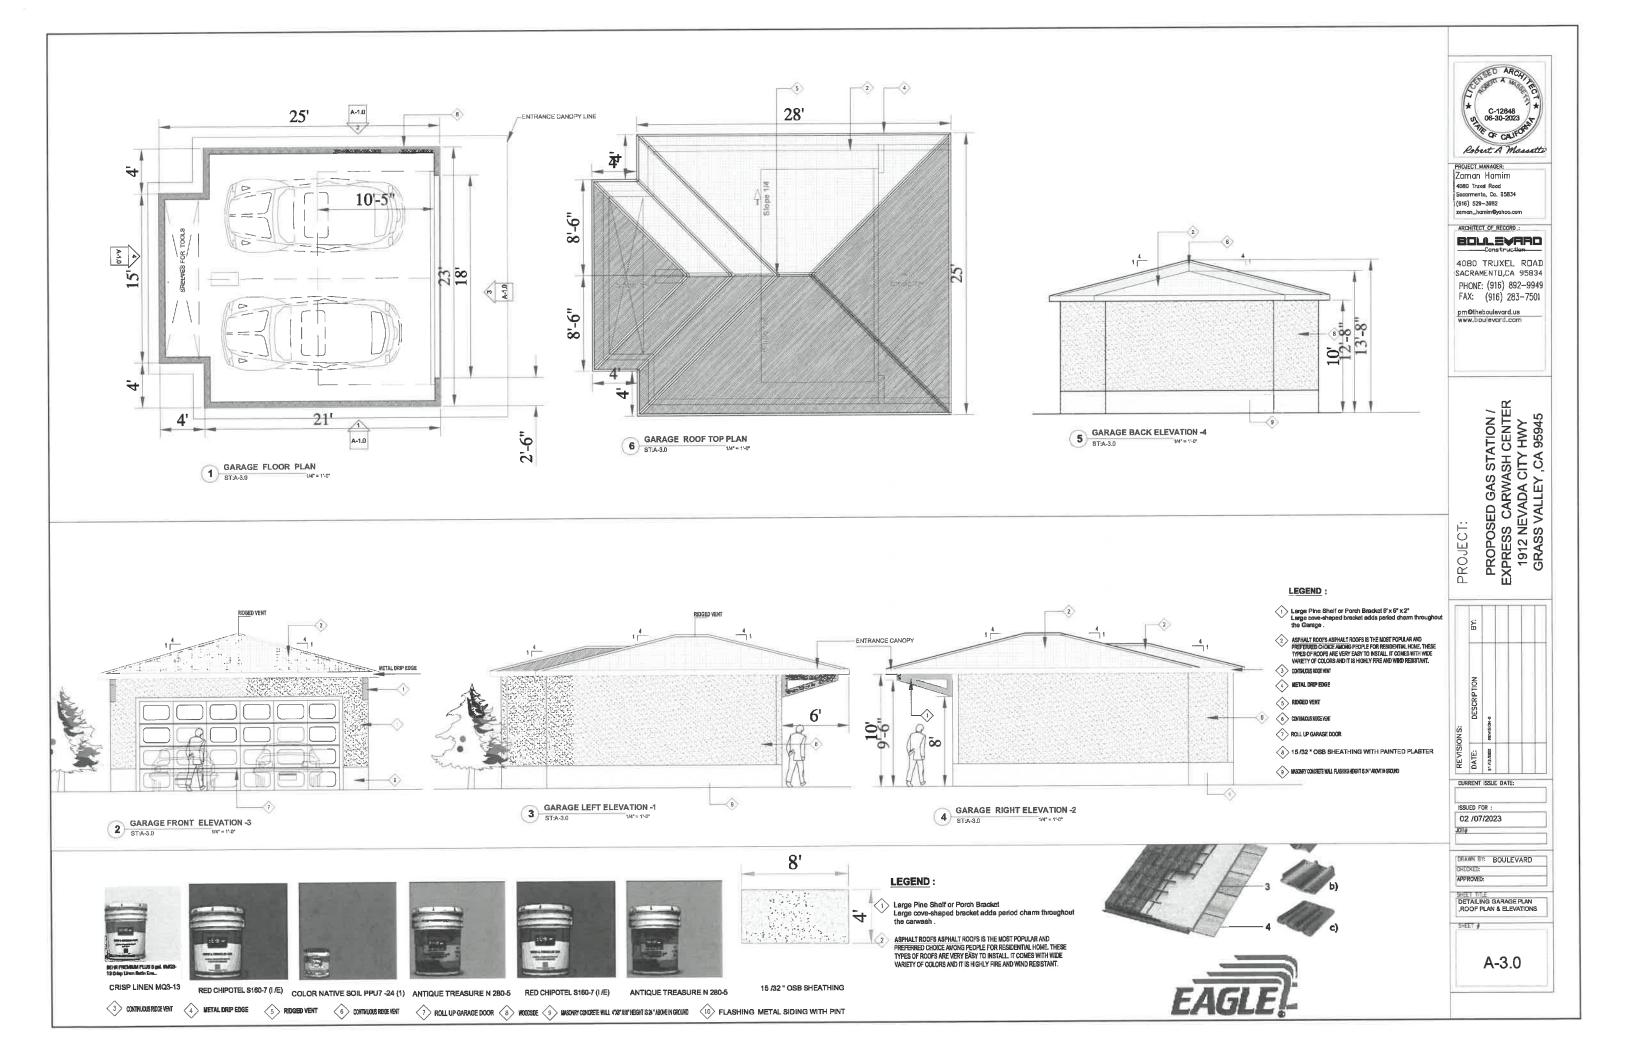

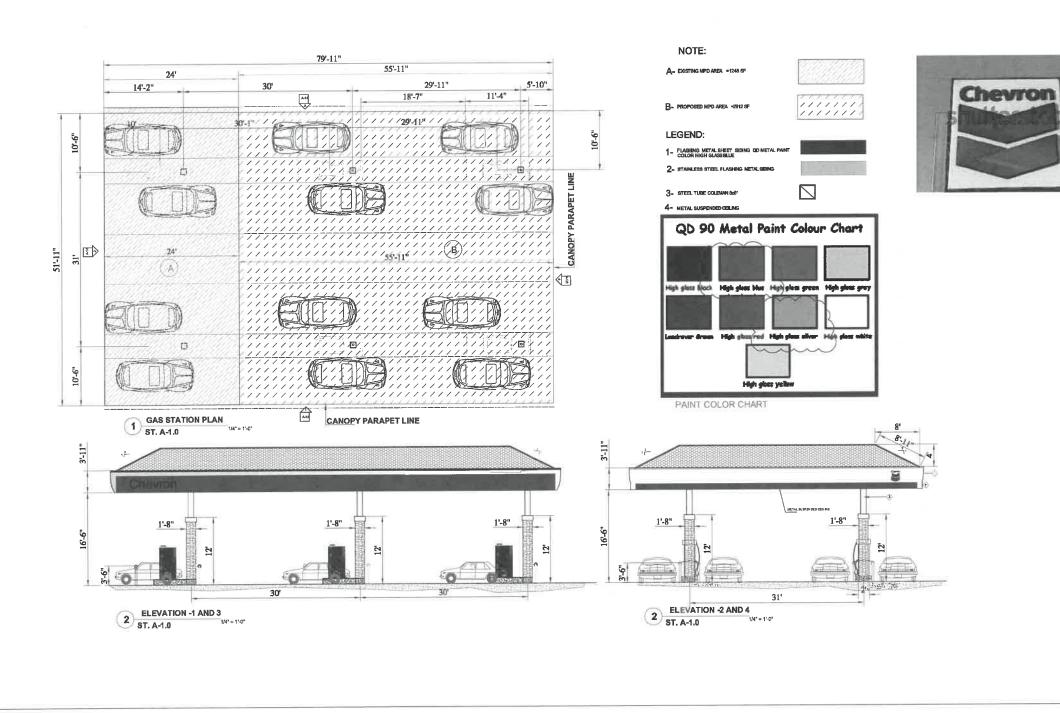

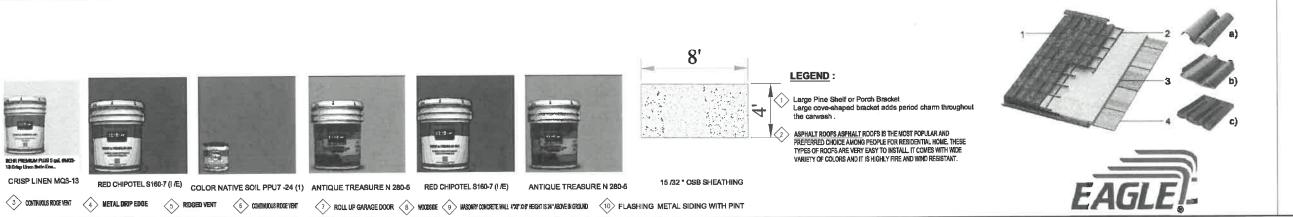

C-12848

OB-30-2023

Robest A Massetts

EROJECT\_MANAGER:
Zaman Harnim
4080 Truxel Road
Sacarmento, Ca. 95834
(916) 529-3982
zaman\_harnim@yahao.com

ARCHITECT OF RECORD :

BOLLEVARD

4080 TRUXEL ROAD SACRAMENTO,CA 95834 PHONE: (916) 892-9949 FAX: (916) 283-7501

m@theboulevard.us

Y TER

PROPOSED GAS STATION / EXPRESS CARWASH CENTER 1912 NEVADA CITY HWY GRASS VALLEY ,CA 95945

PROJECT:




CURRENT ISSUE DATE:


02/07/2023

DRAWN BY: BOULEVARD
ONEOXED:
APPROVED:

GAS STATION PLAN ,& ELEVATIONS

A-4.0

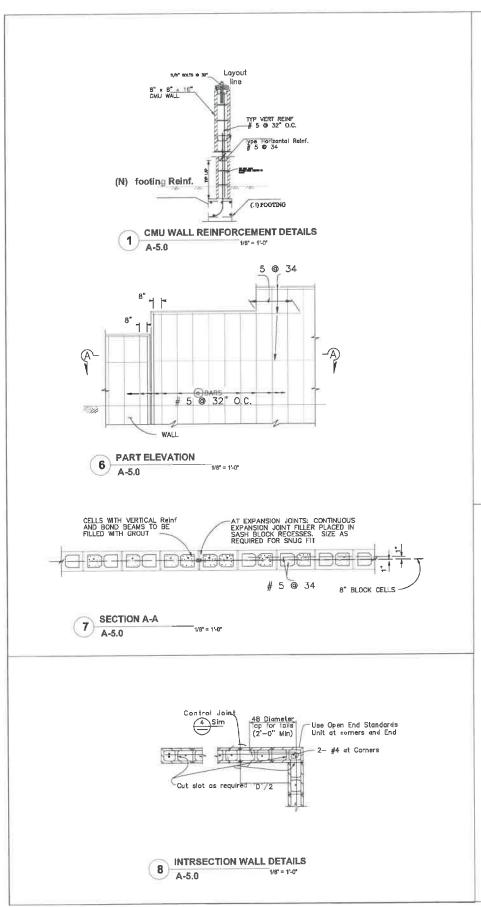

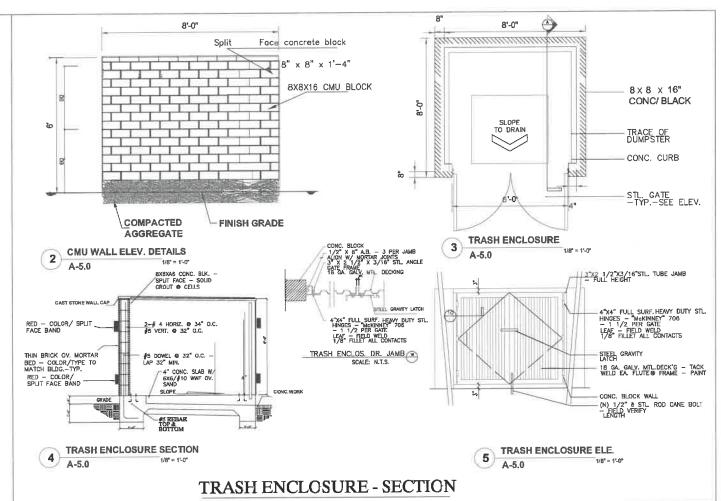

PROJECT\_MANAGER: Zaman Hamim 4080 Truxel Road Sacarmento, Ca. 95834 (916) 529-3982

ARCHITECT OF RECORD : 

4080 TRUXEL ROAD SACRAMENTU,CA 95834 PHONE: (916) 892-9949 FAX: (916) 283-7501

pm@theboulevard.us www.boulevard.com

PROPOSED GAS STATION / EXPRESS CARWASH CENTER 1912 NEVADA CITY HWY GRASS VALLEY ,CA 95945

PROJECT:

REVISIONS:	ONS:	
DATE:	DESCRIPTION	BY:
12 MB 20201	REVISION-0	

ISSUED FOR : 02 /07 /2023 J08#

DRAWN BY: BOULEVARD APPROVED:

TRASH INCLOSURE DETAILS

SHEET

A-5.0

