Planning Commission

Hearing Date: January 9, 2024

Effective Date: January 19, 2024

PLANNING COMMISSION RESOLUTION NO. 2024-02

A RESOLUTION OF THE PLANNING COMMISSION OF THE CITY OF ESCONDIDO, CALIFORNIA, APPROVING A CONDITIONAL USE PERMIT FOR THE DEVELOPMENT OF A NORTH COUNTY TRANSIT DISTRICT FLEET VEHICLE AND MAINTENANCE OPERATIONS EXPANSION

APPLICANT: North County Transit District

CASE NO: PL21-0057

WHEREAS, North County Transit District ("Applicant"), filed a land use development application, Planning Case No. PL21-0057 ("Application"), with the City of Escondido ("City") constituting a request to process a Conditional Use Permit for the development of a proposed fleet storage area adjacent to their existing East Division Maintenance Facility. The Breeze Operations East Site Expansion ("Project") consists of approximately 56,100 square feet of paved fleet vehicle storage area, repurposing the site, consolidation of entrances, repaving, restriping, screening, and providing perimeter landscape enhancements; and

WHEREAS, the proposed Project is located at the southwest corner of N. Quince Street and Norlak Avenue and directly north of the Escondido Creek Channel, and addressed as 335 N. Quince Street (APN 232-091-20-00), in the Light Industrial (M-1) zone and has a General Plan Land Use designation of General Industrial (GI); and

WHEREAS, the subject property is all that real property described in Exhibit "A" which is attached hereto and made a part hereof by this reference as though fully set forth herein ("Property"); and

WHEREAS, the Application was submitted to, and processed by, the Planning Division of the Development Services Department in accordance with the rules and regulations of the Escondido Zoning Code and the applicable procedures and time limits specified by the Permit Streamlining Act (Government Code section 65920 et seq.) and the California Environmental Quality Act (Public Resources Code section 21000 et seq.) ("CEQA"); and

WHEREAS, fleet vehicle storage and support services as ancillary uses are permitted within the Light Industrial (M-1) zone, subject to the approval of a Conditional Use Permit, in accordance with Section 33-564 (Table 33-564) of the Escondido Zoning Code and Article 57 provisions; and

WHEREAS, pursuant to CEQA and the CEQA Guidelines (Title 14 of California Code of Regulations, Section 15000 et. seq.), the City is the Lead Agency for the Project, as the public agency with the principal responsibility for approving the proposed Project; and

WHEREAS, the Planning Division studied the Application, performed necessary investigations, prepared a written report, and hereby recommends approval of the Project as depicted on the plan set shown in Exhibit "B", which is attached hereto and made a part hereof by this reference as though fully set forth herein; and

WHEREAS, City staff provided public notice of the application in accordance with City and State public noticing requirements; and

WHEREAS, on January 9, 2024, the Planning Commission held a duly noticed public hearing as prescribed by law, at which time the Planning Commission received and considered the reports and recommendation of the Planning Division and gave all person's full opportunity to be heard and to present evidence and testimony regarding the Project. Evidence was submitted to and considered by the Planning Commission, including, without limitation:

- a. Written information including plans, studies, written and graphical information, and other material, submitted by the Applicant;
- b. Oral testimony from City staff, interested parties, and the public;
- c. The staff report, dated January 9, 2024, with its attachments as well as City staff's recommendation on the Project, which is incorporated herein as though fully set forth herein; and
- d. Additional information submitted during the public hearing; and

WHEREAS, the public hearing before the Planning Commission was conducted in all respects as required by the Escondido Municipal Code and the rules of this Planning Commission.

NOW, THEREFORE, BE IT RESOLVED by the Planning Commission of the City of Escondido that:

- 1. The above recitations are true and correct.
- 2. The Planning Commission, in its independent judgement, has determined the Project to be exempt from environmental review pursuant to California Environmental Quality Act ("CEQA"), CEQA Guidelines section 15332, Class 32 (In-Fill Development). The Project qualifies for an exemption under CEQA Guidelines from the California

Environmental Quality Act (CEQA) under Section 15332, Class 32 In-fill Development Project. The proposed project or its circumstances would not result in any exceptions identified in CEQA Guidelines, Section 15300.2. Among the classes of projects that are exempt from CEQA review are those projects that are specifically identified as urban in-fill development. CEQA Guidelines, Section 15332, defines in-fill development (Class 32 exemptions) as being applicable to projects meeting the following conditions:

- The project is consistent with the applicable general plan designation and all applicable general plan policies as well as with applicable zoning designation and regulations.
- The proposed development occurs within city limits on a project site of no more than five (5) acres substantially surrounded by urban uses.
- The project site has no value as habitat for endangered, rare or threatened species.
- Approval of the project would not result in any significant effects relating to traffic,
   noise, air quality, or water quality.
- The site can be adequately served by all required utilities and public services.
- 3. The project does not involve the use of significant amounts of hazardous substances; and is serviced by all necessary public services and facilities and the site is connected to City sewer and water services.
- 4. After consideration of all evidence presented, and studies and investigations made by the Planning Commission and on its behalf, the Planning Commission makes the substantive findings and determinations attached hereto as Exhibit "C" relating to the information that has been considered. In accordance with the

Findings of Fact and the foregoing, the Planning Commission reached a decision on the matter as hereinafter set forth.

- 5. The Application to use the Property for the Project, subject to each and all the conditions hereinafter set forth in Exhibit "D", is hereby approved by the Planning Commission. The Planning Commission expressly declares that it would not have approved this Application except upon and subject to each and all of said conditions, each and all of which shall run with the land and be binding upon the Applicant, the owner, and all subsequent owners of the Property, and all persons who use the Property for the use permitted hereby.
- 6. The Planning Commission, therefore, directs that a Notice of Exemption be filed with the County Clerk of the County of San Diego in accordance with the CEQA Guidelines.
- 6. The development plans for the Project are on file in the Planning Division of the Development Services Department and are available for inspection by anyone interested herein, and the development plans are incorporated herein by this reference as if they were fully set forth herein. The Project is conditionally approved as set forth on the Application and Project drawings, all designated as approved by the Planning Commission, and which shall not be altered without the express authorization by the Planning Division. Any deviations from the approved development plans shall be reviewed by the City for substantial compliance and may require amendment by the appropriate hearing body.

BE IT FURTHER RESOLVED that, pursuant to Government Code section 66020(d)(1):

1. NOTICE IS HEREBY GIVEN that the Project is subject to dedications,

reservations, and exactions, as specified in the Conditions of Approval. The Project is

subject to certain fees described in the City of Escondido's Development Fee Inventory

on file in both the Planning Division and Engineering Division of the Development

Services Department. The Applicant shall be required to pay all development fees of the

City then in effect at the time and in such amounts as may prevail when building permits

are issued. It is the City's intent that the costs representing future development's share of

public facilities and capital improvements be imposed to ensure that new development

pays the capital costs associated with growth. The Applicant is advised to review the

Planned Fee Updates portion of the web page, <u>www.escondido.org</u>, and regularly monitor

and/or review fee-related information to plan for the costs associated with undertaking the

Project.

2. NOTICE IS FURTHER GIVEN that the 90-day period during which to

protest the imposition of any fee, dedication, reservation, or other exaction described in

this Resolution begins on the effective date of this Resolution, and any such protest must

be in a manner that complies with Government Code section 66020.

PASSED, ADOPTED, AND APPROVED by a majority vote of the Planning Commission

of the City of Escondido, California, at a regular meeting held on the 9th day of January,

2024, by the following vote, to wit:

AYES: COMMISSIONERS:

NOES: COMMISSIONERS:

ABSTAINED: COMMISSIONERS:

	ABSENT:	COMMISSIO	ONERS:
ATTEST:			Rick Paul, Chair Escondido Planning Commission
	Morones, Secreto Planning Comr	•	
	I hereby certif	fy that the forego	ing Resolution was passed at the time and by
the vote a	bove stated.		
			Alexander Rangel, Minutes Clerk Escondido Planning Commission

Decision may be appealed to City Council pursuant to Zoning Code Section 33-1303

# Exhibit "A"

# Planning Case No. PL21-0057

# **Legal Description**

## Legal Description of Land

Real property in the City of Escondido, County of San Diego, State of California, described as follows:

PARCEL 2 OF PARCEL MAP #4261 IN THE CITY OF ESCONDIDO, IN THE COUNTY OF SAN DIEGO, STATE OF CALIFORNIA, ACCORDING TO MAP THEREOF ON FILE IN THE OFFICE OF THE COUNTY RECORDER OF SAN DIEGO COUNTY, NOVEMBER 25, 1975.

APN: 232-091-20-00

# Exhibit "B" Planning Case No. PL21-0057

Project Plans

# **BREEZE OPERATIONS EAST SITE EXPANSION**

335 N. QUINCE STREET ESCONDIDO, CA 92806

#### DECLARATION OF RESPONSIBLE CHARGE

I HEREBY DECLARE THAT I AM THE ENGINEER OF WORK FOR THIS PROJECT. THAT I HAVE EXERCISED RESPONSIBLE CHARGE OVER THE DESIGN OF THE PROJECT AS DEFINED IN SECTION 6703 OF THE BUSINESS AND PROFESSIONS CODE, AND THAT THE DESIGN IS CONSISTENT WITH CURRENT STANDARDS.

LUNDERSTAND THAT THE CHECK OF PROJECT DRAWINGS AND SPECIFICATIONS BY THE CITY OF ESCONDIDO IS CONFINED TO A REVIEW ONLY AND DOES NOT RELIEVE ME, AS ENGINEER OF WORK, OF MY RESPONSIBILITIES FOR PROJECT DESIGN.

NAME OF ENGINEER R.C.E # EXP. DĀTE \_

#### SURVEY NOTE:

COORDINATES SHOWN ARE BASED ON THE CALIFORNIA COORDINATE SYSTEM (CCS83), ZONE VI, 1983 NAD (2017.50 EPOCH)

BEARINGS ARE BASED ON THE BEARING BETWEEN CALIFORNIA SPATIAL REFERENCE CENTER CONTINUOUS GPS STATIONS "DSME" TO "RAPP" BEING Not "18'37.5" E


ELEVATIONS ARE BASED ON CITY OF ESCONDIDO BENCH MARK 68-A DESCRIBED AS "CHISELED X ON TOP OF CURB, AT THE CENTER OF CUBB RETURN, ON THE N.W. CORNER OF 9TH AVENUE AND JUMPER STREET. RESET 12/2005."
ELEV. = 640.07 FEET INGYO 29. YEAR OF ADJUSTMENT. 2012)

DATE OF SURVEY: MAY 2020



2 WORKING DAY



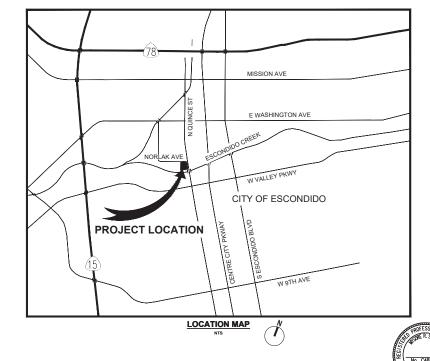

INDEX OF DRAWINGS					
DWG NO.	SHT NO.	SHEET TITLE			
C-001	09	TITLE SHEET			
C-101	10	SITE PLAN			
C-102	11	DEMOLITION PLAN			
C-103	12	CONSTRUCTION PLAN			
C-104	13	GRADING AND DRAINAGE PLAN			
C-105	14	EROSION CONTROL PLAN			
C-106	15	UTILITIES PLAN			
C-107	16	SIGNAGE AND STRIPING PLAN			
C-501	17	DETAILS			
C-501A	18	DETAILS			
C-502	19	DETAILS			
C-503	20	DETAILS			
C-504	21	DETAILS			
C-505	22	DETAILS			
C-506	23	DETAILS			
C-507	24	DETAILS			
C-508	25	DETAILS			

#### SOILS ENGINEER CERTIFICATE

THIS GRADING AND RETAINING WALL PLAN HAS BEEN REVIEWED BY THE UNDERSIGNED AND FOUND TO BE IN CONFORMANCE WITH THE RECOMMENDATIONS AND SPECIFICATIONS OUTLINED IN THE SOILS REPORT PREPARED FOR THIS DEVELOPMENT.

COMPANY:		
ADDRESS:		
PHONE:	DATE:	
ENGINEER:		
		R C F NO



RECORD DRAV	NING
TIEGOTIE ETITU	71110
PRINT ENGINEER'S NAME R C F	DATE

CITY OF ESCONDIDO ENGINEERING DEPARTMENT				
APPROVED				
ByDate				
Comments				
OBTAIN GRADING PERMIT AT FIELD ENGINEERING OFFICE				

#### NOT FOR CONSTRUCTION

				DESIGNED BY:	
					JD
	09/16/22	JD	SWQMP REVISIONS TO MWS	DRAWN BY:	
	09/24/21	JD	NCTD REQUESTED UPDATES		ZO
	01/29/21	JD	FINAL DESIGN (CUP SET)	CHECKED BY:	
	12/07/20	JD	FINAL DESIGN		ΚT
	10/02/20	JD	50% DESIGN SUBMITTAL	DATE:	
REV	DATE	BY	DESCRIPTION	09/16	3/22







PROJECT TITLE BREEZE OPERATIONS EAST	PROJECT NO	4020125
SITE EXPANSION	SCALE	N/A
SHEET TITLE TITLE SHEET	DRAWING NO	C-001
IIILE SHEET	SHEET NO	9 OF 45



SITE PLAN



#### **GENERAL NOTES:**

- ALL WORK TO BE DONE IN ACCORDANCE WITH THE STANDARD SPECIFICATIONS FOR PUBLIC WORKS CONSTRUCTION, 2015 EDITION, EFFECTIVE DECEMBER 07, 2016 BY RESOLUTION NO. 2016-17 AND THE DESIGN STANDARDS AND STANDARD DRAWINGS OF THE CITY OF ESCONDIDO EFFECTIVE APRIL 02, 2014 BY RESOLUTION 2014-08, ALONG WITH ANY AMENDMENTS THERETO.
- ALL CONTRACTORS WORKING IN THE PUBLIC RIGHT OF WAY SHALL ORTAIN A SEPARATE ENCROACHMENT PERMIT WITH THE CITY OF ESCONDIDO FROM THE DIRECTOR OF ENGINEERING SERVICES, INSPECTION OF ALL WORK IS REQUIRED. CONTACT THE ENGINEERING FIELD OFFICE AT (760) 839-4664 TO ARRANGE FOR ENCROCHMENT PERMITS AND INSPECTION. TWENTY-FOUR HOUR ADVANCE NOTICE IS REQUIRED FOR INSPECTION. NO WORK SHALL BE PERFORMED IN THE PUBLIC RIGHT OF WAY ON SATURDAYS, SUNDAYS OR LEGAL HOLIDAYS WITHOUT THE EXPRESS PERMISSION OF THE CITY ENGINEER.
- 3. IT SHALL BE THE RESPONSIBILITY OF THE CONTRACTOR TO LOCATE ALL SUBSTRUCTURES, WHETHER SHOWN HEREON OR NOT, AND PROTECT THEM FROM DAMAGE. THE EXPENSE OF REPAIR OR REPLACEMENT OF SAID SUBSTRUCTURES SHALL BE BORNE BY THE CONTRACTOR.
- 4. LOCATION AND ELEVATION OF ALL EXISTING IMPROVEMENTS WITHIN THE AREA OF WORK SHALL BE CONFIRMED BY FIELD MEASUREMENT PRIOR TO CONSTRUCTION OF NEW WORK, CONTRACTOR WILL MAKE EXPLORATORY EXCAVATIONS AND LOCATE EXISTING UNDERGROUND FACILITIES SUFFICIENTLY AHEAD OF CONSTRUCTION TO PERMIT REVISIONS TO PLANS IF REVISIONS ARE NECESSARY BECAUSE OF ACTUAL LOCATION OF EXISTING FACILITIES.

# ASSESSOR'S PARCEL NUMBER (APN): 232-091-20


SITE ADDRESS: 335 NORTH QUINCE STREET ESCONDIDO, CA 92025

LEGAL DESCRIPTION:
PARCEL 2 OF PARCEL MAP #4261 IN THE CITY OF ESCONDIDO, IN THE COUNTY OF SAN DIEGO, STATE OF CALIFORNIA, ACCORDING TO MAP THEREOF ON FILE IN THE OFFICE OF THE COUNTY RECORDER OF SAN DIEGO COUNTY, NOVEMBER 25, 1975.

EASEMENTS:
ITEM 3: AN EASEMENT FOR PIPE LINES, DITCHES AND INCIDENTAL PURPOSES, RECORDED AUGUST 1, 1895 IN BOOK 238 OF DEEDS, PAGE 390. IN FAVOR OF: ESCONDIDO IRRIGATION DISTRICT. NOT PLOTTABLE FROM RECORD DATA.

ITEM 4: AN EASEMENT FOR LAY WATER PIPES ACROSS SAID LAND AND INCIDENTAL PURPOSES IN THE DOCUMENT RECORDED AUGUST 25, 1908 IN BOOK 449 OF DEEDS, PAGE 13.

ITEM 5: AN EASEMENT FOR WATER PIPE LINE AND INCIDENTAL PURPOSES, RECORDED NOVEMBER 23, 1962 AS INSTRUMENT NO. 200754 OF OFFICIAL RECORDS. IN FAVOR OF: MERLE F. FARR AND ELLEN D. FARR, HUSBAND AND WIFE AS COMMUNITY PROPERTY

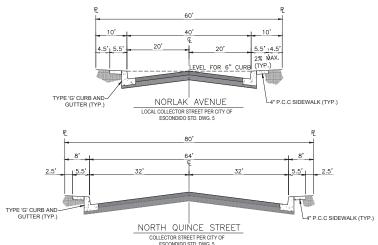

#### NOT FOR CONSTRUCTION


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PROJECT TITLE BREEZE OPERATIONS EAST	PROJECT NO	4020125
SITE EXPANSION	SCALE	1" = 40'
SITE PLAN	DRAWING NO	C-101
SITE PLAIN	SHEET NO	10 OF 45



**LEGEND** 

1 REMOVE EXISTING DRIVE APPROACH AND SIDEWALK

2 REMOVE EXISTING ASPHALT PAVEMENT

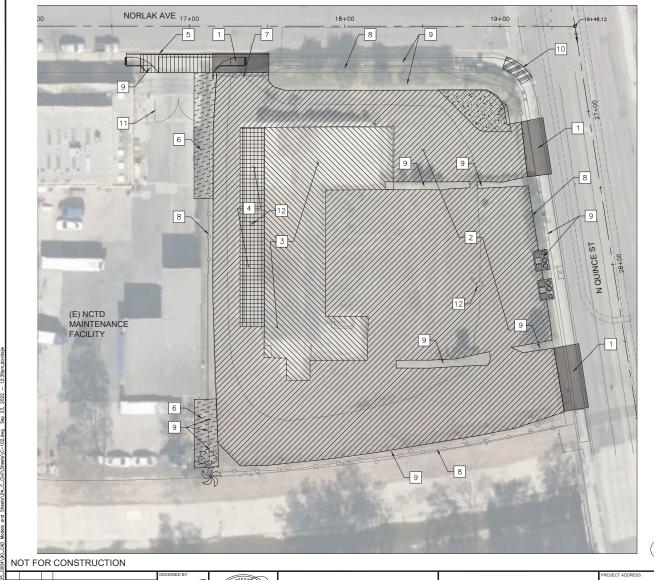3 REMOVE EXISTING CONCRETE FOUNDATION

REMOVE EXISTING TRUCK DOCK, RETAINING WALL AND CONCRETE PAVEMENT

REMOVE EXISTING CURB AND SIDEWALK AS REQUIRED FOR NEW DRIVE APPROACH.

REMOVE INTERFERING PORTIONS OF ADJACENT 6 IMPROVEMENTS AS REQUIRED FOR NEW DRIVEWAY CIRCULATION

7 REMOVE EXISTING VEHICLE GATE AND RELATED FOUNDATIONS.

REMOVE EXISTING PERIMETER FENCE AND RELATED FOUNDATIONS.

9 REMOVE EXISTING VEGETATION (GREES, SHRUBS, GRASS) AND PARKING ISLAND.

REMOVE EXISTING SIDEWALK AND CONCRETE PEDESTRIAN RAMP AS REQUIRED FOR NEW ADA CURB RAMP.

11 REMOVE EXISTING FENCE AND VEHICLE GATE.

12 REMOVE EXISTING AREA DRAIN AND INTERFERING PORTIONS OF EXISTING STORM DRAIN LINE







4020125

1" = 20'

C-102

11 OF 45


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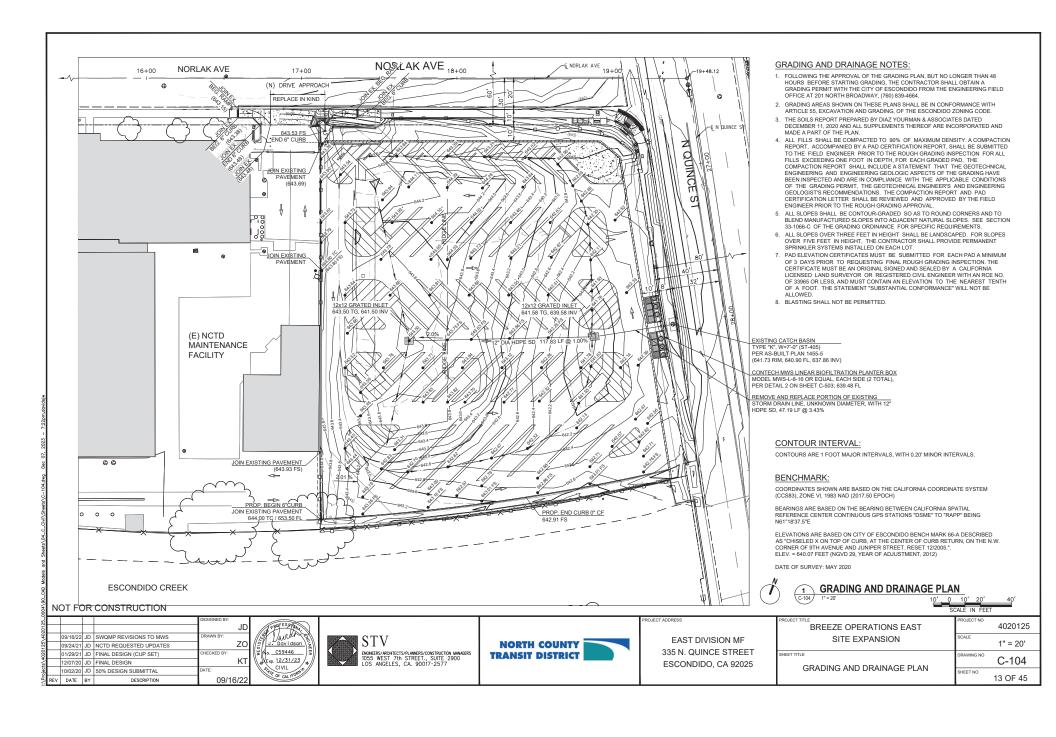




**NORTH COUNTY** TRANSIT DISTRICT

ROJECT TITLE BREEZE OPERATIONS EAST	PROJECT
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DEMOLITION PLAN	DRAWING
DEMOLITION PLAN	SHEET N



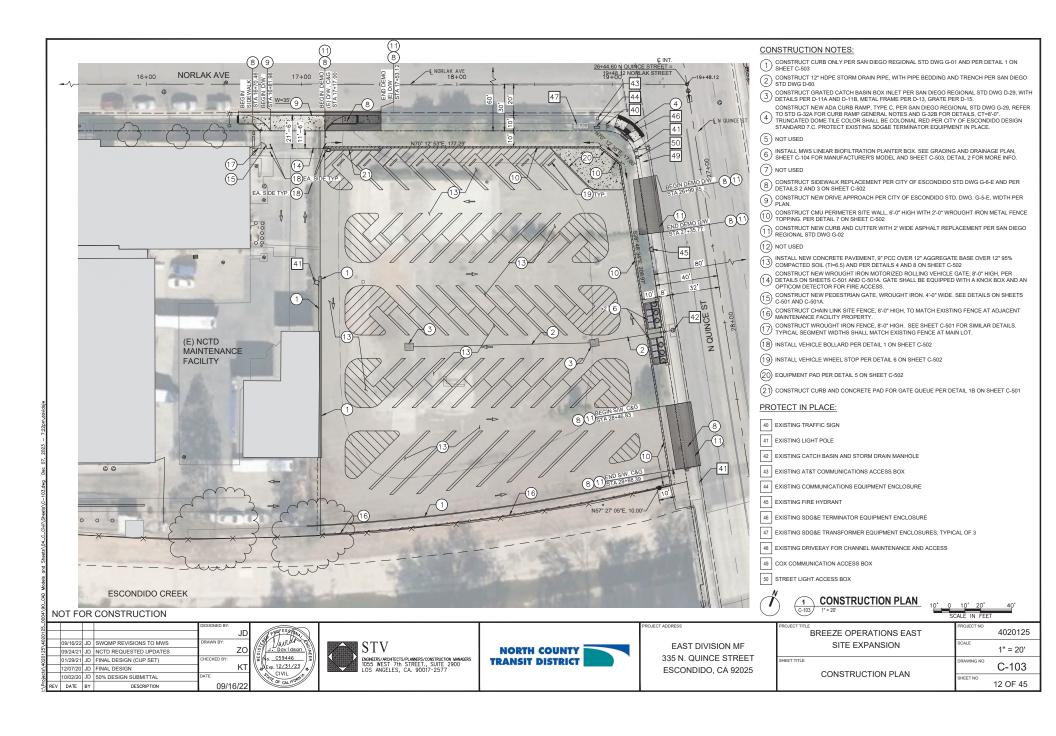



#### STORM WATER POLLUTION PREVENTION NOTES:

- 1. BEST MANAGEMENT PRACTICES (BMPS) SHALL BE IMPLEMENTED DURING ALL PHASES OF CONSTRUCTION IN CONFORMANCE WITH THE CITY OF ESCONDIDO'S MUNICIPAL CODE. ADDITIONALLY, SITES OVER AN ACRE SHALL ABIDE BY THE CONSTRUCTION GENERAL PERMIT (CGP) ALL BMPS SHALL BE INSTALLED IN ACCORDANCE WITH THE MOST BET THE CONSTRUCTION GENERAL PERMIT (COPF). ALL DIMPS STRAIL BE INSTRUCTED IN ACCORDANCE WITH THE MIGST RECENT VERSION OF THE CASQA HANDBOOK, AT A MINIMUM PERMITER CONTROL AND CONSTRUCTION ENTRANCES SHOULD BE IN PLACE PRIOR TO A GRADING PERMIT BEING ACTIVATED.
- 2. INSPECTION, MODIFICATION AND MAINTENANCE OF THE BMPS SHALL BE IMPLEMENTED AS NECESSARY. IN THE EVENT OF FAILURE OR REFUSAL TO PROPERLY MAINTAIN THE BMPS. THE CITY MAY ISSUE EMERGENCY MAINTENANCE WORK TO BE COMPLETED TO PROTECT ADJACENT PRIVATE AND PUBLIC PROPERTY. THE COST (INCLUDING AN INITIAL MOBILIZATION AMOUNT) AND ANY FINES ASSESSED TO THE CITY SHALL BE CHARGED TO THE OWNER OF THE PROJECT
- 3. NECESSARY MATERIALS TO IMPLEMENT THE REQUIRED BMPS SHALL BE AVAILABLE ON SITE TO FACILITATE RAPID DEPLOYMENT OR TO REPAIR ANY BMP FAILURES
- 4. CITY STAFF SHALL BE ALERTED BY THE CONTRACTOR, PERMITTEE OR OWNER, AS NEEDED FOR EMERGENCY WORK DURING STORMS
- RUN-ON FLOW ONTO THE SITE SHALL BE PROPERLY MANAGED AND PLANNED FOR TO PREVENT FAILURE OF BMPS
  AND/OR ILLEGAL DISCHARGES FROM THE PROJECT SITE INTO THE STORM DRAIN.
- 6. STORM DRAIN INLET PROTECTION SHALL BE INSTALLED AT EVERY ONSITE STORM DRAIN INLET TO PREVENT SEDIMENT FROM ENTERING THE STORM DRAIN SYSTEM. WHERE FEASIBLE DESILTING BASINS SHALL ALSO BE PROVIDED AT DRAINAGE OUTLETS FROM THE GRADED SITE.
- 7. EROSION CONTROL MEASURES SHALL BE IMPLEMENTED ON SLOPES AND ANY EXPOSED SOIL USING THE FOLLOWING BMPS. FIBER BLANKETS. BONDED FIBER MATRIX: OR BY INSTALLING OR MAINTAINING EXISTING VEGETATION. THE CONTRACTOR SHALL IMMEDIATELY REPAIR AND STABILIZE ANY ERODED AREAS. INACTIVE SLOPES SHALL BE PROTECTED AND STABILIZED. ALL EXPOSED SOIL INCLUDING INACTIVE AND ACTIVE SLOPES SHALL BE PROTECTED. PRIOR TO A RAIN EVENT
- 8. ALL UNPAVED GRADED CHANNELS SHALL IMPLEMENT EROSION PREVENTION MEASURES SUCH AS LINING AND INSTALLING VELOCITY CHECK DAMS AT REGULAR INTERVALS.
- 9. STREET SWEEPING VEHICLES WITH VACUUMS AND WATER TANKS SHALL BE USED TO KEEP PAVED STREETS FREE OF LOOSE SOIL AND/OR CONSTRUCTION DEBRIS.
- 10. CONTRACTORS SHALL HAVE WATER TRUCKS AND EQUIPMENT ON-SITE TO MINIMIZE AIRBORNE DUST CREATED FROM GRADING AND HAULING OPERATIONS OR EXCESSIVE WIND CONDITIONS. ADDITIONAL DUST CONTROL MEASURES SHALL BE IMPLEMENTED AS NEEDED.
- 11 STOCKPILES SHALL BE COVERED AT THE END OF EACH WORKING DAY AND PRIOR TO FORECAST RAIN ASPHALT SHALL ADDITIONALLY BE PLACED ON A LAYER OF PLASTIC SHEET, OR EQUIVALENT.
- 12. ALL PORTABLE TOILETS SHALL HAVE SECONDARY CONTAINMENT AND NOT BE LOCATED NEAR STORM DRAIN (I.E., CATCH BASIN OR STREET)
- 13. VEHICLES SHALL HAVE DRIP PANS UNDERNEATH THEM AND ANY LEAKS OR SPILLS SHALL BE PROMPTLY REPAIRED AND
- ALL DEBRIS SHALL BE PLACED IN DUMPSTERS WITH LIDS. THE LIDS SHALL BE CLOSED AT THE END OF EACH DAY AND ARE NOT TO BE OVERFILLED. ADDITIONAL TRASH PICK-UPS SHALL BE MADE AS NECESSARY.
- 15. LIQUID MATERIALS SHALL BE STORED IN CLOSED CONTAINERS IN SECONDARY CONTAINMENT AND UNDER COVER.
- SOLID MATERIALS SHALL BE STORED ON PALLETS AND BE COVERED PRIOR TO FORECAST RAIN.

  16. A MATERIALS WASHOUT SHALL BE AVAILABLE ONSITE WHENEVER LIQUID MATERIALS ARE USED. THE WASHOUT SHALL
- FULLY CONTAIN WASH MATERIALS AND THE SURROUNDING AREA SHALL BE KEPT FREE OF SPILLS.
- 17. DISCHARGE OF POTABLE WATER (SUCH AS FROM POWER WASHING OR FILLING WATER TRUCKS) SHALL BE PREVENTED OR DIRECTED TO LANDSCAPE.
- 18. PERIMETER CONTROL IS REQUIRED ON ALL SITES
- 19. ALL ACTIVE ENTRANCES SHALL PREVENT TRACKING BY INSTALLING STABILIZED CONSTRUCTION ENTRANCES.

#### ENGINEER'S CERTIFICATION OF STRUCTURAL BMP'S

THE ENGINEER OF RECORD SHALL VERIFY THAT THE STRUCTURAL BMP'S HAVE BEEN CONSTRUCTED AND OPERATE IN COMPLIANCE WITH ALL OF THE DESIGN SPECIFICATIONS. PLANS, PERMITS, ORDINANCES AND THE REQUIREMENTS OF THE MS4 PERMIT

THE ENGINEER OF RECORD SHALL PROVIDE THE FIELD OFFICE WITH A SIGNED AND STAMPED THE ENGINEER OF RECORD SHALL FAVOUE THE FIELD OFFICE WITH A SHAPE AND STRUCTURAL BMP'S WERE INSTALLED IN ACCORDANCE WITH THE APPROVED PLANS AND SWQMP. THE CERTIFICATION SHALL INCLUDE PHOTOGRAPHS TAKEN DURING SEVERAL PHASES OF THE TREATMENT FACILITIES DURING CONSTRUCTION (INCLUDING PHOTOGRAPHS OF SUBSURFACE STRUCTURES AND MATERIALS) AND FINAL AS-BUILT CONDITIONS.





CONSTRUCTION ENTRANCE BMP

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REV	10/02/20	JD	50% DESIGN SUBMITTAL	DATE:	1
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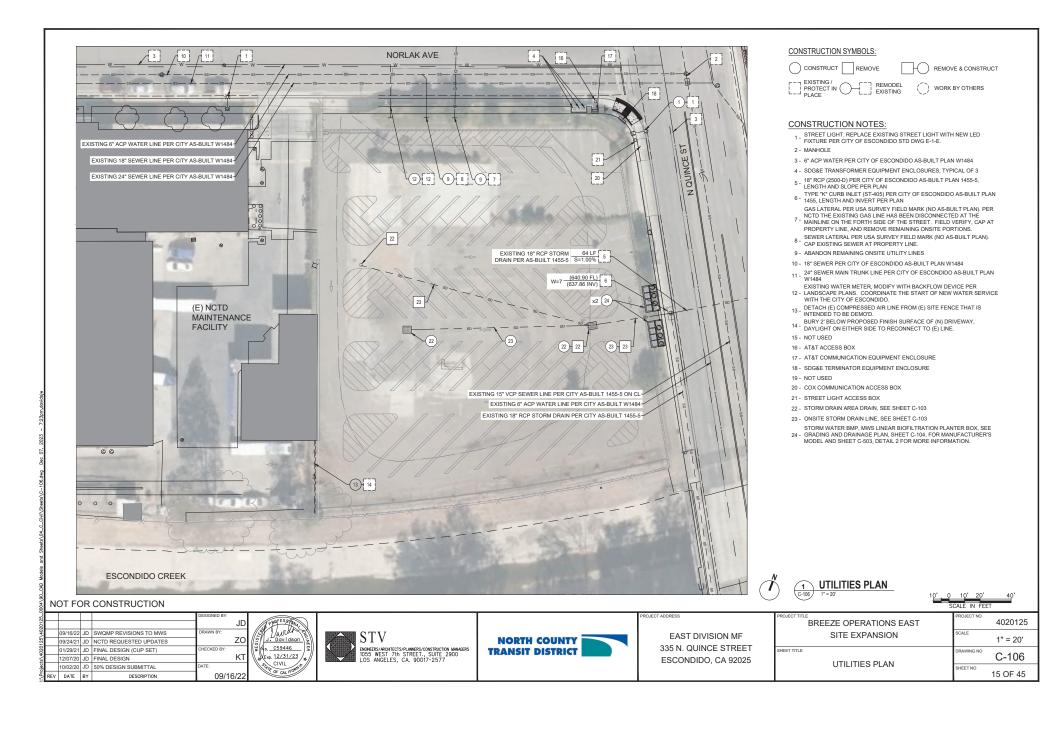
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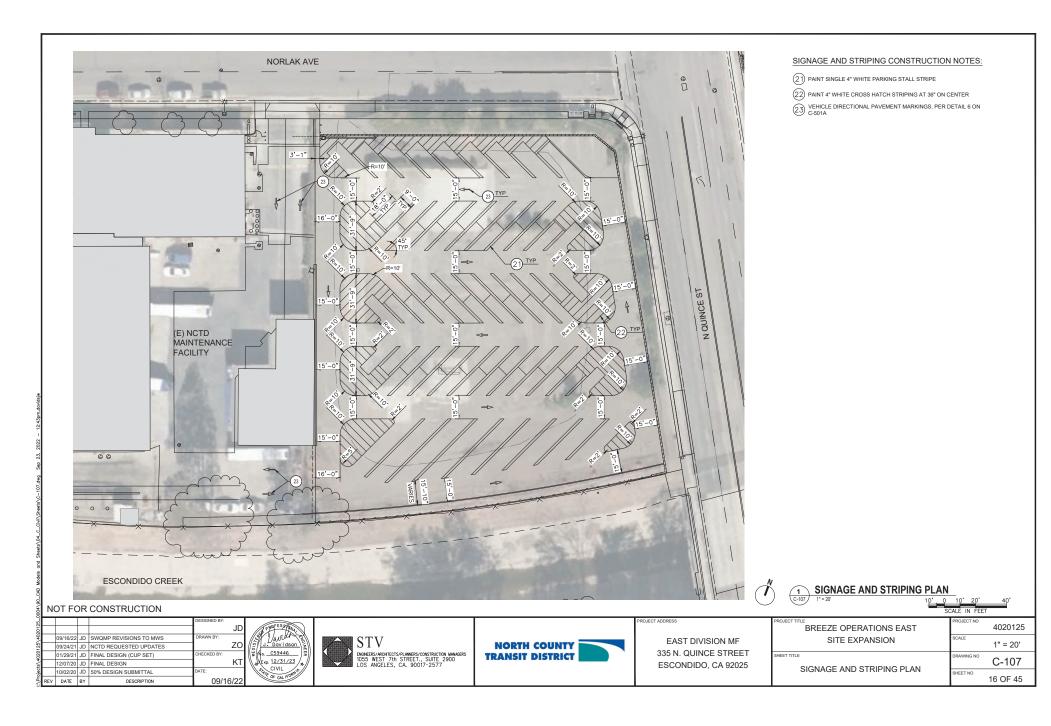
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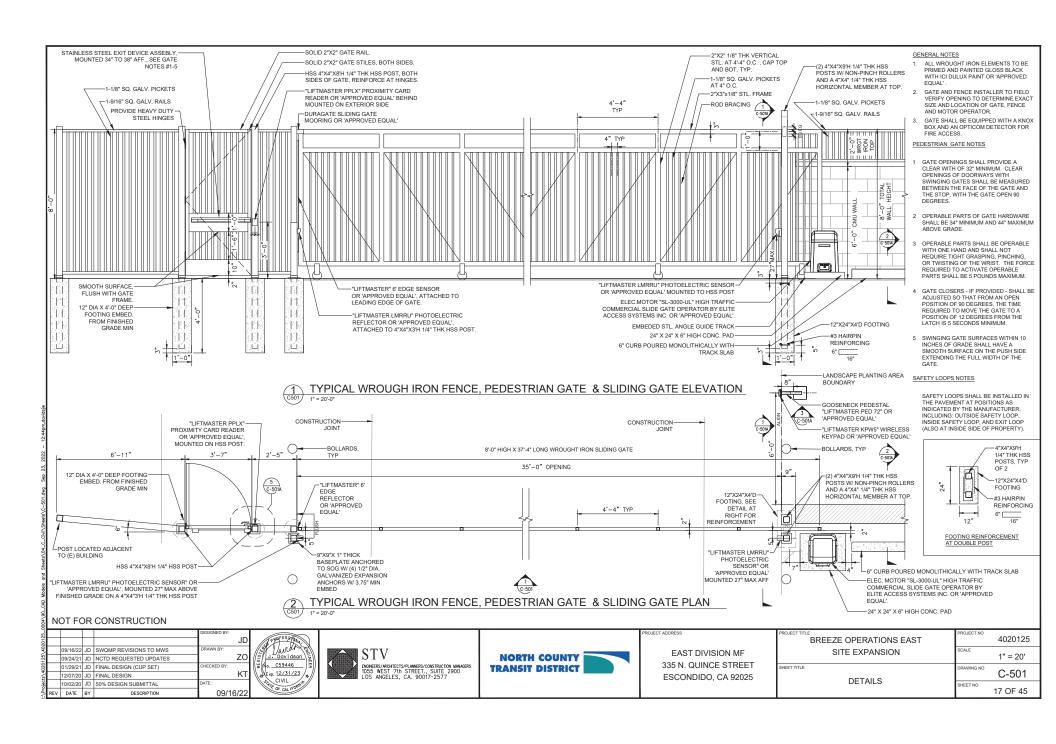
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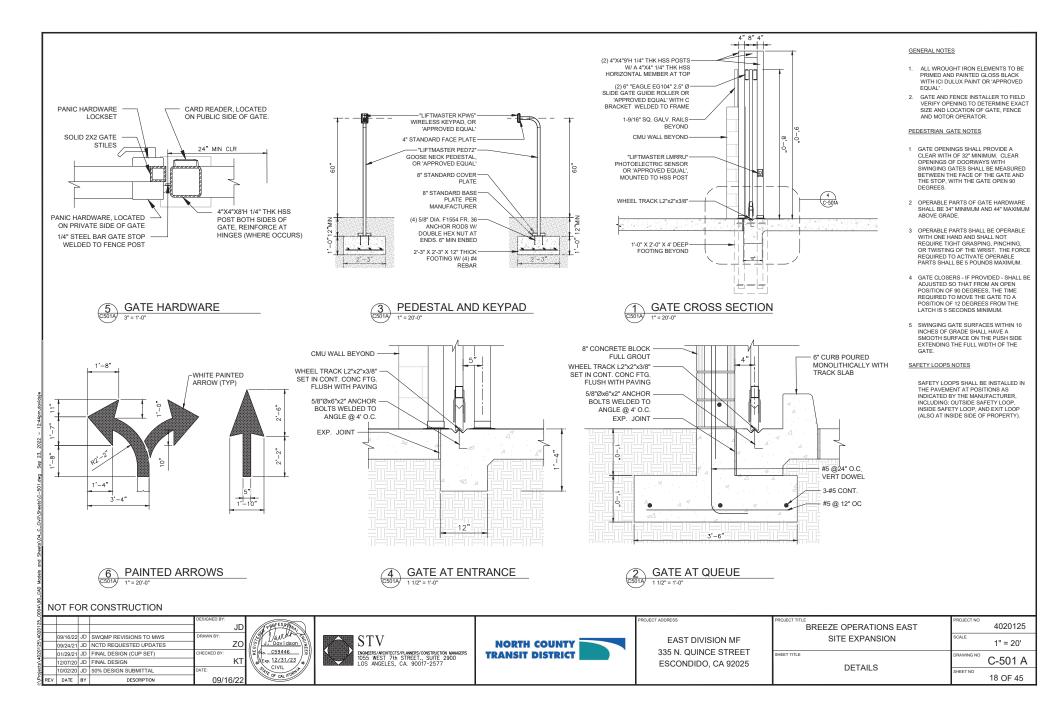
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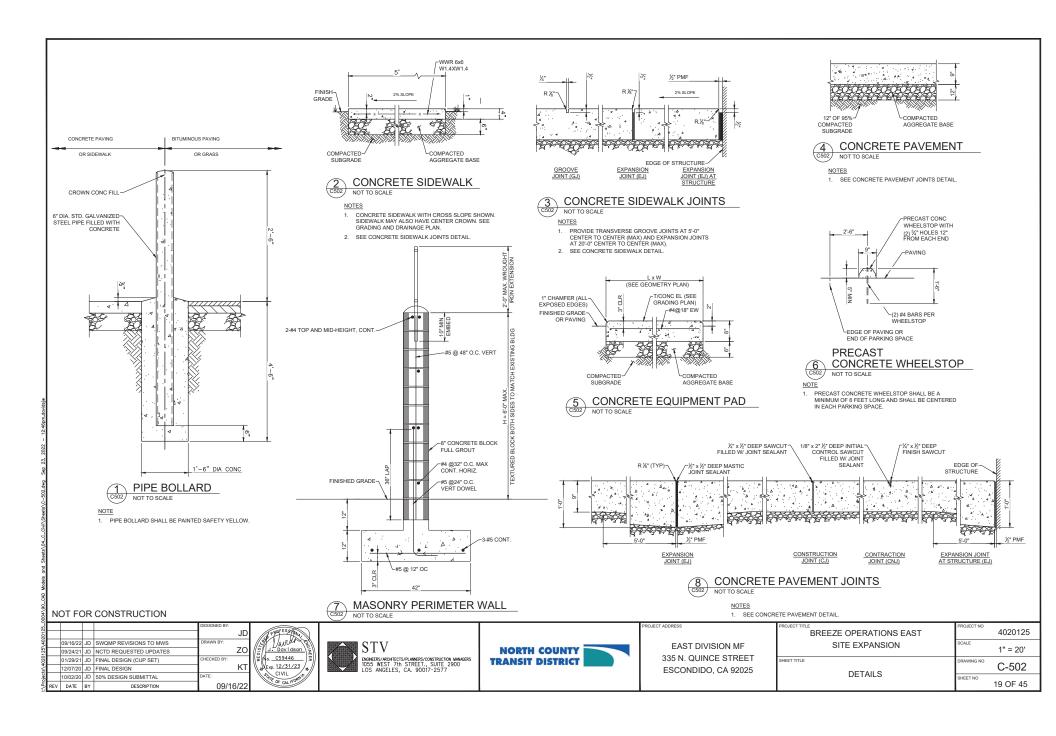
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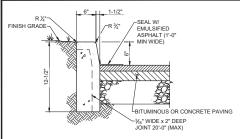

















#### NOTES

1. PROVIDE %" PREMOLDED EXPANSION JOINT FILLER MATERIAL AT ALL INTERSECTIONS AND AT THE END OF EACH PLACEMENT.

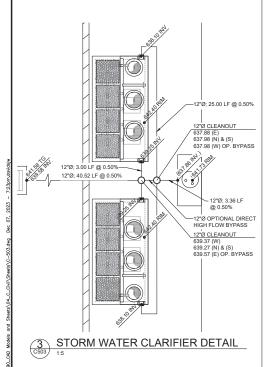

SITE SPECIFIC DATA					
PROJECT NUMBE	ER .	4020125-0004			
PROJECT NAME		NCTD BEB PILO	OT PROGRAM		
PROJECT LOCATI	ON	ESCON	IDIDO		
STRUCTURE ID		BMP#1 AN	D BMP#2		
	TREATMENT	REQUIRED			
VOLUME B	ASED (CF)	FLOW BAS	ED (CFS)		
N/A		0.55 CFS			
PEAK BYPASS R	PEQUIRED (CFS) -	- IF APPLICABLE 1.33			
PIPE DATA	I.E.	MATERIAL	DIAMETER		
INLET PIPE 1	639.25	HDPE	12"Ø		
INLET PIPE 2	N/A	N/A	N/A		
OUTLET PIPE	638.10	HDPE	12"Ø		
	PRETREATMENT	BIOFILTRATION	DISCHARGE		
RIM ELEVATION	642.40 RIM				
SURFACE LOAD	PEDESTRIAN				
FRAME & COVER	2FA ø.30"	OPEN PLANTER	ø24"		

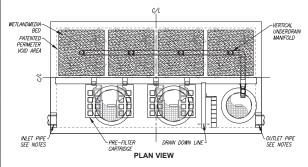

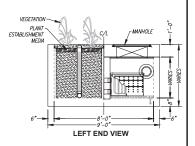



#### INSTALLATION NOTES

- 13. CONTRACTOR TO PROVIDE ALL LABOR, EQUIPMENT, MATERIALS AND INCIDENTALS REQUIRED TO OFFLOAD AND INSTALL THE SYSTEM AND APPURTEMNICS IN ACCORDANCE WITH THIS DRAWING AND THE MANUFACTURERS SPECIFICATIONS, UNLESS OTHERWISE STATED IN MANUFACTURERS CONTRACT.
- MANUFACTURERS CONTRACT.
  UNIT MUST BE INSTALLED ON LEVEL BASE. MANUFACTURER RECOMMENDS A MINIMUM 6" LEVEL ROCK BASE UNLESS SPECIFIED BY THE PROJECT ENORIERE CONTRACTOR SE RESPONSIBLE TO VERHEY PROJECT ENCINEERS RECOMMENDED BASE SPECIFICATIONS. CONTRACTOR TO SUPPLY AND INSTALL ALL EXTERNAL CONNECTING PIPES. ALL PIPES MUST BE FLUSH WITH INSIDE SURFACE OF
- PIPES. ALL PIPES MUST BE FLUSH WITH INSIDE SURFACE OF CONCRETE. (PIPES CANNOT INTUINE BEYOND FLUSH), MORET OF OUTFLOW PIPE MUST BE FLUSH WITH IDSCHARCE CHAMBER FLOOR. ALL PIPES SHALL BE SEALD WHERE FROM FER MANUFACTURERS STANDARD CONNECTION DETAIL. CONTRACTOR RESPONSIBLE FOR INSTALLATION OF ALL RISERS, MANUFACES, AND HATCHES, CONTRACTOR FLO ORDOT ALL MANUFACES, AND HATCHES, CONTRACTOR FLO ORDOT ALL MANUFACES AND HATCHES, CONTRACTOR FLO ORDOT ALL MANUFACES AND HATCHES ON MANUFACE MADERICS. THE MANUFACE MADERICS AND THE MANUFACE MADERICS AND THE MANUFACE MADERICS. THE MANUFACE MADERICS AND THE MANUFACE MADERICS AND THE MANUFACE MADERICS. THE MANUFACE MADERICS AND THE MANUFACE MADERICS AND THE MANUFACE MADERICS. THE MANUFACE MADERICS AND THE MANUFACE MADERICS AND THE MANUFACE MADERICS.
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- INSTALLED BY OTHERS.
  CONTRACTOR RESPONSIBLE FOR CONTACTING BIO CLEAN FOR
  ACTIVATION OF UNIT. MANUFACTURERS WARRANTY IS VOID WITH OUT
  PROPER ACTIVATION BY A BIO CLEAN REPRESENTATIVE.

#### GENERAL NOTES


 MANUFACTURER TO PROVIDE ALL MATERIALS UNLESS OTHERWISE NOTED. MANDIACIONER TO PROVIDE ALL MATERIALS UNLESS DIFERENCE NOTED.
ALL DIMENSIONS, ELEVATIONS, SPECIFICATIONS AND CAPACITIES ARE SUBJECT TO
CHANGE. FOR PROJECT SPECIFIC DRAWNIOS DETAILING EXACT DIMENSIONS, WEIGHTS
AND ACCESSORIES PLEASE CONTACT BIO CLEAN.

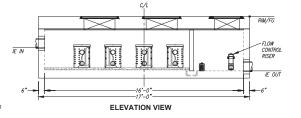

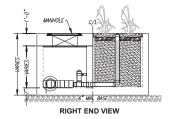

NAVAIC L O 1C VI	
WETLAND MEDIA LOADING RATE (GPM/SF)	
PRETREATMENT LOADING RATE (GPM/SF)	
OPERATING HEAD (FT)	
TREATMENT FLOW (CFS)	

MWS-L-8-16-V STORMWATER BIOFILTRATION SYSTEM STANDARD DETAIL

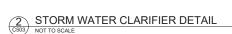

PROPRIFTARY AND CONFIDENTIAL

THE INFORMATION CONTAINED IN THIS DOCUMENT IS THE SOLE PROPERTY OF FORTERNA MID ITS COMPANES. THIS DOCUMENT WAS INSTANCED THAT THE PROPERTY OF FORTERNA MID ITS COMPANIES. THIS DOCUMENT WAS INFORMATION FOR MID INFORMATION OF FORTERNA.

**MATILANDS** 

#### NOT FOR CONSTRUCTION

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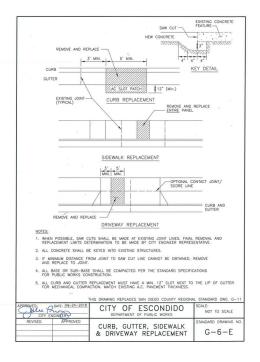








EAST DIVISION MF
335 N. QUINCE STREET
ESCONDIDO, CA 92025

PROJECT TITLE BREEZE OPERATIONS EAST	PROJECT NO	4020125
SITE EXPANSION	SCALE	1" = 20'
DETAILS	DRAWING NO	C-503
DETAILS	SHEET NO	20 OF 45



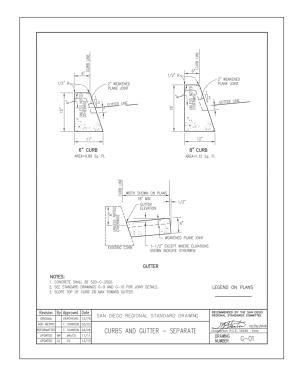

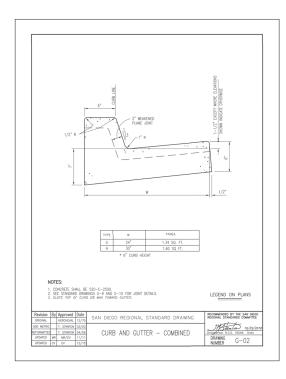

				DESIGNED BY:	
				,	JD
	09/16/22	JD	SWQMP REVISIONS TO MWS	DRAWN BY:	
	09/24/21	JD	NCTD REQUESTED UPDATES		ZO
	01/29/21	JD	FINAL DESIGN (CUP SET)	CHECKED BY:	
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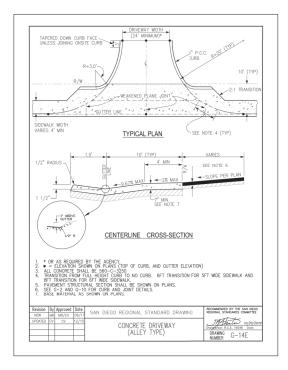








PROJECT ADDRES

BREEZE OPERATIONS EAST	PROJECT NO	4020125
SITE EXPANSION	SCALE	N/A
DETAILS	DRAWING NO	C-504
DE TAILS	SHEET NO	21 OF 45
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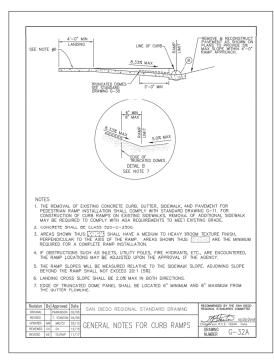


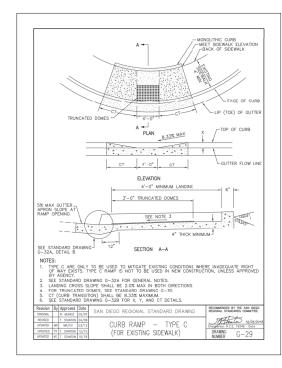



EAST DIVISION MF 335 N. QUINCE STREET

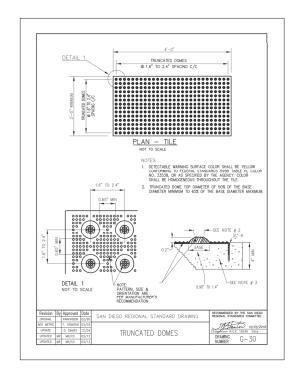ESCONDIDO, CA 92025

PROJECT TITLE BREEZE OPERATIONS EAST	PROJECT NO	4020125
SITE EXPANSION	SCALE	N/A
DETAILS	DRAWING NO	C-505
DETAILS	SHEET NO	22 OF 45



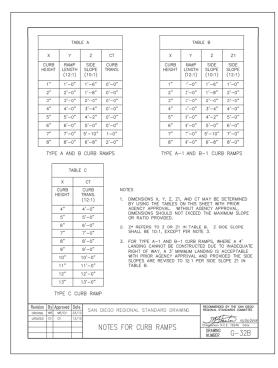

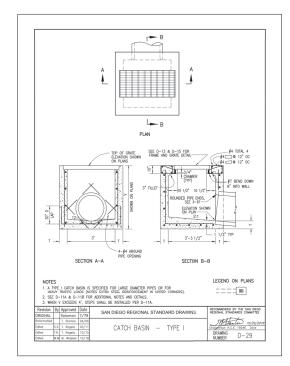

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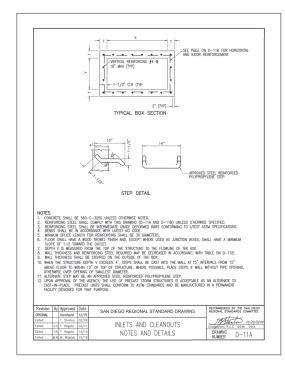








PROJECT ADDR

PROJECT TITLE BREEZE OPERATIONS EAST	PROJECT NO	4020125		
SITE EXPANSION	SCALE	N/A		
SHEET TITLE  DETAILS	DRAWING NO	C-506		
DETAILS	SHEET NO	23 OF 45		



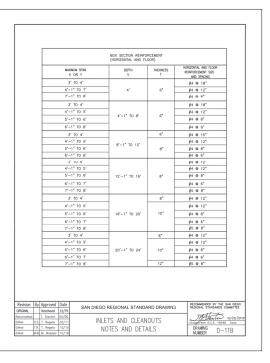

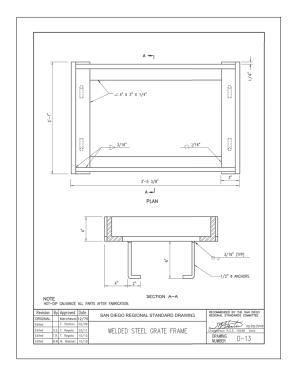

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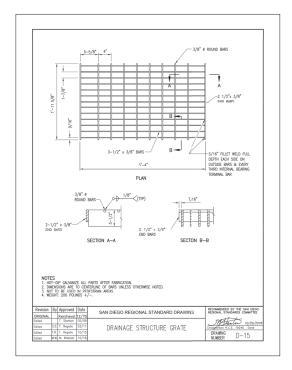







PROJECT ADDRESS

BREEZE OPERATIONS EAST	PROJECT NO	4020125
SITE EXPANSION	SCALE	N/A
DETAILS	DRAWING NO	C-507
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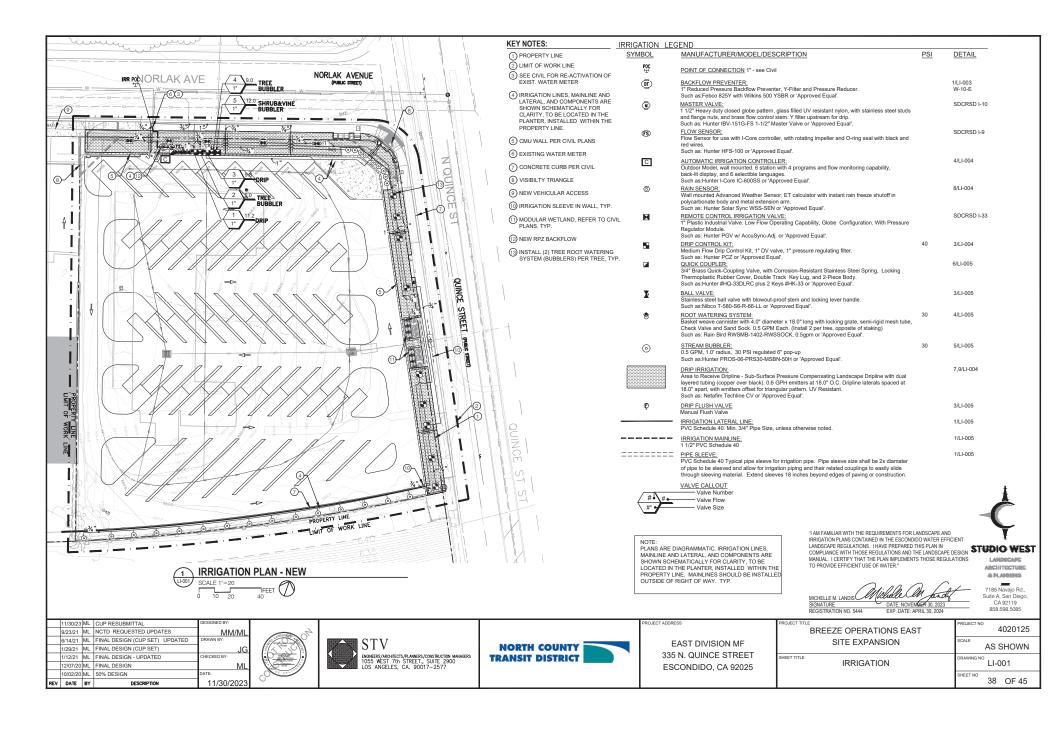




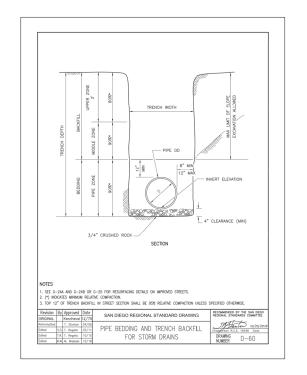

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PROJECT TITLE BREEZE OPERATIONS EAST	PROJECT NO	4020125
SITE EXPANSION	SCALE	N/A
DETAILS	DRAWING NO	C-508
DETAILS	SHEET NO	25 OF 45



#### PRESSURE LOSS CALCULATIONS

PRESSURE LOSS SUMMARY						
Project:	BREEZE OPERATIONS EAST SITE EXPANSION					
Date:						

Valve No.: GPM/Size. 11.2 GPM / 1'

A. RECORD SITE INFORMATION	
Static Pressure at Source (Main)	70.
Pressure Loss/Gain Coefficient	0.43
Net Elevation Change (Source to Meter)	0
Elevation at Source	64
Elevation at Meter	64
Static Pressure before Meter	70.
D. DDECCUDE LOCK CALCULATIONS	

	70.
SIZE	LOSS (PS)
1"	0.
1-1/2"	0.
1"	12
1-1/2"	0.
1"	7.
3/4"-1"	1.
	3.
	-0.
	64
	64
	3.6
	16.
	54.
	1" 1-1/2" 1" 1-1/2"

#### PRESSURE LOSS SUMMARY

June 21, 2023

Valve No.: GPM/Size.: 12.0 GPM / 1

A. RECORD SITE INFORMATION	
Static Pressure at Source (Main)	70
Pressure Loss/Gain Coefficient	0.4
Net Elevation Change (Source to Meter)	C
Elevation at Source	6
Elevation at Meter	6
Static Pressure before Meter	70

ъ,	PRESSURE LUSS CALCULATIONS		
		SIZE	LOSS (PSI)
	Water Meter	1"	0.8
	Mainline	1-1/2"	0.3
	Backflow Assembly	1"	12.0
	Master Valve	1-1/2"	0.0
	Control Valve	1"	5.0
	Laterals	3/4"-1"	10.9
	Fittings (15% of total PSI Loss for components)		4.4
	Net Elevation Change (Elev. Diff. x 0.433)		-0.4
	Elevation at Meter		643
	Elevation at Worst Case Head		644
	15% Pressure Buffer		4.95
	TOTAL PRESSURE LOSS		25.9
	TOTAL AVAILABLE PRESSURE		44.1

#### IRRIGATION SCHEDULE

#### AREA EVAPOTRANSPIRATION DATA

	ESCONDIDO											
	JAN.	FEB.	MAR.	APR.	MAY	JUN.	JUL.	AUG.	SEP.	OCT.	NOV.	DEC.
Normal Year Average ETo Inches Per Month												
Normal Year Average FTo (Inches Per Week)												

DIVIDE THE MINUTES PER WEEK BY THE NUMBER OF IRRIGATION CYCLES TO DETERMINE RUN TIME PER CYCLE IRRIGATION SCHEDULE

	CROP DEN. MICROCL LANDSC. IRRIG. PRECIP. AVERAGE MINUTES PER WEEK OF IRRIGATION																		
ZONE	VALVE DESCRIPTION	COEF. (Ke	FAC. (K <sub>0</sub> )	FAC. (K <sub>MC</sub> )	COEFF.	EFFIC. (IE)	RATE (PR)	JAN.	FEB.	MAR.	APR.	MAY	JUN.		AUG.	SEP.	ост.	NOV.	DEC.
1	Bubbler, Mod. Water Tree and Shrub	0.5	1.0	1.0	0.5	0.85	0.96	18	24	32	40	47	57	58	SS	46	32	21	16
2	Bubbler, Low Water Tree and Shrub	0.3	1.0	1.0	0.3	0.85	0.96	11	14	19	2.4	28	34	35	33	28	19	13	10
3	Drip, Low WaterShurb and Groundcover	0.3	1.0	1.0	0.3	0.81	0.28	38	52	70	87	102	123	125	119	99	70	46	35
4	Bubbler, Mod. Water Vine	0.5	1.0	1.0	0.5	0.85	0.96	18	24	32	40	47	57	58	55	46	32	21	16
								-	-	-	-	-	-	-	-	-	-	-	-
TOTAL MINUTES PER WEEK						PER WEEK	18	24	32	40	47	57	58	55	46	32	21	16	
TOTAL HOURS FER WEF								0.3	0.4	0.5	0.7	0.8	1.0	1.0	0.9	0.8	0.5	0.4	0.3

Note: Irrigation schedules are based upon historical climate data and are intended only as a general guide. Irrigation schedules shall be regularly adjusted to account for changes in climate conditions, maturity of plant materials and other site specific condition

dscape Coefficient (K<sub>1</sub>) = Species Factor (K<sub>4</sub>) x Desnsity Factor (K<sub>n</sub>) x Microclimate Factor (K<sub>Mr</sub>)

Minutes of Irrigation Per Week: (ETo x K<sub>L</sub>) x 60

#### IRRIGATION NOTES

- IRRIGATION PLAN IS DIAGRAMMATIC. IRRIGATION DESIGN ASSUMES NO DEVIATION IN GRADING, PAVING AND/OR PLANTING PLAN LAYOUT FROM ACTUAL FIELD CONDITIONS. ALL NEW IRRIGATION FOUIPMENT SHALL BE LOCATED IN PLANTING AREAS ONLY UNLESS NOTED OTHERWISE ALL NEW EQUIPMENT SHALL BE INSTALLED AS SHOWN IN THE DETAILS AND AS NOTED IN THESE SPECIFICATIONS. CONTRACTOR SHALL BE RESPONSIBLE FOR REVIEWING PLANTING AND IRRIGATION PLAN LAYOUT AGAINST ACTUAL GRADED FIELD CONDITIONS PRIOR TO COMMENCEMENT OF WORK ANY DEVIATIONS IN ACTUAL FIELD CONDITIONS FROM THOSE SHOWN ON IRRIGATION PLAN SHALL BE BROUGHT TO THE ATTENTION OF THE LANDSCAPE ARCHITECT PRIOR TO COMMENCEMENT OF WORK CONTRACTOR SHALL BE RESPONSIBLE FOR THE COST OF REPLACING AND/OR MODIFYING ANY IRRIGATION FOLIPMENT INSTALLED WHERE FIFLD CONDITIONS DIFFER FROM THOSE SHOWN ON PLANTING AND/OR IRRIGATION PLANS WHEN SAID INSTALLATION HAS NOT BEEN APPROVED IN ADVANCE BY OWNER OR LANDSCAPE ARCHITECT.
- CONTRACTOR SHALL KEEP THE PREMISES CLEAN AND FREE OF EXCESS FOLIPMENT, MATERIALS AND RUBBISH INCIDENTAL TO WORK COVERED UNDER THIS SECTION.

  PVC SPECIFICATIONS: REFER TO PROJECT SPECIFICATIONS FOR MORE INFORMATION.
- CONTRACTOR SHALL VERIFY LOCATION OF POINT OF CONNECTION IN FIELD.
  SYSTEM WAS DESIGNED TO OPERATE AT PRESSURE AVAILABLE OF 70 PSI. SHOULD ACTUAL PRESSURE BE LOWER UPON CONNECTION TO WATER SUPPLY. CONTACT LANDSCAPE ARCHITECT IF PRESSURE AT METER IS LOWER THAN 70 PSI OR ABOVE 85 PSI
- CONTRACTOR SHALL ADJUST ALL FLOW AT VALVES TO PROVIDE CORRECT OPERATING VOLUME AND
- PRESSURE TO HEADS ON EACH CIRCUIT.
  CONTRACTOR SHALL INSTALL NEW AUTOMATIC CONTROLLER, (SIZE AND TYPE AS NOTED AND INSTALLED AS INDICATED ON IRRIGATION PLAN OR WHERE DIRECTED BY OWNER). CONTROLLER SHALL BE INSTALLED PER MANUFACTURER'S INSTRUCTIONS. CONTROL WIRES SHALL BE SLEEVED IN ELECTRICAL CONDUIT USING SWEEP FLLS. FROM CONTROLLER INTERIOR TO EIGHTEEN INCHES (18") BELOW GRADE. OWNER SHALL PROVIDE 110-VOLT SERVICE TO CONTROLLER. PROVIDE SIGNAL WIRES FOR FLOW SENSOR AND MASTER VALVES AS SPECIFIED BY MANUFACTURER. WIRE SPECIFICATIONS:
- - WINE SPECIFICATIONS.

    CONTRACTOR SHALL INSTALL NEW WIRE FROM CONTROLLER TO NEW VALVES.

    A. ALL NEW WIRE SHALL BE 14-GAUGE ANG-UF, DIRECT BURIAL TYPE. A RED COLOR SHALL BE PROVIDED FOR EACH VALVE STATION INCLUDING EXTRA WIRE. COMMON WIRE SHALL BE WHITE. WIRE RUNS ARE TO BE CONTINUOUS FROM CONTROLLER TO VALVE WITH SPLICES AT VALVES ONLY. SPLICES AND CONNECTIONS SHALL BE MADE WITH PEN-TITE CONNECTORS OR EQUIVALENT AND SHALL BE PLACED IN VALVE BOX.
  - ALL WIRES SHALL BE INSTALLED WITH TWELVE INCHES (12") OF EXCESS WIRE (COILED) AT
  - THE END OF EACH WIRE RUN AND AT NINETY DEGREE CHANGES IN DIRECTION.
    C. CONTROL WIRE SHALL BE LAID EIGHTEEN INCHES (18") DEEP. CONTROL WIRE SHALL BE BUNDLED AND PLACED BENEATH MAINLINE WHERE POSSIBLE, TAPED TO MAINLINE AT TEN FEET (10')
  - ONE (1) ADDITIONAL CONTROL WIRE SHALL BE RUN TO EACH VALVE MANIFOLD. WIRE SHALL
  - BE BUNDLED, TAPED, AND PLACED IN CONTROL VALVE BOX.

    E. CONTRACTOR IS TO PROVIDE AN ADDITIONAL COMMON WIRE TO THE END OF THE MAINLINE. RUN IN TWO DIRECTIONS FROM THE CONTROLLER. WIRE SHALL BE BUNDLED, TAPED, AND PLACED IN
  - ALL AUTOMATIC CONTROL VALVES SHALL BE OF SIZE AND TYPE NOTED IN LEGEND. VALVE MANIFOLD SHALL BE CONNECTED OFF OF A SINGLE TEE ON THE MAINLINE EXCEPT AT THE END OF THE MAINLINE RIVN. VALVES SHALL BE SET A MINIMUM OF EIGHT INCHES (8") APART TO ALLOW SERVICING. VALVE SHALL BE TAGGED WITH CONTROLLER LETTER AND VALVE NUMBER PERMANENTLY MARKED
- 10. ONE (1) VALVE SHALL BE INSTALLED IN EACH BOX. VALVE BOXES SHALL BE LOCATED WITHIN SHRUB PLANTER BEDS (WHEREVER POSSIBLE) AND SHALL BE SET FLUSH WITH THE MOW CURB, OR A MINIMUM OF TWELVE INCHES (12") AWAY FROM ANY OTHER HARDSCAPE OR STRUCTURE. VALVE BOX SHALL BE LARGE ENOUGH TO ACCOMMODATE SERVICING VALVES INCLUDING DRIP FILTERS

#### IRRIGATION OPERATION

- THIS SECTION IS PROVIDED AS A REQUIREMENT FOR MAINTENANCE DURING THE 120 DAY
- ESTABLISHMENT PERIOD AND AS A RECOMMENDATION FOR FUTURE CONTINUED MAINTENANCE.

  IRRIGATION IS TO BE MAINTAINED AND OPERATED IN SUCH A MANNER AS TO PREVENT WATER FROM COLLECTING ON OR RUNNING ACROSS CONCRETE OR ASPHALT OR FROM OVERSPRAYING ONTO BUILDINGS, FENCES, WALLS OR OTHER HARDSCAPE FEATURES.
- MAINTENANCE CONTRACTOR SHALL BE REQUIRED TO HAVE AVAILABLE AND LISE A SOIL TURE OR PROBE TO FREQUENTLY CHECK SOIL MOISTURE BEFORE AND AFTER OPERATION OF THE IRRIGATION SYSTEM TO EVALUATE THE NECESSITY FOR IRRIGATION SCHEDULING ADJUSTMENTS CONTRACTOR SHALL ADJUST SYSTEM TIMING AND COVERAGE PATTERNS ON AN ONCOING BASIS TO COMPENSATE FOR REDUCED WATER REQUIREMENTS AS PLANTS MATURE AND PATTERN DEFLECTION AS PLANTS GROW
- MAINTENANCE CONTRACTOR SHALL BE REQUIRED TO FREQUENTLY TEST THE IRRIGATION SYSTEM TO ENSURE THAT ALL HEADS OPERATE CORRECTLY AND THAT NO BREAKS OR LEAKS EXIST. THE MAINTENANCE CONTRACTOR SHALL NOT PERMIT THE IRRIGATION SYSTEM TO OPERATE WITH BROKEN EQUIPMENT. REPAIRS TO THE SYSTEM SHALL BE MADE WITH ORIGINALLY SPECIFIED MATERIALS IN ACCORDANCE WITH THE LANDSCAPE ARCHITECT'S PLANS TO ENSURE PROPER COVERAGE AND PRESSURE WITHIN THE IRRIGATION SYSTEM. FAILURE TO MATCH ORIGINALLY SPECIFIED MATERIALS MAY RESULT IN AN INOPERABLE SYSTEM WITH SIGNIFICANT WATER WASTE

- 11. ALL PRESSURE MAINLINES SHALL BE A MINIMUM OF EIGHTEEN INCHES (18") DEEP AND MARKED WITH INDICATOR TAPE ABOVE PIPE. ALL PVC LATERALS SHALL BE A MINIMUM OF TWELVE INCHES (12") DEEP TRENCH BACKEILL SHALL BE FREE OF ANY MATERIAL THAT MAY DAMAGE IRRIGATION PIPE OR EQUIPMENT INCLUDING ROCKS IN EXCESS OF ONE INCH (1") IN DIAMETER. IN THE EVENT OF BACKFILL SETTLEMENT, CONTRACTOR SHALL PERFORM REQUIRED REPAIRS AT HIS OWN COST. REFER TO DETAILS AND SPECIFICATIONS FOR MORE INFORMATION
- ALL MAINLINE, WIRING AND LATERAL LINES SHALL BE SLEEVED WITH PVC SCHEDULE 40 TWO (2X) TIMES THE DIAMETER OF THE SLEEVED LINE WHERE IT PASSES UNDER PAVED AREAS OR THROUGH WALLS, (SEE SLEEVING DETAIL), IRRIGATION CONTRACTOR SHALL COORDINATE WITH CONCRETE AND A.C. PAVING CONTRACTOR TO ENSURE ALL SLEEVING IS SET PRIOR TO CONCRETE POURS AND ASPHALT PLACEMENT. CONTRACTOR IS TO LOCATE AND UTILIZE EXISTING SLEEVES UNDER DRIVEWAY AND WALKS, IF AVAILABLE. UNDER NO CIRCUMSTANCES SHALL NEW IRRIGATION LINES BE INSTALLED LINDER ASPHALT OR CONCRETE WITHOUT SLEEVING
- MAINLING SHALL BE SLEEVED EXTENDING 10 FEET TO EITHER SIDE OF HARDSCAPE.
  PRIOR TO BACKFILLING TRENCHES, THE FOLLOWING PROCEDURES SHALL BE IMPLEMENTED:
- A. ALL MAINLINES IN THE SYSTEM SHALL BE CAPPED AND PRESSURE TESTED AT 125 PSI FOR A PERIOD OF FOUR (4) HOURS. ANY LEAKS FOUND SHALL BE CORRECTED BY REMOVING THE LEAKING PIPE OR FITTINGS AND INSTALLING NEW MATERIAL IN ITS PLACE
- CONTRACTOR SHALL NOT ALLOW NOR CAUSE ANY OF HIS WORK TO BE COVERED UNTIL IT HAS BEEN INSPECTED. TESTED AND APPROVED BY THE OWNER'S AUTHORIZED REPRESENTATIVE.
- WHEN INSTALLATION OF THE IRRIGATION SYSTEM IS COMPLETED AND PRIOR TO PLANTING, THE CONTRACTOR, IN THE PRESENCE OF THE BUILDER/OWNER'S AUTHORIZED REPRESENTATIVE, SHALL PERFORM A COVERAGE TEST OF WATER AFFORDED ALL PLANTING AREAS TO ENSURE IT IS COMPLETE AND ADEQUATE. CONTRACTOR SHALL FURNISH ALL MATERIALS AND PERFORM ALL WORK REQUIRED TO CORRECT ANY INADEQUACIES OF COVERAGE AT HIS OWN COST.
- CONTRACTOR SHALL FURNISH TO OWNER A COMPLETE "AS BUILT" DRAWING OF NEW AND EXISTING EQUIPMENT INSTALLED SHOWING EXACT SIZE, TYPE, AND DIMENSIONED LOCATIONS OF THE FOLLOWING ITEMS:
- A. POINT OF CONNECTION
- B. BALL VALVES C. QUICK COUPLERS
- D. CONTROL VALVES
- E CONTROLLERS F. MAINLINE
- G. CONTROLLER WIRE H. SLEEVING
- THE "AS BUILT" DRAWING SHALL BE PREPARED ON BOND AND CONTRACTOR SHALL PROVIDE TWO PRINTS ALONG WITH ORIGINAL
- CONTRACTOR SHALL ALSO PROVIDE A REDUCED "AS BUILT" DRAWING (MAXIMUM 11X17 SIZE), COLOR-CODED. SHOWING AREAS IRRIGATED BY EACH STATION. THIS PLAN SHALL BE ENCASED IN PLASTIC UPON OWNERS APPROVAL OF DRAWING. CONTRACTOR SHALL ALSO PROVIDE IRRIGATION PROGRAMMING CHART. THESE ARE TO BE DELIVERED ON OR BEFORE FINAL INSPECTION.
- 19. IRRIGATION CONTRACTOR SHALL MAINTAIN THE SYSTEM FOR ONE HUNDRED AND TWENTY (120) DAYS UPON OWNER ACCEPTANCE OF CONSTRUCTION COMPLETION AND SHALL WATER AS
- REQUIRED TO ESTABLISH NEW PLANT MATERIAL. CONTRACTOR SHALL PROVIDE CONTROLLER KEYS AND MANUALS, ONE (1) QUICK COUPLER KEY WITH HOSE SWIVEL, AND AN ADDITIONAL QUANTITY OF SIX OF EACH NOZZLE TYPE USED TO OWNER AT TURNOVER
- 21. IRRIGATION CONTRACTOR SHALL GUARANTEE IN WRITING THE ENTIRE NEWLY INSTALLED IRRIGATION SYSTEM TO BE FREE OF DEFECTS IN WORKMANSHIP AND MATERIALS FOR A PERIOD OF
- ONE (1) YEAR FROM FINAL ACCEPTANCE BY OWNER.
  CONTRACTOR SHALL NOTIFY UNDERGROUND SERVICE ALERT BY CONTACTING 'DIG ALERT' AT 811, 22 BEFORE START OF CONSTRUCTION (14 CALENDAR DAYS PRIOR TO DIGGING)



"I AM FAMILIAR WITH THE REQUIREMENTS FOR LANDSCAPE AND IRRIGATION PLANS CONTAINED IN THE ESCONDIDO WATER EFFICIENT LANDSCAPE REGULATIONS. LHAVE PREPARED THIS PLAN IN COMPLIANCE WITH THOSE REGULATIONS AND THE LANDSCAPE DESIGN STUDIO WEST MANUAL. I CERTIFY THAT THE PLAN IMPLEMENTS THOSE REGULATIONS TO PROVIDE EFFICIENT USE OF WATER.

LAMBROARE **ARCHITECTURE** -IN PLANNING

7185 Navaio Rd CA 92119 858.598.5085

39 OF 45

MICHELLE M. LANDIS REGISTRATION NO. 5444 **BREEZE OPERATIONS EAST** 

П	 11/30/23	IVIL	CUP RESUBINITIAL		
	9/23/21	ML	NCTD REQUESTED UPDATES	MM/N	ΛL
	6/14/21	ML	FINAL DESIGN (CUP SET) UPDATED	DRAWN BY:	
	1/29/21	ML	FINAL DESIGN (CUP SET)	J	JG
	1/12/21	ML	FINAL DESIGN - UPDATED	CHECKED BY:	
	12/07/20	ML	FINAL DESIGN	I.	ΛL
	40/00/00		FOOY DECICAL	DATE	

REV DATE BY



11/30/202






EAST DIVISION MF 335 N. QUINCE STREET ESCONDIDO, CA 92025

SHEET TITLE **IRRIGATION** CALCULATIONS, NOTES

SITE EXPANSION

4020125 AS SHOWN 11-002

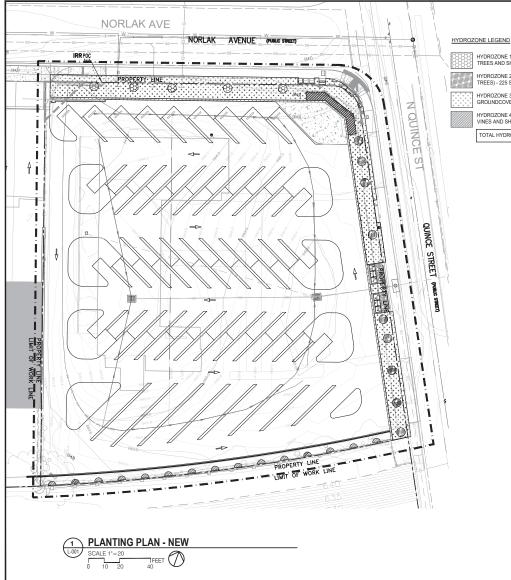

HYDROZONE 1 (BUBBLER-MODERATE WATER

HYDROZONE 2 (BUBBLER-LOW WATER

HYDROZONE 3 (DRIP- LOW WATER SHRUB AND GROUNDCOVER) - 4568 SF

HYDROZONE 4 (BUBBLER- MODERATE WATER VINES AND SHRUBS) - 357 SF

TOTAL HYDROZONES - 5275 SF

ETWU = Estimated Total Water Usage (gallons per year)

MAWA CALCULATIONS

ETWU = ((ETo)(.62)) ((PF X HA / IE) + SLA) ETo = reference evapotranspiration (inches)

.62 = conversion facto to gallons PF = plant factor from wucols HA = hydrozone area (s.f.) IE = irrigation efficiency

HYDROZONE #1 PF .85

HYDROZONE #2 SLA

[( 57 )(0.62)] [( .3 X4568 ) + ( 0 )] = 59,790 Gal./Yr. DRIP HYDROZONE #3 PF HA SLA

[(\_57\_)(0.62)] [(\_.5\_\_x357\_\_\_) + (\_0\_\_)] = 7,421\_\_ Gal./Yr. BUBBLERS PF .85 HA

Water Budget Calculations (gallons per year)

Water Budget = (ETO)(0.62) [(0.7)(LA) + (0.3)(SLA)] Where: ETo = Evaptranspiration (inches per year)(see Table 6 or ETo Map)

0.62 = Conversion factor (to gallons)

0.45 = Evapotranspiration Adjustment Factor (ETAF)

LA = Landscape Area (square feet)

0.3 = Additional Evapotranspiration Adjustment Factor for Special Landscape Area SLA = Special Landscape Area (square feet) In the calculation below provide the values for the water budget calculation used for the proposed project. The ETo for the calculation may be based on the precise location of the project using the ETo Map or based on the ETo for the Community Planning Area in Table 6 of the Landscape Standards each of which follows.

 $(\begin{tabular}{c|c} \bf 57 & (0.62) & [(0.45)(\begin{tabular}{c|c} \bf 5275 \end{tabular}) + (0.55)(\begin{tabular}{c|c} \bf 0 \end{tabular})] = \begin{tabular}{c|c} \bf 102,530 \end{tabular} Gal./Yr.$ ETo LA

IRRIGATION METHO	D AND EFFICIENCY	
BUBBLERS .85 DRIP .81		
PLANT WATER USE LOW MODERATE HIGH SPECIAL LANDSCAPE AREA	PLANT FACTOR <0.1-0.3 0.4-0.7 0.8 AND GREATER 1.0	ALSO INCLUDES ARTIFICIAL TURF WATER FEATURES

Water Budget Calculations										
Controller #	Hydrozone #	Valve Circuit	Irrigation Method	Plant Factor PF	Hydrozone Area HA	% of Total Landscape Area	PF X HA	IE	PF X HA / IE	
A	1 - trees/shrub mod water	2	bubblers	.5	125	2%	63	.85	74	
A	2 - trees low water	4	bubblers	.3	225	4%	68	.85	80	
A	3 - gc/shrub low to mod water	1,3	drip	.3	4568	87%	1370	.81	1691	
A	4 - vine mod water	5	bubblers	.5	357	7%	179	.85	211	

MAWA = Maximum Applied Water Allowance (gallons per year)

MAWA = 102,530 gal/yr

ETWU = Estimated Total Water Usage (gallons per year)

ETWU = 72,659 gal/yr

Estimated water use is 72,659 gallons per year less than the Maximum Applied Water Allowance

"I AM FAMILIAR WITH THE REQUIREMENTS FOR LANDSCAPE AND IRRIGATION PLANS CONTAINED IN THE ESCONDIDO WATER EFFICIENT

LANDSCAPE REGULATIONS. I HAVE PREPARED THIS PLAN IN COMPLIANCE WITH THOSE REGULATIONS AND THE LANDSCAPE DESIGN **STUDIO WEST** MANUAL. I CERTIFY THAT THE PLAN IMPLEMENTS THOSE REGULATIONS TO PROVIDE EFFICIENT USE OF WATER."

-IN-PILANDINIG 7185 Navajo Rd., Suite A, San Diego, CA 92119 858.598.5085

SIGNATURE REGISTRATION NO. 5444

REV	DATE	BY	DESCRIPTION	11/30/2023
	10/02/20	ML	50% DESIGN	DATE:
	12/07/20	ML	FINAL DESIGN	ML
	1/12/21	ML	FINAL DESIGN - UPDATED	CHECKED BY:
	1/29/21	ML	FINAL DESIGN (CUP SET)	JG
	6/14/21	ML	FINAL DESIGN (CUP SET) UPDATED	DRAWN BY:
	9/23/21	ML	NCTD REQUESTED UPDATES	MM/ML
	11/30/23	ML	CUP RESUBMITTAL	DESIGNED BY:







EAST DIVISION MF 335 N. QUINCE STREET ESCONDIDO, CA 92025 BREEZE OPERATIONS EAST SITE EXPANSION


SHEET TITLE HYDROZONE PLAN AND CALCULATIONS


4020125 AS SHOWN LI-003


40 OF 45

LANDSCARE

**ARCHITECTURE** 

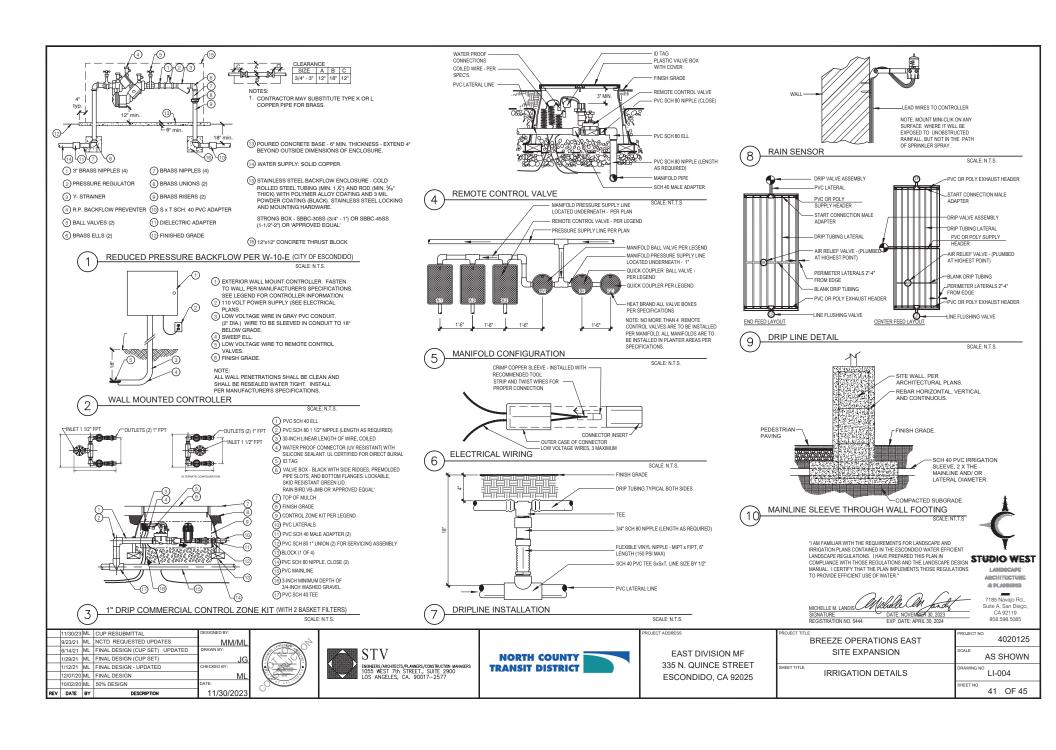

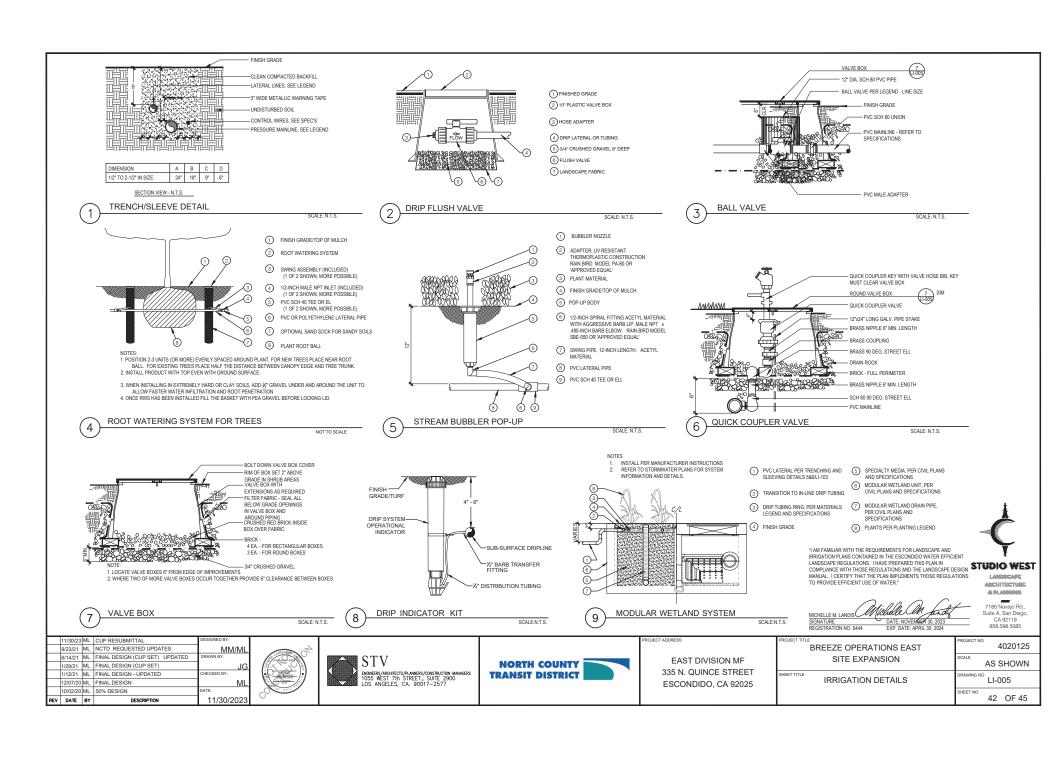

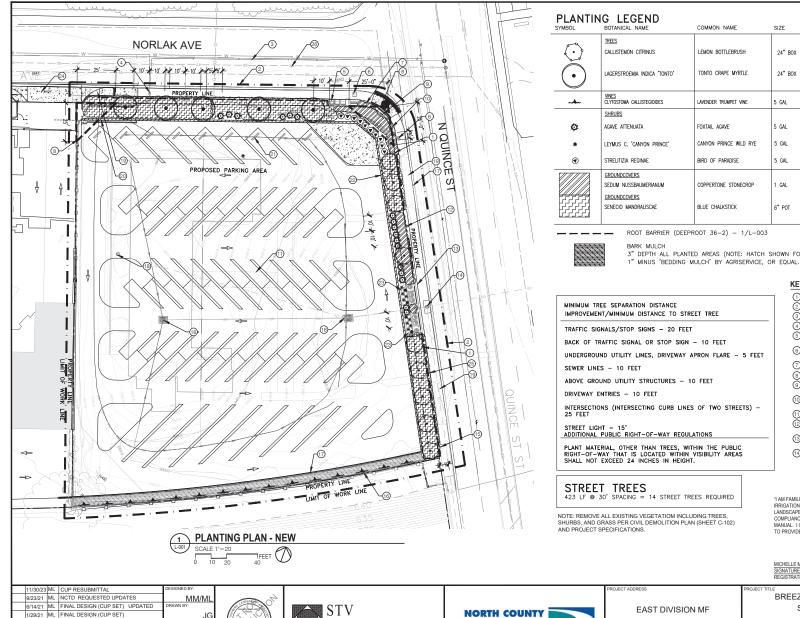

1/12/21 ML FINAL DESIGN - UPDATED

11/30/202

12/07/20 ML FINAL DESIGN

10/02/20 ML 50% DESIGN

REV DATE BY

PLANTIN SYMBOL	G LEGEND BOTANICAL NAME	COMMON NAME	SIZE	REMARKS	QUANTITY	HEIGHT & SPREAD	WUCOLS	NATIVE	DETAIL
	TREES CALLISTEMON CITRINUS LAGERSTROEMIA INDICA "TONTO"	LEMON BOTTLEBRUSH TONTO CRAPE MYRTLE	24" BOX 24" BOX	STD, 2" MIN CALIPER, 6' MIN HEIGHT STD, 2" MIN CALIPER, 6' MIN HEIGHT	5	15' X 15' 20' X 20'	L	N N	L-1-E /L-002 L-1-E /L-002
n.Am	VINES CLYTOSTOMA CALLISTEGIOIDES	LAVENDER TRUMPET VINE	5 GAL		15	15' X 15'	M	N	3, L-002
<b>©</b> * •	SHRUBS AGAVE ATTENUATA LEYMUS C. 'CANYON PRINCE' STRELITIZIA REGINAE	FOXTAIL AGAVE  CANYON PRINCE WILD RYE  BIRD OF PARADISE	5 GAL 5 GAL 5 GAL	MODULAR WETLAND, SEE CIVIL PLANS & SPECIFICATIONS	17 12 10	4' X 5' 4' X 3' 5' X 4'	L L	N N N	4/L-002 4/L-002 4/L-002
	GROUNDCOVERS SEDUM NUSSBAUMERIANUM GROUNDCOVERS SENECIO MANDRALISCAE	COPPERTONE STONECROP BLUE CHALKSTICK	1 GAL 6* POT	12* 0.C.	698 SF 3463 SF	18" X 12" 12" X 18"	L	N N	5/L-002 5/L-002

3" DEPTH ALL PLANTED AREAS (NOTE: HATCH SHOWN FOR CLARITY AT VINE PLANTER)

### KEY NOTES:

1) PROPERTY LINE 2 LIMIT OF WORK LINE 3 EXISTING WATER LINE

(4) EXISTING WATER METER

5 EXISTING TRANSFORMERS TO REMAIN 6 EXISTING COMM RISER TO REMAIN

(7) EXISTING SIGN TO REMAIN

8 VISIBILITY TRIANGLE (9) EXISTING TRANSFORMERS TO REMAIN

(1) EXISTING STREET LIGHT TO REMAIN

11) STRIPING PER CIVIL 2 EXISTING FIRE HYDRANT TO REMAIN

(13) EXISTING BUS STOP SIGN TO REMAIN

(4) EXISTING STORM DRAIN INLET

"I AM FAMILIAR WITH THE REQUIREMENTS FOR LANDSCAPE AND IRRIGATION PLANS CONTAINED IN THE ESCONDIDO WATER EFFICIENT LANDSCAPE REGULATIONS. I HAVE PREPARED THIS PLAN IN COMPLIANCE WITH THOSE REGULATIONS AND THE LANDSCAPE DESIGN **STUDIO WEST** MANUAL. I CERTIFY THAT THE PLAN IMPLEMENTS THOSE REGULATIONS

LAMBROARE ARCHITECTURE

(15) EXISTING SIGN TO REMAIN

(17) CONCRETE CURB PER CIVIL

(19) NEW SIDEWALK PER CIVIL

② CMU WALL PER CIVIL

(25) ROOT BARRIER, TYP.

② EXISTING SEWER LINE

(18) STORM WATER DRAIN PER CIVIL,

ROLLING GATE AND TRACK PER CIVIL PLANS

(21) WHEEL STOPS PER CIVIL - TYP

(3) MODULAR WETLANDS, PER CIVIL PLANS.

24) NEW VEHICULAR ACCESS

(16) FENCE PER CIVIL

-B-PLANNING

CA 92119 858.598.5085

BREEZE OPERATIONS EAST SITE EXPANSION

SHEET TITLE

TO PROVIDE EFFICIENT USE OF WATER."

4020125 AS SHOWN L-001


335 N. QUINCE STREET ESCONDIDO, CA 92025

TRANSIT DISTRICT

**PLANTING** 

PLAN

43 OF 45

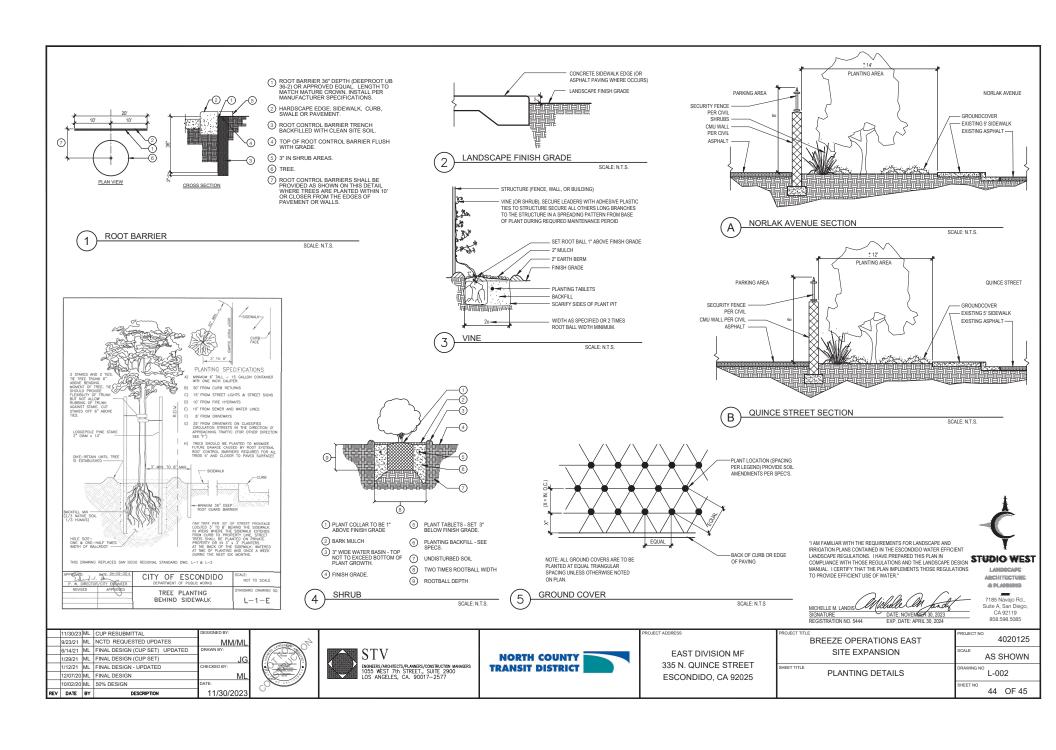



LAVENDER TRUMPET VINE



NORLAK STREET -CREPE MYRTLE



QUINCE STREET -LEMON BOTTLEBRUSH







BIRD OF PARADISE



SOFT TIPPED FOXTAIL AGAVE



BLUE CHALK STICK



SEDUM 'COPPERTONE'



PARKWAY SHRUBS & SUCCULENTS

3 L-003 PARKWAY GROUNDCOVERS

"I AM FAMILIAR WITH THE REQUIREMENTS FOR LANDSCAPE AND IRRIGATION PLANS CONTAINED IN THE ESCONDIDO WATER EFFICIENT LANDSCAPE REQUILATIONS. HAVE PREPARED THIS PLAN IN COMPLIANCE WITH THOSE REGUILATIONS AND THE LANDSCAPE DESIGN WATER FOR AMAULA. I CERTIFY THAT THE PLAN IMPLEMENTS THOSE REGUILATIONS TO PROVIDE EFFICIENT USE OF WATER."

7185 Navajo Rd., Suite A, San Diego, CA 92119 858.598.5085 4020125

LANDSCAPE ARCHITECTURE -B PLANDING

REV	DATE	BY	DESCRIPTION	11/30/2023
	10/02/20	ML	50% DESIGN	DATE:
	12/07/20	ML	FINAL DESIGN	ML
	1/12/21	ML	FINAL DESIGN - UPDATED	CHECKED BY:
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	11/30/23	ML	CUP RESUBMITTAL	DESIGNED BY:







PROJECT TITLE	
	BREEZE OPERATIONS EAST
	SITE EXPANSION
SHEET TITLE	

SITE EXPANSION	AS SHOW				
PLANT MATERIAL	DRAWING NO L-003				
	SHEET NO	45	OF 45		

# Exhibit "C"

# Planning Case No. PL21-0057

# **Factors to be Considered/Findings of Fact**

# **Environmental Determinations:**

- 1. Pursuant to the California Environmental Quality Act (Public Resources Code section 21000 et. seq.) ("CEQA"), and its implementing regulations (14 C.C.R. § 15000 et seq.) ("CEQA Guidelines"), the City of Escondido ("City") is the Lead Agency for the Project ("Project"), as the public agency with the principal responsibility for approving the Project.
- 2. The Project qualifies for an exemption from further environmental review pursuant an exemption from the California Environmental Quality Act (CEQA) under Section 15332, Class 32, (In-fill Development Projects) because such categorical exemption applies to proposed developments within city limits on sites of no more than five acres substantially surrounded by urban uses, where the site has no habitat value for special status species, can be adequately served by all required utilities and public services, and the Project would not result in any significant effects relating to traffic, noise, air quality, or water quality (CEQA Guidelines § 15332(b)-(e)). Furthermore, the Project does not involve the use of significant amounts of hazardous substances. The proposed Project meets the following criteria:
  - a. The Project is consistent with the applicable general plan designation and all applicable general plan policies as well as with applicable zoning designation and regulations.
  - b. The proposed development occurs within city limits on a project site of no more than five acres substantially surrounded by urban uses.
  - c. The project site has no value as habitat for endangered, rare or threatened species.
  - d. Approval of the Project would not result in any significant effects relating to traffic, noise, air quality, or water quality.
  - e. The site can be adequately served by all required utilities and public services

The Project also does not trigger any exceptions to the categorical exemption as listed in CEQA Guidelines section 15300.2.

3. The Planning Commission has independently considered the full administrative record before it, which includes but is not limited to the January 9, 2024, Planning Commission Staff Report; testimony by staff and the public; and other materials and evidence submitted or provided to it. The administrative record demonstrates that each of the requirements have been satisfied. No substantial evidence has been submitted that would support a finding that any of the above-described exemption requirements has not been satisfied. The Project will not have a significant effect on the environment, and all the requirements of CEQA have been met.

## **Public Notice and Outreach:**

Planning Division staff provided public notice of the application in accordance with City and State public noticing requirements. A notice was published in the local newspaper on or around December 28, 2023. In addition, on or around December 26, 2023, notices were sent to owners within 500 feet of the project site. A public notice was also posted at the project site, on the City's website, and posted at City Hall.

## Conditional Use Permit (CUP)

- 1. This Conditional Use Permit is granted upon sound principles of land use and in response to services required by the community in that the proposed Project has been designed and conditioned to comply with all applicable zoning regulations and design standards. The Project is located within and is surround by similar industrial characteristics and uses. Further, the proposed Project serves a transit district which provides multimodal options, including bus services which serve community members with public transit options.
- 2. This Conditional Use Permit will not cause deterioration of bordering land uses or create special problems for the area in which it is located in that the proposed Project has been designed and conditioned to comply with all applicable zoning regulations and design standards. The Project is located within and is surround by similar industrial characteristics and uses. The Project will replace a vacant underutilized light industrial parcel and has been designed to reduce land use conflicts, consolidating entrances to minimize vehicular conflicts, and enhancing the visual presence. Conditions have been incorporated into the approval of the Project to ensure no conflicts will occur with surrounding uses.
- 3. The proposed Project is located within a designation light industrial area of the City's General Plan. The conditional use is located in in area surrounded by similar industrial/commercial uses. The proposed Project is located adjacent to the existing North County Transit District East Division Maintenance Facility, which will complement and support their current operations and use as a fleet vehicle storage area. Further, the project was reviewed by the City's Staff Development Review Committee for compliance with City requirements and conditioned the Project so as to preserve the public health, safety, and general welfare.

#### Exhibit "D"

# Planning Case No. PL21-0057 335 N. Quince Street/NCTD Fleet Parking Conditions of Approvals

This Project is conditionally approved as set forth on the application received by the City of Escondido on January 29, 2021, and the Project drawings consisting of a Site Plan, Street Elevations, Civil/Grading, and Landscape Design Plans; all designated as approved on January 9 2024, and shall not be altered without express authorization by the Development Services Department.

For the purpose of these conditions, the term "Applicant" shall also include the Project proponent, owner, permittee, and the Applicant's successors in interest, as may be applicable.

#### A. General:

- 1. Acceptance of Permit. If the Applicant fails to file a timely and valid appeal of this Permit within the applicable appeal period, such inaction by the Applicant shall be deemed to constitute all of the following on behalf of the Applicant:
  - **a.** Acceptance of the Permit by the Applicant; and
  - **b.** Agreement by the Applicant to be bound by, to comply with, and to do all things required of or by the Applicant pursuant to all of the terms, provisions, and conditions of this Project Permit or other approval and the provisions of the Escondido Municipal Code or Zoning Code applicable to such Permit.
- 2. Permit Expiration. If the Permit was filed as or concurrent with a Site Plan and Conditional Use Permit, the Permit shall expire 24 months from the effective date of approval, unless additional time is granted pursuant to the Map Act or to the Escondido Municipal Code. If not filed as concurrent with a Site Plan or Conditional Use Permit application, the Permit shall automatically expire after one year from the date of this approval, or the expiration date of any extension granted in accordance with the Escondido Municipal Code and Zoning Code.

The Permit shall be deemed expired if a building permit has not been obtained or work has been discontinued in the reliance of that building permit. If no building permits are required, the City may require a noticed hearing to be scheduled before the authorized agency to determine if there has been demonstrated a good faith intent to proceed, pursuant to and in accordance with the provision of this Permit.

3. Certification. The Director of Development Services, or his/her designee, is authorized and directed to make, or require the Applicant to make, all corrections and modifications to the Project drawings and any other relevant document comprising the Project in its entirety, as necessary to make them internally consistent and in conformity with the final action on the Project. This includes amending the Project drawings as necessary to incorporate revisions made by the decision-making body and/or reflecting any modifications identified in these conditions of approval. Three copies of final Approved Plan set, shall be submitted to the Planning Division for certification. Said plans must be certified by the Planning Division prior to submittal of any post-entitlement permit, including grading, public improvement, landscape, or building plans for the Project.

## 4. Conformance to Approved Plans.

- **a.** The operation and use of the subject property shall be consistent with the Project Description and Details of Request, designated with the Approved Plan set.
- **b.** Nothing in this Permit shall authorize the Applicant to intensify the authorized activity beyond that which is specifically described in this Permit.
- C. Once a permit has been issued, the Applicant may request Permit modifications. "Minor" modifications may be granted if found by the Director of Development Services to be in substantial conformity with the Approved Plan set, including all exhibits and Permit conditions attached hereto. Modifications beyond the scope described in the Approved Plan set may require submittal of an amendment to the Permit and approval by the authorized agency.
- **5. Limitations on Use.** Prior to any use of the Project site pursuant to this Permit, all Conditions of Approval contained herein shall be completed or secured to the satisfaction of the Development Services Department.

## 6. Availability of Permit Conditions.

- a. Prior to building permit issuance, the Applicant shall cause a covenant regarding real property to be recorded that sets forth the terms and conditions of this Permit approval and shall be of a form and content satisfactory to the Director of Development Services.
- b. The Applicant shall make a copy of the terms conditions of this Permit readily available to any member of the public or City staff upon request. Said terms and conditions shall be printed on any construction plans that are submitted to the Building Division for plan check processing.

- 7. Right to Entry. The holder of this Permit shall make the premises available for inspection by City staff during construction or operating hours and allow the investigations of property necessary to ensure that minimum codes, regulations, local ordinances and safety requirements are properly followed. The Applicant shall provide such business records, licenses, and other materials necessary upon request to provide evidence of compliance with the conditions of approval, as well as federal, state, or laws.
- 8. Compliance with Federal, State, and Local Laws. Nothing in this Permit shall relieve the Applicant from complying with conditions, performance standards, and regulations generally imposed upon activities similar in nature to the activity authorized by this permit. (Permits from other agencies may be required as specified in the Permit's Details of Request.) This Permit does not relieve the Applicant of the obligation to comply with all applicable statutes, regulations, and procedures in effect at the time that any engineering permits or building permits are issued unless specifically waived herein.

No part of this Permit's approval shall be construed to permit a violation of any part of the Escondido Municipal or Zoning Code. During Project construction and after Project completion, the Applicant shall ensure the subject land use activities covered by this Permit is conducted in full compliance with all local and state laws.

9. Fees. The appropriate development fees and Citywide Facility fees shall be paid in accordance with the prevailing fee schedule in effect at the time of building permit issuance, to the satisfaction of the Director of Development Services. Through plan check processing, the Applicant shall pay development fees at the established rate. Such fees may include, but not be limited to: Permit and Plan Checking Fees and other fees listed in the Fee Schedule, which may be amended. Arrangements to pay these fees shall be made prior to building permit issuance to the satisfaction of the Development Services Department.

Approval of this development project is conditioned upon payment of all applicable development fees and connection fees in the manner provided in Chapter 6 of the Escondido Municipal Code.

**10. Public Art Partnership Program.** All requirements of the Public Art Partnership Program, Ordinance No. 86-70 shall be satisfied prior to any building permit issuance. The ordinance requires that a public art fee be added at the time of the building permit issuance for the purpose of participating in the City Public Art Program.

## 11. Clerk Recording.

a. Exemption. If the environmental determination prepared for the Project is a categorical exemption, the City of Escondido hereby notifies the Applicant that the County Clerk's Office requires a documentary handling fee of \$50 in order to file a Notice of Exemption. In order to file the Notice of Exemption with the County Clerk, in conformance with California Environmental Quality Act (CEQA) Guidelines section 15062, the Applicant should remit to the City of Escondido Planning Division, within two working days of the final approval of the Project (the final approval being the date of this letter) a certified check payable to the "County Clerk" in the amount of \$50. The filing of a Notice of Exemption and the posting with the County Clerk starts a 35-day statute of limitations period on legal challenges to the agency's decision that the Project is exempt from CEQA. Failure to submit the required fee within the specified time noted above will result in the Notice of Exemption not being filed with the County Clerk, and a 180-day statute of limitations period will apply.

- **b.** For more information on filing fees, please refer to the County Clerk's Office and/or the California Code of Regulations, Title 14, Section 753.5.
- **12. Legal Description Adequacy.** The legal description attached to the application has been provided by the Applicant and neither the City of Escondido nor any of its employees assume responsibility for the accuracy of said legal description.
- 13. Application Accuracy. The information contained in the application and all attached materials are assumed to be correct, true, and complete. The City of Escondido is relying on the accuracy of this information and Project-related representations in order to process this application. Any permits issued by the City may be rescinded if it is determined that the information and materials submitted are not true and correct. The Applicant may be liable for any costs associated with rescission of such permits.
- 14. Revocation, Suspension, Modification. At any time after Project implementation, the City may require a noticed public hearing to be scheduled before the Planning Commission to determine if there has been demonstrated a good faith intent to proceed in reliance on this approval. This item may be referred to the appropriate decision-making body upon recommendation of the Director of Development Services for review and possible revocation or modification of the Permit regarding non-compliance with the Conditions of Approval.

This Permit may be revoked, suspended or modified by the Planning Commission, or by the City Council on appeal, at any time regardless of who is the owner of the subject property or who has the right to possession thereof or who is using the same at such time, whenever, after a noticed hearing, and after the following findings are fully investigated:

**a.** A violation of any term or condition not abated, corrected or rectified within the time specified on the notice of violation; or

- **b.** A violation of any City ordinance, state law, or federal law not abated, corrected or rectified within the time specified on the notice of violation; or
- **c.** The use as presently conducted creates or constitutes a nuisance.

## 15. Indemnification, Hold Harmless, Duty to Defend.

- a. The Applicant shall indemnify, hold harmless, and defend (with counsel reasonably acceptable to the City) the City, its Councilmembers, Planning Commissioners, boards, commissions, departments, officials, officers, agents, employees, and volunteers (collectively, "Indemnified Parties") from and against any and all claims, demands, actions, causes of action, proceedings (including but not limited to legal and administrative proceedings of any kind), suits, fines, penalties, judgments, orders, levies, costs, expenses, liabilities, losses, damages, or injuries, at law or in equity, including without limitation the payment of all consequential damages and attorney's fees and other related litigation costs and expenses (collectively, "Claims"), of every nature caused by, arising out of, or in connection with (i) any business, work, conduct, act, omission, or negligence of the Applicant or the owner of the Property (including the Applicant's or the owner of the Property's contractors, subcontractors, licensees, sublessees, invitees, agents, consultants, employees, or volunteers), or such activity of any other person that is permitted by the Applicant or owner of the Property, occurring in, on, about, or adjacent to the Property; (ii) any use of the Property, or any accident, injury, death, or damage to any person or property occurring in, on, or about the Property; or (iii) any default in the performance of any obligation of the Applicant or the owner of the Property to be performed pursuant to any condition of approval for the Project or agreement related to the Project, or any such claim, action, or proceeding brought thereon. Provided, however, that the Applicant shall have no obligation to indemnify, hold harmless, or defend the City as to any Claims that arise from the sole negligence or willful misconduct of the City. In the event any such Claims are brought against the City, the Applicant, upon receiving notice from the City, shall defend the same at its sole expense by counsel reasonably acceptable to the City and shall indemnify the City for any and all administrative and litigation costs incurred by the City itself, the costs for staff time expended, and reasonable attorney's fees (including the full reimbursement of any such fees incurred by the City's outside counsel, who may be selected by the City at its sole and absolute discretion and who may defend the City against any Claims in the manner the City deems to be in the best interests of the City).
- b. The Applicant further and separately agrees to and shall indemnify, hold harmless, and defend the City (including all Indemnified Parties) from and against any and all Claims brought by any third party to challenge the Project or its approval by the City, including but not limited to any Claims related to the Project's environmental determinations or environmental review documents, or any other action taken by the

City regarding environmental clearance for the Project or any of the Project approvals. Such indemnification shall include the Applicant's payment for any and all administrative and litigation costs and expenses incurred by the City in defending against any such Claims, including payment for all administrative and litigation costs incurred by the City itself, the costs for staff time expended, and reasonable attorney's fees (including the full reimbursement of any such fees incurred by the City's outside counsel, who may be selected by the City at its sole and absolute discretion and who may defend the City against any Claims in the manner the City deems to be in the best interests of the City and the Project).

c. The City, in its sole discretion and upon providing notice to the Applicant, may require the Applicant to deposit with the City an amount estimated to cover costs, expenses, and fees (including attorney's fees) required to be paid by the Applicant in relation to any Claims referenced herein, which shall be placed into a deposit account from which the City may draw as such costs, expenses, and fees are incurred. Within 14 days after receiving written notice from the City, the Applicant shall replenish the deposit account in the amount the City determines is necessary in the context of the further defense of such Claims. To the extent such deposit is required by the City, the amount of such deposit and related terms and obligations shall be expressed in a written Deposit Account Agreement, subject to the City Attorney's approval as to form. The City, in its sole and reasonable discretion, shall determine the amount of any initial deposits or subsequent deposits of funds, and the Applicant may provide documentation or information for the City to consider in making its determinations. Nothing within this subsection shall be construed as to relieve the Applicant's obligations to indemnify, hold harmless, or defend the City as otherwise stated herein.

## B. Construction, Maintenance, and Operation Obligations:

1. Code Requirements. All construction shall comply with the applicable requirements of the Escondido Municipal Code, Escondido Zoning Code, California Building Code; and the requirements of the Planning Division, Engineering Services Department, Director of Development Services, Building Official, City Engineer, and the Fire Chief in carrying out the administration of said codes. Approval of this Permit request shall not waive compliance with any City regulations in effect at the time of Building Permit issuance unless specifically waived herein.

As a condition of receiving the land use approvals specified herein, Applicant shall maintain the property subject to the approvals in compliance with all applicable city codes governing the condition or appearance of property. In addition to compliance with such basic standards, the property subject to these approvals shall also be maintained free of trash, plant debris, weeds, and concrete (other than existing foundations and permanent structures). Any signs placed on the property advertising such property for sale or rent shall be in accordance with applicable laws, and be kept clean, in like-new condition, and

free from fading and graffiti at all times. This condition shall be applicable from the date the land use is approved. The failure to comply with this condition shall subject the approvals specified herein to revocation for failure to comply.

2. Agency License and Permitting. In order to make certain on- or off-site improvements associated with the Approved Plan set, the Permit request may require review and clearance from other agencies. Nothing in these Conditions of Approval shall be construed as to waive compliance with other government agency regulations or to obtain permits from other agencies to make certain on- or off-site improvements prior to Final Map recordation, grading permit issuance, building permit issuance, or certificate of occupancy as required. This review may result in conditions determined by the reviewing agency.

At all times during the effective period of this Permit, the Applicant and any affiliated responsible party shall obtain and maintain in valid force and effect, each and every license and permit required by a governmental agency for the construction, maintenance, and operation of the authorized activity.

- **3. Utilities.** All new utilities and utility runs shall be undergrounded, or fee payment in-leu subject to the satisfaction of the City Engineer.
- **4. Noise.** All Project generated noise shall conform to the City's Noise Ordinance (Ordinance 90-08).
- **5. Lighting.** If required, all exterior lighting shall conform to the requirements of Article 35 (Outdoor Lighting Ordinance) of the Escondido Zoning Code.
- 6. General Property Maintenance. The Applicant (NCTD) shall be responsible for maintaining the fleet vehicle storage area in good visual and functional condition. This shall include, but not be limited to, all exterior elements related to the screening walls, lighting, and gated access points. The internal site improvements include new paving, restriping, lighting, screening walls, and perimeter landscaping, shall be maintained for a safe, clean and efficient appearances.
- 7. Anti-Graffiti. The Applicant shall remove all graffiti from buildings and wall surfaces within 48 hours of defacement, including all areas of the job site for when the Project is under construction.
- **8. Anti-Litter.** The site and surrounding area shall be maintained free of litter, refuse, and debris. Cleaning shall include keeping all publicly used areas free of litter, trash, and garbage.

- Roof, Wall, and Ground Level Equipment. All fleet vehicle storage and maintenance equipment shall be screened and concealed from view in accordance with Section 33-1085 of the Escondido Zoning Code.
- **10. Staging Construction Areas.** All staging areas shall be conducted on a pre-determined site only, subject to written approval of the Engineering Department. Off-site staging areas, if any, shall be approved through the issuance of an off-site staging area permit/agreement with the City.
- 11. Disturbance Coordinator. The Applicant shall designate and provide a point-of-contact whose responsibilities shall include overseeing the implementation of Project, compliance with Permit terms and conditions, and responding to property owner or neighborhood concerns.
- 12. Construction Waste Reduction, Disposal, and Recycling. If any, the Applicant shall recycle or salvage for reuse a minimum of 65% of the non-hazardous construction and demolition waste for residential projects or portions thereof in accordance with either Section 4.408.2, 4.408.3, or 4.408.4 of the California Green Building Standards Code; and/or for non-residential projects or portions thereof in accordance with either Section 5.408.1.1, 5.408.1.2, or 5.408.1.3 of the California Green Building Standards Code. In order to ensure compliance with the waste diversion goals for all residential and non-residential construction projects, the Applicant must submit appropriate documentation as described in Section 4.408.5 of the California Green Building Standards Code for residential projects or portions thereof, or Section 5.408.1.4 for non-residential projects or portions thereof, demonstrating compliance with the California Green Building Standards Code sections cited above.
- 13. Construction Equipment Emissions. Applicant shall incorporate measures that reduce construction and operational emissions. Prior to the City's issuance of the demolition and grading permits for the Project, the Applicant shall demonstrate to the satisfaction of the Planning Division that its construction contractor will use a construction fleet wherein all 50-horsepower or greater diesel-powered equipment is powered with California Air Resources Board ("CARB") certified Tier 4 Interim engines or equipment outfitted with CARB-verified diesel particulate filters. An exemption from this requirement may be granted if (i) the Applicant provides documentation demonstrating that equipment with Tier 4 Interim engines are not reasonably available, and (ii) functionally equivalent diesel PM emission totals can be achieved for the Project from other combinations of construction equipment. Before an exemption may be granted, the Applicant's construction contractor shall demonstrate to the satisfaction of the Director of Development Services that (i) at least two construction fleet owners/operators in San Diego County were contacted and those owners/operators confirmed Tier 4 Interim equipment could not be located within San Diego County during the desired construction schedule, and (ii) the proposed replacement equipment has been evaluated using the California Emissions Estimator

Model ("CalEEMod") or other industry standard emission estimation method, and documentation provided to the Planning Division confirms that necessary project-generated functional equivalencies in the diesel PM emissions level are achieved.

**14. Signage.** All proposed signage associated with the Project must comply with Article 66 (Sign Ordinance) of the Escondido Zoning Code. Separate sign permits will be required for Project signage. All non-conforming signs shall be removed. The Applicant shall submit with any sign permit graphic/list of all signs to be removed and retained, along with any new signage proposed.

# C. Parking and Loading/Unloading:

- 1. No contractor or employee may store, or permit to be stored, a commercial or construction vehicle/truck; or personal vehicle, truck, or other personal items on private property without written permission of the Applicant. The written authorization shall be submitted to the City for file records.
- **D. Landscaping:** The Applicant assumes all responsibility for maintaining all on-site perimeter landscape pertaining to the installation of the screening walls, parkways improvements, and buffer areas in substantial conformance to the planting and irrigation schedule as shown on the final Approved Plan set.
  - 1. Landscaped areas shall be maintained in a flourishing manner. Appropriate irrigation shall be provided for all landscape areas and be maintained in a fully operational condition.
  - All existing planting and planter areas, including areas within the public right-of-way, shall be repaired and landscaping brought into compliance with current standards. All dead plant material shall be removed and replaced by the property owner or management company.
  - 3. If at the time of planning final inspection that it is determined that sufficient screening is not provided, the Applicant shall be required to provide additional landscaping improvements to the satisfaction of the Planning Division.
  - 4. The landscaped areas shall be free of all foreign matter, weeds and plant material not approved as part of the landscape plan.
  - 5. Failure to maintain landscaping and the site in general may result in the setting of a public hearing to revoke or modify the Permit approval.
  - 6. **Landscaping Plans.** Applicant shall install all required landscape improvements in substantial conformance to the planting and irrigation schedule as shown on the final Approved Plan set.
    - a. A final landscape and irrigation plan shall be submitted to the Engineering Services Department for review and approval, if meeting any of the criteria listed under Section

33-1323 of the Zoning Code. Five copies of detailed landscape and irrigation plans shall be submitted to the Engineering Services Department with the second submittal of the grading plan or site plan. The initial submittal of the landscape plans shall include the required plan check fees, paid in accordance with the prevailing fee schedule in effect at the time of submittal. Details of Project fencing and walls, including materials and colors, shall be provided on the landscape plans. (Building permits may also be required.) The landscape and irrigation plans shall be reviewed and approved by the Planning Division and Engineering Services Department prior to issuance of grading or site plan permits, and shall be equivalent or superior to the conceptual landscape plans included as part of the Approved Plan set, to the satisfaction of the Planning Division. The required landscape and irrigation plans(s) shall comply with the provisions, requirements and standards outlined in Article 62 (Landscape Standards) of the Escondido Zoning Code, except where stricter requirements are imposed by the State of California.

- b. Screening walls, retaining walls, storm improvements, and landscaping (i.e. planting and irrigation) is to be provided prior to final occupancy.
- c. The installation of the landscaping and irrigation shall be inspected by the Project landscape architect upon completion. He/she shall complete a Certificate of Landscape Compliance certifying that the installation is in substantial compliance with the approved landscape and irrigation plans and City standards. The Applicant shall submit the Certificate of Compliance to the Planning Division and request a final inspection.
- d. Any new freestanding walls and/or retaining walls shall incorporate decorative materials or finishes, and shall be indicated on the landscaping plans. (Building permits may also be required.) All freestanding walls visible from points beyond the Project site shall be treated with a protective sealant coating to facilitate graffiti removal. The sealant shall be a type satisfactory to the Director of Development Services.
- e. New or retrofitted trash enclosures shall accommodate vertical climbing plants, vines with support trellis panels, clinging non-deciduous or fast-growing shrubbery that will screen the enclosures wall surface. Director of Development Services shall find that the proposed landscaping design, material, or method provides approximate equivalence to the specific requirements of this condition or is otherwise satisfactory and complies with the intent of these provisions.

## E. Specific Engineering Division Conditions:

1. The Developer shall provide the City Engineer with a Preliminary Title Report covering subject property.

- 2. The location of all existing on-site and adjacent utilities and storm drain facilities shall be determined by the Developer's engineer. If a conflict occurs with the proposed project or improvements, arrangements for relocation of the conflicting utilities/facilities shall be made with the owner of the utility/facility prior to approval of the Grading plans. This utility/facility relocation work shall be completed prior to issuance of Building Permits.
- 3. Improvement plans prepared by a Civil Engineer, required for all public street, utility, and storm drain improvements, and Grading/Private Improvement plans prepared by Civil Engineer, required for all grading, drainage and private onsite improvement design, shall be submitted for review through the City's virtual plan review portal as a single package containing all items on the Engineering Initial Submittal Checklists. Landscaping Plans shall be prepared by a Landscape Architect.
- 4. The Developer shall post securities in accordance with the City prepared Bond and Fee Letter based on a final Engineer's Estimate of Grading and Improvements Cost prepared by the project engineer. The Developer is required to provide a Cash Clean Up deposit for all grading, landscaping, private Improvements and onsite drainage improvements prior to approval of Grading Plans and issuance of Grading Permit. This Cash Clean Up Deposit amount shall be 10% of the total cost of the project private improvements, drainage and landscaping. All improvements shall be completed prior to issuance of a Certificate of Occupancy or final Engineering inspections.
- **5.** All public improvements shall be constructed in a manner that does not damage existing public improvements. Any damage shall be determined by and corrected by the Developer to the satisfaction of the City Engineer.

# STREET IMPROVEMENTS AND TRAFFIC

- 1. The project's access drive shall be constructed as an alley-type driveway apron per City's standard drawing G-5-E with a minimum throat width of thirty (30) feet.
- **2.** All on-site driveways, and parking areas will be private. Typical sections and design details shall be to the satisfaction of the City Engineer and Community Development Director.
- **3.** All unused driveways shall be removed and replaced with full height curb and gutter and sidewalk in accordance with City standards.
- **4.** The developer shall remove and construct a new ADA pedestrian curb ramp at the corner of N. Quince Street and Norlak Avenue per San Diego Regional Standard Drawing G-29.
- 5. The Developer shall remove and replace all damaged sidewalk, curb and gutter, along all project frontages to the satisfaction of the City Engineer prior to issuance of a Certificate of Occupancy or final Engineering inspection.
- 6. The Developer shall repaint all pavement striping and markings adjacent to the project that have been damaged and prematurely faded due to project construction traffic to the satisfaction of the City Engineer.

- **7.** All gated entrances shall be approved by the City Engineer, Building Official, and the Fire Marshal.
- 8. The Developer will be required to provide a detailed detour and traffic control plan, for all construction and staging activities, and any requested materials placement within existing rights-of-way to the satisfaction of the City Engineer. This plan shall include any proposed sidewalk closures and provide for alternate pedestrian access around the project site. This plan shall be approved prior to the issuance of an Encroachment Permit for construction or other project activities within the public right-of-way.
- **9.** The Developer shall install trash capture devices on existing storm drain inlets along the project's frontage to the satisfaction of the City Engineer.
- **10.** The installation of all utilities and facilities (green street tree wells, fire hydrant, transformers, etc.) shall be constructed at the ultimate location and to the satisfaction of the City Engineer.

# **GRADING and SITE IMPROVEMENTS**

- 1. A site grading and erosion control plan prepared by a registered Civil Engineer shall be approved by the Engineering Department. The first submittal of the grading plan shall be accompanied by a copy of the preliminary soils and geotechnical report. The Soils Engineer will be required to indicate in the soils report that he/she has reviewed the grading design and found it to be in conformance with his/her recommendations.
- 2. All easements, both private and public, affecting subject property shall be shown and delineated on the Grading and Improvement Plans.
- **3.** All private driveways and parking areas shall be paved with a minimum of 3" asphalt concrete (AC) over 6" of asphalt Base (AB) or 7" Portland Concrete Cement (PCC) over 6" AB. All paved areas exceeding 15% slope or less than 1.0% shall be paved with PCC.
- 4. Erosion control, including riprap, interim slope planting, sandbags, or other erosion control measures shall be provided to control sediment and silt from the project. The Developer shall be responsible for maintaining all erosion control facilities throughout the project.
- 5. The Developer shall be responsible for the recycling of all excavated materials designated as Industrial Recyclables (soil, asphalt, sand, concrete, land clearing brush and rock) at a recycling center or other location(s) approved by the City Engineer.
- **6.** A Construction General Permit is required from the State Water Resources Control Board for all storm water discharges associated with a construction activity where clearing, grading, and excavation results in a land disturbance of one or more acres.
- **7.** All existing foundations, structures, trees not otherwise noted to remain or be relocated shall be removed or demolished from the site.

#### DRAINAGE

- Final on-site and off-site storm drain improvements shall be determined to the satisfaction
  of the City Engineer and shall be based on a Drainage Study to be prepared by the
  Engineer of Work. The drainage study shall be in conformance with the City of Escondido
  Design Standards.
- **2.** All on-site storm drains not in public easements are private. The responsibility for maintenance of these storm drains shall be that of the Property Owner.
- 3. A Storm Water Quality Management Plan (SWQMP) in compliance with the City's latest adopted Storm Water Design Manual shall be prepared for all newly created or replaced onsite impervious areas, impervious frontage, and required offsite improvements. The SWQMP shall be submitted for approval with the final improvement and grading plans. The SWQMP shall include treatment calculations, post-construction storm water treatment measures, and maintenance requirements and responsibilities both for onsite treatment and also any "Green Street" facilities located in the public right-of-way. The SWQMP shall demonstrate how proposed proprietary best management practices meet bio-filtration treatment requirements in accordance with the City's Storm Water Design Manual.
- 4. All site drainage with emphasis on the parking and driveway areas shall be treated to remove expected contaminants using a high efficiency non-mechanical method of treatment. The City highly encourages the use of bio-retention areas as the primary method of storm water retention and treatment. The landscape plans will need to reflect these areas of storm water treatment.
- **5.** The Developer will be required to have the current owner of the property sign, notarize, and record a Storm Water Control Facility Maintenance Agreement.
- **6.** All storm water treatment and retention facilities and their drains including the bio-retention basins and planters, any permeable paver areas shall be considered private. The responsibility for maintenance of these post construction storm water treatment facilities shall be that of the Property Owner.

## **WATER SUPPLY**

- 1. Fire hydrants, if required, together with an adequate water supply shall be installed at locations approved by the Fire Marshall. Fire hydrants shall connect to a minimum 8-inch water main. Existing fire hydrants shall meet current City of Escondido standards.
- 2. All on-site water lines and backflow prevention devices beyond the City water meter or DCA shall be considered a private water system. The property owner shall be responsible for all maintenance of these water lines and appurtenances.
- 3. All new or existing water meters shall have an approved reduced pressure backflow prevention devise per the City of Escondido Design Standards and Standard Drawings. Water meters and backflow prevention devices shall not be installed within a driveway apron or on private drive areas. Backflow prevention assemblies are private and should

be located on private property. Backflows shall be located directly behind the public water meter.

- **4.** No trees or deep-rooted bushes shall be planted within 10-feet of any water mains.
- 5. There shall be no permanent structures located within the City's Public Utility Easements.
- **6.** Any water services to be replaced, reconnected or relocated as a part of this project shall be replaced in entirety from the public water main to the public water meter to the satisfaction of the Utilities Engineer and Water Distribution Department.
- 7. Any fire hydrants to be replaced, reconnected or relocated as a part of this project shall be replaced in entirety from the public water main to the fire hydrant per the satisfaction of the Utilities Engineer and Water Distribution.
- **8.** The Developer shall disconnect at the public main, all water services and fire hydrants laterals to be abandoned, to the satisfaction of the Utilities Engineer and Water Distribution Department.

#### **SEWER**

- 1. All sewer laterals shall be constructed per current City of Escondido Design Standards and Standard Drawings and per the current Uniform Plumbing Code.
- 2. No trees or deep-rooted bushes shall be planted within 15-feet of any sewer main or within 10-feet of any sewer lateral. Sewer laterals shall be 5-feet horizontally clear from other utilities.
- **3.** All sewer laterals shall be considered a private sewer system. The property owner shall be responsible for all maintenance of sewer laterals to the public sewer main.
- **4.** The project design shall be such that all existing or new sewer manholes are accessible at all times by City "Vactor" trucks for maintenance.
- 5. The Developer shall cap and plug at the public sewer main all sewer lines and laterals to be abandoned, to the satisfaction of the Utilities Engineer and the City Inspector.

#### LANDSCAPE

1. A site landscaping and irrigation plan shall be submitted to the Engineering Department with the second submittal of the grading plan for review and approval by Engineering and Planning Departments. The initial submittal of the landscape plans shall include the required plan check fees.

#### **CASH SECURITIES**

 A cash security shall be posted to pay any costs incurred by the City to clean-up eroded soils and debris, repair damage to public or private property and improvements, install new BMPs, and stabilize and/or close-up a non-responsive or abandoned project. Any moneys used by the City for cleanup or damage will be drawn from this security and the grading permit will be revoked by written notice to the developer until the required cash security is replaced. The cleanup cash security shall be released upon final acceptance of the grading and improvements for this project. The amount of the cash security shall be 10% of the total estimated cost of the grading, drainage, landscaping, and best management practices items of work with a minimum of \$5,000 up to a maximum of \$50,000, unless a higher amount is deemed necessary by the City Engineer.

# **E.** Specific Fire Department Conditions:

1. An adequate water supply and approved paved access is required prior to any combustibles being brought to the site.