

Project: 1078 Harbour Island Road – accessory building construction

Date: December 17, 2021

This review is for an application to construct an additional building (accessory structure) on the existing single family lot at the above address. The property is within the Harbour Island Subdivision 1, Lot 23.

The subject property is 54,908 SF (1.26 acres) and contains a two story single family home residence. The residence is a canal front property. The canal adjoins Little Lake Conway.

The applicant proposes to construct an accessory structure on the same lot. The structure includes approximately 1,724 SF of new impervious area to the lot. The structure is not shown to be directly connected to the existing home.

Per the information received for review, this accessory structure will be for living quarters and will not have a full kitchen or kitchenette. Per the City Zoning Code, Chapter 134, Section 134-1, definitions, this appears to be classified as a Guest Cottage. A Guest Cottage is defined as living quarters within a detached accessory building located on the same lot or parcel of land as the principal building, to be used exclusively for housing members of the family occupying the principal building and their nonpaying guests, such quarters shall have no kitchen facilities and shall not be rented or otherwise used as a separate dwelling.

The City Zoning code has a reference for cottages and in Section 134-220, Special Exceptions, paragraph c, there is a reference to guest cottages as a use that may be permitted. A Special exception application must be submitted for this use.

The accessory structure may not encroach on the side setbacks as described for the specific lot zoning. City code Section 134-483, paragraphs a, b, c, f, h and i, has additional information on the "location" of the proposed structure and maximum height.

The proposed accessory structure is greater than the minimum 5 foot setback, per Section 134-483. The proposed distance is 7'-6", which is outside the existing side yard drainage easement.

Section 134-483, (i) - The maximum height may not exceed the height of the principal structure. The height is shown on the site plan as 14'-6", which is less than the height of the home and less than the maximum of 16' for accessory structures.

The plans also proposed a 36' by 11'-8" carport. The total area of the car port is 420 SF. Per Section 134-483, (g) – detached garages shall be limited to a maximum of 600 SF.

The existing impervious area for the lot is 10,912 SF. The new total impervious area with the new addition and the changes to the driveway is approximately 12,636 SF. The total lot area is 54,908 SF. The percent impervious after construction will be approximately 23%, which is below the allowable limit of 45%.



Based on our review, the proposed accessory structure appears to meet the criteria listed in the City Code. As noted above, the code states this will need to be submitted to the City for review and then to Planning and Zoning and City Council for final approval.

Please be reminded, approval of this application by the City of Edgewood does not grant authority to alter other portions of this property, nor does it waive any permits that may be required by Federal, State, or County agencies which may have jurisdiction.

Sincerely, CPH, Inc.

Allen C. Lane, Jr., P.E. Project Engineer



APPLICATION FOR SPECIAL EXCEPTION

Reference: City of Edgewood Code of Ordinances, Section 134-121
REQUIRED FEE: \$750.00 + Applicable Pass-Through Fees (Ordinance 2013-01)

(Please note this fee is non-refundable)

PLANNING AND ZONING MEETING DATE:	1/10/2022
CITY COUNCIL MEETING DATE:	2/15/2022

IMPORTANT: A COMPLETE application with all required attachments and ten (10) copies must be submitted to the City Clerk <u>30</u> days before the next Planning & Zoning meetings. No application shall be deemed accepted unless it is complete and paid for.

Notarized letter of authorization from Owner MUST be submitted if application is filed by anyone other than property owner.

Please type or print. Complete carefully, answering each question and attaching all necessary documentation and additional pages as necessary.

New Special Exception Request

Amendment to Special Exception. Date special exception granted				
Applicant's Name:	Roland J. Krantz	Owner's Name:	Anthony W. Johnson	
Address:	102 Drennen Road Suite A-2, Orlando FL 32806	Address:	1078 Harbour Island Rd Orlando, FL 32809-3040	
Phone Number:	407-326-2119	Phone Number:	407-496-8657	
Fax:		Fax:	N/A	
Email:	Jim.krantz@alairhomes.com	Email:	barillasjohnson@yahoo.com	
Legal Description:	egal Description: HARBOUR ISLAND SUB 1/131 LOT 23			
Zoned:	R-1AA			
Location:	Harbour Island			
Tract Size:	1.26 acres			
City section of the Zoning Code from which Special Exception is requested: Residential (R-1AA). 134-220(C)(5)).		





CITY OF EDGEWOOD

Request:	Construction of detached dwelling approximately 1,215sqft.
Existing on Site:	Existing home approximately 4,760sqft with a screened pool and boat dock.

The applicant hereby states that the above request for Special Exception does not violate any deed restrictions on the property. Application must be signed by the legal owner, not agent, unless copy of power of attorney is attached.

Applicant's Signature	Want // Mes	Date:	12/6/21	
Applicant's Printed Name	Roland J. Krantz	Date:	12/6/21	
Owner's Signature	arthon W. John			
Owner's Printed Name	Anthony W. Johnson			

Office Use Only:		
Received Date:	12/6/2021	
Received By:	Brett Sollars	
Forwarded To:	CPH- Allen Lane	
Notes:		

Please submit your completed application to City Hall via email to bmeeks@edgewood-fl.gov or to sriffle@edgewood-fl.gov or additional questions, please contact City Hall at 407-851-2920.



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Revised 3/27/2020

SPECIAL EXCEPTION APPLICATION

- 1. Provide the legal description (include street address) .
- 2. If you are not the owner of the subject property, provide written acknowledgement and authorization from property owner that they do not object to the use requested in the Special Exception Application, and give their authorization for the use if approved.
- 3. SURROUNDING ZONING DESIGNATIONS:

DIRECTION	ZONING
NORTH	R1-A
SOUTH	12-11
EAST	R-IAA
WEST	ECD

- 4. Describe the proposed use you; including conditions on the use, hours of operation, required parking and loading spaces, and number of employees. If proposed use is a training/vocational school, provide the number of anticipated students/clients.
- 5. If applicable, please provide:
- Dimensions of the property (see attached example)
- Existing and proposed location of structure(s) on the property
- Vehicular access ways, driveways, circulation areas (include widths)
- · Off-street parking and loading areas
- Refuse and service areas
- · Required setbacks; landscape or buffer areas; and other open spaces
- Existing and proposed adjacent rights-of-way, showing widths and centerlines
- Distances between buildings
- Landscape plan



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BS

NOV 09 202 range County Division of Building Safety

201 South Rosalind Avenue

CITY OF EDGEWOOD Post Office Box 2687 • Orlando, Florida 32802-2687

Phone: 407-836-5550 www.ocfl.net/building

10	1	25	/ 2021
Date			
Ruildi	na l	Dorm	it Number

APPLICATION FOR BUILDING/LAND USE PERMIT*

* All Applications Must Comply with Concurrency Requirements

WARNING TO OWNER: "YOUR FAILURE TO RECORD A NOTICE OF COMMENCEMENT MAY RESULT IN YOUR PAYING TWICE FOR IMPROVEMENTS TO YOUR PROPERTY. A NOTICE OF COMMENCEMENT MUST BE RECORDED AND POSTED ON THE JOB SITE BEFORE THE FIRST INSPECTION. IF YOU INTEND TO OBTAIN FINANCING, CONSULT WITH YOUR LENDER OR AN ATTORNEY BEFORE RECORDING YOUR NOTICE OF COMMENCEMENT."

A CONTRACTOR AND MANAGEMENT OF STREET				
PLEASE PRINT: The undersigned hereby applies for a	permit to make building	improvements as inc	dicated below on property.	
Project Address: 1078 Harbour Island Road (Must match address on plans)				
Suite/Unit #: Bldg #:		City: Orlando	Zin Code: 33800	
Subdivision Name:	**		Zip Code. <u>32809</u>	_
Parcel ID Number: Section Town			Block Lat	
(15 Digit Parcel ID Number & Legal Descri		Subdivision	Block Lot	
Owner Name: Anthony & Dennis Johnson		Phone No.: (40	7) 496 - 8657	
Owner Address: 1078 Harbour Island Road	d	City: Orlando	State: FL Zip Code	32809
Tenant Name:		Phone No.: (
Nature of Business:				
Architect Name:	License N	lo.:	Phone No.: ()	-
Civil Engineer Name:				
Nature of Proposed Improvements: N				
FUTURE USE OF PROPRIETY	MICH DE AN OH	IC XITCL FOIL	POSTONOR,	
PROPERTY ON SEWER or Sewer Sew		2. and Notice of Com	mencement prior to the first	inspection.
Is Notice of Commencement Recorded	d? ☐ Yes ☑ No			
If there were comments on this project		eceive them?		
☐ Pick them up				
Is proposed work in response to a Not			ounty Inspector? TYes	✓ No
Is proposed work in response to an un				
Has project had a pre-review? Yes			s):	
Is building fire sprinklered? Yes			7-	_
Detached Garage? ☐Yes ☑No		Valuation for Deta	ched Garage Only: \$	
Required work: Plumbing Electric	cal Mechanical DGas		onda Garago Grilly. V	
Alterations Only:	odi Elivicoridinicai Eloas			
Is this a new tenant? Yes	If was state provi	one nee.		
Intended use of space:	ii yes, state previ	ous use		
List use of adjoining tenant space(s):	Side:	Above:		
Page:	Side:	Above		

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Permit Application Information - Page Two

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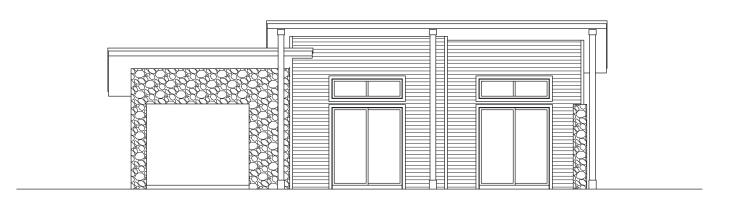
CITY OF EDGEWOOD Owner's Name Anthony & Dennis Johnson Owner's Address 1078 Harbour Island Road Fee Simple Titleholder's Name (If other than owner's) Fee Simple Titleholder's Address (If other than owner's) State Zip Code Contractor's Name Roland James Krantz Contractor's Address 102 Drennen Road State FL Zip Code 32806 City Orlando Job Name Job Address 1078 Harbour Island Road _____State _____ Zip Code 32809 City Orlando Bonding Company Name Bonding Company Address State Zip Code City ____ Architect/Engineer's Name Architect/Engineer's Address Mortgage Lender's Name Mortgage Lender's Address Application is hereby made to obtain a permit to do the work and installations as indicated. I certify that no work or installation has commenced prior to the issuance of a permit and that all work will be performed to meet the standards of all laws regulating construction in this jurisdiction. I understand that a separate permit must be secured for ELECTRICAL, PLUMBING, GAS, MECHANICAL, ROOFING, SIGNS, POOLS, ETC. OWNER'S AFFIDAVIT: I certify that all the foregoing information is accurate and that all work will be done in compliance with all applicable laws regulating construction and zoning. WARNING TO OWNER: Your failure to record a Notice of Commencement may result in your paying twice for improvements to your property. A Notice of Commencement must be recorded and posted on the job site before the first inspection. If you intend to obtain financing, consult with your lender or an attorney before recording your Notice of Commencement. Contractor Signature // Lyrens Wowner Signature The foregoing instrument was acknowledged before me this 27 27 27 The foregoing instrument was acknowledged before me this / 1 27 1 21 by DENKE JOHNSON Who is personally known to me who is personally known to me by ROLAND and who produced 1.2. and who produced as identification and who as identification and who did not take an oath. did not take an oath. Notary Public State of Florida Notary Public State of Florica Notary as to Owner Notary as to Contractor Nicholas Hidalgo My Commission _ HH 181513 Nicholas Hidalgo My Commission HH 181513 Exp. 10/5/2025 Commission No. Commission No. Exp. 10/5/2025 State of FL. County of State of FL. County of



CITY OF EDGEWOOD

JOHNSON RESIDENCE

ORLANDO, FL.



SQUARE FOOTAGE TABULATIONS	
EXISTING SQUARE FOOTAGE (CONDITIONED):	3,017
EXISTING SQUARE FOOTAGE (NON-CONDITIONED):	1,743
EXISTING TOTAL GROSS:	4,760
NEW ADU SQUARE FOOTAGE (CONDITIONED):	699
NEW ADA SQUARE FOOTAGE (NON-CONDITIONED):	516
NEW TOTAL ADU GROSS:	1,215
NEW ADU FRONT COVERED PORCH SF:	151
NEW ADU REAR COVERED PORCH SF:	291
TOTAL SITE CONDITIONED SF EXISTING + ADU:	3,716
TOTAL SITE NON-CONDITIONED SF EXISTING + ADU:	2,259
TOTAL SITE GROSS SF EXISTING + ADU:	5,975



Α1

CONTRACTORS SHALL VERIFY ALL CONDITIONS AT THE JOBSITE PRIOR TO COMMENCING WORK CONTRACTORS SHALL REPORT ALL DISCREPANCIES IN THE DRAWING AND EXISTING CONDITIONS TO THE ARCHITECT PRIOR TO COMMENCING WORK.

INTENT OF PLANS ARE FOR PERMITTING APPROVAL. CONTRACTORS SHALL INCLUDE ALL NECESSARY ITEMS, EQUIPMENT, AND ACCESSORIES REQUIRED TO COMPLETE THEIR SCOPE OF WORK THOUGH THEY MAY NOT BE INDICATED ON THESE PLANS.

ALL DETAILS AND SECTIONS SHOWN ON THE DRAWINGS ARE INTENDED TO BE TYPICAL AND SHALL BE CONSTRUED TO APPLY TO ANY SIMILAR SITUATION ELSEWHERE IN THE WORK EXCEPT WHERE A

CONTRACTORS SHALL APPLY FOR THEIR TRADE PERMITS IF NECESSARY, PAY ALL PERMITTING FEES, AND ARRANGE ALL INSPECTIONS RELATED TO THEIR TRADE. OWNER SHALL BE NOTIFIED IN ADVANCE PRIOR TO

ALL WIND LOAD CALCULATIONS AND DESIGN CRITERIA ARE BASED ON AN "ENCLOSED" STRUCTURE. ANY BREACH OR PENETRATION, SUCH AS WINDOWS, DOORS, ETC. DURING A STORM EVENT WILL COMPROMISE

ALL EXTERIOR WALLS ARE SHEAR WALLS AND MUST TRANSFER LOADS TO FOUNDATION. TRUSSES SHALL BE DESIGNED BY PRE-ENGINEERED TRUSS COMPANY AND SUBMITTED TO AHJ (CITY OF

REFER TO TUB/SHOWER MANUFACTURER INFORMATION FOR DRAIN LOCATION PER OWNER'S FIXTURE

10. ALL PLUMBING, GAS, MECHANICAL, AND ELECTRICAL SHALL COMPLY WITH FLORIDA BUILDING CODE

11. USE CEMENTIOUS BACKER BOARD AT ALL WET WALLS UNLESS NOTED OTHERWISE.

PROVIDE BLOCKING IN WALLS WHERE REQUIRED FOR PLUMBING FIXTURES AND FOR MILLWORK SECUREMENT.

SITE WORK

SUBSURFACE SOIL CONDITION INFORMATION IS NOT AVAILABLE. FOUNDATIONS ARE DESIGNED FOR A 2.000 PSF SOIL BEARING CAPACITY. CONTRACTOR SHALL REPORT ANY DIFFERING CONDITIONS TO THE ARCHITECT PRIOR TO COMMENCING WORK AND VERIFY SOIL IS CAPABLE OF SUPPORTING DESIGN LOAD OF

2. PROVIDE GROUND POISONING PER STATE OF FLORIDA AND HRS. CHAPTER 100-55, F.A.C., UNDER ENTIRE SURFACE OF LIVING AREA FLOOR AND ON BOTH SIDES OF FOUNDATION WALL. REFER TO CHEMICAL TERMITE TREATMENT NOTES FOR OPTIONAL APPLICATIONS.

A FOUNDATION SURVEY SHALL BE PERFORMED AND A COPY OF THE SURVEY SHALL BE ON THE SITE FOR THE BUILDING INSPECTORS TO USE. OR, ALL PROPERTY MARKERS SHALL BE EXPOSED AND A STRING STRETCHED FROM MAKER TO MARKER TO VERIFY REQUIRED SETBACKS.

ALL PLUMBING, ELECTRICAL AND MECHANICAL ROUGH-INS MUST BE COMPLETE, INSPECTED AND APPROVED BEFORE REQUESTING THE FRAMING INSPECTION.

CHEMICAL TERMITE TREATMENT

TERMITE TREATING AND PROTECTION TO MEET THE REQUIREMENT OF SECTION R-318 OF THE FLORIDA BUILDING CODE, RESIDENTIAL

R-318 TERMITE PROTECTION SHALL BE PROVIDED BY REGISTERED TERMITICIDES, INCLUDING SOIL APPLIED PESTICIDES, BAITING SYSTEMS, AND PESTICIDES APPLIED TO WOOD, OR OTHER APPROVED METHODS OF TERMITE PROTECTION LABELED FOR USE AS A PREVENTATIVE TREATMENT TO NEW CONSTRUCTION. UPON COMPLETION OF THE APPLICATION OF THE TERMITE PROTECTION TREATMENT, A CERTIFICATE OF COMPLIANCE SHALL BE ISSUED TO THE BUILDING DEPARTMENT BY THE LICENSED PEST CONTROL COMPANY THAT CONTAINS THE FOLLOWING STATEMENT: "THE BUILDING HAS RECEIVED A COMPLETE TREATMENT FOR THE PREVENTION OF SUBTERRANEAN TERMITES. TREATMENT IS IN ACCORDANCE WITH RULES AND LAWS ESTABLISHED BY THE FLORIDA DEPARTMENT OF AGRICULTURE AND CONSUMER SERVICES."

USE REGISTERED TERMITICIDES OR OTHER APPROVED METHODS.

SOIL TREATMENTS FOR SUBTERRANEAN TERMITES:
 4.1. PROTECTION TO BE DONE AFTER ALL EXCAVATION, BACKFILLING AND COMPACTION IS COMPLETE.

DISTURBED SOIL TREATMENT MUST BE RETREATED.

TREATMENT SHALL BE PROTECTED FROM RAINFALL BY 6 MIL VAPOR BARRIERS. IF RAINFALL OCCURS BEFORE BARRIERS PLACEMENT, SOIL MUST BE RETREATED.

PROTECTION SLEEVES AROUND METALLIC PIPING PENETRATING CONCRETE SLAB-ON-SLAB GRADE FLOORS SHALL NOT BE CELLULOSE-CONTAINING MATERIALS AND RECEIVE AN APPLICATION OF TERMITICIDE IN ANNULAR SPACE BETWEEN SLEEVE AND PIPE.

PRESSURE TREATED LUMBER THAT HAS BEEN CUT OR DRILLED THAT EXPOSES UNTREATED PORTIONS OF WOOD ARE REQUIRED TO BE FIELD TREATED.

OPTIONAL BORATE APPLIED TO ALL FRAME MEMBERS WITHIN 24" AFF. OWNER TO VERIFY METHOD OF PROTECTION

METHOD OF TREATMENT SHALL BE APPROVED BY THE GOVERNING AHJ. "LIQUID BORATE OR BOR-A-COR PRODUCT METHODS MUST BE DETERMINED AT PERMIT STAGE AND PRODUCT APPROVAL DATA MUST BE ON FILE WITH THE BUILDING DEPARTMENT.

CARPENTRY

CUTTING OF WOOD STRUCTURAL MEMBERS TO BE IN ACCORDANCE TO F.B.C

ROOF SHEATHING SHALL BE APA RATED SHEATHING. SEE ROOF AND INSULATION SECTION.
INTERIOR NON-BEARING WOOD PARTITIONS SHALL BE 2X4 STUDS AT 16" O.C. UNLESS OTHERWISE NOTED

WITH A SINGLE P.T. SILL AND TOP PLATE BEARING WALLS AS INDICATED ON DRAWINGS.

LUMBER IN CONTACT WITH MASONRY AND SOIL TO BE PRESSURE TREATED.

ROUGH HARDWARE FOR EXTERIOR USE SHALL BE GALVANIZED.

ROOF TRUSSES AND ROOF FRAMING MEMBERS SHALL BE SECURED WITH GALVANIZED METAL HURRICANE ANCHOR STRAPS AS INDICATED ON DRAWINGS. ALL PRODUCTS SHALL HAVE APPROVED FLORIDA

FASCIA TO BE WOOD INTEGRATED WITH SOFFIT

SOFFITS SHALL BE TONGUE AND GROVE WOOD.

PROVIDE DRAFTSTOPPING PER REQUIREMENTS OF F.B.C. R302.12

ROOFING AND INSULATION

PROVIDE MODIFIED BITUMEN ROOF INCLUDING BASE SHEET AND CAP PLY MEMBRANE AS SHOWN ON PLAN ALL ROOF SHEATHING TO BE 1/2" APA RATED SHEATHING WITH EDGE CLIPS 24" O.C. MAX. NO EDGE CLIPS AT ROOF TRUSS

3. PROVIDE FLASHING AT ALL VERTICAL WALL TO ROOF INTERSECTIONS AND ALUMINUM DRIP EDGES AT ROOF PERIMETER. ALL IN ACCORDANCE WITH ASTM D255 OR ASTM D3462

R-38 BLOWN FIBERGLASS OVER LIVING AREAS (ATTIC) WITH BATTS AT VAULT OR INACCESSIBLE AREAS.
 R-13 MIN. FIBERGLASS BATTS AT ALL EXTERIOR FRAME WALLS.

R-6 MIN. AT EXTERIOR BLOCK MASS WALLS PROVIDE ALTERNATE FOR SPRAY FOAM AND/OR BLOCK INJECTION

NO PLUMBING STACKS OR VENT PENETRATIONS ON FRONT SIDE OF ROOF.

TEMPORARY BRACING OF ROOF TRUSS SHALL BE INSTALLED PER BCSI RECOMMENDATIONS AND SHALL BE UTILIZED AS THE PERMANENT BRACING FOR THE ROOF SYSTEM.

DOORS AND WINDOWS

FRONT ENTRY DOOR TO BE FIBERGLASS EXTERIOR DOOR OR APPROVED EQ.

INTERIOR DOORS TO BE 1-3/8". STYLE TO BE SELECTED BY OWNER

BARN DOOR TO BE 42" IN ORDER FOR DOOR TO LAP OVER OPENING. PROVIDE DRYWALL SOFFIT AT HEADER TO PROVIDE SAME AMOUNT OF JAMB LAP.

4. SLIDING GLASS DOOR TO BE ALUMINUM OR VINYL FRAMED INSULATED SLIDING GLASS DOORS. GLASS SHALL BE TEMPERED AND HAVE AN INTEGRAL LOCK. PROVIDE MILL FINISH TRACK.

WINDOWS TO BE ALUMINUM OR VINYL FRAME, INSULATED, ARGON FILLED WINDOWS. PROVIDE TEMPERED WINDOWS AS REQUIRED PER F.B.C. ALL SINGLE HUNG WINDOWS SHALL HAVE INTEGRAL LOCK. PROVIDE

6. NO GARAGE DOORS ARE PART OF THIS PROJECT BUT CARPORT OPENINGS SHALL BE SIZED FOR FUTURE GARAGE DOORS.

7. PROVIDE CONTINUOUS BED OF SEALANT UNDER EXTERIOR DOOR THRESHOLDS AT AT DOORS, WINDOWS, AND OTHER AREAS AS REQUIRED. PROVIDE NECESSARY BACKER ROD PRIOR TO INSTALLATION OF ANY

8. ALL WINDOW AND DOOR FRAME FINISHES SHALL BE SELECTED BY OWNER. ANY DAMAGE TO FINISH SHALL BE FIXED IN FIELD.

9. ALL DOORS AND WINDOWS SHALL BE INSTALLED AND SECURED PER MANUFACTURER'S FLORIDA PRODUCT APPROVAL NOTICE OF ACCEPTANCE

1. SEE ELECTRICAL DRAWING FOR ALL ELECTRICAL NOTES.

AIR CONDITION CONTRACTOR TO PROVIDE ALL PERMITTING DOCUMENTS INCLUDING COMPLETE FLORIDA MODEL ENERGY CODE FORMS PRIOR TO FABRICATION AND INSTALLATION.

2. PROVIDE CENTRAL AIR CONDITIONING AND HEATING SYSTEM.

3. AIR CONDITION CONTRACTOR SHALL VERIFY ALL AHU/COMP LOCATIONS PER MANUFACTURE! RECOMMENDATIONS AND LOCAL BUILDING CODES WITH REGARD TO SPACE REQUIREMENTS FOR SERVICE AND OPERATION

4. DUCT WORK TO BE R-6 FIBERGLASS INSULATED AS REQUIRED WITH SPLITTER DAMPERS AND TURNING

PROVIDE SUPPLY DUCTS TO ALL INHABITABLE SPACES AND WALK-IN CLOSETS

INSULATE REFRIGERATION LINES WITH 1" AP ARMAFLEX RUBBER INSULATION TUBE WITH SHIELD OR EQUAL.

COORDINATE CONDENSATE DRAIN WITH FOUNDATION INSTALLATION.

SET ALL CONDENSING UNITS ON HOUSEKEEPING PAD WITH MINIMUM 18" CLEARANCE ON ALL SIDES. SECURE UNIT TO PAD WITH "L" BRACKETS AND FASTENERS.

PROVIDE SECURITY DRAIN UNDER ALL HORIZONTAL APPLICATION AIR HANDLERS AND/OR EVAPORATION COILS. PANS MUST BE 2" DEEP. GALVANIZED NON-INSULATED.

10. SECURITY DRAIN PANS MUST HAVE AN AUXILIARY LINE TERMINATED TO SEWER WITH MECHANICAL FLOAT SWITCH

11. SUPPLY GRILLES WITH ADJUSTABLE DIFFUSER FACE AND WHITE FINISH.

12. PROVIDE ONE DIGITAL THERMOSTAT PER SYSTEM.

13. PROVIDE MECHANICAL VENTILATION SYSTEM AT ALL BATHROOMS. THE MINIMUM VENTILATION SHALL BE 50 CUBIC FEET PER MINUTE FOR INTERMITTENT VENTILATION OF 26 CUBIC FEET PER MINUTE FOR CONTINUOUS VENTILATION. VENTILATION AIR EXHAUSTED FROM THE SPACE SHALL BE DIRECTED TO THE

WOOD TONGUE AND GROVE WALL SIDING AND SOFFIT FINISH.

PROVIDE 5/8" TYPE X DRYWALL TO GARAGE CEILING.

INTERIOR WALLS SHALL BE 1/2" GYPSUM. FINISH AS SELECTED BY OWNER

WET WALLS SHALL BE 1/2" MOISTURE RESISTANT.

INTERIOR CEILINGS TO BE 1/2" SAG RESISTANT DRYWALL CEILING BOARD OR 5/8" DRYWALL

TILE WALLS SHALL BE 1/2" CEMENT BOARD OR APPROVED EQUAL. APPLY LIQUID APPLIED WATERPROOFING SYSTEM ON ALL CEMENT BOARD PRIOR TO INSTALLING TILE; REDGARD OR APPROVED EQ. WITH REINFORCED FABRIC.

PLUMBING NOTES

SANITARY LINES SHALL BE CAST IRON OR PVC SCHEDULE 40 AS APPROVED BY THE BUILDING OFFICIAL.

WATER SUPPLY LINES SHALL BE COPPER, TYPE "L", OR CPVC AS APPROVED BY LOCAL BUILDING CODES.

PROVIDE HOSE BIBBES PER DIRECTION OF OWNER AND AS IDENTIFIED ON PLANS. ALL CLEANOUTS SHALL BE FLUSH WITH GRADE

GANG ALL STACKS TO FACILITATE THE MINIMUM NUMBER OF ROOF PENETRATIONS AS POSSIBLE.

PLUMBER TO DIVERT ALL ROOF VENTS TO BACK SIDE OF ROOF. SIZE AND LOCATION OF CLEANOUTS SHALL CONFORM TO FLORIDA BUILDING CODE. RESIDENTIAL

FIXTURE SUPPLY SIZES TO CONFIRM WITH FLORIDA BUILDING CODE, RESIDENTIAL.

ALL WATER CLOSETS SHALL BE MAXIMUM FLUSH CAPACITY ALLOWED BY BUILDING CODE 10. PROVIDE ALL SHOWER VALVES WITH BOTH FLOW AND TEMPERATURE CONTROLS. PIPES SHALL BE

CODES AND REFERENCES

FLORIDA BUILDING CODE, RESIDENTIAL SEVENTH EDITION (2020)

CONCRETE

CONSTRUCTION TYPE / CLASSIFICATION ZONING: R-1AA PER EDGEWOOD, FL. ZONING MAP

TO BE MIN 1.5 LBS OF FIBER PER CUBIC YARD.

ALL INTERIOR SLAB FINISHES SHALL BE STEEL TROWEL FINISH.

C90-0601, WITH A MINIMUM NET COMPRESSIVE STRENGTH OF 1900 PSI.

THE MASONRY CELL WITH MIN. 1/2" CLEARANCE TO INSIDE FACE.

MINIMUM COMPRESSIVE STRENGTH AT 28 DAYS OF 3,000 PSI SLUMP 8" TO 11

8. ALL EXTERIOR SLAB FINISHES SHALL BE MEDIUM BROOM FINISH

MORTAR SHALL BE TYPE'S CONFORMING TO ASTM C270-07

OCCUPANCY: R-3 PER FBC CONSTRUCTION TYPE: V; UNPROTECTED PER FBC MAX. HEIGHT: 35 FEET

ALL CONCRETE SHALL HAVE A MINIMUM COMPRESSIVE STRENGTH AT 28 DAYS OF 3,000 PSI

IN PLACE BY USING ADDITIONAL CROSS-REINFORCING TIED TO FOOTING REINFORCIN

2. HORIZONTAL FOOTING BARS SHALL BE BENT 1'-0" AROUND CORNERS OR CORNER BARS WITH A 2'-0" LAP

5. ALL REINFORCING STEEL / STIRRUPS AND TIES SHALL BE NEW DOMESTIC DEFORMED BARS FREE FROM

CONCRETE COVER MIN. 3" WHEN EXPOSED TO EARTH OR 1 1/2" TO FORM U.N.O.
WELDED WIRE FABRIC SHALL CONFORM TO ASTM A-185 / A185M-07. WWM SHALL BE LAPPED AT LEAST 6"

AND CONTAIN AT LEAST ONE CROSS WIRE WITHIN THE 6". POLYPROPYLENE FIBERS FOR SLABS ON GRADE

RUST, SCALE, AND OIL AND SHALL MEET ASTM A615 / A185M-04A, GRADE 40. REINFORCING FOR FOOTING

SHALL BE SUPPORTED ON PRE-CAST CONCRETE PADS, TOP REINFORCING SHALL BE POSITIVELY SUPPORTED BY TEMPORARY STRINGERS. DOWELS FOR COLUMNS AND FILLED CELLS SHALL BE SECURED

IF TIE ANCHORS ARE USED, SIMPSON HIGH STRENGTH EPOXY TIE ANCHORING ADHESIVE SHALL BE USED.

HOLLOW LOAD BEARING UNITS SHALL BE NORMAL WEIGHT, GRADE N, TYPE 2, CONFORMING TO ASTM

COARSE GROUT SHALL CONFORM TO ASTM C476 WITH A MAXIMUM AGGREGATE SIZE OF 3/8" AND A

4. VERTICAL REINFORCEMENT SHALL BE AS NOTED ON THE DRAWINGS WITH THE CELLS FILLED WITH COARSE

VERTICAL REINFORCEMENT SHALL BE HELD IN POSITION AT THE TOP AND BOTTOM AND AT A MAXIMUM SPACING OF 192 DIA OR 10 FT WHICHEVER IS LESS. REINFORCING SHALL BE PLACED IN THE CENTER OF

REINFORCING STEEL CAN BE LAPPED. LAP SHALL BE 25".
TEMPORARY BRACING AND SHORING OF WALL TO PROVIDE STABILITY DURING CONSTRUCTION SHALL BE

8. DO NOT APPLY UNIFORM LOADS TO MASONRY WALLS FOR (3) DAYS AND NO CONCENTRATED LOADS FOR (7

DURING CONCRETE POURS, THE CONTRACTOR SHALL ADEQUATELY VIBRATE THE FILLED CELL WITH

ALL EXTERIOR WOOD STUD WALLS, BEARING WALLS, SHEAR WALLS, AND MISC. STRUCTURAL WOOD

ANY WOOD FRAME INTERIOR BEARING WALL STUDS THAT HAVE HOLES IN THE CENTER OF THE STUD UP TO

VERIFY THAT THE CHEMICALS USED TO TREAT WOOD IS NOT CORROSIVE TO STEEL. FOR EXAMPLE, ACQ-C, ACQ-D, CBA-A OR CA-B REQUIRED HOT-DIPPED GALVANIZED OR STAINLESS STEEL FASTENERS.

ALL EXPOSED WOOD OR WOOD IN CONTACT WITH EARTH OR CONCRETE TO BE PRESSURE TREATED.

8.1. ROOF DECK: 1/2" PLYWOOD C-C/C-D, EXTERIOR OR OSB. OWNER INTENDS TO UTILIZE ZIP SYSTEM BY

9. MINIMUM OF 3 PLY STUD COLUMNS TO BE INSTALLED AT BEAM OR GIRDER TRUSS BEARING LOCATIONS.

WALL SHEATHING: 7/16" PLYWOOD C-C/C-D, EXTERIOR OR OSB. OWNER INTENDS TO UTILIZE ZIP

10. SYP #1 GRADE OR BETTER FASTEN PLYS TOGETHER USING 16d COMMON NAILS 6" O.C. AS EACH MEMBER IS

11. 4 PLY AND/OR LARGER STUD COLUMNS SHALL BE FASTENED TOGETHER AS STATED ABOVE PLUS CS16 COIL
STRAPPING WRAPPED AROUND COLUMN WITH A 4" END CAP AT 16" O.C. OR 1/2" THRU BOLTS AT 24" O.C.

12. INSTALL BLOCKING IN ALL WALL STUDS OVER 8'-0" AT MID-HEIGHT, AND SHEATHING JOINT. BRACE GABLE

14. ALL CONNECTION HARDWARE SHALL BE GALVANIZED AND SUPPLIED BY SIMPSON STRONG TIE CO., OR EQ. ALL NAIL HOLES SHALL BE FILLED OR AS PRESCRIBED BY THE MANUFACTURER.

13. ALL NAILING AND BOLTING SHALL COMPLY WITH AMERICAN INSTITUTE OF TIMBER CONSTRUCTION

REQUIREMENTS. ALL NAILS EXPOSED TO THE EXTERIOR SHALL BE GALVANIZED.

1" DIA. SHALL HAVE STUD PROTECTION SHIELDS. ALL HOLES OVER 1" IN DIA. FOR PLUMBING LINES, ETC.

EITHER RODDING OR PENCIL VIBRATOR TO ENSURE PROPER CONCRETE CONSOLIDATION

UNTREATED WOOD SHALL NOT BE IN DIRECT CONTACT WITH CONCRETE OR MASONRY.

DESIGN HEIGHT: 14'-6" T.O. RIDGE

GROUT AND GRADE 40 STEEL.

8. SHEATHING REQUIREMENTS:

HUBER ENGINEERED WOODS.

SYSTEM BY HUBER ENGINEERED WOODS.

THE RESPONSIBILITY OF THE CONTRACTOR.

FRAMING MEMBERS SHALL BE EITHER #1 SYP OR #2 SPF.

ALL LUMBER SHALL HAVE MOISTURE CONTENT OF 19% OR LESS.

SHALL BE REPAIRED WITH SIMPSON HSS2 STUD SHOES, TYP. U.N.O.

PRESSURE TREATED LUMBER SHALL BE IN ACCORDANCE WITH AWPA U1.

ROOF LOADING: LIVE: 20 PSF DEAD: 17 PSF FOR SHINGLE FLOOR LOADING: LIVE: 40 PSF DEAD: 15 PSF UNINHABITABLE ATTIC: DEAD: 20 PSF

DESIGN CRITERIA

studio1+ AA26003729 EDWARD 'JOE' KNOUS, RA 2733 DONALDSON DRIVE ORLANDO, FL 32812 407-590-0505 JOEKNOUS@STUDIOONEPLUS.COM

EDWARD JOE KNOUS FI REG NO AR97048

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ISLAND HARBOUR 1078

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ORLANDO,

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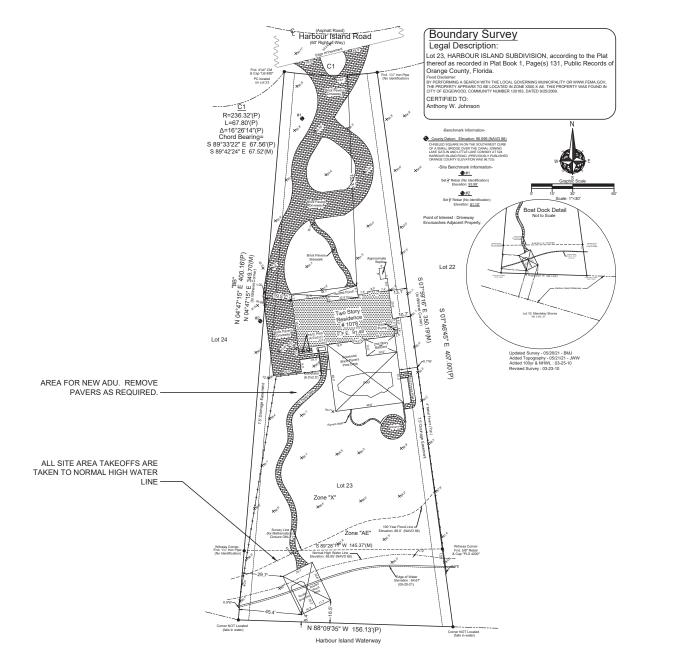
JOB NUMBER 20-079 PROJECT MANAGER DRAWN BY: J. KNOUS J. KNOUS LAST FILED: Frl, 08 Oct 2021 SHEET TITLE: NOTES

CITY OF EDGEWOOD

11/9/2021

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CITY OF EDGEWOOD

EXISTING SITE NOTES

- EXISTING LOT AREA = 54,908 SF PER ORANGE COUNTY
- 1. EXISTING LOT AREA = 94,900 SF PER ORANGE COUNTY
 WEBSITE
 2. ACTUAL MEASURED LOT AREA TO NORMAL HIGH WATER LINE
 = 38,677 SF
 3. EXISTING BUILDING PAD = 2,384 SF
 4. EXISTING POOL DECK = 1,874 SF
 5. EXISTING DRIVEWAY = 5,277 SF

 EXISTING DRIVEWAY = 5,277 SF

- EXISTING WALKWAYS = 1,010 SF EXISTING PADS = 51 SF

- 8. EXISTING FRONT PORCH = 316 SF
 9. EXISTING TOTAL IMPERVIOUS AREA = 10,912 SF
 10. EXISTING ISR = 28% MEASURED TO NHWL

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JOHNSON RESIDENCE 1078 HARBOUR ISLAND ROAD ORLANDO, FL. 32809 AHJ: EDGEWOOD


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JOB NUMBER:	20-079
PROJECT MANAGER:	-
DRAWN BY:	J. KNOUS
APPROVED BY:	J. KNOUS
LAST FILED: Fri, 08 Oct 2021 4: 26pm	
SHEET TITLE:	
EXISTING SITE	PLAN

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EXISTING SITE PLAN

SCALE: 1/32" = 1'-0"



NEW SITE PLAN

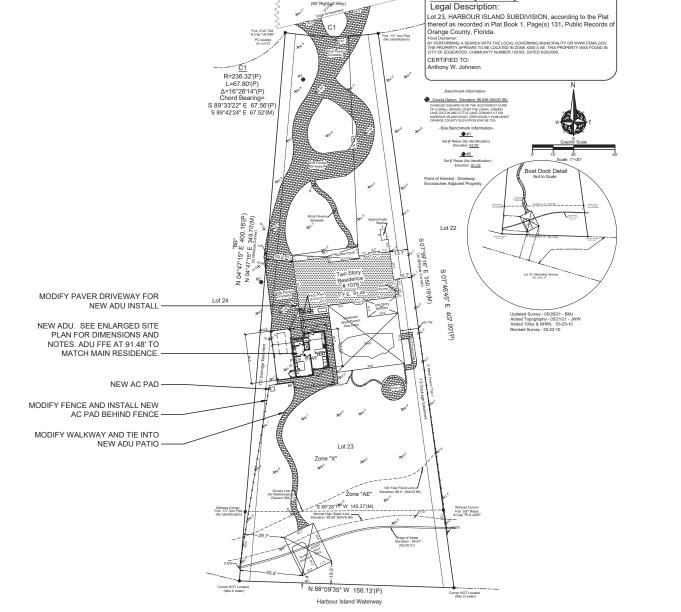SCALE: 1/32" = 1'-0"

Boundary Survey

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CITY OF EDGEWOOD

SITE NOTES

- MIN. LOT AREA: 10.890 SF
- ACTUAL LOT AREA: 54,908 SF LOT AREA MEASURED TO NHWL: 38,677 SF
- MIN. FLOOR AREA: 2,200 SF
- MAX HEIGHT: 35 FEET ACTUAL HEIGHT: 14'-6"
- REAR SETBACK: 50 FEET
- SIDE SETBACK: 10 FEET PRIMARY STRUCTURE, 5 FEET FOR ADU.
- 9. SEPARATION FROM BUILDINGS: 6 FEET 10. FRONT SETBACK: 30 FEET 3. EXISTING BUILDING PAD = 2,384 SF

- EXISTING POOL DECK = 1,874 SF MODIFIED DRIVEWAY = 5,199 SF
- MODIFIED WALKWAYS = 1,588 SF
- EXISTING PADS = 51 SF EXISTING FRONT PORCH = 316 SF
- NEW ADU AC PAD = 9 SF
- NEW ADU BUILDING PAD = 1,215 SF
- 11. TOTAL IMPERVIOUS AREA = 12,636 SF
- 12. ISR = 0.33% MEASURED TO NHWL
- 13 MAX ISR: 0.55
- 14. PROJECT SCOPE: ADD NEW DETACHED STRUCTURE

ALAIR JOHNSON RESIDENCE 3 HARBOUR ISLAND ROAD

EDWARD JOE KNOUS

AR97048

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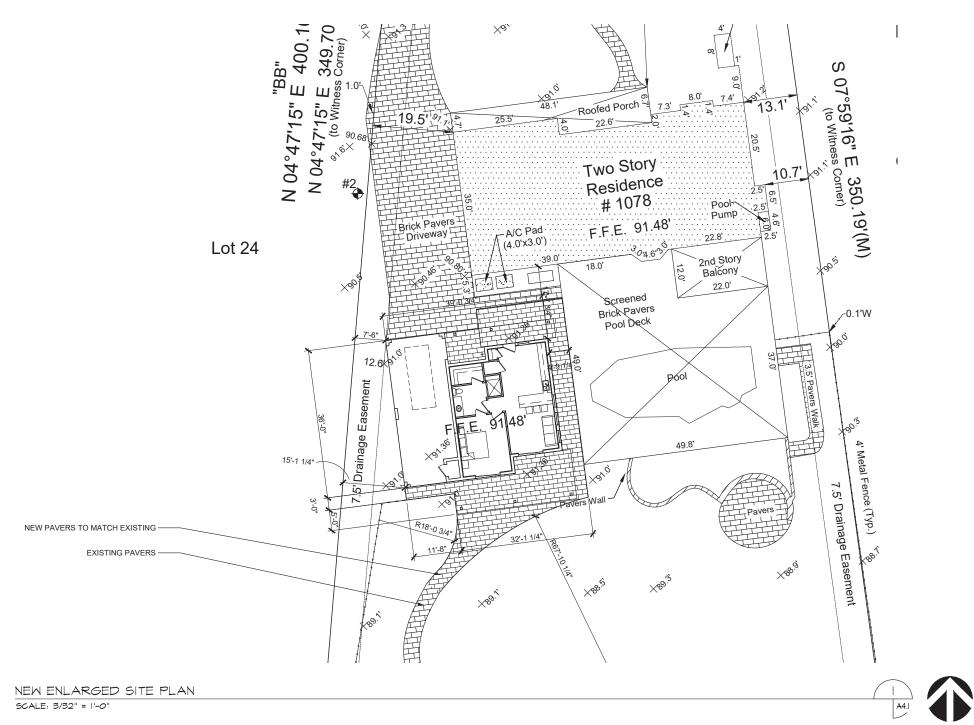
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SHEET TITLE:

NEW SITE PLAN

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NEW ENLARGED SITE PLAN

SCALE: 3/32" = 1'-0"



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JOB NUMBER:	20-07
PROJECT MANAGER:	
DRAWN BY:	J. KNOU
APPROVED BY:	J. KNOU
LAST FILED: Fri, 08 Oct 2021 4: 27pm	
SHEET TITLE:	
NEW ENLARG	ED
SITE PLAN	I

REV. A4.1

- LAPPED 6" AND SEALED. W.W.F. 6 X 6 W1.4 X W1.4. OR FIBERMESH.
- 4" REINFORCED 3000 PSI CONCRETE FOR SLABS.
- 6" REINFORCED 3000 PSI CONCRETE FOR STAIRS.
- REFER TO MANUFACTURER SPECIFICATIONS PRIOR TO POURING OR RECESSING DOOR SILLS.
- EXTERIOR PORCHES TO SLOPE AWAY FROM HOUSE AS INDICATED ON PLANS.
- EXTERIOR HOUSEKEEPING AC PAD TO SLOPE 1/2" PER FOOT AWAY FROM HOUSE
- ALL FILL TO BE FREE OF ORGANIC MATERIAL AND COHESIVE SOILS, COMPACTED IN 12" LIFTS TO 95% OF MAX, DRY DENSITY AS DETERMINED BY ASTM-1557 ■ INDICATES FILLED CELL WITH 3,000 PSI CONC. FROM FOUNDATION TO BEAM WITH (1) #5 REBAR
- TYPICAL ABOVE SLAB. HOOKED FTG. DOWELS 6" EMBEDMENT WITH 25" EXTENSION ABOVE SLAB. FILLED CELLS TO BE PLACED AT EACH CORNER, END OF INDICATED BRG. WALLS, EACH SIDE OF ALL OPENINGS, UNDER GIRDER TRUSSES (FLOOR AND ROOF), AND 48" O.C. MAX.
- 10. CONTROL JOINTS ARE NOT REQUIRED BY CODE BUT ARE SUGGESTED (ESPECIALLY WHEN USING FIBER REINFOR. CONCRETE OR IN EXTERIOR CONDITIONS). CONTROL JOINTS TO BE 1/8" SAW CUT A DEPTH OF 1/4 OF THE THICKNESS OF THE SLAB. FILL CUT W/ APPROVED JOINT MATERIAL.

UPLIFT CONNECTORS

UPLIFT CONNECTORS SUCH AS HURRICANE CLIPS, TRUSS ANCHORS, AND ANCHOR BOLTS ARE ONLY REQUIRED ON MEMBERS IN WALLS THAT ARE EXPOSED TO UPLIFT OR LATERAL FORCES. INTERIOR LOAD BEARING WALLS ARE NOT ALWAYS EXPOSED TO UPLIFT FORCES. THE MEMBERS OF THESE WALLS WOULD NOT NEED TO HAVE CONNECTORS APPLIED. COORDINATE WITH THE TRUSS ENGINEER AND PLANS FOR THE LOCATION OF THESE WALLS.

CAST IN PLACE REINFORCED CONCRETE

- ALL CONCRETE SHALL HAVE A MINIMUM COMPRESSIVE STRNGTH AT 28 DAYS OF 3,000 PSI. HORIZONTAL FOOTING BARS SHALL BE BENT 1'-0" AROUND CORNERS OR CORNER BARS WITH A 2'-0" LAP PROVIDED
- CONCRETE COVER MIN. 3" WHEN EXPOSED TO EARTH OR 1 1/2" TO FORM U.N.O.
- WELDED WIRE FABRIC SHALL CONFORM TO ASTM A-185 / A185M-07. WWM SHALL BE LAPPED AT LEAST 6" AND CONTAIN AT LEAST ONE CROSS WIRE WITHIN THE 6". POLYPROPYLENE FIBERS FOR SLABS ON GRADE TO BE MIN 1.5 LBS OF FIBER PER CUBIC YARD.
- ALL REINFORCING STEEL / STIRRUPS AND TIES SHALL BE NEW DOMESTIC DEFORMED BARS FREE FROM RUST, SCALE, AND OIL AND SHALL MEET ASTM A615 / A185M-04A. REINFORCING FOR FOOTING SHALL BE SUPPORTED ON PRE-CAST CONCRETE PADS, TOP REINFORCING SHALL BE POSITIVELY SUPPORTED BY TEMPORARY STRINGERS. DOWELS FOR COLUMNS AND FILLED CELLS SHALL BE SECURED IN PLACE BY USING ADDITIONAL CROSS-REINFORCING TIED TO FOOTING REINFORCING.
- IF TIE ANCHORS ARE USED, SIMPSON HIGH STRENGTH EPOXY TIE ANCHORING ADHESIVE SHALL BE

MISSED DOWELS/ANCHORS

- MISSED J BOLTS FOR WOOD BEARING WALLS MAY BE SUBSTITUTED WITH 1/2" DIA. EPOXY ANCHORS WITH 7" EMBEDMENT. SIMPSON "SET" EPOXY ADHESIVE BINDER FOLLOWING ALL MANUFACTURER'S RECOMMENDATION OR SIMPSON 1/2" TITEN HD BOLTS WITH MINIMUM 7" EMBEDMENT. SEE PLAN FOR EMBEDMENT DEPTH AT FLOOR STEPS.
- FOR MISSED VERT. DOWELS, DRILL A 3/4" DIA. HOLE 6" DEEP AT THE LOCATION OF THE OMITTED REBAR AND INSTALL A 32" LONG #5 BAR INTO THE EPOXY FILLED HOLE. USE A TWO PART EMBEDMENT EPOXY (SIMPSON HIGH STRENGTH EPOXY TIE ANCHORING ADHESIVE) MIXED PER THE MANUFACTURER'S INSTRUCTIONS. ASSURE THAT ALL DUST AND DEBRIS FROM DRILLING ARE REMOVED FROM THE HOLE BY BRUSHING AND USING COMPRESSED AIR PRIOR TO APPLYING THE EPOXY. ALL THE EPOXY TO CURE TO THE MANUFACTURER'S SPECIFICATIONS.
- FOR MORTAR JOINTS INSTALLED THAT ARE LESS THAN 1/4", PROVIDE (1) #5 VERT. IN CONC. FILLED CELL EACH SIDE OF THE JOINT (BAR DOES NOT HAVE TO BE CONT. TO FOOTING).
 4. INTERIOR BEARING WALL: (IN ADDITION TO THE GENERAL PLACEMENT REQUIREMENTS) 5/8" DIA. X 6"
- EMBEDMENT SIMPSON TITÈN HD ANCHORS SPACED A MAXIMUM OF 48" O.C. IF RESISTING UPLIFT LOADS OR 3 1/2" EMBEDMENT AT 48" O.C. IF RESISTING GRAVITY LOADS.
- EXTERIOR BEARING WALL: (IN ADDITION TO THE GENERAL PLACEMENT REQUIREMENTS) 5/8" DIA. X 6" EMBEDMENT SIMPSON TITEN HD ANCHORS SPACED A MAXIMUM OF 24" O.C.

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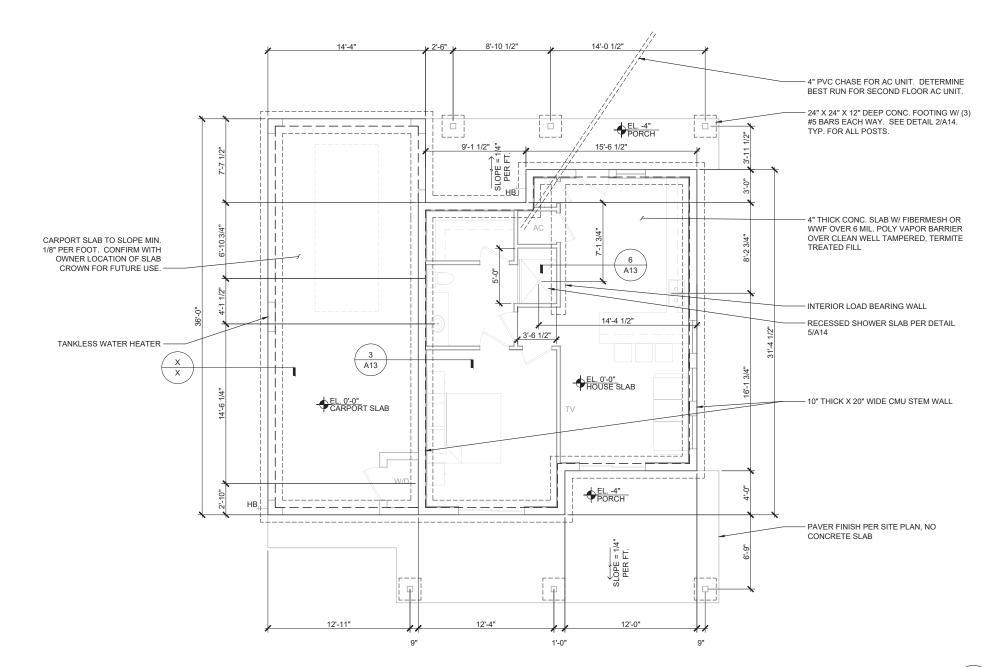
EDGE

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FOUNDATION PLAN

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FOUNDATION PLAN SCALE: 1/4" = 1'-0"

F 18.8 F 18.1 SF 17.6 E 2 (EDGE) F 19.4 F 18.8 F 18.1	-21.0 -20.0 -18.0 -17.0 -24.0 -23.0 -22.0	
F 19.4 F 18.8 F 18.1 ISF 17.6 E 2 (EDGE) F 19.4 F 18.8 F 18.1	-20.0 -18.0 -17.0 -24.0 -23.0	
F 18.8 F 18.1 SF 17.6 E 2 (EDGE) F 19.4 F 18.8 F 18.1	-20.0 -18.0 -17.0 -24.0 -23.0	
F 18.1 SF 17.6 E 2 (EDGE) F 19.4 F 18.8 F 18.1	-18.0 -17.0 -24.0 -23.0	
F 17.6 E 2 (EDGE) F 19.4 F 18.8 F 18.1	-17.0 -24.0 -23.0	
E 2 (EDGE) F 19.4 F 18.8 F 18.1	-24.0 -23.0	
F 19.4 F 18.8 F 18.1	-23.0	
F 18.8 F 18.1	-23.0	
F 18.1		
	-22.0	
SF 17.6	-21.0	
ZONE 3 (CORNER)		
F 19.4	-24.0	
F 18.8	-23.0	
F 18.1	-22.0	
SF 17.6	-21.0	
E 5 (CORNER)		
	-28.0	
20.2	-26.0	
19.0	-23.0	
- 10.0	-22.0	
r 18.0	-17.0	
	= 20.2 = 19.0 &F 18.0	

PLYWOOD SHEATHING NOTES

- 1. EXTERIOR FASTENING SCHEDULE:

- NAIL SIZE: 8d VERTICAL SPACING: 6" O.C. HORIZONTAL SPACING: 6" O.C.
- 1.3. HORIZONTAL SPACING: 6" O.C.
 1.4. FIELD SPACING: 12" O.C.
 2. EXTERIOR GABLE END FASTENING SCHEDULE:
 2.1. NAIL SIZE: 8d
 2.2. VERTICAL SPACING: 4" O.C.
 2.3. HORIZONTAL SPACING: 4" O.C.
 2.4. FIELD SPACING: 8" O.C.
 3. PROVIDE BLOCKING AT ALL SHEATHING EDGES

GENERAL NOTES

- ALL HABITABLE ROOMS TO MEET THE MINIMUM LIGHT AND VENTILATION REQUIREMENTS OF FLORIDA BUILDING CODE-RESIDENTIAL. SECTION R303.
- 2. ALL WALL DIMENSIONS ARE SHOWN FROM FACE OF STUD OR CMU. STUDS SHALL BE
- 16" O.C. WALL INSULATION R-6.
- VERIFY CABINET SIZES AND ROUGH OPENINGS WITH STUD LAYOUT. COORDINATE WITH OWNER LOCATION OF ALL INTERIOR FINISHES.
- CEILING HEIGHT VARIES.

PRECAST LINTEL SCHEDULE								
MARK	SIZE	REBAR IN LINTEL	REBAR IN KO	MASONRY OPENING	CONFIGURATION			
L-1	8"x8"	#5	-	11'-8"	FILLED PRECAST			
L-2	8"x8"	#5	-	5'-1 1/2"	FILLED PRECAST			
L-3	8"x8"	#5	-	3'-0"	FILLED PRECAST			
L-4	8"x8"	#5	-	2'-8"	FILLED PRECAST			
L-5	8"x8"	#5	-	6'-0"	FILLED PRECAST			
L-6	8"x8"	#5	-	8'-10"	FILLED PRECAST			
L-7	8"x16"	#5	#5	15'-4"	FILLED PRECAST AND PRESTRESSED W/ FILLED KO ABOVE			

NOTE: LINTEL SCHEDULE IS BASED ON WINDOW OPENING. CONTRACTOR SHALL FIELD VERIFY BLOCK

COURSING AS LINTEL SIZE MAY BE REQUIRED TO BE LONGER FOR BLOCK COURSING.

GARAGE DOOR NOTE

GARAGE DOORS CONNECTED TO HOUSE SHALL BE 1-3/8" SOLID WOOD DOOR, 1-3/8" SOLID OR HONEYCOMB CORE STEEL DOOR, OR 20-MINUTE RATED DOOR. PROVIDE SELF CLOSING DEVICE.

		CONNECTO		
CONNECTOR	UPLIFT	ALLOWABLE LOADS (LATERAL)	FASTENERS	NOTES
A23	-	715/565 (DF/SP)	10d X 1 1/2"	
A33	-	800/330 (DF/SP)	10d	
ABU66Z	2,475	18,205 (DOWN)	0.162 X 3.5"	
H1	480	510/190 (DF/SP)	0.131	
H2.5A	565	110 (DF/SP)	0.131	
H3	400	210/170 (DF/SP)	0.131	
H6	1,230	-	0.131	
H8	780	90 (DF/SP)	0.148	
H10A	1,040	(DF/SP)	0.148 X 1 1/2"	
H10A-2	1,080	(DF/SP)	0.148 X 1 1/2"	
H10S	910	660/215 (DF/SP)	0.131 X 1 1/2"	
HETA -20	1,810	-	(9) #10	
HD3B	1,895	1,610 (SPF/HF)	5/8"	1 1/2" WOOD MEMBER THICKNESS
	2,525	2,145 (SPF/HF)	5/8"	2 1/2" WOOD MEMBER THICKNESS
	3,130	3,050 (SPF/HF)	5/8"	3" WOOD MEMBER THICKNESS
	3,130	3,050 (SPF/HF)	5/8"	3 1/2" WOOD MEMBER THICKNESS
HGA10	605	500/720 (DF/SP)	1/4" X 1.5" SDS	
HGA10KT	650	1,165/940 (DF/SP)	1/4" X 1.5" SDS	
HGUS26-2	1,725	-	SD10212	SD SCREWS
HGUS28-3	3,235		0.162 X 3.5"	
HTS16	1,260	-	10d	
HTS20	1,450	_	10d	
HTT4	-,100	3,000 (DF/SP)	10d X 1 1/2"	1 1/2" X 5 1/2" WOOD MEMBER SIZE
HUC212-2	1,135	1,805 (DF/SP)	10d	
HUS26	1,320	(DF/SP)	0.162 X 3 1/2"	
LTS12	660	(DF/SP)	0.148" X 3"	
LTS16	660	(DF/SP)	0.148" X 3"	
LUS24	435	(DF/SP)	0.148" X 3"	
MPB66Z		3,545	1/4"x2.5"	ROTATIONAL STIFFNESS: 2,405,00
	5,815			ROTATIONAL STIFFNESS. 2,405,00
MBHA 3.56/16	3,475	5,330 (DF)	10d X 1 1/2"	
MSTA24	1,640	1,455 (SPF/HF)	10d	
MSTAMOS	2,050	2,050 (SPF/HF)	10d	
MSTAM36	1,870	-	10d	
MTS12	1,000	-	10d X 1 1/2"	
MTS18	1,000	-	10d X 1 1/2"	
SP1	585	535 (SPF/HF)	10d	
SP2	1,065	605 (SPF/HF)	10d	
SP4	825	-	#10	
SP8	930	-	#10	
SS1.5	-	500 (COMPRESSION)	10d X 1 1/2"	
SS3	-	665 (COMPRESSION)	10d	
PSC	-	-	-	SIZE BASED ON PLYWOOD

CONNECTOR SCHEDULE

CONTRACTOR SHALL REFER TO TRUSS PACKAGE FOR ENGINEERED UPLIFT VALUES. SIMPSON DEVICE SHALL MEET THE MINIMUM UPLIFT VALUE IDENTIFIED ON THE TRUSS PACKAGE. LARGEST UPLIFT VALUE IS 1,977 ON TRUSS #24, SIMPSON MSTA36 STRAP.

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JOB NUMBER:

PROJECT MANAGER: DRAWN BY:

FLOOR PLAN -

20-079

J. KNOUS

J. KNOUS

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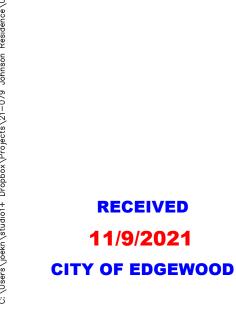
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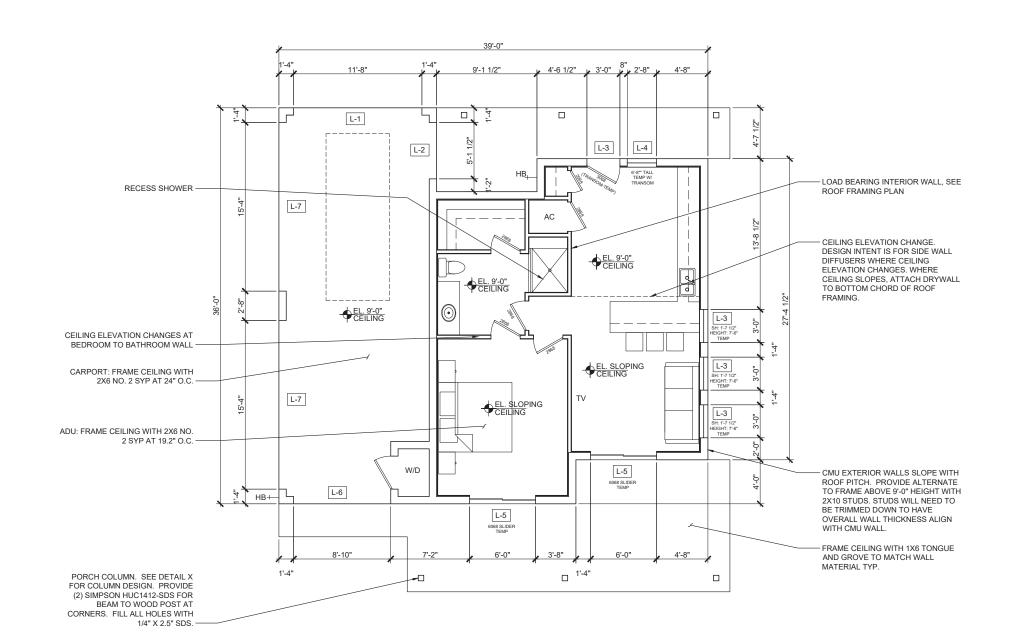
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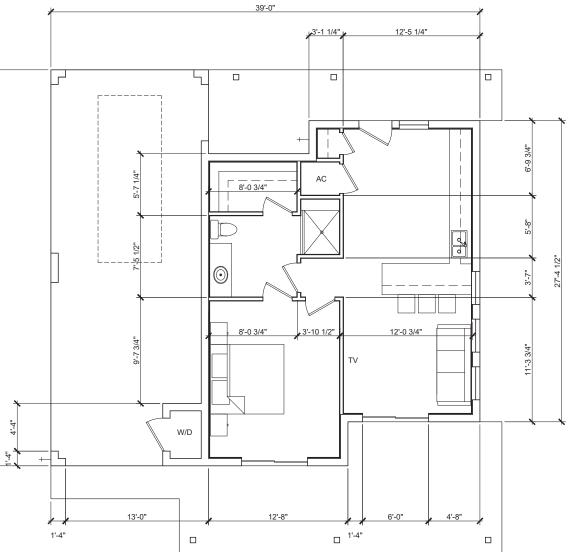
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FLOOR PLAN



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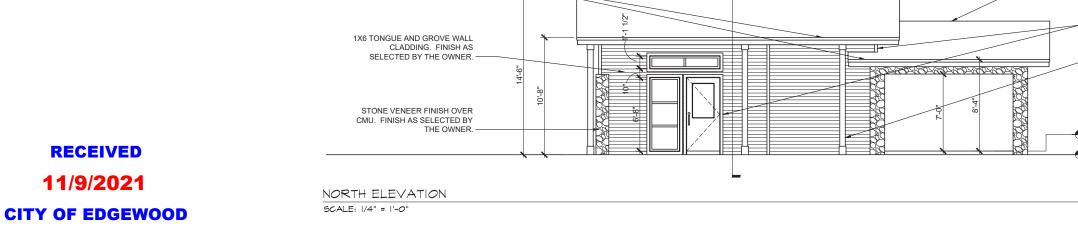
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> J. KNOUS J. KNOUS

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DIMENSION FLOOR PLAN



CONTRACTOR TO PROVIDE SLOPED CAST IN PLACE BOND BEAM, TYP. ON 1X6 NON-VENTED TONGUE AND GROVE SOFFIT TO MATCH WALL CLADDING. CONTRACTOR SHALL CONFIRM DIRECTION OF SOFFIT T&G DIRECTION. - 3" WIDE TRIM AROUND ALL OPENINGS AND AT WALL CORNERS 1X6 TONGUE AND GROVE WALL CLADDING. FINISH AS SELECTED BY THE OWNER. WRAP COLUMNS IN 1X TRIM AND PROVIDE BASE AND CAP WRAP. FINISH TO MATCH WALL CLADDING. STONE VENEER FINISH OVER CMU. FINISH AS SELECTED BY THE OWNER. SOUTH ELEVATION SCALE: 1/4" = 1'-0"

SEAMLESS GUTTERS AT LOW

SIDE OF ROOF

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MODIFIED BITUMEN ROOF

AND AT WALL CORNERS

3" WIDE TRIM AROUND ALL OPENINGS

PROVIDE BASE AND CAP WRAP. FINISH


WRAP COLUMNS IN 1X TRIM AND

TO MATCH WALL CLADDING.

JOB NUMBER: 20-079 PROJECT MANAGER: DRAWN BY: J. KNOUS APPROVED BY: J. KNOUS LAST FILED: Fri, 08 Oct 2021 4: 27pm SHEET TITLE: ELEVATIONS REV.


Alo

A10

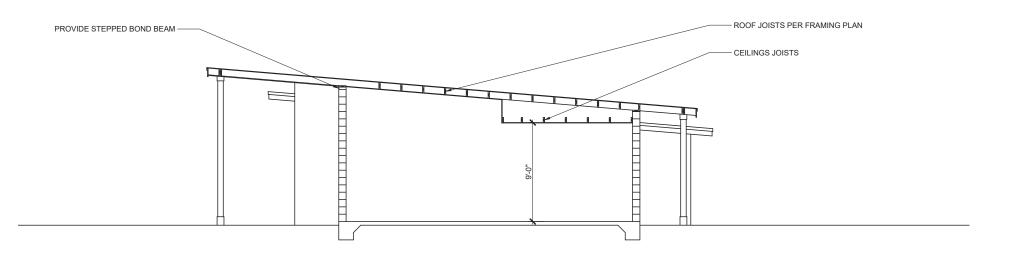

NORTH/SOUTH SECTION

SCALE: 1/4" = 1'-0"

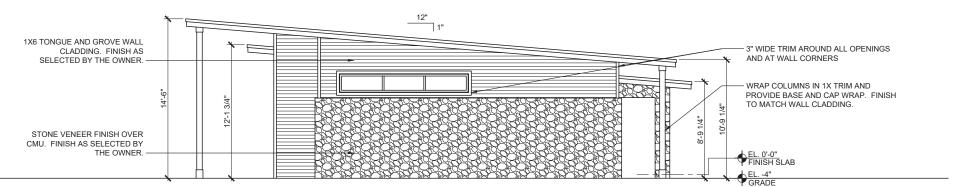

RECEIVED 11/9/2021 **CITY OF EDGEWOOD**

WEST ELEVATION SCALE: 1/4" = 1'-0"

PROJECT MANAGER: DRAWN BY: APPROVED BY: LAST FILED: Fri, 08 Oct 2021 4: 27pm SHEET TITLE:

JOB NUMBER:

ELEVATIONS

20-079

J. KNOUS

J. KNOUS

REV.

ISSUED FOR

10/08/2021 PERMITTING

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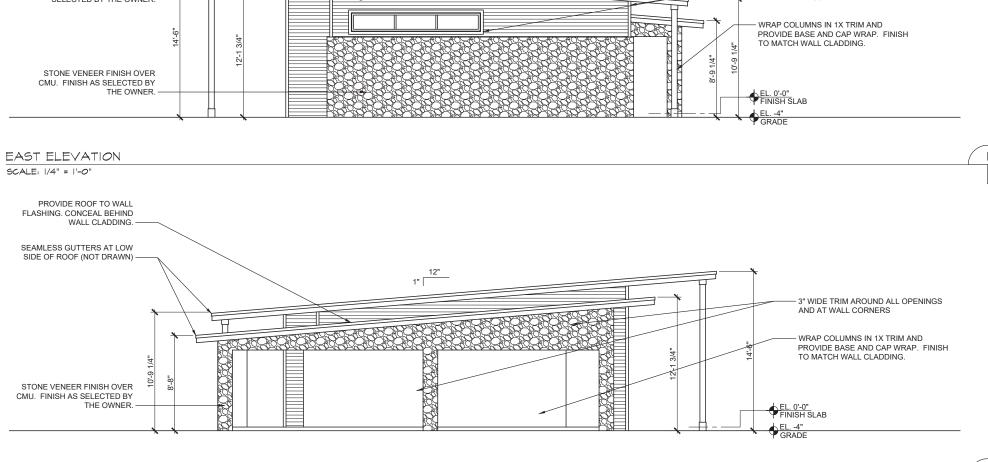
JOHNSON RESIDENCE 1078 HARBOUR ISLAND ROAD

ORLANDO, FL. 3280 AHJ: EDGEWOOD

AR97048

FL REG. NO.:

A11



11/9/2021

CITY OF EDGEWOOD

GENERAL NOTES:

REFER TO A15 FOR WALL DETAILS.
 SIMPSON TITEN HD SECURING 2X SOLE PLATE SHALL BE SPACED 48" O.C., 12" FROM CORNERS, AND 12" FROM SOLE PLATE SPLICES.

studio 1

ARCHITECT: studio1+ AA26003729 EDWARD 'JOE' KNOUS, RA 2733 DONALDSON DRIVE ORLANDO, FL 32812 407-590-0505 JOEKNOUS@STUDIOONEPLUS.COM

SEAL

NAME: EDWARD JOE KNOUS
FL REG. NO.: AR97048

ONSULTANTS

A L A I R

JOHNSON RESIDENCE 1078 HARBOUR ISLAND ROAD ORLANDO, FL. 32809 AHJ: EDGEWOOD

LOCATION

DATE ISSUED FOR 10/08/2021 PERMITTING

JOB NUMBER: 20-079
PROJECT MANAGER: -DRAWN BY: J. KNOUS
APPROVED BY: J. KNOUS
LAST FILED:
Fri, 08 Oct 2021
4:280m

4: 28pm SHEET TITLE:

EXT. WALLS SECTIONS

SHEET NUMBER:

A12

REV.

CEILING JOISTS PER FRAMING PLAN.
SECURE TRUSS TO TOP PLATE WITH FIBERGLASS SHINGLES
WEATHER MEMBRANE OVER 1/2" SIMPSON H1, FILL ALL HOLES WITH 8d NAILS. APA RATED SHEATHING WITH SIMPSON PSC EDGE CLIPS. *SEE ROOF PLAN FOR ROOF SLOPE. - R-38 INSULATION PRE-FINISHED ALUM. DRIP EDGE CEILING JOISTS PER FRAMING PLAN. ATTACH TO ROOF JOISTS WITH (3) 16d OVER 1x CONT. NAILER OVER 1X SUB FASCIA NAILS OR TOENAIL TO SILL PLATE PROVIDE WOOD TRIM AT SOFFIT - 1/2" SAG RESISTANT CEILING BOARD TO FASCIA LINE OR 5/8" GYPSUM NON VENTED TONGUE AND - CONT. 2x8 P.T. SILL PLATE **GROVE SOFFIT** BOND BEAM FULLY GROUTED WITH PROVIDE WOOD TRIM AT SOFFIT TO WALL LINE 5/8" DIA. ANCHOR BOLT 6" FROM EDGE AND 32" O.C. W/3x3x1/8" WASHER -WALL SIDING PER ELEVATIONS -- (1) #5 BAR IN FILLED CELL. SEE FOUNDATION PLAN. 3/4" RIGID INSULATION -- W.W.F. 6X6 W1.4XW1.4 OR FIBER REINFORCED - 4" 3,000 PSI CONCRETE SLAB ON CLEAN COMPACT FILL IN MAX 12" 1X2 FURRING STRIPS 16" O.C. -LIFTS. TERMITE TREAT. 1X4 PT BASE NAILER 1/2" ABOVE SLAB T.O.S. - 6 MIL VAPOR BARRIER - #5 CONT. AT SLAB LEVEL 25" LAP IN BARS - 8" CMU WITH 3,000 PSI FILL - #5 WITH STANDARD 90 DEGREE HOOK, EMBEDDED A MIN. OF 6". - (3) #5 CONT.

WINDOW. SEE PLAN AND
ELEVATIONS FOR HEAD HEIGHT
AND SILL HEIGHT.

WINDOW OPENING EACH SIDE:
PROVIDE VERTICAL 1X4 BLOCKING
ON EACH SIDE:
ON EACH SIDE:
PRECAST FLUSH SILL

WOOD BLOCKING AND INTERIOR
FINISHED SILL

1/2 DRYWALL

3/4" RIGID INSULATION
1/2 PURRING STRIPS 16" O.C.
1/2 PURRING STRIPS 16" O.C.
1/2 PURRING STRIPS 16" O.C.
1/4 PT BASE NAILER 1/2" ABOVE SLAB

T.O.S.

SEE FOUNDATION PLAN AND DETAILS
FOR ADDITIONAL INFORMATION.

NOTE:
1. SEE WALL SECTION 1/A12 FOR ADDITIONAL INFORMATION.

EXT. WALL SECTION

SCALE: 3/4" = I'-O"

Al2

EXT. WALL SECTION AT WINDOW

Al2

CITY OF EDGEWOOD

- 25" LAP IN BARS - W.W.F. 6X6 W1.4XW1.4 OR FIBER 4" 3.000 PSI CONCRETE SLAB ON CLEAN COMPACT FILL IN MAX 12" LIFTS TERMITE TREAT GRADE 6 MIL VAPOR BARRIER #5 CONT. AT SLAB LEVEL 10" X 20" CONT CONCRETE FOOTER, 3,000 8" CMU WITH 3,000 PSI FILL #5 WITH STANDARD 90 DEGREE HOOK, EMBEDDED A MIN. OF 6". (2) #5 CONT.

- SPECIFIC TYP. STEM WALL NOTES:

 1. VERTICAL REINF. IN SOLID GROUTED CELLS AT ALL CORNERS AND PER DOWEL PLAN. REINF. AT CORNER FOOTINGS SHALL BE L SHAPE AND EXTEND 25" IN BOTH
- DIRECTIONS TO TIE TO CONT. REINF.
- 3. ALL EXTERIOR FOOTINGS (BOTTOM OF FOOTING) SHALL BE PLACED AT LEAST 12" BELOW THE UNDISTURBED GROUND SURFACE.



- 6" SLAB. SIZE TO EXTEND BEYOND UNITS - WWF OR FIBER REINFORCED

GENERAL NOTES:

PLATE SPLICES.

REFER TO A15 FOR WALL DETAILS. SIMPSON TITEN HD SECURING 2X SOLE PLATE SHALL BE SPACED 48" O.C., 12"

FROM CORNERS, AND 12" FROM SOLE


4" 3,000 PSI CONCRETE SLAB ON CLEAN COMPACT FILL IN MAX 12" LIFTS. TERMITE TREAT.


AC HOUSEKEEPING PAD 2 Al3


SCALE: 3/4" = 1'-0" W.W.F. OR FIBER REINFORCED SEE 2/A10

PAVER PORCH/LANAI - 6 MIL VAPOR BARRIER #5 CONT. AT SLAB LEVEL 8" CMU WITH 3.000 PSI FILL 10" X 20" CONT. CONCRETE FOOTER, 3,000 PSI #5 WITH STANDARD 90 DEGREE HOOK, EMBEDDED A MIN. OF 6". - (3) #5 CONT. 3 BEARING WALL STEP DOWN PORCH/LANAI

SCALE: 3/4" = 1'-0"

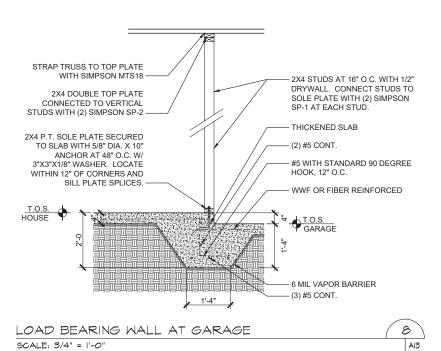

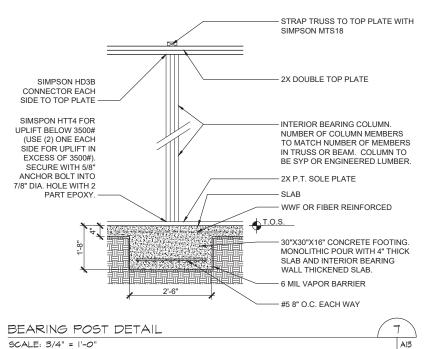

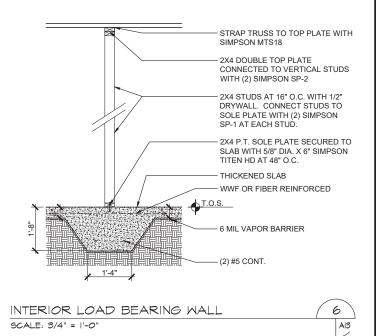



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EDWARD JOE KNOUS FL REG. NO. AR97048

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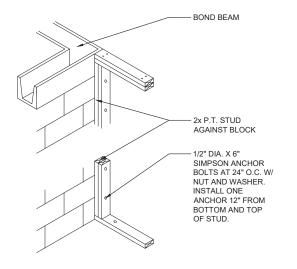
HARBOUR ORLANDO, 1078

EDGEWOOD

ISSUED FOR 10/08/2021 PERMITTING

JOB NUMBER: 20-079 PROJECT MANAGER: DRAWN BY: J. KNOUS APPROVED BY J. KNOUS LAST FILED: Fri, 08 Oct 2021 SHEET TITLE: DETAILS -FOUNDATION REV.

A13




NOT ALL FASTENING INFORMATION SHOWN ON THIS DETAIL. REFER TO A15 FOR ADDITIONAL STUD WALL FRAMING INFORMATION.

1/2" DIA. X 6" SIMPSON ANCHOR BOLTS AT 24" O.C. W/ NUT AND WASHER. INSTALL ONE ANCHOR 12" FROM BOTTOM AND TOP OF SIMPSON H3 WITH (8)-8d NAILS AT SOLE PLATE AND TOP PLATE SECURED TO VERTICAL STUD. 2x P.T. STUD AGAINST BLOCK - REINFORCED CELL

 STUD PLACEMENT TO BLOCK SHALL BE PER FLOOR PLAN. ILLUSTRATION ABOVE IS FOR GENERAL DETAILING.

GARAGE DOOR FRAMING

SCALE: NTS

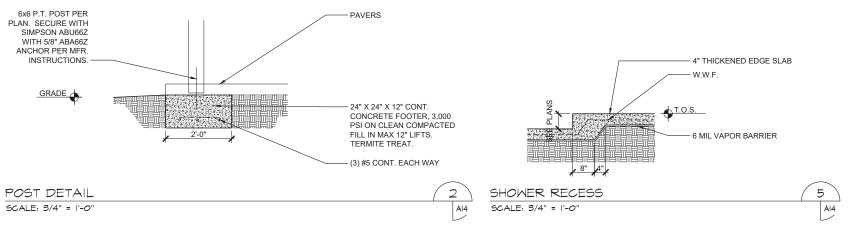

CORNER REINFORCEMENT SCALE: |" = |'-0"

GENERAL NOTES:

LAP SPLICE

STANDARD BEND

BEND

- #5 CONT.

CELL

- #5 CONT.

BOTH DIRECTIONS

"A"

BAR

Al4

PLATE SPLICES.

REFER TO A15 FOR WALL DETAILS.

REBAR LAP SPLICING DETAIL

REQUIRED LAP SPLICE, EMBEDMENT, AND HOOKED REINFORCING STEEL (INCHES)

GRADE 40

HOOKED SIZE DIA. EMBEDDED LENGTH SPLICE

#5 CORNER BAR WITH 25" LAP IN

#5 CORNER BAR WITH ACI STD.

6

Al4

9


Al4

HOOK IN CONCRETE FILLED

EMBEDDED

STANDARD HOOK

#5 = 2-1/2"

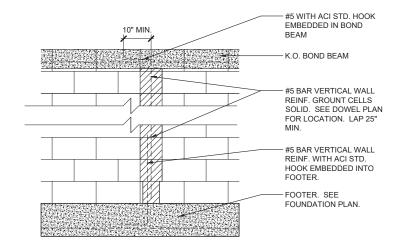

MAONRY WALL REINFORCED CELL DETAIL SCALE: 3/4" = 1'-0"

SIMPSON TITEN HD SECURING 2X SOLE PLATE SHALL BE SPACED 48" O.C., 12" RCHITECT: studio1+ AA26003729 EDWARD 'JOE' KNOUS, RA 2733 DONALDSON DRIVE ORLANDO, FL 32812 FROM CORNERS, AND 12" FROM SOLE

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ALAIR

I RESIDENCE JR ISLAND ROAD ORLANDO, FL. 3280 AHJ: EDGEWOOD HARBOUR 1078

ISSUED FOR 10/08/2021 PERMITTING

JOB NUMBER: 20-079 PROJECT MANAGER: DRAWN BY: J. KNOUS APPROVED BY: J. KNOUS LAST FILED: Frl, 08 Oct 2021 4: 28pm SHEET TITLE: DETAILS

REV.

CITY OF EDGEWOOD


RECEIVED


11/9/2021

A14



HEADER SUPPORT NO. OF JACKS AND STUDS REQ. AT OPENINGS						
OPENING SIZE	2x4 WALL					
OI ENITO OIZE	JACKS EA. END	KINGS EA. END				
1'-0" - 3'-11"	1	1				
4'-0" - 10'-5"	2	1				
10'-6"-16-0"	2	2				

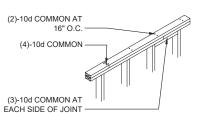

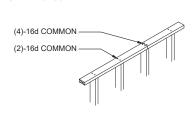

WHERE NOTCH OR BORE IS GREATER THAN 50 PERCENT OF THE PLATE WIDTH, PROVIDE 16 GAUGE X 1.5" WIDE METAL TIE FASTENED ACROSS AND TO THE PLATE AT EACH SIDE OF THE NOTCH WITH 8-10d NAILS EACH SIDE.

TOP PLATE FASTENERS

MIN. 1x4 TRUSS BRACING

PRE-ENGINEERED WOOD TRUSS (2)-12d AT EACH TRUSS

3

SIMPSON A23 EVERY 4'-0" O.C.

SECURE WITH (8) 10d NAILS.

GENERAL WOOD ATTACHMENT DETAILS

SCALE: 1/2" = 1'-0"

SCALE: 1/2" = 1'-0"


OVERLAP TRUSS BRACING AT LEAST

ONE TRUSS SPACE

TRUSS BRACING OVERLAP

SIMPSON H6. FILL ALL HOLES WITH 8d COMMON. - 16d COMMON AT 16" O.C. 5/8" DIA X - (2)-3/4" DIA. THRU BOLTS 6" SIMPSON TITEN HD 5/8" DIA. X 6" SIMPSON TITEN HD 12" FROM CORNERS AND SPLICES 4 STUD CORNER - STRAPPING INFORMATION (2)-8d COMMON

(2)-10d COMMON AT 16"

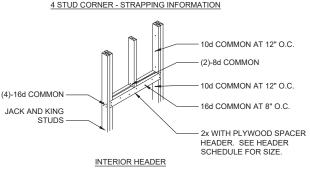

SIMPSON SP4

DOUBLE 2x TOP PLATE

SIMPSON MSTA24 -

SIMPSON A33. FILL

SCALE: 1/2" = 1'-0"

2x4 CROSS BRACE ACROSS 4 BAYS STARTING 4'-0" FROM

AT CROSSING WITH 45 DEGREE ANGLE. NOT REQUIRED.

WHEN GABLE IS LESS THAN 4'-1" OR SHORTER


2x4 BLOCKING BETWEEN TRUSSES AT 48" O.C.

RIDGE AND 48" O.C. AFTER. NAIL WITH (3) 10d AT EACH END

- 2x4 CONT. RAT RUN TO TRUSS WITH (2) 12d AT EACH TRUSS. SPAN 4 TRUSS BAYS.

ALL HOLES WITH

SIMPSON SP1

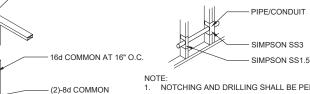

- (5)-10d COMMON

4 STUD CORNER

2x CRIPPLE STUDS AT 16" O.C.

2x.IACK STUDS

- 2x STUDS AT 16" O.C. - 2x SILL AT WINDOW

HEADER. SEE HEADER SCHEDULE

(2) FULL HEIGHT STUDS AT JAMBS

FASTEN EACH STUD TOGETHER

WITH 16d COMMON AT 16" O.C.

2x CRIPPLE STUDS 16" O.C. AT

SIMPSON HTT4 W/ (18) 10d'S TO

ALTERNATE: SIMPSON SP4 OR SP6 AT JACK AND KING STUD.


STUDS AND 5/8" ANCHOR TO

FOUNDATION AT EACH JAMB.


2x P.T. SOLE PLATE


- NOTCHING AND DRILLING SHALL BE PER F.B.C. R602.2.3 NOTCHING: EXTERIOR WALL OR LOAD BEARING,
- DEPTH NOT EXCEEDING 25 PERCENT OF ITS STUDS WIDTH
- NOTCHING: INTERIOR NON LOAD BEARING, DEPTH NOT TO EXCEED 40 PERCENT OF ITS STUDS WIDTH
- DRILLING: HOLE IS NO MORE THAN 60 PERCENT OF ITS STUDS WIDTH, THE EDGE OF HOLE IS NO MORE THAN 5/8" TO EDGE OF STUD, AND THE HOLE IS NOT LOCATED IN THE SAME SECTION AS A CUT OR NOTCH. EXTERIOR OR BEARING WALLS DRILLED OVER 40 AND UP TO 60 PERCENT SHALL BE DOUBLED WITH NO MORE THAN TWO SUCCESSIVE DOUBLED STUDS BORED.
- USE SIMPSON STUD SHOES WHERE PIPE/CONDUIT EXCEEDS VALUES ABOVE BUT NOT OVER 2-3/8" OUTSIDE DIA.

INTERIOR HEADER

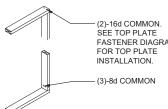

END STUD INTERIOR

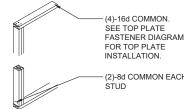

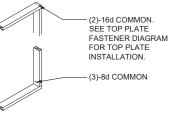



DOUBLE END STUD

ALAIR

AI5

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HARBOUR ORLANDO, 078

EDGE

ISSUED FOR 10/08/2021 PERMITTING

11/9/2021

CITY OF EDGEWOOD

INTERIOR NON-LOAD BEARING WALLS DO NOT REQUIRE SP-1 AND SP-2 STUD FASTENERS TO SOLE AND TOP PLATES.

RECEIVED

GENERAL NOTES:

- SEE SHEET A13 FOR LOAD BEARING
- ALL FLASHING SHALL BE PER FBC R903.2.1, R905.2.8, AND R703.4.1,

NAIL TOP OF RAT RUN TO GABLE TRUSS WITH (2) 12d AND (1) SIMPSON H8 WITH (10) 10d NAILS. SECURE GABLE TRUSS TO

DETAIL REPRESENTS TYP. GABLE END FRAMING CONDITION. SPECIFIC DETAIL MAY VARY SLIGHTLY BASED ON TRUSS DESIGN AND LAYOUT. REFER TO DETAIL FOR ATTACHMENT AND BRACING REQUIREMENTS

TYP. FRAME WALL GABLE END

DOUBLE TOP PLATE WITH SIMPSON HGA10 AT 48" O.C. WITH 1/4" x 1 1/2"

ASPHALT SHINGLES AND WEATHER BARRIER OVER 1/2" APA RATED

CLIPS

SHEATHING WITH SIMPSON PSC EDGE

DROP GABLE END TRUSS AND 2x OUT

REFER TO WALL SECTION FOR SPECIFIC

2x4 L BRACE FOR GABLES 3'-0" TO 5'-11"

TALL. 2x6" L BRACE FOR GABLES 6'-0" AND TALLER. ATTACH L BRACE WITH 10d

LOOK RAFTERS. ATTACH 2x OUT LOCKERS AT 24" O.C. TO TRUSS WITH MTS12 OR H2.5A. SPACE OUTLOOKER

> HARDIE BOARD VENTED SOFFIT WALL FINISH. SEE ELEVATIONS.

> > 7/16" PLYWOOD SHEATHING

BLOCKERS 24" O.C.

FASCIA DETAIL

NAILS AT 4" O.C

GABLE TRUSS

SCALE: 3/4" = 1'-0"

SCALE: 3/4" = 1'-0"

DASHED LINES REPRESENT FRAMING FOR WINDOW OPENING.

EXT. WOOD FRAMING CONNECTION DETAIL

CLB BRACING AT 20' MAX. INTERVALS

THREE OR MORE REPEATED IDENTICAL TRUSSES SHALL HAVE DIA. BRACES (AS REQUIRED

AI5

APA RATED SHEATHING

COMPRESSION WEB SLOPING OR VERTICAL

CONT. PERMANENT LATERAL BRACE (CLB)

MOVEMENT AND SHOULD BE REPEATED AT

SIDE OF WEB TO PREVENT LATERAL

1x4 MIN. BRACING W/ (2)-10d NAILS AT

APPROX. 20'-0" INTERVALS.

INTERSECTING WEBS

GYPSUM BOARD

PERMANENT DIA. BRACE NAILED TO OPPOSITE

STUD CONNECTION DETAILS

JOB NUMBER: 20-079 PROJECT MANAGER: DRAWN BY: J. KNOUS PPROVED BY J. KNOUS LAST FILED: Fri, 08 Oct 2021 SHEET TITLE:

DETAILS -

WALL FRAMING

A15

REV.

1. START AT CORNER OF BUILDING, UNROLL WEATHER BARRIER KEEPING THE ROLL PLUMB: EXTEND THE WEATHER BARRIER TO A POINT 12" PAST AN OUTSIDE OR INSIDE CORNER OF WALL. VERTICALLY OVERLAP THE PREVIOUS SHEET OF WEATHER BARRIER A MINIMUM OF 6". VERTICAL GRID LINES AT 8" SPACING ARE PROVIDED TO ASSIST IN ALIGNMENT WITH STUDS

2. PROPER SHINGLING OF THE WEATHER BARRIER IS ESSENTIAL IN KEEPING MOISTURE OUT OF THE EXTERIOR ENVELOPE. WEATHER BARRIERS ARE TO BE INSTALLED STARTING AT THE LOWEST POINT TO RECEIVE WEATHER BARRIER WITH SUBSEQUENT COURSES LAPPING THE PREVIOUS SHEET TO ENSURE BARRIER SHINGLING.

- 3. WEATHER BARRIER SHOULD OVERLAP THROUGH-WALL FLASHING BY A MINIMUM OF 6" FOR MAXIMUM AIR LEAKAGE REDUCTION.
- 4. SECURE WEATHER BARRIER WITH FASTENERS AND CAPS AS DIRECTED BY THE MANUFACTURER AND FASTEN AT STUDS.
- 5. UNROLL WEATHER BARRIER DIRECTLY OVER DOOR AND WINDOW
- 6. ALL HORIZONTAL AND VERTICAL LAPS SHALL BE A MINIMUM OF 6". TAPE ALL JOINTS USING MANUFACTURER'S TAPE.
- 7. DO NOT INSTALL FASTENERS WITHIN 6" OF SILLS AND JAMBS AT OPENINGS AND 9" AT THE HEAD OF THESE OPENINGS.

WEATHER BARRIER INSTALLATION AT STUCCO

9. WEATHER BARRIERS AT STUCCO FINISHES REQUIRE 2 COMPLETE LAYERS OF WEATHER BARRIER.

10. FIRST LAYER IS THE DRAINAGE LAYER AND SHALL BE INSTALLED WITH THE RIBBED DRAINAGE PLANE ORIENTED VERTICALLY AND INSTALLED AS DIRECTED IN STEPS 1 THROUGH 7 ABOVE. USE DUPONT TYVEK WEATHER BARRIER.

11 THE SECOND LAYER IS INSTALLED OVER THE DRAINAGE PLANE AS DIRECTED IN STEPS 1 THROUGH 7 ABOVE. USE DUPONT TYVEK STUCCOWRAP WEATHER BARRIER.

11/9/2021 CITY OF EDGEWOOD

RECEIVED

GENERAL NOTES:

ALL FLASHING PER FBC R903.2.1, R905.2.8, AND R703.4.1.

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EDWARD JOE KNOUS FI REG NO AR97048

078

ISSUED FOR

ALAIR

ORLANDO,

EDGEWOOD

AHJ:

10/08/2021 PERMITTING

JOB NUMBER: 20-079 PROJECT MANAGER DRAWN BY: J. KNOUS APPROVED BY J. KNOUS SHEET TITLE:

DETAILS -


FLASHING


METAL SILL PAN STEP 1 STEP


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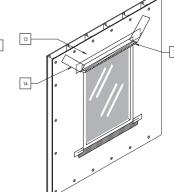
- 1. ALL PANS ARE TO BE SOLDERED AND MADE WATER TIGHT
- 2. WHEN ATTACHMENT REQUIRES FASTENER THROUGH THE SILL, ADD AN ADDITIONAL APPLICATION OF SELF ADHERED MEMBRANE ON TOP OF METAL FAN.
- 3. FIELD VERIFY ALL WINDOW AND DOOR DIMENSIONS TO VERIFY PROPER WALL AND FLASHING WATERPROOFING.
- 4. ALL INSTALLATION DETAIL DRAWINGS REFER TO BOTH WINDOW AND DOOR INSTALLATIONS.
- CONTRACTOR TO INTERPOLATE DETAIL FOR SPECIFIC APPLICATION.

WINDOW SILL PAN - WHERE REQUIRED



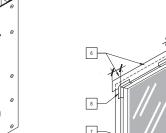

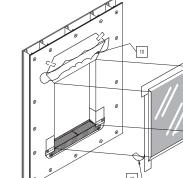

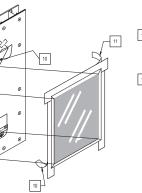

12. WINDOW AND DOOR HEAD FLASHING. REFER TO WINDOW AND DOOR DETAIL FOR FLASHING

13. FLIP DOWN UPPER FLAP OF WEATHER BARRIER SO IT LAYS FLAT ACROSS HEAD FLASHING.

14. TAPE ALONG ALL CUTS IN WEATHER BARRIER WITH SELF ADHERING MEMBRANE STRIPS.

AS NECESSARY. APPROVED SEALANT AND BACKER ROD WILL ALSO SERVE AS A BACK DAM

AGAINST THE WINDOW HEAD AND COVER THE TOP EDGE WITH SELF ADHERING MEMBRANE STRIPS


WIDTH OF WINDOW OPENING AND APPROXIMATELY 10" IN DEPTH. ATTACH SKIRT TO UNDERSIDE OF

WINDOW USING A PIECE OF 4" SELF ADHERING MEMBRANE CUT TO THE SAME WIDTH AS THE SKIRT

INFORMATION. PLACE IN A BEAD OF APPROVED SEALANT ON THE REAR SIDE. INSTALL THE DRIP CAP TIGHT

15. CREATE THE HIGH PRESSURE SKIRT BY CUTTING A PIECE OF WEATHER BARRIER 2" WIDER THAN THE

16. SECURE SIDE OF WINDOW AND SKIRT WITH WRAP CAPS OR APPROVED FASTENERS.
17. SEAL AROUND THE WINDOW OPENING AT THE INTERIOR, USING APPROVED SEALANT AND BACKER ROD

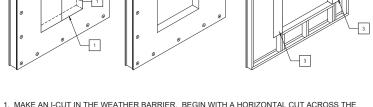

5

- BOTTOM AND THE TOP OF THE WINDOW FRAME. FROM THE CENTER CUT STRAIGHT DOWN TO 2. CUT TWO 45 DEGREE SLITS A MINIMUM OF 8" FROM THE CORNER OF THE HEADER TO CREATE
- A FLAP ABOVE THE ROUGH OPENING TO EXPOSE SHEATHING OR FRAMING MEMBERS AND TO ALLOW HEAD FLASHING INSTALLATION. FLIP HEAD FLAP UP AND TEMPORARILY SECURE WITH
- 3. FOLD SIDE FLAPS INTO ROUGH OPENING, CUT EXCESS FLAPS, AND SECURE. NOTE: SIDE FLAPS SHOULD COVER INTERIOR FACING FRAMING STUD.

- BACKDAM, AND ADHERE INTO ROUGH OPENING ALONG SILL AND UP JAMBS MIN. 6" ON EACH SIDE. 6. PREPARE HEAD FLASHING BY CUTTING A PIECE OF SELF ADHERING MEMBRANE 12" LONGER THAN THE HEAD LENGTH.
- BEFORE FLASHING, PRIME WINDOW FINS AND CASINGS WITH APPROVED PRIMER. CENTER THE FLASHING ON THE WINDOW HEAD AND POSITION SO THAT IT CONTACTS THE WINDOW FRAME AND INTERIOR SIDE OF THE FRONT FLANGE AND ADHERE THE FLASHING TO THE WINDOW FRAME. USE THE INNER RELEASE PAPER TO FORM A TIGHT SEAL IN THE CORNER. REMOVE THE INNER RELEASE PAPER AND ADHERE THE FLASHING TO THE BACK OF THE ALUMINUM WINDOW FIN AND CASING. AT THE CORNER OF THE WINDOW FRAME, CUT THE SELF ADHERING MEMBRANE ALONG THE CORNER AT A 45 DEGREE ANGLE AND
- . PREPARE JAMB FLASHING BY CUTTING A PIECE OF SELF ADHERING MEMBRANE 6" LONGER THAN THE JAMB AND FOLLOW
- 9. INSTALL WINDOW ACCORDING TO MFR. INSTALLATION INSTRUCTIONS.
- 10. SPRAY THE TOP OF THE JAMBS AND EXPOSED SHEATHING WITH APPROVED PRIMER. REMOVE THE REMAINING RELEASE PAPER FROM JAMB FLASHING AND PRESS FIRMLY TO ADHERE IT THE WEATHER BARRIER


- 4. CUT SELF ADHERING MEMBRANE 6" LONGER THAN WIDTH OF ROUGH OPENING SILL.
- 5. REMOVE THE CENTER PIECE OF RELEASE PAPER, COVER HORIZONTAL SILL BY OVERHANG INSIDE EDGE OF SILL BY 1" FOR
- STEP 6. ATTACHING MEMBRANE TO WINDOW FRAME.
- 8. INSTALL 2"X4" SELF ADHERING MEMBRANE PATCH IN EACH CORNER
- 11. REMOVE THE RELEASE PAPER AT THE HEAD AND ADHERE IT TO THE WALL SURFACE

3

WEATHER BARRIER ASSEMBLY

SCALE: NTS


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WEATHER BARRIER. LAP MIN. 6"
AND TAPE BARRIER AT JOINTS
WITH 3" TAPE.

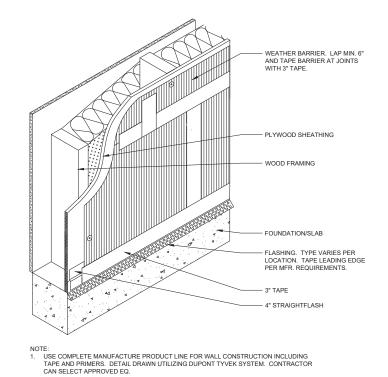APPLY CONT. BEAD OF SEALANT
AROUND PENETRATION USING
DUPONT COMMERCIAL SEALANT
OR DUPONT RECOMMENDED
SEALANT

3" TAPE OVER WEATHER
BARRIER AND AROUND ENTIRE
PENETRATION AS INDICATED




WEATHER BARRIER ASSEMBLY - WALL BASE

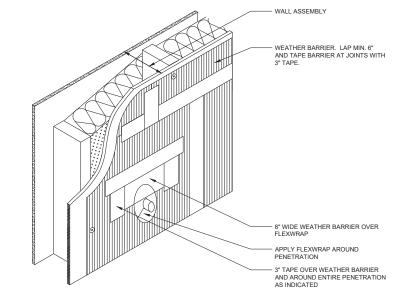SCALE: NTS

WEATHER BARRIER ASSEMBLY - PENETRATION SCALE: NTS

WEATHER BARRIER ASSEMBLY - PENETRATION SCALE: NTS

AIT.

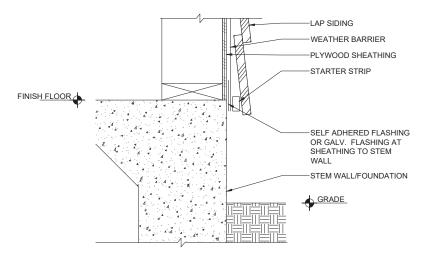





GENERAL NOTES:

1. ALL FLASHING PER FBC R903.2.1, R905.2.8, AND R703.4.1.

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DATE ISSUED FOR
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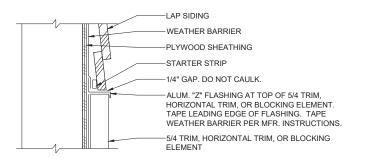
JOB NUMBER: 20-079
PROJECT MANAGER: -DRAWN BY: J. KNOUS

APPROVED BY: J. KNOUS

LAST FILED:
Fri, 08 Oct 2021
4: 29pm
SHEET TITLE:

DETAILS -FLASHING


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LAP SIDING AT TRIM PROJECTION

SCALE: 3" = 1'-0"

AIB



ROOF TO WALL TRANSITION-MOD BIT ROOF

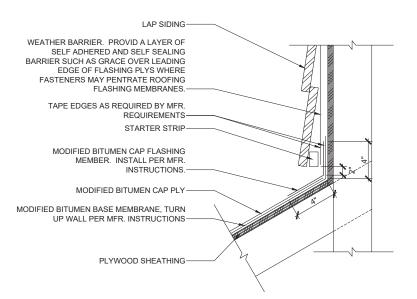SCALE: 3" = 1'-0"

AIB

GENERAL NOTES:

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ELECTRICAL SYSTEM SHALL BE COMPLETE AND EFFECTIVELY GROUNDED AS REQUIRED BY THE LATEST EDITION OF THE N.E.C.

ALL MATERIALS SHALL BE NEW AND BEAR UNDERWRITERS LABELS, WHERE APPLICABLE

ALL WORK SHALL BE PERFORMED BY A LICENSED ELECTRICAL CONTRACTOR IN A FIRST CLASS WORKMANLIKE MANNER.

5. THE ELECTRICAL INSTALLATION SHALL MEET ALL STANDARD

REQUIREMENTS OF POWER AND TELEPHONE COMPANIES.

IT IS NOT THE INTENT OF THESE DRAWINGS TO SHOW ALL INFORMATION FOR CONSTRUCTION. THE CONTRACTOR IS EXPECTED TO FURNISH AND INSTALL ALL ITEMS FOR A COMPLETE ELECTRICAL SYSTEM AND PROVIDE ALL REQUIREMENTS NECESSARY FOR EQUIPMENT TO BE PLACED IN PROPER WORKING ORDER.

PROVIDE POWER AND PRE-WIRE ALL OPENINGS FOR OWNER'S INSTALLED SECURITY SYSTEM.

VERIFY ALL CONDUCTORS AND BREAKERS WITH EQUIPMENT MFR. SPECIFICATIONS.

PROVIDE GROUND FAULT INTERRUPT BREAKERS FOR ALL BATHROOM, GARAGE AND EXTERIOR OUTLETS. 10. ELECTRICAL FIXTURES, TRIM AND APPLIANCES SHALL BE APPROVED BY

11. PROVIDE PRE-WIRED TELEPHONE OUTLETS AS SHOWN ON PLANS.

VERIFY LOCATIONS WITH OWNER 12. PROVIDE PRE-WIRED TELEVISION OUTLETS AS SHOWN ON PLANS. VERIFY LOCATIONS WITH OWNER

13. PROVIDE SMOKE DETECTION AT ALL BEDROOMS (INSIDE AND OUTSIDE) ADJACENT TO BEDROOM DOOR. DETECTORS SHALL BE TIED TOGETHER SO THAT IF ONE UNIT IS ACTIVATED, ALL UNITS ACTIVATE

14. PROVIDE CARBON MONOXIDE ALARM WITHIN 10'-0" OF ALL BEDROOMS PER FLORID BUILDING CODE-RESIDENTIAL.

15 ALL BEDROOM RECEPTACLES MUST HAVE ARC FAULT CURRENT INTERRUPTERS PER CURRENT NEC CODE REQUIREMENTS.

16. GROUND FAULT PROTECTION SHOULD BE APPLIED TO ALL AREAS AS REQUIRED PER CURRENT NEC CODE.

17. ALL ELECTRICAL OUTLETS SHALL BE CONCEALED IN FRAMED WALLS. INTERIOR AND EXTERIOR CONDUIT SHALL NOT BE SURFACE MOUNTED.

18. WIRE FRONT DOOR WITH DOOR BELL.

19. OUTDOOR OUTLETS SHALL BE IN WEATHERPROOF ENCLOSURE.

20. IF EXTERIOR AC COMPRESSOR IS RELOCATED, (1) OUTLET SHALL BE WITHIN 25 FEET.

21. PROVIDE LIGHT WITHIN ATTIC SPACE ADJACENT TO ATTIC ACCESS POINT

22. PROVIDE EQUIPMENT DISCONNECTS AS REQUIRED PER RECOMMENDATION OF MFR.

23. VERIFY EXACT LOCATION OF POWER METER WITH POWER COMPANY. 24. VERIFY WITH OWNER LOCATION OF ALL DIMMER SWITCHES.

25. VERIFY WITH OWNER LOCATION OF PENDANT AND RECESSED LIGHT

26. ELECTRICAL LIGHTING SHALL MET COMPLIANCE WITH HIGH-EFFICIENCY

LIGHTING PER ELORIDA BUILDING CODE ENERGY CONSERVATION R404

ELECTRICAL SYMBOL LEGEND

STRIP FLUORESCENT/LED LIGHT FIXTURE - CEILING MOUNTED, WALL MOUNTED

INCANDESCENT, LED OR COMPACT FLUORESCENT FIXTURE 0 CEILING MOUNTED, WALL MOUNTED

 \triangleleft GAS CONNECTION

(SD) SMOKE DETECTOR

CO CARBON MONOXIDE

(T) THERMOSTATE

0 EXHAUST FAN

Ø EXHAUST FAN AND LIGHT KIT

\$ \$₃ \$_{0S} 1-POLE, 3-WAY, OCCUPANCY SENSOR

\$_D D DIMMER SWITCH

#

DUPLEX RECEPTACLE AT 18", ABOVE COUNTER AT 42", GROUND FAULT TYPE, ISOLATED GROUND TYPE

WEATHERPROOF RECEPTACLE

CEILING MOUNTED DUPLEX RECEPTACLE


(2) DUPLEX RECEPTACLES IN SINGLE OUTLET BOX WITH SINGLE COVER PLATE AT 18", ABOVE COUNTER AT 42"

 $\square \bigcirc \vee$ JUNCTION BOX, MOTOR CONNECTION

120/240V PANELBOARD

W C P TELEPHONE OUTLET AT 18", WALL TELEPHONE OUTLET AT 54",
ABOVE COUNTER, PAY TELEPHONE OUTLET. PROVIDE 4" SQ. BOX RJ45 OUTLET COVERPLATE WITH RJ11 BEZEL AND 1 RACEWAY TO ACCESSIBLE CEILING. NUMBER INDICATES QUANTITY OF OUTLETS PER BOX, WHEN MORE THAN 1. RUN (1)CAT5E WHITE PER OUTLET TO TELEPHONE BOARD.

COMPUTER OUTLET AT 18", ABOVE COUNTER. PROVIDE 4" SQUARE BOX, RJ45 OUTLET, COVERPLATE, AND 1" CONDUIT TO ACCESSIBLE CEILING. NUMBER INDICATES QUANTITY WHEN MORE THAN 1. RUN (1)CAT5E BLU CABLE PER OUTLET TO LAN RACK.

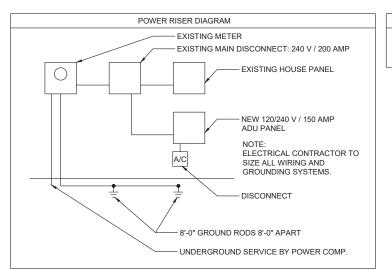

ELECTRICAL LOAD CALCULATION NOTE

ELECTRICAL CONTRACTOR SHALL PROVIDE LOAD CALCULATIONS TO SIZE DISCONNECTS AND PANELS.

2. ELECTRICAL CONTRACTOR SHALL INDICATE ALL CIRCUITS ON PANEL

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REV.

