MECATOS BAKERY & CAFE

5645 HANSEL AVE EDGEWOOD, FL 32809

CONSTRUCTION DOCUMENTS



LOCATION MAP

PREPARED BY

HARRIS CIVIL ENGINEERS, LLC. 1200 HILLCREST STREET, SUITE 200 ORLANDO EL 32803

LANDSCAPE ARCHITECT

DALE & COMPANY 651 N. MILLS AVENUE ORLANDO, FL 32803 OFFICE: 407.894.1317

CIVIL ENGINEER

OFFICE: 407.629.4777

ENGINEER OF RECORD: DAVID TAYLOR, P.E. LICENSE NUMBER: 60928

> HCE PROJECT NUMBER: 7391000 DATE: OCTOBER 25, 2021

INDEX OF SHEETS

C-000 COVER SHEET C-001 GENERAL NOTES C-002 EXISTING CONDITIONS

C-003 DEMOLITION AND EROSION CONTROL PLAN

C-100 SITE AND GEOMETRY PLAN C-101 SITE AND GEOMETRY PLAN C-200 GRADING AND DRAINAGE PLAN

C-402 LIFT STATION DETAIL

L-101 LANDSCAPE SITE PLAN

SITE DATA TABLE PARCEL ACREAGE: 0.906 ACRES 24-23-29-3400-00-014 FAST FOOD WITH DRIVE THRU PROPOSED USES: ZONING: SPECIAL DISTRICT: C=1 EDGEWOOD CENTRAL DISCTRICT(ECD) MINIMUM REQUIRED:

29 REGULAR SPACES REQUIRED
(1 SPACE PER 100 SF GFA +
1 SPACE PER 200 SF EXTERNAL SEATING)
2 ADA ACCESSIBLE SPACE
29 TOTAL SPACES REQUIRED PROVIDED: 29 REGULAR SPACES

MIN 25' (BLDG) 20' (BLDG) 25' (BLDG) 25' (BLDG) BUILDING SETBACKS: FRONT W: AREA: PRE-DEVELOPMENT POST DEVELOPMENT

XPANSION AREA: LLOWABLE EXPANSION AREA ROPOSED EXPANSION AREA

LOT TO BUILDING RATIO - REQUESTING WAIVE

CALL 48 HOURS BEFORE YOU DIG IT IS THE LAW. DIAL 811



HARRIS


1200 Hillcrest Street

EDGEWOOD,

AVE,



RECEIVED

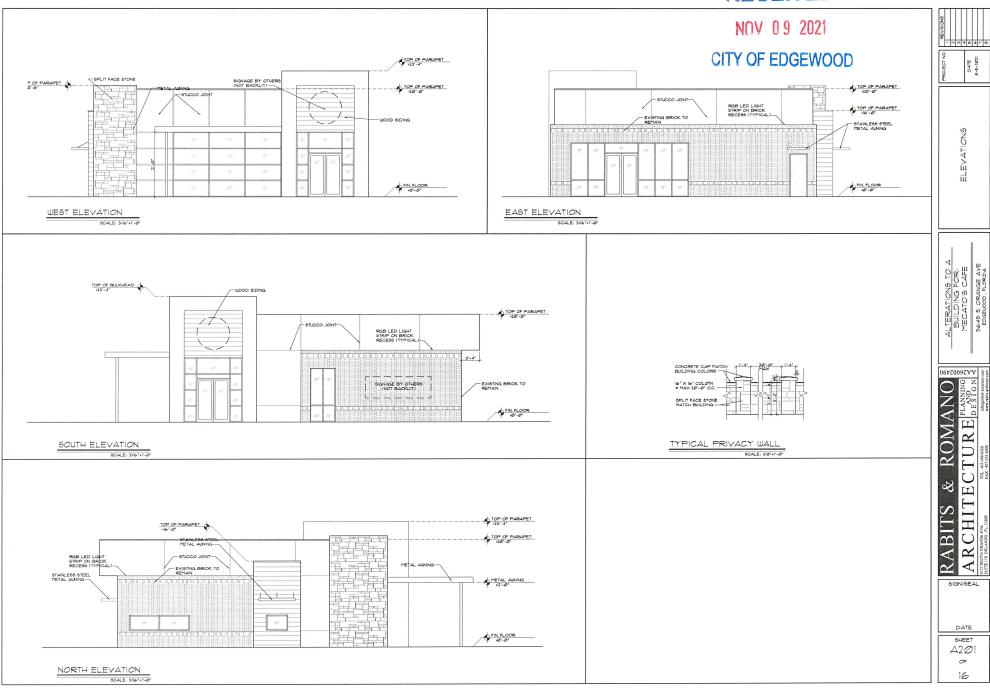

GENERAL NOTES

- CONTRACTOR SHALL PROVIDE ALL NECESSARY SIGNS, BARRIERS, LABOR, EQUIPMENT, ETC., TO MAINTAIN A SAFE AND ADEQUATE FLOW OF PEDESTRIAN AND VEHICULAR TRAFFIC ALONG ROADWAYS AND WALKWAYS AND INTO AND OUT OF SITE AND BUILDINGS FOR THE DURATION OF THE CONSTRUCTION.
- 2. CONTRACTOR SHALL PROVIDE ACCESS FOR EMERGENCY VEHICLES AROUND AND TO ALL BUILDINGS DURING CONSTRUCTION.
- 3. SURVEY DATUM BASED ON NAVD88 DATUM.
- 4. THE CONTRACTOR SHALL FIELD VERIFY ALL CONDITIONS AND DIMENSIONS PRIOR TO ANY WORK AND SHALL BE RESPONSIBLE FOR ALL WORK AND MATERIALS INCLUDING THOSE FURNISHED BY SUBCONTRACTORS. CONTRACTOR SHALL ACCEPT PREMISES AS FOUND. OWNER ASSUMES NO RESPONSIBILITY FOR THE CONDITION OF THE EXISTING SITE OR EXISTING STRUCTURES AT THE TIME OF BIDDING OR THEREAFTER.
- UNLESS OTHERWISE NOTED, CONTRACTOR TO CLEAR AND GRUB WORK AREAS OF ALL VEGETATION. CONCRETE SLABS AND FOUNDATIONS, PAVEMENT, FENCES, LIGHT POLES, UTILITIES, ETC. AS INDICATED ON THE PLANS OR BY THE PROJECT MANAGER AND PROPERLY DISPOSE OF OFF SITE. ANY EXISTING UTILITY SERVICES SHALL BE PROPERLY DISCONNECTED, PLUGGED, REMOVED OR ABANDONED.
- 6. ALL CONSTRUCTION SHALL COMPLY WITH THE APPLICABLE BUILDING CODES AND LOCAL RESTRICTIONS. THE CONTRACTOR MUST COMPLY WITH THE CONTRACTOR REGISTRATION REQUIREMENTS OF ALL GOVERNING AUTHORITIES.
- THE CONTRACTOR SHALL REPORT TO THE ENGINEER ANY ERROR, INCONSISTENCIES, OR OMISSIONS HE MAY DISCOVER. THE CONTRACTOR IS RESPONSIBLE FOR CORRECTING ANY ERRORS AFTER THE START OF CONSTRUCTION WHICH HAS NOT BEEN BROUGHT TO THE ATTENTION OF THE ENGINEER. THE MEANS OF CORRECTING ANY ERRORS SHALL FIRST BE APPROVED BY THE ENGINEER AND PROJECT MANAGER.
- 8. CONTRACTOR SHALL REFER AND CONFORM TO ALL RECOMMENDATIONS AND FINDINGS AS SET FORTH IN THE GEOTECHNICAL REPORT. THE PROJECT MANAGER AND ENGINEER ACCEPT NO RESPONSIBILITY FOR THE ACCURACY OF THE FINDINGS OR FOR THE FINAL RECOMMENDATIONS. CONTACT THE PROJECT MANAGER FOR INSTRUCTIONS PRIOR TO THE CONTINUATION OF WORK SHOULD ANY UNUSUAL CONDITIONS BECOME APPARENT DURING GRADING OR FOUNDATION CONSTRUCTION. EXISTING ELEVATIONS AND LOCATIONS TO BE JOINED SHALL BE VERIFIED BY THE CONTRACTOR BEFORE CONSTRUCTION. IF THEY DIFFER FROM THOSE SHOWN ON THE DRAWINGS, THE CONTRACTOR SHALL NOTIFY THE PROJECT MANAGER AND ENGINEER SO THAT MODIFICATIONS CAN BE MADE BEFORE PROCEEDING WITH THE WORK.
- 9. THE CONTRACTOR SHALL ENSURE THAT PERMITS FOR CONSTRUCTION ARE OBTAINED PRIOR TO STARTING
- 10. PRIOR TO COMMENCEMENT OF WORK THE CONTRACTOR WILL COORDINATE HIS ACTIVITIES WITH ALL THE UTILITY COMPANIES SERVING THIS AREA. CONTRACTOR IS TO COORDINATE FULLY WITH UTILITY COMPANIES ON EXACT LOCATION OF UNDERGROUND UTILITIES PRIOR TO EXCAVATION.
- 11. THE LOCATIONS OF ALL EXISTING UTILITIES AND STORM DRAINAGE SHOWN ON THE PLANS HAVE BEEN DETERMINED FROM AVAILABLE INFORMATION AND ARE GIVEN FOR THE CONVENIENCE OF THE CONTRACTOR. THE OWNER AND ENGINEER ASSUME NO RESPONSIBILITY FOR INACCURACY. PRIOR TO THE START OF CONSTRUCTION, IT SHALL BE THE CONTRACTOR'S RESPONSIBILITY TO MAKE THE NECESSARY ARRANGEMENTS FOR ANY RELOCATION OF THESE UTILITIES WITH THE UTILITY COMPANY. THE CONTRACTOR SHALL EXERCISE CAUTION WHEN CROSSING ANY UNDERGROUND UTILITY. EXISTING UTILITIES WHICH INTERFERE WITH THE PROPOSED CONSTRUCTION SHALL BE RELOCATED AS DIRECTED ON THE PLANS.
- 12. ALL PROPERTY AFFECTED BY THIS WORK SHALL BE RESTORED TO A CONDITION EQUAL TO OR BETTER THAN EXISTING UNLESS SPECIFICALLY EXEMPTED BY THE PLANS. THE COST FOR SUCH RESTORATION SHALL BE INCIDENTAL TO OTHER CONSTRUCTION AND NO EXTRA COMPENSATION WILL BE ALLOWED.
- 13. THE PROJECT SPECIFICATIONS AND GENERAL CONDITIONS ARE TO BE FOLLOWED IN ADDITION TO THESE
- 14. SUBSURFACE INFORMATION SHOWN ON THESE DRAWINGS WAS OBTAINED FOR USE IN ESTABLISHING DESIGN CRITERIA FOR THE PROJECT. THE ACCURACY OF THIS INFORMATION IS NOT GUARANTEED AND IS NOT TO BE CONSTRUED AS PART OF THE PLANS GOVERNING CONSTRUCTION OF THE PROJECT.
- 15. THE CONTRACTOR AND ALL SUB-CONTRACTORS ARE TO BE KNOWLEDGEABLE OF AND STRICTLY ADHERE TO ALL OSHA STANDARDS.
- 16. PRIOR TO CONSTRUCTION THE CONTRACTOR SHALL VERIFY VERTICAL AND HORIZONTAL LOCATION OF EXISTING UTILITIES AT PROPOSED CROSSINGS AND POINTS OF CONNECTION. THE CONTRACTOR SHALL NOTIFY THE ENGINEER IMMEDIATELY, IN WRITING, OF ANY UTILITY CONFLICTS OR DISCREPANCIES. ALL LOCATION DATA TO BE INCLUDED ON THE AS-BUILT DRAWINGS. REFER TO AS-BUILT REQUIREMENTS THIS SHEET AS WELL AS SPECIFICATIONS FOR AS-BUILT REQUIREMENTS.

DEMOLITION NOTES

- PRIOR TO COMMENCEMENT OF DEMOLITION THE CONTRACTOR WILL COORDINATE THEIR ACTIVITIES WITH ALL THE UTILITY COMPANIES SERVING THIS AREA AND THE PROJECT MANAGER, CONTRACTOR IS TO COORDINATE FULLY WITH UTILITY COMPANIES AND THE PROJECT MANAGER ON EXACT LOCATION OF UNDERGROUND UTILITIES PRIOR TO EXCAVATION.
- 2. THE CONTRACTOR IS TO COMPLETELY REMOVE AND DISPOSE OF ALL STRUCTURES AND BUILDINGS INCLUDING FOUNDATIONS, TIMBER AND BRUSH, EXCEPT AS OTHERWISE INDICATED; STUMPS AND ROOTS; EXISTING PAVEMENT; OTHER STRUCTURES AS SHOWN OR REASONABLY IMPLIED IN THE
- 3. MINIMUM DEPTH FOR REMOVAL OF OBJECTS SHALL BE THREE (3) FEET BELOW SUB-GRADE IN ROADWAY AND SIDEWALK AREAS AND FOUR (4) FEET BELOW FINISHED GRADE ELSEWHERE. WHERE EXISTING BUILDINGS ARE TO BE DEMOLISHED, OR AT PROPOSED POOL LOCATIONS ALL TRACES OF FOUNDATIONS AND UNDERGROUND UTILITIES ARE TO BE REMOVED. THE CONTRACTOR IS RESPONSIBLE FOR PROPER DISPOSAL OF ALL WASTE MATERIAL.
- 4. ALL BUILDING REMOVAL AND DEMOLITION SHALL BE PERFORMED AS SHOWN OR AS DIRECTED BY THE ENGINEER AND/OR THE PROJECT MANAGER.
- 5. RELOCATION OR REMOVAL OF OVERHEAD OR UNDERGROUND UTILITIES SHALL BE COORDINATED BY THE CONTRACTOR WITH THE APPROPRIATE UTILITY COMPANY AND THE PROJECT MANAGER.
- 6. SEE LANDSCAPE DEMOLITION PLAN FOR ADDITIONAL REQUIREMENTS FOR PLANT MATERIALS AND
- IRRIGATION LINES. CONTRACTOR TO COORDINATE EFFORTS AND TIMING SO THAT EXISTING UTILITIES REMAIN IN SERVICE
- UNTIL SUCH TIME AS THE PROPOSED UTILITIES HAVE BEEN INSTALLED, AS-BUILT PROVIDED AND ACCEPTED BY ENGINEER.

<u>GEOMETRY NOTES</u>

- ALL SURVEY DATA USED AND CONDITIONS ASSUMED TO BE PRESENT IN PREPARATION OF THESE PLANS WAS PROVIDED BY THE OWNER. HARRIS CIVIL ENGINEERS, LLC. AND THE PROJECT MANAGER DO NOT ASSUME RESPONSIBILITY FOR THE ACCURACY OR COMPLETENESS OF THIS DATA.
- 2. THE CONTRACTOR SHALL VERIFY AND LOCATE ALL VERTICAL AND HORIZONTAL CONTROL POINTS PRIOR TO CONSTRUCTION. IF ANY DISCREPANCIES SHOULD BE FOUND, THE CONTRACTOR SHALL NOTIFY THE ENGINEER AND SURVEYOR OF THE CONDITION IN WRITING PRIOR TO COMMENCING ANY CONSTRUCTION
- 3. ALL PAVEMENT OFFSETS, RADII AND DIMENSIONS SHOWN ARE TO PROPOSED EDGE OF PAVEMENT, UNLESS OTHERWISE NOTED.
- 4. THE CONTRACTOR SHALL STAKE ALL IMPROVEMENTS USING THE GEOMETRIC DATA PROVIDED. IT IS THE CONTRACTORS SOLE RESPONSIBILITY TO COMPLETELY STAKE AND CHECK ALL IMPROVEMENTS TO ENSURE ADEQUATE POSITIONING, BOTH HORIZONTAL AND VERTICAL, PRIOR TO THE INSTALLATION OF ANY IMPROVEMENTS.
- 5. THE CONTRACTOR SHALL MAINTAIN A SET OF IN PROGRESS "AS-BUILT" PLANS ON-SITE AND SUBMIT THESE PLANS ALONG WITH THE CERTIFIED AS-BUILT PLANS TO THE ENGINEER OF RECORD UPON

EROSION PROTECTION NOTES

- EROSION AND SEDIMENT CONTROL MEASURES ARE TO BE PLACED PRIOR TO, OR AS THE FIRST STEP IN, CONSTRUCTION. SEDIMENT CONTROL PRACTICES WILL BE APPLIED AS A PERIMETER DEFENSE AGAINST ANY TRANSPORTATION OF SOILS OFF THE SITE. THE CONTRACTOR SHALL ACCEPT AND WILL BE RESPONSIBLE FOR MAINTAINING ALL EROSION CONTROL FACILITIES.
- B. SILT SCREENS AND TURBIDITY BARRIERS MUST REMAIN IN PLACE AND IN GOOD CONDITION AT ALL LOCATIONS SHOWS ON THE PLANS AND AS REQUIRED UNTIL THE CONTRACT IS COMPLETED AND SOILS ARE STABILIZED AND VEGETATION HAS BEEN ESTABLISHED.
- THE EROSION CONTROL MEASURES SET FORTH IN THESE PLANS ARE INTENDED AS MINIMUM STANDARDS. ANY EROSION CONTROL REQUIRED BEYOND THAT SPECIFIED SHALL BE CONSIDERED AS INCLUDED WITHIN THIS CONTRACT.
- ALL EROSION AND SEDIMENT CONTROL WORK SHALL CONFORM TO THE PROJECT PLANS AND SPECIFICATIONS, ORANGE COUNTY AND S.J.R.W.M.D. REQUIREMENTS.
- LIMITS OF ALL EROSION PREVENTION MUST BE STAKED BY CONTRACTOR AND THE LOCATION INSPECTED AND APPROVED BY THE PROJECT MANAGER PRIOR TO PLACEMENT OF EROSION CONTROL MEASURES AND ANY CLEARING OR CONSTRUCTION ACTIVITIES. THE CITY NEEDS TO INSPECT EROSION PROTECTION MEASURES PRIOR TO ANY SITE WORK TAKING PLACE. REMOVAL OF THESE SAME EROSION CONTROLS AND PREVENTION MEASURES MAY BE DONE ONLY AFTER AUTHORIZATION BY THE PROJECT MANAGER IS OBTAINED.
- F. MATERIALS FROM WORK ON THIS PROJECT SHALL BE CONTAINED, AND NOT ALLOWED TO COLLECT ON ANY OFF-PERIMETER AREAS, WETLANDS, PROTECTED AREAS OR IN WATERWAYS. THESE INCLUDE BOTH NATURAL AND MAN-MADE OPEN DITCHES, STREAMS, STORM DRAINS, LAKES OR PONDS.
- DAILY INSPECTIONS SHALL BE MADE BY THE CONTRACTOR TO DETERMINE THE EFFECTIVENESS OF THESE EFFORTS. ANY NECESSARY REMEDIES SHALL BE PERFORMED WITHOUT DELAY AND AT NO COST TO THE OWNER.
- H. ALL MUD, DIRT OR OTHER MATERIALS TRACKED OR SPILLED ONTO EXISTING OR PRIVATE ROADS. BEACH AREAS, AND FACILITIES FROM THIS SITE, DUE TO CONSTRUCTION, SHALL BE PROMPTLY REMOVED BY THE CONTRACTOR. DEVIATION FROM THIS WILL CAUSE PROJECT MANAGER NOTIFICATION, AND ALL WORK TO STOP UNTIL CORRECTED.
- I. PERMANENT SOIL EROSION CONTROL MEASURES FOR ALL SLOPES, CHANNELS, DITCHES OR ANY DISTURBED LAND AREAS SHALL BE COMPLETED IMMEDIATELY AFTER FINAL GRADING. WHEN IT IS NOT POSSIBLE TO PERMANENTLY PROTECT A DISTURBED AREA IMMEDIATELY AFTER GRADING OPERATIONS, TEMPORARY EROSION CONTROL MEASURES SHALL BE INSTALLED. ALL TEMPORARY PROTECTION SHALL BE MAINTAINED UNTIL PERMANENT MEASURES ARE IN PLACE AND ESTABLISHED. TEMPORARY EROSION CONTROL MAY CONSIST OF BUT NOT BE LIMITED TO MULCH. SAND BAGS, PIPING, SLOPE DRAINS, SETTLEMENT BASINS, ARTIFICIAL COVERINGS, BERMS, AND DUST CONTROL.
- ALL REVEGETATION SHALL BE INSTALLED IN ACCORDANCE WITH MATERIALS AND PROCEDURES AS SPECIFIED BY THE LANDSCAPE ARCHITECT. THE FINAL INSTALLATION, AS OPPOSED TO TEMPORARY STABILIZATION, IS TO BE MAINTAINED UNTIL FINAL ACCEPTANCE. REFER TO LANDSCAPE PLANS FOR FINAL VEGETATED SITE CONDITIONS.
- THE CONTRACTOR SHALL PREPARE A SCHEDULE OF DEWATERING FOR UTILITY ITEMS. THIS WILL CONSIST OF ESTIMATES OF POINTS OF DISCHARGE, DISCHARGE FLOWS, DATES AND DURATIONS FOR ALL UTILITY ITEMS WHICH WILL REQUIRE DEWATERING. THIS WILL INCLUDE ALL UTILITIES. THIS SCHEDULE SHALL BE SUBMITTED TO THE PROJECT MANAGER FOR APPROVAL OF THE DEWATERING OPERATIONS.
- L. DURING CONSTRUCTION, THE CONTRACTOR WILL PROVIDE TEMPORARY MULCHING OR STABILIZATION FOR AREAS THAT HAVE BEEN CLEARED AND NOT REWORKED WITHIN SEVEN (7) CALENDAR DAYS DURING SIDE SLOPES SHALL BE MULCHED OR STABILIZED WITHIN SEVEN (7) DAYS DURING THE WET SEASON AND FOURTEEN (14) DAYS DURING THE DRY SEASON.
- M. ALL SURFACE WATER DISCHARGE FROM THE SITE, INCLUDING DEWATERING DISCHARGE SHALL MEET WATER QUALITY STANDARDS (LESS THAN 29 NTU ABOVE BACKGROUND) PRIOR TO REACHING ANY WATER BODIES INCLUDING WETLANDS, LAKES AND STORM WATER PONDS. CONTRACTOR SHALL TAKE WATER SAMPLES PRIOR TO START OF CONSTRUCTION WHICH SHALL BE USED AS BASE LINE WATER QUALITY. ALL DEWATERING PLANS AND TESTS MUST BE SUBMITTED TO AND APPROVED BY THE PROJECT MANAGER PRIOR TO INSTALLATION AND OPERATION.
- N. IN THE EVENT THAT THE EROSION PREVENTION AND CONTROL DEVICES SHOWN IN THESE PLANS PROVE NOT TO BE EFFECTIVE, ALTERNATE METHODS FOR MAINTAINING WATER QUALITY STANDARDS FOR DISCHARGE FROM THE CONSTRUCTION SITE WILL BE REQUIRED AT THE CONTRACTOR'S EXPENSE. ALL ALTERNATIVE EROSION PREVENTION AND CONTROL DEVICES MUST BE APPROVED BY THE PROJECT
- O. IN CONJUNCTION WITH STAKING AND PLACEMENT OF EROSION CONTROL MEASURES THE CONTRACTOR SHALL STAKE THE LIMITS OF CLEARING AS INDICATED ON THE PLANS OR AS REQUIRED BY CONSTRUCTION. THE LIMITS OF CLEARING MUST BE INSPECTED AND APPROVED BY THE PROJECT MANAGER PRIOR TO ANY CLEARING AND REMOVAL. THE CONTRACTOR WILL PAY FOR REVEGETATION OF ANY AND ALL AREAS THAT ARE CLEARED PRIOR TO THE PROJECT MANAGER'S APPROVAL OR AREAS THAT ARE CLEARED BEYOND THE LIMITS APPROVED BY THE PROJECT MANAGER.
- P. ALL DRAINAGE STRUCTURES, INLETS, ETC. MUST HAVE EROSION CONTROL MEASURES IN PLACE AND MAINTAINED UNTIL COMPLETION OF THE PROJECT.
- Q. SILT FENCE LOCATIONS SHOWN ON THE PLANS ARE A REPRESENTATION, AS A MINIMUM TO WHERE SILT FENCING IS REQUIRED. THE EXACT LOCATION TO BE DETERMINED AS PART OF NOTE E ABOVE.

DRAINAGE NOTES

- ALL CONSTRUCTION SHALL CONFORM TO, AND SHALL BE INSTALLED AND CLEARED FOR SERVICE IN ACCORDANCE WITH THE ORANGE COUNTY STANDARDS, UNLESS STATED OTHERWISE IN THE SPECIFICATIONS, OR ON THE PLANS.
- 2. ALL EARTHWORK OPERATIONS SHALL BE IN ACCORDANCE WITH THE SPECIFICATIONS, PLANS AND RECOMMENDATIONS OF THE GEOTECHNICAL ENGINEER (AS APPLICABLE).
- 3. WHEN TRENCH EXCAVATION EXCEEDS FIVE (5) FEET IN DEPTH: A. CONTRACTOR SHALL CONFORM TO OSHA STD. 29CFR. SECTION 1926.650 WHICH IS INCORPORATED IN FL. STATE 90-96.
- THE CONTRACTOR SHALL PROVIDE WRITTEN ASSURANCE OF COMPLIANCE WITH THIS LAW. C. TRENCH SAFETY SYSTEM SHALL BE DESIGNED BY THE CONTRACTOR.
- 5. ALL DRAINAGE PIPING OTHER THAN LANDSCAPE SOCK DRAIN PIPING SHALL HAVE A MINIMUM OF TWENTY-FOUR (24) INCHES OF COVER UNLESS SHOWN OTHERWISE ON THE PLANS OR AS DIRECTED BY THE ENGINEER.
- 6. UNLESS OTHERWISE NOTED ON THE PLANS, ALL DRAINAGE AND LANDSCAPE SOCK DRAIN PIPING SHALL BE ADS N12 PIPE OR APPROVED EQUAL. PIPES 10-INCH DIAMETER AND SMALLER SHALL BE PVC. SDR 26, PER ASTM D3212 AND ASTM F477. CONCRETE STORM SEWER PIPE SHALL BE REINFORCED CONCRETE PIPE, CLASS III, ASTM C-76.
- 7. DRAINAGE STRUCTURE RIM ELEVATION REFERS TO TOP OF GRATE, OR EDGE OF PAVEMENT FOR CURB

 14. CONTRACTOR TO COORDINATE WITH UTILITY COMPANIES PRIOR TO ANY CONSTRUCTION ACTIVITY FOR DIG INLETS.
- 8. RIM ELEVATIONS SHOWN FOR PROPOSED STRUCTURES LOCATED IN EXISTING PAVEMENT AREAS ARE APPROXIMATE AND SHOWN FOR REFERENCE ONLY. CONTRACTOR TO PLACE RIM ELEVATIONS TO BE WITHIN 0.01' OF THE EXISTING PAVEMENT GRADE.

PAVING AND GRADING NOTES

- ALL CONSTRUCTION SHALL BE IN ACCORDANCE WITH THE PROJECT SPECIFICATIONS, AND THE LATEST EDITION OF THE FLORIDA DEPARTMENT OF TRANSPORTATION STANDARD SPECIFICATIONS FOR ROAD AND BRIDGE CONSTRUCTION, UNLESS STATED OTHERWISE IN THE SPECIFICATIONS OR ON THE PLANS OR IN THE GEOTECHNICAL ENGINEERING REPORT.
- THE CONTRACTOR SHALL STAKE ALL IMPROVEMENTS USING THE GEOMETRIC DATA PROVIDED. IT IS THE CONTRACTOR'S SOLE RESPONSIBILITY TO COMPLETELY STAKE AND CHECK ALL IMPROVEMENTS TO ENSURE ADEQUATE POSITIONING, BOTH HORIZONTAL AND VERTICAL, PRIOR TO THE INSTALLATION OF ANY IMPROVEMENTS. THE CONTRACTOR SHALL NOTIFY THE ENGINEER IMMEDIATELY IN WRITING IF ANY APPARENT DISCREPANCIES ARE
- 3. ALL AREAS WHICH ARE DISTURBED DURING CONSTRUCTION UNLESS OTHER WISE NOTED SHALL BE VEGETATED PER THE LANDSCAPE ARCHITECTS PLANS. ALL SLOPES STEEPER THAN 5:1 SHALL BE SODDED. ALL OTHER DISTURBED AREAS ARE TO BE FERTILIZED, SEEDED AND MULCHED UNLESS OTHERWISE NOTED. THESE AREAS SHALL BE MAINTAINED BY THE CONTRACTOR UNTIL A SATISFACTORY STAND OF GRASS IS ESTABLISHED OR PERMANENT LANDSCAPE MATERIALS HAVE BEEN INSTALLED.
- 4. ALL FILL SHALL BE COMPACTED TO 95% OF MAXIMUM DENSITY (AASHTO T-180), UNLESS OTHERWISE NOTED ON THE PLANS, IN THE SPECIFICATIONS OR THE GEOTECHNICAL REPORT.
- 5. FRONT OF HOUSE AREA PAVEMENT FINISHES AND DETAILS ARE PROVIDED BY THE ARCHITECT. BACK OF HOUSE AREA PAVEMENT FINISHES AND DETAILS ARE PROVIDED BY THE CIVIL ENGINEER. CONTRACTOR TO REFER TO THE CORRECT PLANS WHEN INSTALLING PAVEMENT.
- 6. TWO (2) WORKING DAYS NOTICE WILL BE GIVEN TO THE PROJECT MANAGER PRIOR TO TESTING ANY ROADWAY SHOWN ON THESE PLANS
- 7. CONTRACTOR SHALL REFER TO THE CIVIL DRAWINGS FOR SITE DRAINS AND PAVEMENT SLOPES. SLOPE THE PAVEMENT AS INDICATED ON THE GRADING PLAN OR IF NOT SHOWN, SLOPE THE ENTIRE PAVEMENT SURFACE WITHIN AN AREA TO THE STORM DRAINAGE STRUCTURE WHILE OBEYING CROSS SLOPE AND MAXIMUM SLOPE WITHIN THE AMERICANS WITH DISABILITIES ACT. PONDING WATER DUE TO IMPROPER SLOPES AND/OR DRAIN INLETS HIGHER OR LOWER THAN THE SURROUNDING PAVEMENT SURFACE SHALL BE CORRECTED AT THE CONTRACTOR'S EXPENSE.
- CONTRACTOR TO ENSURE THERE ARE NO FIELD DISCREPANCIES FOUND WHEN MATCHING EXISTING PAVEMENT ELEVATIONS TO THOSE STATED ON THE PLANS. CONTRACTOR TO INFORM THE ARCHITECT AND CIVIL ENGINEER IMMEDIATELY SHOULD ANY DISCREPANCIES BE FOUND.

STANDARD SEWER AND WATER NOTES

- 1. ALL EXISTING UTILITIES HAVE BEEN FIELD VERIFIED AT ALL POINTS OF CONNECTION TO AND AT ALL AREAS OF CONFLICT WITH ORANGE COUNTY UTILITIES (OCU) MAINS. ALTHOUGH THIS INFORMATION HAS BEEN OBTAINED FROM SURVEY DATA, THE CONTRACTOR MUST VERIFY FIELD CONDITIONS PRIOR TO CONSTRUCTION. DIFFERENCES DISCOVERED DURING CONSTRUCTION SHALL BE BROUGHT IMMEDIATELY TO THE PROJECT MANAGERS/ENGINEER'S ATTENTION AND RESOLVED IN ACCORDANCE WITH THE STANDARDS OF ORANGE COUNTY UTILITIES.
- 2. ALL UTILITIES (INCLUDING PUMP STATION IF APPLICABLE) LOCATED OUTSIDE PUBLIC RIGHT-OF-WAYS AND PUBLIC EASEMENTS SHALL BE PRIVATELY OWNED AND MAINTAINED.
- THE WET SEASON AND FOURTEEN (14) CALENDAR DAYS DURING THE DRY SEASON. IN ADDITION, ALL 3. A MINIMUM OF 3 FEET OF COVER SHALL BE MAINTAINED OVER ALL PROPOSED WATER, WASTEWATER, AND RECLAIMED WATER MAINS.
 - 4. WHERE POTABLE WATER AND SANITARY UTILITIES (SANITARY SEWER, FORCE MAIN, REUSE WATER) CROSS WITH LESS THAN EIGHTEEN (18) INCHES VERTICAL CLEARANCE, THE SEWAGE MAIN SHALL BE CONCRETE ENCASED PVC PIPE OR ENCASED IN A WATERTIGHT CARRIER PIPE, CENTERED ON THE POINT OF CROSSING. A MINIMUM HORIZONTAL SEPARATION OF SIX (6) TO TEN (10) FEET (EDGE TO EDGE) BETWEEN POTABLE WATER MAINS AND SEWAGE MAINS SHALL BE MAINTAINED WHEN PRACTICAL. WHEN THE APPROPRIATE HORIZONTAL SEPARATION CANNOT BE MAINTAINED THE SEWAGE MAIN SHALL BE CONCRETE ENCASED PVC PIPE OR ENCASED IN A WATERTIGHT CARRIER PIPE.
 - ALL WATER MAIN AND SANITARY SEWER MATERIALS AND APPURTENANCES CONNECTING TO THE ORANGE COUNTY PUBLIC UTILITY SYSTEM SHALL CONFORM TO AND SHALL BE INSTALLED, TESTED AND CLEARED FOR SERVICE IN ACCORDANCE WITH THE "MANUAL OF STANDARDS AND SPECIFICATIONS FOR WASTEWATER AND WATER MAIN CONSTRUCTION" FOR ORANGE COUNTY AND THE REQUIREMENTS OF THE FLORIDA DEPARTMENT OF ENVIRONMENTAL PROTECTION.
 - 6. THE CONTRACTOR SHALL PERFORM HYDROSTATIC TESTING OF ALL NEWLY INSTALLED WATER DISTRIBUTION SYSTEM AND OTHER PRESSURIZED PIPING IN ACCORDANCE WITH THE ORANGE COUNTY UTILITIES STANDARDS AND IN ACCORDANCE WITH AWWA STANDARD C600 FOR DUCTILE IRON PIPE. TESTING SHALL BE IN ACCORDANCE WITH AWWA MANUAL M23 FOR PVC PIPE.
 - 7. THE CONTRACTOR SHALL DISINFECT ALL SECTIONS OF THE WATER DISTRIBUTION SYSTEM IN ACCORDANCE WITH THE FDEP WATER PERMIT, AND RECEIVE APPROVAL THEREOF FROM THE LOCAL WATER UTILITY, ENGINEER OF RECORD, AND FDEP, PRIOR TO PLACING IN SERVICE. IT IS THE CONTRACTOR'S RESPONSIBILITY TO OBTAIN COPIES OF THE FDEP WATER AND SEWER PERMITS FROM THE PROJECT MANAGER AND MAINTAIN THEM ON THE JOB SITE AT ALL TIMES. DISINFECTION OF THE WATER DISTRIBUTION SYSTEM SHALL BE PERFORMED IN ACCORDANCE WITH AWWA 651 "DISINFECTING WATER MAINS" AND THE "2011 OCU STANDARDS AND CONSTRUCTIONS MANUAL"
 - 8. ALL POTABLE WATER MAIN MUST BEAR THE "NSF" LOGO.
 - 9. WATER MAIN PVC PIPE FOUR (4) INCH THROUGH TWELVE (12) INCH MUST BE AWWA C900, CLASS 150, DR 18.
 - 10. PLASTIC WATER SERVICE PIPING AND FITTINGS 1 THROUGH 2 INCHES SHALL CONFORM TO THE REQUIREMENTS OF AWWA C800 AND C901 (POLYETHYLENE TUBING). PVC SERVICE PIPING TWO (2) INCHES THROUGH THREE (3) INCHES SHALL BE SDR 14.
 - 11. PVC GRAVITY SEWER FOUR (4) INCH THROUGH (15) INCH SHALL BE SDR 35. JOINTS SHALL BE INTEGRAL BELL ELASTOMERIC GASKET IN ACCORDANCE WITH ASTM D3212 AND ASTM F477. ALL PVC SEWER SHALL BEAR THE "NSF-DW SEAL."
 - 12. UNDERGROUND FIRE LINES FROM THE POINT OF SERVICE (P.O.S.) TO THE BUILDING SHALL MEET NFPA 24 REQUIREMENTS.
 - 13. ALL UNDERGROUND UTILITY PIPING SHALL HAVE A MINIMUM OF (3) FEET OF COVER UNLESS SHOWN OTHERWISE ON THE PLANS OR AS DIRECTED BY THE ENGINEER.
 - PERMITS, ELECTRICAL PERMITS OR OTHER PERMITS AS APPLICABLE. CONTRACTOR IS TO COORDINATE FULLY WITH UTILITY COMPANIES ON EXACT LOCATION OF UNDERGROUND UTILITIES PRIOR TO EXCAVATION.
 - 15. ALL WATER AND SEWER LINES ARE TO BE CAPPED TEMPORARILY AT THEIR OPEN ENDS UNTIL CONNECTIONS ARE CONSTRUCTED.
 - 16. TWO WORKING DAYS NOTICE WILL BE GIVEN TO THE PROJECT MANAGER AND ORANGE COUNTY INSPECTORS PRIOR TO START OF CONSTRUCTION AND TESTING OF ANY UTILITY SHOWN ON THESE PLANS. THE CONTRACTOR SHALL PERFORM PRE-TESTS OF THE UTILITIES PRIOR TO NOTIFICATION TO THE ENGINEER AND ORANGE COUNTY INSPECTOR. ADDITIONAL REINSPECTIONS DUE TO FAILED TESTING WILL BE PAID FOR BY THE CONTRACTOR. CONTACT ORANGE COUNTY UTILITIES AT 407-254-9798.
 - 17. WHEN TRENCH EXCAVATION EXCEEDS 5 FEET IN DEPTH: A. CONTRACTOR SHALL CONFORM TO OSHA STD. 29CFR. SECTION 1926.650. B. THE CONTRACTOR SHALL PROVIDE WRITTEN ASSURANCE OF COMPLIANCE WITH THIS LAW. C. TRENCH SAFETY SYSTEM SHALL BE BY THE CONTRACTOR.
 - 19. ON-SITE WASTEWATER COLLECTION SYSTEM SHALL BE PRIVATELY OWNED AND MAINTAINED.
 - 20. ON-SITE WATER DISTRIBUTION SYSTEM SHALL BE PRIVATELY OWNED AND MAINTAINED.
 - 21. ON-SITE MANHOLE COVER WILL NOT HAVE "ORANGE COUNTY" ON COVER.

- 22. THIS PROJECT REQUIRES A FDEP SEWER CONSTRUCTION PERMIT. THE CONTRACTOR SHOULD REQUEST A COPY OF THIS PERMIT AND KEEP IT AT THE JOB SITE AT ALL TIMES DURING CONSTRUCTION. IT IS THE CONTRACTOR'S RESPONSIBILITY TO "NOT" PUT THE SYSTEM INTO SERVICE (EXCEPT FOR NECESSARY TESTING) UNTIL THE CONTRACTOR HAS PROVIDED CERTIFIED "AS-BUILT" PLANS TO THE ENGINEER OF RECORD, AND THE ENGINEER HAS OBTAINED A CLEARANCE LETTER FROM FDEP. FROM THE TIME AS-BUILT DRAWINGS ARE APPROVED BY THE ENGINEER THE ESTIMATED TIME FOR PROCESSING AND RECEIPT OF THE F.D.E.P. CERTIFICATION IS 30 TO 45 DAYS.
- 23. THIS PROJECT REQUIRES A FDEP WATER DISTRIBUTION SYSTEM PERMIT. THE CONTRACTOR SHOULD REQUEST A COPY OF THIS PERMIT AND KEEP IT AT THE JOB SITE AT ALL TIMES DURING CONSTRUCTION. IT IS THE CONTRACTOR'S RESPONSIBILITY TO "NOT" PUT THE SYSTEM INTO SERVICE UNTIL THE CONTRACTOR HAS PROVIDED CERTIFIED "AS-BUILT" PLANS AND COPIES OF THE APPROVED BACTERIOLOGICAL TESTING HAS BEEN SUBMITTED TO THE ENGINEER OF RECORD, AND THE ENGINEER HAS PROVIDED A COPY OF THE FDEP CLEARANCE LETTER TO THE CONTRACTOR, ALLOWING THE SYSTEM TO BE PLACED INTO OPERATION. PROVIDE BAC T'S AT POINTS SPECIFIED IN THE F.D.E.P. PERMIT. BAC T' REPORT CANNOT BE OLDER THAN 30 DAYS AT THE TIME IT IS SUBMITTED TO F.D.E.P. FROM THE TIME AS-BUILT DRAWINGS ARE APPROVED BY THE ENGINEER THE ESTIMATED TIME FOR PROCESSING AND RECEIPT OF THE F.D.E.P. CERTIFICATION IS 30 TO 45 DAYS.
- 24. ALL UTILITIES CONNECTING TO THE ORANGE COUNTY SYSTEM SHALL BE IN CONFORMANCE WITH THE 2011 OCU STANDARDS AND CONSTRUCTION SPECIFICATIONS MANUAL.
- 25. CONTRACTOR TO COORDINATE EFFORTS AND TIMING SO THAT EXISTING POTABLE WATER AND SANITARY SEWER LINE REMAIN IN SERVICE UNTIL SUCH TIME AS THE PROPOSED POTABLE WATER AND SANITARY LINES HAVE BEEN INSTALLED AND F.D.E.P. CLEARANCE CERTIFICATION HAS BEEN RECEIVED.
- 26. CONTRACTOR TO COORDINATE EFFORTS AND TIMING SO THAT EXISTING SEWER LINES REMAIN IN SERVICE UNTIL SUCH TIME AS THE PROPOSED SEWER LINES HAVE BEEN INSTALLED, AS-BUILT PROVIDED AND ACCEPTED BY

AS-BUILT SUBMITTAL

THE CONTRACTOR SHALL SUBMIT SIX SETS OF PLANS AND AN AUTOCAD FILE ON A CD OF THE AS-BUILT DRAWINGS PREPARED BY A REGISTERED SURVEYOR TO HCE FOR REVIEW. THE AS-BUILT DRAWINGS SHALL CONTAIN THE FOLLOWING INFORMATION:

WATER LINES

THE AS-BUILT PLANS SHALL SHOW COORDINATES AND ELEVATIONS FOR TOP OF ALL THE PROPOSED WATER MAINS, LATERALS AND APPURTENANCES, I.E. TIE-IN POINT, BENDS, TEES, VALVES & BOXES, FIRE HYDRANTS, METERS, BACKFLOW UNITS, STUBS, ETC. NOTE ALL PIPE MATERIALS, SIZES AND ANY CONCRETE ENCASEMENT OR SLEEVES. AS-BUILT PLANS ARE TO INCLUDE THE NUMBER OF TEST POINTS AND LOCATIONS OF THE BACTERIOLOGICAL SAMPLE AS STIPULATED IN THE FDEP PERMIT.

SANITARY SEWER

THE AS-BUILT PLANS SHALL SHOW COORDINATES AND ELEVATIONS FOR ALL MANHOLE RIMS AND PIPE INVERTS, CLEANOUTS AND INVERTS, WYES AND LATERALS WITH TOP OF PIPE ELEVATIONS PLUS PIPE SIZES, LENGTHS AND MATERIAL TYPES. AS-BUILT DATA SHALL ALSO INCLUDE THE LOCATIONS OF CHANGE IN MATERIALS AND CONCRETE

STORM DRAINAGE

THE AS-BUILT PLANS SHALL SHOW COORDINATES AND ELEVATIONS FOR ALL MANHOLES, INLETS, CATCH BASINS, RIMS AND PIPE INVERTS, CLEANOUTS AND INVERTS, WYES AND LATERALS WITH TOP OF PIPE ELEVATIONS PLUS PIPE SIZES, LENGTHS AND MATERIAL TYPES. AS-BUILT COORDINATES AND TOP OF PIPE ELEVATIONS FOR BEACH LANDSCAPE SOCK DRAIN PIPES SHALL BE PROVIDED EVERY 25' ALONG THE PIPE.

EXISTING UTILITIES

WHEN EXISTING UTILITIES ARE CROSSED OR ENCOUNTERED THE TYPE OF CROSSING SHALL BE NOTED ALONG WITH THE LOCATION, TYPE, SIZE, MATERIAL AND ELEVATION. THE AS-BUILT DATA FOR ALL EXISTING UTILITIES ENCOUNTERED SHALL MEET THE WATER LINE, SANITARY SEWER AND STORM SEWER REQUIREMENTS NOTED ABOVE.

HARRIS CIVIL ENGINEERS, LLC. (HCE) WILL REVIEW THE AS-BUILT DRAWINGS FOR COMPLIANCE WITH THE PLANS AND GOVERNMENTAL PERMITS AND ISSUE COMMENTS TO THE CONTRACTOR.


UPON HCE REVIEW(S) AND COMPLETION OF ANY COMMENTS AND CORRECTIVE WORK, HCE WILL ADVISE THE CONTRACTOR ON THE NUMBER OF SIGNED AND SEALED AS-BUILT DRAWINGS THAT ARE NEEDED FOR CERTIFICATION TO THE VARIOUS GOVERNMENTAL AGENCIES. ONCE SUBMITTED, CERTIFICATION AND ACCEPTANCE COULD TAKE FROM 30 TO 45 DAYS FOR EACH PERMIT.

Harris Civil Engineers, LLC


1200 Hillcrest Street Suite 200 Orlando, Florida 32803

Phone: (407) 629-4777 Fax: (407) 629-7888


www.harriscivilengineers.com

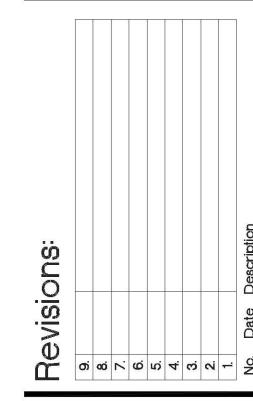



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Release:

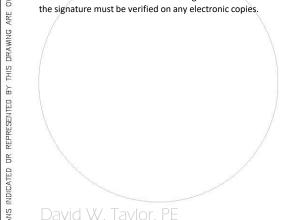



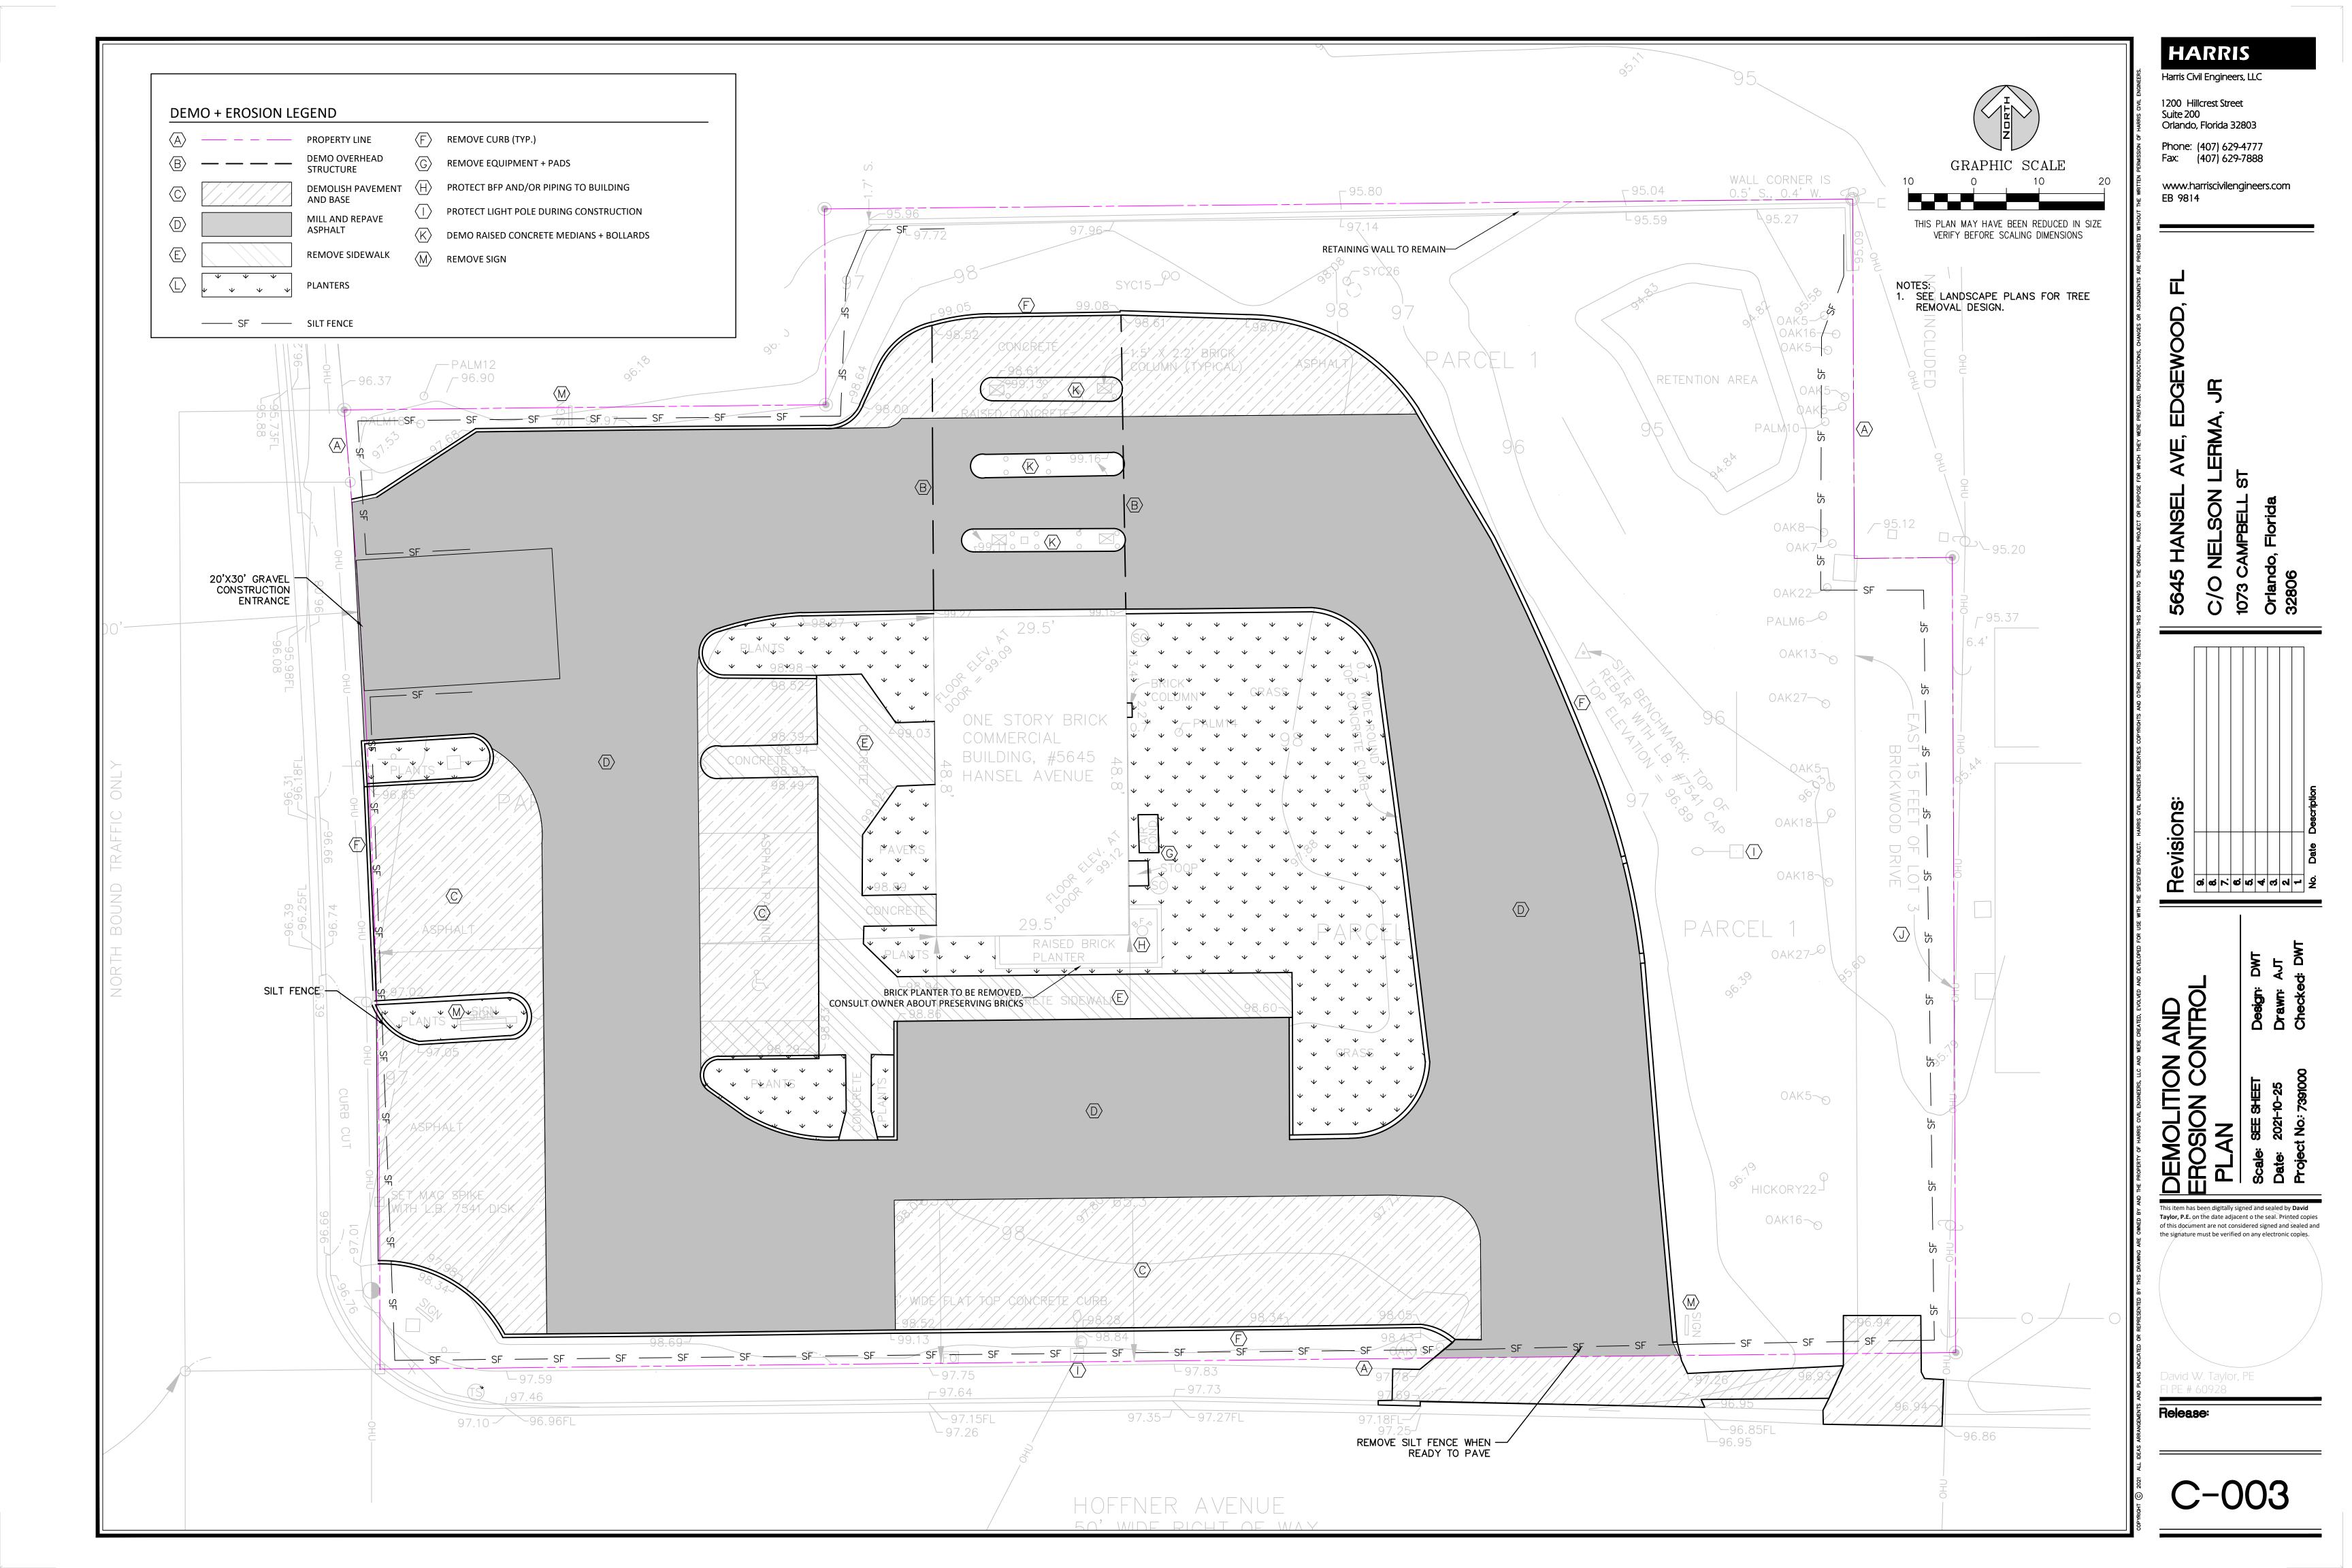

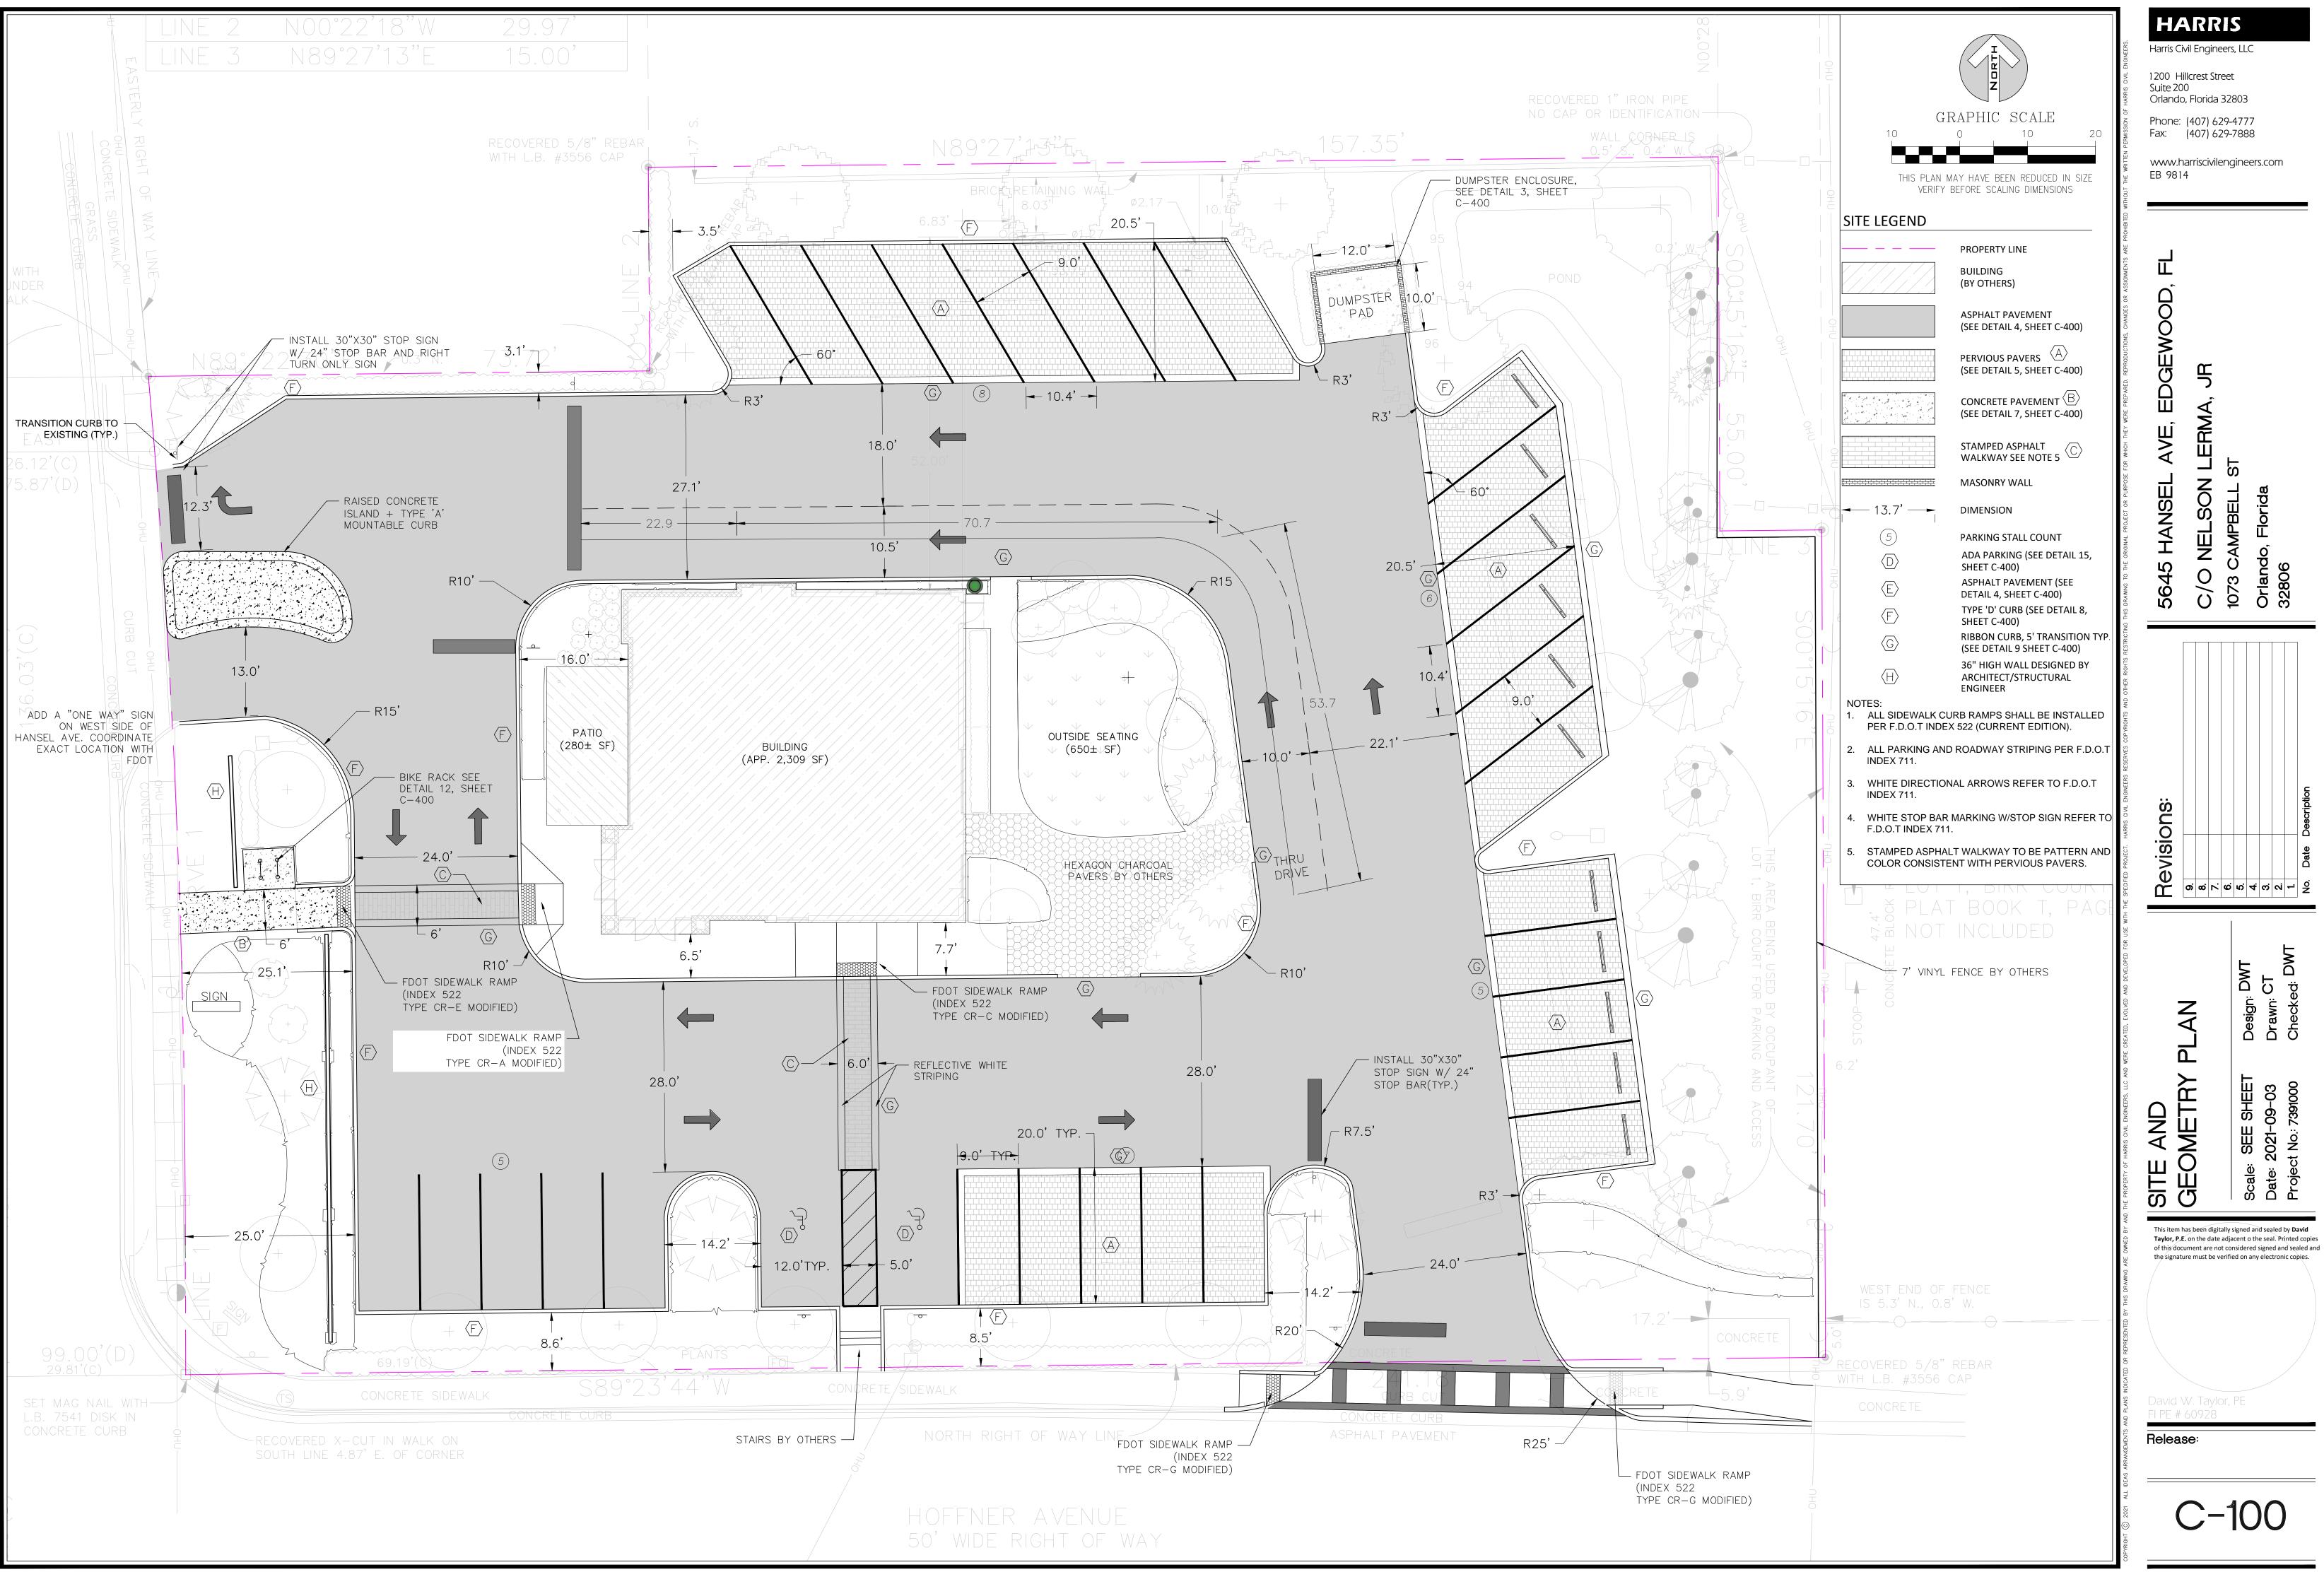HARRIS

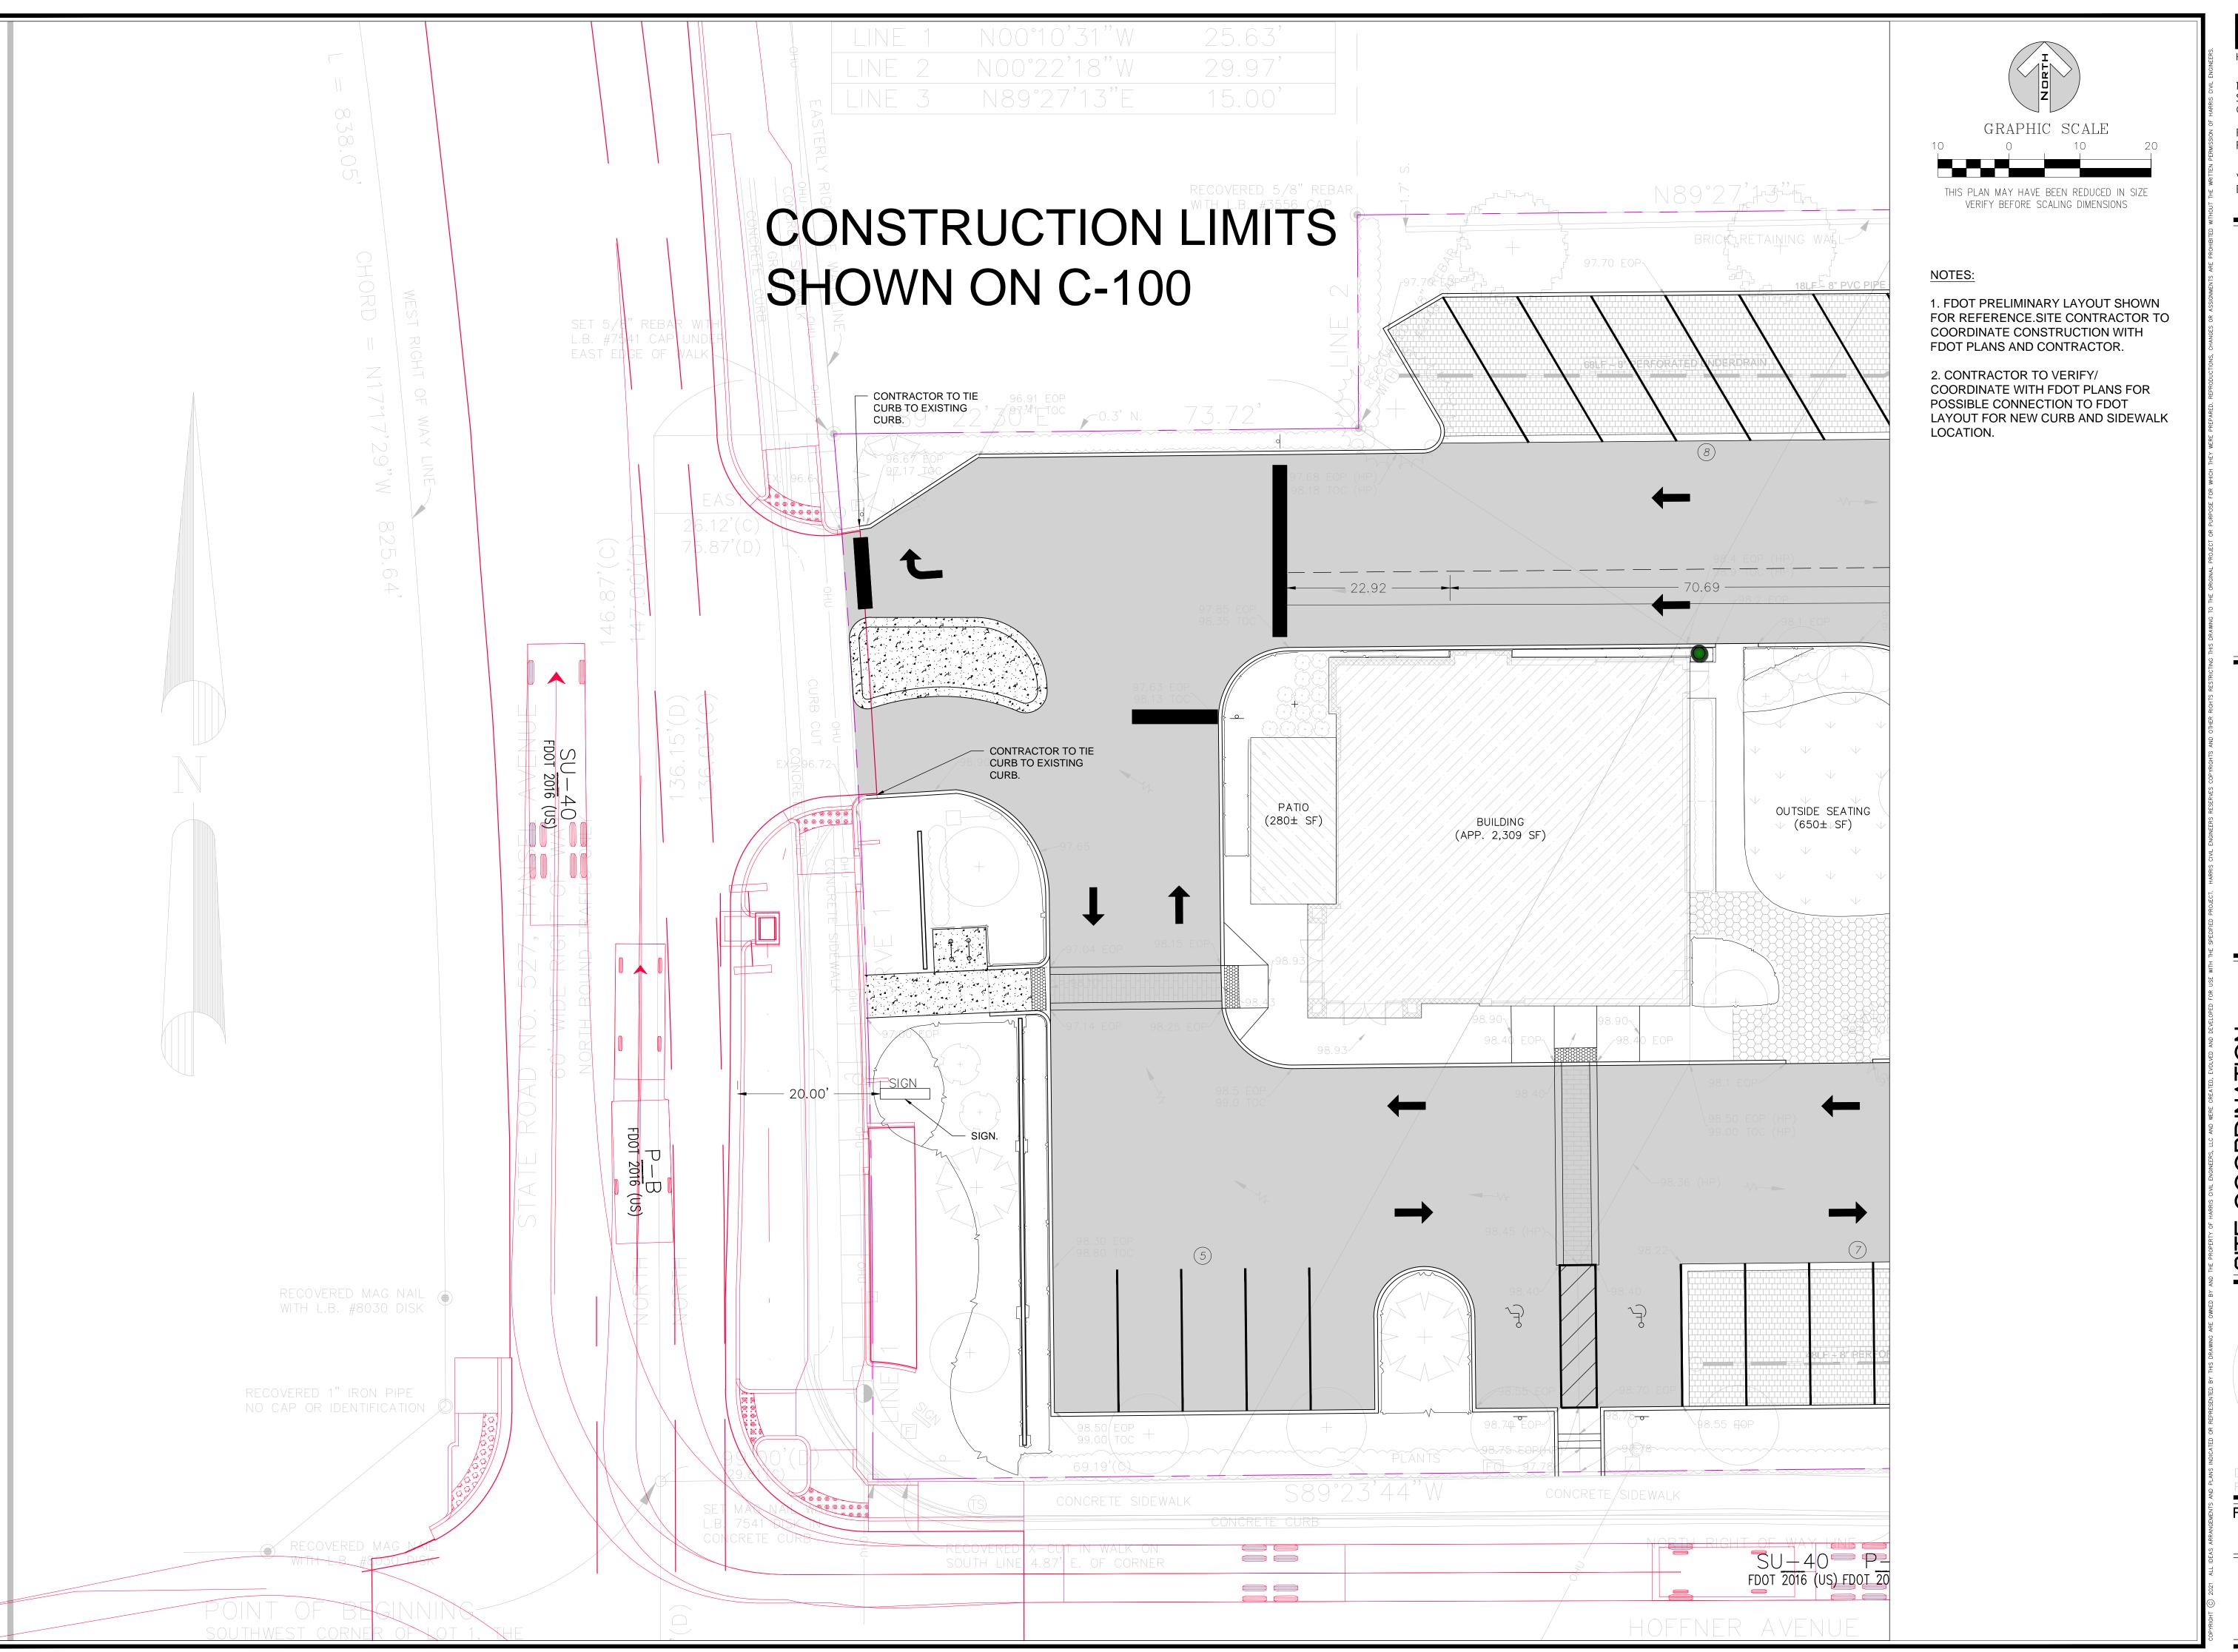Harris Civil Engineers, LLC

1200 Hillcrest Street Suite 200 Orlando, Florida 32803

Phone: (407) 629-4777 Fax: (407) 629-7888

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Д. .-.-

NELSON LERMA, JR


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Design: DWT
Drawn: AJT

Scale: SEE SHEE! Date: 2021-09-25 Project No: 7391000


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PE # 60928

Release

C-101

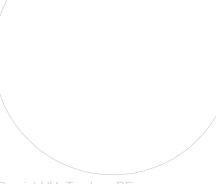



Fax: (407) 629-7888

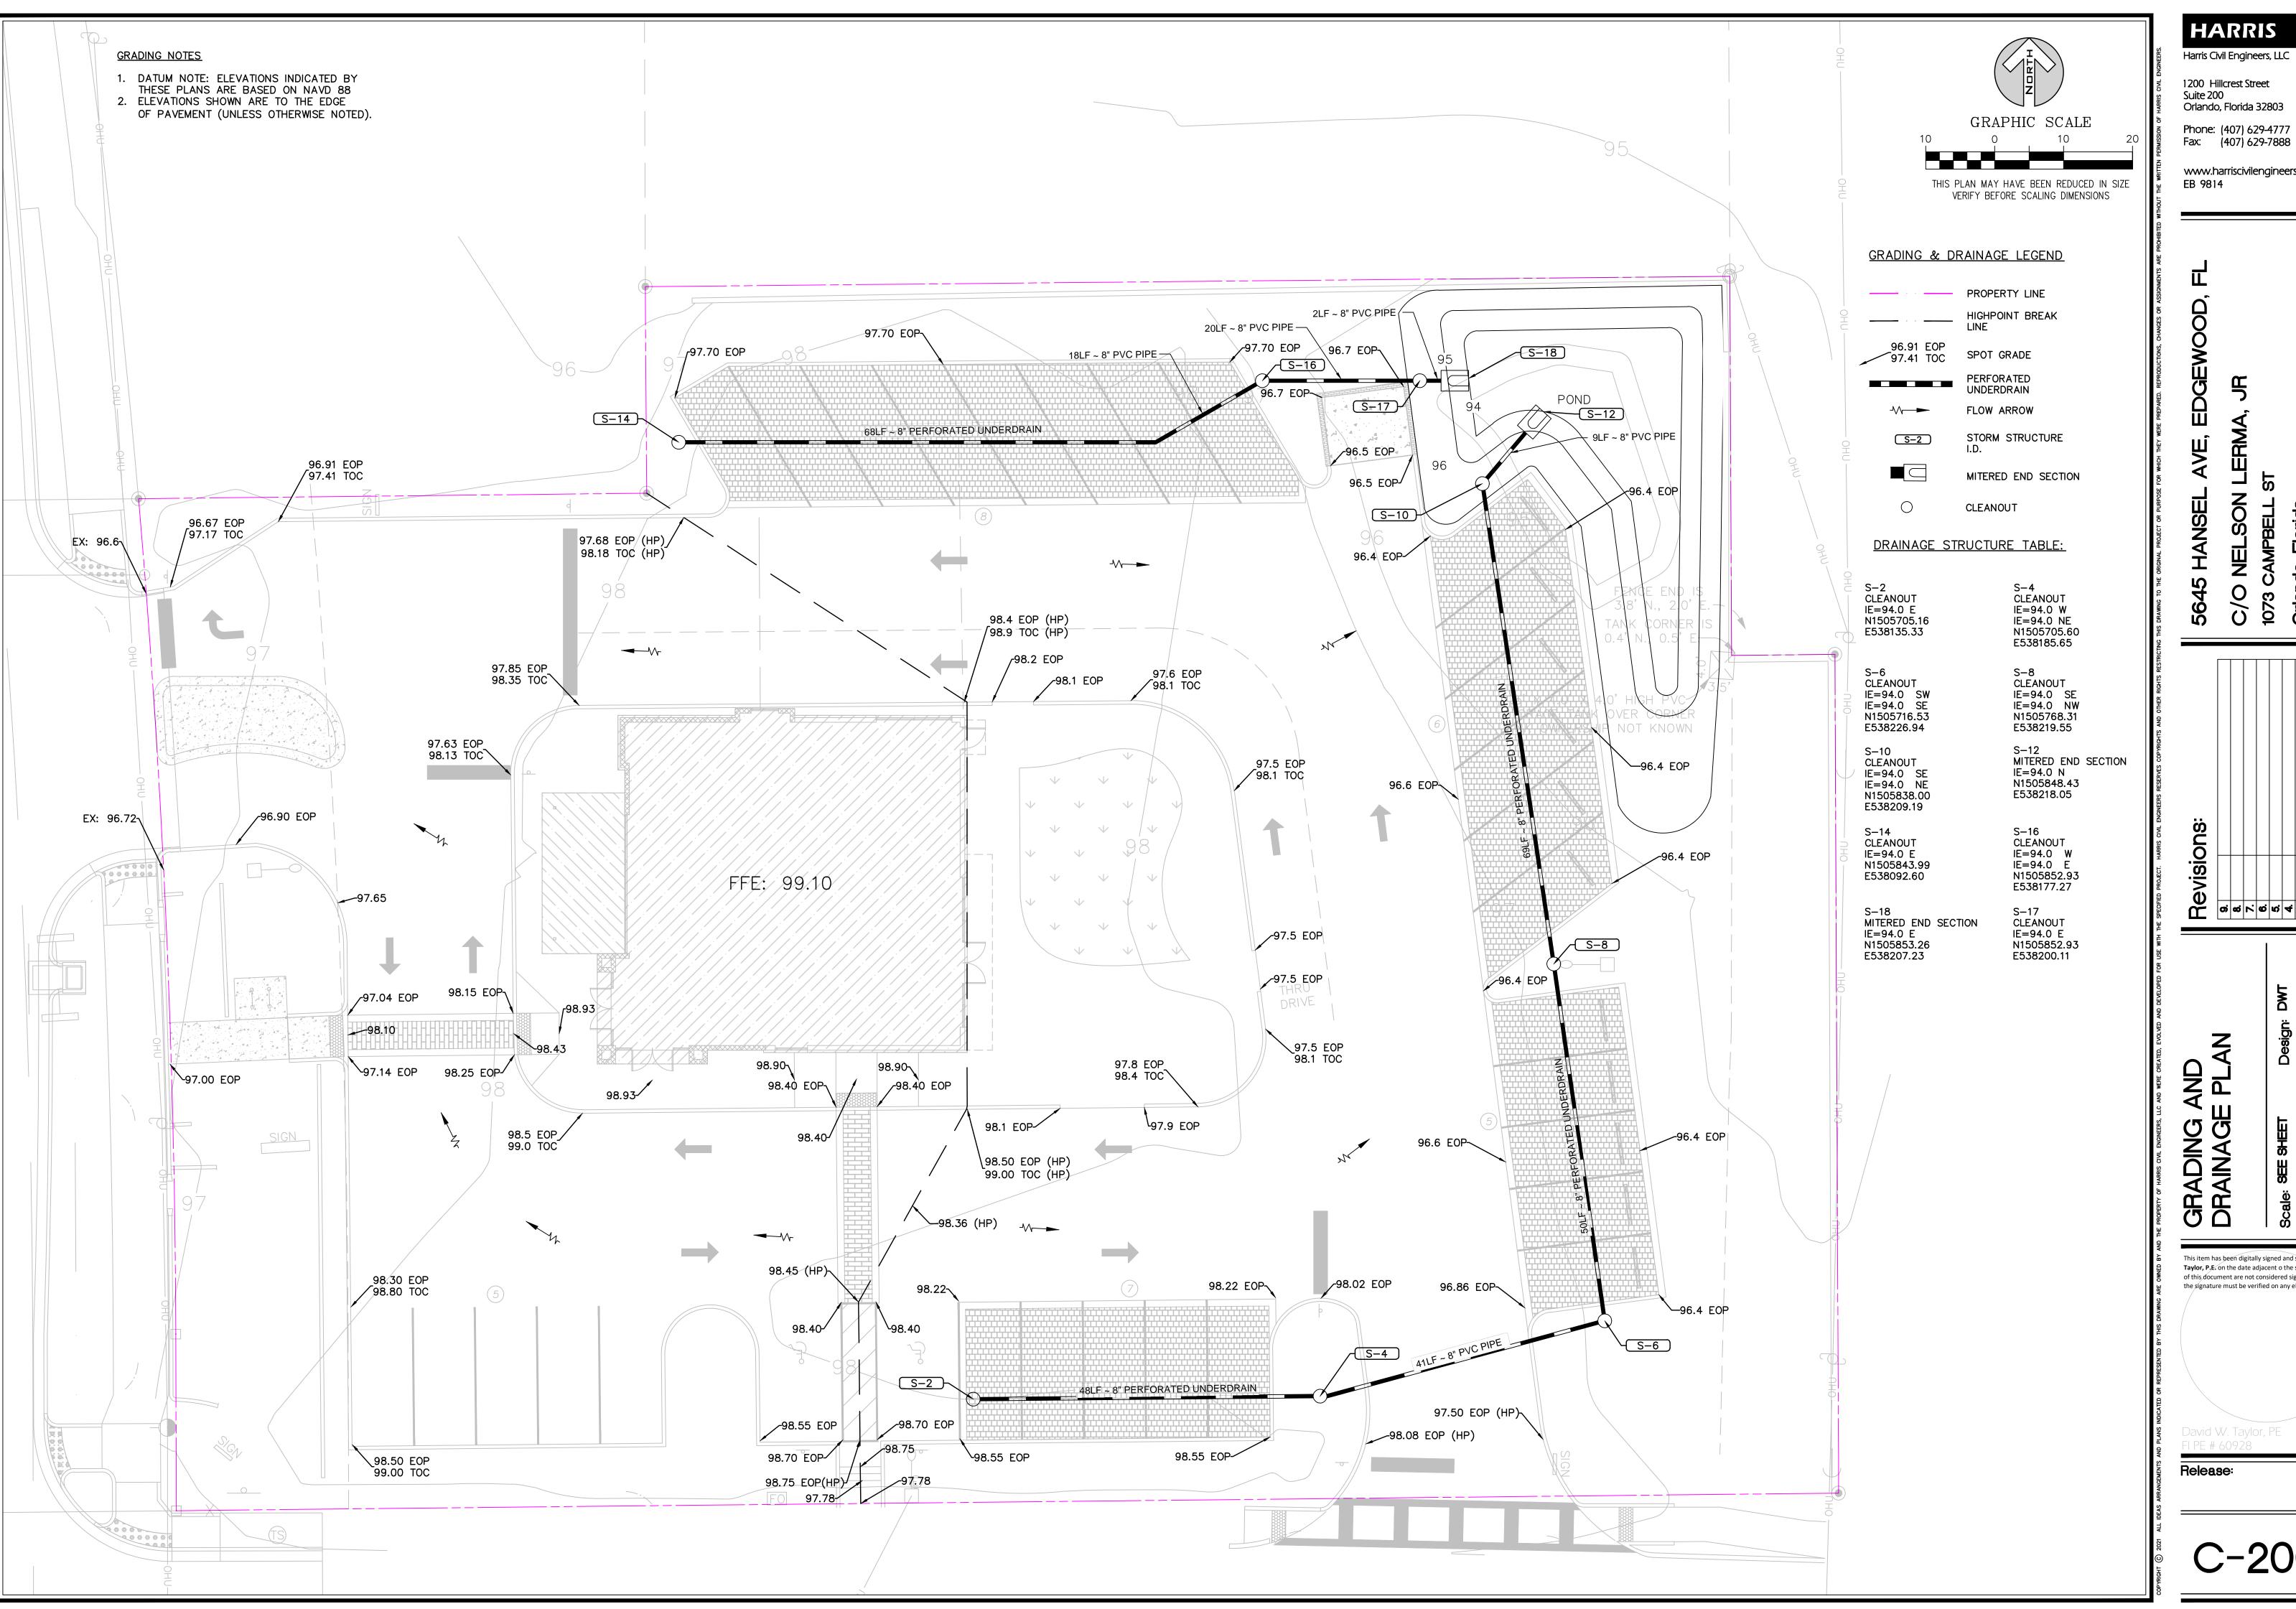
www.harriscivilengineers.com

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PLAN

1. 30" FROM INSIDE OF RAIL TO INSIDE OF RAIL MIN.

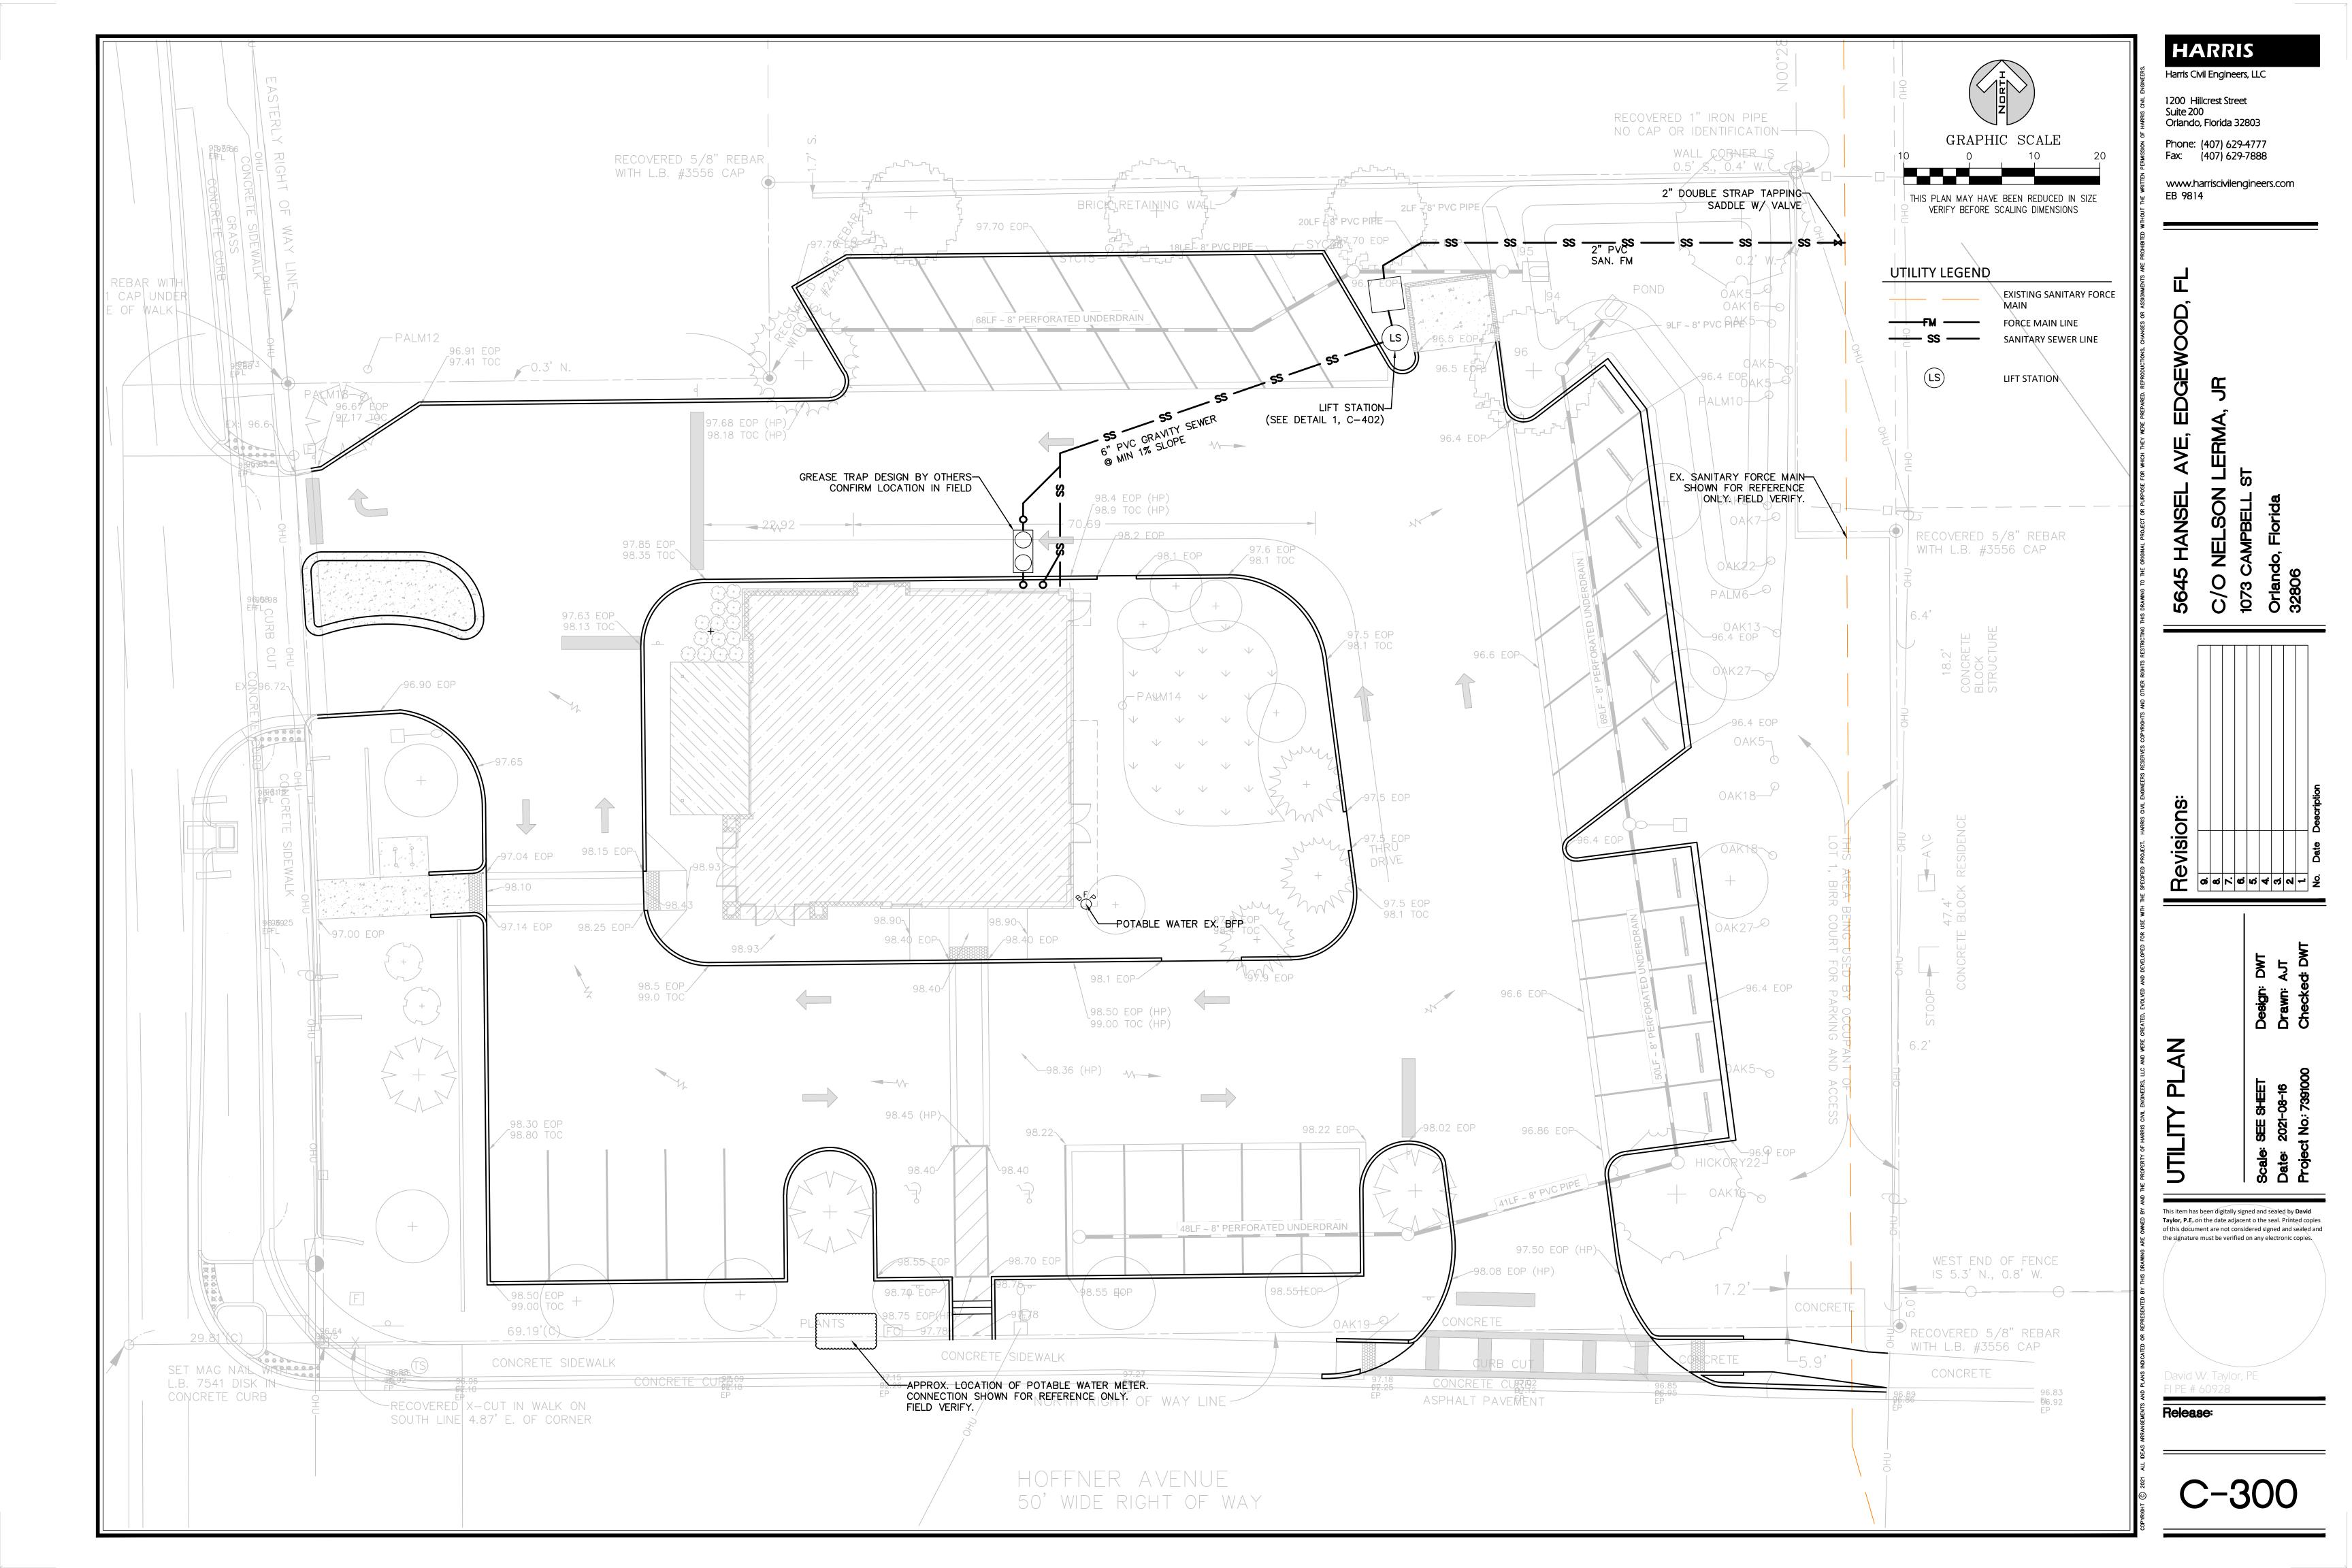
BIKE RACK DETAIL

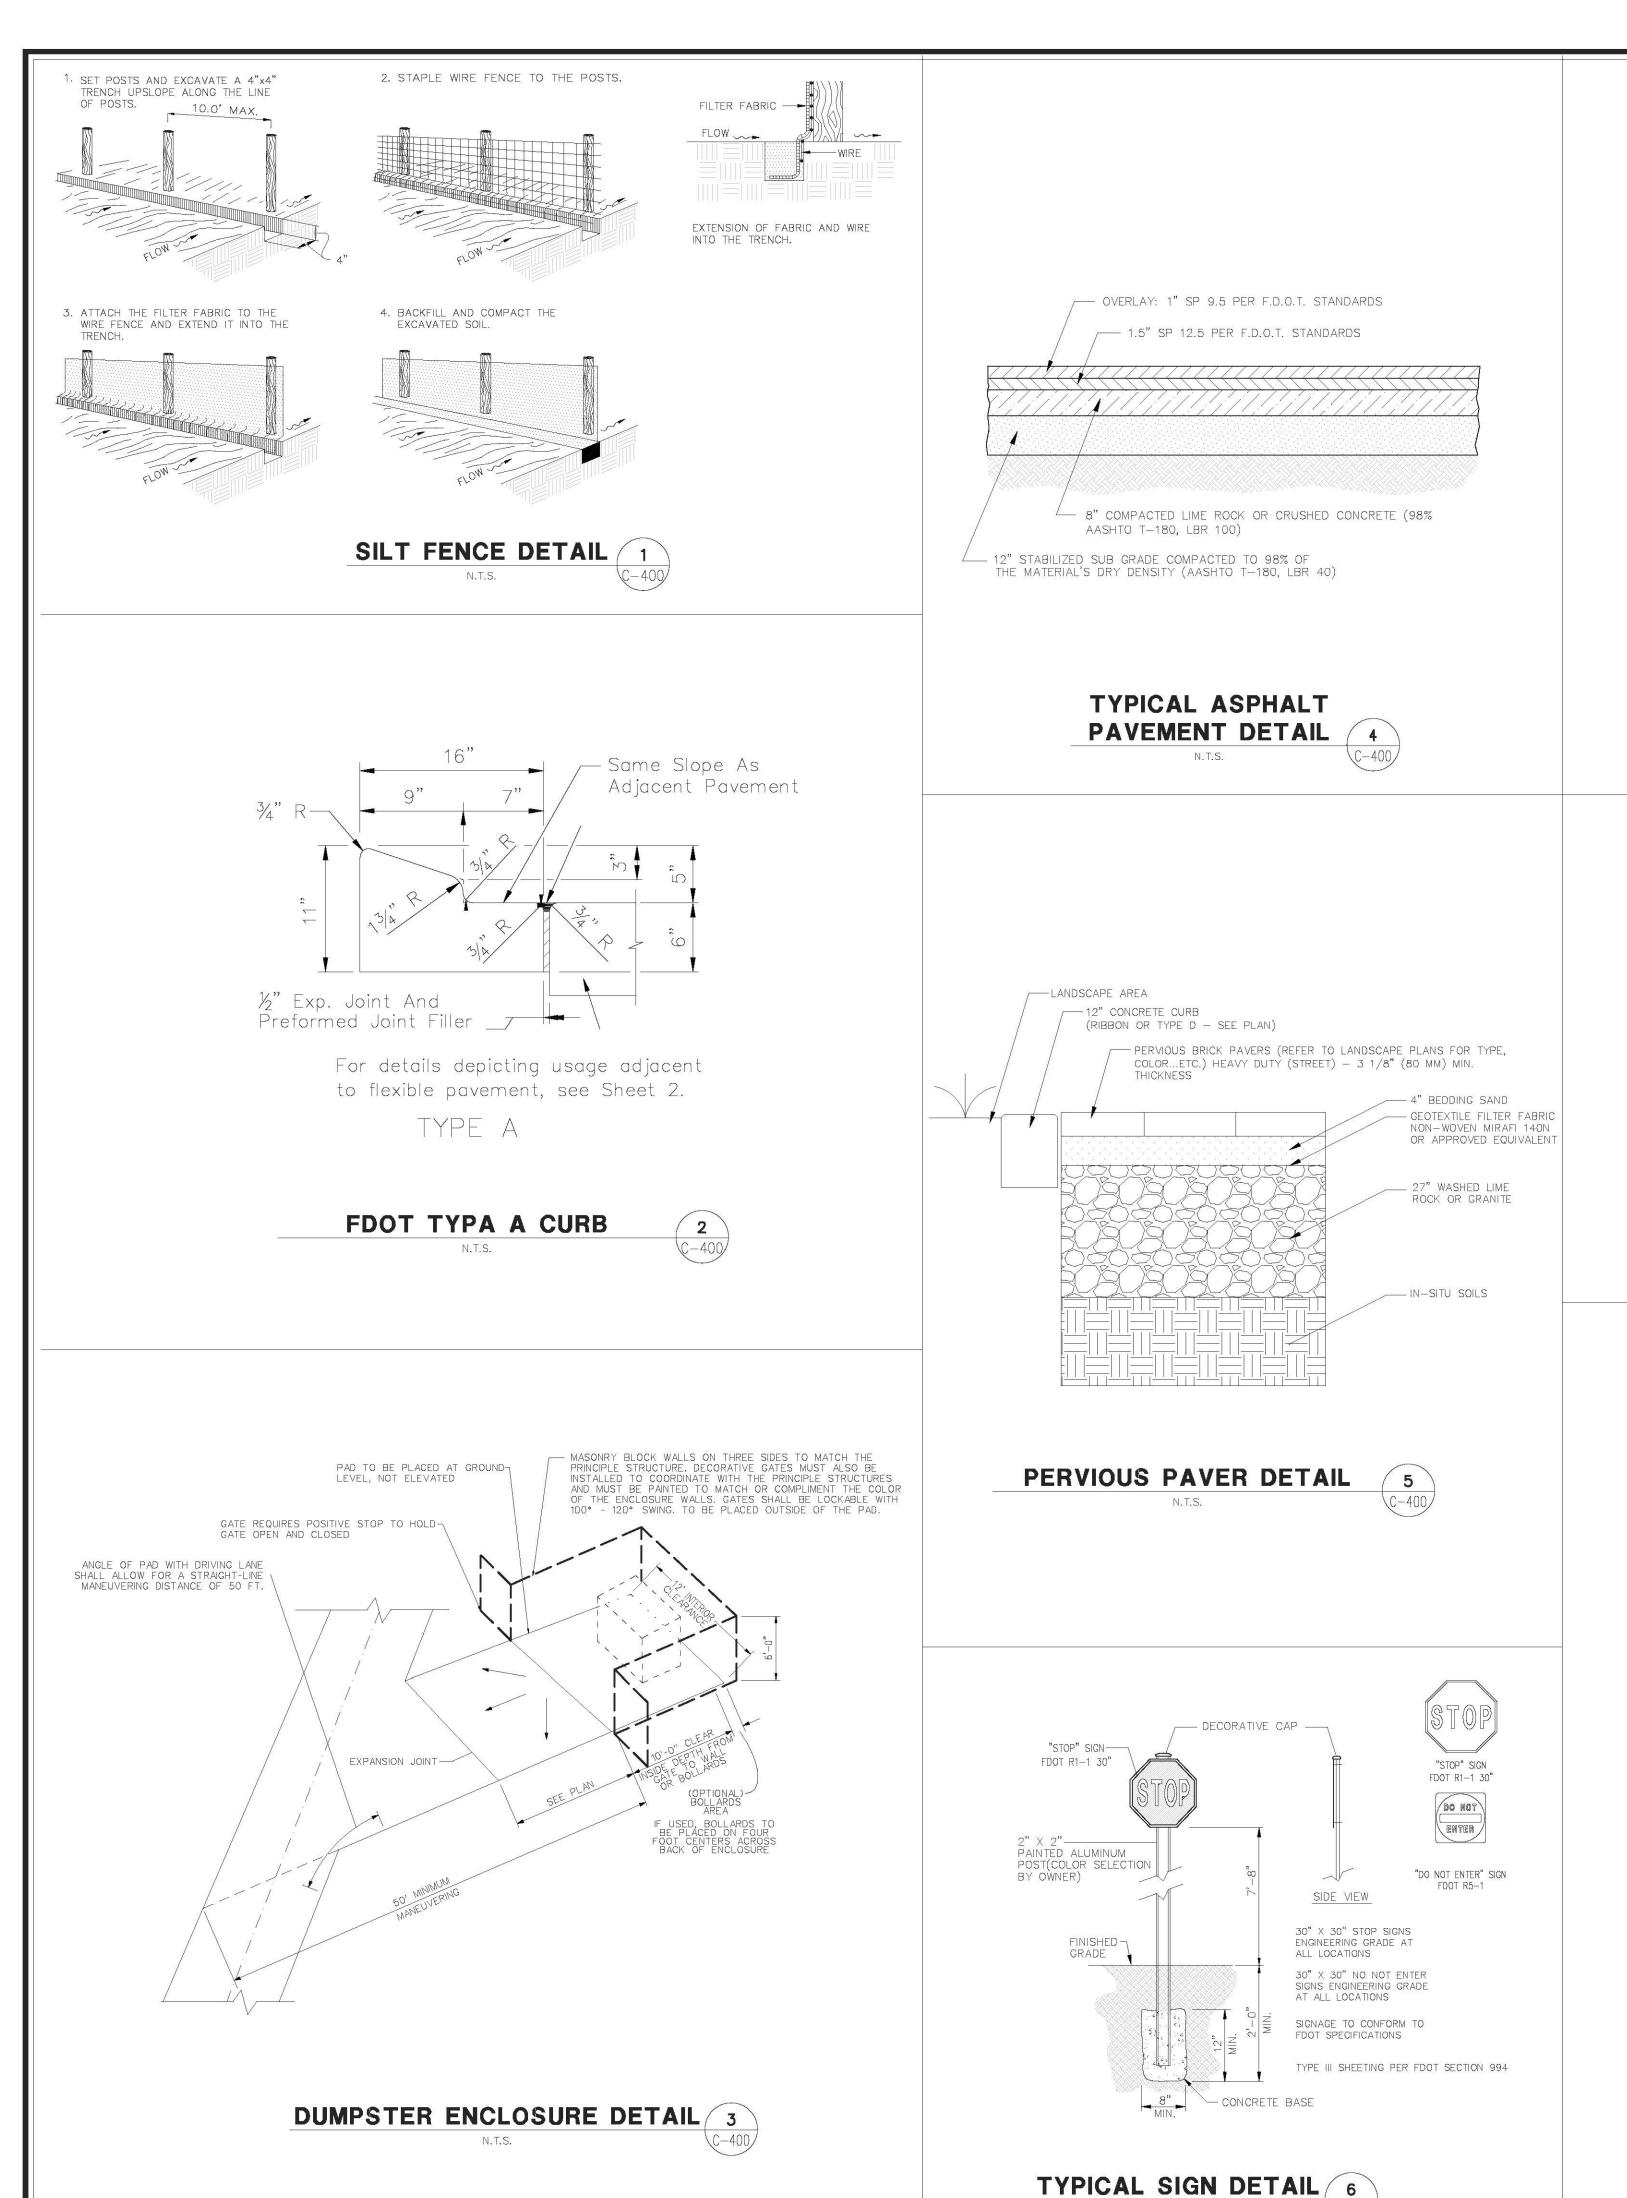
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2. 30" FROM OUTSIDE OF RAIL TO EDGE OF CONCRETE MIN.

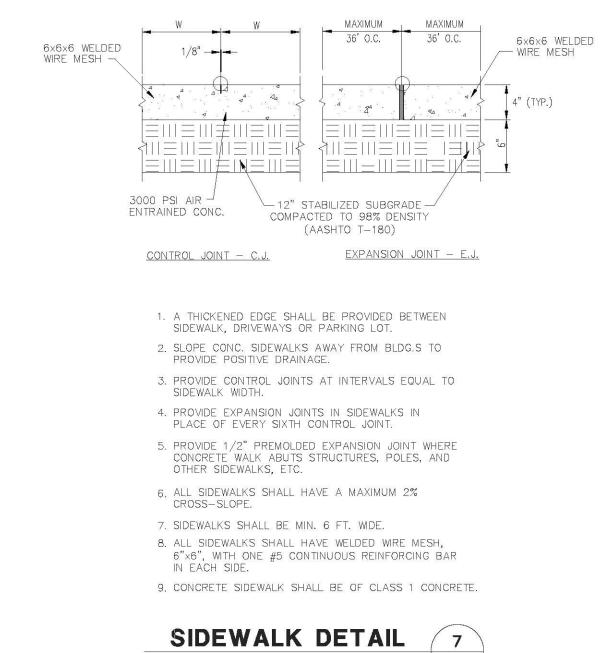3. SEE IMAGE BELOW FOR VISUAL REFRENCE OF BIKE RACKS

NOTES:



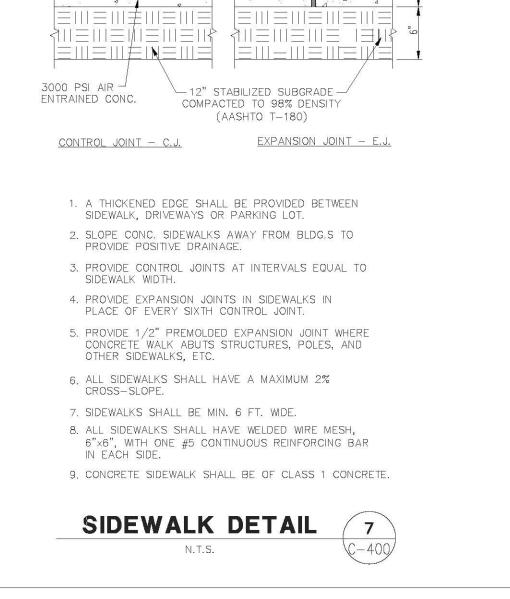
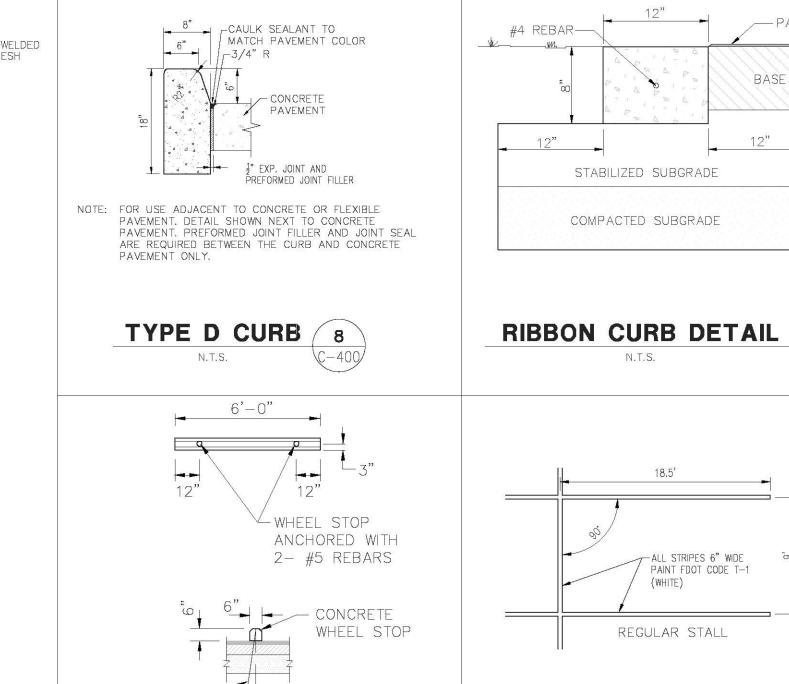
#5 REBAR.

WHEELSTOP DETAIL 10



PAVEMENT

BASE

HARRIS

1200 Hillcrest Street

Orlando, Florida 32803


Phone: (407) 629-4777 Fax: (407) 629-7888

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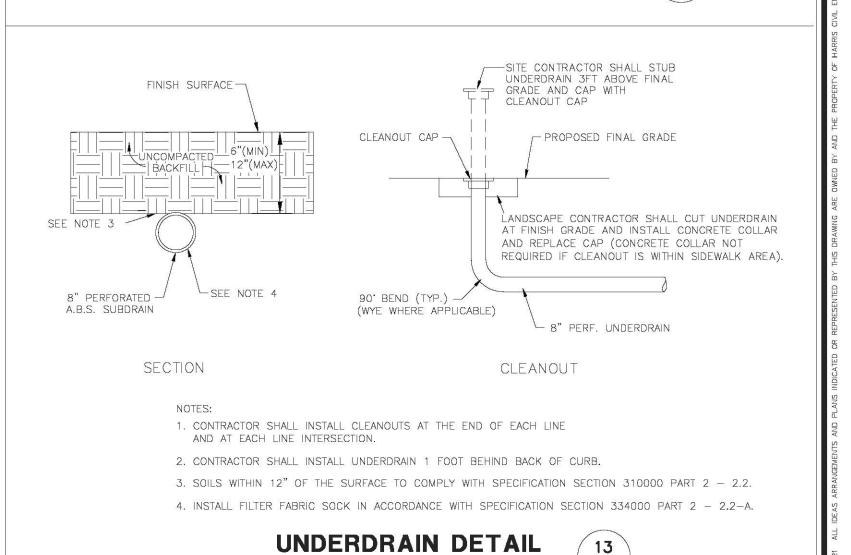
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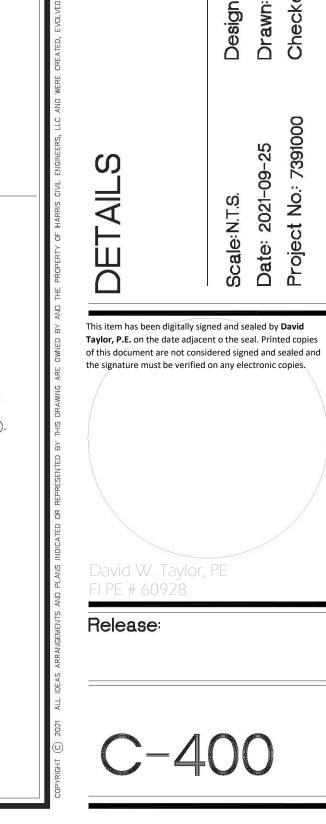
EB 9814

Harris Civil Engineers, LLC






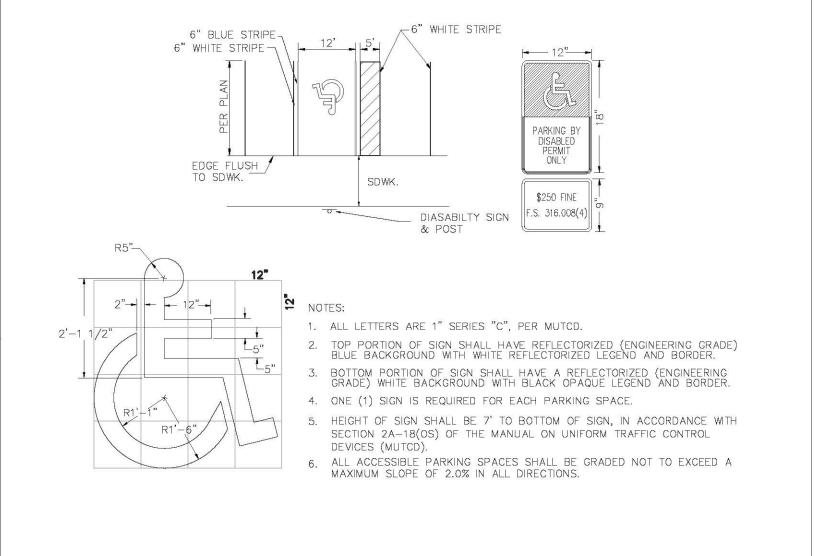




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CURB RAMP CR-A DETAIL 2

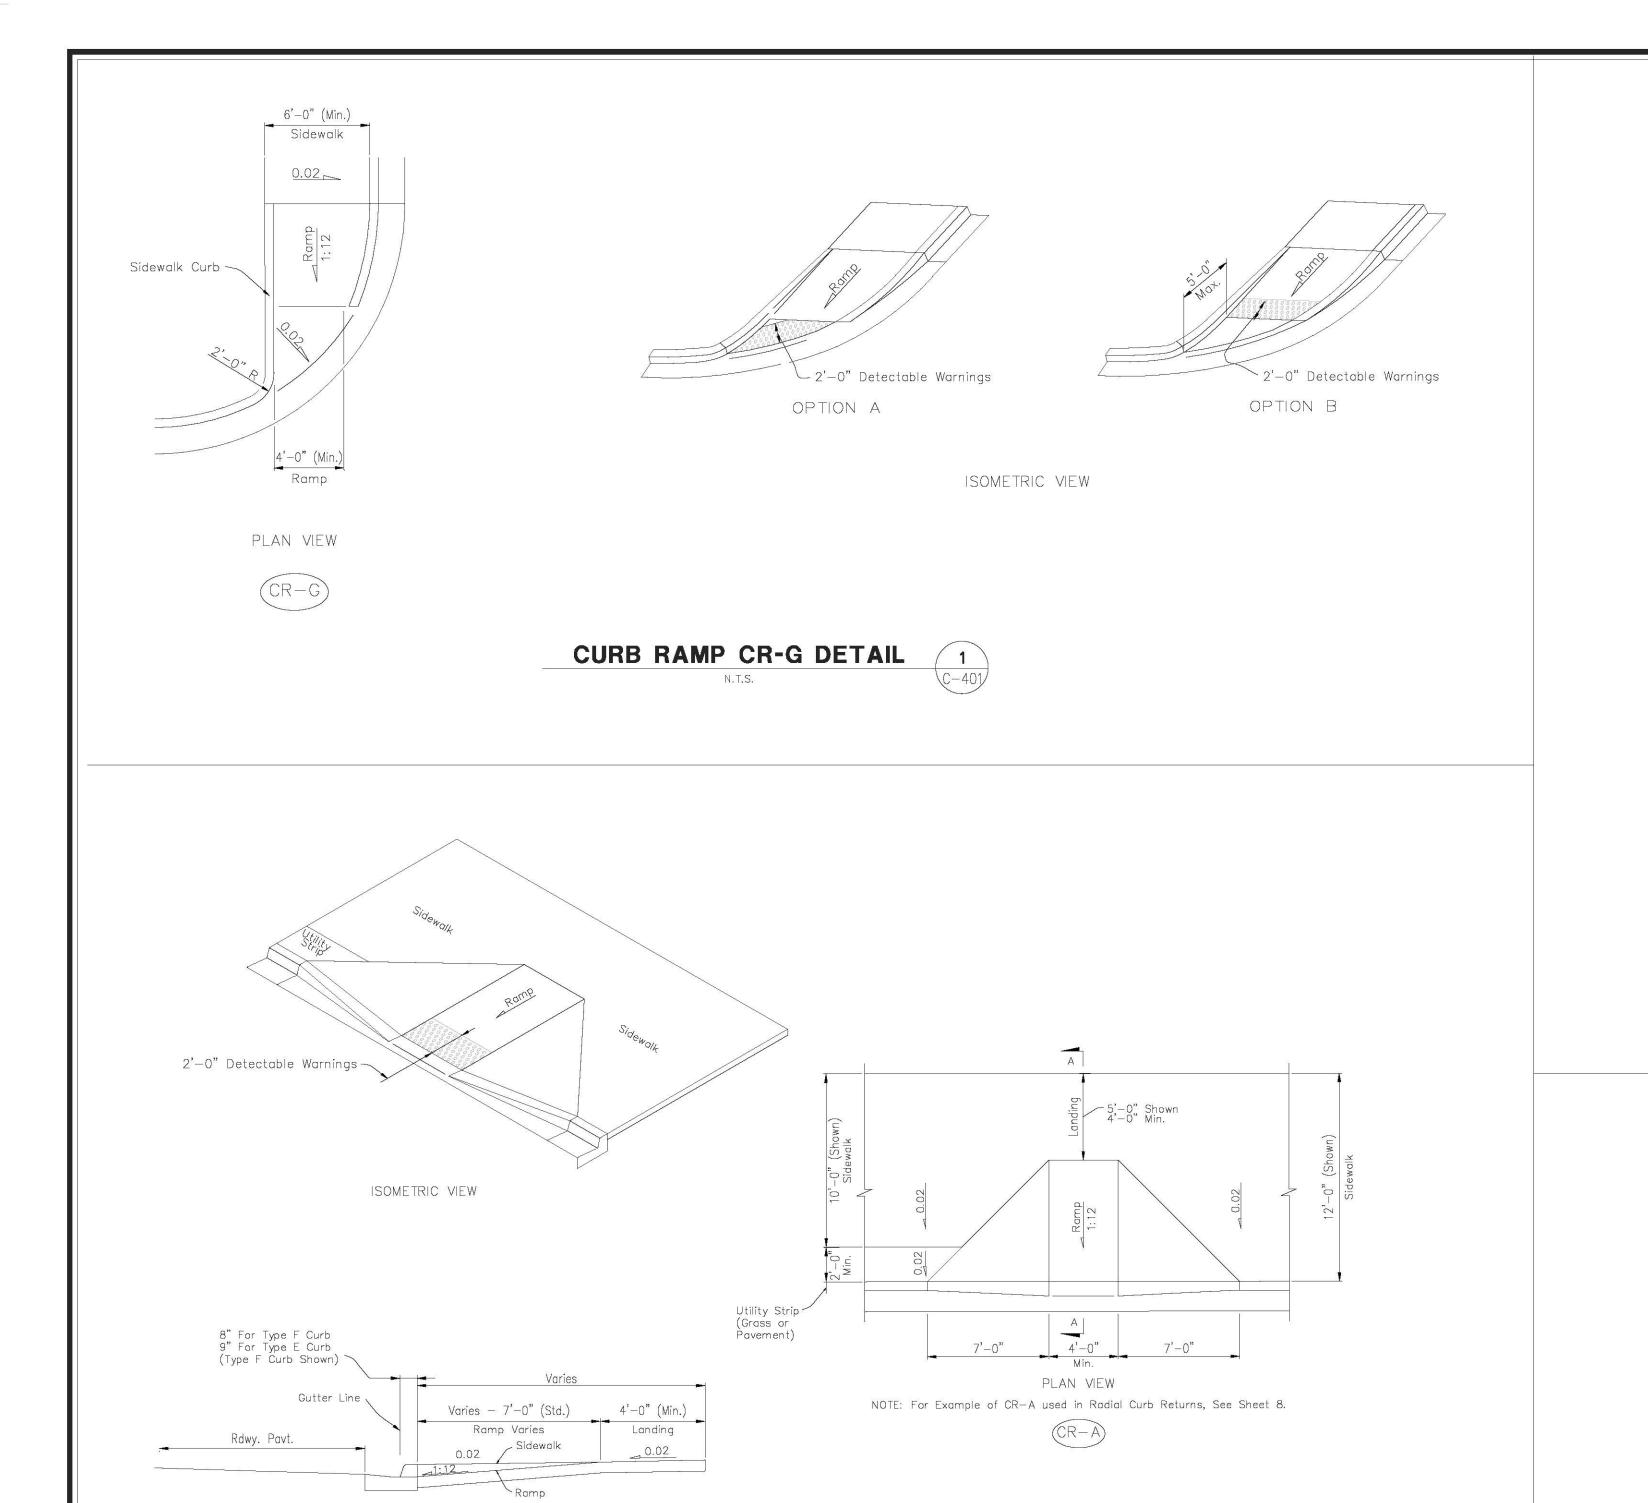N.T.S. C-401

SECTION A-A



CURB RAMP CR-C DETAIL

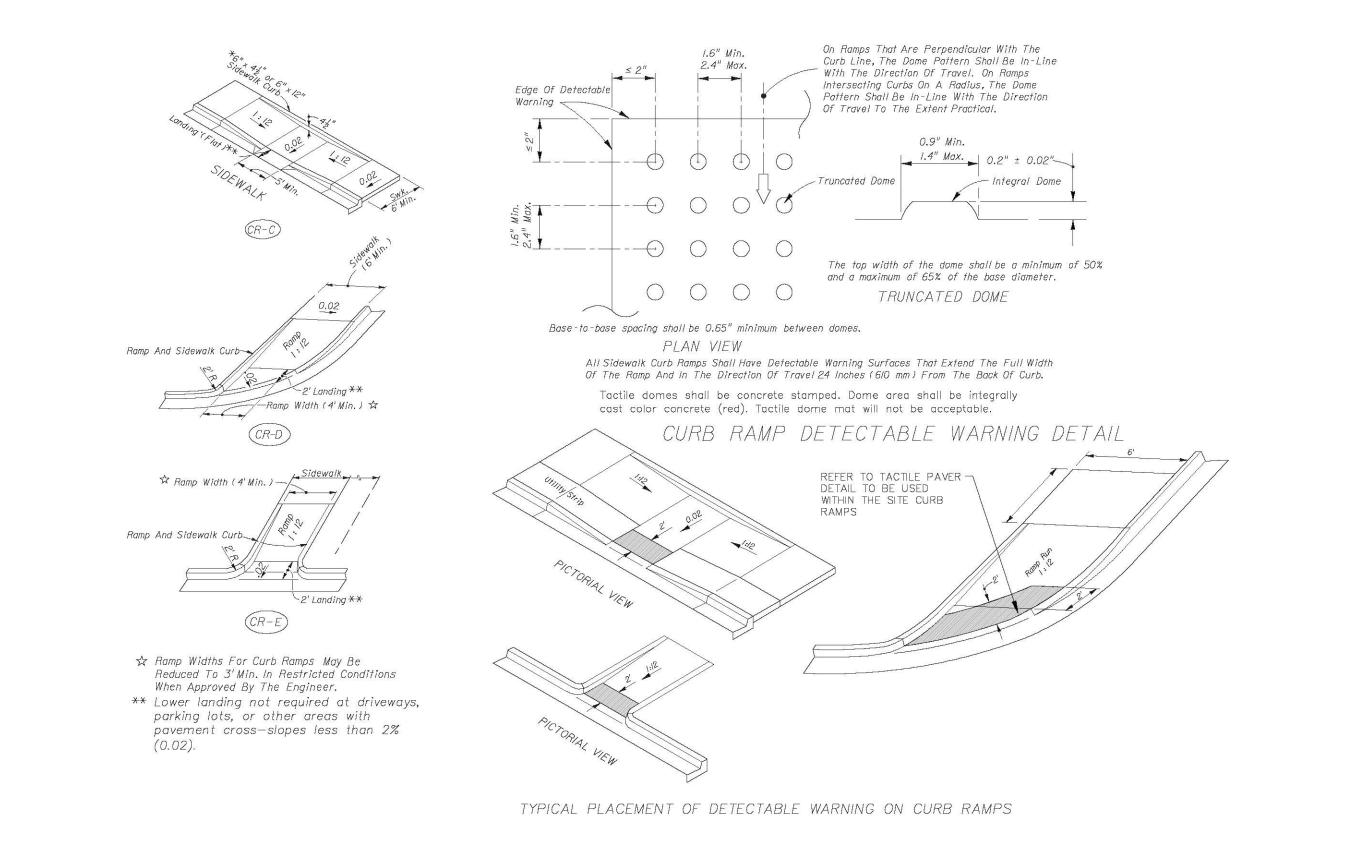N.T.S.

3
C-401

HARRIS

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NSEL AVE, EDGEWOOD,
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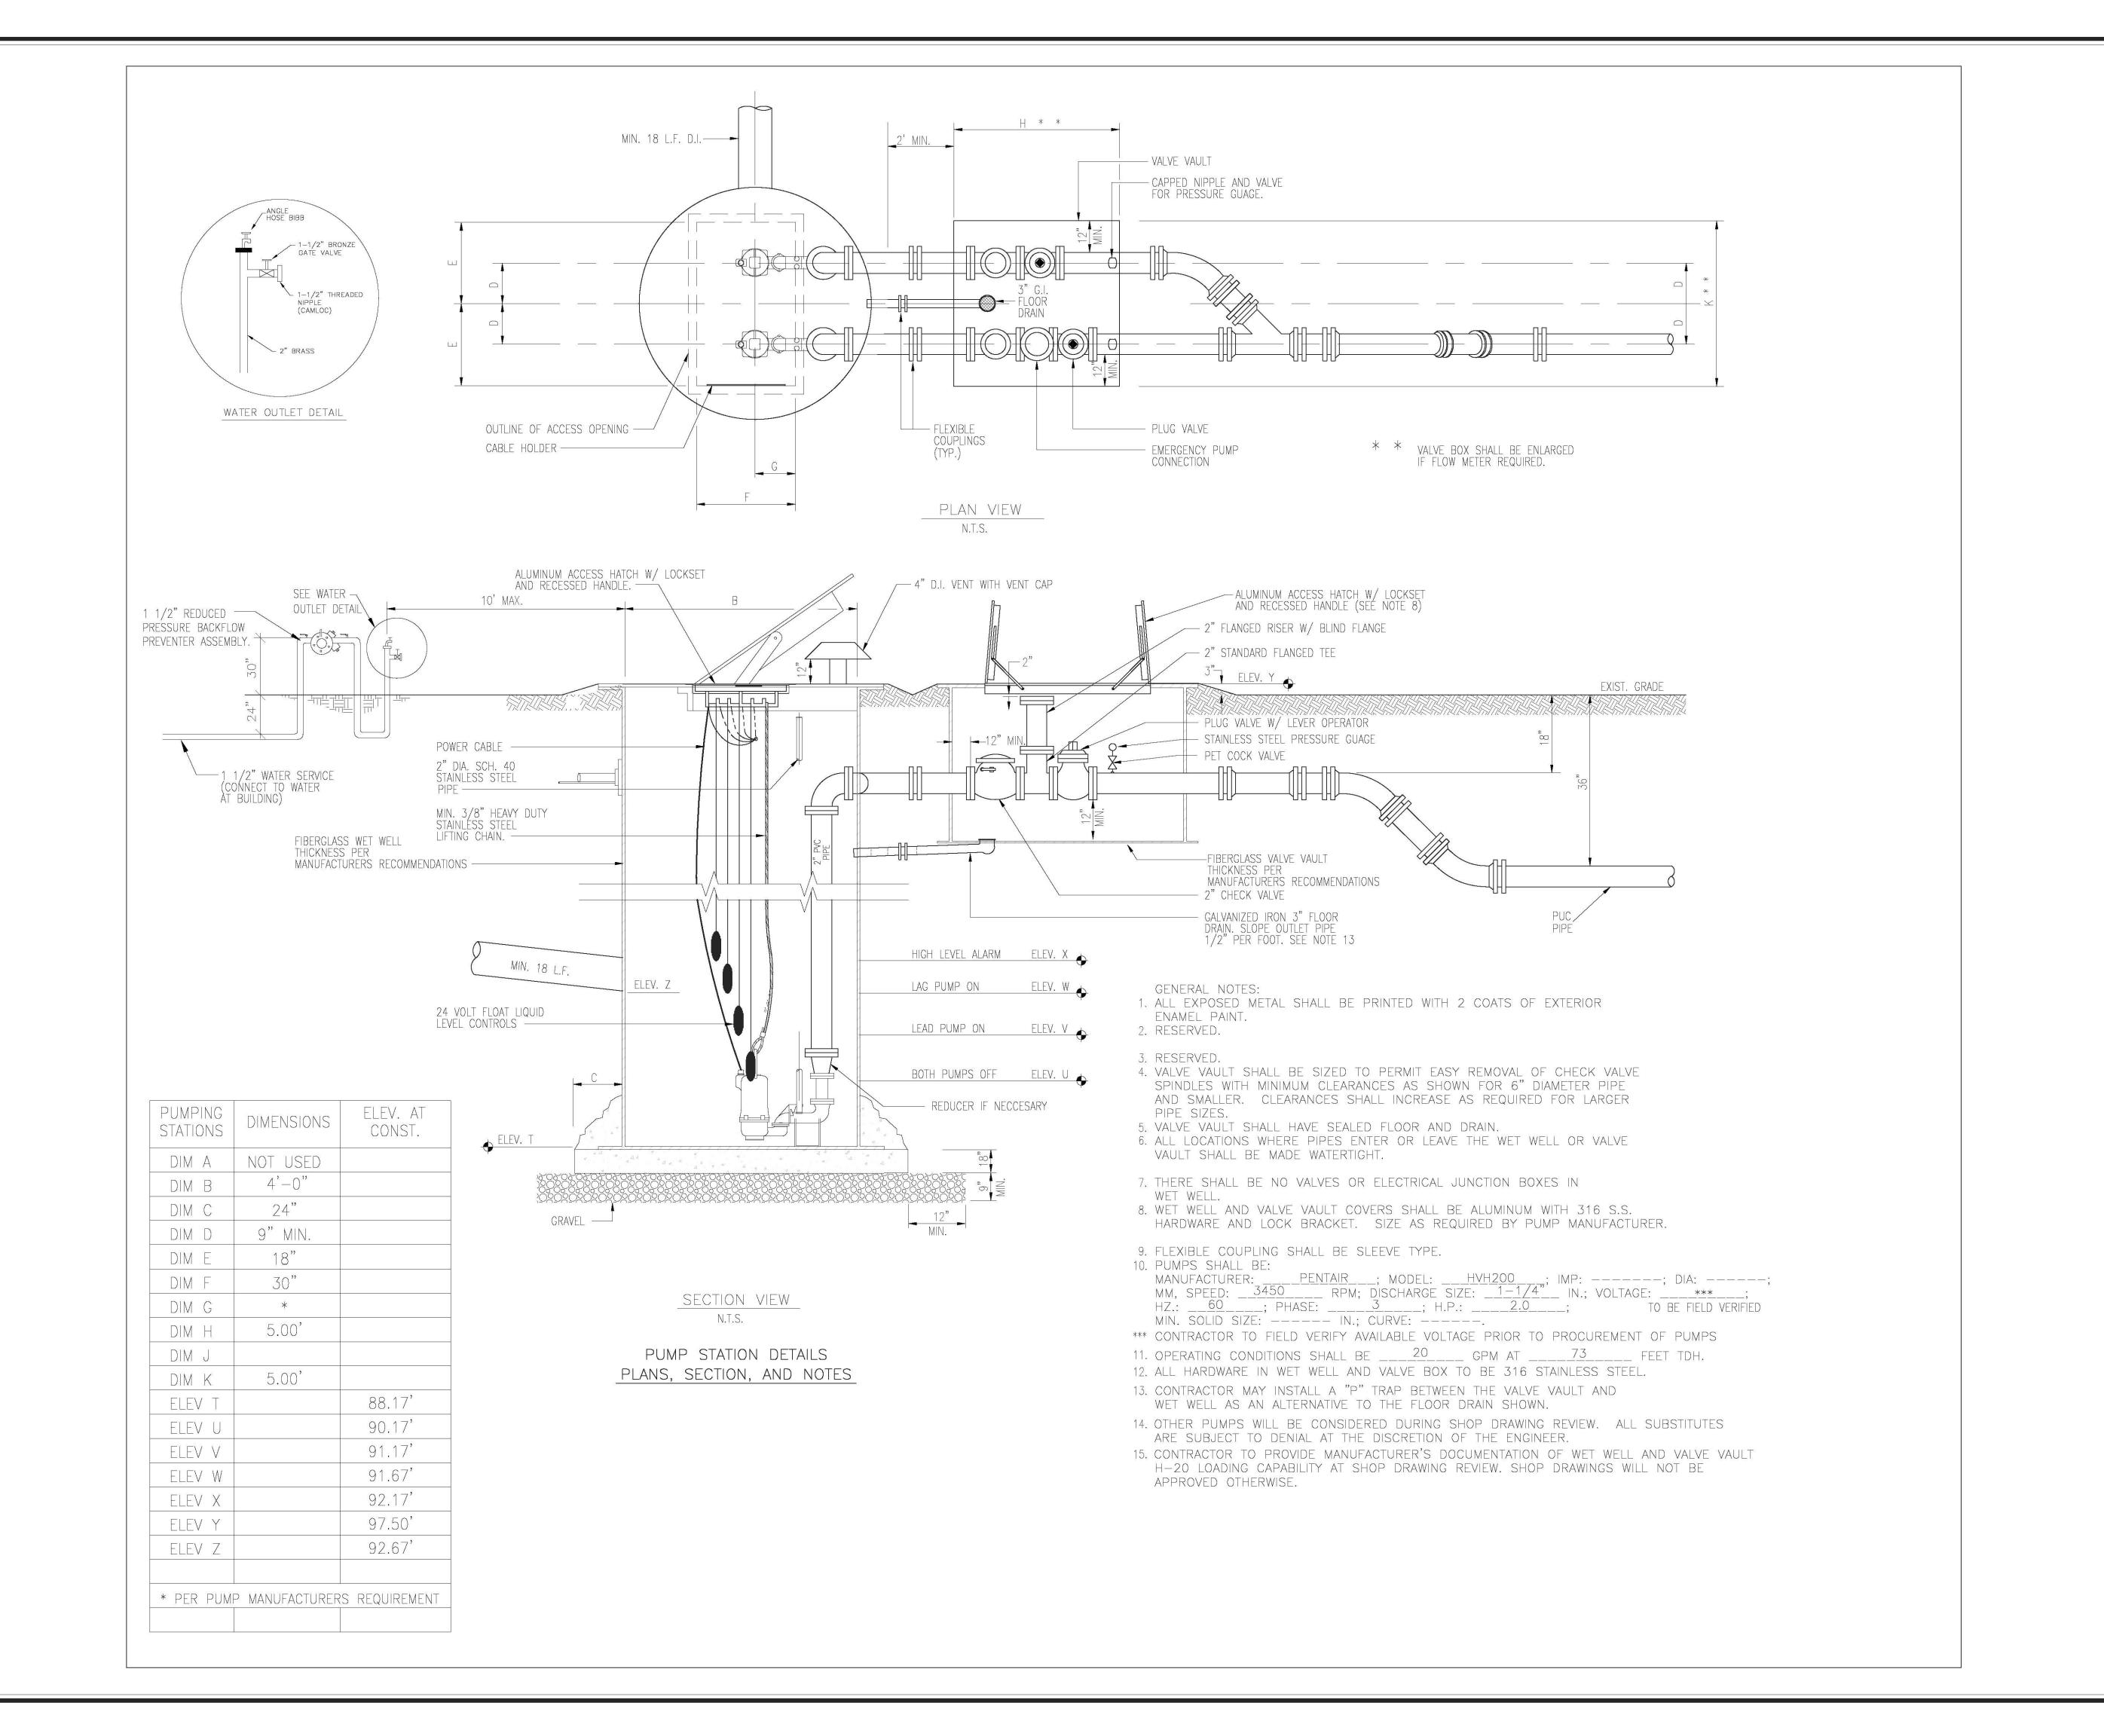
Date: 2021-09-25

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Release:

C-401



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> HANSEL AVE, EDGEWOOD, FL NELSON LERMA, JR


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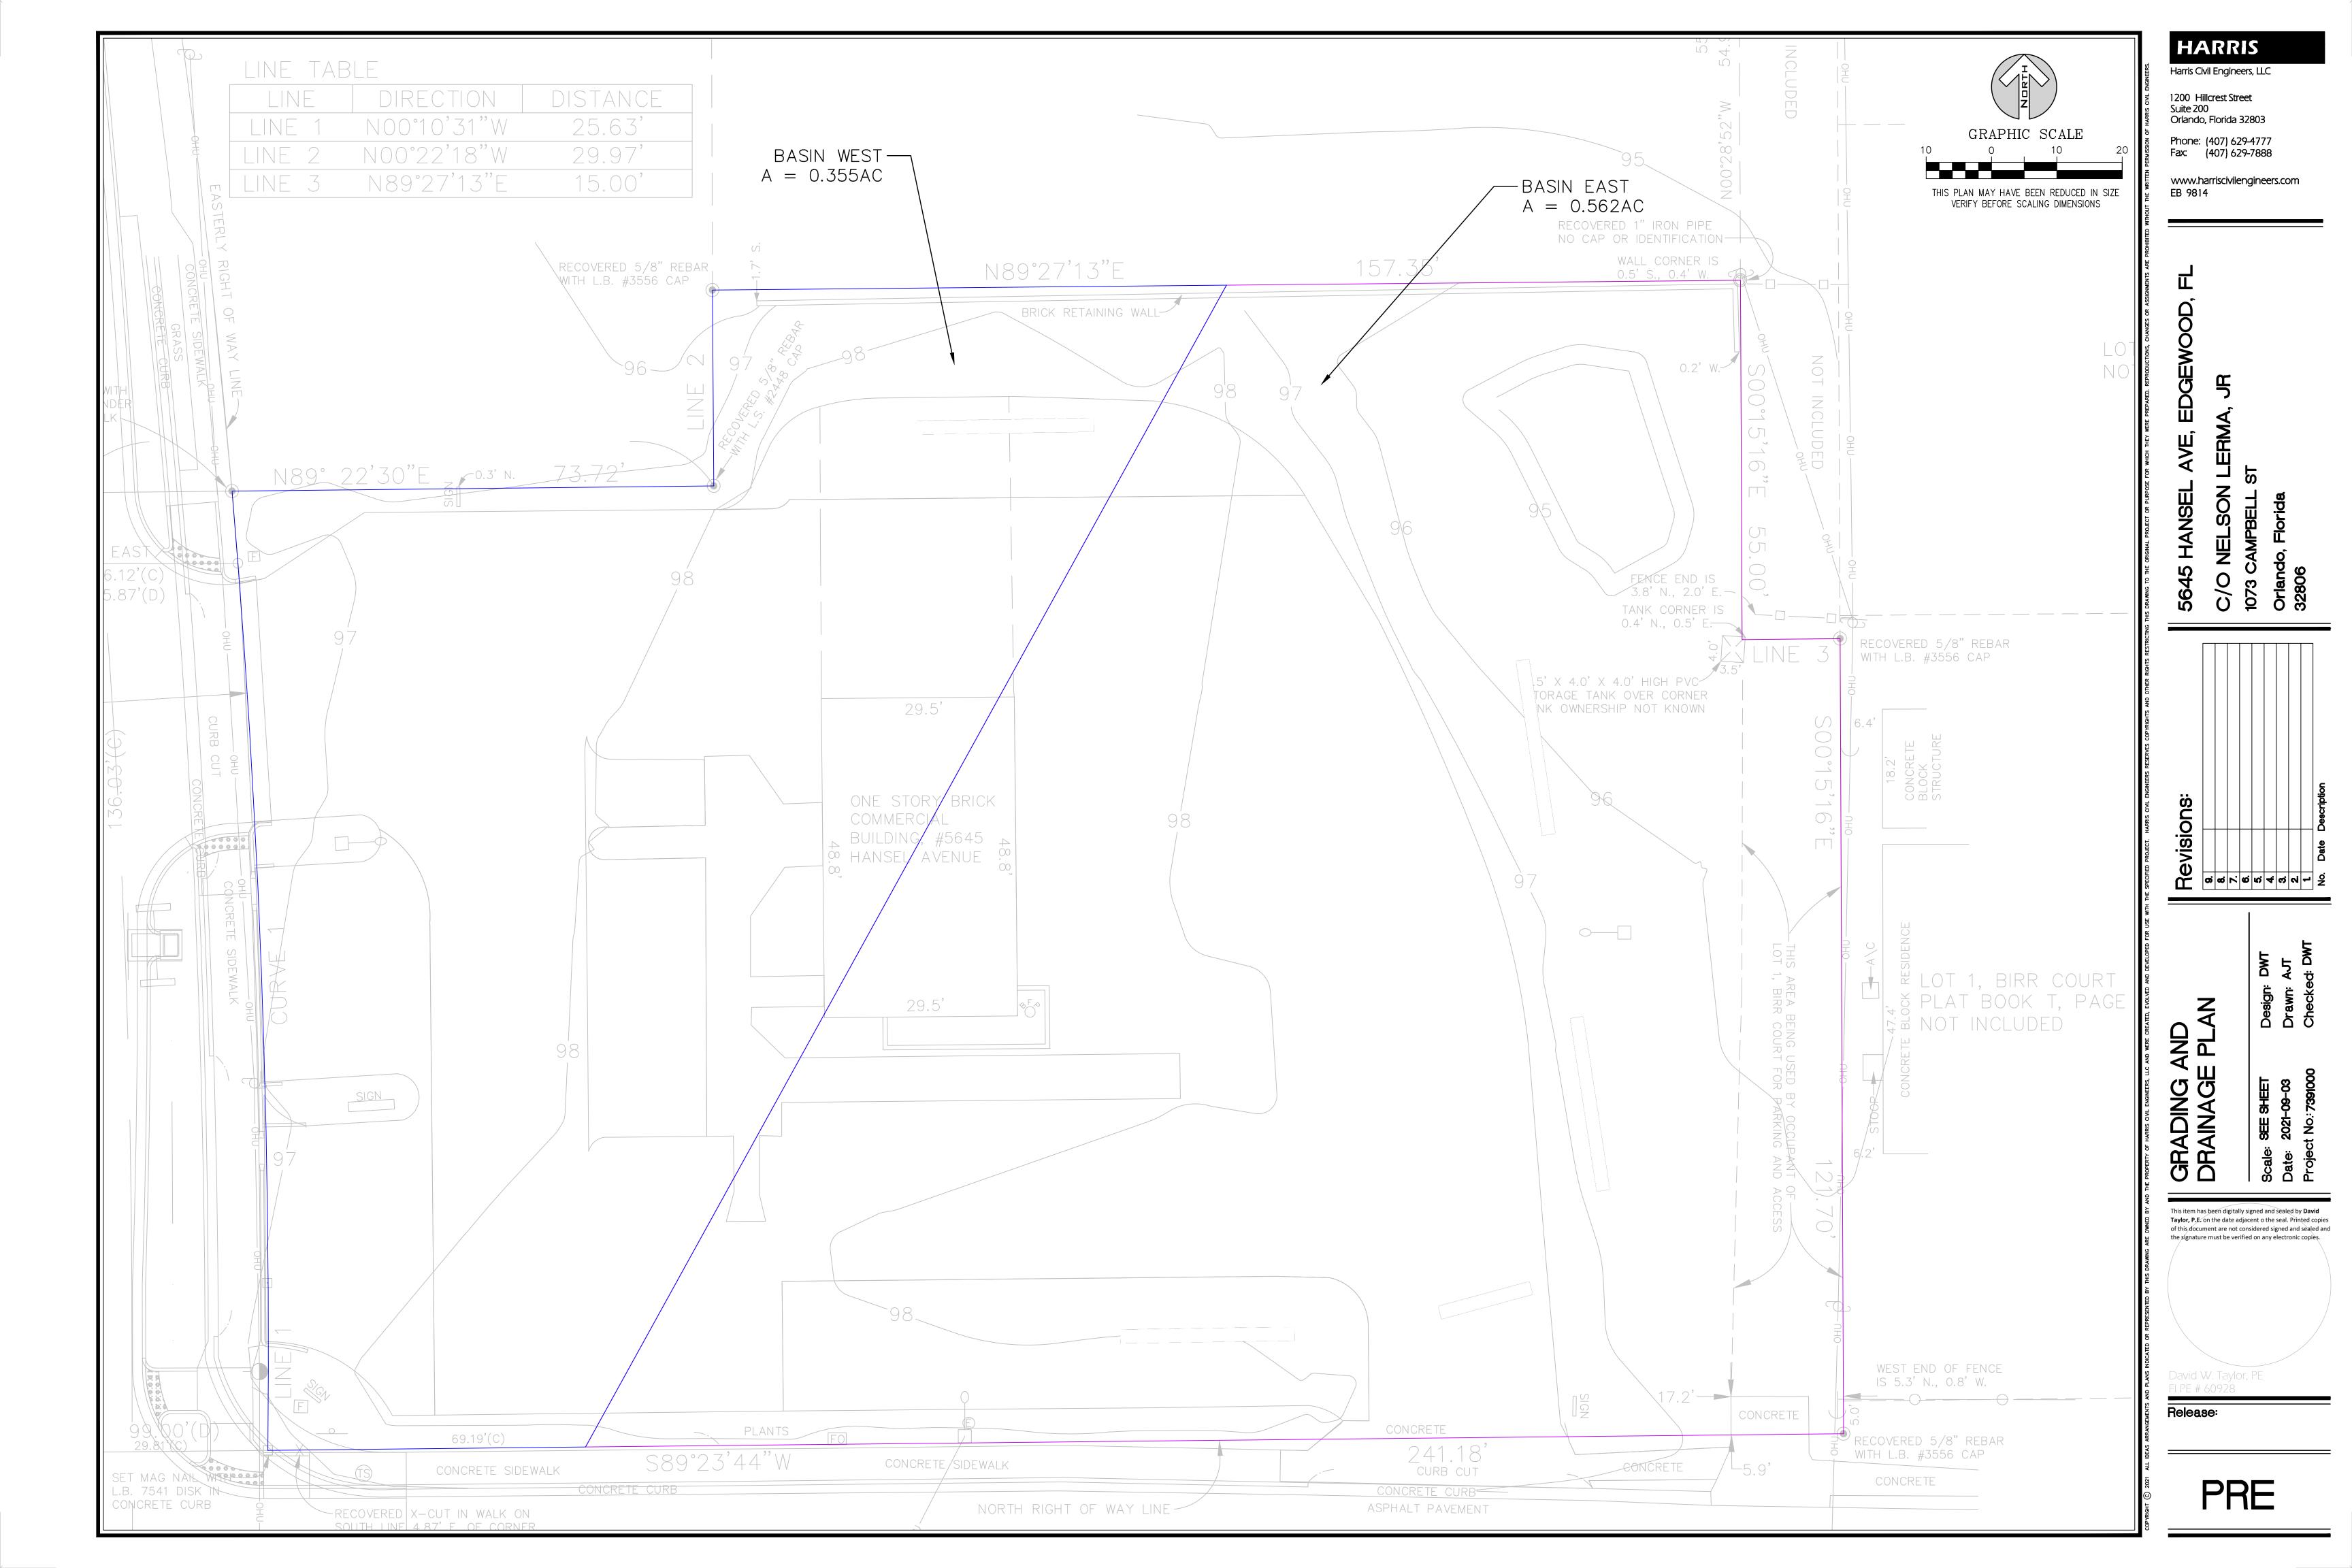
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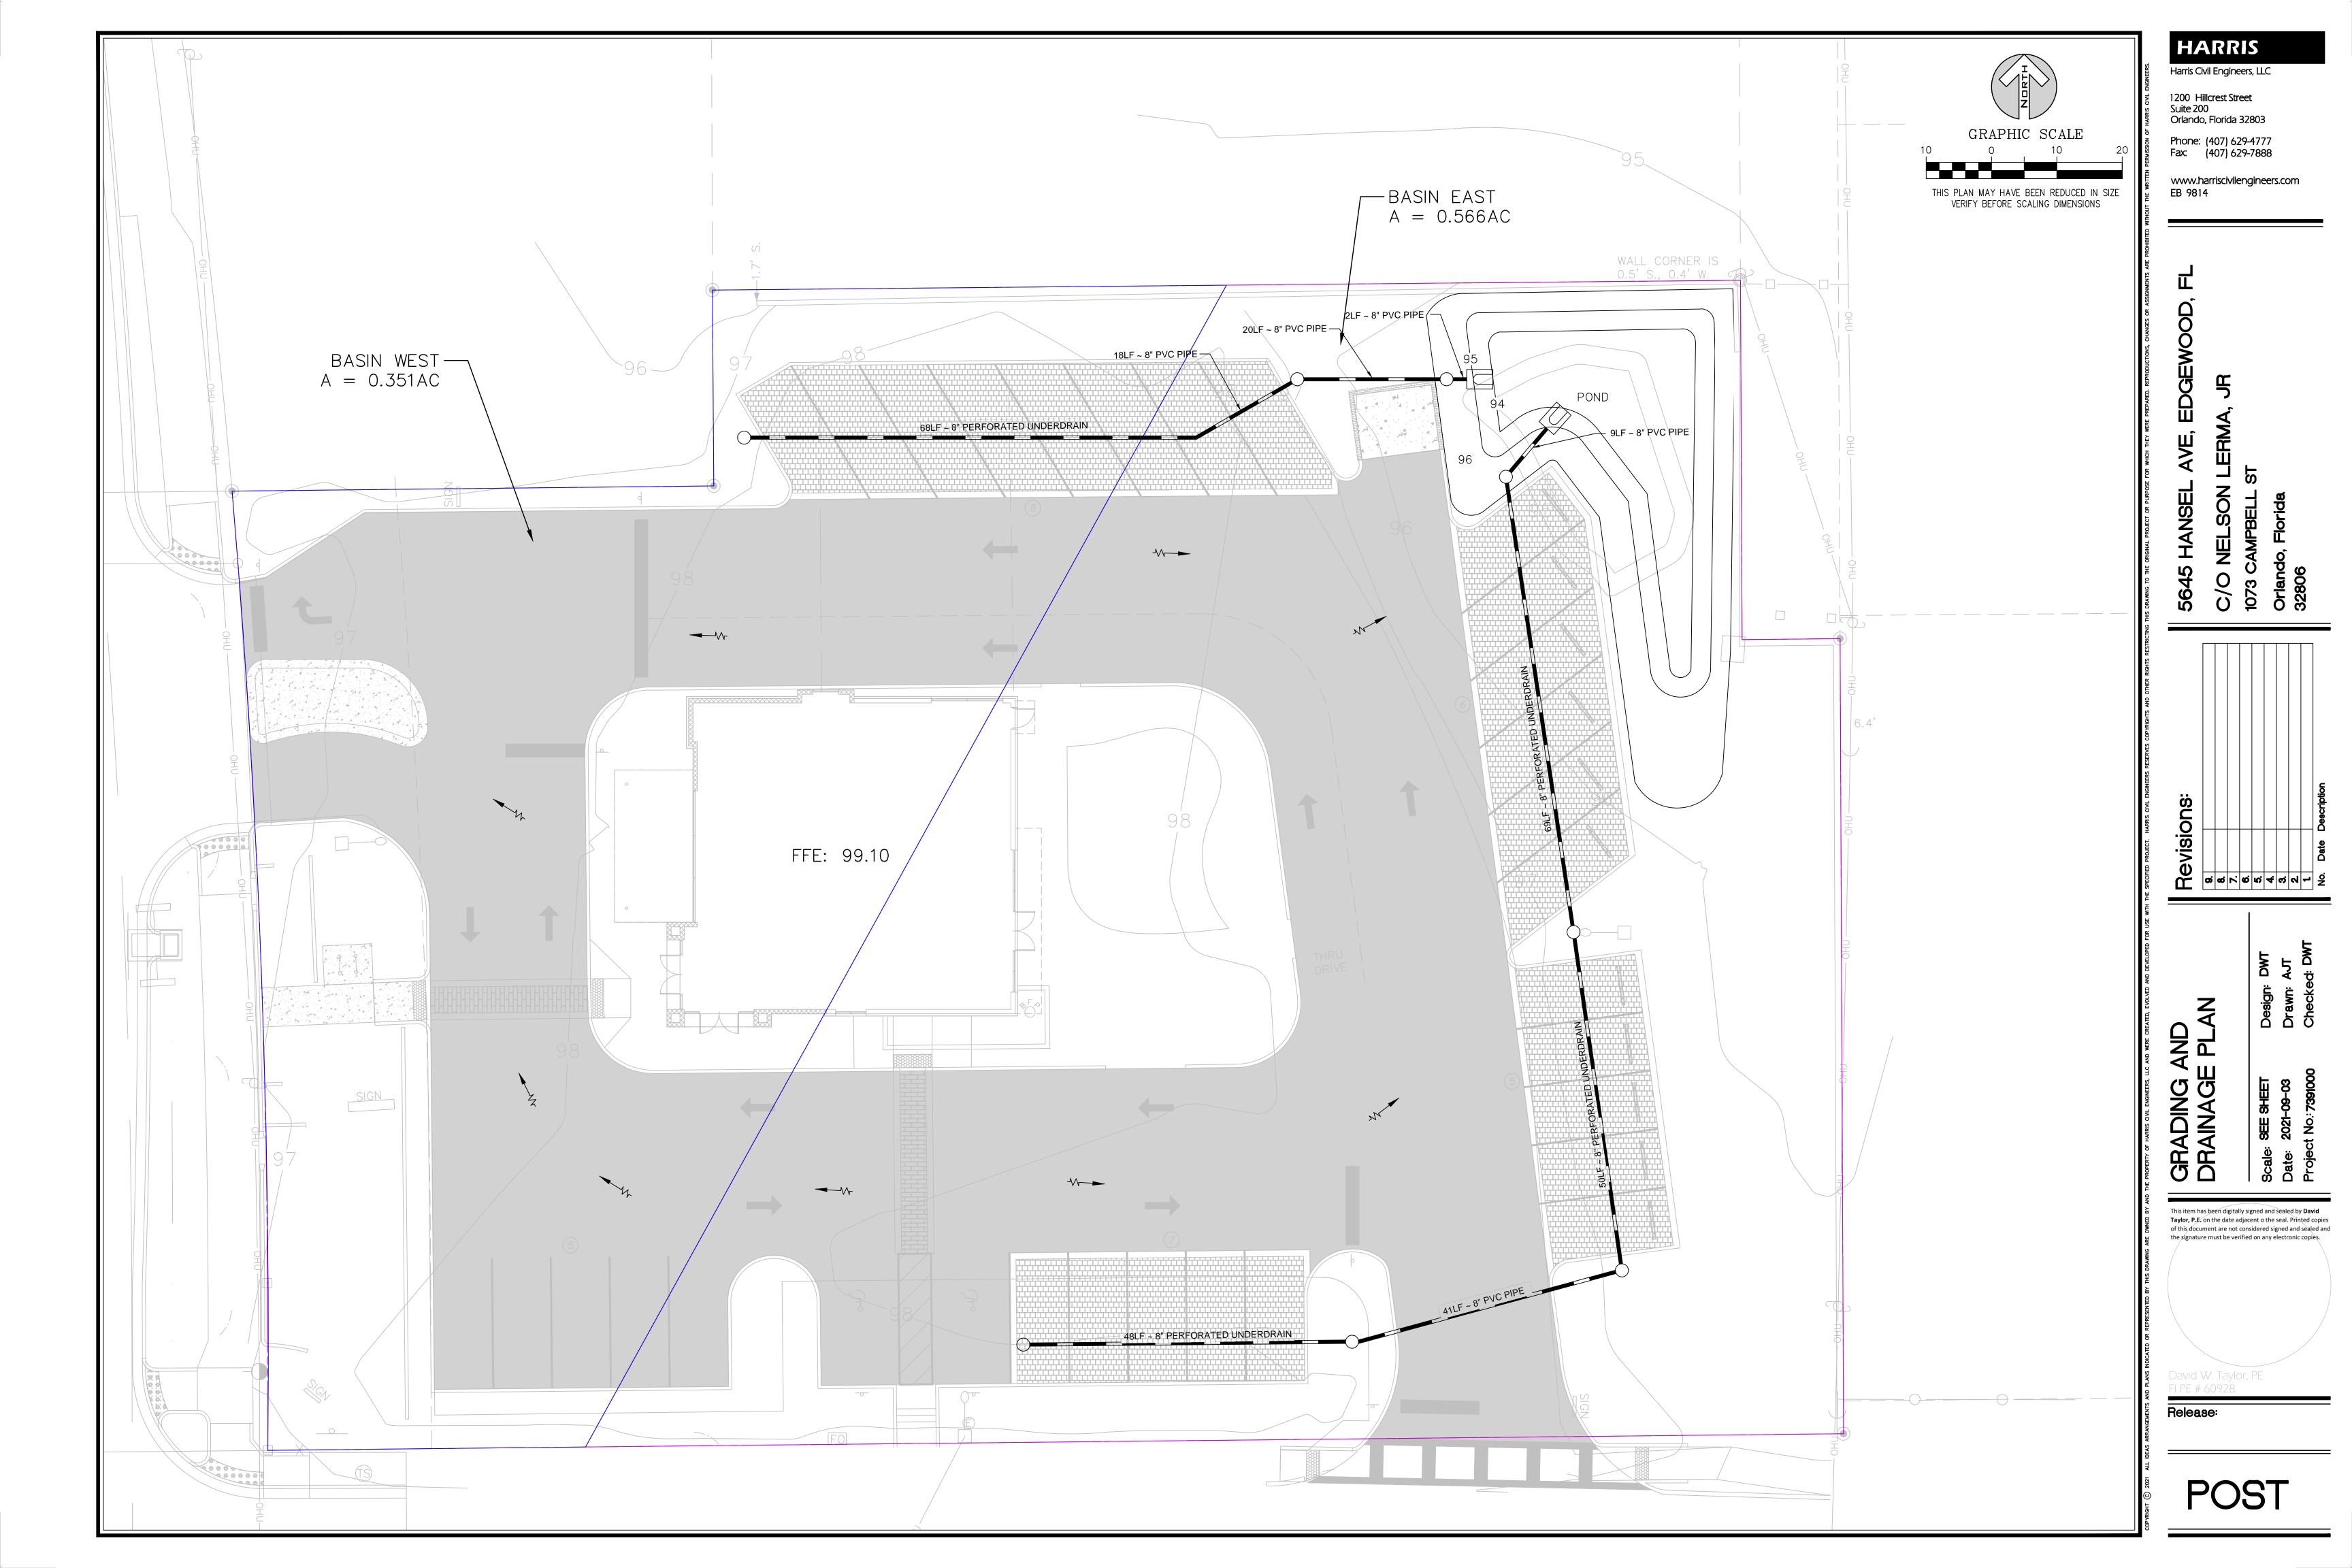
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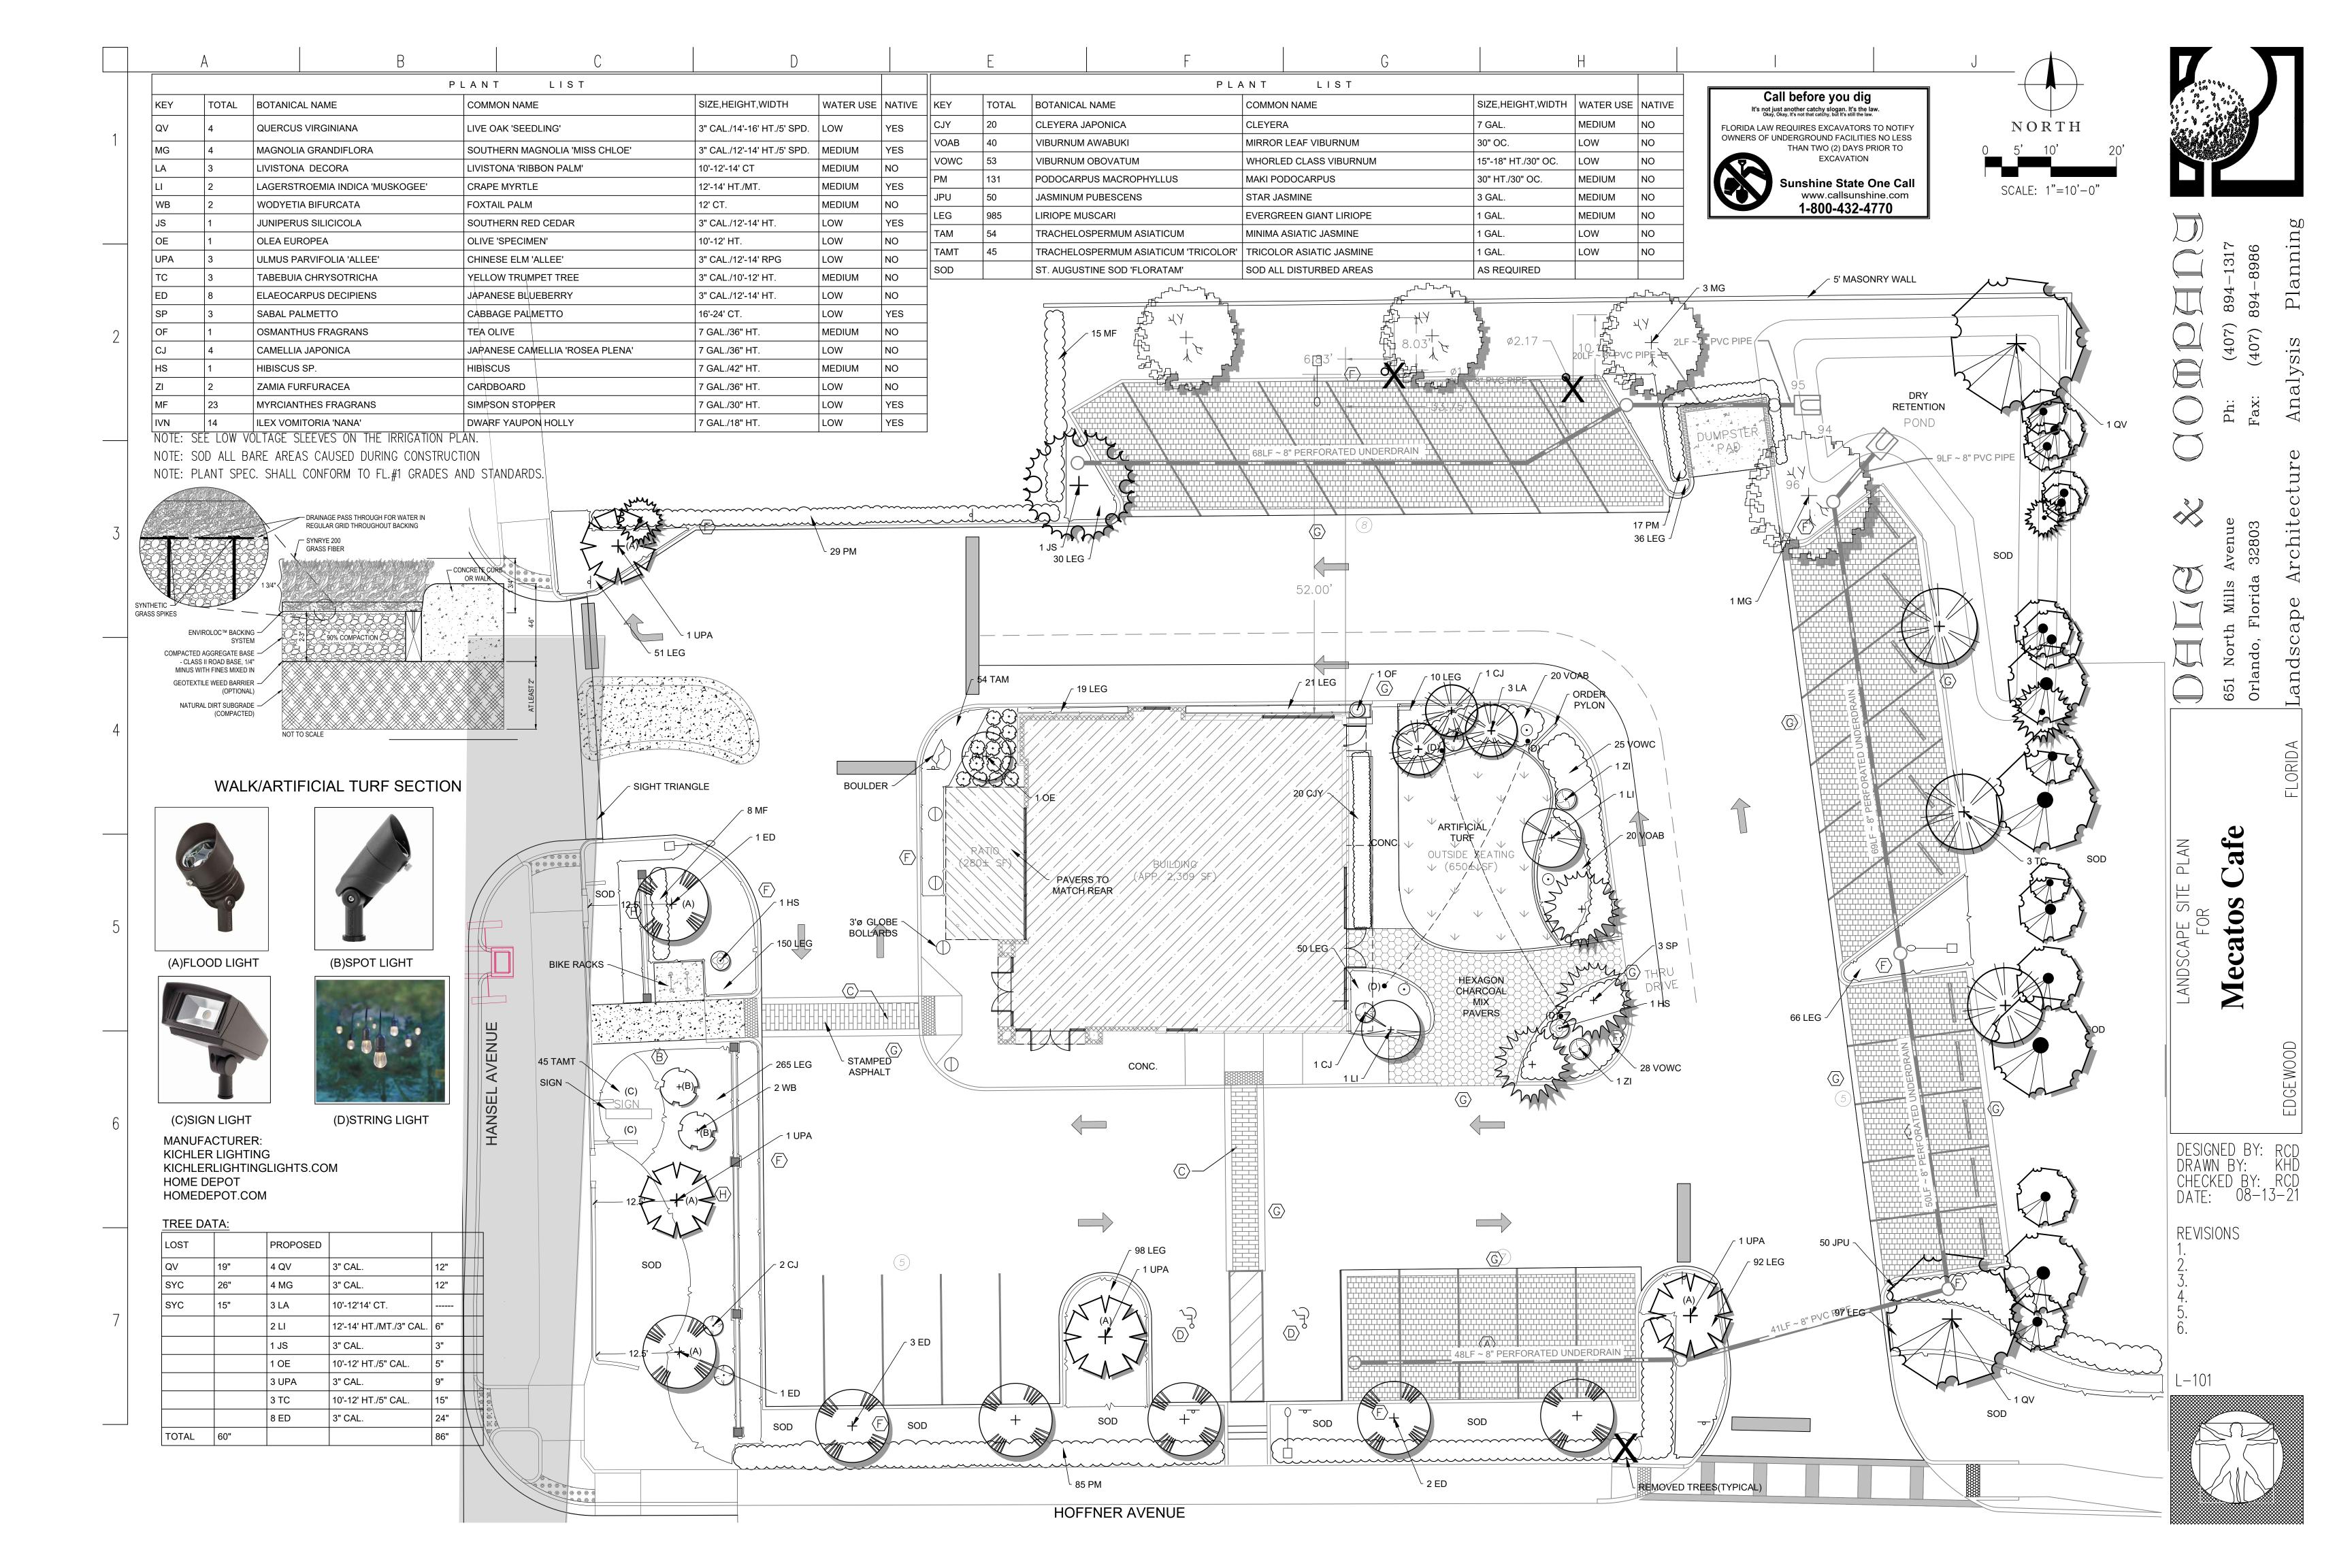



Release

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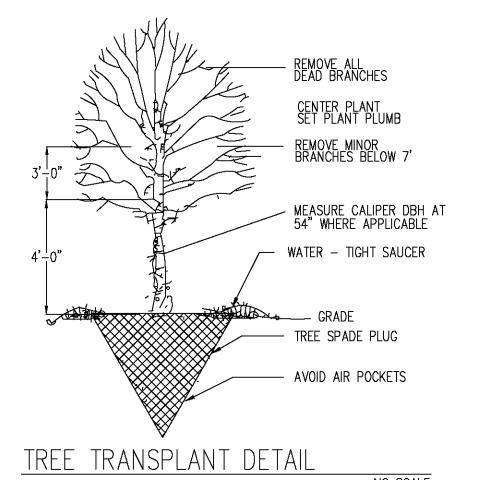







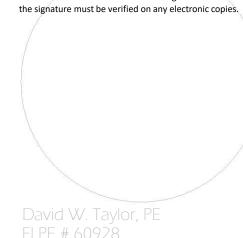


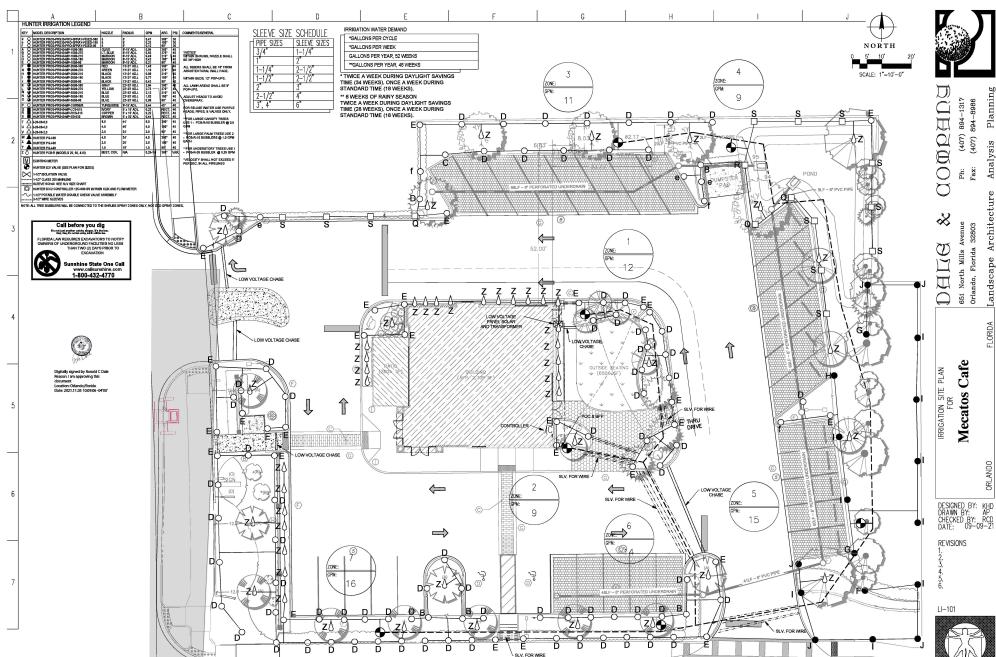
NO SCALE




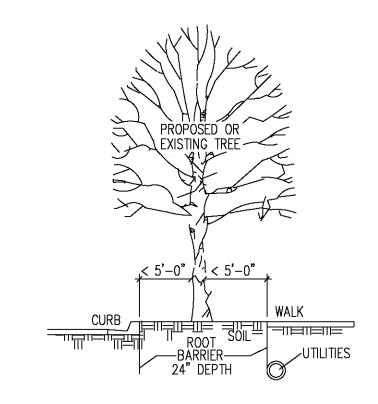

ROOT BARRIER DETAIL NO SCALE

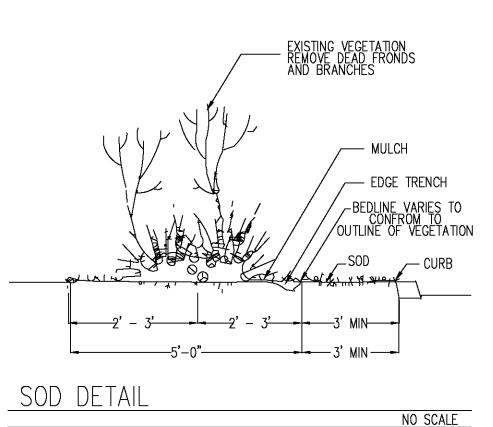

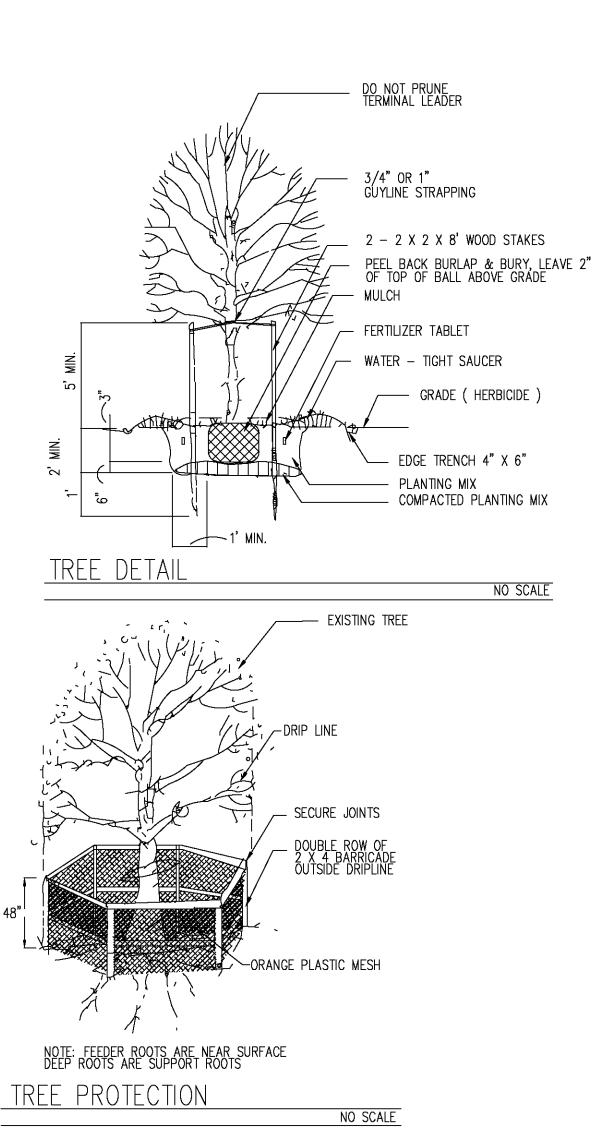

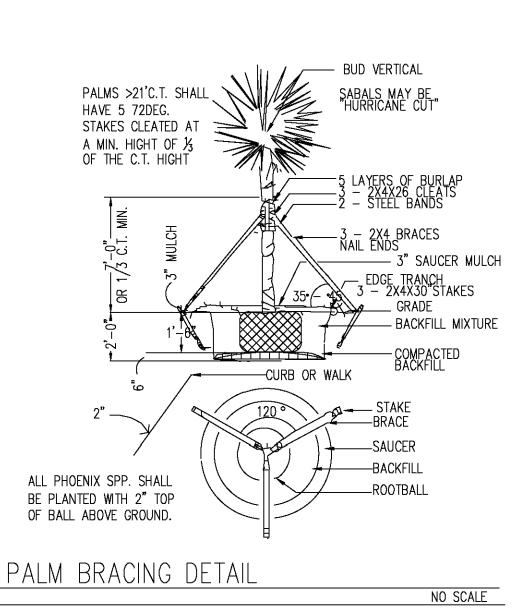

SECTION 02900 LANDSCAPE PART ONE - GENERAL

A. All portions of Division I - General Requirements are included with this section.

B. Furnish all transportation, materials, labor, equipment, taxes, and service to complete all work as shown on the drawings and as specified herein. C. Avoid conditions which will create hazards. Post signs

or barriers as required. Provide adequate means for protection from damage trough excessive erosion, flooding, heavy rains or

winds, etc. Repair or replace such damage. E. Plant totals are for the convenience of the Contractor and are not guaranteed. Verify drawings. Planting is required as indicated on drawings.

Comply with all federal, state and local regulations. Contractor shall notify L.A. of any adverse soil conditions ancountered ie. clay, loose fill , high water table or poor

drainage and any condition adverse to planting. Quantity deviations, questions on plans; please notify. Plant list is an estimate.

1.1 RELATED SECTIONS; SECTION 02810 IRRIGATION

1.2 REFERENCES

A. Standard Plant Names, 1942 edition prepared by the American Joint Committee on Horticultural Nomenclature.

Grades and Standards for Nursery Plants, Florida Department of Agriculture; Part II 1998 American Standard for Nursery Stock, prepared by the

American Association of Nurserymen, Inc. (ANSI Z60. Hortus Third, Liberty Hyde Bailer Hortorium 1976.

E. Florida Irrigation Society Standards and Specifications for turf and Landscape Systems (Revision 61098).

1.3 SUBMITTALS Provide to Owner's representative during;

Owner's representative.

A. Preconstruction 1. Unit Prices for all materials, including estimate (or quotation) or area to be sodded or seeded. 2. Proposed substitutions of materials or sizes. Obtain approval by both landscape architect and

B. Construction 1. Plant inspection certificates and shipping invoices

as requested. 2. All fertilizer labels and notarized letter of conformance with these specifications.

C. Contract Close-out 1. Two sets as-built record documents (red-line

1.4 QUALITY ASSURANCE

A. All work shall be performed under the constant supervision of a foreman, having at least one year experience or education in the nursery trades. B. Contractor is expected to participate in a pre-

construction conference with Owner and landscape architect to coordinate schedule, clarify questions, and discuss acceptable performance for payment.

C. Contractor is expected to participate in a contract close-out conference with Owner and landscape architect to verify completion of the work, and to establish a "Date of Substantial Completion"

A. Contractor shall be fully responsible for all maintenance, damages, and replacements until Date of Substantial Completion of that specific phase of work. Document damage to the work caused by other trades. Immediately bring to Owner's attention, and quickly repair (at Owner's expense) as directed

Maintenance consists of pruning, cultivation, edginbeds and walks, weeding, mulching, adjusting guys, resetting plants to proper grade or upright position, hand watering as required, restoration of planting saucer, and furnishing and applying such sprays as necessary

to keep the planting free from insects or disease. C. The Contractor shall keep the premises free from accumulations of waste materials or rubbish caused by his employees or work, at all times.

1.6 REPLACEMENTS

A. During the guarantee period any plant required under this contract that is dead or not in satisfactory growth condition (as determined by the landscape architect) shall be promptly replaced by the Contractor. Replacement shall be as specified for the

original planting and at no cost to the Owner. B. Replacement period commences at Date of Substantial

Completion and continues as follows: a. Trees - one (1) year

b. Shrubs - ninety (90) days

c. Sod - ninety (90) days

d. Other Products - one (1) year Time limit may be extended by mutual agreement for material in questionable health at end of guarantee

C. Plant damage by theft, vandalism, gross neglect, undue weather conditions, acts of God, or unseasonable planting are exempt from the guarantee provision.

3.3 INSTALLATION A. Topsoil

Spread topsoil over all areas to receive ground cover to a minimum compacted depth of 4 inches.

B. Rough Grading

. Mold land surfaces to within 1 inch of final grade. Construct swales and berms. Fill low areas. Ensure proper drainage of all areas. Spread 6 inch lifts at 85% compaction (Proctor)

2. Slope grade away from buildings at a minimum slope of 1/2 inch per foot for a distance of 10 feet

C. Final Grading

1. Remove all non-conforming matter from site, such as rocks, sods, sticks, building rubble, wire, or cans.

2. Dig out weeds by the roots. 3. Till in soil amendments such as lime, iron, or gypsums if indicated by local conditions, but only after approval by landscape architect. Ensure

PART TWO - PRODUCTS

uniform application.

2.0 MATERIALS

A. Topsoils shall be fertile, natural, and typical of the locality. It shall be without subsoil or slag and shall be free of stones, lumps, plants or their roots, sticks, or other extraneous matter that is not conductive to production of plant life, or would

interfere with future maintenance B. Sod may have no visible broadleaf weeds when viewed from a standing position and the turf shall be visibly consistent with no obvious patches of foreign grasses. It may have no visible signs of disease or insect stress. In no case may the total amount of foreign grasses or weeds exceed 2% of the total canopy. The sod shall be (as noted on plan) neatly moved and be mature enough that when grasped at one end it can be picked up and handled without damage.

C. Seed shall meet the tolerance for germination and purity in accordance with the U.S. Department of Agriculture Rules and Regulations under the latest edition of the "Federal Seed Act" for certified seed Seed shall be mixed by the dealers and shall be delivered to the site in sealed containers which shall beat the dealer's guaranteed analysis. Seed mixture and seeding rate shall be as specified on the drawings.

. "Agri-form" or "Woodace" 21 gram tablet of 20-10-5

formulation. 2. Granular fertilizer shall be a balanced formula, uniform in composition, free flowing and delivered to site in unopened bags.

Incorporate black Florida peat into planting mix when specified on plant list at the following rates: 1. 1 gallon plants - 1/8 cubic feet

2. 3 gallon plants - 1 cubic feet 3. Trees - 1/2 cubic foot per foot of height

"Selfan" or "Preen" pre-emergent.

G. Additional Soil Amendments 1. Apply as needed to bring soil into optimum growth range for specified plants.

2. If soil is below 5.0 ph incorporate enough horticultural lime to bring within 5.6 to 6.5 ph range.

1. Measured standing in natural form of the size indicated on "plant list" and grade "Florida No 1" unless otherwise indicated.

2. Non-classified plants to meet AAN standards. Tree calipers shall be measured 6 inches above soil

3. All plants shall be sound, healthy, free from insect pests and eggs, and have normal, healthy root systems.

4. Form shall be symmeterical or typical for species and variety.

5. Any plant may be rejected by landscape architect if not of satisfactory size, health, quality, or character

6. Trees having rootballs wrapped with synthetic burlap will be rejected.

I. Mulch shall be Pine bark, no cypress bark, & free from sticks, stones, leaves or other debris.

Use magnesium grading rakes of 30 inch minimum width to remove irregularities in final grade prior to sodding or seeding and to ensure a flat subgrade.

2.2 MIXES

A. Planting Mixture

1. Use the best natural soil existing on site, combined with fertilizer.

PART THREE - EXECUTION

A. Examine surfaces to which work will be applied and immediately notify landscape architect in writing if site is not in proper condition for Contractor to perform his duties under the terms of this contract. Review engineering drawings for additional information.

Coordinate work with Owner and other related trades. Relocate existing plant material as directed by landscape architect, and according to drawings.

Locate, identify and mark all known utilities in area of the work. Take reasonable care to avoid damages or hazards.

Remove from site existing sods, seeds, inferior plantings and preconstruction debris as necessary to incorporate work to the site. Obtain verification regarding removal of questionable material. Clean up of debris from new construction (by other trades) is not included in this contract.

D. Planting Pits

Excavate to dimensions shown on plan. E. Plant Installation

1. Do not crack or break soil away from root ball 2. Carefully set plant plumb, best side facing "out" at the same soil level, to 1" higher, as previously

3. Remove all twine, burlap, or rope from top third of root ball. Retain cloth under ball. Wash in

backfill with slow hose. 4. Form shallow basin at each plant. Adjust grade to 1 1/2" below adjacent pavement. All plants shall

be 30" minimum from walls, walks and fences. 5. Space ground cover in triangle pattern with outside row parallel to bedline, 1/2 plant spacing distance

from edge. Sod Installation Sod all areas indicated on plan and areas disturbed

by work of other trades. 2. Lay panels tightly together. Top dress cracks with

sand. Water thoroughly. G. Stake and Guy

Stake and guy ..as per plan.

H. Fertilize

Fertilize evenly at following rates: 1. Tablet Fertilizer 1 gallon plant - 1 tablet

2 gallon plant - 1 to 2 tablets 5 gallon plant - 2 to 3 tablets Trees - 1 tablet per foot of height 2. Granular Fertilizer

Work into the top 2 " of soil at the rate of 20 pounds per 1000 square feet for lawn areas. I. Prune

Prune as little as necessary to remove damaged twigs. In any case, terminal leader shall not be topped either before or after installation.

J. Herbicide Apply pre-emergent herbicide to all beds according to manufacturer's recommendations.

Spread to a uniform depth of 2"min. Fluff and pat in place.

3.4 FIELD QUALITY CONTROL

A. Landscape architect or Owner may conduct periodic inspections to determine that the terms of this

contract are fulfilled. B. Contractor will be expected to participate with Owner in final inspection to review project for conformance to the contract. Items to be reviewed include type. quantities, sizes, locations, dimensions, and quality of materials and workmanship. Final payment for work will depend upon satisfactory condition of project on Date of Substantial Completion.

END OF SECTION



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DETAIL O ¥ ANDSC/

Call before you dig

FLORIDA LAW REQUIRES EXCAVATORS TO NOTIFY

OWNERS OF UNDERGROUND FACILITIES NO LESS

THAN TWO (2) DAYS PRIOR TO

Sunshine State One Call

1-800-432-4770


www.callsunshine.com

EXCAVATION

It's not just another catchy slogan. It's the law.
Okay, Okay, It's not that catchy, but It's still the law.

DESIGNED BY: RCD DRAWN BY: CHECKED BY: RCD


REVISIONS

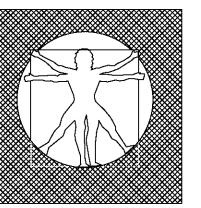


MOUNT CONTROLLER WITH LCD SCREEN AT EYE LEVEL. CONTROLLER SHALL BE HARD-WIRED TO GROUNDED 110 or 220 VAC SOURCE.

IRRIGATION CONTROLLER


*IF THE PLAN SPECIFIES THE USE OF A TWO WIRE CONTROLLER, OR IF ONE WILL BE USED, PLEASE SEE THE ADDITIONAL DETAILS AND SPECIFICATIONS FOR IT LOCATED ON A SEPORATE SHEET. IF THE SHEET WAS NOT INCLUDED WITH THIS SET OF PLANS PLEASE CONTACT DALE AND COMPANY FOR A COPY.

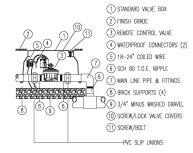


REMOTE CONTROL VALVE

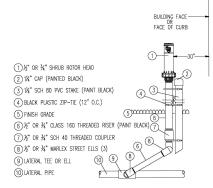


SHRUB ROTOR HEAD *DO NOT LISE RE-BAR ANGLE IRON, OR ANYTHING OTHER THAN PVC AS SPECIFIED IN THIS DETAIL FOR STAKING

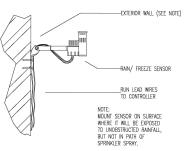


RAIN/ FREEZE SENSOR

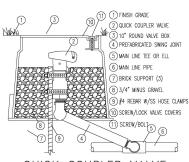


QUICK COUPLER VALVE

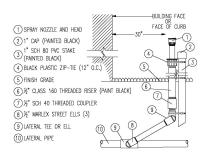


SHRUB SPRAY HEAD *DO NOT USE RE-BAR, ANGLE IRON, OR ANYTHING OTHEL THAN PVC AS SPECIFIED IN THIS DETAIL FOR STAKING.

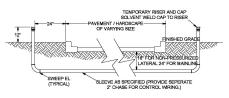


SLEEVE INSTALLATION

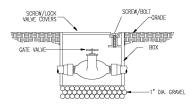

GATE VALVE

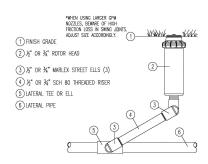

ROTOR HEAD

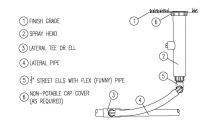

SPRAY HEAD

SECTION 02810 IRRIGATION SYSTEMS

PART ONE - GENERAL

- 1.0 SUMMARY
 A. All portions of Division I General Requirements are included with this section.

 Furnish all transportation, materials, labor, equipment, and services to complete all work shown on the drawings and as specified.
- 1.1 RELATED SECTIONS: section 02900 landscape planting
- 1.2 TOLERANCE A. Install sprinkler heads where indicated by symbol.

 B. Drawings are schematic. Adjust pipe and locations to conform to site conditions and to avoid obstructions. Conceal components behind walls of shrubbery where possible. Verify questionable locations before installation.

- locations before installation.

 3 SUBSTITUTE

 4. Subnit two bound folders containing.

 1. Written operating instructions for all components.

 5. Complete parts but and manufacturers data.

 5. Complete parts but and manufacturers data.

 6. Complete parts but and manufacturers data.

 6. Written maintenance instructions owings with the following literal distriction of the parts of t

1.5 QUALITY ASSURANCE.
A. Contractor is expected to participate in preconstruction meeting.
A. Contractor is expected to participate in excellents schedule, abordy questions, and discuss acceptable performance retrient for payments.
B. Contractor is expected to participate in contract closeout meeting with Owner and Inducages acceptance to were proper completion of the work, establish Tate of Substantial Completion*, and advise Owner as to system operation.

- 1.6. WEMANTES

 A Contractor will be fully responsible for system operation until Date of Substantial Completion.

 B. Contractor is fully responsible for all parts and workmanship for all parts and workmanship for phase or portion of the project.

 C. See to the furfillment of all manufacturers warranties.

PART TWO - PRODUCTS
2.0 MATERIALS
Backfill shall be free from stone, trash, or other debris.

- 2.1 MANUFACTURED UNITS
 A. Automatic electro-mechanical controller fully installed and
- A Blacetric valve installed in valve box.

 C Valve box with lid manufactured by "Amtek" or "Brooks".

 D Connection for control wires manufactured by "Pentite" or "3" installed as per manufactured wirections, and above grade in valve boxes.

 E. Gete valves shall be brass and installed in valve box.

 F. Automatic drain valves shall be installed in 1 cubic foot gravel

- 2.2 COMPOINTS

 Another with which is direct burial # 14, type UP. Tape to underside of main every 10 feet. Install spare ground, wire + 5 extra wires. Main line shall be class 200 P/C minimum (ANS/ANTA 0224).

 C. Leteral lines shall be class 160 P/C minimum (ANS/ANTA 0224).

 E. Leteral lines shall be class 160 P/C minimum (ANS/ANTA 0224).

 E. Leteral lines shall be class 160 P/C minimum (ANS/ANTA 0224).

 E. Leteral lines shall be class 160 P/C minimum (ANS/ANTA 0224).

 E. All pipe, connector and mine. It filling for the meter and check valve assembly will be galvanized.

 All pipe, connector and mine. It filling for the meter and check valve assembly will be galvanized.

PART THREE - EXECUTION

3.0 EXAMINATION
Examine surfaces to which work will be applied and immediately notify landscape architect in writing if site is not in proper condition for Contractor to perform his duties under the terms of this contract.

- AS PROFICEION
 A Lecate identity, and mark all known utilities in area of the work.
 Take reasonable care to avoid damages or heards.
 Take reasonable care to avoid damages or heards.
 See that the second of the seco

3.2 PREPARATION A Surface Preparation. Stake out each run of pipes, each head, and each valve. B. Test control wire for continuity before unreeling for installation.

- 3.3 INSTALLATION

 3.3 INSTALLATION

 3.4 INSTALLATION

 3.5 INSTALLATION

 3.5 INSTALLATION

 4.5 INSTALLATION

 5.5 INSTALLATION

 5.5 INSTALLATION

 5.6 INSTALLATION

 6.6 INSTALLATION

 6.7 INSTALLA

3.4 TULERANCES A Main line and drive crossings shall have 18 inches minimum cover. B. lateral lines shall have 18 inches minimum cover. C. All heads shall be 4 inches minimum from walks, drives, or curbs. D. bl. prode heeds and valve boxes shall be installed with top flush the prode of the cover of

- 3.5 FIRLD TESTS Apply 100 psi hydrostatic pressure to main lines for 120 minutes. If a leak is found, repair and retest until satisfactory.

3.6 ADJUSTMENTS
A Adjust sprinkler patterns and radius. Ensure uniform and
A regist sprinkler patterns and radius. Ensure uniform and
B No heads shall be allowed to spray valls, fences, walks, or drives.
C. Set times to operate as appropriate for season, soil type,
drainage, and plant requirements.

- A FREIG Quistr CONTROL

 A Landscape architect or Owner may conduct periodic inspections to

 A Landscape architect or Owner may conduct periodic inspections to

 B. Contractor will be expected to participate with Owner in final
 inspection to review project for conformance to the contract.

 dimensions, and quality of materials and workmanship
 inspections, and quality of materials and workmanship
 inspections of the contract of the conformance of the contract of

END OF SECTION



1317 894-Q (404)

Ph:

×

0 Mills North

651 Orla

Cafe Mecatos

Call before you dig

's not just enother setchy elegen. It's the is the the start and the set the set of the set

THAN TWO (2) DAYS PRIOR TO 1-800-432-4770

> DESIGNED BY: RCD DRAWN BY: KHD CHECKED BY: RCD DATE: 09-09-21

REVISIONS

LI-501



LEGAL DESCRIPTION - VESTING DEED;

The land referred to herein below is situated in the County of Orange, State of Florida, and described as follows:

Begin at the Southwest corner of Lot 1, The Subdivision of the Harney Homestead, according to the plat thereof recorded in Plat Book C, Page 53, of the Public Records of Orange County, Florida; thence run North 147.00 feet; thence run East 99.00 feet; thence run South 147.00 feet; thence run West 99.00 feet to the Point of Beginning.


TOGETHER WITH:

Lots 1, 2 and 3, W.M. Hansel Replat, according to the plat thereof recorded in Plat Book J, Page 45, of the Public Records of Orange County, Florida.

TOGETHER WITH:

Lot 4, Second W.M. Hansel Replat, according to the plat thereof recorded in Plat Book L, Page 74, of the Public Records of Orange County, Florida.

LESS AND EXCEPT any portion thereof used, taken or dedicated for road right of way purposes.

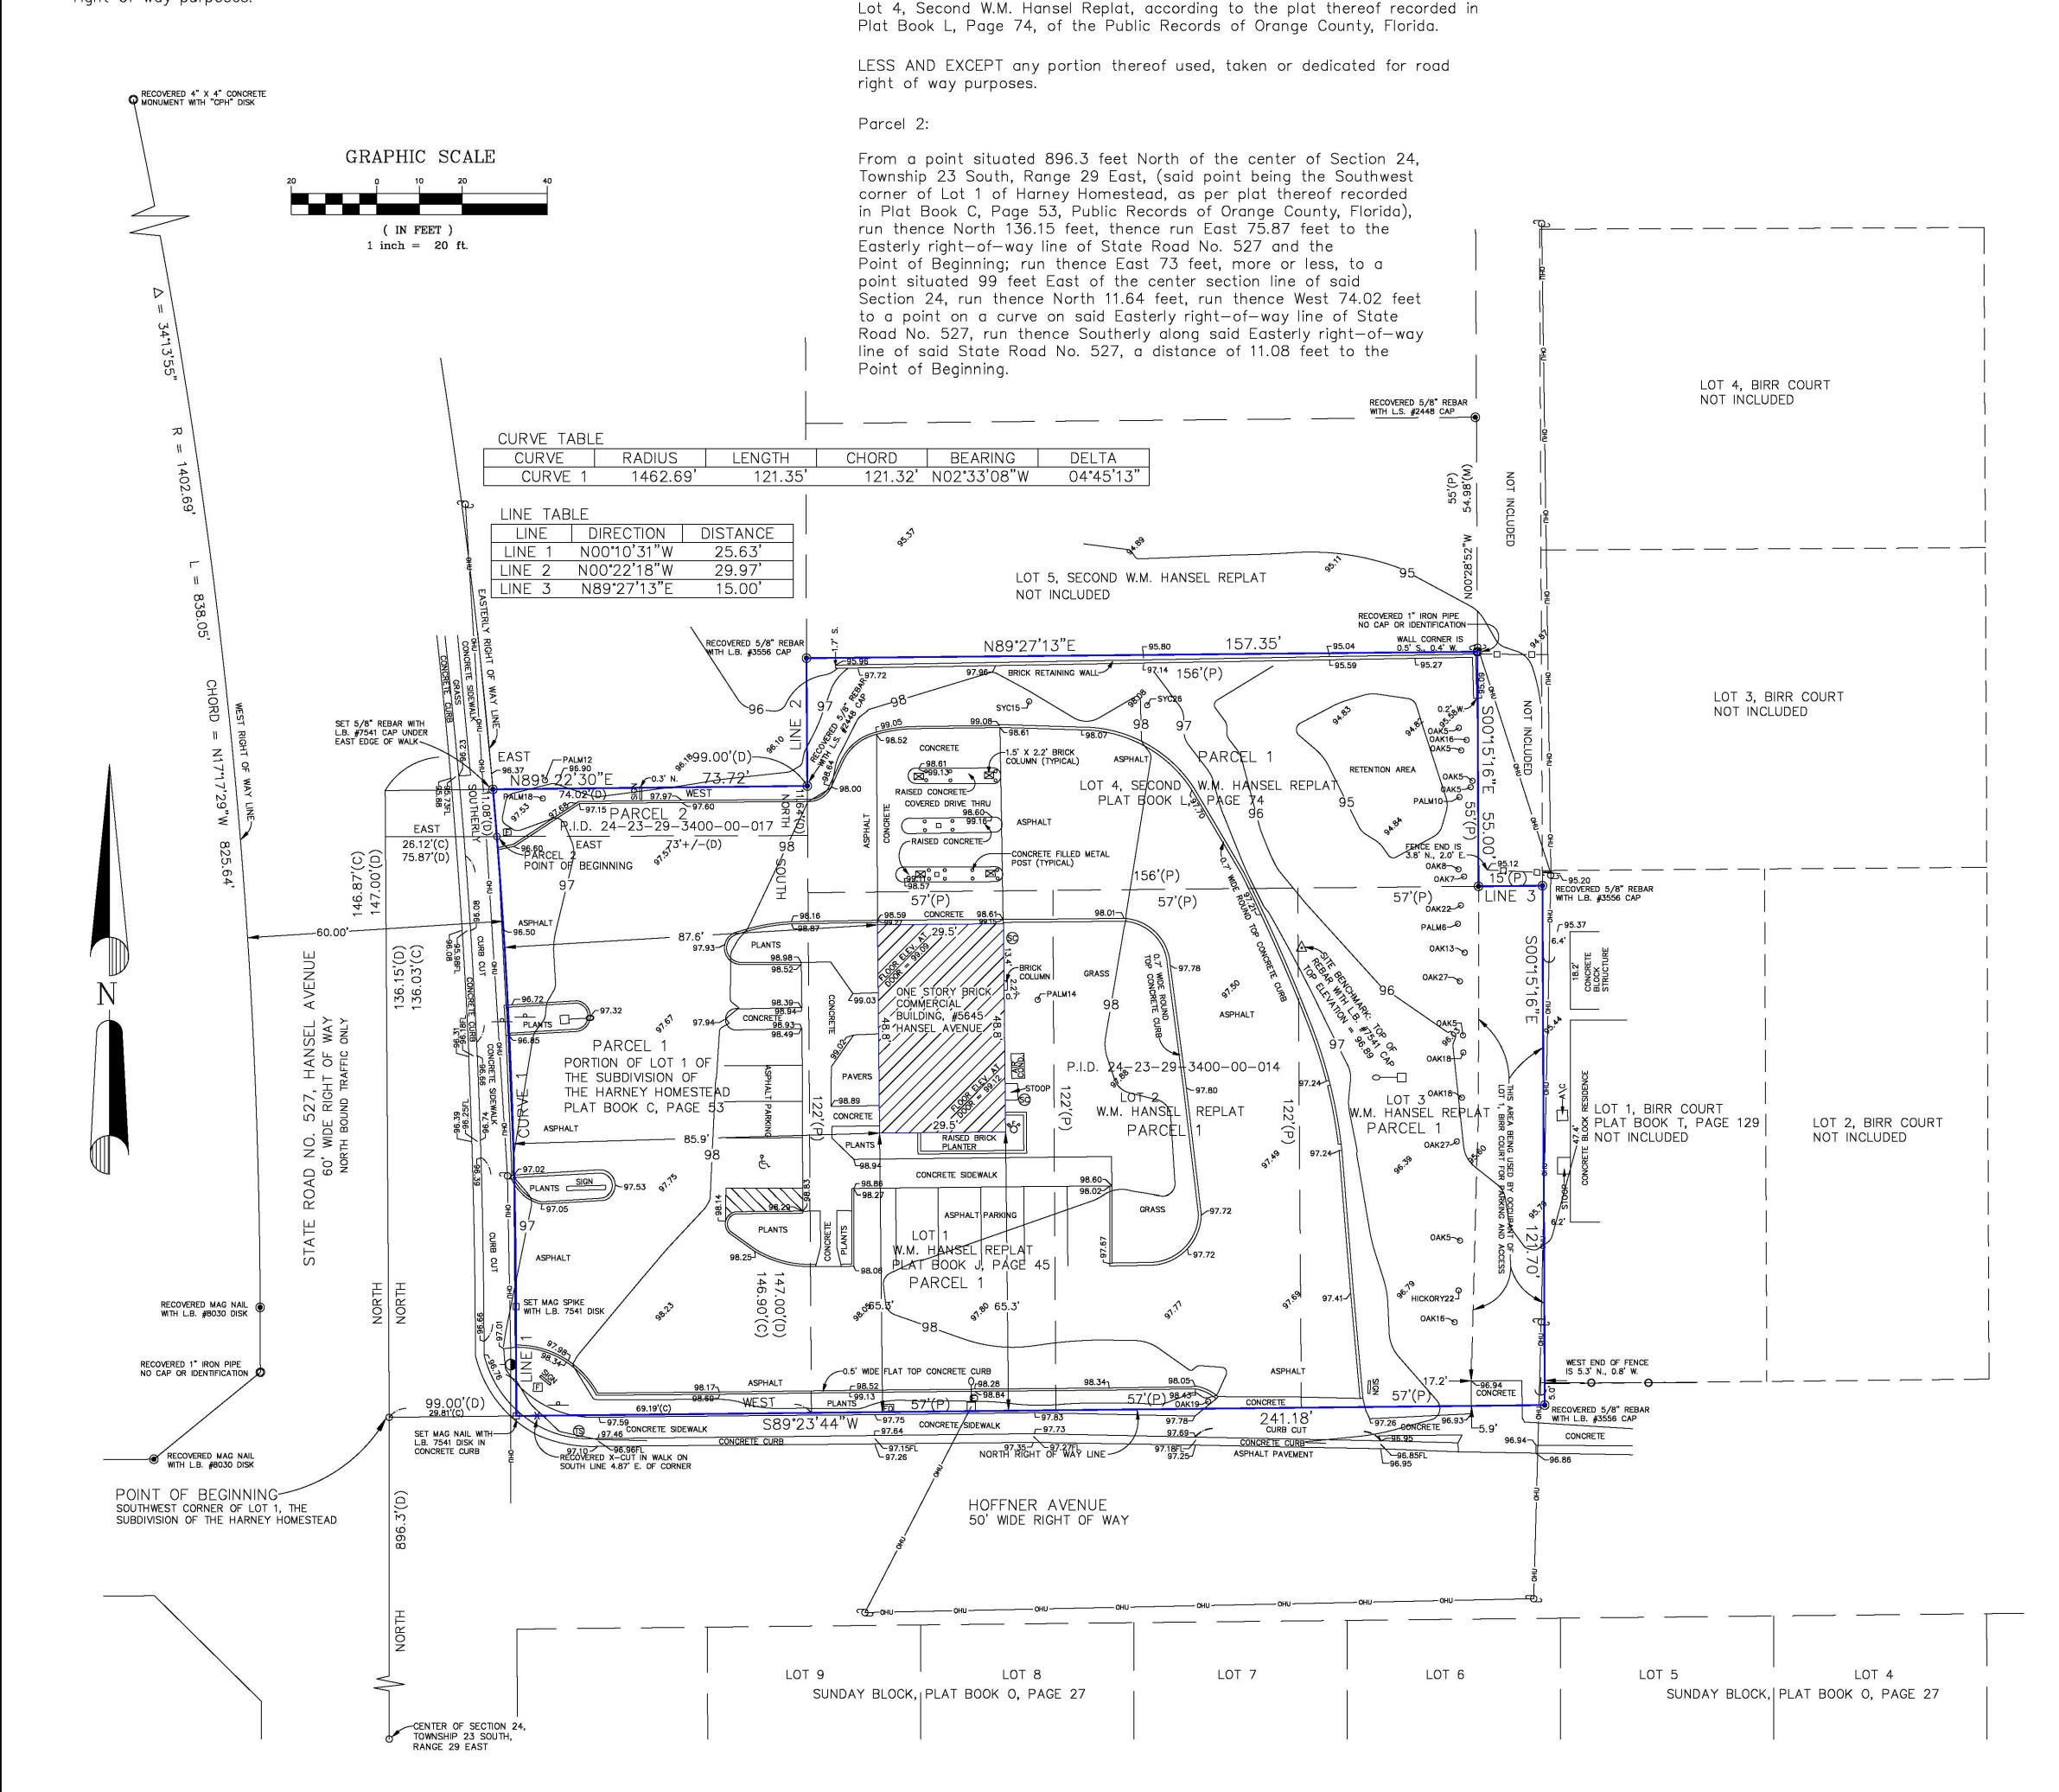

LEGAL DESCRIPTION - TITLE COMMITMENT;

Florida, and described as follows:

Parcel 1:

described as follows:

the Point of Beginning.

TOGETHER WITH:

TOGETHER WITH:

The land referred to herein below is situated in the County of Orange, State of

A portion of Lot 1 of The Subdivision of the Harney Homestead, more particularly

Begin at the Southwest corner of Lot 1, The Subdivision of the Harney Homestead,

according to the plat thereof recorded in Plat Book C, Page 53, of the Public

Records of Orange County, Florida; thence run North 147.00 feet; thence run

East 99.00 feet; thence run South 147.00 feet; thence run West 99.00 feet to

Lots 1, 2 and 3, W.M. Hansel Replat, according to the plat thereof recorded in

Plat Book J, Page 45, of the Public Records of Orange County, Florida.

SURVEYOR'S NOTES:

BEARINGS AS SHOWN HEREON ARE BASED ON THE NORTH RIGHT OF WAY LINE OF HOFFNER AVENUE HAVING AN ASSUMED BEARING OF S89°23'44"W.

THIS SURVEY WAS PREPARED WITH THE BENEFIT OF AND IN RELIANCE UPON A TITLE COMMITMENT ISSUED BY FIRST AMERICAN TITLE INSURANCE COMPANY ON 2-01-2021 WITH FILE NO. 2037-5167324. THIS SURVEYOR HAS NOT CONDUCTED ANY TITLE RESEARCH. THIS SURVEY WAS PREPARED FOR THE SOLE PURPOSE OF PROVIDING THE CLIENT WITH BOUNDARY INFORMATION TO BE USED FOR A MORTGAGE LOAN AND TRANSFER OF TITLE CLOSING TRANSACTION AND TOPOGRAPHIC INFORMATION TO BE FOR ANALYSIS OF POTENTIAL IMPROVEMENTS.

NON-VISIBLE AND/OR UNDERGROUND IMPROVEMENTS WERE NOT LOCATED, EXCEPT AS OTHERWISE SHOWN.

THERE MAY BE EASEMENTS AND/OR RESTRICTIONS OF RECORD AND/OR PRIVATE AGREEMENTS NOT FURNISHED TO THIS SURVEYOR OR SHOWN HEREON THAT MAY AFFECT PROPERTY RIGHTS AND/OR LAND USE RIGHTS OF THE LANDS SHOWN HEREON.

THERE MAY BE ENVIRONMENTAL ISSUES AND/OR OTHER MATTERS REGULATED BY VARIOUS DEPARTMENTS OF FEDERAL, STATE OR LOCAL GOVERNMENTS AFFECTING THE SUBJECT PROPERTY THAT ARE NOT SHOWN HEREON.

UTILITY LOCATIONS AS SHOWN HEREON ARE BASED ON FIELD LOCATION OF OBSERVABLE SURFACE AND ABOVE GROUND EVIDENCE OF UTILITY FACILITIES. THIS SURVEYOR DOES NOT WARRANT THE ACCURACY OF ANY UNDERGROUND FACILITIES AND YOUR ATTENTION IS DRAWN TO THE FACT THAT THERE MAY BE ADDITIONAL UNDERGROUND UTILITIES THAT DID NOT HAVE OBSERVABLE SURFACE EVIDENCE WHICH COULD BE LOCATED AND/OR SHOWN HEREON.

HAVING EXAMINED THE FLOOD INSURANCE RATE MAP PUBLISHED BY THE FEDERAL EMERGENCY MANAGEMENT AGENCY, IT IS THE OPINION OF THIS SURVEYOR THAT THE LANDS SHOWN AND DESCRIBED HEREON LIE IN FLOOD ZONE "X", DEFINED ON SAID F.I.R.M. AS "AREAS OF MINIMAL FLOODING." SEE MAP NUMBER 12095C0430 F. DATED 9-25-2009.

ELEVATIONS AS SHOWN HEREON ARE BASED ON ORANGE COUNTY BENCHMARK H709002 AND ARE REFERENCED TO THE NORTH AMERICAN VERTICAL DATUM OF 1988 (NAVD88).

THE SUBJECT PROPERTY CONTAINS 39,941 SQUARE FEET OR 0.917 ACRES, MORE OR LESS. SURVEY DATE (LAST DATE OF FIELD WORK): APRIL 8, 2021.

TITLE COMMITMENT NOTES:

REFERRING TO THE EXCEPTIONS AS LISTED IN THE TITLE COMMITMENT REFERENCED IN THE SURVEYOR'S NOTES, THIS SURVEYOR WOULD HAVE THE FOLLOWING COMMENTS; EXCEPTIONS 1 THROUGH 3 ARE STANDARD EXCEPTIONS, HOWEVER, PLEASE DIRECT YOUR ATTENTION TO THE EAST SIDE OF LOT 3, HANSEL REPLAT. THE EASTERLY PORTION OF LOT 3, AS SHOWN AND NOTED HEREON IS PRESENTLY BEING USED FOR PARKING AND ACCESS FROM HOFFNER AVE. BY THE OCCUPANT OF THE RESIDENCE ON THE ADJACENT LOT 1 OF BIRR COURT. THIS SURVEYOR WAS NOT PROVIDED WITH ANY EASEMENT DOCUMENTATION FOR THE EASTERLY PORTION OF LOT 3.

EXCEPTIONS 4 THROUGH 8 ARE STANDARD EXCEPTIONS.

EXCEPTION 9; MATTERS SHOWN ON THE PLAT OF THE SUBDIVISION OF THE HARNEY HOMESTEAD. THIS SURVEYOR DID NOT OBSERVE ANY MATTERS ON SAID PLAT THAT WOULD AFFECT THE SUBJECT PROPERTY. EXCEPTION 10; MATTERS SHOWN ON THE PLAT OF THE W. M. HANSEL REPLAT. THIS SURVEYOR DID NOT OBSERVE ANY MATTERS SHOWN ON THE PLAT OF SECOND W. M. HANSEL REPLAT. THIS SURVEYOR DID NOT OBSERVE ANY MATTERS ON SAID PLAT THAT WOULD AFFECT THE SUBJECT PROPERTY. EXCEPTION 12; DISTRIBUTION EASEMENT TO FLORIDA POWER CORP. RECORDED IN O.R. BOOK 3873, PAGE 1565. THIS EASEMENT AFFECTS THE SUBJECT PROPERTY BUT DOES NOT CONTAIN A PLOTTABLE LEGAL DESCRIPTION THAT CAN BE PLOTTED AND SHOWN HEREON. EXCEPTION 13; THIS EXCEPTION REFERS TO A RECORDED LEASE THAT IS NOT A SURVEY MATTER.

CONTIGUITY STATEMENT:

BASED ON THE LEGAL DESCRIPTION CONTAINED IN THE REFERENCED TITLE COMMITMENT AND ALSO ON THE BOUNDARY EVIDENCE RECOVERED IN THE FIELD AND SHOWN AND NOTED HEREON THIS SURVEYOR WOULD MAKE THE FOLLOWING STATEMENT;
PARCELS 1 AND 2, AS IDENTIFIED AS SUCH HEREON, ARE CONTIGUOUS TO EACH OTHER ALONG THEIR RESPECTIVE COMMON BOUNDARIES WITH NO GAPS, GORES OR HIATUSES ALONG SUCH COMMON BOUNDARIES.

LEGAL DESCRIPTION STATEMENT:

THE LANDS DESCRIBED IN THE LEGAL DESCRIPTION — DEED ARE ONE AND THE SAME AS THE LANDS DESCRIBED IN THE LEGAL DESCRIPTION — TITLE COMMITMENT.

CERTIFIED SOLELY AND EXCLUSIVELY TO WHITE & LUCZAK, P.A.
FIRST AMERICAN TITLE INSURANCE COMPANY
CNBM INVESTMENTS LLC
AXIOM BANK, N.A.



DOCUMENT WAS AUTHORIZED BY DONALD A. HORNE, PSM 4548

ON OCTOBER 25, 2021

MAP LEGEND:

(C) INDICATES A CALCULATED DISTANCE AND OR DIRECTION.

(D) INDICATES A DESCRIPTION DISTANCE AND OR DIRECTION

(P) INDICATES A PLAT DISTANCE AND \OR DIRECTION.

(M) INDICATES A MEASURED DISTANCE AND OR DIRECTION.

LB INDICATES LAND SURVEYING BUSINESS.

LS INDICATES INDIVIDUAL LICENSED LAND SURVEYOR.

PSM INDICATES PROFESSIONAL SURVEYOR AND MAPPER.

P.I.D. INDICATES PROPERTY IDENTIFICATION NUMBER.

ന്ച INDICATES A WOOD UTILITY POLE.

INDICATES A GUY WIRE ANCHOR.

O—☐ INDICATES AN OVERHEAD LIGHT ON A CONCRETE POLE.

- INDICATES A METAL SIGN ON A METAL POST.

10 INDICATES A PVC SANITARY CLEANOUT.

♥ INDICATES A WATER BACK FLOW PREVENTER.

1 INDICATES A TRAFFIC SIGNAL JUNCTION BOX.

I INDICATES A CONCRETE POLE OR SIGN FOOTER

- INDICATES A CONCRETE TRAFFIC SIGNAL POLE.

لا INDICATES A HANDICAP PARKING SPACE

© INDICATES AN ELECTRIC JUNCTION BOX.

© INDICATES A FIBER OPTIC JUNCTION BOX.

—они——oни—INDICATES OVERHEAD UTILITY LINE(S).

/97.31 INDICATES A SPOT ELEVATION SHOT AT THE END OF THE LEADER LOCATION.

98 INDICATES THE APPROXIMATE LOCATION OF THE 98 FOOT CONTOUR.

→95.82FL INDICATES A SPOT ELEVATION SHOT AT THE FLOW LINE OF THE CONCRETE CURB.

OAK22- INDICATES AN OAK TREE HAVING A 22" BREAST HEIGHT DIAMETER AT THE CENTER OF THE CIRCLE, END OF THE LEADER LOCATION.

6 PALM14 INDICATES AN OAK TREE HAVING A 14" BREAST HEIGHT DIAMETER AT THE CENTER OF THE CIRCLE, END OF THE LEADER LOCATION.

PREPARED FOR:

NELSON LERMA, JR.

1073 CAMPBELL STREET □RLAND□, FL□RIDA 32806 352-262-8955

MAP OF BOUNDARY
AND TOPOGRAPHIC
SURVEY

5643 AND 5645

IN SECTION 24, TOWNSHIP 23 SOUTH

ERTIFY THAT WE HAVE PERFORMED A FIELD SURVEY OF THE SIBED PROPERTY, FOR THE PURPOSE HEREON DESCRIBED SURVEY AND TANDARDS OF PRACTICE FOR SURVEYS SET FORTH IN TANDARDS OF PRACTICE FOR SURVEYS SET FORTH IN THE SOLLE AND NEFIT OF THE ENTITY AND OR INDIVIDUAL WHOMSOEVER DON'S SURVEY IS NOT VALID WITHOUT THE SIGNATURE AND ORIGINAL RAISE THIS SURVEY IS NOT VALID WITHOUT THE SIGNATURE AND ORIGINAL RAISE SURVEY IS NOT VALID WITHOUT THE SIGNATURE AND ORIGINAL RAISE SURVEY.


Re-21
THIS IS TO CERTIFY
HEREON DESCRIBED
AND THAT THIS DRA
MEETS THE STANDA
CHAPTER 5J-17, F.
EXCLUSIVE BENEFIT
BE RELIED UPON BY

 $\frac{RODNBARY SURVEY}{BDUNBARY SURVEY}$ ADD LEGAL DESCRIPTION — TITLE COMMIT.
REVISE NOTES PER ATTORNEY WHITE $\frac{F.B. PG. NDMAD}{CA \{C. By: DH}$ VARIOUS TO ADD TOPOGRAPHY $\frac{Drawn By: DH}{Drawn By: DH}$ Checked By: DH $\frac{Drawn By: DH}{Drawn By: DH}$ Checked By: DH $\frac{Drawn By: DH}{Drawn By: DH}$ Checked By: DH $\frac{Drawn By: DH}{Drawn By: DH}$

SCALE 1"= 20'

J∏B #

1B # 1 2329B ΩF 1

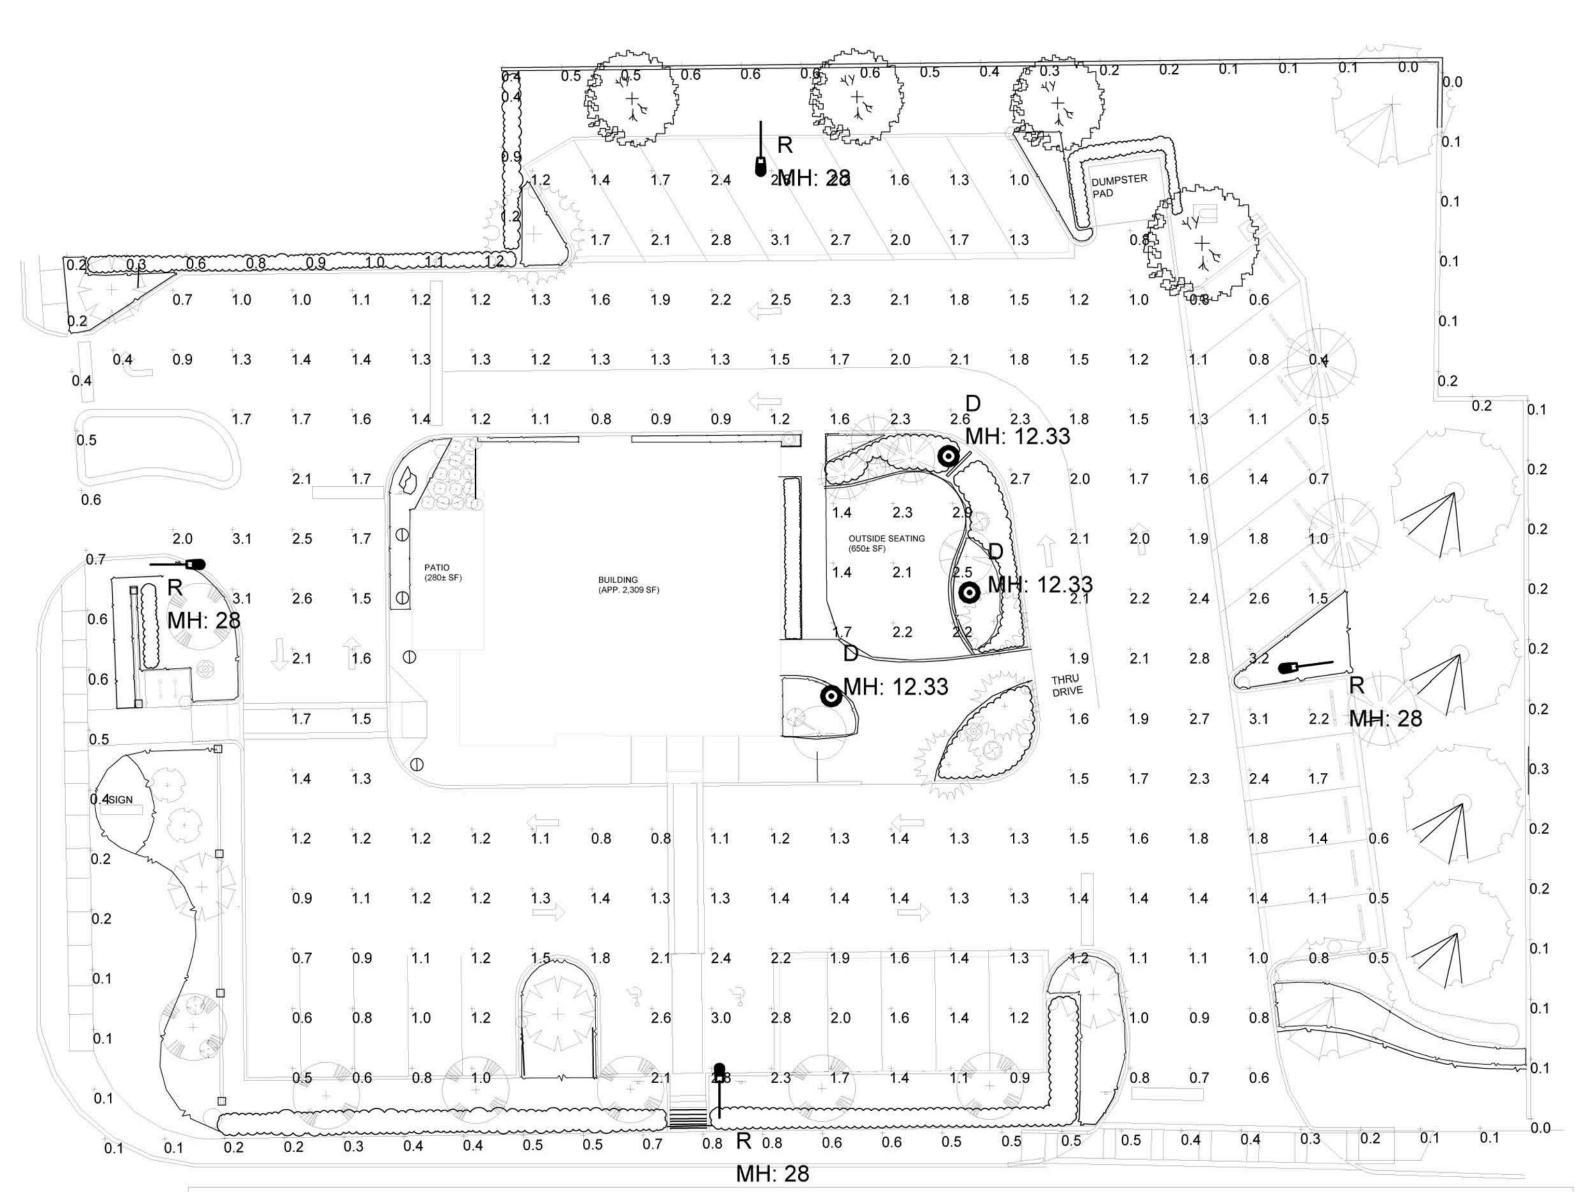

Luminaire Sche	uminaire Schedule							
Symbol	Qty	Label	Arrangement	Description	LLF	Lum Watts	Mtg Height	
0	3	D	Single	Duke Ocala 50W Type V Acorn	0.950	51.5	12.33	
	4	R	Single	Duke Roadway-110W-Type III-4000K	0.950	105	28	

Calculation Summary							
Label	CalcType	Units	Avg	Max	Min	Avg/Min	Max/Min
Outside Seating	Illuminance	Fc	2.08	2.9	1.4	1.49	2.07
Parking & Drive	Illuminance	Fc	1.53	3.2	0.4	3.83	8.00
Property Line	Illuminance	Fc	0.38	1.2	0.0	N.A.	N.A.

Luminaire	Location Sur	mmary				
		Insertion Po	oint			
LumNo	Label	X	Y	Z	Orient	Tilt
1	D	2002	-285.9	12.33	0	0
2	D	2025.1	-268.7	12.33	0	0
3	D	2021.6	-245.9	12.33	0	0
4	R	2085.8	-280.3	28	187.6	0
5	R	1983.3	-356.4	28	90	0
6	R	1888.2	-264	28	0	0
7	R	1990.2	-190	28	270	0

FOOTCANDLE ANALYSIS BY PHOTOMETRICS LLC 10/29/2021.

THE PARKING SURFACE IS ASSUMED TO BE ASPHALT.

THIS LAYOUT MEETS IES RP8-18 RECOMMENDATIONS FOR BASIC PARKING LOT LIGHTING LEVELS AND UNIFORMITY.

PPARKING LOT LIGHTS ARE 110 WATT LED AT 28' ABOVE FINISHED GRADE. PARKING LOT LIGHTS ARE FULL CUTOFF WITH NO LIGHT ABOVE HORIZONTAL. PEDESTRIAN LIGHTS ARE 52 WATT LED AT 12'4" ABOVE FINISHED GRADE. ALL PERIMETER LIGHTS ARE AIMED AWAY FROM NEIGHBORING PROPERTIES. CALCULATION GRIDS ARE AT GRADE (Z=0)

FOOTCANDLE READINGS DO NOT INCLUDE SHADOWING EFFECTS CAUSED BY OBSTRUCTIONS ONSITE SUCH AS BUILDINGS, TREES, ETC.

THE IES PHOTOMETRIC COMPUTER FILES USED FOR THIS ANALYSIS WERE PROVIDED BY THE MANUFACTURER(S) OF THE LIGHT FIXTURE(S) USED ON THIS PROJECT. THE ACCURACY OF THESE FILES ARE THE RESPONSIBILITY OF THE MANUFACTURER(S).

CONFORMANCE TO ANY AND ALL FACILITY, LOCAL, STATE, OR NATIONAL CODES AND REQUIREMENTS IS THE RESPONSIBILITY OF THE OWNER AND/OR THE OWNER'S REPRESENTATIVE.

CAREFUL PLACEMENT AND ORIENTATION OF THE LIGHT FIXTURES ONSITE IS REQUIRED FOR THIS COMPUTER SIMULATION TO BE ACCURATE.

NORMAL TOLERANCES OF VOLTAGE, TEMPERATURE, LAMP OUTPUT, AND BALLAST AND LUMINAIRE MANUFACTURER WILL AFFECT RESULTS.

Comments			
Date			
#			
I	Rev	rision	ns 🥋
en By: Bob Veazey	cked By:	e: 10/29/2021	le: 1/16"=1'(at 24"x36" Print Size)

CAFE MECATOS EDGEWATI

ome T Phot

#	Category	Summary	Comments	Responsibility	Response	Status
1	regs.	The landscape plan must follow the current ECO 2021 Amended Ordinance.		I A	Others to Address	
2		Per the above referenced ordinance, Division 12 – Edgewood Central District (ECO) Sec. 134-468-Site Design, (h) (2), Highrise live oaks are required 35' on center along Hansel Avenue and Hoffman Avenue. Que to overhead lines on Hansel Avenue, small or understory trees may be used 20' on center. The intent of the trees is to provide shade over the sidewalks. Refer to City current Tree Stock Replacement list for acceptable species.	The trees on Hansel have been changed to meet the ECD requirments.	HCE/Architect	Others to Address	
3	Tree Survey	Provide a tree survey and tree removal and mitigation plan per the requirements of Chapter 130 Tree Management and Protection. Coordinate tree removal with the Civil demolition plans.	Tree survey will be provided. Coordination with the civil demolition plan will also be provided.	Owner	Others to Address	
4		Refer to note 5 above regarding the bike racks. (5)The bike rack is allowed in the People Space, but is preferred behind the wall. The wall can bump out towards the street to allow for this. The "bump out" should be mirrored on the other side of the sidewalk for a symmetrical appearance. The depth of the bike rack must be a minimum of 72" wide, and 30" minimum between the vertical loops.	Bike rack requirements have been provided in the civil drawings.	Owner/HCE/LA	Sheet C-100, bike rack was added and wall was moved to be infront of racks	
5	Pavers	Refer to note 13 above regarding the pavers for the outdoor seating area. (13)The landscape plan indicates pavers for part of the outdoor seating area, and the remaining hatch pattern matches the artificial turf hatch pattern in the back of the building. The artificial turf is not appropriate for the front facade, and please make the seating area one material.	The building footprint has bee changed and the front patio will be all concrete. No artifical turf or pavers will be added to the front patio.	Owner/Architect/LA	Others to Address	
6	Flush Curb	There are several floating "Flush Curb" notes without leaders. I am not sure of their relevance on this plan.	The floating flush curb notes have been removed.	LA	Others to Address	
7	Globe Bollards	The 3' globe bollards and the annuals pot & saucer use the same symbol, and only 1 each is labeled. Please differentiate them graphically, or label all of them.	All circles with the a line going through the middle will be bollards for a total of 4, only on the west side of the property.	LA	Others to Address	
8	Brick Wall	Per {ECO) Sec. 134-468-Site Design, {g} {1}a, a 7' brick wall is required at the east property line instead of a 6' vinyl fence.	Waiver requested to the allow a 7' cream vinyl fence that wil blend with the environment. There are current power line accesibility requirements and land disputes that prevent a permanant structure at the east of the property.	Owner	Others to Address	

			0 1	1		
9	Cultivar		Cultivar names have			
_	names	Provide cultivar names under plant material botanical names.	been provided.	LA	Others to Address	
10	spelling		Spelling has been			
10	Spennig	Elaeocarpus is misspelled on the plant list.	corrected.	LA	Others to Address	
	II-i-ba/		Height and spread of			
11	Height/		the plant list has been			
	spread	Provide height and spread in the plant list descriptions.	provided.	LA	Others to Address	
			Details for the artificial			
12	Artificial Turf		turf area has been			
	7 ti cinician i ani	Provide detail for artificial turf area.	provided.	IΛ	Others to Address	
		Trovide detail for artificial tarrarea.	provided.		Others to Address	
					Chart C 400 datail	
13	Pavers details				Sheet C-400, detail	
		Reference paver detail on civil drawing sheet C-400 detail 7. Confirm if all paver areas intended			comfirmed that all paver	
		to be pervious, per the civil detail.		LA/HCE	areas to be pervious	
			Tree survey will be			
14			provided. Coordination			
14	Trees		with the civil demolition			
	Demolition	Trees shown to be removed on the landscape drawing are shown protected on the demolition	plan will also be			
	plan	plans. Please coordinate.	provided.	HCE/LA	Others to Address	
			The ADA accessible			
			spaces and crosswalk			
			could not be moved due			
15			to the grading			
		Align the sidewalk and crosswalk from Hansel Avenue with the double door entrance on the	requirements for the			
	Crosswalk	west side.	site.	HCE	Others to Address	
			The ADA accessible			
			spaces and crosswalk			
16			could not be moved due			
10			to the grading			
	ADA	Align the ADA access with the double doors entrance on the south, for a more direct route,	requirements for the			
	Crosswalk	further west from the drive through lane vehicle stacking.	site.	HCE/LA		
17			A six feet pedestrian		Sheet C-100, 6' wide	
17	Hoffner	Provide a 6' wide pedestrian connection from Hoffman Avenue per the People Space	connection on Hoffner		connection provided	
	Pedestrian	requirements in the ECO.	has been provided.	HCE/LA	from Hoffman	
		'	The south side		Sheet C-100, sheet	
18		The landscape plans show foundation planting on the south side of the building. The civil	landscape has been		ajusted to display	
10	Consistency	drawings do not show a landscape bed.	removed.	HCE/LA	planters	
	Consistency	urawings do not show a lanuscape bed.	Temoveu.	TICL/LA	Sheet C-401, Sheet C-	
19			The appropriate ADA :-			
19	ADA Bowr	Call out the appropriate ADA rooms details as site or grading plan from about C 401	The appropriate ADA is	HCE	100, ADA ramps called	
	ADA Ramp	Call out the appropriate ADA ramp details on site or grading plan from sheet C-401.	called out in C-401	HCE	out per Index	
			The flush curb has been			
20		What is the purpose of the 20' flush curb SW of the building? How will you protect from	removed and replaced	Owner/LA/HCE		
		vehicular access into seating area?	with a D curve.	, 4.1.02		
	Question		a D carve.		Others to Address	

	Pole	Move the light pole in the east parking area behind the parking spaces.	island has been created.	Owner/HCE	Others to Address	
25	East Light		Parking spaces have been rearranged, and an			
24	Demolition	The demolition plans do not show the removal of the existing concrete apron to Hoffman Avenue, east of the proposed driveway. Sheet C-100 shows a curb crossing the existing driveway apron, and the landscape plan shows sod. Please coordinate.		НСЕ	Sheet C-003, sheet not includes demoltion of existing driveway apron	
23	_	Show FDOT Greenbook sight triangles at exits on to Hansel Avenue and Hoffman Avenue, on	Sight triangles have been added to the landscape plans.	HCE/LA	Others to Address	
22		Coordinate with FDOT for the driveway cut shown on sheet C-101. The site driveway curb does not match the FDOT driveway curb.	'		Sheet C-101, Sheet updated to match FDOT curbing	
21	Signage		Signage has been provided in the civil drawings.	HCE	Sheet C-100, traffic signage added to sheet	