

RENOVATIONS TO DRIPPING SPRINGS SPORTS & RECREATION PARK ATHLETIC FIELDS LIGHTING DRIPPING SPRINGS, TEXAS



PARKS & RECREATION COMMISSION


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LOCATION MAP



VICINITY MAP


JASON W. REED
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Sep 01, 2020

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SUBMISSION OF BID WILL BE CONSIDERED ACKNOWLEDGMENT THAT THE CONTRACTOR HAS VISITED THE SITE AND HAS VERIFIED ALL EXISTING JOB CONDITIONS AND INCLUDED ANY NECESSARY MODIFICATION TO EXISTING AND NEW WORK REQUIRED FOR INSTALLATION OF A COMPLETE AND WORKING SYSTEM.

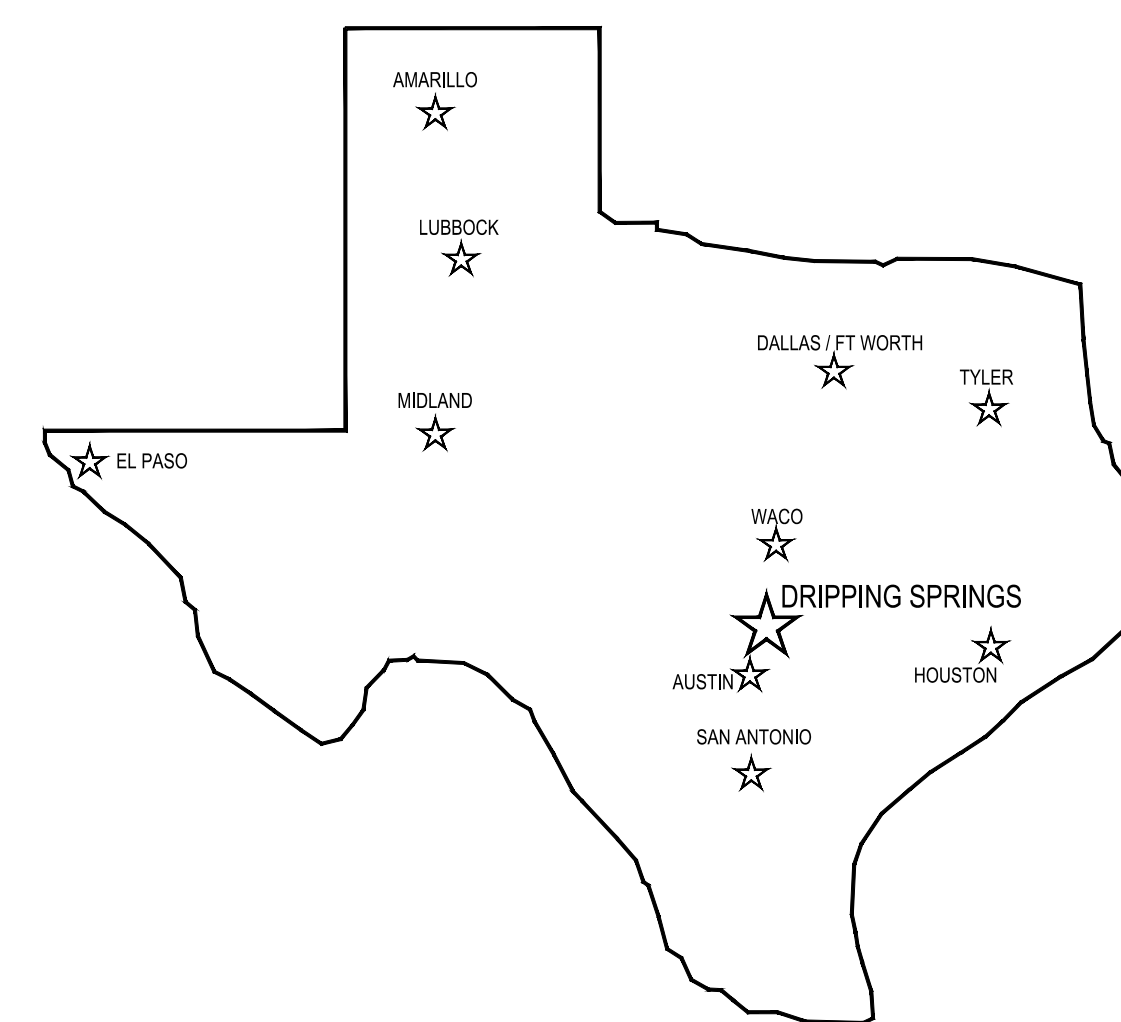

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ISSUE DATE
August 24, 2020

REVISION DATE

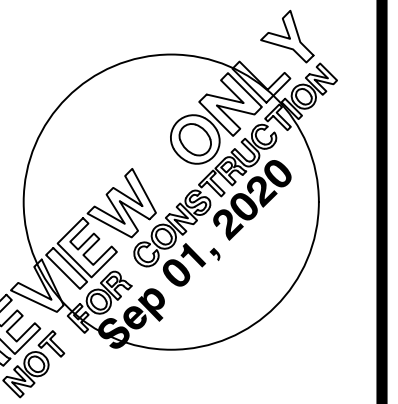
RENOVATIONS TO
SPORTS & RECREATION PARK ATHLETIC FIELDS LIGHTING
CITY OF DRIPPING SPRINGS
DRIPPING SPRINGS, TX

EMA JOB #: 2 001 1663 001
DRAWN BY: **SRW**
CHECKED: **QC**

COVER SHEET

SHEET NUMBER

COVER

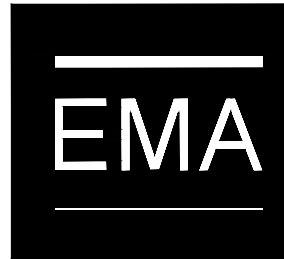


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 DRAWN BY: **clh**
 CHECKED: **qc**

PROJECT
PHASING PLAN


SHEET NUMBER
E100

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1 PROJECT PHASING PLAN
 1"=60'-0"

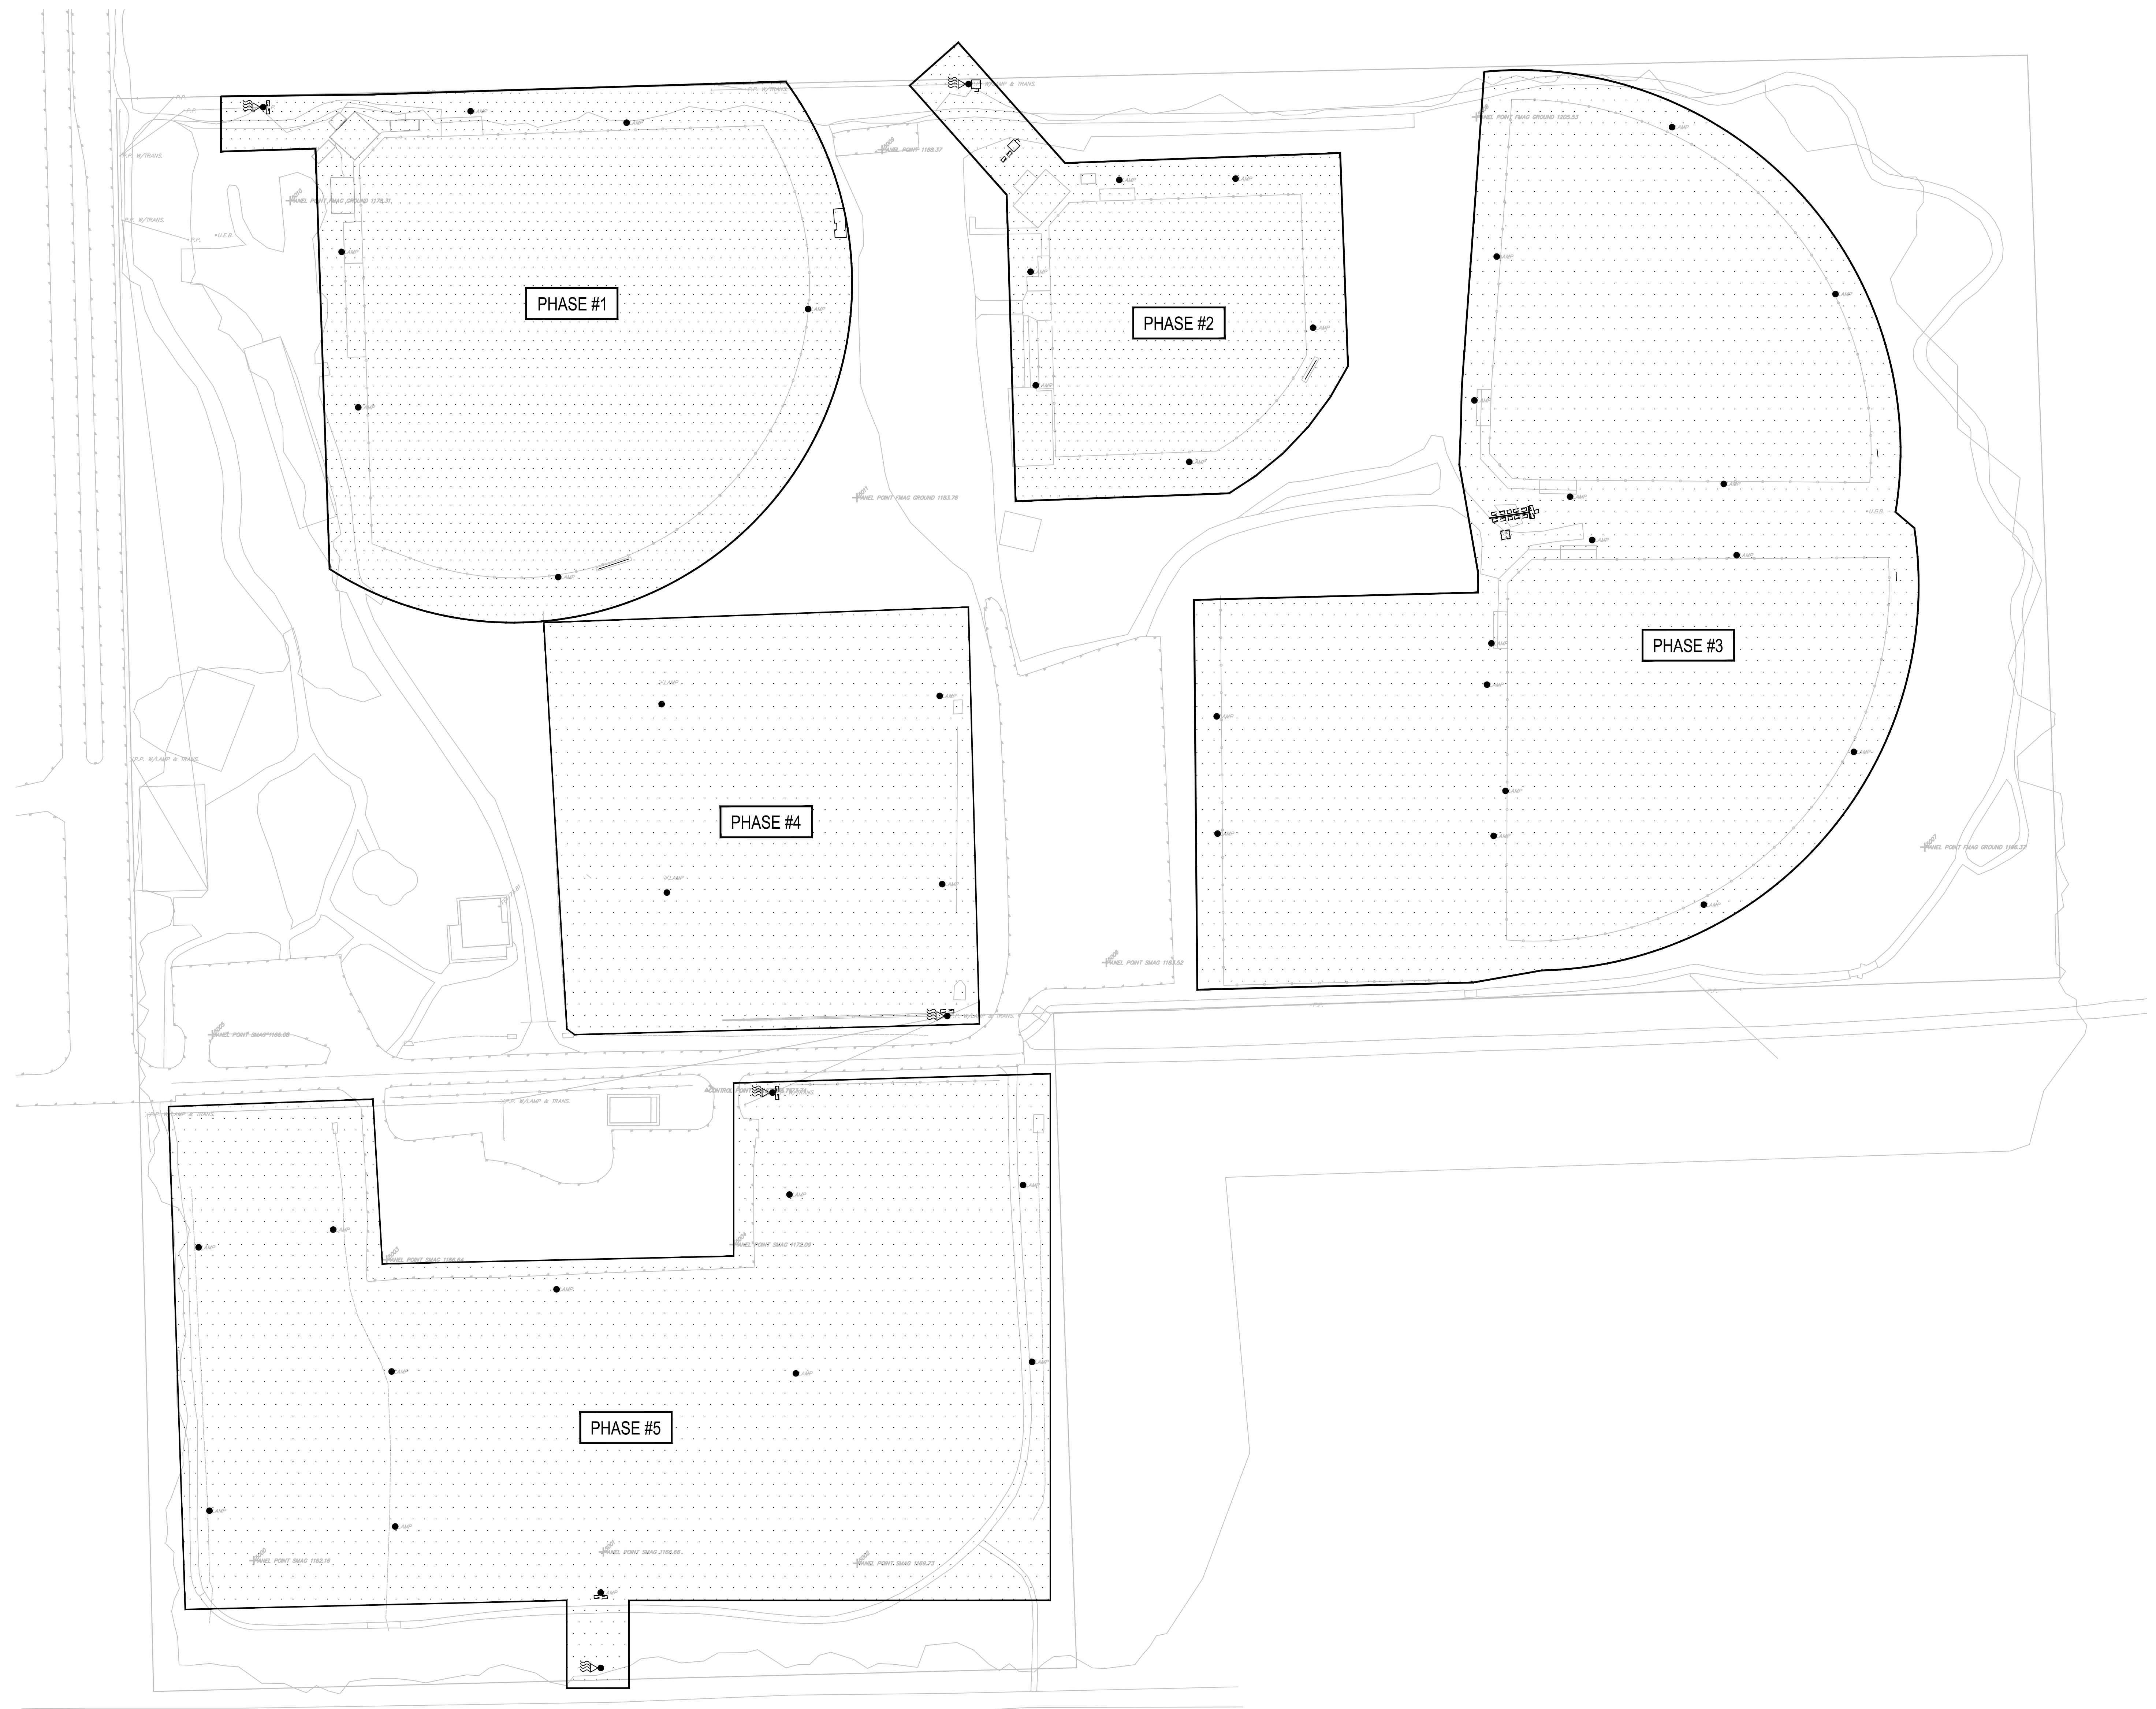

ELECTRICAL DEMOLITION GENERAL NOTES
(SOME NOTES MAY NOT BE USED)


- CONTRACTORS AND SUBCONTRACTORS SHALL VERIFY LOCATION, CONDUCT TEST AND INSPECTIONS, COORDINATE WITH UTILITIES, OWNER'S REPRESENTATIVES, AND CHECK FOR ALL UNDERGROUND UTILITIES AND LINES BEFORE DITCHING TAKES PLACE. CONTRACTOR AND SUBCONTRACTORS PERFORMING THESE DUTIES SHALL BE RESPONSIBLE FOR ANY REPAIRS OF CUT OR DAMAGED LINES AND UTILITIES NOT SHOWN ON PLANS.
- UNLESS NOTED ON DRAWINGS, ALL LIGHTING, SWITCHES, OUTLETS AND OTHER ELECTRICAL DEVICES ARE TO REMAIN.
- REFER TO SPECIFICATION SECTION 26 05 11, ELECTRICAL DEMOLITION REMODELING, FOR GENERAL DEMOLITION REQUIREMENTS.
- ALL MATERIAL REMOVED AND NOT RETAINED BY THE OWNER SHALL BE DISPOSED OF OFF SITE IN A LAWFUL MANNER.
- BEFORE DEMOLISHING PANELS, TRACE ALL BRANCH CIRCUITS TO CONFIRM THAT EXISTING LOADS HAVE BEEN RELOCATED TO NEW PANELS. IF A LOAD EXISTS THAT HAS NOT BEEN RELOCATED TO NEW PANELS, CONTACT THE ENGINEER FOR INSTRUCTIONS.
- THE LOCATIONS FOR ALL EXISTING POWER POLES, DISCONNECTS, PANELBOARDS, SPORTS LIGHTING POLES, ETC. ARE APPROXIMATE.

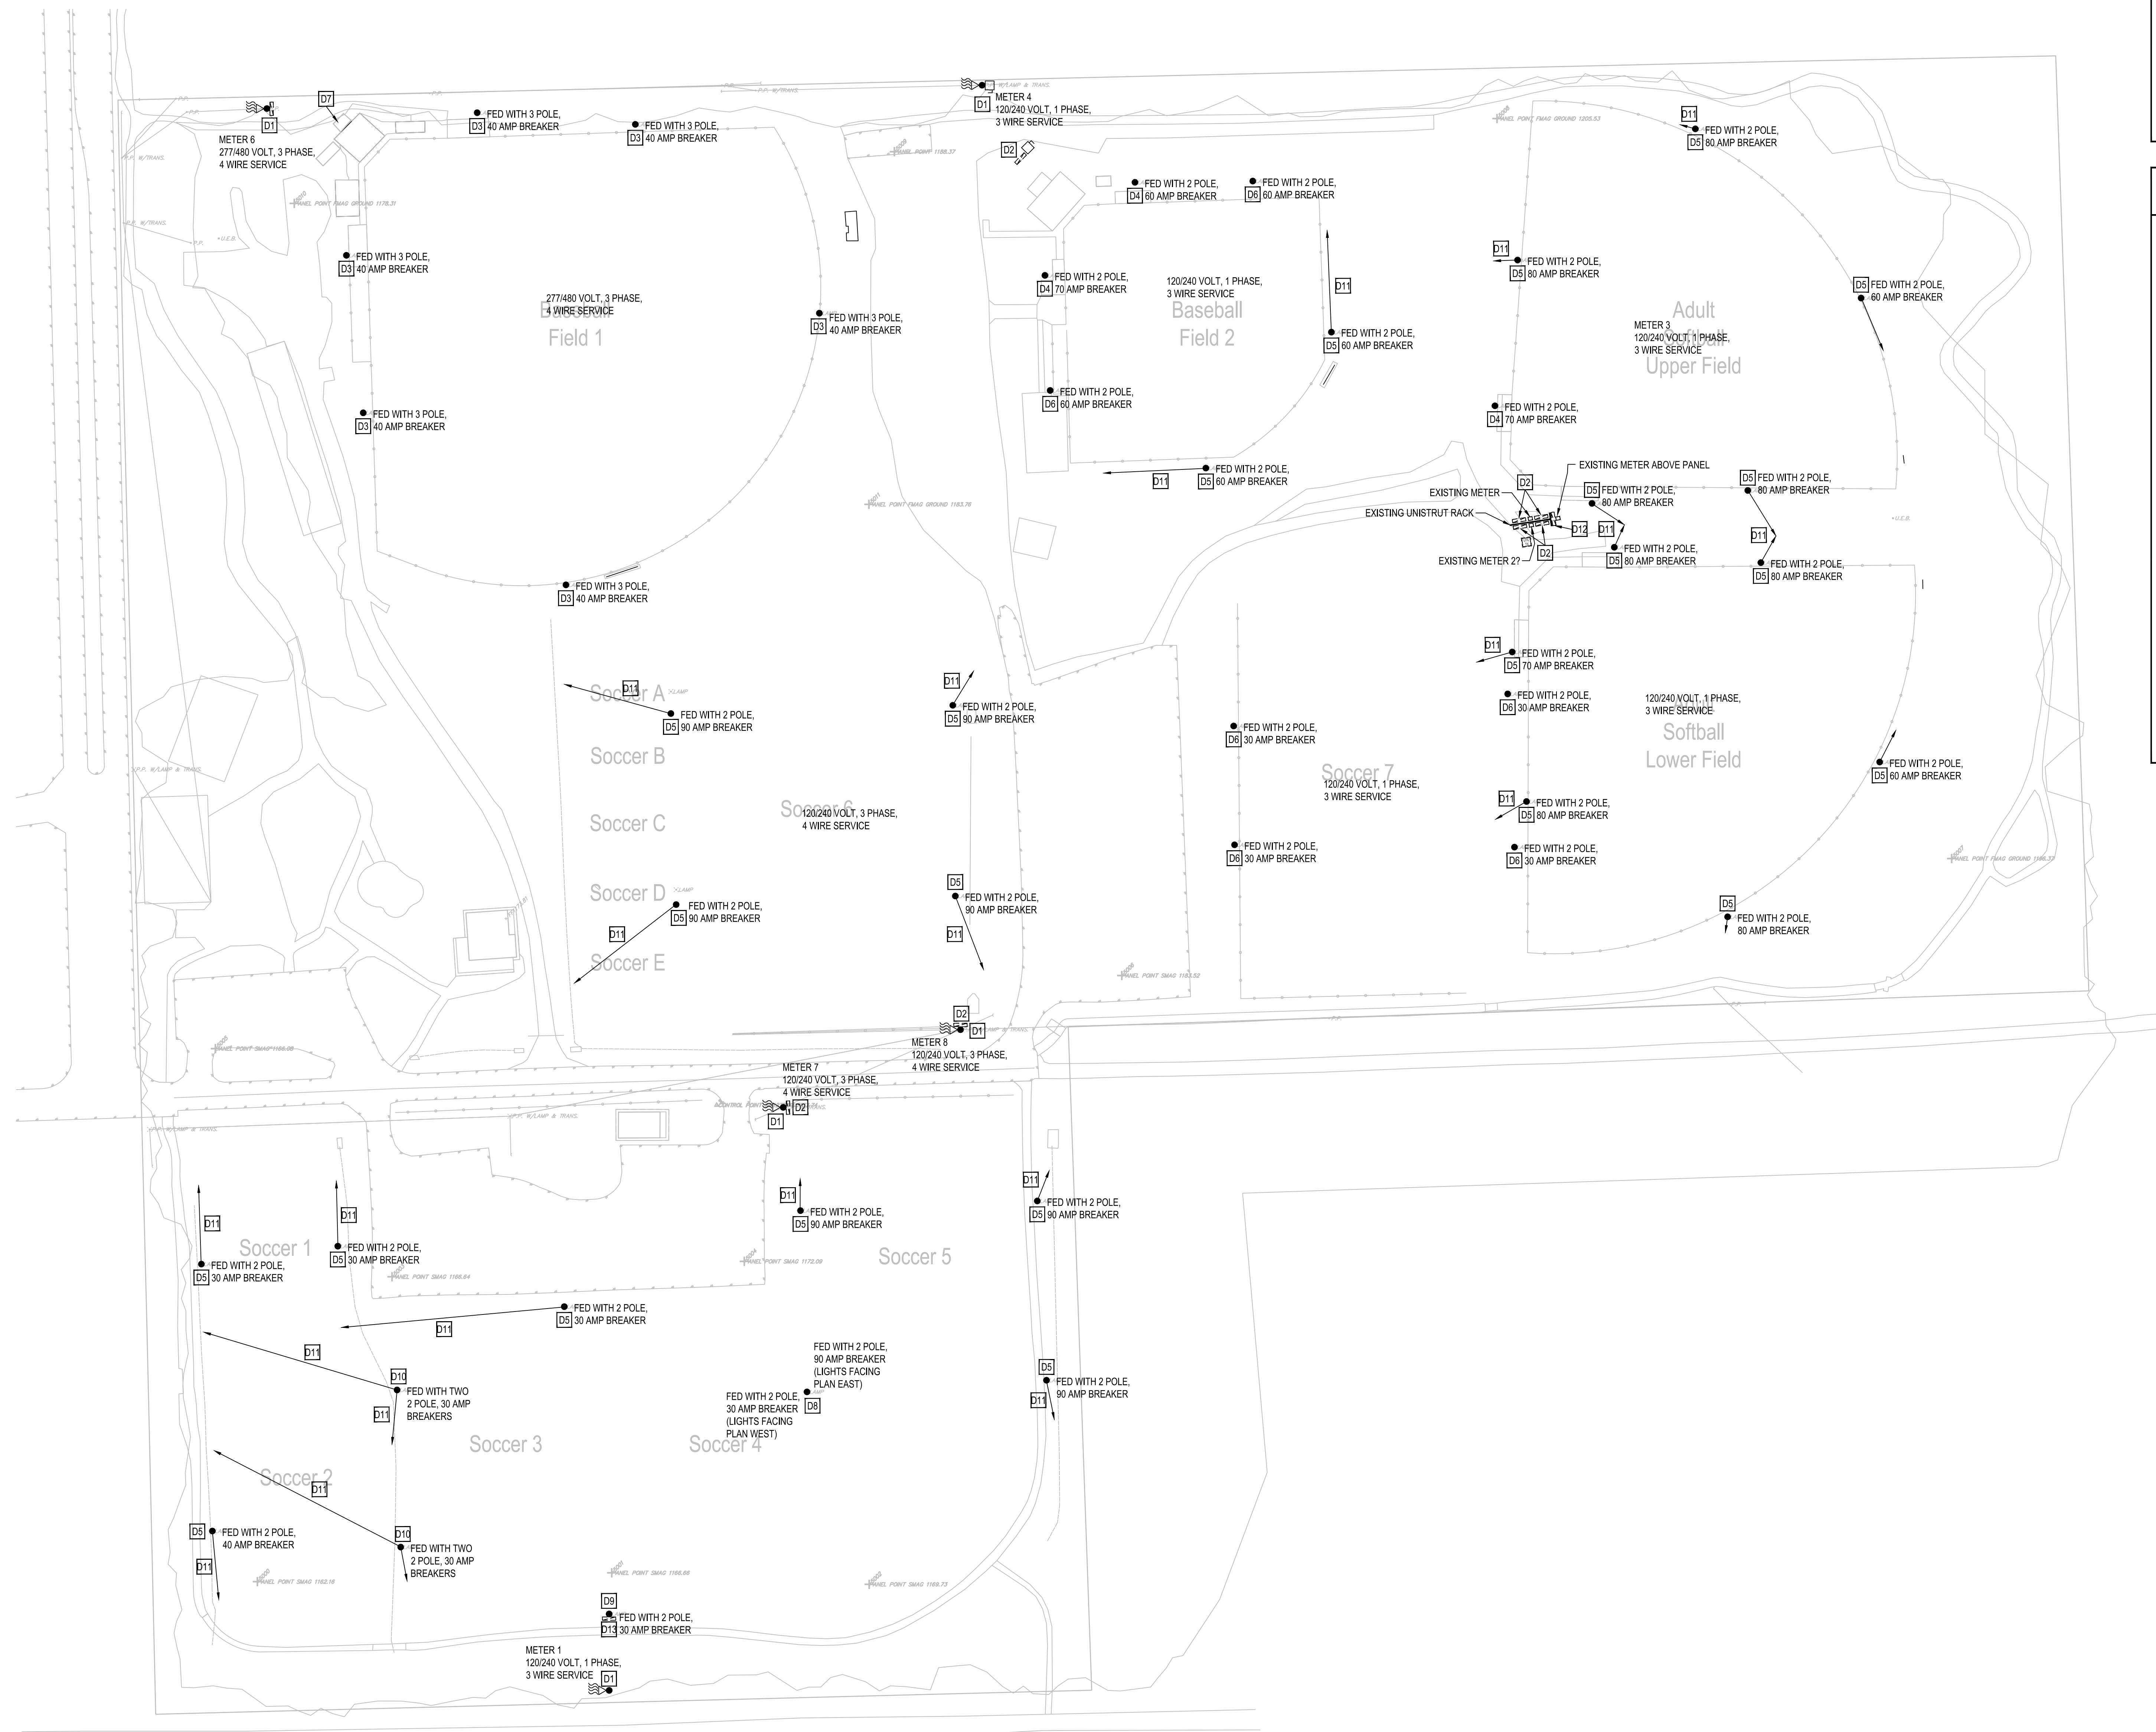ELECTRICAL DEMOLITION PLAN NOTES
(SOME NOTES MAY NOT BE USED)

- D1 EXISTING UTILITY SERVICE TO REMAIN IN PLACE AND OPERATIONAL.
- D2 EXISTING PANEL TO REMAIN IN PLACE AND OPERATIONAL.
- D3 EXISTING SPORTS LIGHTING POLE TO REMAIN IN PLACE. EXISTING SPORTS LIGHTING LUMINAIRES TO BE REMOVED AND REPLACED. EXISTING CONDUIT AND WIRING TO REMAIN IN PLACE. EXISTING BREAKER FEEDING THIS POLE TO BE REMOVED AND REPLACED.
- D4 EXISTING SPORTS LIGHTING POLE AND LUMINAIRES TO BE REMOVED AND REPLACED WITH NEW POLE AND LIGHTS AT THIS APPROXIMATE LOCATION. EXISTING CONDUIT AND WIRING TO REMAIN IN PLACE. EXISTING BREAKER FEEDING THIS POLE TO BE REMOVED AND REPLACED.
- D5 EXISTING SPORTS LIGHTING POLE AND LUMINAIRES TO BE REMOVED AND REPLACED WITH NEW POLE IN A NEW LOCATION. EXISTING CONDUIT AND WIRING TO REMAIN. CONDUIT AND WIRING TO BE PREPARED TO BE EXTENDED TO NEW POLE LOCATION. EXISTING BREAKER FEEDING THIS POLE TO BE REMOVED AND REPLACED.
- D6 EXISTING SPORTS LIGHTING POLE AND LUMINAIRES TO BE REMOVED. REMOVE EXISTING CONDUIT AND WIRING BACK TO SOURCE.
- D7 EXISTING PANELBOARD IN PRESSBOX TO REMAIN IN PLACE AND OPERATIONAL. EXISTING MUSCO CONTROL CABINET TO BE REMOVED AND REPLACED. EXISTING FEEDER AND EXISTING BRANCH CIRCUITS TO REMAIN IN PLACE AND OPERATIONAL.
- D8 EXISTING SPORTS LIGHTING POLE AND LUMINAIRES TO BE REMOVED AND REPLACED WITH NEW POLE AND LIGHTS AT THIS APPROXIMATE LOCATION. EXISTING CONDUIT AND WIRING FOR 90AMP CIRCUIT TO REMAIN IN PLACE. REMOVE EXISTING CONDUIT AND WIRING FOR 30AMP CIRCUIT BACK TO SOURCE. EXISTING BREAKERS FEEDING THIS POLE TO BE REMOVED AND REPLACED.
- D9 EXISTING PANEL TO REMAIN IN PLACE. EXISTING SPORTS LIGHTING TO BE REMOVED. REMOVE CONDUIT AND WIRING BACK TO SOURCE.
- D10 EXISTING SPORTS LIGHTING POLE AND LUMINAIRES TO BE REMOVED AND REPLACED WITH NEW POLE IN A NEW LOCATION. EXISTING CONDUIT AND WIRING FOR BOTH 30AMP CIRCUITS TO BE PREPARED TO BE EXTENDED TO NEW LOCATIONS. EXISTING BREAKERS FEEDING THIS POLE TO BE REMOVED AND REPLACED.
- D11 EXISTING CONDUIT AND WIRING TO BE PREPARED TO EXTEND IN DIRECTIONS SHOWN TO NEW POLE LOCATIONS.
- D12 EXISTING PANEL TO BE REMOVED AND REPLACED. REMOVE EXISTING FEEDER BACK TO SOURCE. EXISTING BRANCH CIRCUITS FOR PUMP AND TIMER TO REMAIN IN PLACE AND OPERATIONAL.
- D13 EXISTING PANEL TO BE REMOVED AND REPLACED. REMOVE EXISTING FEEDER BACK TO SOURCE. EXISTING BRANCH CIRCUITS TO REMAIN IN PLACE AND OPERATIONAL.



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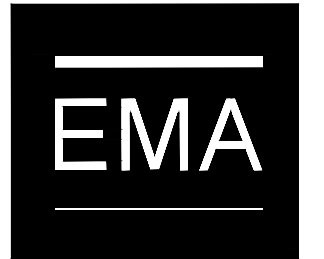
**ELECTRICAL
DEMOLITION
SITE PLAN**

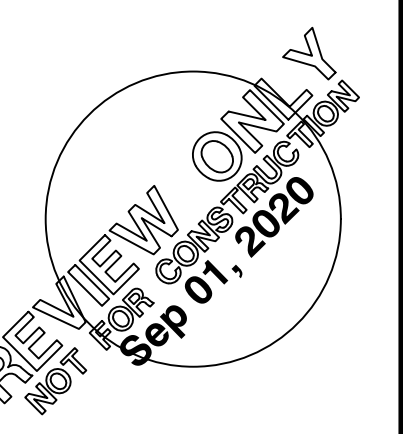SHEET NUMBER
EDS101


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CHECKED:	QC

**ELECTRICAL
 SITE PLAN**

SHEET NUMBER
ES101

ELECTRICAL SITE GENERAL NOTES

(SOME NOTES MAY NOT BE USED)

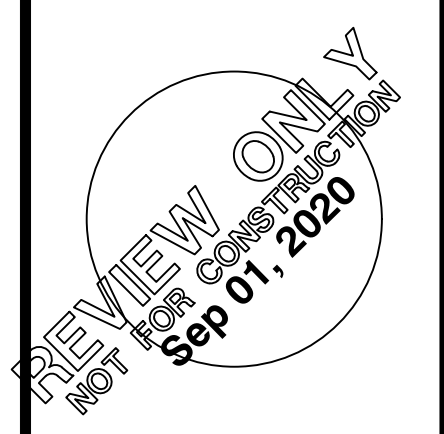- CONTRACTORS AND SUBCONTRACTORS SHALL VERIFY LOCATION, CONDUCT TEST AND INSPECTIONS, COORDINATE WITH UTILITIES, OWNER'S REPRESENTATIVES, AND CHECK FOR ALL UNDERGROUND UTILITIES AND LINES BEFORE DITCHING TAKES PLACE. CONTRACTOR AND SUBCONTRACTORS PERFORMING THESE DUTIES SHALL BE RESPONSIBLE FOR ANY REPAIRS OF CUT OR DAMAGED LINES AND UTILITIES NOT SHOWN ON PLANS.
- FOR ALL NEW SPORTS LIGHTING CIRCUITS, DO NOT ROUTE CONDUIT UNDERNEATH THE FIELDS. ALL CONDUITS SHALL GO AROUND THE FIELDS.
- FOR ALL SPORTS LIGHTING CIRCUITS BEING EXTENDED TO A NEW LOCATION, DO NOT ROUTE NEW CONDUIT UNDERNEATH THE FIELDS, WHERE THERE IS ANY DIGGING OR TRENCHING ON THE FIELDS, FILL IN DIRT AND SOO TO MATCH EXISTING CONDITIONS.

ELECTRICAL SITE PLAN NOTES

(SOME NOTES MAY NOT BE USED)

- NEW MUSCO CONTROL CABINET INSTALLED ON UNISTRUT SUPPORT. PROVIDE TWO SINGLE POLE, 20AMP BREAKERS WITH #12 WIRE FROM ADJACENT EXISTING PANEL FEEDING NEW SPORTS LIGHTING.
- EXTEND CONDUIT AND WIRING TO NEW POLE LOCATION FROM DEMOLISHED POLE LOCATION.
- PROVIDE NEW LED SPORTS LIGHTING ON EXISTING POLE. CONNECT TO EXISTING LIGHTING CIRCUIT AT THIS LOCATION. REMOVE EXISTING THREE POLE, 40AMP BREAKER FEEDING THIS POLE AND REPLACE WITH NEW THREE POLE, 20AMP BREAKER.
- NEW SPORTS LIGHTING POLE TO BE INSTALLED AT EXISTING POLE LOCATION. CONNECT TO EXISTING LIGHTING CIRCUIT AT THIS LOCATION. REMOVE EXISTING TWO POLE, 60AMP BREAKER FEEDING THIS POLE AND REPLACE WITH NEW TWO POLE, 30AMP BREAKER. EXTEND CONDUIT AND WIRING AS NECESSARY.
- NEW SPORTS LIGHTING POLE TO BE INSTALLED AT EXISTING POLE LOCATION. CONNECT TO EXISTING LIGHTING CIRCUIT AT THIS LOCATION. REMOVE EXISTING TWO POLE, 70AMP BREAKER FEEDING THIS POLE AND REPLACE WITH NEW TWO POLE, 30AMP BREAKER. EXTEND CONDUIT AND WIRING AS NECESSARY.
- NEW SPORTS LIGHTING POLE. CONNECT TO EXISTING LIGHTING CIRCUIT FROM EXISTING POLE LOCATION AS SHOWN. REMOVE EXISTING TWO POLE, 60AMP BREAKER FEEDING THIS POLE AND REPLACE WITH NEW TWO POLE, 50AMP BREAKER. EXTEND CONDUIT AND WIRING AS NECESSARY.
- NEW SPORTS LIGHTING POLE. CONNECT TO EXISTING LIGHTING CIRCUIT FROM EXISTING POLE LOCATION AS SHOWN. REMOVE EXISTING TWO POLE, 80AMP BREAKER FEEDING THIS POLE AND REPLACE WITH NEW TWO POLE, 50AMP BREAKER. EXTEND CONDUIT AND WIRING AS NECESSARY.
- NEW SPORTS LIGHTING POLE. CONNECT TO EXISTING LIGHTING CIRCUIT FROM EXISTING POLE LOCATION AS SHOWN. REMOVE EXISTING TWO POLE, 60AMP BREAKER FEEDING THIS POLE AND REPLACE WITH NEW TWO POLE, 50AMP BREAKER. EXTEND CONDUIT AND WIRING AS NECESSARY.
- NEW SPORTS LIGHTING POLE. CONNECT TO EXISTING LIGHTING CIRCUITS FROM EXISTING POLE LOCATIONS AS SHOWN. REMOVE EXISTING TWO POLE, 80AMP BREAKER FEEDING THIS POLE AND REPLACE WITH NEW TWO POLE, 50AMP BREAKER TO FEED LIGHTS ON PLAN SOUTH SIDE OF POLE. REMOVE SECOND EXISTING TWO POLE, 80AMP BREAKER FEEDING THIS POLE AND REPLACE WITH NEW TWO POLE, 30AMP BREAKER TO FEED LIGHTS ON PLAN NORTH SIDE OF POLE. EXTEND CONDUIT AND WIRING AS NECESSARY.
- NEW SPORTS LIGHTING POLE. CONNECT TO EXISTING LIGHTING CIRCUITS FROM EXISTING POLE LOCATIONS AS SHOWN. REMOVE EXISTING TWO POLE, 80AMP BREAKER FEEDING THIS POLE AND REPLACE WITH NEW TWO POLE, 50AMP BREAKER TO FEED LIGHTS ON PLAN SOUTH SIDE OF POLE. REMOVE SECOND EXISTING TWO POLE, 80AMP BREAKER FEEDING THIS POLE AND REPLACE WITH NEW TWO POLE, 30AMP BREAKER TO FEED LIGHTS ON PLAN NORTH SIDE OF POLE. EXTEND CONDUIT AND WIRING AS NECESSARY.
- NEW SPORTS LIGHTING POLE. CONNECT TO EXISTING LIGHTING CIRCUIT FROM EXISTING POLE LOCATION AS SHOWN FOR LIGHTS ON PLAN EAST SIDE OF POLE. REMOVE EXISTING TWO POLE, 70AMP BREAKER FEEDING THIS POLE AND REPLACE WITH NEW TWO POLE, 50AMP BREAKER TO FEED LIGHTS ON PLAN EAST SIDE OF POLE. EXTEND CONDUIT AND WIRING AS NECESSARY. PROVIDE POWER TO LIGHTS FROM CIRCUIT SHOWN.
- NEW SPORTS LIGHTING POLE. CONNECT TO EXISTING LIGHTING CIRCUIT FROM EXISTING POLE LOCATION AS SHOWN. REMOVE EXISTING TWO POLE, 80AMP BREAKER FEEDING THIS POLE AND REPLACE WITH NEW TWO POLE, 40AMP BREAKER. EXTEND CONDUIT AND WIRING AS NECESSARY.
- NEW SPORTS LIGHTING POLE. CONNECT TO EXISTING LIGHTING CIRCUIT FROM EXISTING POLE LOCATION AS SHOWN. REMOVE EXISTING TWO POLE, 60AMP BREAKER FEEDING THIS POLE AND REPLACE WITH NEW TWO POLE, 40AMP BREAKER. EXTEND CONDUIT AND WIRING AS NECESSARY.
- NOT USED.
- NEW SPORTS LIGHTING POLE. CONNECT TO EXISTING LIGHTING CIRCUIT FROM EXISTING POLE LOCATION AS SHOWN. REMOVE EXISTING TWO POLE, 90AMP BREAKER FEEDING THIS POLE AND REPLACE WITH NEW TWO POLE, 40AMP BREAKER. EXTEND CONDUIT AND WIRING AS NECESSARY.
- NEW SPORTS LIGHTING POLE. CONNECT TO EXISTING LIGHTING CIRCUIT FROM EXISTING POLE LOCATION AS SHOWN. REMOVE EXISTING TWO POLE, 90AMP BREAKER FEEDING THIS POLE AND REPLACE WITH NEW TWO POLE, 50AMP BREAKER. EXTEND CONDUIT AND WIRING AS NECESSARY.
- NEW SPORTS LIGHTING POLE TO BE INSTALLED AT EXISTING POLE LOCATION. CONNECT TO EXISTING LIGHTING CIRCUIT FROM EXISTING POLE LOCATION AS SHOWN FOR LIGHTS ON PLAN EAST SIDE OF POLE. REMOVE EXISTING TWO POLE, 30AMP BREAKER FEEDING THIS POLE AND REPLACE WITH NEW TWO POLE, 20AMP BREAKER TO FEED LIGHTS ON PLAN EAST SIDE OF POLE. EXTEND CONDUIT AND WIRING AS NECESSARY. PROVIDE POWER TO LIGHTS ON PLAN WEST SIDE OF POLE FROM CIRCUIT SHOWN.
- NEW SPORTS LIGHTING POLE. CONNECT TO EXISTING LIGHTING CIRCUIT FROM EXISTING POLE LOCATION AS SHOWN. REMOVE EXISTING TWO POLE, 30AMP BREAKER FEEDING THIS POLE AND REPLACE WITH NEW TWO POLE, 20AMP BREAKER. EXTEND CONDUIT AND WIRING AS NECESSARY.
- NEW SPORTS LIGHTING POLE. CONNECT TO EXISTING LIGHTING CIRCUIT FROM EXISTING POLE LOCATION AS SHOWN. REMOVE EXISTING TWO POLE, 40AMP BREAKER FEEDING THIS POLE AND REPLACE WITH NEW TWO POLE, 20AMP BREAKER. EXTEND CONDUIT AND WIRING AS NECESSARY.
- NEW SPORTS LIGHTING POLE TO BE INSTALLED AT EXISTING POLE LOCATION. BOTH EXISTING 30AMP CIRCUITS AT THIS LOCATION TO BE EXTENDED TO POLE LOCATIONS SHOWN. PROVIDE POWER TO LIGHTS FROM CIRCUIT SHOWN.
- NEW SPORTS LIGHTING POLE. CONNECT TO EXISTING LIGHTING CIRCUIT FROM EXISTING POLE LOCATION AS SHOWN FOR LIGHTS ON PLAN WEST SIDE OF POLE. REMOVE EXISTING TWO POLE, 30AMP BREAKER FEEDING THIS POLE AND REPLACE WITH NEW TWO POLE, 20AMP BREAKER TO FEED LIGHTS ON PLAN WEST SIDE OF POLE. EXTEND CONDUIT AND WIRING AS NECESSARY. PROVIDE POWER TO LIGHTS ON PLAN EAST SIDE OF POLE FROM CIRCUIT SHOWN.
- INSTALL NEW MUSCO CONTROL CABINET IN SPACE MADE AVAILABLE WITH THE REMOVAL OF THE EXISTING MUSCO CONTROL CABINET. PROVIDE TWO SINGLE POLE, 20AMP BREAKERS WITH #12 WIRE FROM ADJACENT EXISTING PANEL FEEDING NEW SPORTS LIGHTING.



1 ELECTRICAL SITE PLAN
 1"=60'-0"

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ELECTRICAL POWER SYMBOLS	
	DUPLEX RECEPTACLE - 18" A.F.F. OR AS NOTED
	MULTI-POLE RECEPTACLE - 18" A.F.F. OR AS NOTED
	MULTI-POLE RECEPTACLE - 208V 10 3/16 ISOLATED GROUND HUBBELL TWIST-LOCK #G2620 RECEPTACLE OR EQUAL - 18" A.F.F. OR AS NOTED
	EXISTING RECEPTACLE
	DUPLEX RECEPTACLE WITH ISOLATED GROUND RECEPTACLE - 18" A.F.F. OR AS NOTED
	QUAD RECEPTACLE - 18" A.F.F. OR AS NOTED
	QUAD RECEPTACLE WITH ISOLATED GROUND - 18" A.F.F. OR AS NOTED
	GFI DUPLEX RECEPTACLE - 6" ABOVE MILLWORK BACKPLASH IF SHOWN ON MILLWORK OR 18" A.F.F. - VERIFY MILLWORK LOCATION WITH ARCHITECT.
	DUPLEX FLOOR RECEPTACLE WITH BRASS COVER PLATE - 3/4" C. TO ACCESSIBLE ATTIC SPACE OR AS NOTED
	WIREMOLD RECEPTACLE WITH ISOLATED GROUND - 18" A.F.F. OR AS NOTED
	WIREMOLD RECEPTACLE WITH ISOLATED GROUND - 18" A.F.F. OR AS NOTED
	WIREMOLD RECEPTACLE WITH ISOLATED GROUND - 18" A.F.F. OR AS NOTED
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	WIREMOLD RECEPTACLE WITH ISOLATED GROUND - 18" A.F.F. OR AS NOTED
	WIREMOLD RECEPTACLE WITH ISOLATED GROUND - 18" A.F.F. OR AS NOTED
	4-GANG BACK BOX WITH DIVIDERS FOR POWER AND COMMUNICATIONS INCLUDE DEVICES AND COVERS-WIREMOLD WSA SERIES
	6-GANG BACK BOX WITH DIVIDERS FOR POWER AND COMMUNICATIONS INCLUDE DEVICES AND COVERS-WIREMOLD WSA SERIES
	POWER/COMMUNICATION POLE - FURNISH REQUIRED LENGTH TO PENETRATE CEILING
	SURFACE MOUNTED RACEWAY
	MECHANICALLY HELD CONTACTOR - ABOVE CEILING
	WATER SOLENOID ACTUATOR - ABOVE CEILING - VERIFY & COORDINATE WITH PLUMBING DRAWINGS
	GAS SOLENOID ACTUATOR - ON ROOF - VERIFY & COORDINATE WITH PLUMBING DRAWINGS
	PUSH BUTTON EMERGENCY SHUT-OFF - REFER TO SPECIFICATIONS FOR MORE INFORMATION
	THERMOSTAT, CO2 SENSOR, HUMIDITY SENSOR - SEE SENSOR MOUNTING DETAIL FOR MOUNTING HEIGHT AND ADDITIONAL REQUIREMENTS
	JUNCTION BOX - 18" A.F.F. - 34" C. TO CORRIDOR ATTIC SPACE OR AS NOTED
	PLUMBING SENSORS - POWER - CONNECT TO MECHANICAL PLUMBING TRANSFORMER(S)
	AUDIOSIGNAL POWER OUTLET - CEILING OR WALL MOUNTED, SEE COMMUNICATIONS DETAILS
	CLOCK RECEPTACLE - 1'-0" BELOW CEILING OR 8'-0" A.F.F.
	PUMP MOTOR - PROVIDED BY MECHANICAL OR AS NOTED WITH MOTOR SWITCH WITH OVERLOAD S.O.D. CLASS 2510 IN NEMA ENCLOSURE (TYPE K) OR AS NOTED
	SUPPLY FAN - PROVIDED BY MECHANICAL OR AS NOTED WITH MOTOR SWITCH WITH OVERLOAD S.O.D. CLASS 2510 IN NEMA ENCLOSURE (TYPE K) OR AS NOTED
	EXHAUST FAN - PROVIDED BY MECHANICAL OR AS NOTED WITH MOTOR SWITCH WITH OVERLOAD S.O.D. CLASS 2510 IN NEMA ENCLOSURE (TYPE K) OR AS NOTED
	MOTOR WITH MOTOR SWITCH WITH OVERLOAD S.O.D. CLASS 2510 IN NEMA ENCLOSURE (TYPE K) OR AS NOTED-FINAL CONNECTION BY ELECTRICAL
	SAFETY SWITCH - MOUNT 30" ABOVE FINISH GRADE MAX. OR AS DIRECTED
	SURFACE MOUNT EQUIPMENT PANEL, RACK, CABINET, AMPLIFIER, ETC. AS NOTED.
	FLUSH MOUNT EQUIPMENT PANEL, RACK, CABINET, AMPLIFIER, ETC. AS NOTED.
	WATER HEATER - REFER TO PLUMBING FOR MORE INFORMATION
	WEATHERHEAD
	IN-GRADE PULL BOX/HAND HOLE - PROVIDE AS REQUIRED
	FIRE SAFETY CONTROL DEVICE - FIRE ALARM TO SMOKE/FIRE BARRIER DOOR ELECTROMAGNETIC HOLDER/RELEASE INTERFACE
	FIRE SAFETY CONTROL DEVICES - CONTROL RELAY AND DUCT MOUNTED SMOKE DETECTOR WITH CONTROL RELAY
	FIRE SAFETY CONTROL DEVICE - MOTORIZED SMOKE/FIRE DAMPER - POWER CONNECTION BY DIVISION 16
	BUZZER - EDWARDS #156G-6G1 80" A.F.F.
	PUSH BUTTON - EDWARDS #895-W 4" A.F.F. SIGNAL TRANSFORMER - EDWARDS #591 IN J-BOX ABOVE CEILING
	PANELBOARD OR SWITCHBOARD - REFER TO SCHEDULE & RISER
	POWER TRANSFORMER - DESCRIBED IN SCHEDULE, RISER AND/OR SPECIFICATIONS
	GROUND
	HOME RUN WITH CIRCUIT DESIGNATION(S) - LETTER DENOTES PANEL
	SWITCH CIRCUIT
	BRANCH CIRCUIT
	UNDERGROUND POWER CIRCUIT


- NOTES:
 1. SOME SYMBOLS MAY NOT BE USED.
 2. ACCESSIBLE DEVICES HIGHEST OPERABLE PART TO BE 46" MAXIMUM/18" MINIMUM A.F.F. - REFER TO ARCHITECTURAL DRAWINGS.
 3. DIMENSIONS GIVEN A.F.F. ARE TO BOTTOM OF BOX.

ELECTRICAL EXISTING POWER SYMBOLS	
	JUNCTION BOX - 18" A.F.F. - 34" C. TO CORRIDOR ATTIC SPACE OR AS NOTED
	SAFETY SWITCH - MOUNT 30" ABOVE FINISH GRADE MAX. OR AS DIRECTED
	PANELBOARD OR SWITCHBOARD - REFER TO SCHEDULE & RISER
	POWER TRANSFORMER - DESCRIBED IN SCHEDULE, RISER AND/OR SPECIFICATIONS


- NOTES:
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 2. DIMENSIONS GIVEN A.F.F. ARE TO BOTTOM OF BOX.

LIGHTING SYMBOLS	
	SWITCH LOCATION - STANDARD / PROGRAMMABLE, 3-WAY, 4-WAY - MOUNTED AT 44" A.F.F. UNLESS NOTED
	KEYED SWITCH LOCATION - (SAME AS ABOVE) - KEY OPERATED, PROVIDE 12 EXTRA KEYS FOR OWNER
	MOTION SENSOR - SEE SPECS FOR LOCATION, QUANTITY, COMMISSIONING, ETC.
	PHOTOCELL - SEE SPECS FOR LOCATION, QUANTITY, COMMISSIONING, ETC.
	LUMINAIRE - RECESSED / SURFACE / PENDANT - SEE LUMINAIRE SCHEDULE & SPECS - LETTER INDICATES TYPE
	EMERGENCY LUMINAIRE - (SAME AS ABOVE) - SWITCHED, WITH BATTERY, GENERATOR OR UPS BACKUP - MOUNTED AT 7'-0" A.F.F. UNLESS NOTED
	EMERGENCY LUMINAIRE - (SAME AS ABOVE) - NOT SWITCHED, WITH BATTERY, GENERATOR OR UPS BACKUP
	ILLUMINATED EXIT SIGN - NOT SWITCHED, CONTINUOUSLY LIT, BATTERY OPERATED
	EXTERIOR LUMINAIRE - SEE LUMINAIRE SCHEDULE FOR MORE INFORMATION
	HOME RUN WITH CIRCUIT DESIGNATION(S) - LETTER DENOTES PANEL AND CIRCUIT
	SWITCH CIRCUIT, TYPICAL CONTROL PER SPACE
	BRANCH CIRCUIT, INDICATES LUMINAIRE ON A CIRCUIT, NOT INTENDED TO SHOW ROUTING
	UNDERGROUND BRANCH CIRCUIT - APPROXIMATE ROUTE SHOWN
	DAYLIGHTING ZONE - REFER TO LIGHTING CONTROL CHART FOR MORE INFORMATION


- NOTES:
 1. SOME SYMBOLS MAY NOT BE USED.
 2. ACCESSIBLE DEVICES HIGHEST OPERABLE PART TO BE 46" MAXIMUM/18" MINIMUM A.F.F. - REFER TO ARCHITECTURAL DRAWINGS.
 3. DIMENSIONS GIVEN A.F.F. ARE TO BOTTOM OF BOX.
 4. SEE LIGHTING CONTROL CHART FOR SWITCH, MOTION SENSOR AND PHOTOCELL INFORMATION AND CONTROL.

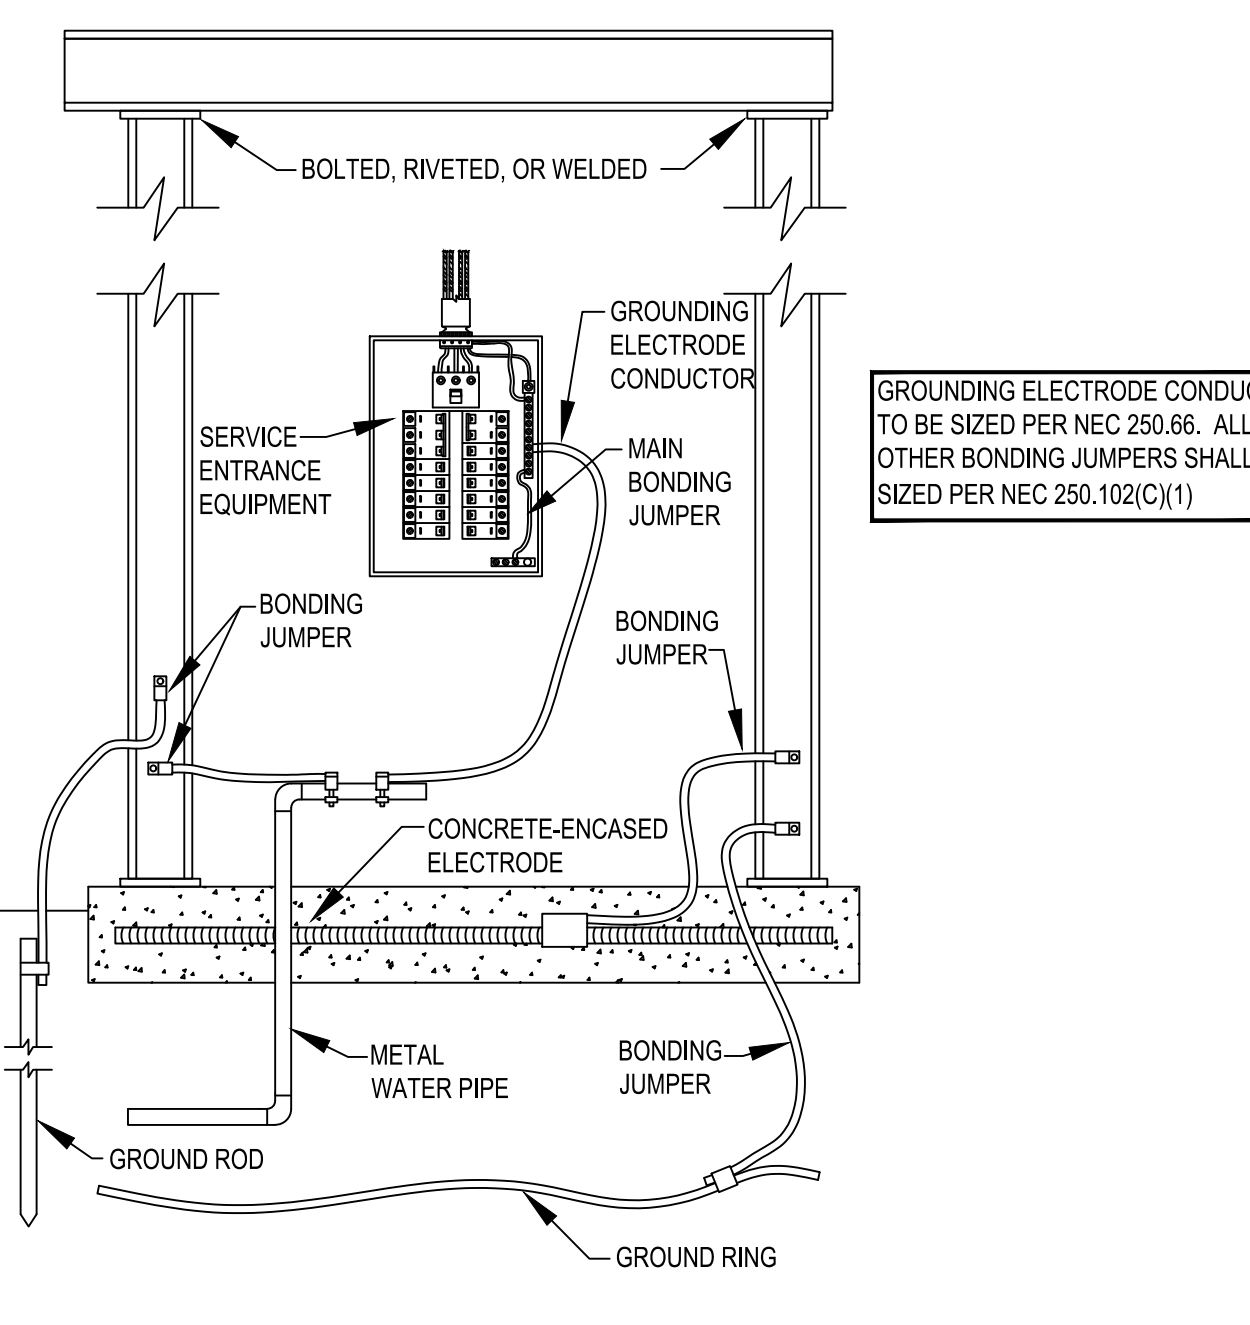


1 GROUNDING ELECTRODE SYSTEM
N.T.S.

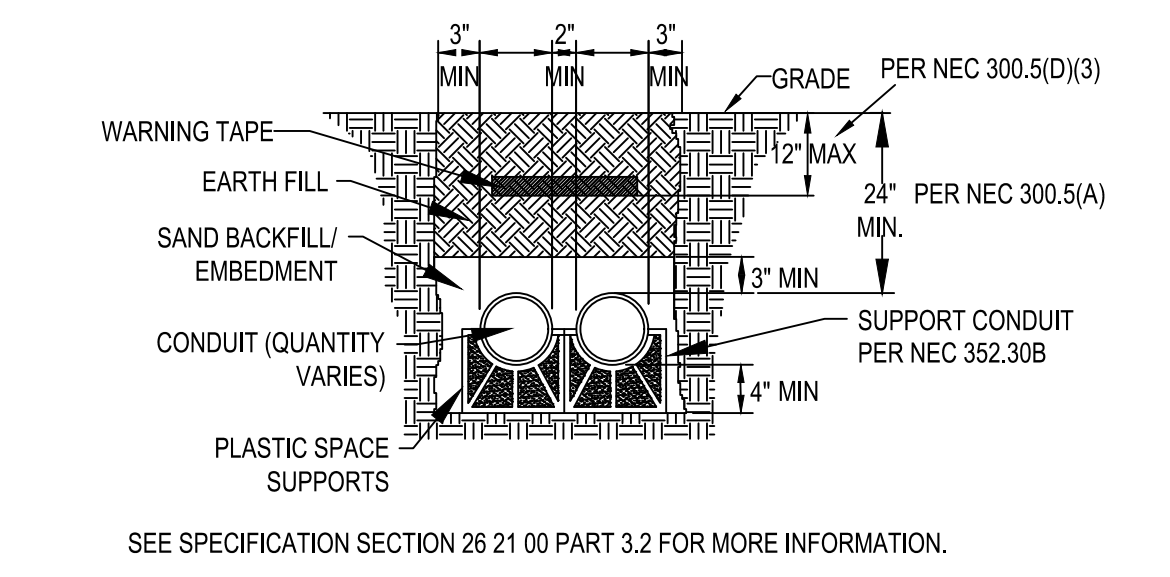


2 UNDERGROUND FEEDER CONDUITS
N.T.S.

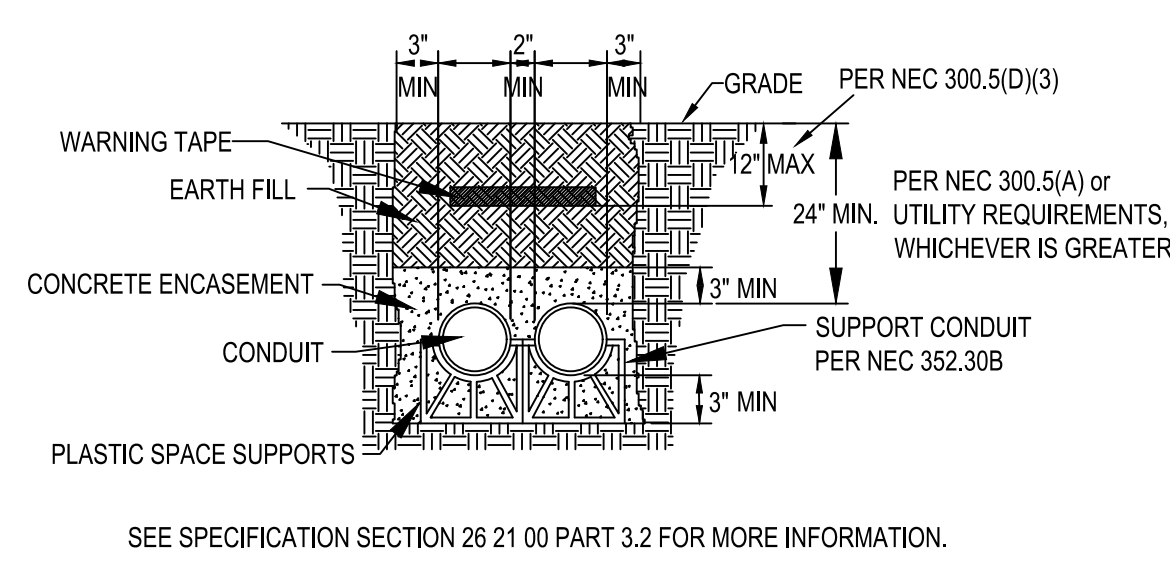


3 UNDERGROUND PRIMARY & SECONDARY CONDUITS
N.T.S.

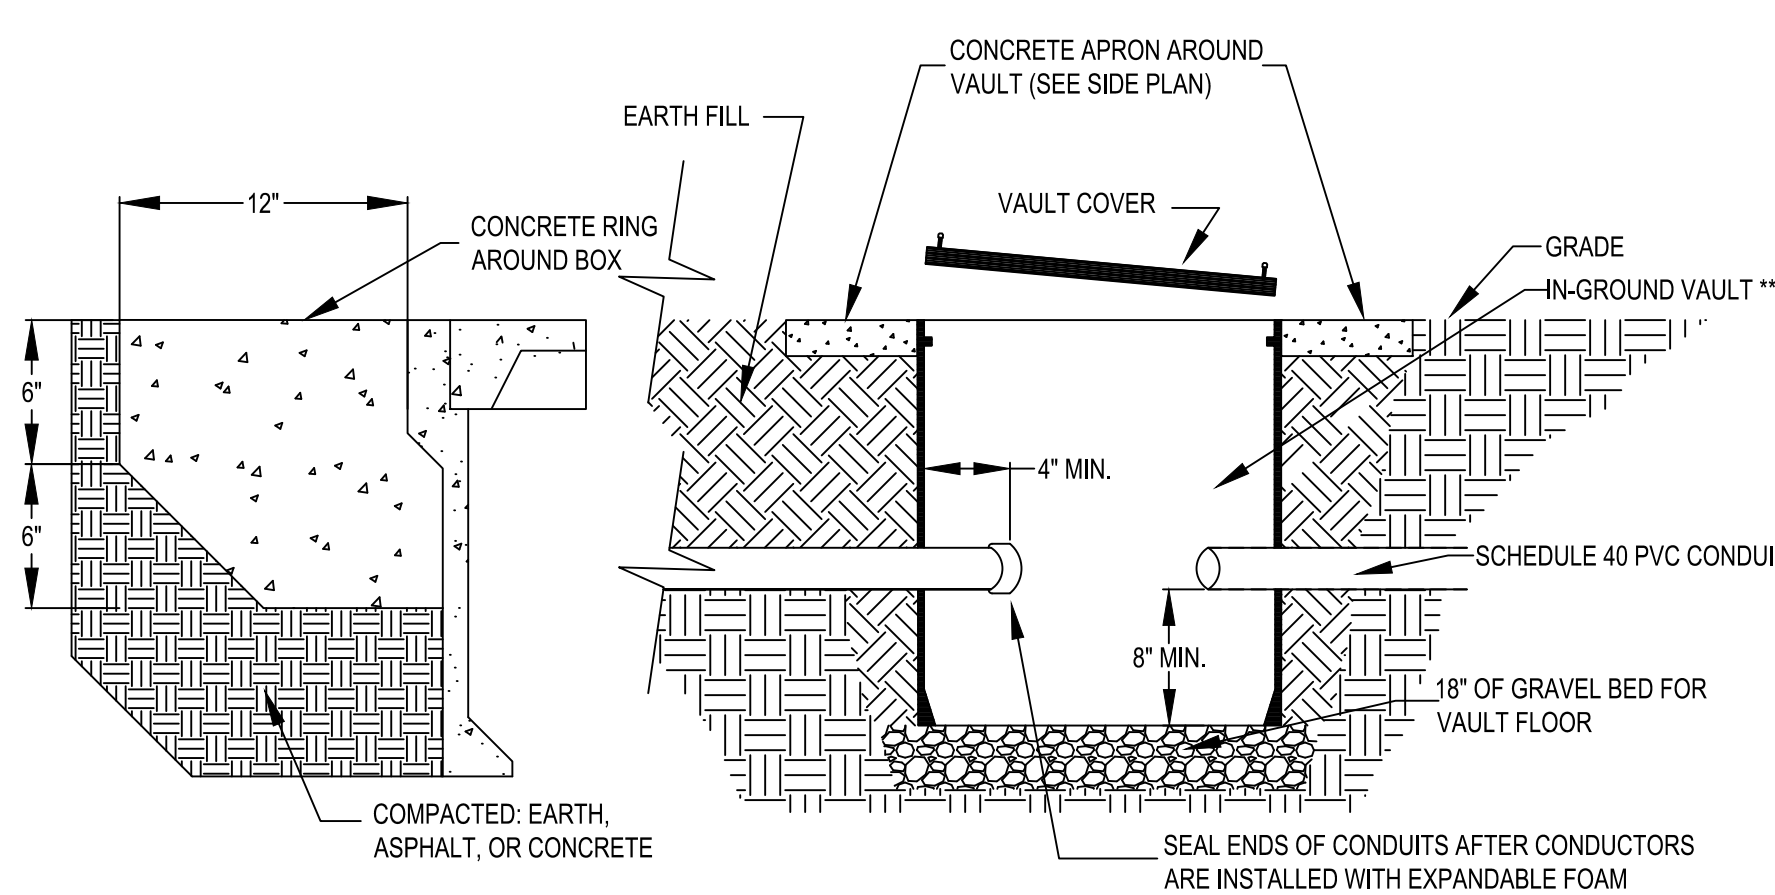


4 PULL BOX DETAIL
N.T.S.

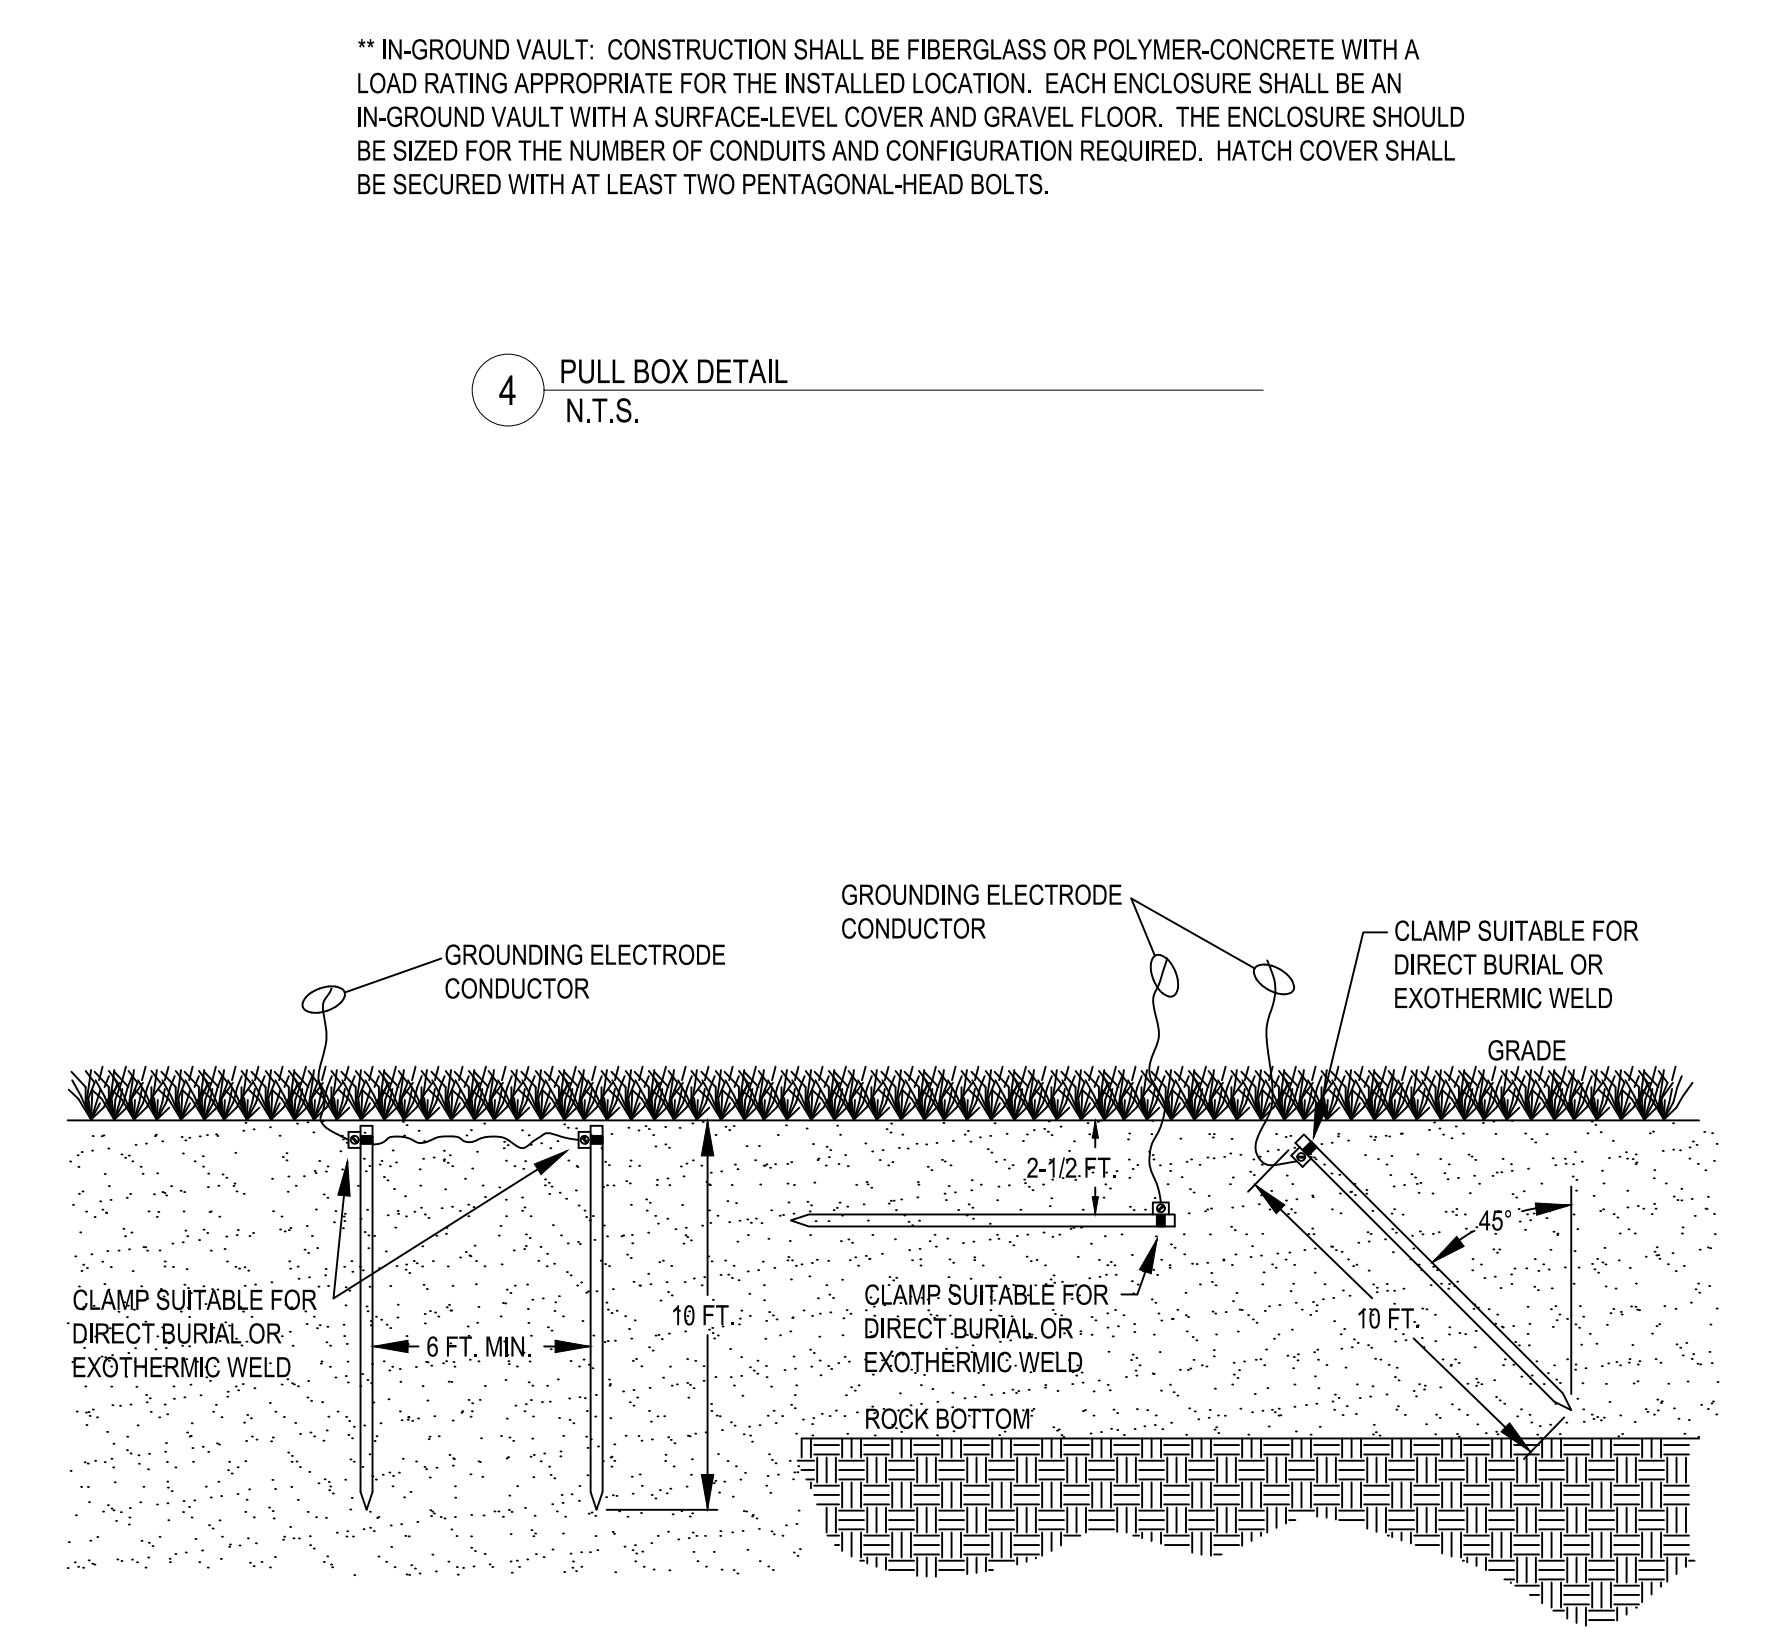

5 NEC GROUNDING ROD DETAILS
N.T.S.

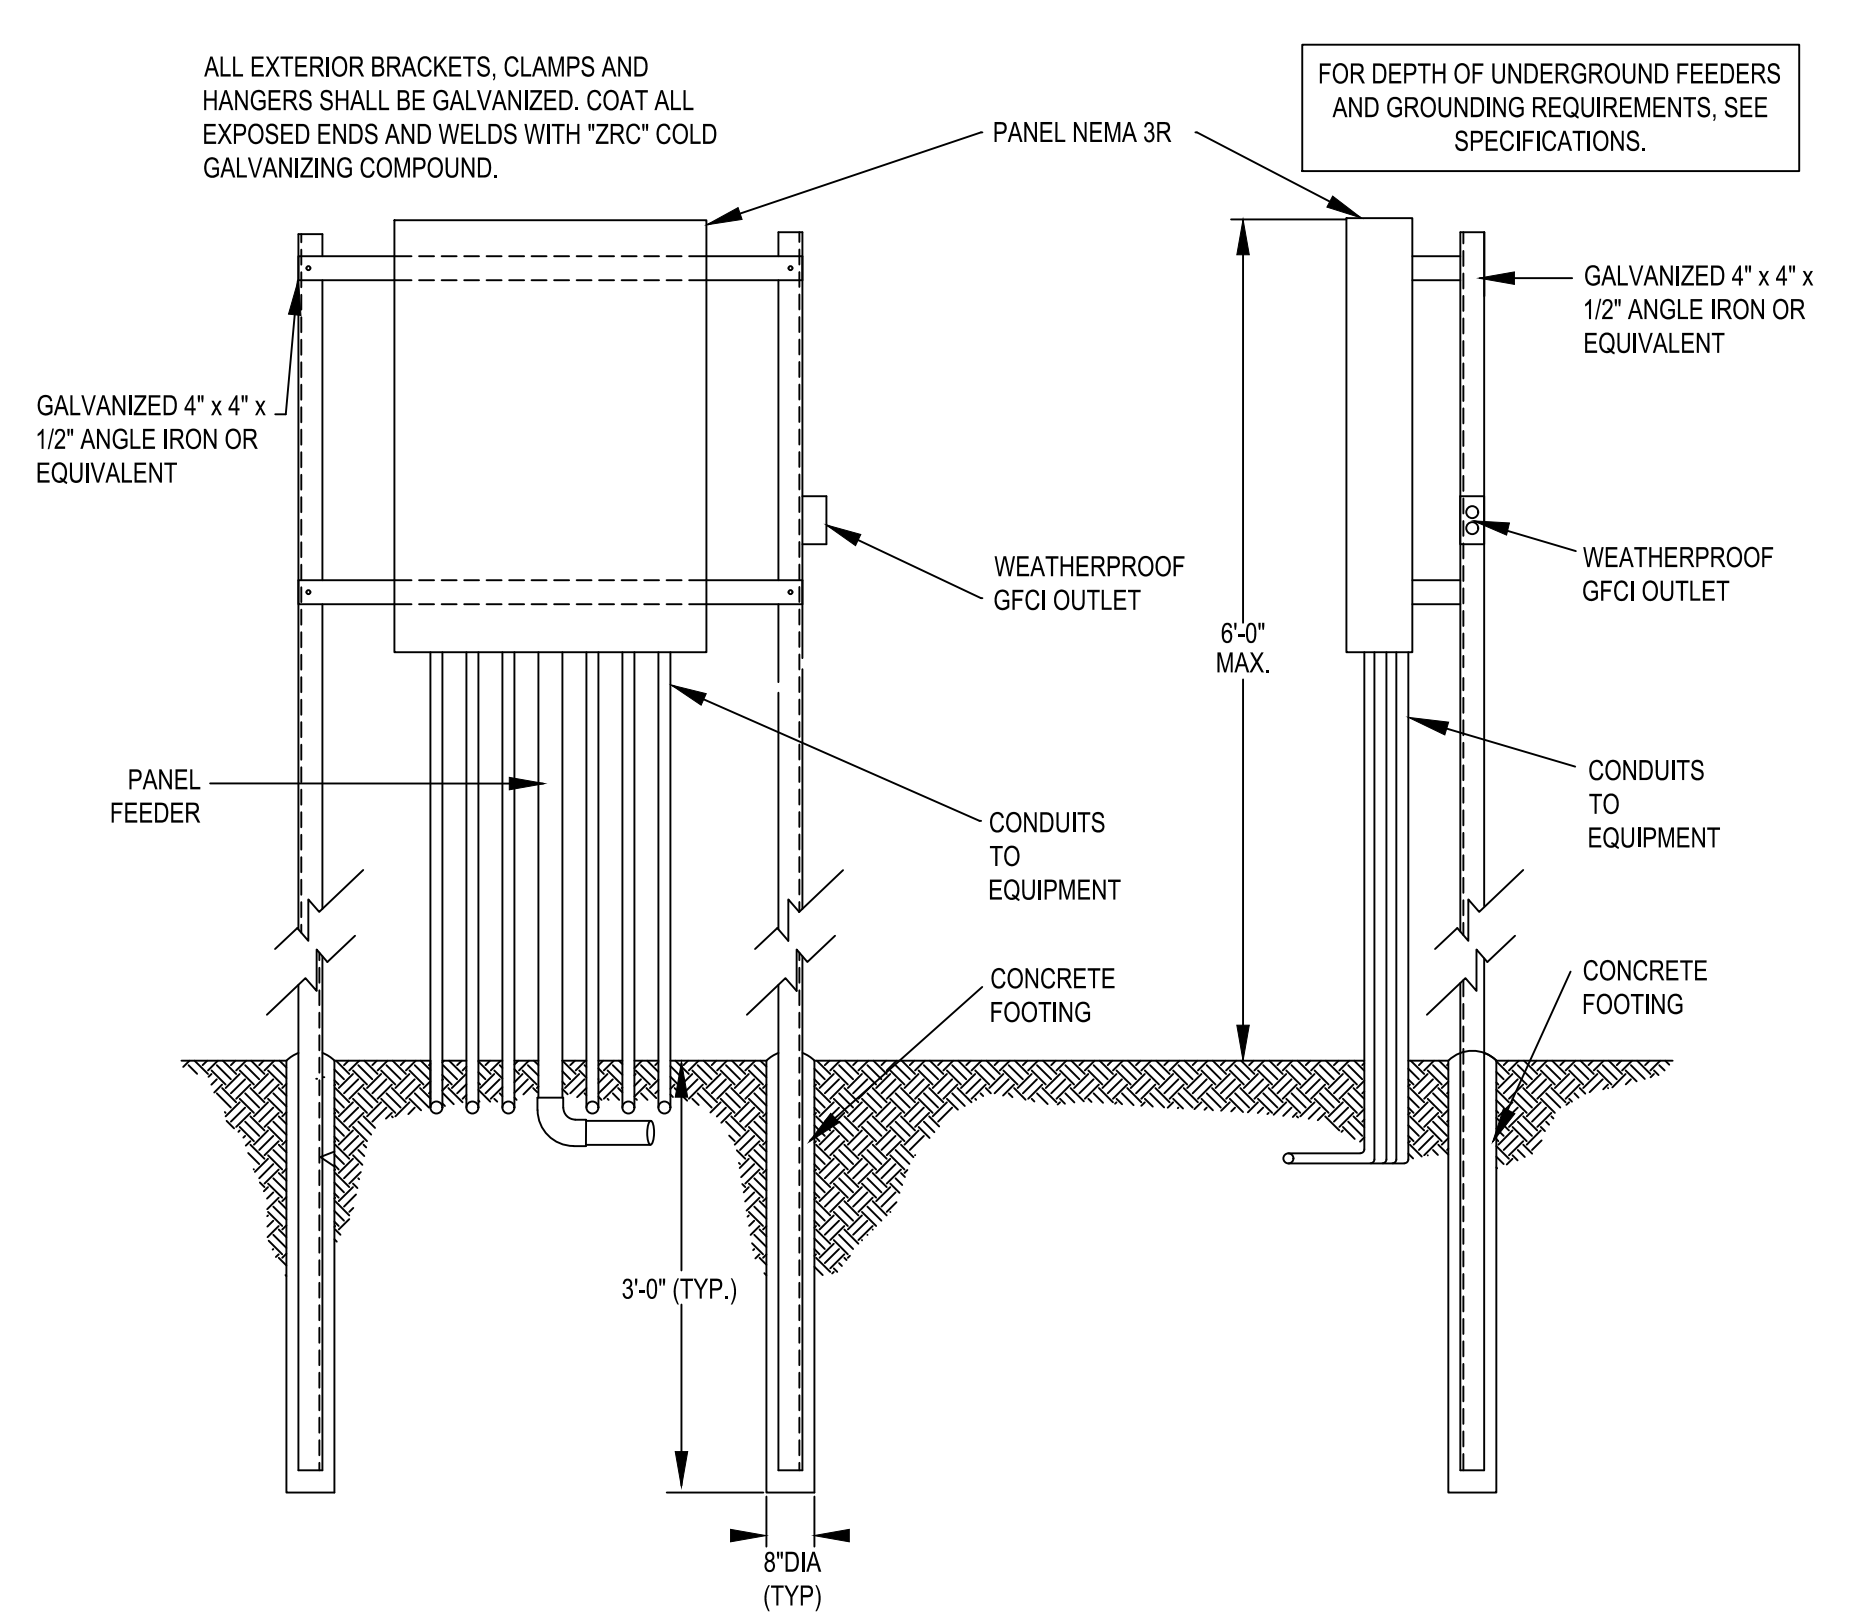

6 SUPPORT FOR PANEL MOUNTED ON GROUND
N.T.S.

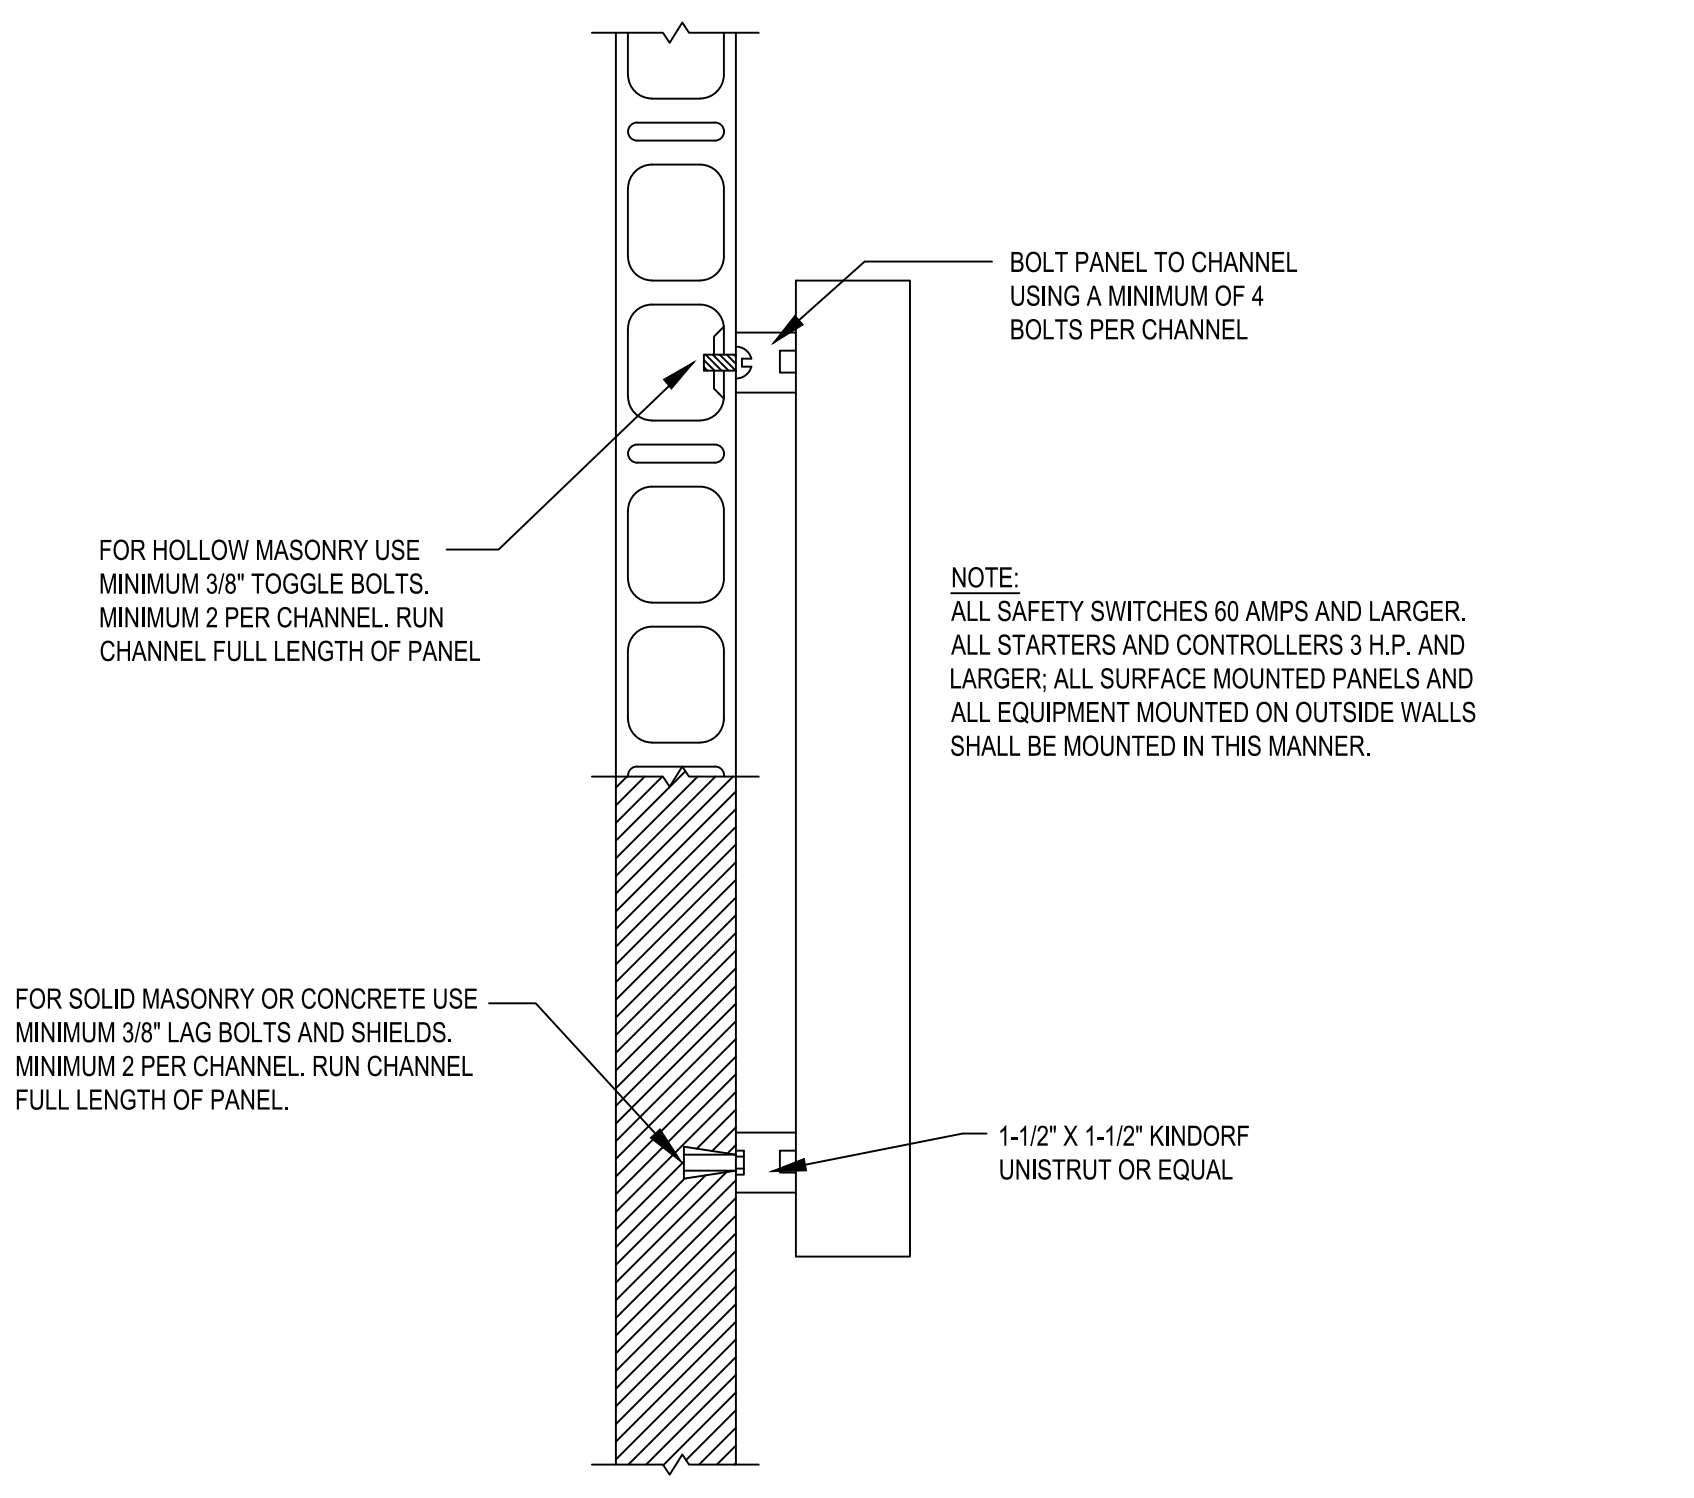

7 SURFACE EQUIPMENT MOUNTING DETAIL
N.T.S.

JASON W. REED
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Sep 01, 2020

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Sep 01, 2020

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 www.estesmcclure.com

ISSUE DATE
August 24, 2020


REVISION DATE

RENOVATIONS TO
SPORTS & RECREATION PARK ATHLETIC FIELDS LIGHTING
 CITY OF DRIPPING SPRINGS
 DRIPPING SPRINGS, TX


EMA JOB #: 2 001 1668 001
 DRAWN BY: **clh**
 CHECKED: **qc**

**ELECTRICAL
 DETAILS & SYMBOLS**

SHEET NUMBER
EL701

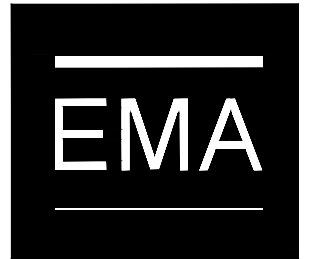

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ISSUE DATE
August 24, 2020

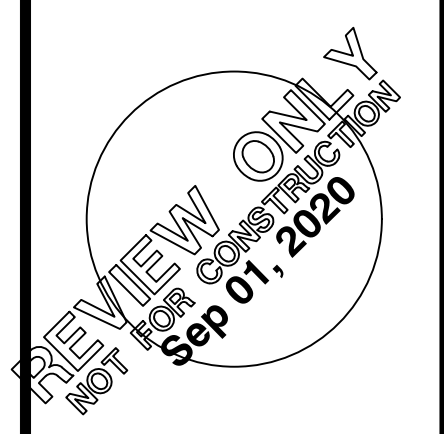REVISION DATE

PANEL - SC		Rating - 225A WITH 225MCB				Located UTILITY ENCLOSURE Surface Mount - Outside (NEMA 3R) AIC - 65,000 Amps			
Fed from - UTILITY (240V 1PH)									
Service - 120/240 1PH 3Wire									
**PROVIDE NEMA 3R ENCLOSURE									
EQUIPMENT SERVED	POLE	TRIP	WIRE	Ø LOAD in VA	Ø LOAD in VA	WIRE	TRIP	POLE	EQUIPMENT SERVED
SPORTS LIGHTING POLE S1	2	40	2	1 A= 7104	2	4	40	2	SPORTS LIGHTING POLE S3
TO MUSCO DISCONNECT ON POLE 10' A.F.G.				3 C= 7104	4				TO MUSCO DISCONNECT ON POLE 10' A.F.G.
SPORTS LIGHTING POLE S2	2	40	4	5 A= 7104	6	6	40	2	SPORTS LIGHTING POLE A7
TO MUSCO DISCONNECT ON POLE 10' A.F.G.				7 C= 7104	8				TO MUSCO DISCONNECT ON POLE 10' A.F.G.
MUSCO CONTROL CABINET	1	20	12	9 A= 2412	10	10	30	2	EXISTING PUMP
MUSCO CONTROL CABINET	1	20	12	11 C= 2412	12				
SPACE	1	-	-	13 A= 1200	14	12	20	1	EXISTING TIMER
SPACE	1	-	-	15 C= 0	16	-	-	-	SPACE
SPACE	1	-	-	17 A= 0	18	-	-	-	SPACE
SPACE	1	-	-	19 C= 0	20	-	-	-	SPACE
SPACE	1	-	-	21 A= 0	22	-	-	-	SPACE
SPACE	1	-	-	23 C= 0	24	-	-	-	SPACE

COMMENTS - * REFER TO RISER DIAGRAM FOR WIRE SIZE

PANEL - SC2		Rating - 400A WITH 400MCB				Located EXISTING POLE Surface Mount - Outside (NEMA 3R) AIC - 65,000 Amps			
Fed from - UTILITY (240V 1PH)									
Service - 120/240 1PH 3Wire									
**PROVIDE NEMA 3R ENCLOSURE									
EQUIPMENT SERVED	POLE	TRIP	WIRE	Ø LOAD in VA	Ø LOAD in VA	WIRE	TRIP	POLE	EQUIPMENT SERVED
POLE S13	2	20	-	1 A= 2904	2	-	20	2	POLE S18
TO MUSCO DISCONNECT ON POLE 10' A.F.G.				3 C= 2904	4				TO MUSCO DISCONNECT ON POLE 10' A.F.G.
POLE S14	2	20	-	5 A= 2904	6	-	20	2	POLE S19
TO MUSCO DISCONNECT ON POLE 10' A.F.G.				7 C= 2904	8				TO MUSCO DISCONNECT ON POLE 10' A.F.G.
POLE S16	2	20	-	9 A= 2904	10	-	20	2	POLE S20
TO MUSCO DISCONNECT ON POLE 10' A.F.G.				11 C= 2904	12				TO MUSCO DISCONNECT ON POLE 10' A.F.G.
POLE S17	2	20	-	13 A= 2904	14	-	20	2	POLE S21
TO MUSCO DISCONNECT ON POLE 10' A.F.G.				15 C= 2904	16				TO MUSCO DISCONNECT ON POLE 10' A.F.G.
POLE S11	2	60	2	17 A= 8280	18	6	40	2	POLE S13
TO MUSCO DISCONNECT ON POLE 10' A.F.G.				19 C= 8280	20				TO MUSCO DISCONNECT ON POLE 10' A.F.G.
POLE S12	2	40	6	21 A= 8280	22	2	60	2	POLE S15
TO MUSCO DISCONNECT ON POLE 10' A.F.G.				23 C= 8280	24				TO MUSCO DISCONNECT ON POLE 10' A.F.G.
MUSCO CONTROL CABINET	1	20	12	25 A= 24	26	12	20	1	MUSCO CONTROL CABINET
SPACE	1	-	-	27 C= 0	28	-	-	-	SPACE
SPACE	1	-	-	29 A= 0	30	-	-	-	SPACE
SPACE	1	-	-	31 C= 0	32	-	-	-	SPACE

COMMENTS - * REFER TO RISER DIAGRAM FOR WIRE SIZE

CIRCUIT BREAKER LOCATIONS IN PANELBOARD "SC2" ARE FOR DETERMINING FULL LOAD AMPACITY FOR PANELBOARD AND ELECTRICAL SERVICE. CONTRACTOR TO INSTALL BREAKERS AS NECESSARY IN ORDER TO UTILIZE EXISTING BRANCH CIRCUITS BEING REUSED TO FEED NEW LIGHTS.

GENERAL RISER NOTES:


- WHEREVER THE LENGTH OF THE SECONDARY CONDUCTORS OF ANY TRANSFORMER EXCEEDS TEN FEET, AN ENCLOSED CIRCUIT BREAKER OR FUSED DISCONNECT IS REQUIRED TO BE PROVIDED WITHIN TEN FEET OF THE TRANSFORMER SECONDARY TERMINALS IN ACCORDANCE WITH NEC ARTICLE 240.21(C)(2). THIS OVERCURRENT DEVICE SHALL HAVE AN AMP RATING EQUAL TO THE AMP RATING OF THE PANEL BEING SERVED. IF THIS OCCURS AND THE PANEL IS IN THE SAME ROOM, THE PANEL BEING FED MAY BE CHANGED TO MAIN LUG ONLY.
- SERVICE ENTRANCE FEEDERS DO NOT REQUIRE AN EQUIPMENT GROUNDING CONDUCTOR. HOWEVER, ALL FEEDERS AFTER THE MAIN SERVICE DISCONNECT(S) DO REQUIRE A GROUNDING CONDUCTOR. PER NEC 250.24, THE GROUNDING ELECTRODE CONDUCTOR SHALL BE INSTALLED AT THE MAIN SERVICE DISCONNECT. ADDITIONALLY, WHETHER LOCATED INSIDE OR OUTSIDE, ALL MAIN SERVICE DISCONNECTS AND BRANCH CIRCUIT DISCONNECTS 100A OR MORE SHALL HAVE GFCI GROUND FAULT PROTECTION PER NEC 230.95 AND 210.13 RESPECTIVELY.
- PROVIDE AND INSTALL BURNDY OR NIB (OR APPROVED EQUIVALENT) UL RATED COMPRESSION REDUCING PIN TERMINALS ON COPPER / ALUMINUM CONDUCTORS AS REQUIRED. SEE IMAGE TO THE RIGHT.
- UTILITY WORK SHOWN HERE IS PROPOSED AND MAY NOT INCLUDE ALL UTILITY COMPANY REQUIREMENTS. COORDINATE FINAL UTILITY LOCATION, EASEMENT REQUIREMENTS, TRANSFORMER SIZE AND LOCATION, TRANSFORMER PAD SIZE, MEANS OF DISCONNECT REQUIREMENTS, ETC. WITH UTILITY COMPANY BEFORE BIDDING.
- COORDINATE THE EXACT LOCATION OF ALL OUTSIDE SWITCHGEAR, MAIN DISCONNECTS, METERS, ETC. WITH OWNER AND ARCHITECT BEFORE INSTALLATION. NEVER PLACE THESE ITEMS NEAR A FRONT ENTRANCE.
- PER NEC 230.95, PROVIDE GFCI PROTECTION PER SPECS AT ALL SERVICE DISCONNECTS RATED 100A OR MORE.
- PER NEC 110.34(A), AT ALL SERVICE ENTRANCE EQUIPMENT PROVIDE A LABEL (PER SPECS) INDICATING CALCULATED FAULT CURRENT AND DATE OF CALCULATIONS. THE DATE OF CALCULATIONS SHALL BE THE DATE ON THE SEAL IN THE BORDER. LABEL SHALL BE PERMANENT, DURABLE, 2" X 4" WITH BLUE LETTERING AND A WHITE BACKGROUND. MECHANICALLY FASTENED TO EQUIPMENT AND CAPABLE OF WITHSTANDING THE ENVIRONMENT INVOLVED.



SAMPLE REDUCING PIN TERMINAL

ELECTRICAL RISER NOTES: (SOME NOTES MAY NOT BE USED)

- 225 3-#4/0, 1-#4 GRN, 2 1/2" C.
- 400 2-2" C. WITH 3-#3/0, 1-#3 GRN IN EACH

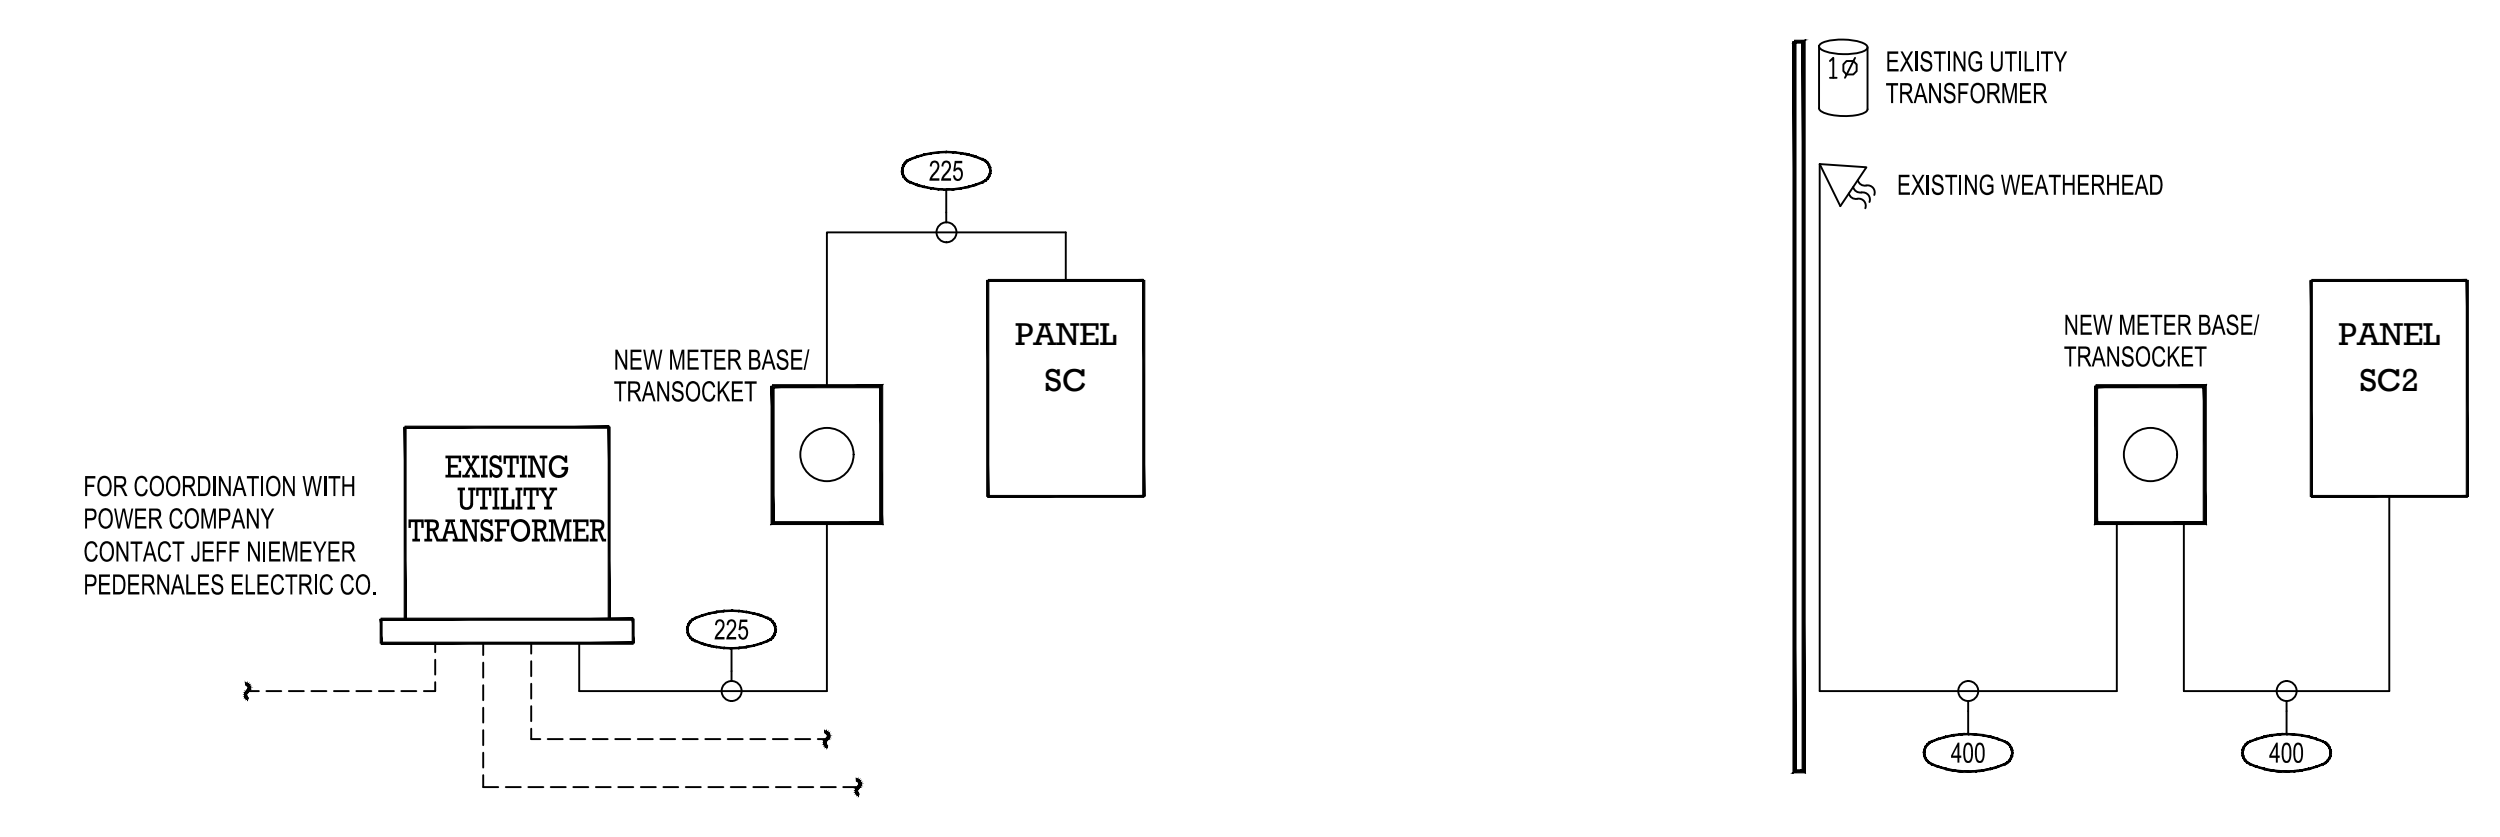

1 ELECTRICAL RISER DIAGRAM
 1"=60'-0"

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 Sep 01, 2020

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RENOVATIONS TO
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EMA JOB #: 2 001 1683 001
 DRAWN BY: CJH
 CHECKED: QC

ELECTRICAL
 PANELBOARD SCHEDULES
 & RISER DIAGRAM

SHEET NUMBER
EL801