



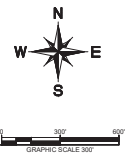

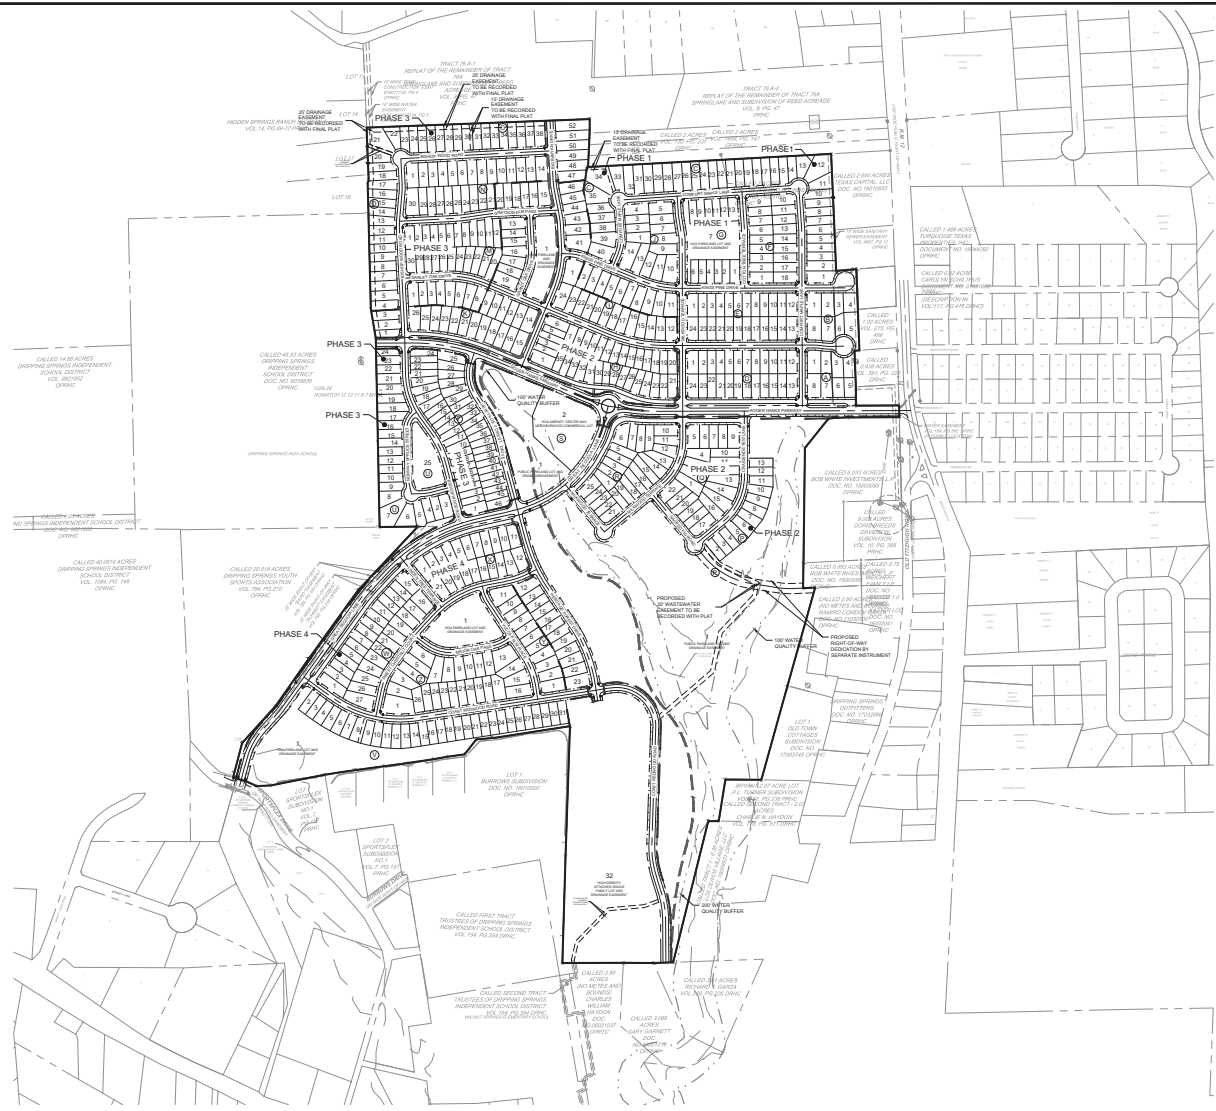


Prepared by: City of Dripping Springs, Texas  
 Date: August 2020  
 Project: Heritage Subdivision, PDD No. 5  
 Scale: As Shown  
 Drawn by: RRL  
 Checked by: AEO  
 Project No.: 19-0000  
 Date: August 2020  
 Scale: As Shown  
 Drawn by: RRL  
 Checked by: AEO



**GENERAL NOTES:**

- THIS DEVELOPMENT IS SUBJECT TO THE ANNEXATION AND DEVELOPMENT AGREEMENT OF THE PLANNED DEVELOPMENT DISTRICT NO. 5: HERITAGE SUBDIVISION, APPROVED BY CITY COUNCIL OCTOBER 17, 2017.
- THIS DEVELOPMENT IS LOCATED WITHIN THE CITY LIMITS OF THE CITY OF DRIPPING SPRINGS, HAYS COUNTY, TEXAS.
- THE ZONING OF THIS DEVELOPMENT IS GOVERNED BY CITY OF DRIPPING SPRINGS PDD #5.
- THIS DEVELOPMENT IS LOCATED WITHIN THE CONTRIBUTING ZONE OF THE EDWARDS AQUIFER AND IS SUBJECT TO THE RULES AND REGULATIONS OF THE EDWARDS AQUIFER PROTECTION PROGRAM OF THE TEXAS COMMISSION ON ENVIRONMENTAL QUALITY (TCEQ).
- DEVELOPMENT DESIGN STANDARDS PER THE HERITAGE SUBDIVISION DEVELOPMENT AGREEMENT OR THE CITY OF DRIPPING SPRINGS AS APPLICABLE.
- UTILITIES WILL BE PROVIDED BY THE FOLLOWING:  
 WATER - DRIPPING SPRINGS WATER SUPPLY CORPORATION  
 WASTEWATER - CITY OF DRIPPING SPRINGS  
 ELECTRIC - PEDERNALES ELECTRIC COMPANY
- ALL (NEW) TELEPHONE AND CABLE TELEVISION LINES AND ALL ELECTRIC UTILITY LATERAL AND SERVICE LINES AND ALL WIRES SHALL BE PLACED UNDERGROUND, EXCEPT AS OTHERWISE HEREIN PROVIDED.
- ALL ELECTRIC, CABLE TELEVISION, AND TELEPHONE SUPPORT EQUIPMENT (TRANSFORMERS, AMPLIFIERS, SWITCHING DEVICES, ETC.) NECESSARY FOR UNDERGROUND INSTALLATIONS IN SUBDIVISIONS SHALL BE PAD MOUNTED OR PLACED UNDERGROUND IN A PUBLIC UTILITY EASEMENT RATHER THAN A RIGHT-OF-WAY.
- ALL PROPOSED COLLECTOR AND LOCAL STREETS WITHIN THIS SUBDIVISION SHALL HAVE A 4' WIDE CONCRETE SIDEWALK, APPLICABLE 5' CONCRETE SIDEWALK OR 8' TRAIL CONSISTENT WITH THE VARIANCES AND ROADWAY SECTIONS SET FORTH IN PDD NO. 5.
- OWNERSHIP AND MAINTENANCE OF ALL NON-SINGLE FAMILY LOTS (EXCLUDING PUBLIC PARK LANDS) WILL BE THE RESPONSIBILITY OF THE HOME OWNERS ASSOCIATION.
- THE OPERATION AND MAINTENANCE OF ALL DRAINAGE EASEMENT LOTS AND IMPROVEMENTS CONSTRUCTED WITHIN THOSE LOTS SHALL BE THE RESPONSIBILITY OF THE HOME OWNERS ASSOCIATION.
- ALL DRAINAGE EASEMENTS ON PRIVATE PROPERTY SHALL BE MAINTAINED BY THE PROPERTY OWNER OR HIS/HER ASSIGNS.
- THE LIMITS OF THE 100-YR STORM WATER RUNOFF ARE CONTAINED WITHIN DRAINAGE EASEMENTS.
- NO LOT WITHIN THIS SUBDIVISION IS WITHIN A FLOOD HAZARD AREA AS SHOWN ON THE FLOOD INSURANCE RESIDENTIAL MAP NO. 48290C0105F DATED SEPTEMBER 9, 2005.
- THE PROPERTY OWNER SHALL PROVIDE ACCESS TO DRAINAGE AND UTILITY EASEMENTS AS MAY BE NECESSARY AND SHALL NOT PROHIBIT ACCESS FOR INSPECTION, OPERATION AND MAINTENANCE.
- ALL EXISTING BUILDINGS, DRIVEWAYS, ROADS, ETC. WILL BE REMOVED, EXCEPT AS NOTED.
- FINAL DETERMINATION OF NEED FOR EASEMENTS WILL BE DETERMINED WITH FINAL PLAT AND CONSTRUCTION PLANS.
- A 15' PUBLIC UTILITY EASEMENT ADJACENT TO ALL PUBLIC STREETS IS HEREBY DEDICATED.
- THE PROPOSED DEVELOPMENT SHALL DEMONSTRATE COMPLIANCE WITH ALL REQUIREMENTS ESTABLISHED IN THE 2012 INTERNATIONAL FIRE CODE AND LOCAL AMENDMENTS.

Length (FT)	STREET NAME	ROW
650	NORWAY SPRUCE STREET	(52' ROW)
2699	BISHOP WOOD ROAD	(52' ROW)
834	GRAYSON ELM PASS	(52' ROW)
2403	DARLEY OAK DRIVE	(52' ROW)
1481	KINGS PINE DRIVE	(52' ROW)
1324	BIG BANYAN DRIVE	(52' ROW)
2422	COMFORT MAPLE LANE	(52' ROW)
2203	MILKWOOD TERRACE	(52' ROW)
493	COTTON TREE TERRACE	(52' ROW)
1927	HERITAGE FOREST DRIVE	(52' ROW)
2736	RODGER HANES PARKWAY	(56'-96' ROW)
1132	SACRED FIG ROAD	(52' ROW)
2844	GREAT SEQUOIA LANE	(56'-96' ROW)
447	GRANIT OAK DRIVE	(52' ROW)
1197	SWEET CHESTNUT COURT	(52' ROW)
332	LINDEN TREE TERRACE	(52' ROW)
534	MAJOR OAK PASS	(52' ROW)
3198	COAST REDWOOD ROAD	(52' ROW)
653	YUCCA PALM PLACE	(52' ROW)

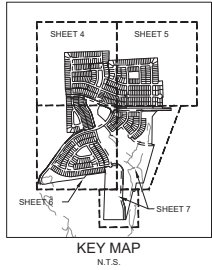

USES	PHASE BREAKDOWN				CUMULATIVE
	PHASE 1	PHASE 2	PHASE 3	PHASE 4	
ACREAGE	37.56	75.6	29.84	47.3	190.3
BLOCKS	9	13	7	6	27
NEW ROADWAY (LF)	9,158	7,143	5077	7861	29,239
RESIDENTIAL LOTS					
35' LOTS	0	6	45	0	51
40' LOTS	12	67	33	0	112
45' LOTS	99	74	60	76	307
50' LOTS	41	12	25	39	117
60' LOTS	8	0	0	0	8
RESIDENTIAL SUBTOTAL	158	159	163	115	595
OPEN SPACE LOTS	1	3	0	0	1
MULTIFAMILY LOTS	0	0	0	1	1
AMENITY CENTER LOT	0	1	0	0	1
TOTAL LOTS	159	163	163	116	601

USES	PHASE BREAKDOWN				CUMULATIVE
	PHASE 1	PHASE 2	PHASE 3	PHASE 4	
ACREAGE	37.56	75.6	29.84	47.3	190.3
BLOCKS	9	13	7	6	27
NEW ROADWAY (LF)	9,158	7,143	5077	7861	29,239
RESIDENTIAL LOTS					
35' LOTS	0	6	45	0	51
40' LOTS	12	67	33	0	112
45' LOTS	99	74	60	76	307
50' LOTS	41	12	25	39	117
60' LOTS	8	0	0	0	8
RESIDENTIAL SUBTOTAL	158	159	163	115	595
OPEN SPACE LOTS	1	3	0	0	1
AMENITY CENTER LOT	0	1	0	0	1
TOTAL LOTS	159	163	163	115	600

LAND USE SUMMARY		
CATEGORY	ACREAGE	LOTS
MEDIUM DENSITY DETACHED	72.68	490
HIGH DENSITY DETACHED	12.49	105
HIGH DENSITY ATTACHED	13.45	1
HOA PARKLAND AND DRAINAGE EASEMENT	9.97	8
HOA AMENITY CENTER AND NEIGHBORHOOD	2.08	1
PUBLIC PARKLAND AND DRAINAGE EASEMENT LOT	39.80	2
PUBLIC RIGHT OF WAY	39.14	NA
COMMERCIAL LOT	0.51	1
TOTAL	190.32	608

HERITAGE PDD COMPLIANT RESIDENTIAL LOT MIX		
Product	Number	Percent
40's	58	12%
45's	307	63%
50's	117	24%
60's	8	2%
Total	490	70%
High Density Detached		
Product	Number	Percent
35's	51	49%
40's	54	51%
Total	105	15%
High Density Attached		
Product	Number	Percent
NA	105	15%
Total	700	

OVERALL PRELIMINARY PLAN

HERITAGE PRELIMINARY PLAN

CITY OF DRIPPING SPRINGS

HAYS COUNTY, TEXAS

3

DATE


REVISIONS

No.

© 2020 KIMLEY-HORN AND ASSOCIATES, INC.  
 10814 JOLLYVILLE ROAD, AVALON IV, SUITE 200, AUSTIN, TX 78799  
 PHONE: 512.835.7600 FAX: 512.835.7601  
 WWW.KIMLEY-HORN.COM  
 TEXAS REGISTERED ENGINEERING FIRM F-928




Prepared by: Kimley-Horn & Associates, Inc. Date: 08/10/2020  
 Drawn by: J. Kimley Date: 08/10/2020  
 Checked by: J. Kimley Date: 08/10/2020  
 This document, together with the contract and any amendments thereto, shall constitute the entire agreement between the parties. No oral interpretation or explanation shall be given. The contractor shall be responsible for obtaining all necessary permits and approvals. The engineer shall not be responsible for any delays or stoppages caused by the contractor. The engineer shall not be responsible for any damages or injuries to persons or property. The engineer shall not be responsible for any costs or expenses incurred by the contractor. The engineer shall not be responsible for any claims or lawsuits filed against the contractor. The engineer shall not be responsible for any claims or lawsuits filed against the engineer. The engineer shall not be responsible for any claims or lawsuits filed against the engineer. The engineer shall not be responsible for any claims or lawsuits filed against the engineer.

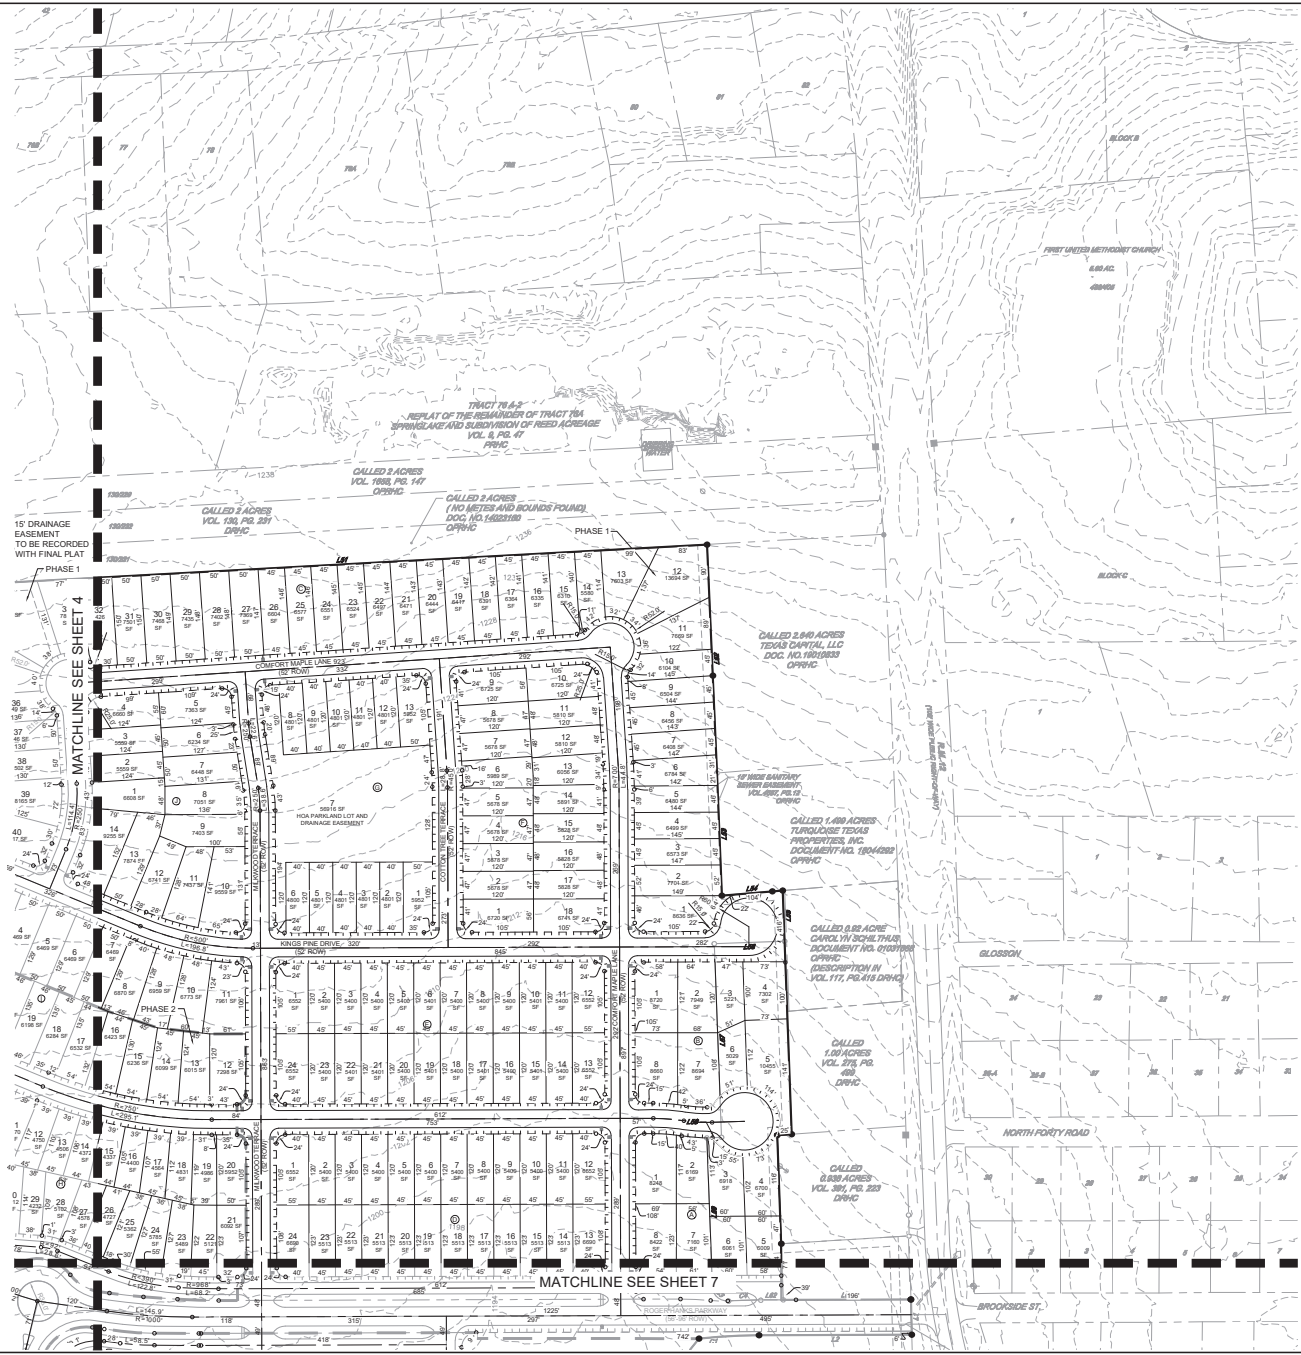

**LEGEND**

- PROPERTY LINE
- PHASE LINE
- CONCRETE SIDEWALK (WIDTH VARIES)
- - - Hike AND BIKE TRAIL
- - - WATER QUALITY BUFFER

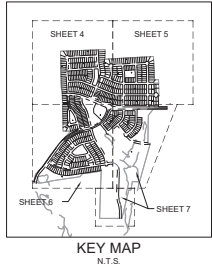

No.	REVISIONS	DATE	BY

**Kimley-Horn**

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TEXAS REGISTERED ENGINEERING FIRM F-928

08/10/2020

J. Kimley, P.E.


KHA PROJECT NO. 2020-08-001  
 DATE: AUGUST 2020  
 SCALE: AS SHOWN  
 DESIGNED BY: JGD  
 DRAWN BY: JGD  
 CHECKED BY: AED


**PRELIMINARY PLAN  
 (SHEET 2 OF 4)**

**HERITAGE  
 PRELIMINARY PLAN  
 CITY OF DRIPPING SPRINGS  
 HAYS COUNTY, TEXAS**

SHEET NUMBER  
**5**

Prepared by: **Kimley-Horn**, 15, 2020, 45-45-25th - City of Dripping Springs, 15000 N. Highway 121, Suite 100, Dripping Springs, TX 78620. This drawing is the property of Kimley-Horn and Associates, Inc. and is not to be used for any other project without the written authorization and signature of the engineer. No part of this drawing may be reproduced or transmitted in any form or by any means, electronic or mechanical, including photocopying, recording, or by any information storage and retrieval system, without the prior written permission of Kimley-Horn and Associates, Inc.

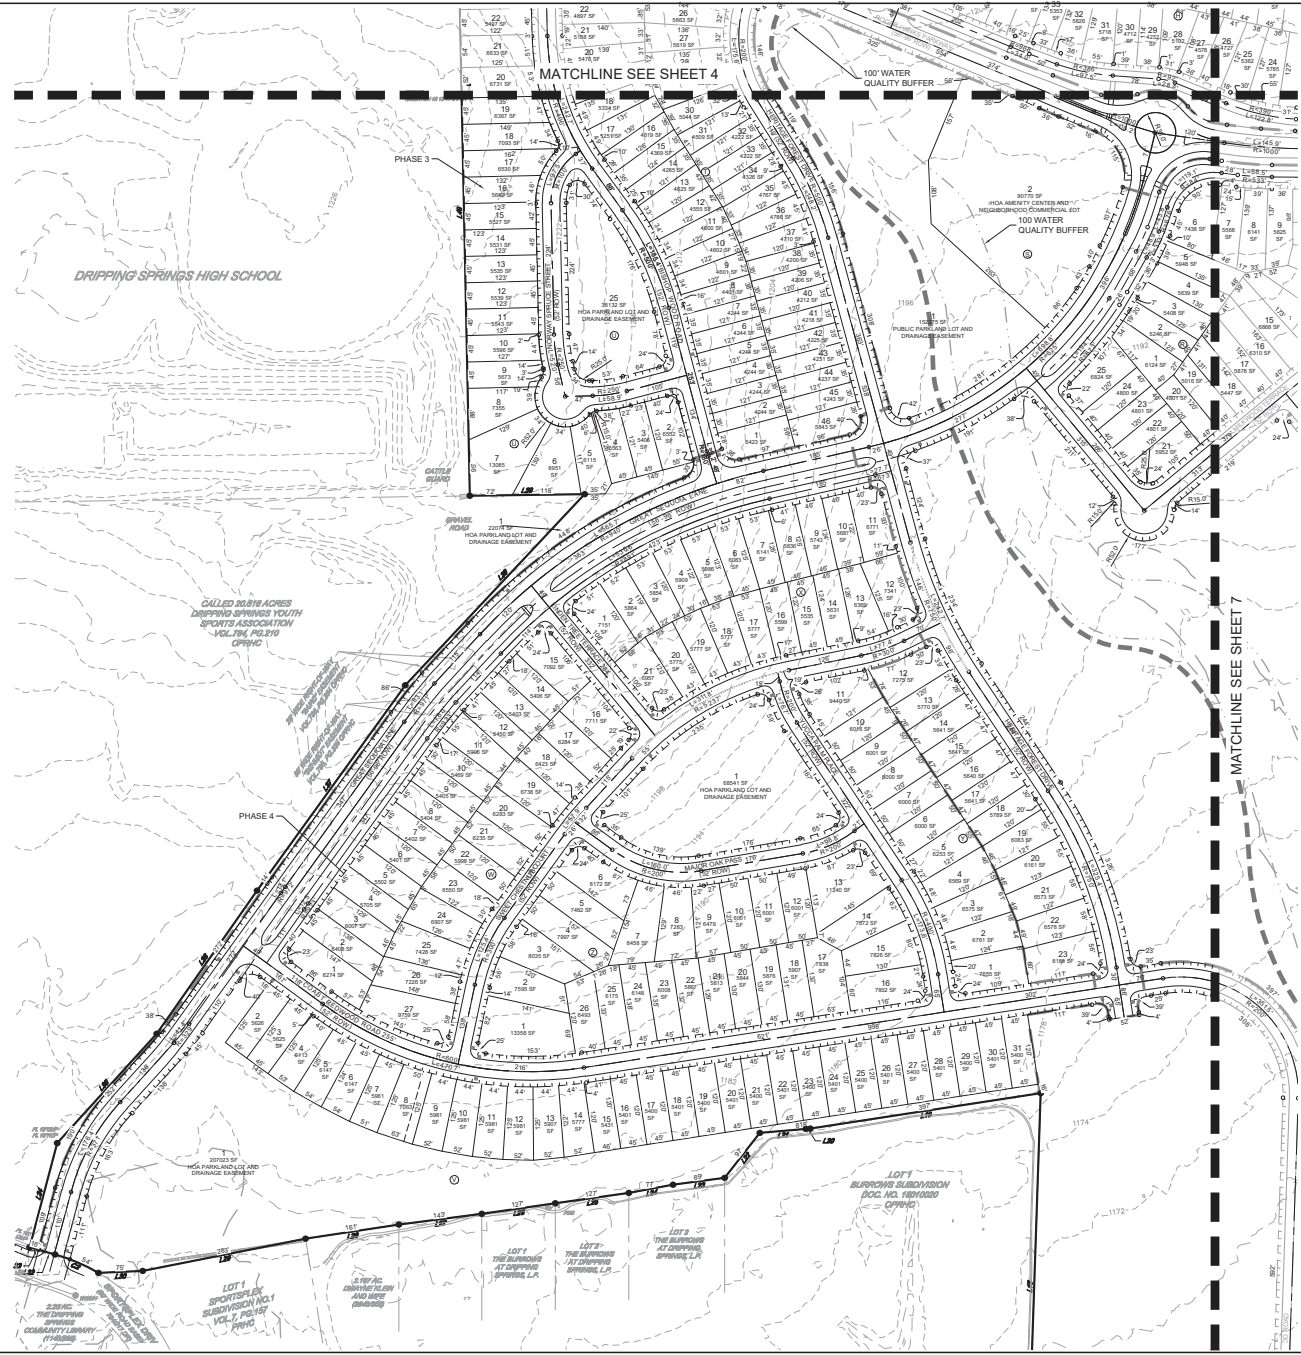






GRAPHIC SCALE 100'


**LEGEND**

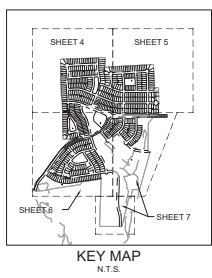- PROPERTY LINE
- - - PHASE LINE
- CONCRETE SIDEWALK (WIDTH VARIES)
- - - BIKE AND BIKE TRAIL
- - - WATER QUALITY BUFFER



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SHEET NUMBER	6	NO.	REVISONS	DATE


Prepared by: **Kimley-Horn & Associates, Inc.**, 15, 2025, 45-45, 45th Street, Austin, TX 78751. This drawing is the property of Kimley-Horn & Associates, Inc. and is not to be used for any other project without the written consent of Kimley-Horn & Associates, Inc. The information contained herein is for the project and site only. The engineer is not responsible for the accuracy of the information provided herein, or for the use of the information for any other project. The engineer is not responsible for the accuracy of the information provided herein, or for the use of the information for any other project.

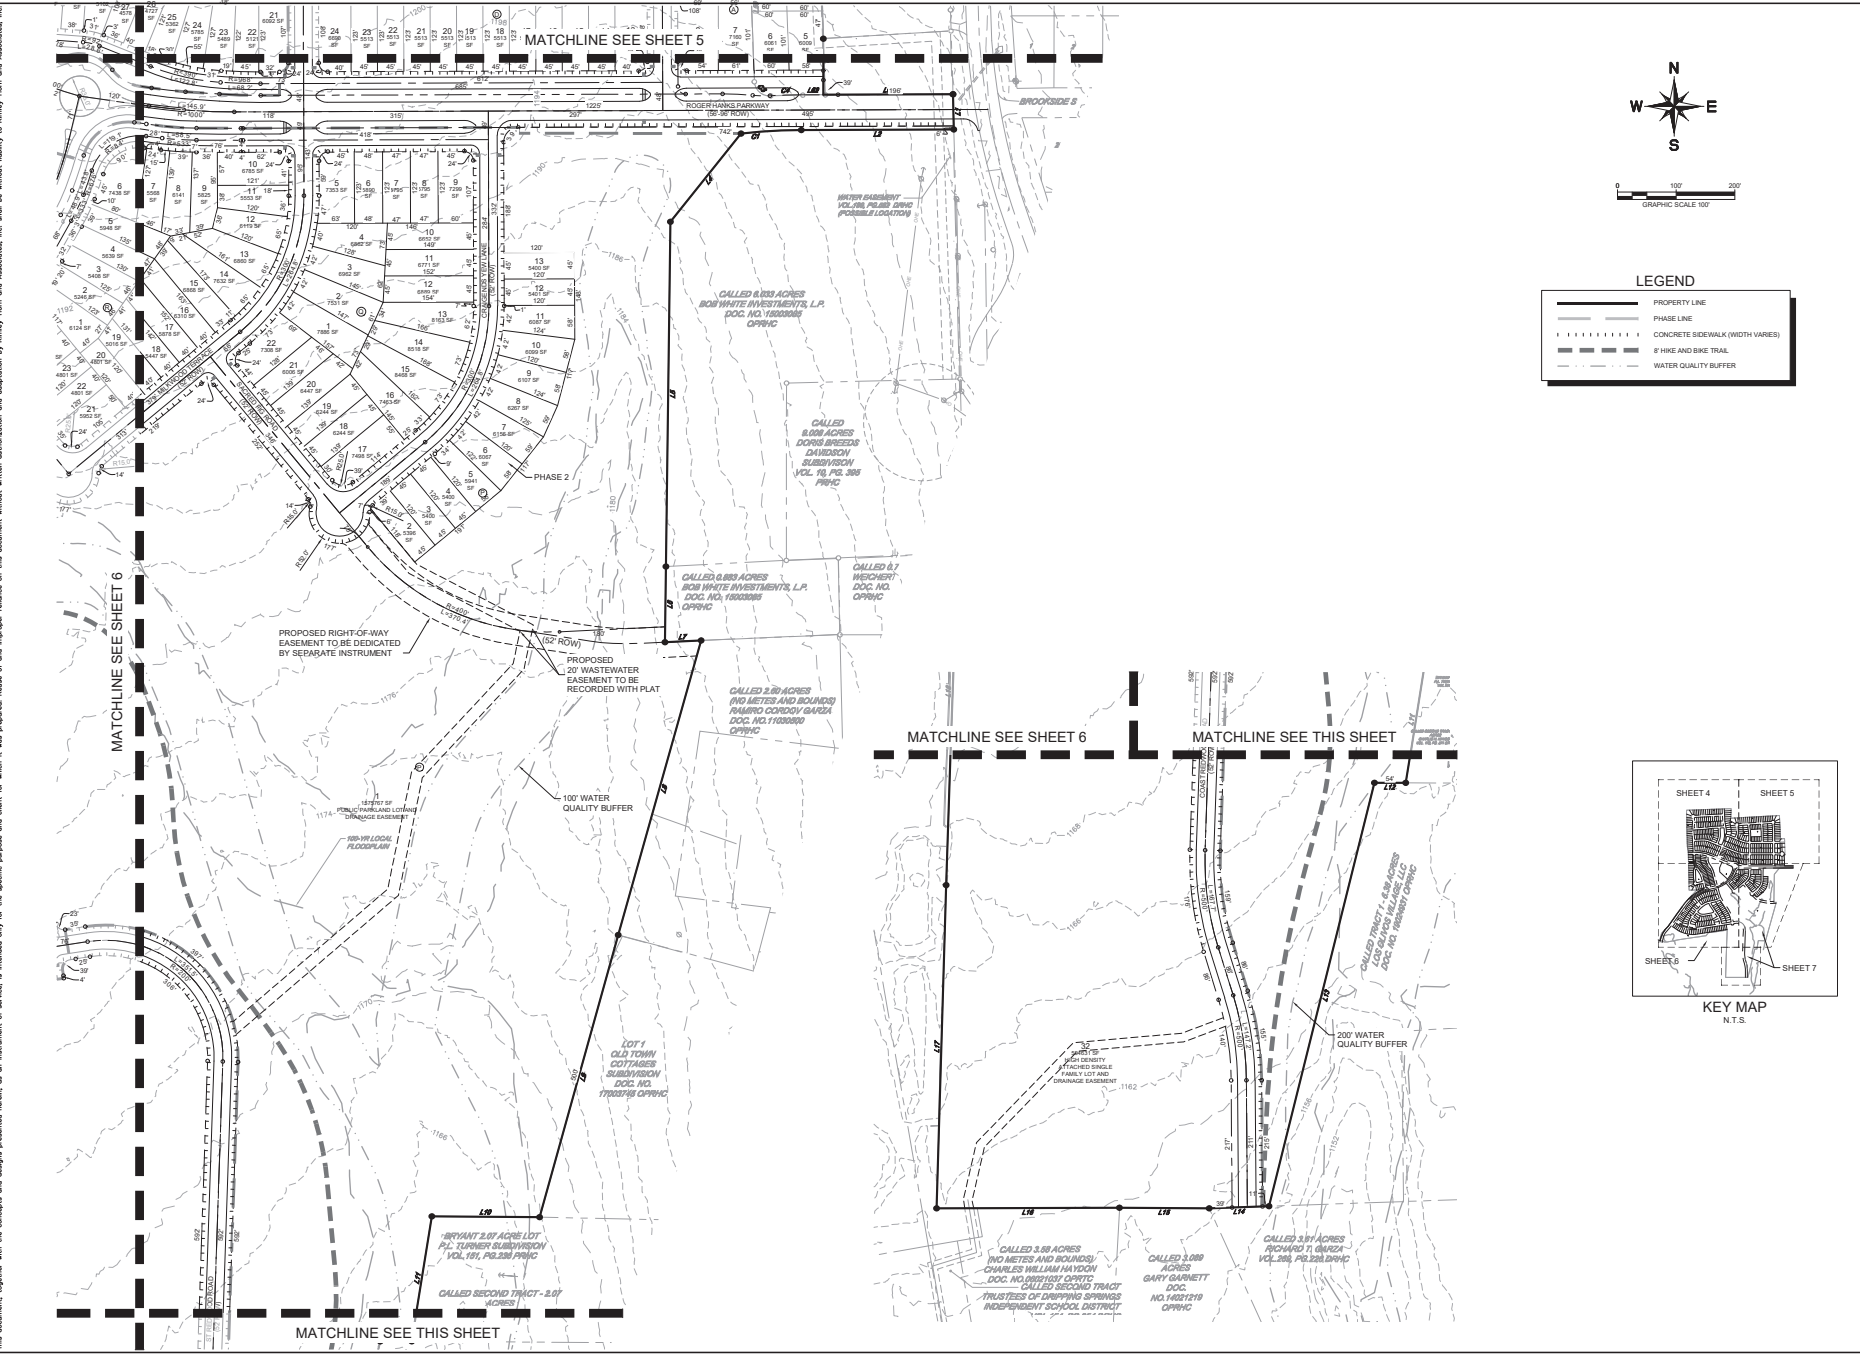

GRAPHIC SCALE 100'

**LEGEND**

- PROPERTY LINE
- - - PHASE LINE
- · - · - CONCRETE SIDEWALK (WIDTH VARIES)
- · - · - BIKE AND BIKE TRAIL
- · - · - WATER QUALITY BUFFER

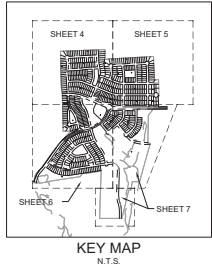

KHA PROJECT NO. 2020-0810	DATE	AUGUST 2020	DESIGNED BY	AGD	CHECKED BY	AEQ
	SCALE	AS SHOWN	DRAWN BY	RLJ	DATE	BY
<b>PRELIMINARY PLAN (SHEET 4 OF 4)</b>						
<b>HERITAGE PRELIMINARY PLAN CITY OF DRIPPING SPRINGS HAYS COUNTY, TEXAS</b>						
SHEET NUMBER						7
						© 2020 KIMLEY-HORN AND ASSOCIATES, INC. 10814 JULYVILLE ROAD, AVALON HILLS, SUITE 200, AUSTIN, TX 78799 PHONE: 512.478.1100 FAX: 512.478.1791 WWW.KIMLEY-HORN.COM TEXAS REGISTERED ENGINEERING FIRM F-928

Revised: 08/10/2020  
 Date: August 10, 2020  
 City: Dallas, Texas  
 Project: 15-2020-05-03-0000  
 Title: Preliminary Plan  
 This document is prepared by Kimley-Horn and Associates, Inc. for the City of Dripping Springs, Texas. It is not to be used for any other purpose without the written consent of Kimley-Horn and Associates, Inc.

### PHASE 1 LOT SUMMARY

BLOCK A		
LOT #	AREA (SF)	AREA (AC)
1	8247	0.19
2	6168	0.14
3	6918	0.16
4	6700	0.15
5	6009	0.14
6	6061	0.14
7	7160	0.16
8	8422	0.19

BLOCK B		
LOT #	AREA (SF)	AREA (AC)
1	8720	0.20
2	7949	0.18
3	5220	0.12
4	7302	0.17
5	10454	0.24
6	5029	0.12
7	8694	0.20
8	8660	0.20

BLOCK C		
LOT #	AREA (SF)	AREA (AC)
1	8635	0.20
2	7700	0.18
3	6573	0.15
4	6498	0.15
5	6479	0.15
6	6784	0.16
7	6407	0.15
8	6455	0.15
9	6503	0.15
10	6104	0.14
11	7669	0.18
12	13693	0.31
13	7602	0.17
14	5679	0.13
15	6310	0.14
16	6335	0.15
17	6363	0.15
18	6390	0.15
19	6417	0.15
20	6444	0.15
21	6470	0.15
22	6497	0.15
23	6524	0.15
24	6550	0.15
25	6577	0.15
26	6604	0.15
27	7369	0.17
28	7402	0.17
29	7435	0.17
30	7468	0.17
31	7500	0.17
32	7426	0.17
33	7812	0.18
34	14805	0.34
35	10388	0.24
36	6348	0.15
37	6645	0.15
38	6502	0.15
39	8164	0.19
40	8416	0.19

#### RESIDENTIAL

BLOCK D		
LOT #	AREA (SF)	AREA (AC)
1	6552	0.15
2	5400	0.12
3	5400	0.12
4	5400	0.12
5	5400	0.12
6	5400	0.12
7	5400	0.12
8	5400	0.12
9	5400	0.12
10	5400	0.12
11	5400	0.12
12	6552	0.15
13	6689	0.15
14	5513	0.13
15	5513	0.13
16	5513	0.13
17	5513	0.13
18	5513	0.13
19	5513	0.13
20	5513	0.13
21	5513	0.13
22	5513	0.13
23	5513	0.13
24	6689	0.15

BLOCK E		
LOT #	AREA (SF)	AREA (AC)
1	6552	0.15
2	5400	0.12
3	5400	0.12
4	5400	0.12
5	5400	0.12
6	5400	0.12
7	5400	0.12
8	5400	0.12
9	5400	0.12
10	5400	0.12
11	5400	0.12
12	6552	0.15
13	6689	0.15
14	5513	0.13
15	5513	0.13
16	5513	0.13
17	5513	0.13
18	5513	0.13
19	5513	0.13
20	5513	0.13
21	5513	0.13
22	5513	0.13
23	5513	0.13
24	6689	0.15

BLOCK G		
LOT #	AREA (SF)	AREA (AC)
1	5952	0.14
2	4800	0.11
3	4800	0.11
4	4800	0.11
5	4800	0.11
6	4800	0.11
8	4800	0.11
9	4800	0.11
10	4800	0.11
11	4800	0.11
12	4800	0.11
13	5952	0.14

BLOCK F		
LOT #	AREA (SF)	AREA (AC)
1	6720	0.15
2	5678	0.13
3	5678	0.13
4	5678	0.13
5	5678	0.13
6	5988	0.14
7	5678	0.13
8	5678	0.13
9	6725	0.15
10	6725	0.15
11	5810	0.13
12	5810	0.13
13	6056	0.14
14	5890	0.14
15	5827	0.13
16	5827	0.13
17	5827	0.13
18	6740	0.15

BLOCK I		
LOT #	AREA (SF)	AREA (AC)
2	6468	0.15
3	6468	0.15
4	6468	0.15
5	6468	0.15
6	6468	0.15
7	6468	0.15
8	6870	0.16
9	6959	0.16
10	6772	0.16
11	7960	0.18

BLOCK J		
LOT #	AREA (SF)	AREA (AC)
1	6607	0.15
2	5558	0.13
3	5558	0.13
4	6659	0.15
5	7363	0.17
6	6234	0.14
7	6447	0.15
8	7050	0.16
9	7403	0.17
10	9559	0.22
11	7437	0.17
12	6741	0.15
13	7874	0.18
14	9255	0.21

#### PHASE 1 NON RESIDENTIAL

NON RESIDENTIAL				
LOT #	BLOCK	LOT TYPE	AREA (SF)	AREA (AC)
7	G	HOA PARKLAND LOT AND DRAINAGE EASEMENT	56916	1.31

BLOCK C		
LOT #	AREA (SF)	AREA (AC)
41	9572	0.22
42	6700	0.15
43	6993	0.16
44	6447	0.15
45	6360	0.15
46	7235	0.17

BLOCK H		
LOT #	AREA (SF)	AREA (AC)
1	7606	0.17
2	4200	0.10
3	4200	0.10
4	4200	0.10
5	4200	0.10
6	5866	0.13
7	5899	0.14
8	4800	0.11
9	4800	0.11
10	4800	0.11
11	4770	0.11
12	4749	0.11
13	4506	0.10
14	4371	0.10
15	4336	0.10
16	4400	0.10
17	4563	0.10
18	4830	0.11
19	4986	0.11
20	5951	0.14
21	6092	0.14
22	5120	0.12
23	5488	0.13
24	5784	0.13
25	5362	0.12
26	4727	0.11
27	4577	0.11
28	5102	0.12
29	4232	0.10
30	4712	0.11
31	5717	0.13
32	5825	0.13
33	5353	0.12
34	5184	0.12
35	5351	0.12

BLOCK I		
LOT #	AREA (SF)	AREA (AC)
1	10352	0.24
12	7297	0.17
13	6015	0.14
14	6099	0.14
15	6236	0.14
16	6423	0.15
17	6531	0.15
18	6284	0.14
19	6197	0.14
20	6197	0.14
21	6197	0.14
22	6197	0.14
23	6195	0.14
24	8206	0.19

### PHASE 2 LOT SUMMARY

#### RESIDENTIAL

BLOCK K		
LOT #	AREA (SF)	AREA (AC)
9	5709	0.13
10	5709	0.13
11	5709	0.13
12	5344	0.12
13	6074	0.14
14	7239	0.17
15	7384	0.17
16	6195	0.14
17	6202	0.14
18	6469	0.15
19	6598	0.15
20	6811	0.16
21	6942	0.16
22	6922	0.16
23	6725	0.15
24	6595	0.15
25	6273	0.14
26	6934	0.16

BLOCK M		
LOT #	AREA (SF)	AREA (AC)
13	7326	0.17
14	5485	0.13
15	5485	0.13
16	6342	0.15
17	6635	0.15
18	6052	0.14
19	7585	0.17

BLOCK N		
LOT #	AREA (SF)	AREA (AC)
15	7606	0.17
16	5740	0.13
17	5496	0.13
18	5496	0.13
19	5496	0.13
20	5496	0.13

BLOCK O		
LOT #	AREA (SF)	AREA (AC)
1	4956	0.11
2	6562	0.15
3	6856	0.16

BLOCK P		
LOT #	AREA (SF)	AREA (AC)
2	5395	0.12
3	5400	0.12
4	5400	0.12
5	5941	0.14
6	6067	0.14
7	6155	0.14
8	6267	0.14
9	6106	0.14
10	6098	0.14
11	6087	0.14
12	5400	0.12
13	5400	0.12

BLOCK Q		
LOT #	AREA (SF)	AREA (AC)
1	7886	0.18
2	7531	0.17
3	6961	0.16
4	6862	0.16
5	7353	0.17
6	5889	0.14
7	5794	0.13
8	5794	0.13
9	7299	0.17
10	6652	0.15
11	6770	0.16
12	6889	0.16
13	8162	0.19
14	8517	0.20
15	8467	0.19
16	7463	0.17
17	7497	0.17
18	6244	0.14
19	6244	0.14
20	6447	0.15
21	6006	0.14
22	7308	0.17

BLOCK Q		
LOT #	AREA (SF)	AREA (AC)
1	7886	0.18
2	7531	0.17
3	6961	0.16
4	6862	0.16
5	7353	0.17
6	5889	0.14
7	5794	0.13
8	5794	0.13
9	7299	0.17
10	6652	0.15
11	6770	0.16
12	6889	0.16
13	8162	0.19
14	8517	0.20
15	8467	0.19
16	7463	0.17
17	7497	0.17
18	6244	0.14
19	6244	0.14
20	6447	0.15
21	6006	0.14
22	7308	0.17

BLOCK R		
LOT #	AREA (SF)	AREA (AC)
1	6123	0.14
2	5245	0.12
3	5408	0.12
4	5639	0.13
5	5947	0.14
6	7438	0.17
7	5568	0.13
8	6140	0.14
9	5824	0.13
10	6785	0.16
11	5552	0.13
12	6119	0.14
13	6860	0.16
14	7631	0.18
15	6867	0.16
16	6309	0.14
17	5878	0.13
18	5447	0.13
19	5016	0.12
20	4800	0.11
21	5952	0.14
22	4800	0.11
23	4800	0.11
24	4800	0.


















Revised: 08/10/2020  
 Checked: 08/10/2020  
 Drawn: 08/10/2020  
 Scale: AS SHOWN  
 Project: 1004 JULYVILLE ROAD, AVALLON IV, SITE 200, AUSTIN, TX 78799  
 Client: KIMBLEY & HORN, INC.  
 Designer: J. HORN  
 Checker: J. HORN  
 Date: 08/10/2020  
 No. of Sheets: 3  
 Sheet No.: 3 OF 3  
 Project No.: 1004 JULYVILLE ROAD, AVALLON IV, SITE 200, AUSTIN, TX 78799  
 Designer: J. HORN  
 Checker: J. HORN  
 Date: 08/10/2020  
 No. of Sheets: 3  
 Sheet No.: 3 OF 3

TREE TABLE	TREE TABLE	TREE TABLE	TREE TABLE	TREE TABLE	TREE TABLE	TREE TABLE	TREE TABLE	TREE TABLE	TREE TABLE	TREE TABLE
NO. DESCRIPTION	NO. DESCRIPTION	NO. DESCRIPTION	NO. DESCRIPTION	NO. DESCRIPTION	NO. DESCRIPTION	NO. DESCRIPTION	NO. DESCRIPTION	NO. DESCRIPTION	NO. DESCRIPTION	NO. DESCRIPTION
9262 9" OAK	9353 10" OAK	9443 11" OAK	9538 12" OAK	9633 13" OAK	9728 14" OAK	9823 15" OAK	9918 16" OAK	10013 17" OAK	10108 18" OAK	10203 19" OAK
9263 10" OAK	9354 11" OAK	9444 12" OAK	9539 13" OAK	9634 14" OAK	9729 15" OAK	9824 16" OAK	9919 17" OAK	10014 18" OAK	10109 19" OAK	10204 20" OAK
9264 11" OAK	9355 12" OAK	9445 13" OAK	9540 14" OAK	9635 15" OAK	9730 16" OAK	9825 17" OAK	9920 18" OAK	10015 19" OAK	10110 20" OAK	10205 21" OAK
9265 12" OAK	9356 13" OAK	9446 14" OAK	9541 15" OAK	9636 16" OAK	9731 17" OAK	9826 18" OAK	9921 19" OAK	10016 20" OAK	10111 21" OAK	10206 22" OAK
9266 13" OAK	9357 14" OAK	9447 15" OAK	9542 16" OAK	9637 17" OAK	9732 18" OAK	9827 19" OAK	9922 20" OAK	10017 21" OAK	10112 22" OAK	10207 23" OAK
9267 14" OAK	9358 15" OAK	9448 16" OAK	9543 17" OAK	9638 18" OAK	9733 19" OAK	9828 20" OAK	9923 21" OAK	10018 22" OAK	10113 23" OAK	10208 24" OAK
9268 15" OAK	9359 16" OAK	9449 17" OAK	9544 18" OAK	9639 19" OAK	9734 20" OAK	9829 21" OAK	9924 22" OAK	10019 23" OAK	10114 24" OAK	10209 25" OAK
9269 16" OAK	9360 17" OAK	9450 18" OAK	9545 19" OAK	9640 20" OAK	9735 21" OAK	9830 22" OAK	9925 23" OAK	10020 24" OAK	10115 25" OAK	10210 26" OAK
9270 17" OAK	9361 18" OAK	9451 19" OAK	9546 20" OAK	9641 21" OAK	9736 22" OAK	9831 23" OAK	9926 24" OAK	10021 25" OAK	10116 26" OAK	10211 27" OAK
9271 18" OAK	9362 19" OAK	9452 20" OAK	9547 21" OAK	9642 22" OAK	9737 23" OAK	9832 24" OAK	9927 25" OAK	10022 26" OAK	10117 27" OAK	10212 28" OAK
9272 19" OAK	9363 20" OAK	9453 21" OAK	9548 22" OAK	9643 23" OAK	9738 24" OAK	9833 25" OAK	9928 26" OAK	10023 27" OAK	10118 28" OAK	10213 29" OAK
9273 20" OAK	9364 21" OAK	9454 22" OAK	9549 23" OAK	9644 24" OAK	9739 25" OAK	9834 26" OAK	9929 27" OAK	10024 28" OAK	10119 29" OAK	10214 30" OAK
9274 21" OAK	9365 22" OAK	9455 23" OAK	9550 24" OAK	9645 25" OAK	9740 26" OAK	9835 27" OAK	9930 28" OAK	10025 29" OAK	10120 30" OAK	10215 31" OAK
9275 22" OAK	9366 23" OAK	9456 24" OAK	9551 25" OAK	9646 26" OAK	9741 27" OAK	9836 28" OAK	9931 29" OAK	10026 30" OAK	10121 31" OAK	10216 32" OAK
9276 23" OAK	9367 24" OAK	9457 25" OAK	9552 26" OAK	9647 27" OAK	9742 28" OAK	9837 29" OAK	9932 30" OAK	10027 31" OAK	10122 32" OAK	10217 33" OAK
9277 24" OAK	9368 25" OAK	9458 26" OAK	9553 27" OAK	9648 28" OAK	9743 29" OAK	9838 30" OAK	9933 31" OAK	10028 32" OAK	10123 33" OAK	10218 34" OAK
9278 25" OAK	9369 26" OAK	9459 27" OAK	9554 28" OAK	9649 29" OAK	9744 30" OAK	9839 31" OAK	9934 32" OAK	10029 33" OAK	10124 34" OAK	10219 35" OAK
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9287 34" OAK	9378 35" OAK	9468 36" OAK	9563 37" OAK	9658 38" OAK	9753 39" OAK	9848 40" OAK	9943 41" OAK	10038 42" OAK	10133 43" OAK	10228 44" OAK
9288 35" OAK	9379 36" OAK	9469 37" OAK	9564 38" OAK	9659 39" OAK	9754 40" OAK	9849 41" OAK	9944 42" OAK	10039 43" OAK	10134 44" OAK	10229 45" OAK
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9290 37" OAK	9381 38" OAK	9471 39" OAK	9566 40" OAK	9661 41" OAK	9756 42" OAK	9851 43" OAK	9946 44" OAK	10041 45" OAK	10136 46" OAK	10231 47" OAK
9291 38" OAK	9382 39" OAK	9472 40" OAK	9567 41" OAK	9662 42" OAK	9757 43" OAK	9852 44" OAK	9947 45" OAK	10042 46" OAK	10137 47" OAK	10232 48" OAK
9292 39" OAK	9383 40" OAK	9473 41" OAK	9568 42" OAK	9663 43" OAK	9758 44" OAK	9853 45" OAK	9948 46" OAK	10043 47" OAK	10138 48" OAK	10233 49" OAK
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9297 44" OAK	9388 45" OAK	9478 46" OAK	9573 47" OAK	9668 48" OAK	9763 49" OAK	9858 50" OAK	9953 51" OAK	10048 52" OAK	10143 53" OAK	10238 54" OAK
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9303 50" OAK	9394 51" OAK	9484 52" OAK	9579 53" OAK	9674 54" OAK	9769 55" OAK	9864 56" OAK	9959 57" OAK	10054 58" OAK	10149 59" OAK	10244 60" OAK
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9305 52" OAK	9396 53" OAK	9486 54" OAK	9581 55" OAK	9676 56" OAK	9771 57" OAK	9866 58" OAK	9961 59" OAK	10056 60" OAK	10151 61" OAK	10246 62" OAK
9306 53" OAK	9397 54" OAK	9487 55" OAK	9582 56" OAK	9677 57" OAK	9772 58" OAK	9867 59" OAK	9962 60" OAK	10057 61" OAK	10152 62" OAK	10247 63" OAK
9307 54" OAK	9398 55" OAK	9488 56" OAK	9583 57" OAK	9678 58" OAK	9773 59" OAK	9868 60" OAK	9963 61" OAK	10058 62" OAK	10153 63" OAK	10248 64" OAK
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9314 61" OAK	9405 62" OAK	9495 63" OAK	9590 64" OAK	9685 65" OAK	9780 66" OAK	9875 67" OAK	9970 68" OAK	10065 69" OAK	10160 70" OAK	10255 71" OAK
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9316 63" OAK	9407 64" OAK	9497 65" OAK	9592 66" OAK	9687 67" OAK	9782 68" OAK	9877 69" OAK	9972 70" OAK	10067 71" OAK	10162 72" OAK	10257 73" OAK
9317 64" OAK	9408 65" OAK	9498 66" OAK	9593 67" OAK	9688 68" OAK	9783 69" OAK	9878 70" OAK	9973 71" OAK	10068 72" OAK	10163 73" OAK	10258 74" OAK
9318 65" OAK	9409 66" OAK	9499 67" OAK	9594 68" OAK	9689 69" OAK	9784 70" OAK	9879 71" OAK	9974 72" OAK	10069 73" OAK	10164 74" OAK	10259 75" OAK
9319 66" OAK	9410 67" OAK	9500 68" OAK	9595 69" OAK	9690 70" OAK	9785 71" OAK	9880 72" OAK	9975 73" OAK	10070 74" OAK	10165 75" OAK	10260 76" OAK
9320 67" OAK	9411 68" OAK	9501 69" OAK	9596 70" OAK	9691 71" OAK	9786 72" OAK	9881 73" OAK	9976 74" OAK	10071 75" OAK	10166 76" OAK	10261 77" OAK
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9325 72" OAK	9416 73" OAK	9506 74" OAK	9601 75" OAK	9696 76" OAK	9791 77" OAK	9886 78" OAK	9981 79" OAK	10076 80" OAK	10171 81" OAK	10266 82" OAK
9326 73" OAK	9417 74" OAK	9507 75" OAK	9602 76" OAK	9697 77" OAK	9792 78" OAK	9887 79" OAK	9982 80" OAK	10077 81" OAK	10172 82" OAK	10267 83" OAK
9327 74" OAK	9418 75" OAK	9508 76" OAK	9603 77" OAK	9698 78" OAK	9793 79" OAK	9888 80" OAK	9983 81" OAK	10078 82" OAK	10173 83" OAK	10268 84" OAK
9328 75" OAK	9419 76" OAK	9509 77" OAK	9604 78" OAK	9699 79" OAK	9794 80" OAK	9889 81" OAK	9984 82" OAK	10079 83" OAK	10174 84" OAK	10269 85" OAK
9329 76" OAK	9420 77" OAK	9510 78" OAK	9605 79" OAK	9700 80" OAK	9795 81" OAK	9890 82" OAK	9985 83" OAK	10080 84" OAK	10175 85" OAK	10270 86" OAK
9330 77" OAK	9421 78" OAK	9511 79" OAK								




KIMLEY-HORN AND ASSOCIATES, INC. 13525 DALLAS ROAD, SUITE 200, AUSTIN, TEXAS 78759  
 PROJECT: HERITAGE PRELIMINARY PLAN, CITY OF DRIPPING SPRINGS, HAYS COUNTY, TEXAS  
 SHEET: EXISTING DRAINAGE AREA MAP  
 DATE: AUGUST 2020  
 DRAWN BY: RRU  
 CHECKED BY: AEO

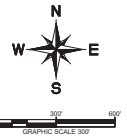

**LEGEND**

	AREA DESIGNATOR
	AREA IN ACRES
	INLET NUMBER
	PROPERTY LINE
	PROPOSED STORM DRAIN LINE
	EXISTING STORM DRAIN LINE
	PROPOSED DRAINAGE DIVIDE
	PROPOSED STORM DRAIN INLET
	PROPOSED STORM DRAIN MANHOLE
	PROPOSED STORM DRAIN HEADWALL
	PROPOSED FLOW DIRECTION
	PROPOSED CONTOUR
	EXISTING CONTOUR
	TIME OF CONCENTRATION FLOW PATH

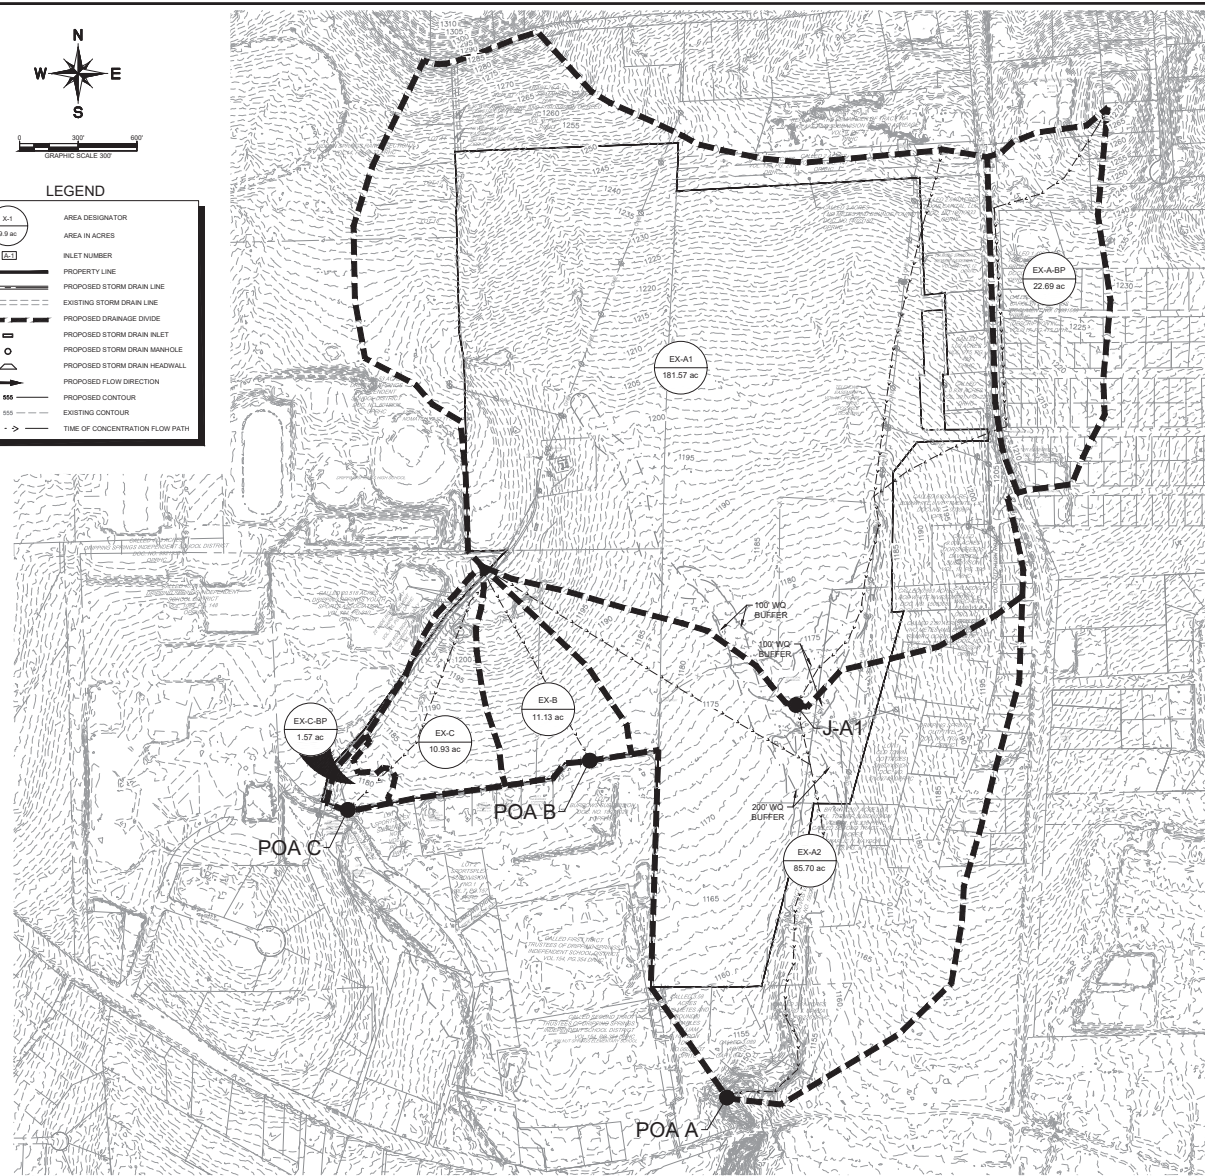

**Composite CN Calculations**

Drainage Area		EX-A1			
Land Cover Description	Hydrologic Condition	Soil Group	SCS CN	Area	CN*AREA
Impervious	Fair	B	98	134510	13181980
Woods-Grass Combination	Fair	B	65	600154	39010010
Woods-Grass Combination	Fair	C	76	0	0
Woods-Grass Combination	Fair	D	82	1519680	124613700
Woods	Fair	B	60	705013	42200600
Woods	Fair	C	73	632818	46185568
Woods	Fair	D	79	4317015	341044185
<b>Totals</b>				<b>7909190</b>	<b>636346603</b>
<b>Composite SCS CN</b>					

**Composite CN Calculations**

Drainage Area		EX-A2			
Land Cover Description	Hydrologic Condition	Soil Group	SCS CN	Area	CN*AREA
Impervious	Fair	B	98	51809	5077282
Woods-Grass Combination	Fair	B	65	0	0
Woods-Grass Combination	Fair	C	76	0	0
Woods-Grass Combination	Fair	D	82	1240581	101760442
Woods	Fair	B	60	13543	812580
Woods	Fair	C	73	189243	12281138
Woods	Fair	D	79	226700	17843700
<b>Totals</b>				<b>3733276</b>	<b>296285413</b>
<b>Composite SCS CN</b>					

**Composite CN Calculations**

Drainage Area		EX-A-BP			
Land Cover Description	Hydrologic Condition	Soil Group	SCS CN	Area	CN*AREA
Impervious	Fair	B	98	0	0
Woods-Grass Combination	Fair	B	65	0	0
Woods-Grass Combination	Fair	C	76	0	0
Woods-Grass Combination	Fair	D	82	0	0
Woods	Fair	B	60	37787	2267220
Woods	Fair	C	73	0	0
Woods	Fair	D	79	712415	56280785
<b>Totals</b>				<b>668491</b>	<b>81900327</b>
<b>Composite SCS CN</b>					

**Composite CN Calculations**

Drainage Area		EX-B			
Land Cover Description	Hydrologic Condition	Soil Group	SCS CN	Area	CN*AREA
Impervious	Fair	B	98	976	95768
Woods-Grass Combination	Fair	B	65	236269	2332302
Woods-Grass Combination	Fair	C	76	0	0
Woods-Grass Combination	Fair	D	82	0	0
Woods	Fair	B	60	0	0
Woods	Fair	C	73	75400	5504200
Woods	Fair	D	79	458203	32717680
<b>Totals</b>				<b>454830</b>	<b>37867048</b>
<b>Composite SCS CN</b>					

**Composite CN Calculations**

Drainage Area		EX-C			
Land Cover Description	Hydrologic Condition	Soil Group	SCS CN	Area	CN*AREA
Impervious	Fair	B	98	17406	170788
Woods-Grass Combination	Fair	B	65	0	0
Woods-Grass Combination	Fair	C	76	0	0
Woods-Grass Combination	Fair	D	82	0	0
Woods	Fair	B	60	0	0
Woods	Fair	C	73	0	0
Woods	Fair	D	79	458992	36236668
<b>Totals</b>				<b>476268</b>	<b>37642458</b>
<b>Composite SCS CN</b>					

**Composite CN Calculations**

Drainage Area		EX-C-BP			
Land Cover Description	Hydrologic Condition	Soil Group	SCS CN	Area	CN*AREA
Impervious	Fair	B	98	0	0
Woods-Grass Combination	Fair	B	65	0	0
Woods-Grass Combination	Fair	C	76	0	0
Woods-Grass Combination	Fair	D	82	0	0
Woods	Fair	B	60	0	0
Woods	Fair	C	73	0	0
Woods	Fair	D	79	68429	5405881
<b>Totals</b>				<b>68429</b>	<b>5405881</b>
<b>Composite SCS CN</b>					

**Heritage Preliminary**  
DETENTION RESULTS - SCS METHOD

**EXISTING CONDITIONS**

Point of Analysis	Total Drainage Area (Acres)	Total Impervious Cover Area (acres)	Impervious Area (%)	Storm Event	Existing Runoff (cfs)
A	289.97	9.75	3.36%	2	290.58
				25	1039.62
				100	1521.50
B	11.13	0.02	0.19%	2	13.75
				25	34.70
				100	47.63
C	12.50	0.40	3.20%	2	15.95
				25	39.35
				100	53.58

**Heritage-Preliminary**  
Drainage Calculations - SCS Method

DRAINAGE AREA	AREA (af)	AREA (Ac.)	IMPERVIOUS COVER (Ac.)	WEIGHTED CURVE NO.	SHEET FLOW			SHALLOW CONCENTRATED FLOW			CHANNEL FLOW						TOTAL Tc (min)						
					Crt	N	P-2yr24hr L (ft)	S (ft/ft)	T (min)	Grass Surface			Channel Flow			Pipe Flow							
										L (ft)	V (ft/s)	S (ft/ft)	T (min)	L (ft)	V (ft/s)	S (ft/ft)		T (min)	L (ft)	V (ft/s)	S (ft/ft)	T (min)	
EX-A1	7,909,190	181.57	3,088	76.68	0.15	100	0.031	7.33	1710	3.00	0.035	9.51	1190	4.5	0.035	0.011	4.46	-	-	0.013	0.010	0.00	21.30
EX-A2	3,733,276	85.70	1,189	79.92	0.15	100	0.020	8.89	1960	2.55	0.025	12.15	2057	7.4	0.035	0.018	4.62	-	-	0.013	0.010	0.00	25.46
EX-A-BP	388,491	22.89	4,470	82.85	0.15	100	0.060	3.46	719	3.31	0.042	3.62	1159	6.0	0.03	0.026	3.22	-	-	0.013	0.010	0.00	12.44
EX-B	484,836	11.13	0.021	78.10	0.15	100	0.018	9.06	1036	2.93	0.033	5.89	0	6.0	0.03	0.020	0.00	-	-	0.013	0.010	0.00	14.85
EX-C	478,098	10.93	0.400	79.69	0.15	100	0.019	8.87	1265	2.84	0.031	7.42	0	6.0	0.03	0.020	0.00	-	-	0.013	0.010	0.00	16.29
EX-C-BP	68,429	1.57	0.000	79.00	0.15	100	0.020	8.69	200	1.84	0.013	1.81	0	4.2	0.035	0.010	0.00	-	-	0.013	0.010	0.00	10.58

\*The minimum Tc is 6 minutes per the TR55.

PROJECT: HERITAGE PRELIMINARY PLAN, CITY OF DRIPPING SPRINGS, HAYS COUNTY, TEXAS

DATE: AUGUST 2020

SCALE: AS SHOWN

DESIGNED BY: AEO

DRAWN BY: RRU

CHECKED BY: AEO

**EXISTING DRAINAGE AREA MAP**

**HERITAGE PRELIMINARY PLAN**  
CITY OF DRIPPING SPRINGS  
HAYS COUNTY, TEXAS

SHEET NUMBER

**17**

**Kimley-Horn**

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TEXAS REGISTERED ENGINEERING FIRM F-928




Project: Heritage Area Preliminary Plan, City of Dripping Springs, Travis County, Texas. Project No. 19. Date: August 2020. Scale: AS SHOWN. Designer: Kimley-Horn and Associates, Inc. 10814 Jollyville Road, Austin, TX 78759. Phone: 512.835.1791. www.kimley-horn.com. Texas Registered Engineering Firm F-928.



**LEGEND**


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	AREA IN ACRES
	PROPERTY LINE
	PROPOSED STORM DRAIN LINE
	EXISTING STORM DRAIN LINE
	PROPOSED DRAINAGE DIVIDE
	PROPOSED STORM DRAIN INLET
	PROPOSED STORM DRAIN MANHOLE
	PROPOSED STORM DRAIN HEADWALL
	PROPOSED FLOW DIRECTION
	PROPOSED CONTOUR
	EXISTING CONTOUR
	TIME OF CONCENTRATION FLOW PATH

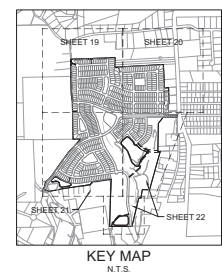

<b>INLET DRAINAGE AREA MAP (1 OF 4)</b>							
<b>HERITAGE PRELIMINARY PLAN CITY OF DRIPPING SPRINGS HAYS COUNTY, TEXAS</b>							
SHEET NUMBER <b>19</b>							No.
REVISIONS							No.
DATE							DATE




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**LEGEND**

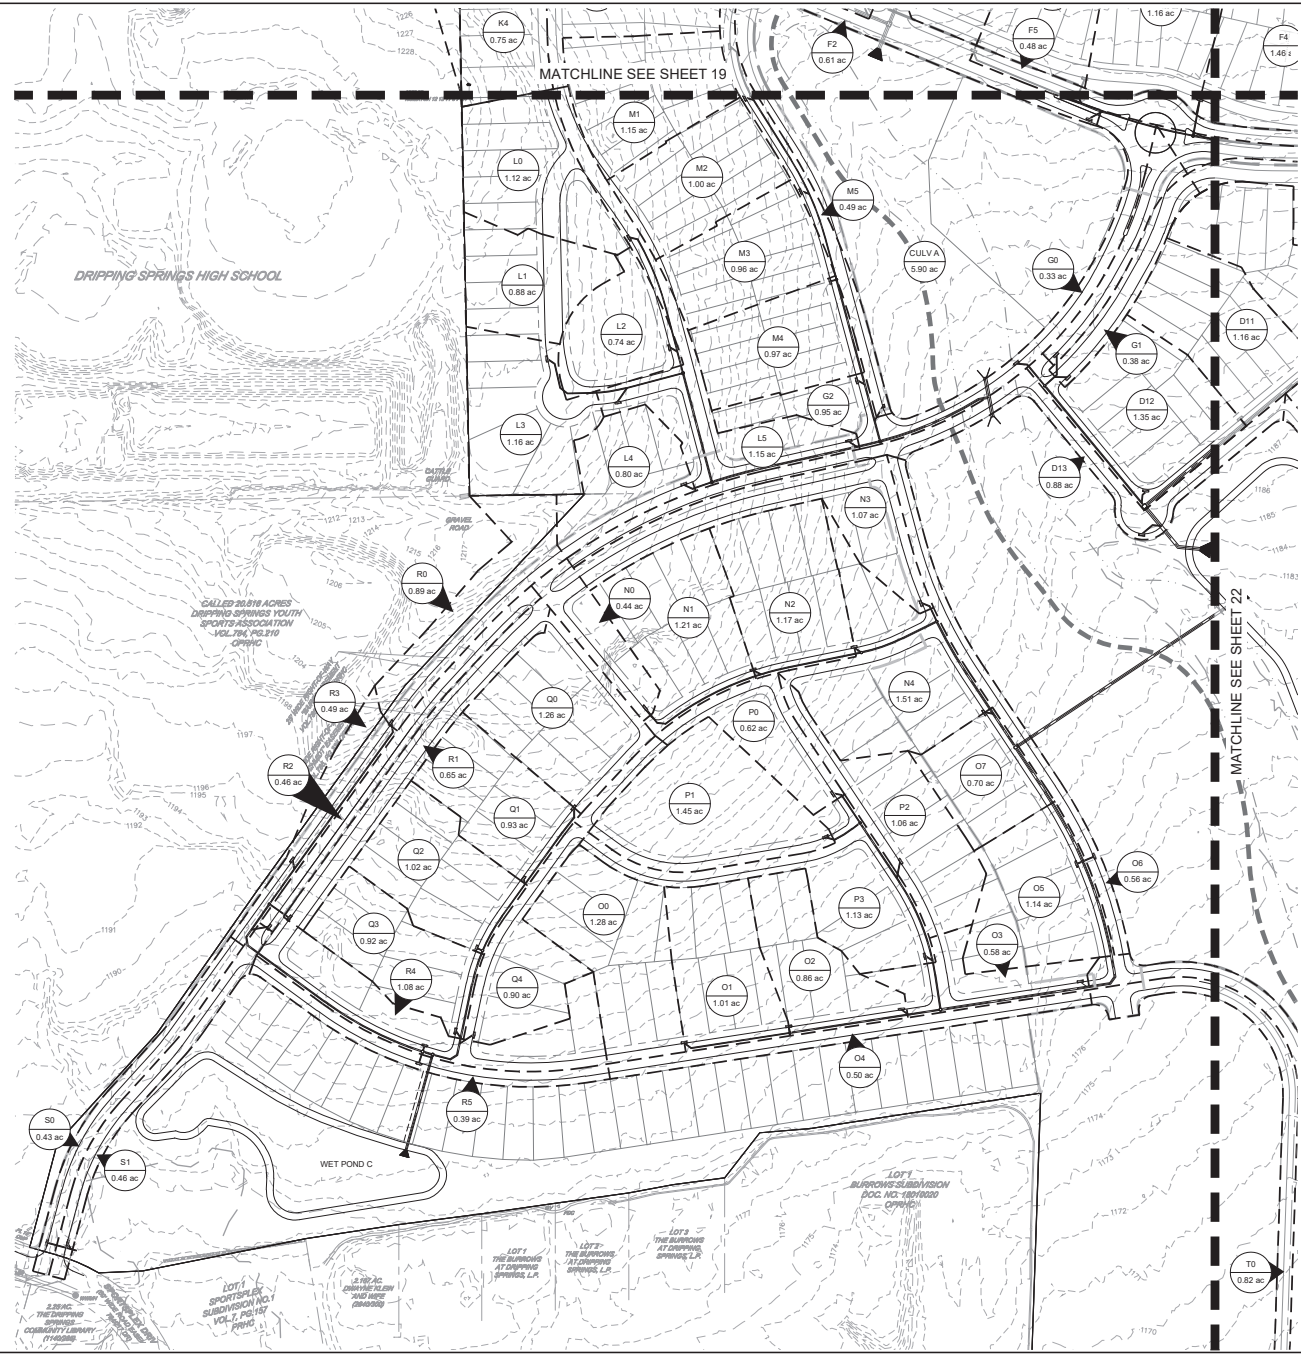	AREA DESIGNATOR
	AREA IN ACRES
	PROPERTY LINE
	PROPOSED STORM DRAIN LINE
	EXISTING STORM DRAIN LINE
	PROPOSED DRAINAGE DIVIDE
	PROPOSED STORM DRAIN INLET
	PROPOSED STORM DRAIN MANHOLE
	PROPOSED STORM DRAIN HEADWALL
	PROPOSED FLOW DIRECTION
	PROPOSED CONTOUR
	EXISTING CONTOUR
	TIME OF CONCENTRATION FLOW PATH




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KHA PROJECT NO. 2020-08-03-0006 DATE: AUGUST 2020 SCALE: AS SHOWN DESIGNED BY: AGD DRAWN BY: RRL CHECKED BY: AED	08/10/2020 						
<b>HERITAGE PRELIMINARY PLAN CITY OF DRIPPING SPRINGS HAYS COUNTY, TEXAS</b>	<b>INLET DRAINAGE AREA MAP (3 OF 4)</b>						
SHEET NUMBER <b>21</b>	REVISIONS <table border="1"> <tr> <th>NO.</th> <th>DATE</th> <th>BY</th> </tr> <tr> <td> </td> <td> </td> <td> </td> </tr> </table>	NO.	DATE	BY			
NO.	DATE	BY					

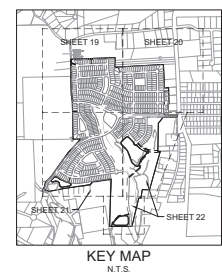



Revised: 08/10/2020; Author: [Name]; Date: 08/10/2020; City: [City]; State: [State]; Scale: AS SHOWN; Project: [Project Name]; Description: [Project Description];

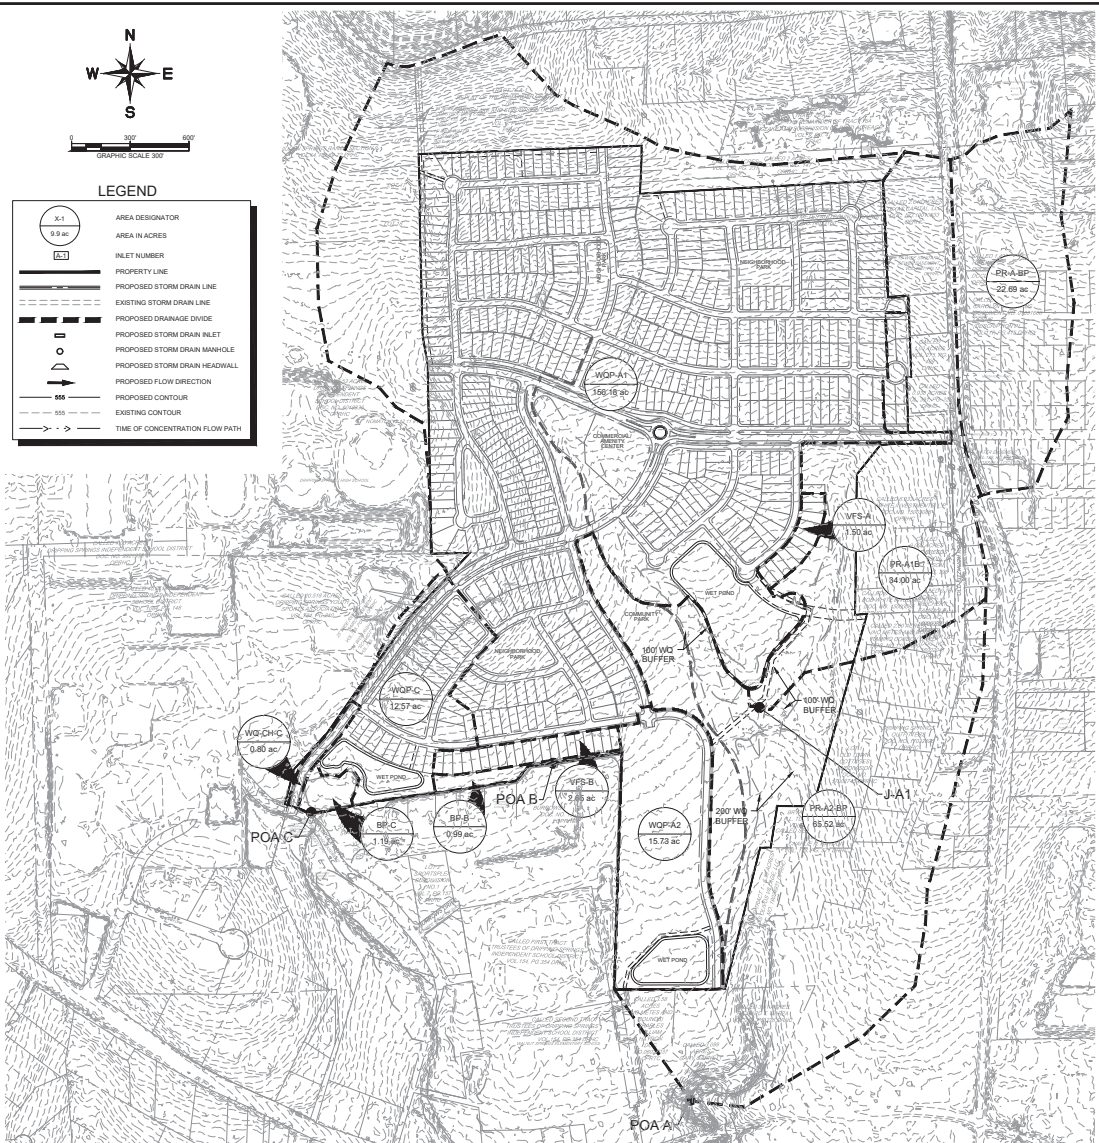

**Texas Commission on Environmental Quality**

**TSS Removal Calculations 04-20-2009** Project Name: **Heritage**  
Date Prepared: **3/16/2020**

Additional information is provided for cells with a red triangle in the upper right corner. Place the cursor over the cell. Text shown in blue indicate location of instructions in the Technical Guidance Manual - RG-348. Characters shown in red are data entry fields. Characters shown in black (Bold) are calculated fields. Changes to these fields will remove the equations used in the spreadsheet.

**1. The Required Load Reduction for the total project:** Calculations from RG-348 Pages 3-27 to 3-30

Page 3-29 Equation 3.3:  $L_{M} = 27.2(A_{I} \times P)$

where:  $L_{M}$  TOTAL PROJECT = Required TSS removal resulting from the proposed development = 80% of increased load  
 $A_{I}$  = Net increase in impervious area for the project  
 $P$  = Average annual precipitation, inches

Site Data: Determine Required Load Removal Based on the Entire Project

County =	Hays
Total project area included in plan =	290.90 acres
Predevelopment impervious area within the limits of the plan =	4.70 acres
Total post-development impervious area within the limits of the plan =	73.67 acres
Total post-development impervious cover fraction =	0.27
P =	33 inches

$L_{M}$  TOTAL PROJECT = **67295** lbs.

\* The values entered in these fields should be for the total project area.

Number of drainage basins / outfalls areas leaving the plan area = **3**

**2. Drainage Basin Parameters (This information should be provided for each basin):**

Drainage Basin/Outfall Area No. = **A1**

Total drainage basin/outfall area =	156.18 acres
Predevelopment impervious area within drainage basin/outfall area =	3.09 acres
Post-development impervious area within drainage basin/outfall area =	53.91 acres
Post-development impervious fraction within drainage basin/outfall area =	0.35
$L_{M}$ THIS BASIN =	45613 lbs.

**3. Indicate the proposed BMP Code for this basin.**

Proposed BMP = **Wet Basin** percent  
 Removal efficiency = **93** percent

- Aquilogic Cartridge Filter
- Bioretention
- Contech Storm Filter
- Constructed Wetland
- Extended Detention
- Grassy Swale
- Retention / Irrigation
- Sand Filter
- Stormceptor
- Vegetated Filter Strips
- Vortices
- Wet Basin
- Wet Vault

**4. Calculate Maximum TSS Load Removed ( $L_R$ ) for this Drainage Basin by the selected BMP Type.**

RG-348 Page 3-33 Equation 3.7:  $L_R = (BMP \text{ efficiency}) \times P \times (A_1 \times 34.6 + A_2 + A_3 \times 0.54)$

where:

$A_2$ = Total On-Site drainage area in the BMP catchment area	
$A_1$ = Impervious area proposed in the BMP catchment area	
$A_3$ = Pervious area remaining in the BMP catchment area	
$L_R$ = TSS Load removed from this catchment area by the proposed BMP	

$A_2$ =	156.18	acres
$A_1$ =	53.91	acres
$A_3$ =	102.27	acres
$L_R$ =	58937	lbs

0.77392897

**5. Calculate Fraction of Annual Runoff to Treat the drainage basin / outfall area**

Desired $L_{M}$ THIS BASIN =	52700	lbs.
F =	0.88	

**6. Calculate Capture Volume required by the BMP Type for this drainage basin / outfall area.** Calculations from RG-348 Pages 3-34 to 3-36

Rainfall Depth =	1.60	inches
Post Development Runoff Coefficient =	0.28	
On-site Water Quality Volume =	254510	cubic feet

Calculations from RG-348 Pages 3-36 to 3-37

Off-site area draining to BMP =	26.09	acres
Off-site impervious cover draining to BMP =	3.09	acres
Impervious fraction of off-site area =	0.12	
Off-site Runoff Coefficient =	0.14	
Off-site Water Quality Volume =	21351	cubic feet

Storage for Sediment = 55172 cubic feet

Total Capture Volume (required water quality volume(s) x 1.20) = 331033 cubic feet

The following sections are used to calculate the required water quality volume(s) for the selected BMP. The values for BMP Types not selected in cell C45 will show NA.

**11. Wet Basins** Designed as Required in RG-348 Pages 3-66 to 3-71

Required capacity of Permanent Pool =	331033	cubic feet	Permanent Pool Capacity is 1.20 times the WQV
Required capacity at WQV Elevation =	585543	cubic feet	Total Capacity should be the Permanent Pool Capacity plus a second WQV.

**Kimley-Horn**

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**HERITAGE**  
PRELIMINARY PLAN  
CITY OF DRIPPING SPRINGS  
HAYS COUNTY, TEXAS

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OVERALL WATER  
QUALITY PLAN




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SHEET NUMBER  
**24**






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<b>HERITAGE</b> <b>PRELIMINARY PLAN</b> CITY OF DRIPPING SPRINGS HAYS COUNTY, TEXAS	<b>OVERALL STORMSEWER</b> <b>PLAN</b>		KHA PROJECT NO. [Number] DATE: AUGUST 2020 SCALE: AS SHOWN DESIGNED BY: [Name] DRAWN BY: [Name] CHECKED BY: [Name]	08/10/2020 No. [Number] REVISIONS [Table] DATE BY
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Project: Heritage - Dripping Springs, TX 78620 05-05-12-2017  
 Date: 08/10/2020  
 City: Dripping Springs, TX 78620  
 State: TX  
 County: Hays  
 District: 0001  
 Sheet: 27 of 4  
 Title: Stormwater Management Plan  
 Author: Kimley-Horn and Associates, Inc.  
 Designer: Kimley-Horn and Associates, Inc.  
 Checker: Kimley-Horn and Associates, Inc.  
 Date: 08/10/2020  
 Project No.: 18-1791  
 Drawing No.: 18-1791-01  
 Scale: AS SHOWN  
 Design By: AED  
 Drawn By: AED  
 Checked By: AED  
 Project Location: 10814 JULYVILLE ROAD, AVALLON IV, SUITE 200, AUSTIN, TX 78759  
 Phone: 512.835.7700  
 Fax: 512.835.7701  
 Website: WWW.KIMLEY-HORN.COM  
 Texas Registered Engineering Firm F-928

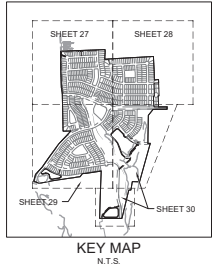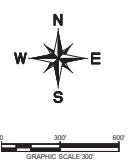
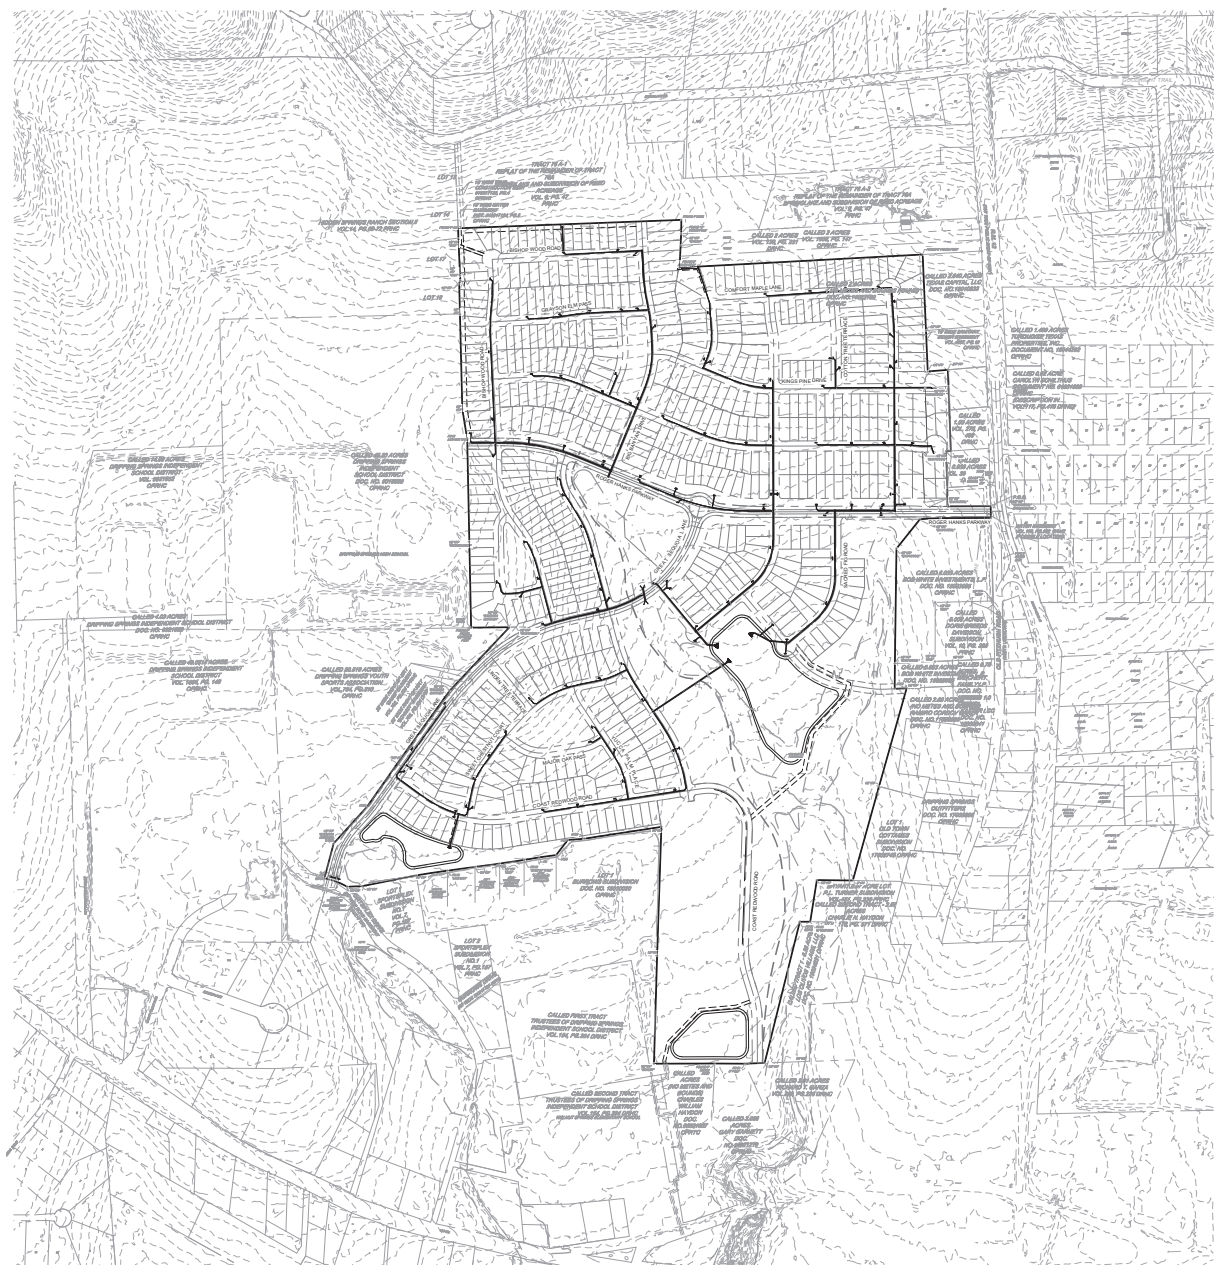


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KHA PROJECT NO.: DATE:	08/10/2020
SCALE: AS SHOWN DESIGNED BY: AED DRAWN BY: AED CHECKED BY: AED	
<b>HERITAGE</b> <b>STORMSEWER PLAN</b> <b>PRELIMINARY PLAN</b> <b>CITY OF DRIPPING SPRINGS</b> <b>HAYS COUNTY, TEXAS</b>	
SHEET NUMBER <b>27</b>	SHEET NUMBER <b>27</b>
REVISIONS No. _____ DATE _____ BY _____	



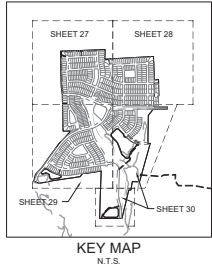

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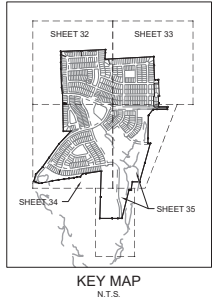
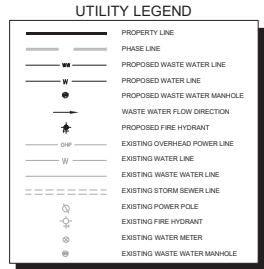
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	<b>STORMSEWER PLAN</b> (SHEET 4 OF 4)
KHA PROJECT NO. 178355 DATE AUGUST 2020 SCALE AS SHOWN DESIGNED BY: JAG DRAWN BY: JRL CHECKED BY: AED	08/10/2020  J. Kimley-Horn & Associates, Inc.
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REVISIONS NO. DATE BY	DATE BY

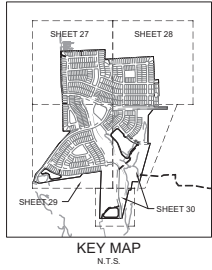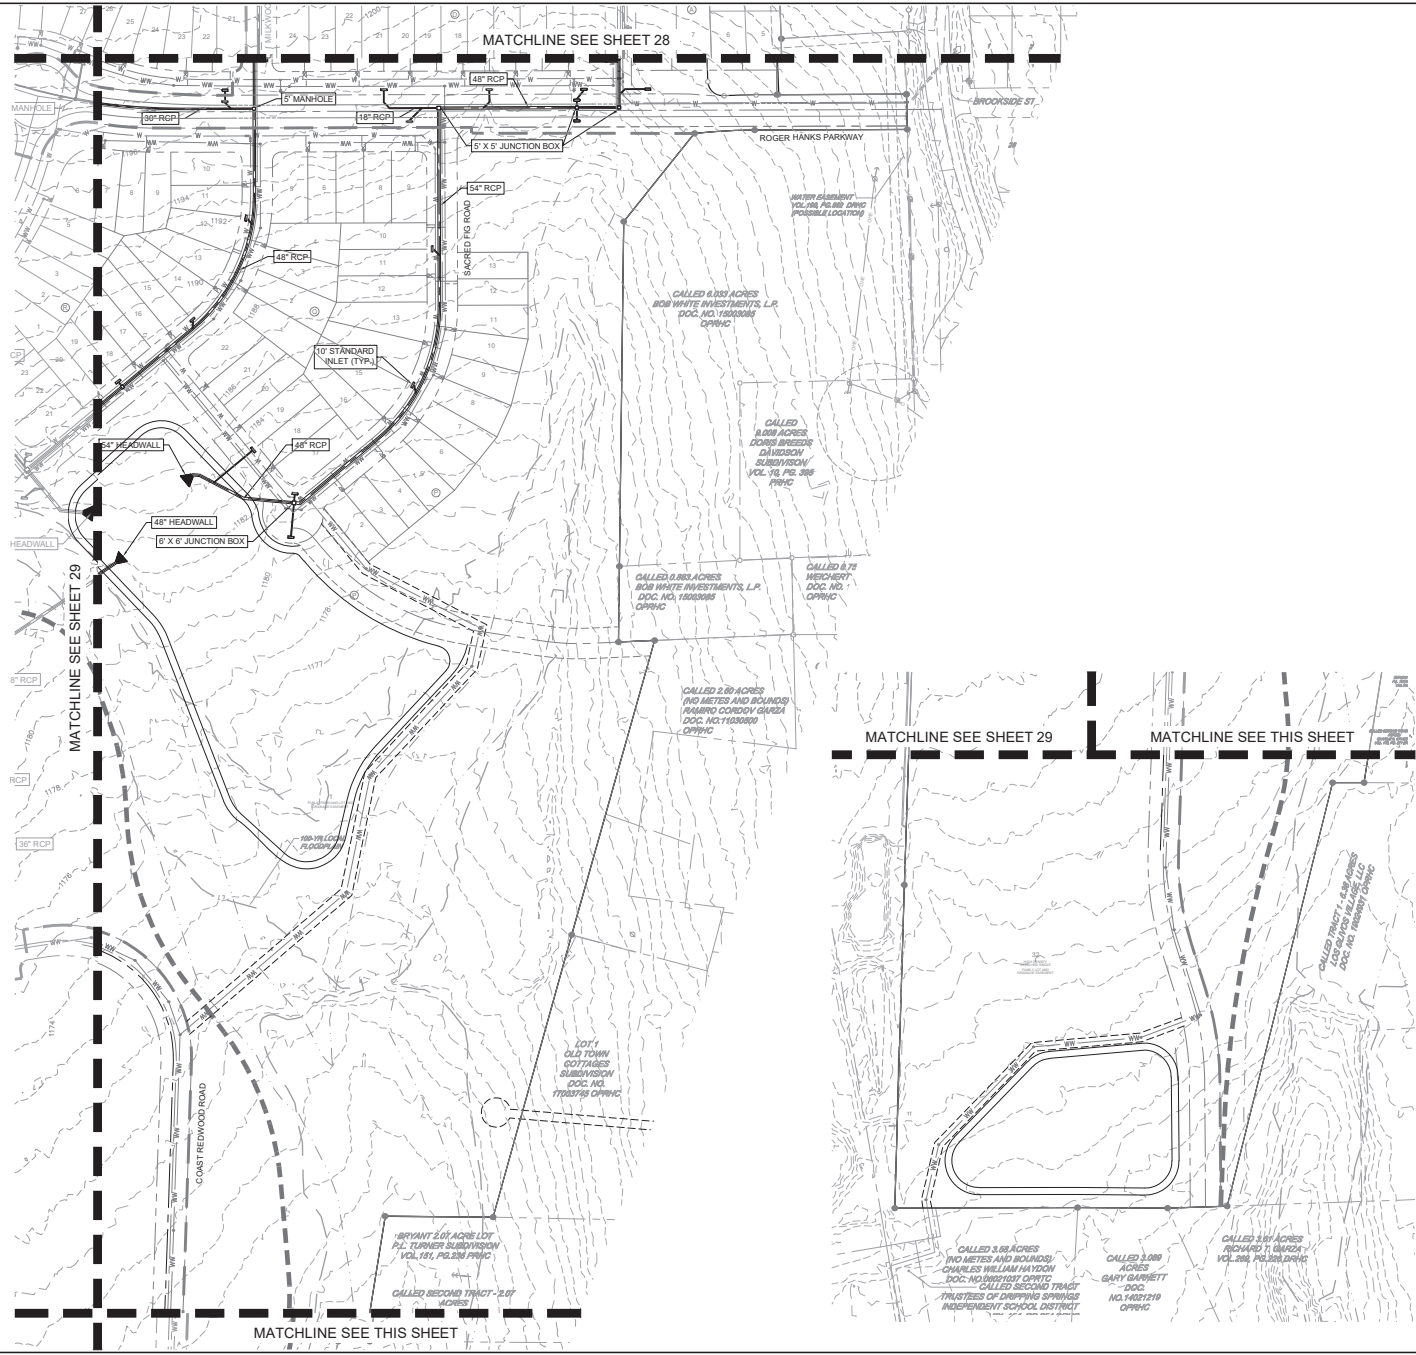






Prepared by: C. G. ...  
 Date: ...  
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<b>HERITAGE</b> <b>WATER &amp; WASTEWATER</b> <b>PRELIMINARY PLAN</b> <b>CITY OF DRIPPING SPRINGS</b> <b>HAYS COUNTY, TEXAS</b>		<b>WATER &amp; WASTEWATER</b> <b>PLAN (SHEET 2 OF 4)</b>					SHEET NUMBER <b>33</b>




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**UTILITY LEGEND**

	PROPERTY LINE
	PHASE LINE
	PROPOSED WASTE WATER LINE
	PROPOSED WATER LINE
	PROPOSED WATER MANHOLE
	WASTE WATER FLOW DIRECTION
	PROPOSED FIRE HYDRANT
	EXISTING OVER-HEAD POWER LINE
	EXISTING WATER LINE
	EXISTING WASTE WATER LINE
	EXISTING STORM SEWER LINE
	EXISTING POWER POLE
	EXISTING FIRE HYDRANT
	EXISTING WATER METER
	EXISTING WASTE WATER MANHOLE



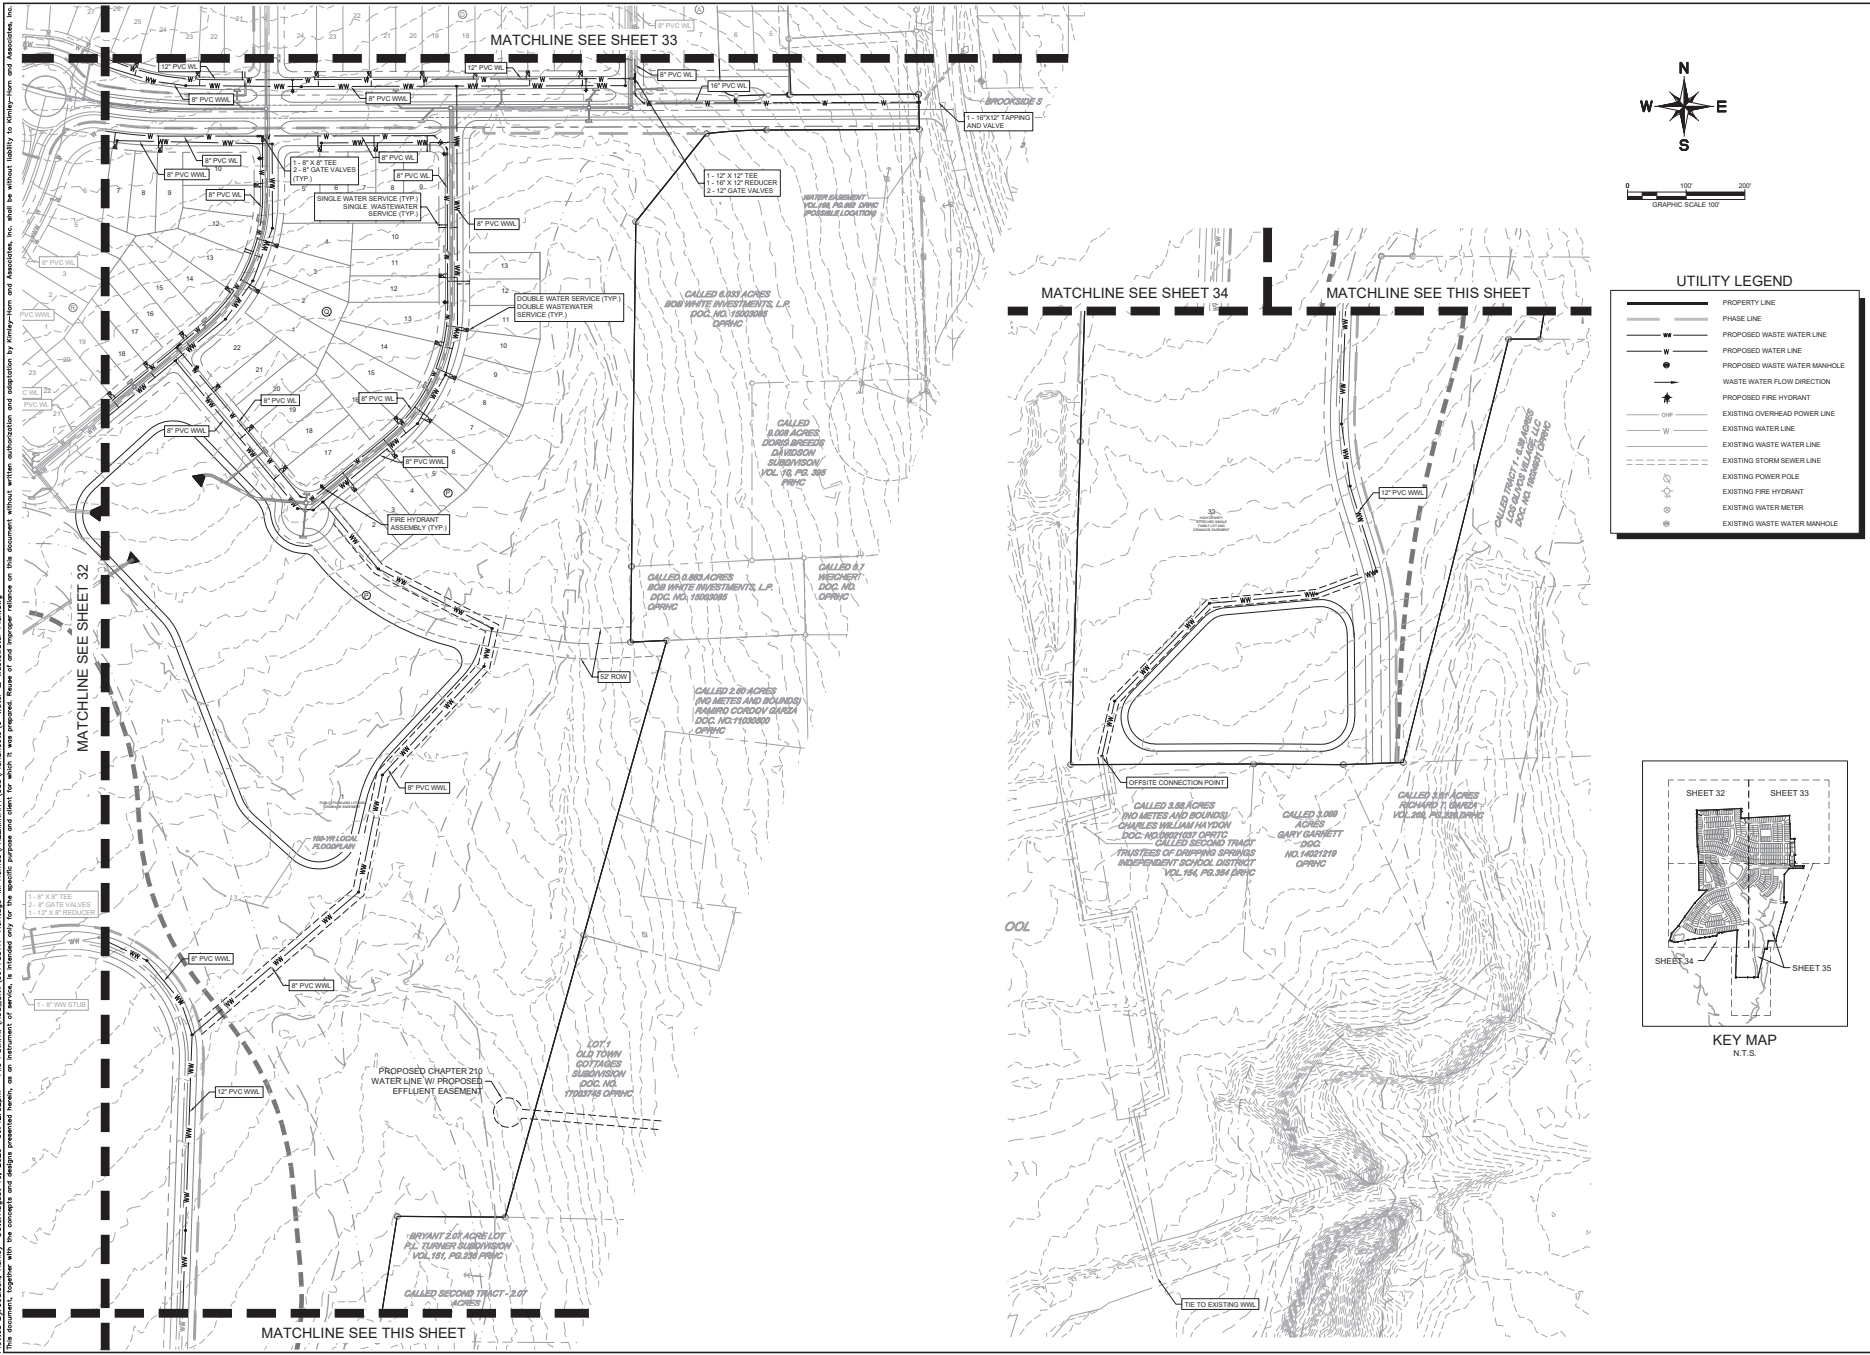


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	08/10/2020 KHA PROJECT NO. 2020-08-001 DATE: AUGUST 2020 SCALE: AS SHOWN DESIGNED BY: AGD DRAWN BY: RRL CHECKED BY: AED						
<b>HERITAGE WATER &amp; WASTEWATER</b>				<b>PLAN (SHEET 4 OF 4)</b>			
<b>HERITAGE</b>				<b>PRELIMINARY PLAN</b>			
CITY OF DRIPPING SPRINGS				HAYS COUNTY, TEXAS			
SHEET NUMBER				35			
		NO. REVISIONS		DATE			

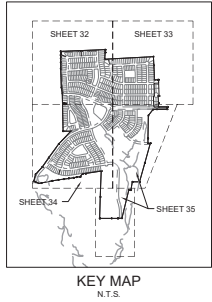



Revised: 08/10/2020; Author: [Redacted]; Date: 08/10/2020; Title: Heritage Plan Preliminary Plan of Dripping Springs, Texas. This drawing is a preliminary plan and is not to be used for construction. It is subject to change without notice. The information shown on this drawing is based on the information provided to the engineer by the client. The engineer is not responsible for the accuracy of the information provided by the client. The engineer is not responsible for the accuracy of the information provided by the client. The engineer is not responsible for the accuracy of the information provided by the client.

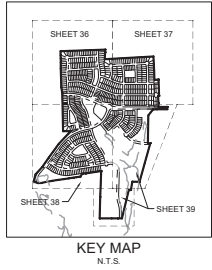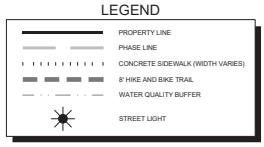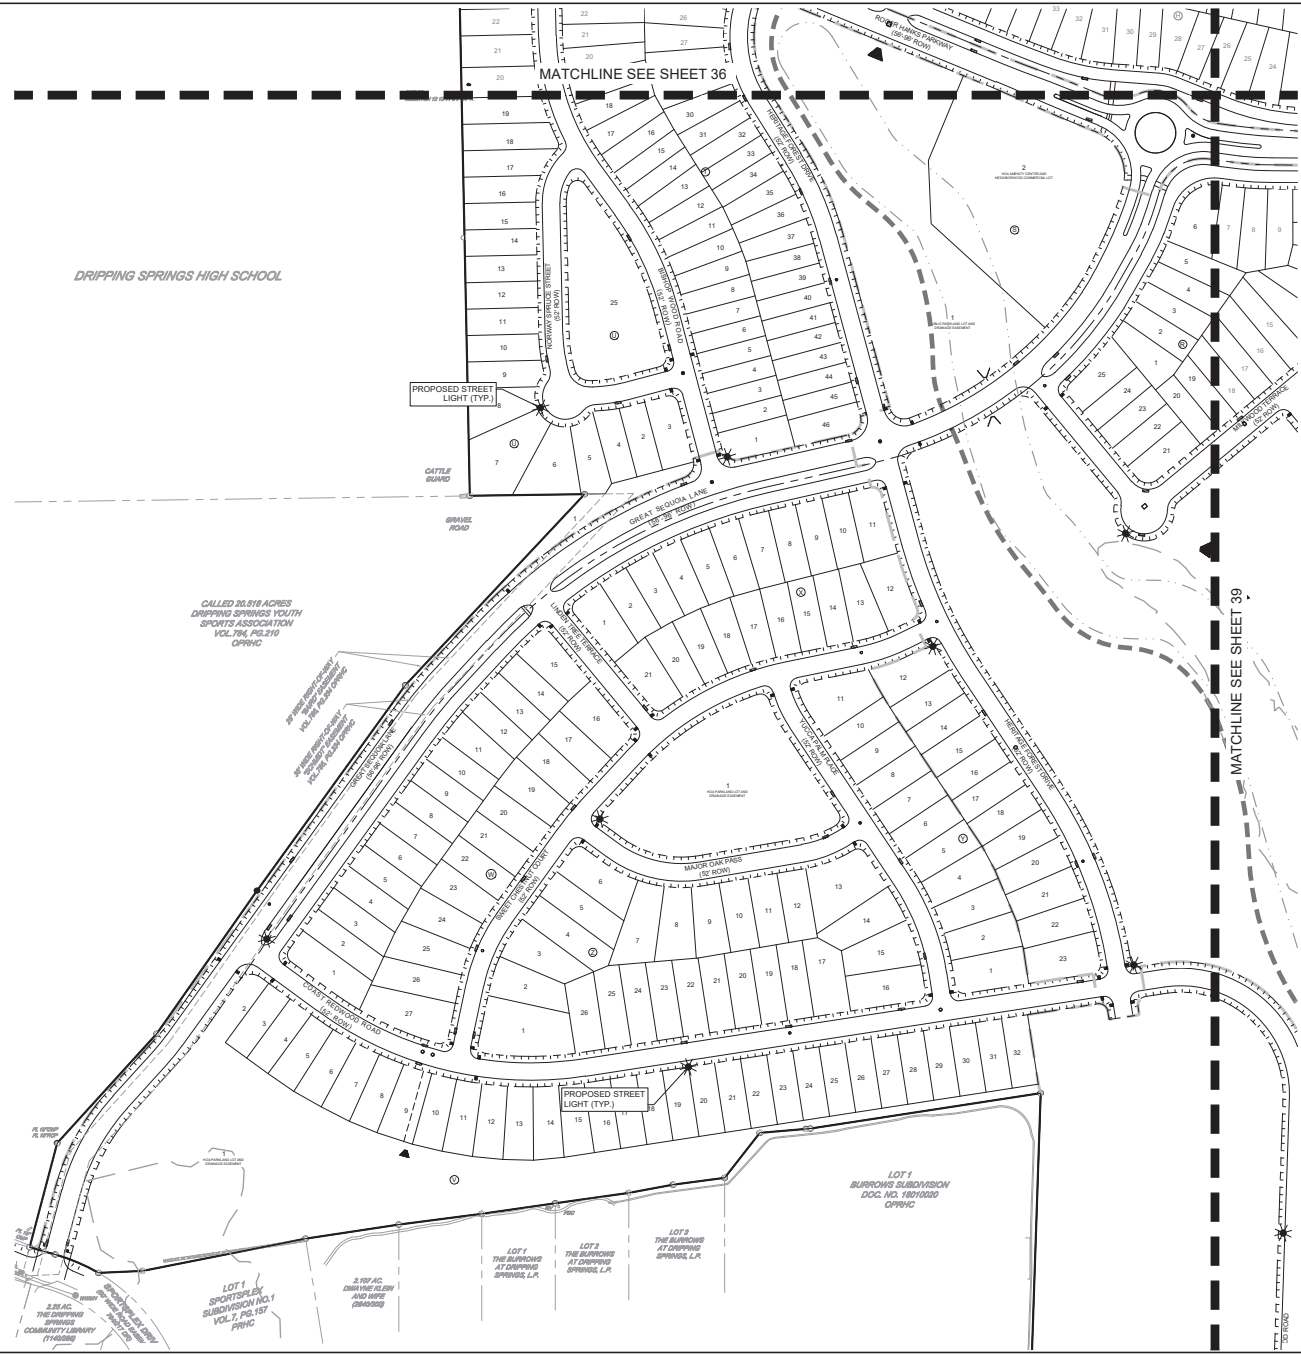

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	08/10/2020  H. Mark S. [Redacted] P.E. KHA PROJECT NO. _____ DATE AUGUST 2020 SCALE AS SHOWN DESIGNED BY: AGD DRAWN BY: RFL CHECKED BY: AED
<b>HERITAGE          PRELIMINARY PLAN          CITY OF DRIPPING SPRINGS          HAYS COUNTY, TEXAS</b>	<b>OVERALL LIGHTING PLAN          (SHEET 3 OF 4)</b>
SHEET NUMBER <b>38</b>	SHEET NUMBER <b>38</b>







