AMK PROPERTIES - DOUGLAS BUILDING

13 South Union Street, Douglas, MI 49406







SOUTHEAST PERSPECTIVE



| DWG NO. | Drawing Title | Issuance | |
|------------|--|-----------------------|----|
| GENER | AL | | |
| G-1 | Title Sheet | Revision | 1 |
| GENER | AL: 1 | | |
| CIVIL | | | |
| C-1 | Survey | Survey Issue | 0 |
| C101 | Grading Plan | Revision | 1 |
| C202 | Utility and Stormwater Management Plan | Revision | 1 |
| L-1 L-2 | Landscape Plan Landscape Details | Revision PC Review | 10 |
| | CAPE: 2 | PC Review | I |
| DEMOL | ITION | | |
| D-1 | Site Demoition Plan | PC Review | 1 |
| | ITION: 1 ECTURAL Site Plan | Revision | 1 |
| A-1.1 | Site Details | Revision | 1 |
| A-2 | First Floor Plan | Revision | 1 |
| A-3 | Second Floor Plan | Revision | 1 |
| A-4 | Exterior Elevations | Revision | 1 |
| A-5 | Exterior Elevations | PC Review | 10 |
| ARCHIT | ECTURAL: 6 | | |
| ELECTE | RICAL | | |
| DII 4 | Site Photometric Plan | PC Review | 1 |
| PH-1 | Site Photometric Plan | LC Keview | |



NORTHEAST PERSPECTIVE



DANIEL Boggs ARCHITECT

ARCHITECTURE & PLANNING

GROSSE ILE, MI 48138 248.882.3642

PROJECT: Douglas Building 13 South Union Street Douglas, MI 49406

PROFESSIONAL SEAL:



ISSUED: 09-04-25 Client Review 09-12-25 Revision 10-03-25 PC Review 10-31-25 Revision

11-05-25 Revision

PROJECT NO:

DRAWN BY:

2025.12

DWB

These drawings have been specifically prepared for AMK Properties for use at 13 South Union Street Douglas, MI 49406

These drawings shall not be used at other locations without the consent and participation of Daniel Boggs Architect.

SHEET TITLE: Title Sheet

SHEET NO:

G-'



TITLE INFORMATION

The Title Description and Schedule B items hereon are from Chicago Title Insurance Company, Commitment No. 031217902RTA Revision 1, Dated October 18, 2023

TITLE DESCRIPTION

Land Situated in the State of Michigan, County of Allegan, City of the Village of Douglas.

Lots 1 and 2 of Dudleyville Plat, except the East half of said Lot 2, according to the Plat thereof recorded in Liber 21 of Deeds on Page 289, Allegan County Records.

SCHEDULE B - SECTION II NOTES

Right(s) of Way and/or Easement(s) and rights incidental thereto, as granted in a document: Granted to: City of the Village of Douglas Recording No: Liber 2945, Page 59. Supporting documents were not provided at time of survey.

SURVEYOR'S NOTES

- 1) Flood Zone Classification: An examination of the National Flood Insurance Program's Flood Insurance Rate Map for Community Number 260549, Panel Number 0164G, with an Effective Date of 6/21/2023, shows this parcel to be located in Zone X (subject to map scale uncertainty).
- 2) Source information from plans and markings has been combined with observed evidence of utilities to develop a view of the underground utilities. However, lacking excavation, the exact location of underground features cannot be accurately, completely, and reliably depicted. In addition, in some jurisdictions, 811 or other similar utility locate requests from surveyors may be ignored or result in an incomplete response. Where additional or more detailed information is required, the client is advised that excavation may be necessary.
- 3) NOTE TO CONTRACTORS: 3 (THREE) WORKING DAYS BEFORE YOU DIG, CALL MISS DIG AT TOLL FREE 1-800-482-7171 FOR UTILITY LOCATIONS ON THE GROUND.

BENCHMARKS


BENCHMARK #336 ELEV. = 620.94 (NAVD88)


Flange bolt under "E" to Hydrant located in southwest corner of Center Street and Union Street, 56'± West of the Easterly asphalt edge of Union Street


BENCHMARK #368 ELEV. = 621.99 (NAVD88)


Set spindle in East side of power pole located 150'± South of the Centerline of Center Street and 14'± West of the Centerline of Union Street


LEGEND

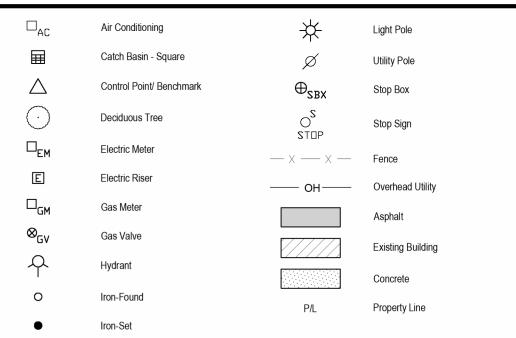

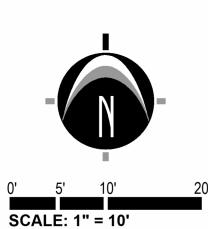

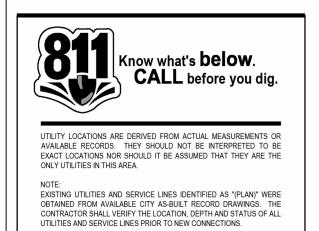

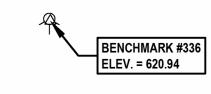

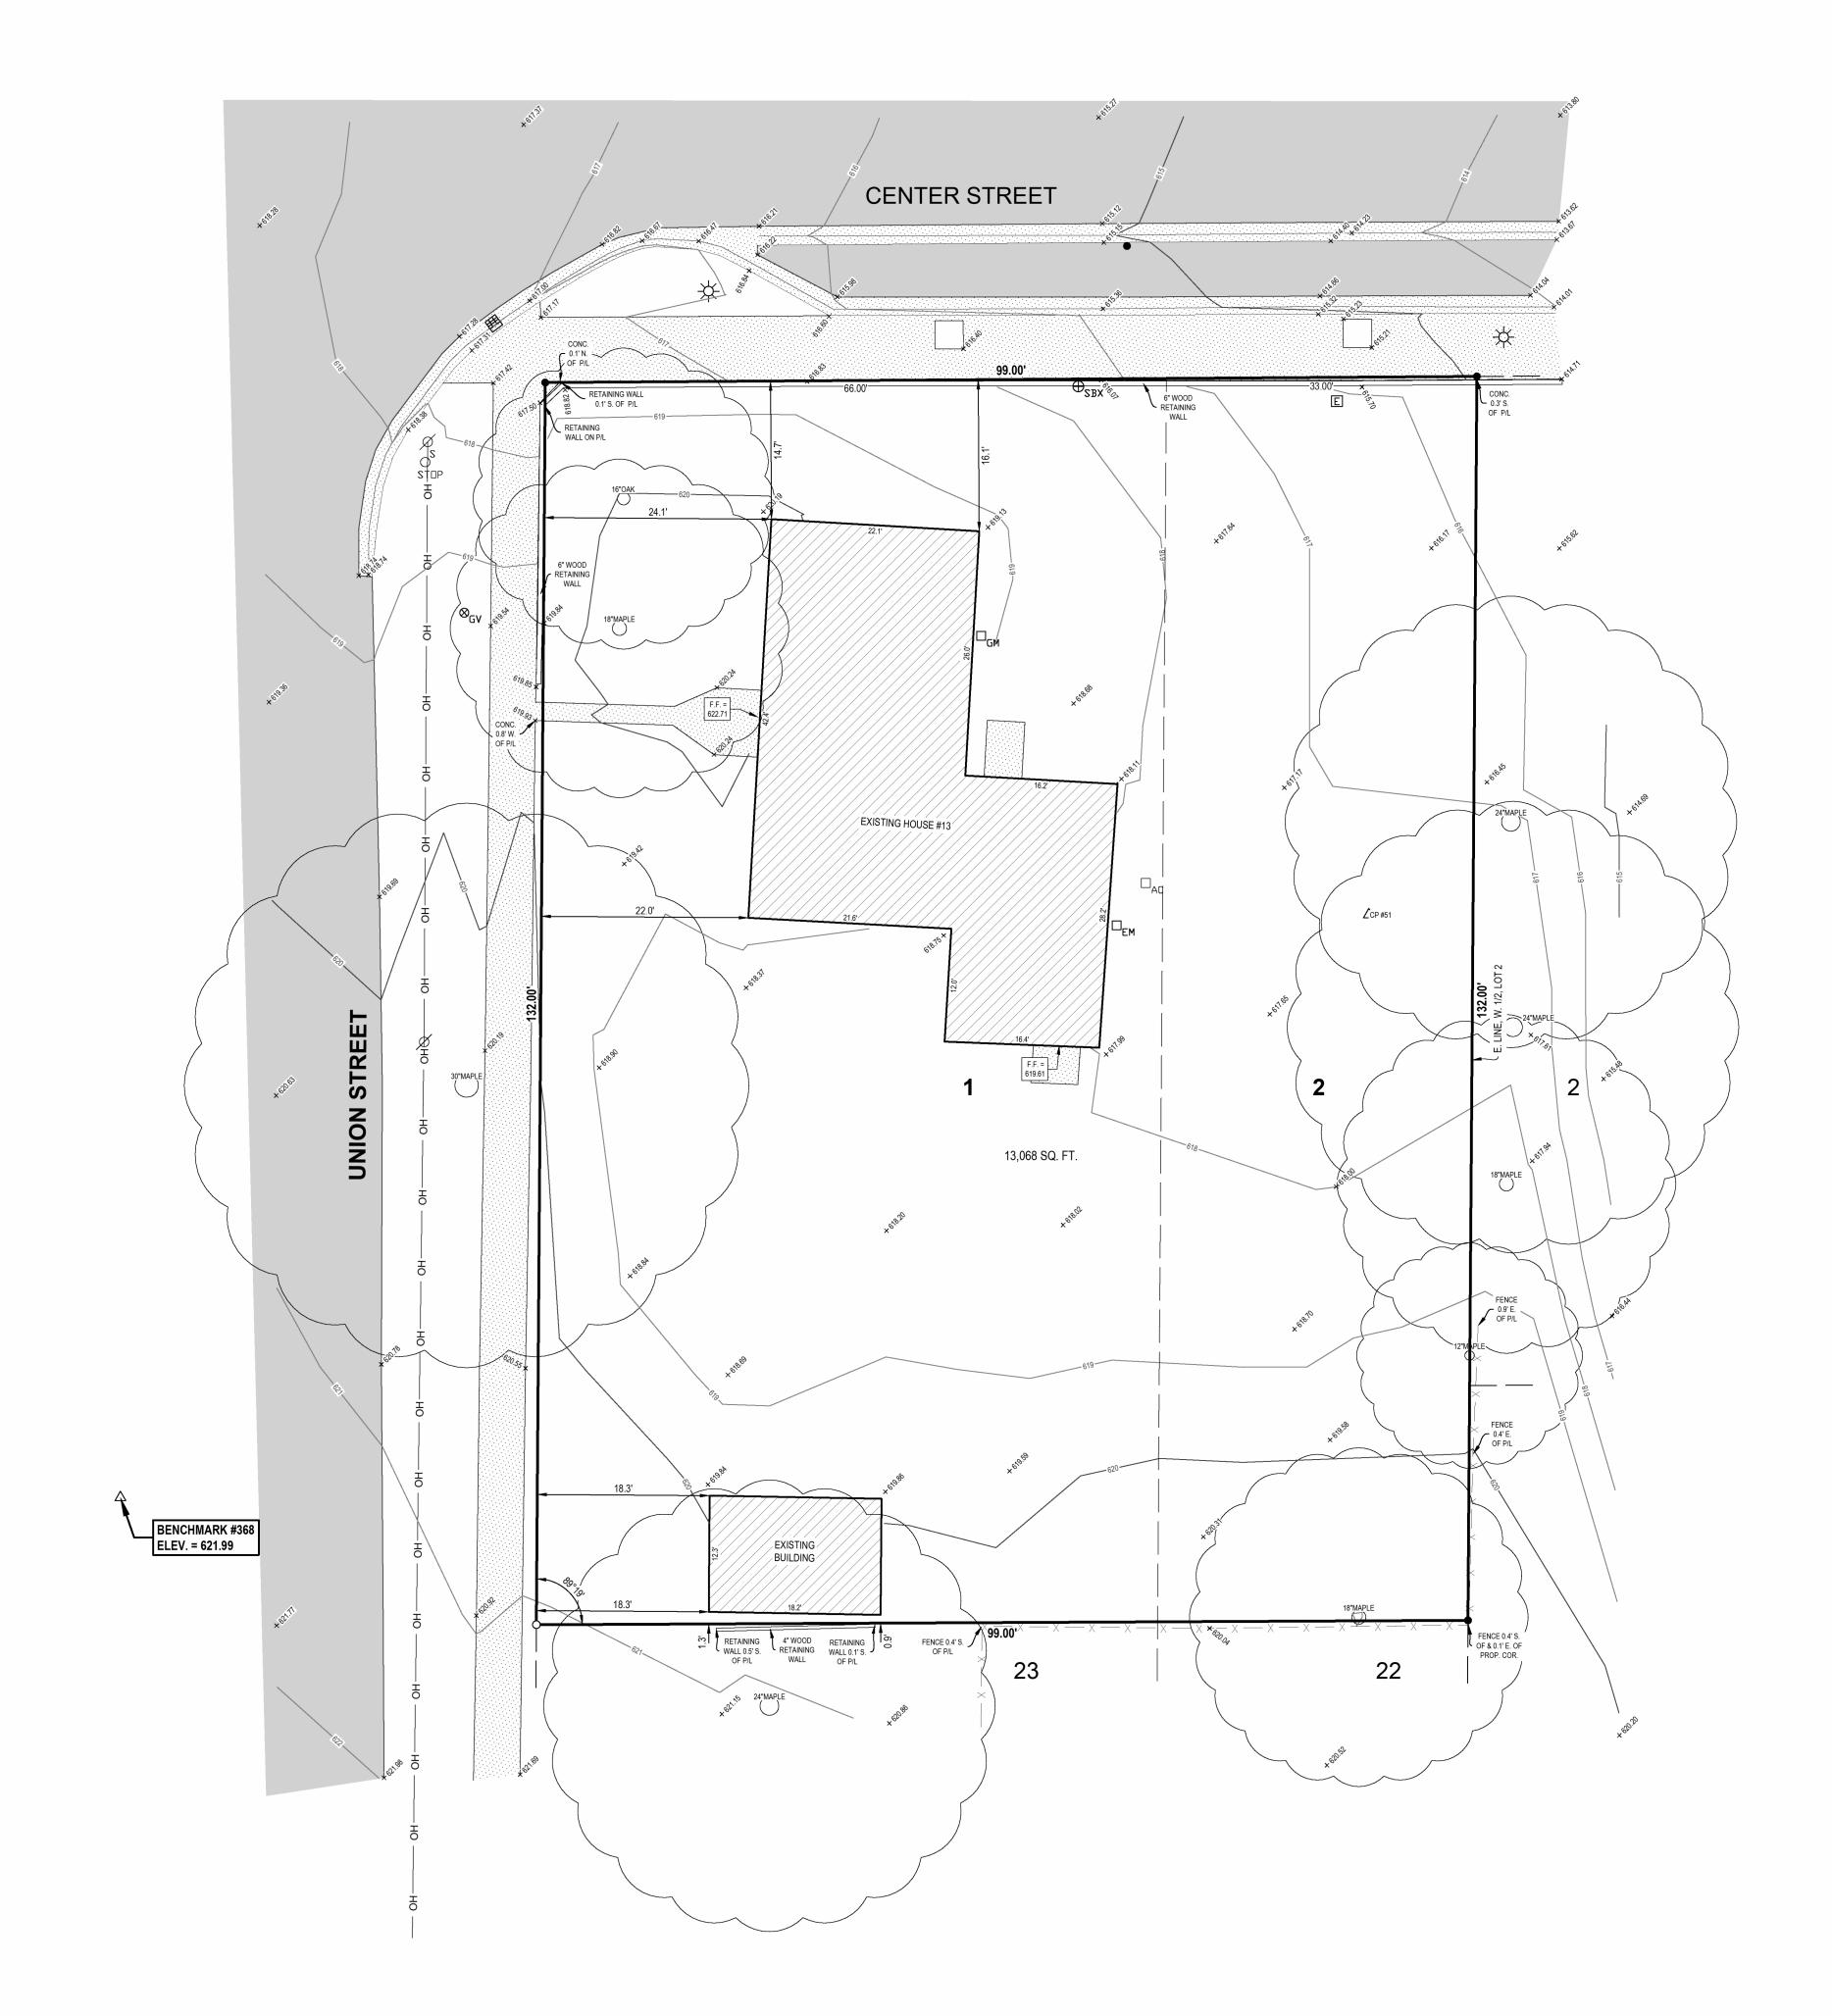



www.nederveld.com 800.222.1868

HOLLAND 347 Hoover Blvd. Holland, MI 49423

Phone: 616.393.0449

ANN ARBOR

CHICAGO

COLUMBUS

GRAND RAPIDS

PREPARED FOR:

Lakewood Construction Inc. Max Nykerk 11253 James Street Holland, MI 49424

INDIANAPOLIS

CREATED:

rawn: DS Date: 3/24/2024

REVISIONS:

n: Date:

OD


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PROJECT NO: 24200315

SHEET NO:

C-1

SHEET: 1 OF 1

BENCH MARKS

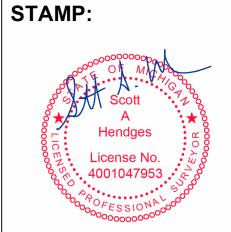BENCH MARK 336 ELEVATION: 620.94 FLANGE BOLT UNDER "E" TO HYDRANT LOCATED IN CORNER OF CENTER STREET AND UNION STREET, 56'+/-WEST OF THE EASTERLY ASPHALT EDGE OF UNION STREET.

BENCH MARK 368 ELEVATION: 621.99 SET SPINDLE IN EAST SIDE OF POWER POLE LOCATED 150'+/- SOUTH OF THE CENTERLINE OF CENTER STREET AND 14'+/- WEST OF THE CENTERLINE OF UNION STREET.

- TOPOGRAPHIC SURVEY WAS COMPLETED BY NEDERVELD IN MARCH 2024 AND REFLECTS CONDITIONS AT THAT TIME. THE SURVEY HAS BEEN SUPPLEMENTED WITH RECORD AND GIS INFORMATION FOR THE CONTRACTOR'S CONVENIENCE. THE CONTRACTOR IS RESPONSIBLE FOR VISITING THE SITE PRIOR TO BIDDING TO CONFIRM EXISTING CONDITIONS AS SHOWN ON THE PLANS. REPORT ALL DISCREPANCIES TO THE ENGINEER.
- 2. THE HORIZONTAL AND VERTICAL INFORMATION PROVIDED IS
- 3. UNDERGROUND UTILITIES ARE SHOWN BASED ON SURFACE MANHOLE AND VALVE LOCATIONS, RECORD DRAWINGS, AND GIS MAPS AND MAY NOT BE ACCURATE. CONTRACTOR SHALL CONTACT MISS DIG PRIOR TO ANY DIGGING. CONTACT ENGINEER IF UTILITIES ARE FOUND IN DIFFERENT CONDITIONS

SYMBOL LEGEND

EXISTING MAJOR CONTOUR EXISTING MINOR CONTOUR PROPOSED MAJOR CONTOUR PROPOSED MINOR CONTOUR LANDING (2% MAX. SLOPE ALL DIRECTIONS) (R) 724.50 XX SPOT ELEVATION EDGE OF METAL EDGE OF WALK FINISH FLOOR GUTTER PAN GRADE ELEVATION HIGH POINT LOW POINT

1. FINISH GRADE OF SOIL EDGES ALONG PAVEMENT TO MATCH

TOP OF PAVEMENT

TOP OF WALL

- 4. ADA PARKING AREAS NOT TO EXCEED 2.0% SLOPE IN ALL
- 5. GRADE AREAS AT SITE PERIMETER TO MATCH GRADES OF
- 6. REMOVE EXCESS SOIL FROM SITE AND DISPOSE OF PROPERLY
- IN ACCORDANCE WITH APPLICABLE REGULATIONS.
- SWALES, SUMPS AND BASINS TO MANAGE INTERIM STORM WATER RUNOFF DURING CONSTRUCTION PROCESS. STORM STATE AND LOCAL QUALITY REQUIREMENTS.

SURVEY NOTES

- BASED ON THE MICHIGAN STATE PLANE COORDINATE SYSTEM (SOUTH ZONE INTERNATIONAL FEET) WITH NAVD88 DATUM,
- THAN SHOWN ON THESE PLANS.

TOP OF CURB

- EDGE OF PAVEMENT.
- 2. STRIP AND STOCKPILE TOPSOIL FROM GRADING AREAS. USE STOCKPILED TOPSOIL AND IMPORTED TOPSOIL AS NECESSARY FOR SURFACE RESTORATION.
- 3. GRADES SHOWN ARE FINAL SURFACE GRADES AFTER COMPLETION OF SURFACE IMPROVEMENTS AND PLACEMENT OF
- DIRECTIONS.
- ADJACENT PARCELS.
- 7. PROVIDE TEMPORARY GRADING FEATURES SUCH AS BERMS, WATER RUNOFF LEAVING THE SITE SHALL MEET ALL FEDERAL,

erti 5 AMK

REVISIONS 1/5/2025 REV REVISION



Building

10/3/2025 PC REVIEW Drawn By SNETZ


Designer BAMCDOWELL Reviewer DRRHOTON Manager BAMCDOWELL

Hard copy is intended to be 24"x36" when plotted. Scale(s) indicated and graphic quality may not be accurate for any other size.

> PROJECT NO. 2501288

SHEET NO.

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4

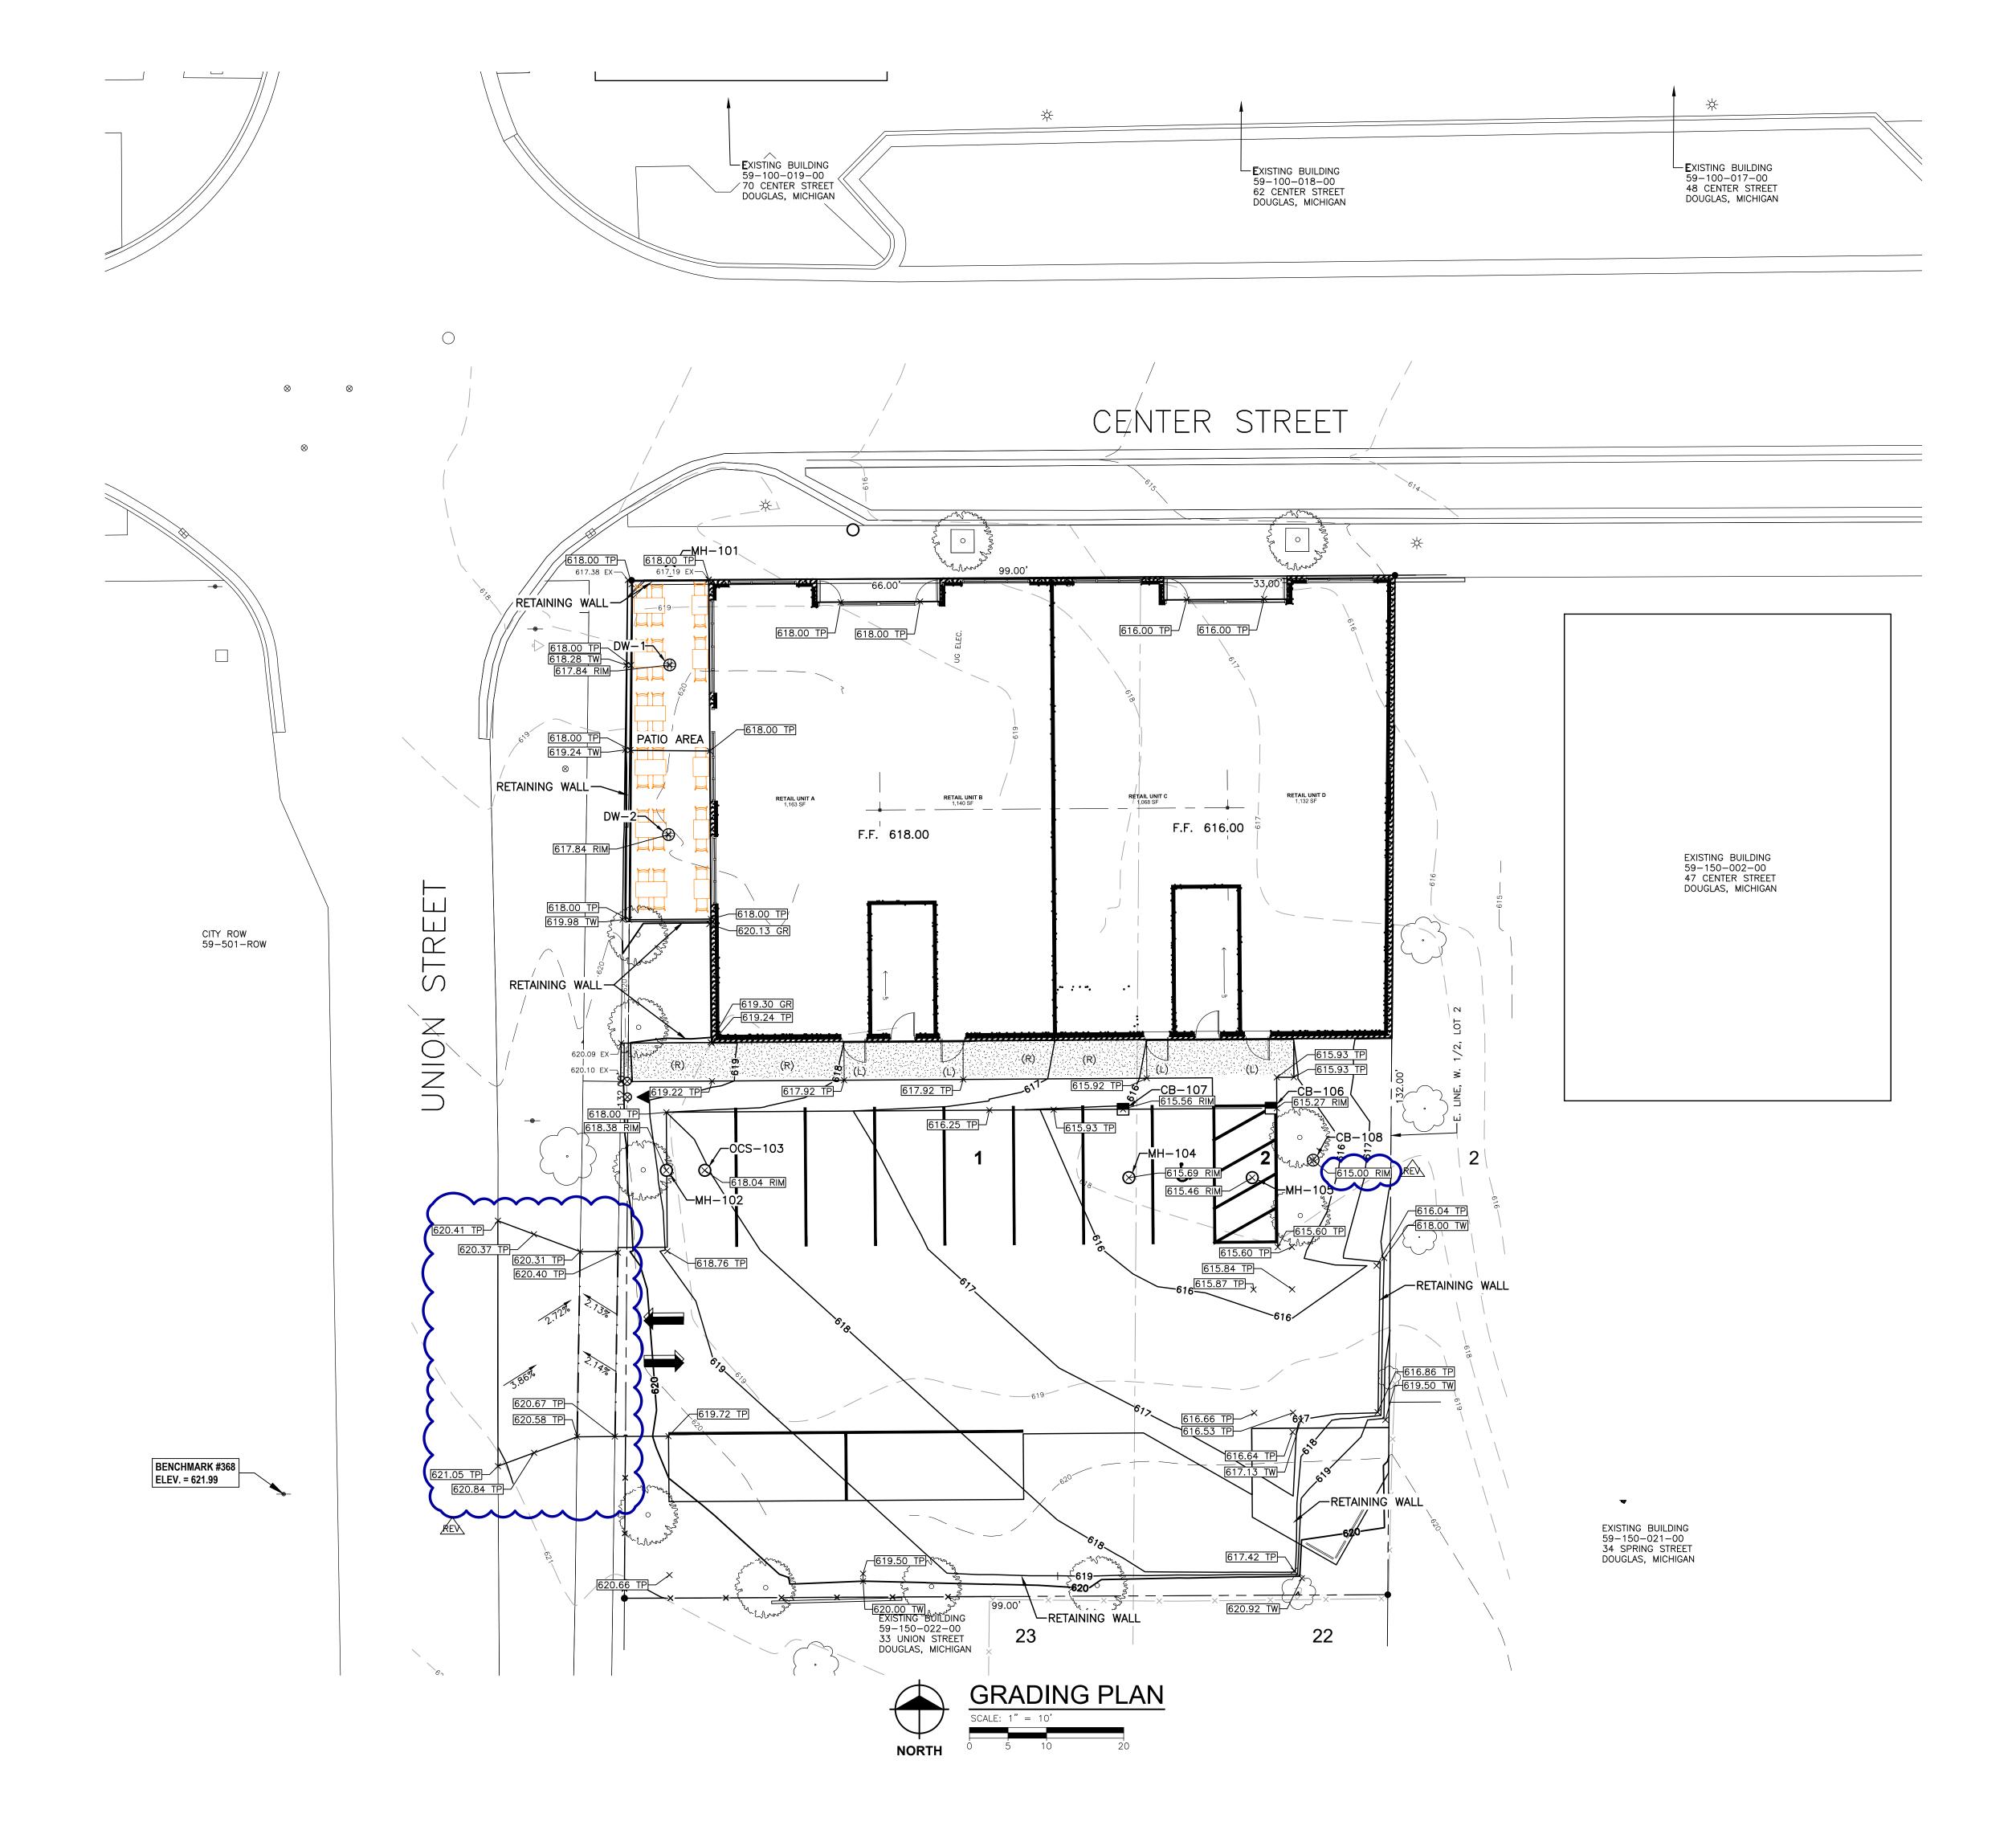10/3/2025 PC REVIEW Drawn By SNETZ Designer BAMCDOWELI DRRHOTON Reviewer

Manager BAMCDOWELL Hard copy is intended to be


24"x36" when plotted. Scale(s) indicated and graphic quality may not be accurate for any other size.

PROJECT NO.

2501288

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BENCH MARKS

UG_ELEC._____

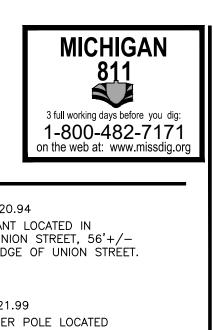48 INCH DIAMETER PRECAST -

100 YR. WS. EL.

CONCRETE RISER SECTION

4'-0"

TOP OF STRUCTURE

EL. 618.03

∕—LOW FLOW 1" DIA.

ORIFICE AT 612.50

-ALL JOINTS WITHIN MANHOLE TO BE

WATERTIGHT.

12" STM.

-SET CASTING IN MORTAR

-

12" STM.

ν D . Δ<mark>Δ</mark>. .

24" DIA.

DRY WELL DETAIL

-12" INV. EL. 612.50

—6−INCH PRECAST BASE SLAB

-2 TO 6 GRADE RINGS

WITH 1/2" PLASTER

COAT INSIDE & OUT

GEOTEXTILE FABRIC

-PRECAST ASTM C478

-PRECAST SECTION WITH 4

ROWS MIN. 1" DIA. HOLES

BOTTOM OF STRUCTURE

─NON-WOVEN

@ 12" O.C.

-INV. VARIES

EL. VARIES

STORMWATER MANAGEMENT SUMMARY

THE DESIGN CRITERIA FOR THE DETENTION SYSTEM IS TO DETAIN

TRANSMITTED TO THE EXISTING STORM SEWER. OWNERSHIP BY

PROPERTY OWNER ON PARCEL. CITY TO OWN STORM IN ROW.

WATER CONVEYANCE SYSTEM UPON EXITING THE SITE IS

POST-DEVELOPED CONDITIONS
DRAINAGE AREA: 13,099 SF = 0.30 AC
RUNGER COEFFICIENT 0.89

REQUIRED DETENTION = 4,311 CFT

PROVIDED DETENTION = 4,359 CFT

FLOODPLAIN MAPS.

WETLAND NOTES

ENVIRONMENTAL NOTES

1. NO KNOWN AREAS OF CONTAMINATION.

MAPPER.

GEOTECHNICAL NOTES

GROUNDWATER ELEVATION: 611.40

AT MINIMUM THE 100-YEAR, 24-HOUR STORM EVENT. THE STORM

SOIL CLASSIFICATION: PRIMARILY LOAMY FINE SAND (27B)

AND FINE SAND (72B) PER WEB SOIL SURVEY

SITE IS NOT LOCATED IN A FLOODPLAIN PER FEMA

1. SITE IS NOT LOCATED IN A WETLAND PER EGLE WETLANDS


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SYMBOL LEGEND




NOTES

- 1. EXISTING UTILITIES LOCATIONS SHOWN ARE APPROXIMATE. VERIFY THE HORIZONTAL AND VERTICAL LOCATION OF EXISTING
- UTILITIES PRIOR TO EXCAVATION WHERE NECESSARY.

INLETS, DURING CONSTRUCTION.

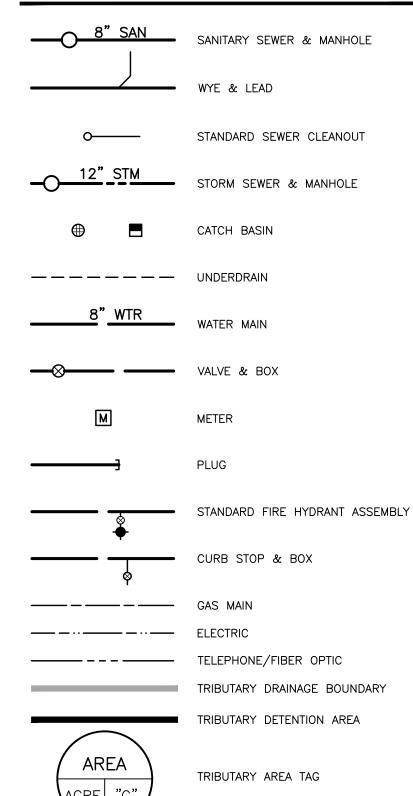- PROTECT AND MAINTAIN SERVICE OF OTHER UTILITIES AT CROSSINGS.
- DO NOT CONNECT ROOF DRAINS, FOUNDATION DRAINS, AND OTHER CLEAN WATER SERVICES TO THE SANITARY SEWER.
- PROVIDE AND MAINTAIN INLET FILTERS AT ALL CATCH BASIN
- WATER MAIN TO HAVE A MINIMUM OF 5.5 FEET OF COVER. FIRE HYDRANTS LOCATED IN CURB ISLAND OR GREEN SPACE SHALL BE LOCATED 5' FROM BACK OF CURB OR EDGE OF
- PROVIDE A MINIMUM OF EIGHTEEN (18) INCHES OF VERTICAL SEPARATION AND TEN (10) FEET OF HORIZONTAL SEPARATION BETWEEN THE WATER MAIN AND ALL SANITARY AND STORM
- FACE NOZZLES OF SITE FIRE HYDRANTS TOWARD BUILDING.
- 10. ADJUST ALL CASTINGS TO FINISH GRADES.
- 11. PIPE LENGTHS ARE TO CENTER OF STRUCTURES UNLESS NOTED OTHERWISE. ALL PIPE LENGTHS ARE FOR THE CONVENIENCE OF THE CONTRACTOR.
- 12. UTILITY ELEVATIONS INDICATED REPRESENT INVERT ELEVATIONS UNLESS OTHERWISE NOTED.

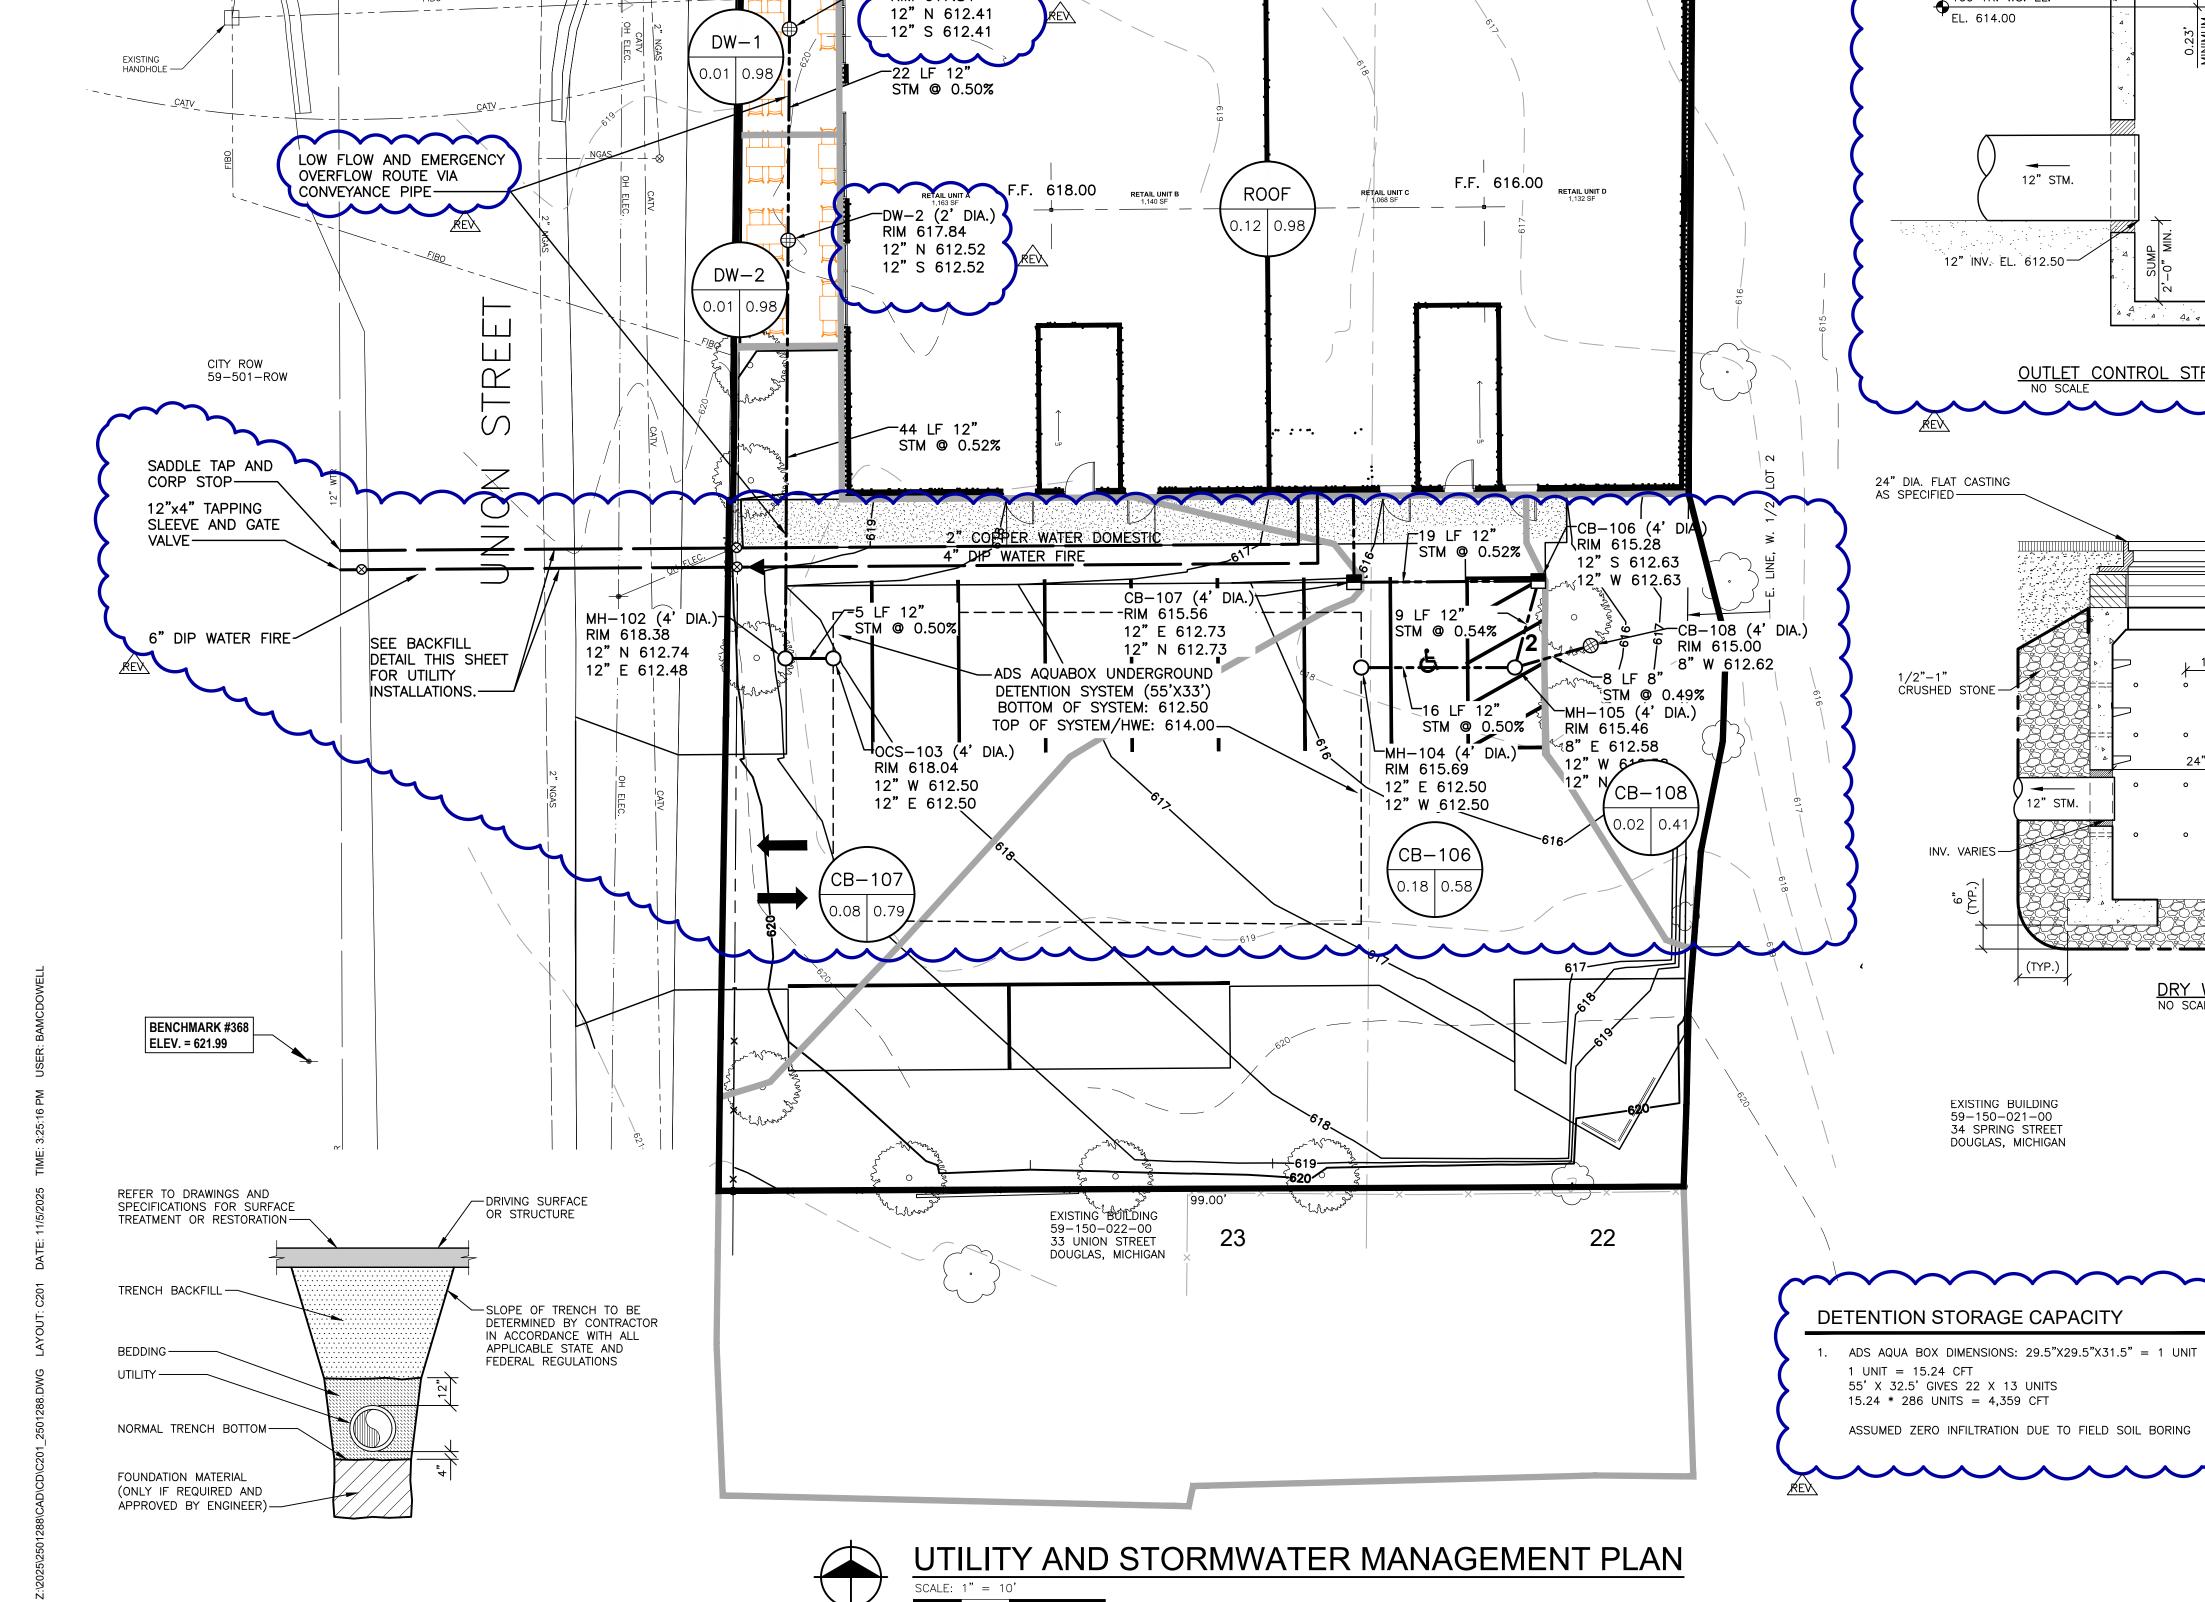

MH-101A (4' DIA.)

CENTER STREET

-CONNECT TO EXISTING

SANITARY LATERAL, FIELD VERIFY.

RIM 618.19

12" W 612.22

12" W 612.22

12" E 612.22

FIELD VERIFY

- INVERT ELEV.

/MH-101 (4' DIA.)

 \sim DW-1 (2' DIA.)

RIM 617.84

ABANDON WATER

SERVICE-

RIM 617.25

12" E 612.34

EX. CB-11 (4' DIA.) RIM=616.99

12" E 613.28

12" W 613.28

__4<u>" NGAS</u> __ _

1 12" STM _ _ _ CATV

TRENCH BELOW DRIVING SURFACE OR STRUCTURE

RIM=618.49

12" E 614.75 12" W 614.75

\ 12"NW 614.75 —

| Туре | Common Name | Miniumum Caliper | Miniumum Height | Miniumum Spread | Root Type |
|------------|------------------------|---------------------|--------------------|--------------------|-----------|
| Small Ever | green Shrubs | - | | 1 | 1 |
| DAS | Dwarf Alberta Spruce | | 36 inches | | BB |
| JY | Japanese Yew | | 24 inches | | BB |
| Small Deci | duous Shrubs | | | | |
| DMQ | Dwarf Japanese Quince | | 24 inches | | BB |
| DWE | Dwarf Winged Euonymous | | 24 inches | | BB |
| Perennials | | | | | • |
| НО | Hosta | | | 15 inches | BB |
| Large Ever | green Shrubs | | | | |
| HY | Hicks Yew | | 24 inches | | BB |
| Large Deci | duous Trees | | | | • |
| PO | Pin Oak | 2-1/2" inches | | | BB |
| SM | Sugar Maple | 2-1/2" inches | | | BB |

LANDSCAPE GENERAL NOTES

1. ALL LANDSCAPE AREAS, ESPECIALLY PARKING LOT ISLANDS AND SHRUB BEDS NEXT TO BUILDING, SHALL BE EXCAVATED OF ALL BUILDING MATERIALS AND POOR SOIL TO A DEPTH OF 12"-18" AND BACK FILLED W/ A GOOD MEDIUM TEXTURED SOIL (LOAM OR LIGHT YELLOW CLAY). ALL LANDSCAPE AREAS TO HAVE 4"-6" OF TOP SOIL AND ARE TO BE CROWNED A MINIMUM OF 6" HIGHER THAN ADJACENT CURBS OF WALKS AFTER EARTH SETTLING.

2. PLANT TREES AND SHRUBS GENERALLY NO CLOSER THAN THE FOLLOWING DISTANCES APART:

A. SHADE TREES: B. SHRUBS LESS THAN 1'-0" HT

& WIDTH AT MATURITY:

C. ORNAMENTAL & EVERGREEN TREES (CRAB, PINE, SPRUCE): 10' O.C.

HATCH INDICATES SITE

HATCH INDICATES PARKING LOT

LANDSCAPING (TYP.)

LANDSCAPING (TYP.)

5 JY

3. DIG SHRUB PITS 1'-0" LARGER THAN THE SHRUB ROOT BALLS. TREE PITS 2'-0" LARGER THAN ROOT BALLS. BACK FILL W/1 PART TOPSOIL - 1 PART SOIL FROM EXCAVATED PLANT HOLE.

4. REMOVE ALL TWINE, WIRE, AND BURLAP FROM TOP OF ALL SHRUB EARTH BALLS AND TREE TRUNKS.

5. LAWN TREES TO BE MULCHED WITH A 2'-0" WIDE BY 3" DEEP MINIMUM SHREDDED BARK RING OR APPROVED ALTERNATE DESIGN FOR TRUNK PROTECTION.

6. ALL LANDSCAPE AREAS TO BE MULCHED WITH 3" OF SHREDDED WOOD MULCH ON

CONTINUOUS WEED-CONTROL BARRIER WITH PLASTIC EDGING AROUND PERIMETER. 7. INSTALLATION OF PLANT MATERIAL SHALL BE IN ACCORDANCE WITH THE AMERICAN

ASSOCIATION OF NURSERYMEN LANDSCAPE STANDARDS.

8. ALL TREES TO STAKED, WRAPPED, AND MULCHED ACCORDING TO THE CITY STANDARDS.

9. ALL ERICACIOUS PLANT MATERIAL AND OTHER ACID LOVING PLANTS SHALL BE PLANTED IN PLANTING MIX OF 1 PART TOPSOIL - 1 PART PEAT.

10. ALL LAWN AREAS TO BE FINE GRADED AND TOP DRESSED WITH 3" OF TOPSOIL BEFORE SODDING.

11. ALL QUANTITIES ON PLANS HAVE BEEN FIGURED AS CLOSELY AS POSSIBLE. IT REMAINS THE RESPONSIBILITY OF THE LANDSCAPE CONTRACTOR TO COMPLETE THE PROJECT AS INDICATED ON THE DRAWINGS.

12. ALL GROUND COVER BEDS SHALL RECEIVE 3" OF PLANT MIX (1/3 TOPSOIL, 1/3 SAND, 1/3 PEAT) ROTOTILLED INTO THE UPPER 6" OF SOIL, MULCH WITH 2" OF MICHIGAN PEAT MULCH.

13. ALL NEW PLANT BEDS AND LAWN AREAS TO BE IRRIGATED UNLESS INDICATED OTHERWISE. EXISTING PLANT BEDS AND LAWN AREAS TO BE IRRIGATED IF INDICATED. CONTRACTOR TO PROVIDE A DESIGN/BUILD IN-GROUND AUTOMATIC IRRIGATION SYSTEM.

CITY LANDSCAPE REQUIREMENTS CITY OF DOUGLAS ZONING ORDINANCE

SECTION 19.05 SITE DEVELOPMENT REQUIREMENTS

(8) SCREENING: 1 TREE PER 20 FEET OF PARKING AREA 99 FEET OF PARKING /20 = 4 TREES (B) 5 FOOT LANDSCAPE STRIP WITH EVERGREEN HEDGE PLANTINGS AND STREET TREES.

SECTION 21.01 LANDSCAPING, FENCING, WALLS, AND **SCREENING**

(4) PARKING LOT LANDSCAPING:

(A) 1 TREE FOR EVERY 8 PARKING SPACES WITH 50 SQUARE FEET OF LANDSCAPED SPACE. (B) 51% OF LANDSCAPED AREAS SHALL BE DEEP-ROOTED PERENNIALS AS APPOSE TO SOD. (C) PROVIDE CLEARLY MARKED PEDESTRIAN

17 SPACES/8 = 2.125 x 8 = 2 TREES 17 SPACES/8 = 2.125 x 50 = 106 SF SPACE 0.51 x 106 = 54 SF PERENNIALS

(5) SITE LANDSCAPING: (A) 10% OF SITE AREA SHALL BE LANDSCAPED.

AISLEWAY FROM PARKING.

13,076 x 10% = 1,307.6 SF REQ'D. (15% ACTUAL)

(C) LANDSCAPING ALONG PUBLIC RIGHT OF WAY SHALL INCLUDE 1 TREE EVERY 30 FEET.

CENTER STREET 99' / 30 = 3 TREES UNION STREET 132' / 30 = 4 TREES

| andscaping Area | | | | | | | | |
|------------------------|--------|--|--|--|--|--|--|--|
| уре | Area | | | | | | | |
| arking Lot Landscaping | 203 SF | | | | | | | |
| | | | | | | | | |

| Area |
|----------|
| 203 SF |
| 1,928 SF |
| 2,130 SF |
| |



ARCHITECT

ARCHITECTURE PLANNING

8538 ISLAND BLVD. GROSSE ILE, MI 48138 248.882.3642

PROJECT:

Douglas Building 13 South Union Street Douglas, MI 49406

PROFESSIONAL SEAL:



PRELIMINARY NOT FOR CONSTRUCTION ISSUED:

10-03-25 PC Review 10-31-25 Revision 11-05-25 Revision

PROJECT NO:

DRAWN BY:

2025.12

Author

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SHEET TITLE: Landscape Plan

SHEET NO:

LANDSCAPE PLAN

SM

JY

SM

13 SOUTH UNION

STREET

13,076 SF

3 DWE DAS 3 DWE

12 HO

РО

JY

SM | JY |

DMQ JY

DAS

L-1 SCALE: 1" = 10'-0"

3 DMQ

SHADE INDICATES NEW

LANDSCAPE SCREENING

LANDSCAPE SCREENING

FOR PARKING AREA

SHADE INDICATES NEW

LAWN AREA

FOR PARKING AREA

4 JY


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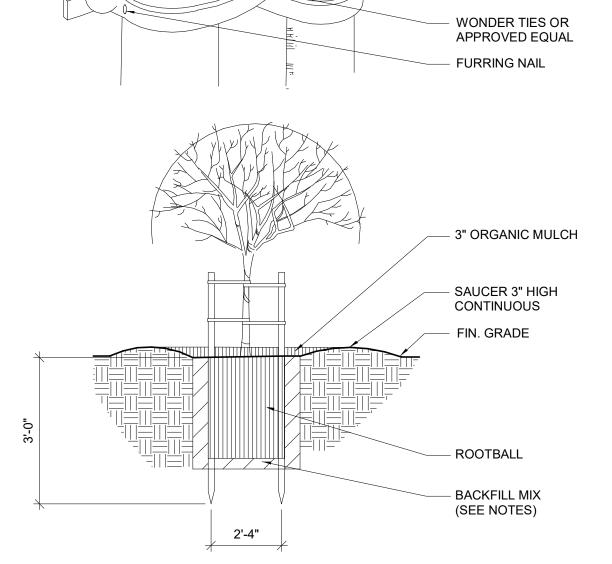
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6 HY


LAWN AREA






TREES - GUYING

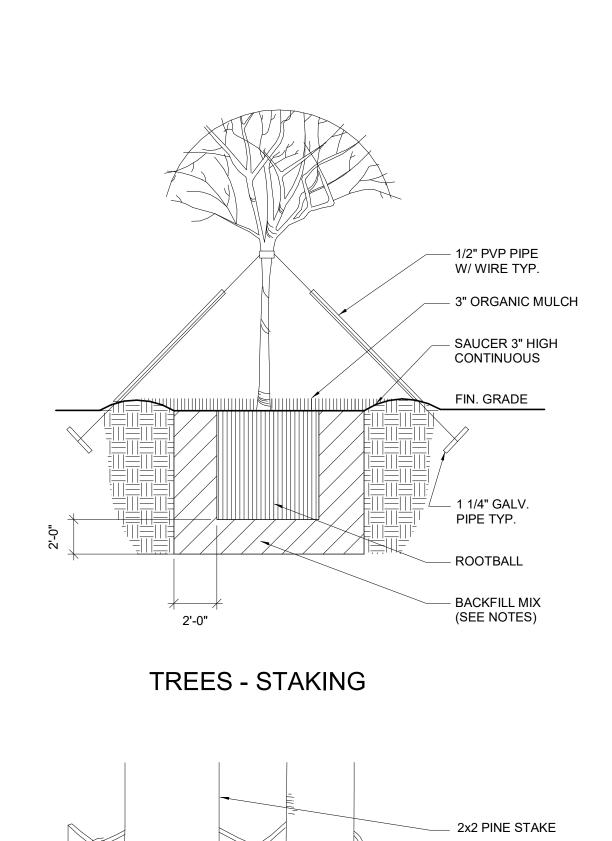

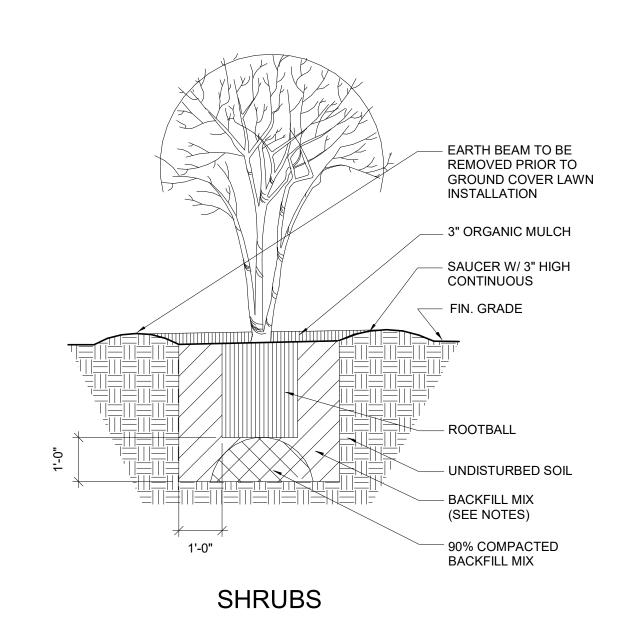

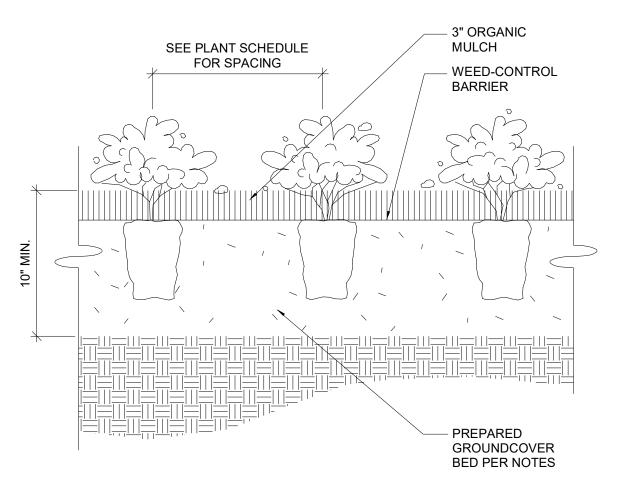

GROUND COVER PLANTING

DANIEL
BOGGS
ARCHITECT


ARCHITECTURE & PLANNING

8538 ISLAND BLVD. GROSSE ILE, MI 48138 248.882.3642

Douglas Building

13 South Union Street
Douglas, MI 49406

PROFESSIONAL SEAL:

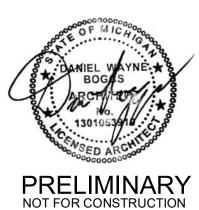

NOT FOR CONSTRUCTION

ISSUED:

10-03-25 PC Review

PROJECT NO: 2025.12

DRAWN BY:

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SHEET TITLE:

Landscape Details

SHEET NO:

L-2

1 SITE DEMOLITION PLAN
D-1 SCALE: 1" = 10'-0"


DANIEL
BOGGS
ARCHITECT

ARCHITECTURE & PLANNING

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Douglas Building
13 South Union Street
Douglas, MI 49406

PROFESSIONAL SEAL:

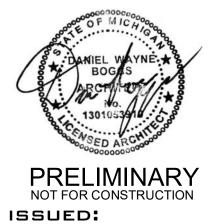

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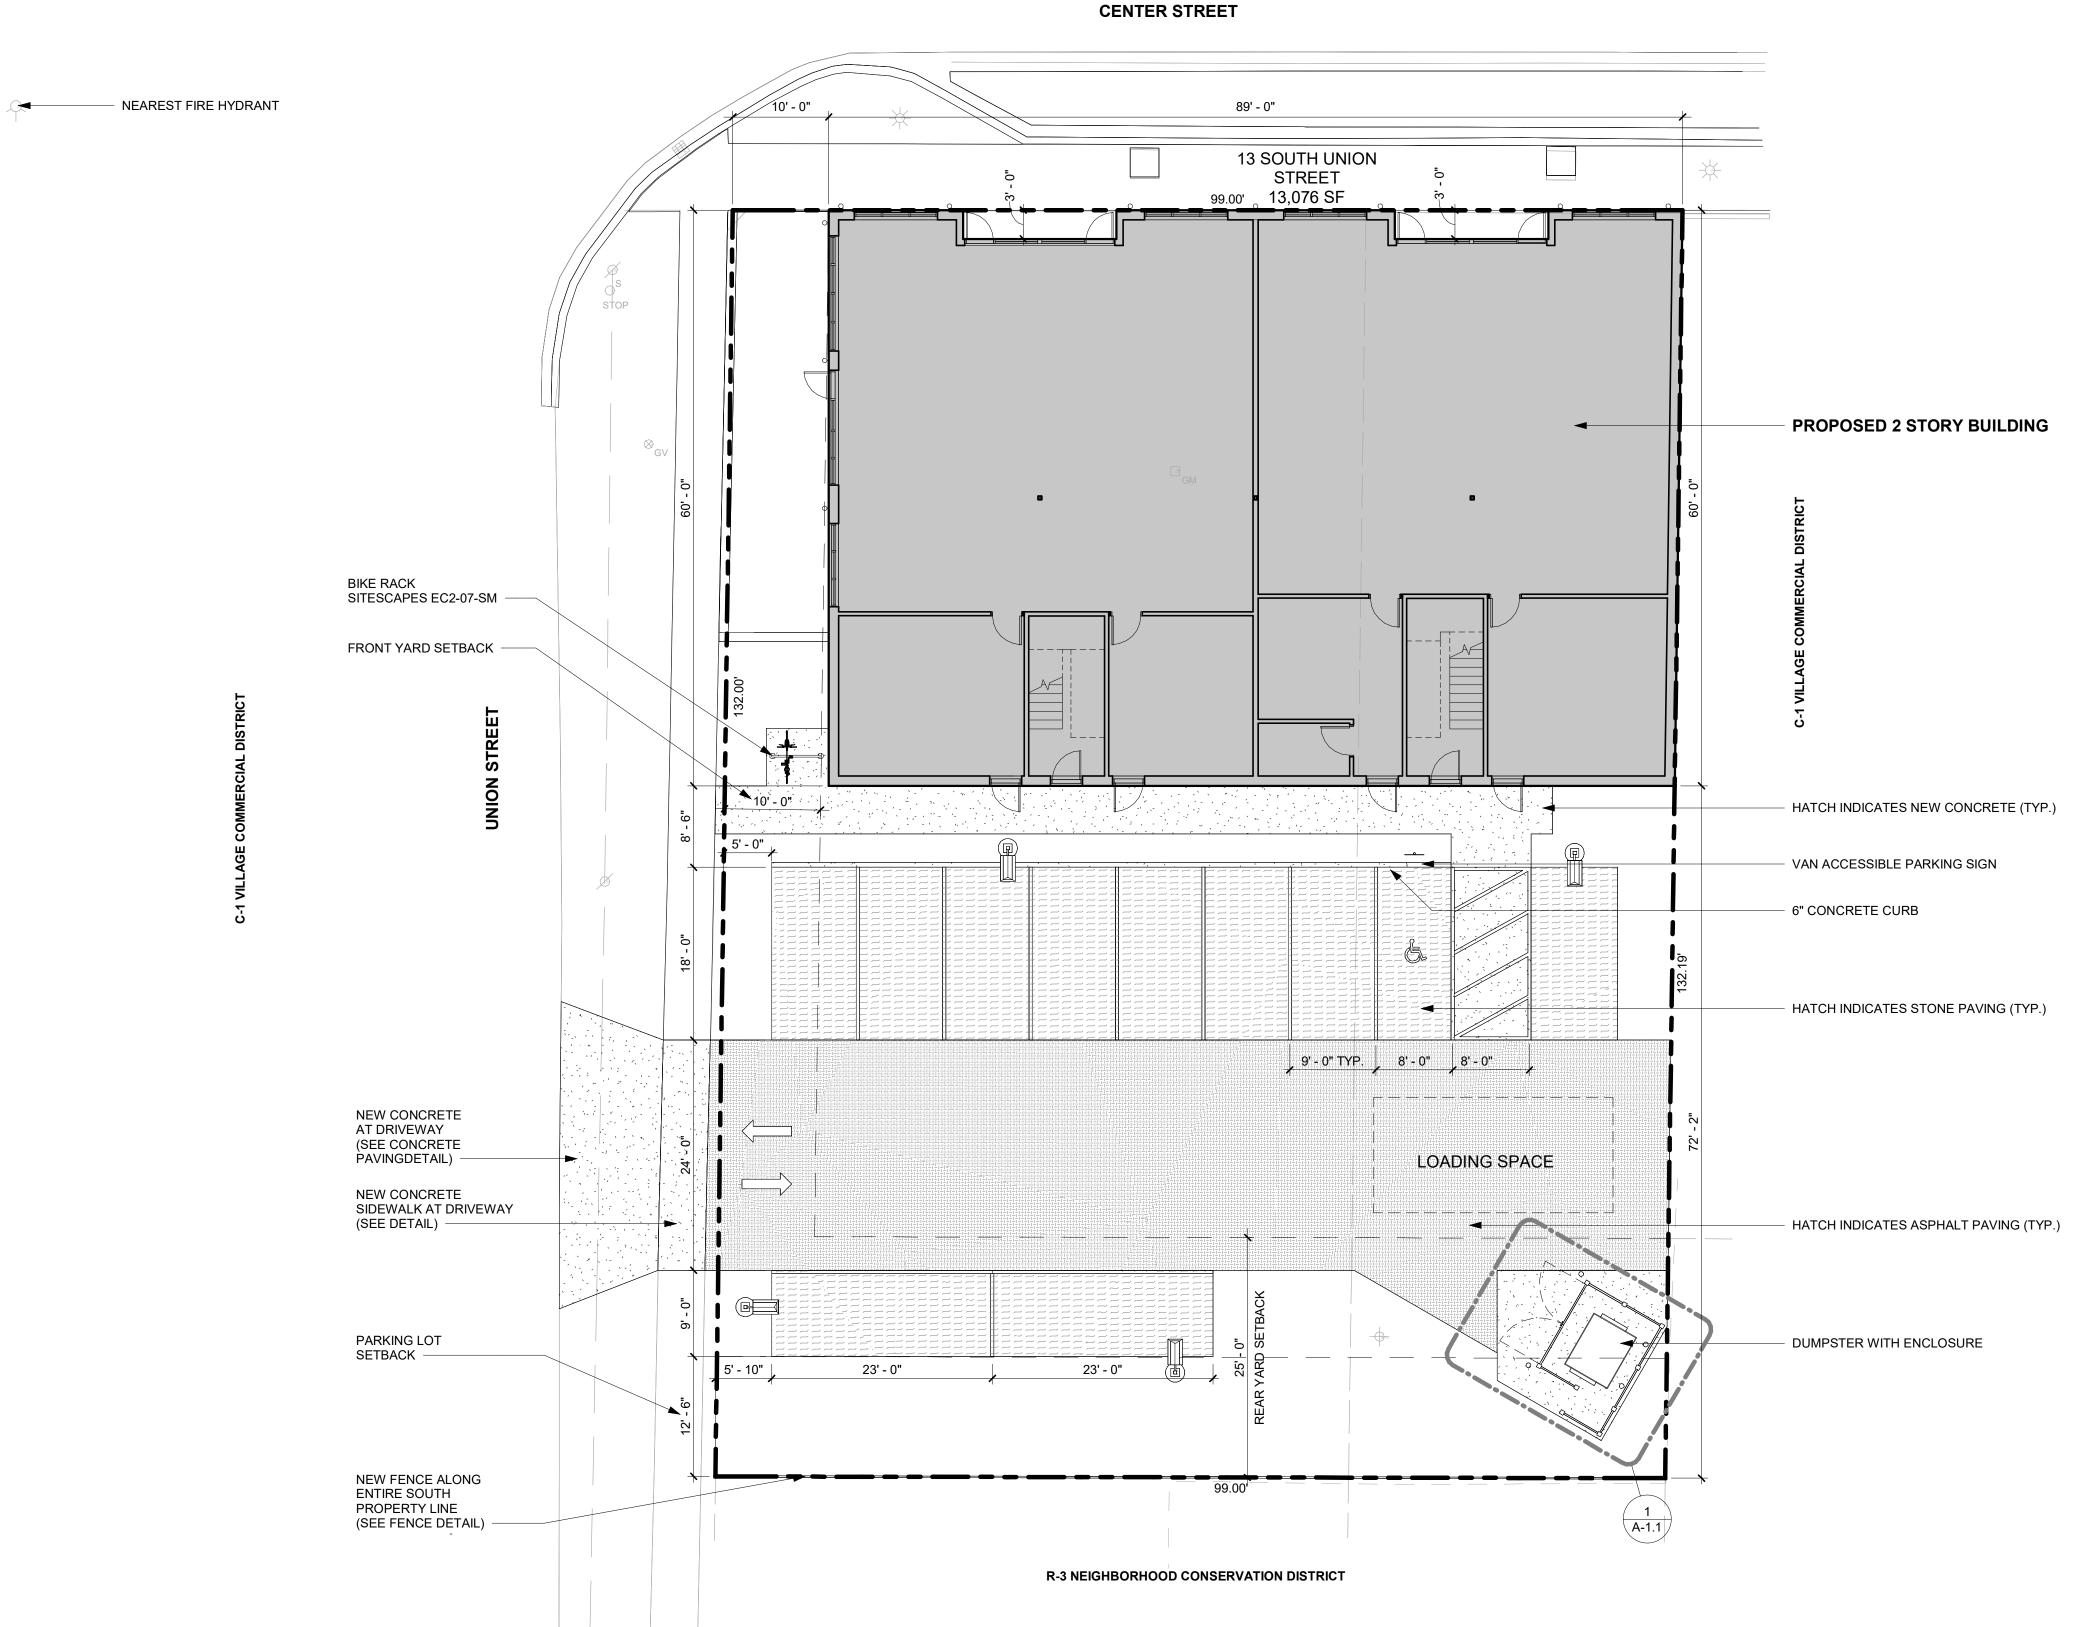
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SHEET TITLE:
Site Demoition
Plan

SHEET NO:



C-1 VILLAGE COMMERCIAL DISTRICT



CITY ORDINANCE REVIEW CITY OF DOUGLAS ZONING ORDINANCE

FLOOR AREA RATIO: 9,498/13,076 = 73%

ESTIMATED COMPLETION DATE: NOVEMBER 1, 2026 ARTICLE 10: C-1 VILLAGE CENTER DISTRICT

SECTION 10.02 - DISTRICT SUMMARY

MINIMUM LOT AREA:

A. PERMITTED USES RESIDENTIAL ABOVE RETAIL OR OFFICE

RETAIL BUSINESS OR RETAIL SALES

C. SITE AND BUILDING PLACEMENT STANDARDS

4,000 SF (13,076 ACTUAL) MINIMUM LOT FRONTAGE: 20 FT

(99 FT CENTER STREET) (132 FT UNION STREET)

MAXIMUM LOT COVERAGE: 80% (40% ACTUAL)

MINIMUM SETBACKS:

FRONT: EAST SIDE:

0 FT (0 FT ACTUAL) 5 FT OR ON LOT LINE (0 FT ACTUAL) 10 FT CORNER LOT WEST SIDE: (10 FT ACTUAL) 25 FT ABUTS RESIDENTIAL

(72 FT ACTUAL)

D. BUILDING FORM STANDARDS

MAXIMUM PRINCIPAL 28 FT (28 FT ACTUAL) BUILDING HEIGHT:

MAXIMUM NUMBER OF STORIES: 2 STORIES (2 ACTUAL)

ROOF PITCH: FLAT WITH PARAPET

OR 6:12 TO 12:12 (FLAT WITH PARAPET)

MINIMUM TRANSPARENCY GROUND FLOOR: 60% (100% ACTUAL)

UPPER STORIES: 30% (100% ACTUAL)

FIRST FLOOR USE: NON-RESIDENTIAL

RESIDENTIAL ACCESS: SEPARATE FROM COMMERCIAL ENTRY

3 FEET TO 5 FEET RECESS ENTRY:

(3 FT ACTUAL)

BUILDING MATERIALS PROVIDED STRUCTURAL

STEEL, MASONRY, WOOD COMPONENTS:

BUILDING FACADES BRICK, STONE, FIBER CEMENT SIDING

SECTION 10.03 - PERFORMANCE STANDARDS

(D) SCREENING AT LEAST 6 FEET IN HEIGHT SHALL BE PROVIDED TO PREVENT HEADLIGHT GLARE FROM SHINING ONTO ADJACENT RESIDENTIAL PROPERTY.

SECTION 10.04 - OFF STREET PARKING AND LOADING

(B) C-1 DISTRICT PARKING REQUIREMENTS (1) SHALL BE 50% OF PARKING REQUIRED BY

SECTION 19.03. ARTICLE 19: OFF STREET PARKING AND LOADING

SECTION 19.03 PARKING SPACE REQUIREMENTS

(2) MULTIPLE DWELLINGS: 2 SPACES FOR EACH DWELLING UNIT AND 1 SPACE FOR EACH 3 DWELLING UNITS FOR GUEST PARKING. 1 PARKING

2 DWELLING UNITS x 2 SPACES = 4 SPACES 2 DWELLING UNITS < 900 SF x 1 SPACE = 2 SPACES 1 GUEST SPACE PER 3 DWELLING UNITS = 1 SPACE

TOTAL SPACES REQUIRED (38) RETAIL STORES: 1 SPACE FOR EVERY 300 SQUARE

SPACE FOR DWELLING UNITS LESS THAN 900 SF.

FEET OF USABLE FLOOR AREA.

USABLE FLOOR AREA = 3,347 SF / 300 = 11

SECTION 19.06 LOADING AND UNLOADING SPACE REQUIREMENTS

(3) SPACE REQUIREMENTS: 12'x25' LOADING SPACE.

TOTAL PARKING SPACES REQ'D: 7 + 11 x 50% = 9

| Parking Schedule | | | | | | | |
|-------------------------|-------|--|--|--|--|--|--|
| Туре | Count | | | | | | |
| 8' x 18' Van Accessible | 1 | | | | | | |
| 9' x 18' - 90 deg | 8 | | | | | | |
| 9' x 23' Parallel | 2 | | | | | | |
| Total Provided: | 11 | | | | | | |



DANIEL

Boggs

8538 ISLAND BLVD. GROSSE ILE, MI 48138 248.882.3642

PROJECT: Douglas Building 13 South Union Street Douglas, MI 49406

PROFESSIONAL SEAL:



PRELIMINARY NOT FOR CONSTRUCTION ISSUED:

07-15-25 Client Review 07-22-25 City Preliminary Review 09-04-25 Client Review 10-03-25 PC Review

10-31-25 Revision

11-05-25 Revision

PROJECT NO: 2025.12


DRAWN BY: Author

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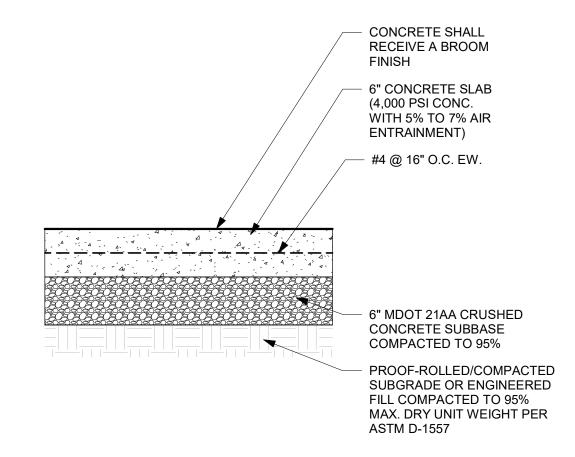
SHEET TITLE: Site Plan

SHEET NO:




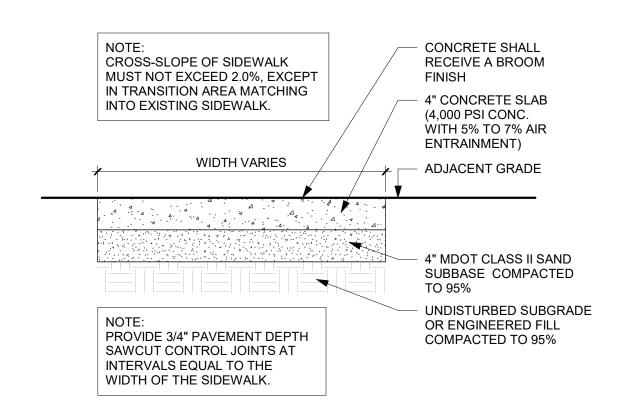

10 CONCRETE SIDEWALK DETAIL A-1.1/ SCALE: 1" = 1'-0"




9 DUMPSTER ENCLOSURE PAVING DETAIL \A-1.1\scale: 1" = 1'-0"

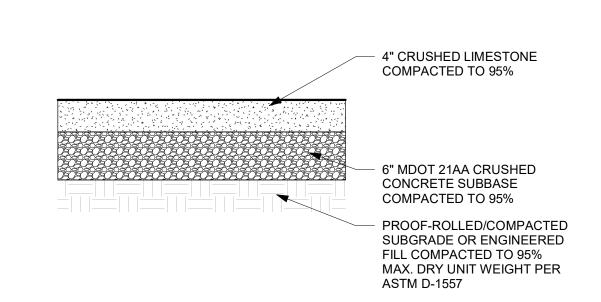

8 STONE PAVING DETAIL

A-1.1 SCALE: 1" = 1'-0"

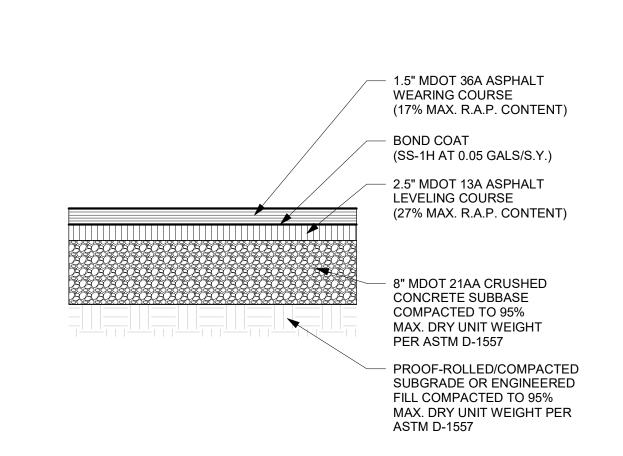

11 CONCRETE SIDEWALK DETAIL AT DRIVEWAY A-1.1 SCALE: 1" = 1'-0"

ASTM D-1557

CONCRETE SHALL

FINISH

12 CONCRETE PAVING DETAIL

CROSS-SLOPE OF SIDEWALK

INTO EXISTING SIDEWALK.

NOTE:

MUST NOT EXCEED 2.0%, EXCEPT

IN TRANSITION AREA MATCHING

PROVIDE 3/4" PAVEMENT DEPTH

SAWCUT CONTROL JOINTS AT

INTERVALS EQUAL TO THE

WIDTH OF THE SIDEWALK.

WIDTH VARIES

A-1.1 SCALE: 1" = 1'-0"

RECEIVE A BROOM

4" CONCRETE SLAB (4,000 PSI CONC.

WITH 5% TO 7% AIR ENTRAINMENT)

6"x6" W2.9 x W2.9 WELDED WIRE MESH

6" MDOT 21AA CRUSHED CONCRETE SUBBASE COMPACTED TO 95%

PROOF-ROLLED/COMPACTED

SUBGRADE OR ENGINEERED

FILL COMPACTED TO 95%

ASTM D-1557

MAX. DRY UNIT WEIGHT PER

- CONCRETE SHALL RECEIVE A BROOM

4" CONCRETE SLAB

WITH 5% TO 7% AIR

(4,000 PSI CONC.

ENTRAINMENT)

6"x6" W2.9 x W2.9

- ADJACENT GRADE

WELDED WIRE MESH

6" MDOT 21AA CRUSHED CONCRETE SUBBASE


PROOF-ROLLED/COMPACTED SUBGRADE OR ENGINEERED

FILL COMPACTED TO 95%


MAX. DRY UNIT WEIGHT PER

COMPACTED TO 95%


7 ASPHALT PAVING DETAIL A-1.1 SCALE: 1" = 1'-0"

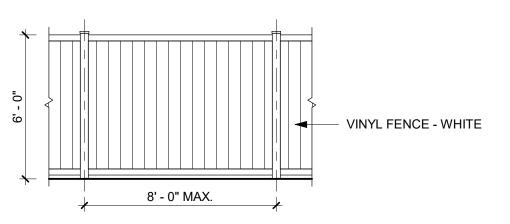




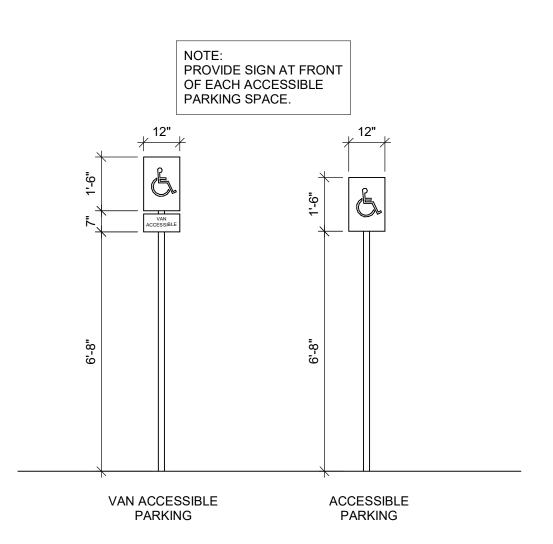


5 ACCESSIBLE PARKING SIGNAGE A-1.1 SCALE: 3/8" = 1'-0"

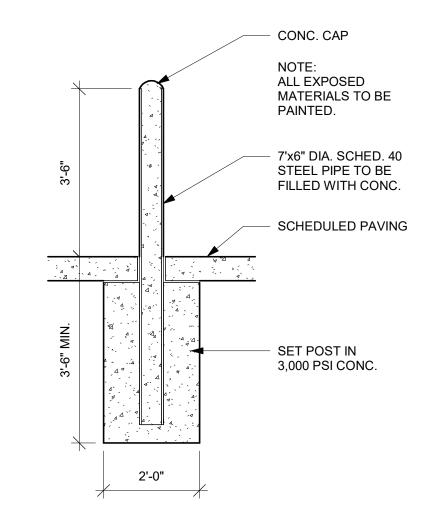


4 BOLLARD DETAIL A-1.1 SCALE: 1/2" = 1'-0"

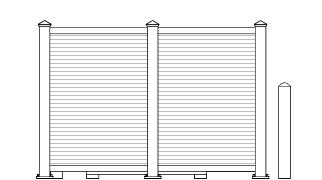

3 DUMPSTER ENCLOSURE - SIDE

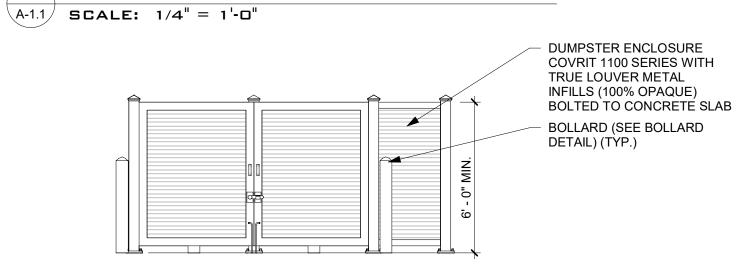

2 DUMPSTER ENCLOSURE - FRONT A-1.1 SCALE: 1/4" = 1'-0"

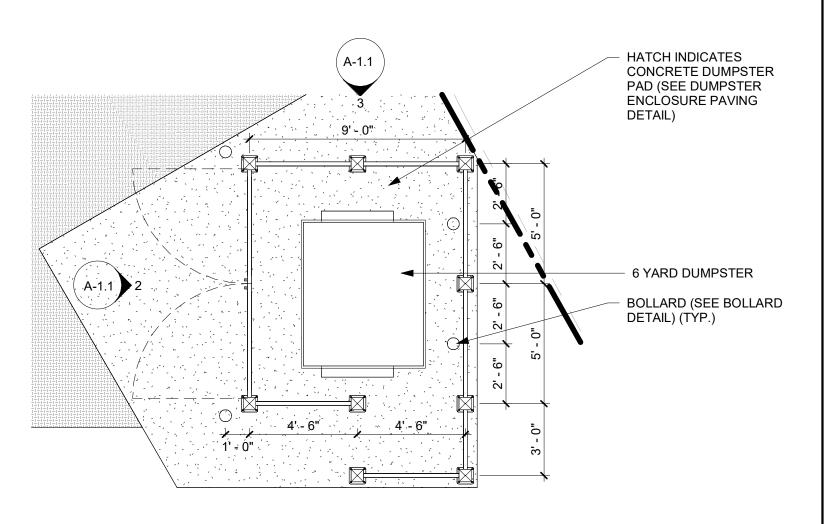

1 ENLARGED DUMPSTER ENCLOSURE PLAN A-1.1 SCALE: 1/4" = 1'-0"




ARCHITECTURE PLANNING

8538 ISLAND BLVD. GROSSE ILE, MI 48138 248.882.3642

PROJECT: Douglas Building 13 South Union Street Douglas, MI 49406

PROFESSIONAL SEAL:

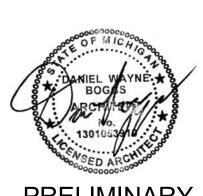

NOT FOR CONSTRUCTION ISSUED:

10-03-25 PC Review 10-31-25 Revision 11-05-25 Revision


PROJECT NO: 2025.12

DRAWN BY: Author

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SHEET TITLE: Site Details

SHEET NO:

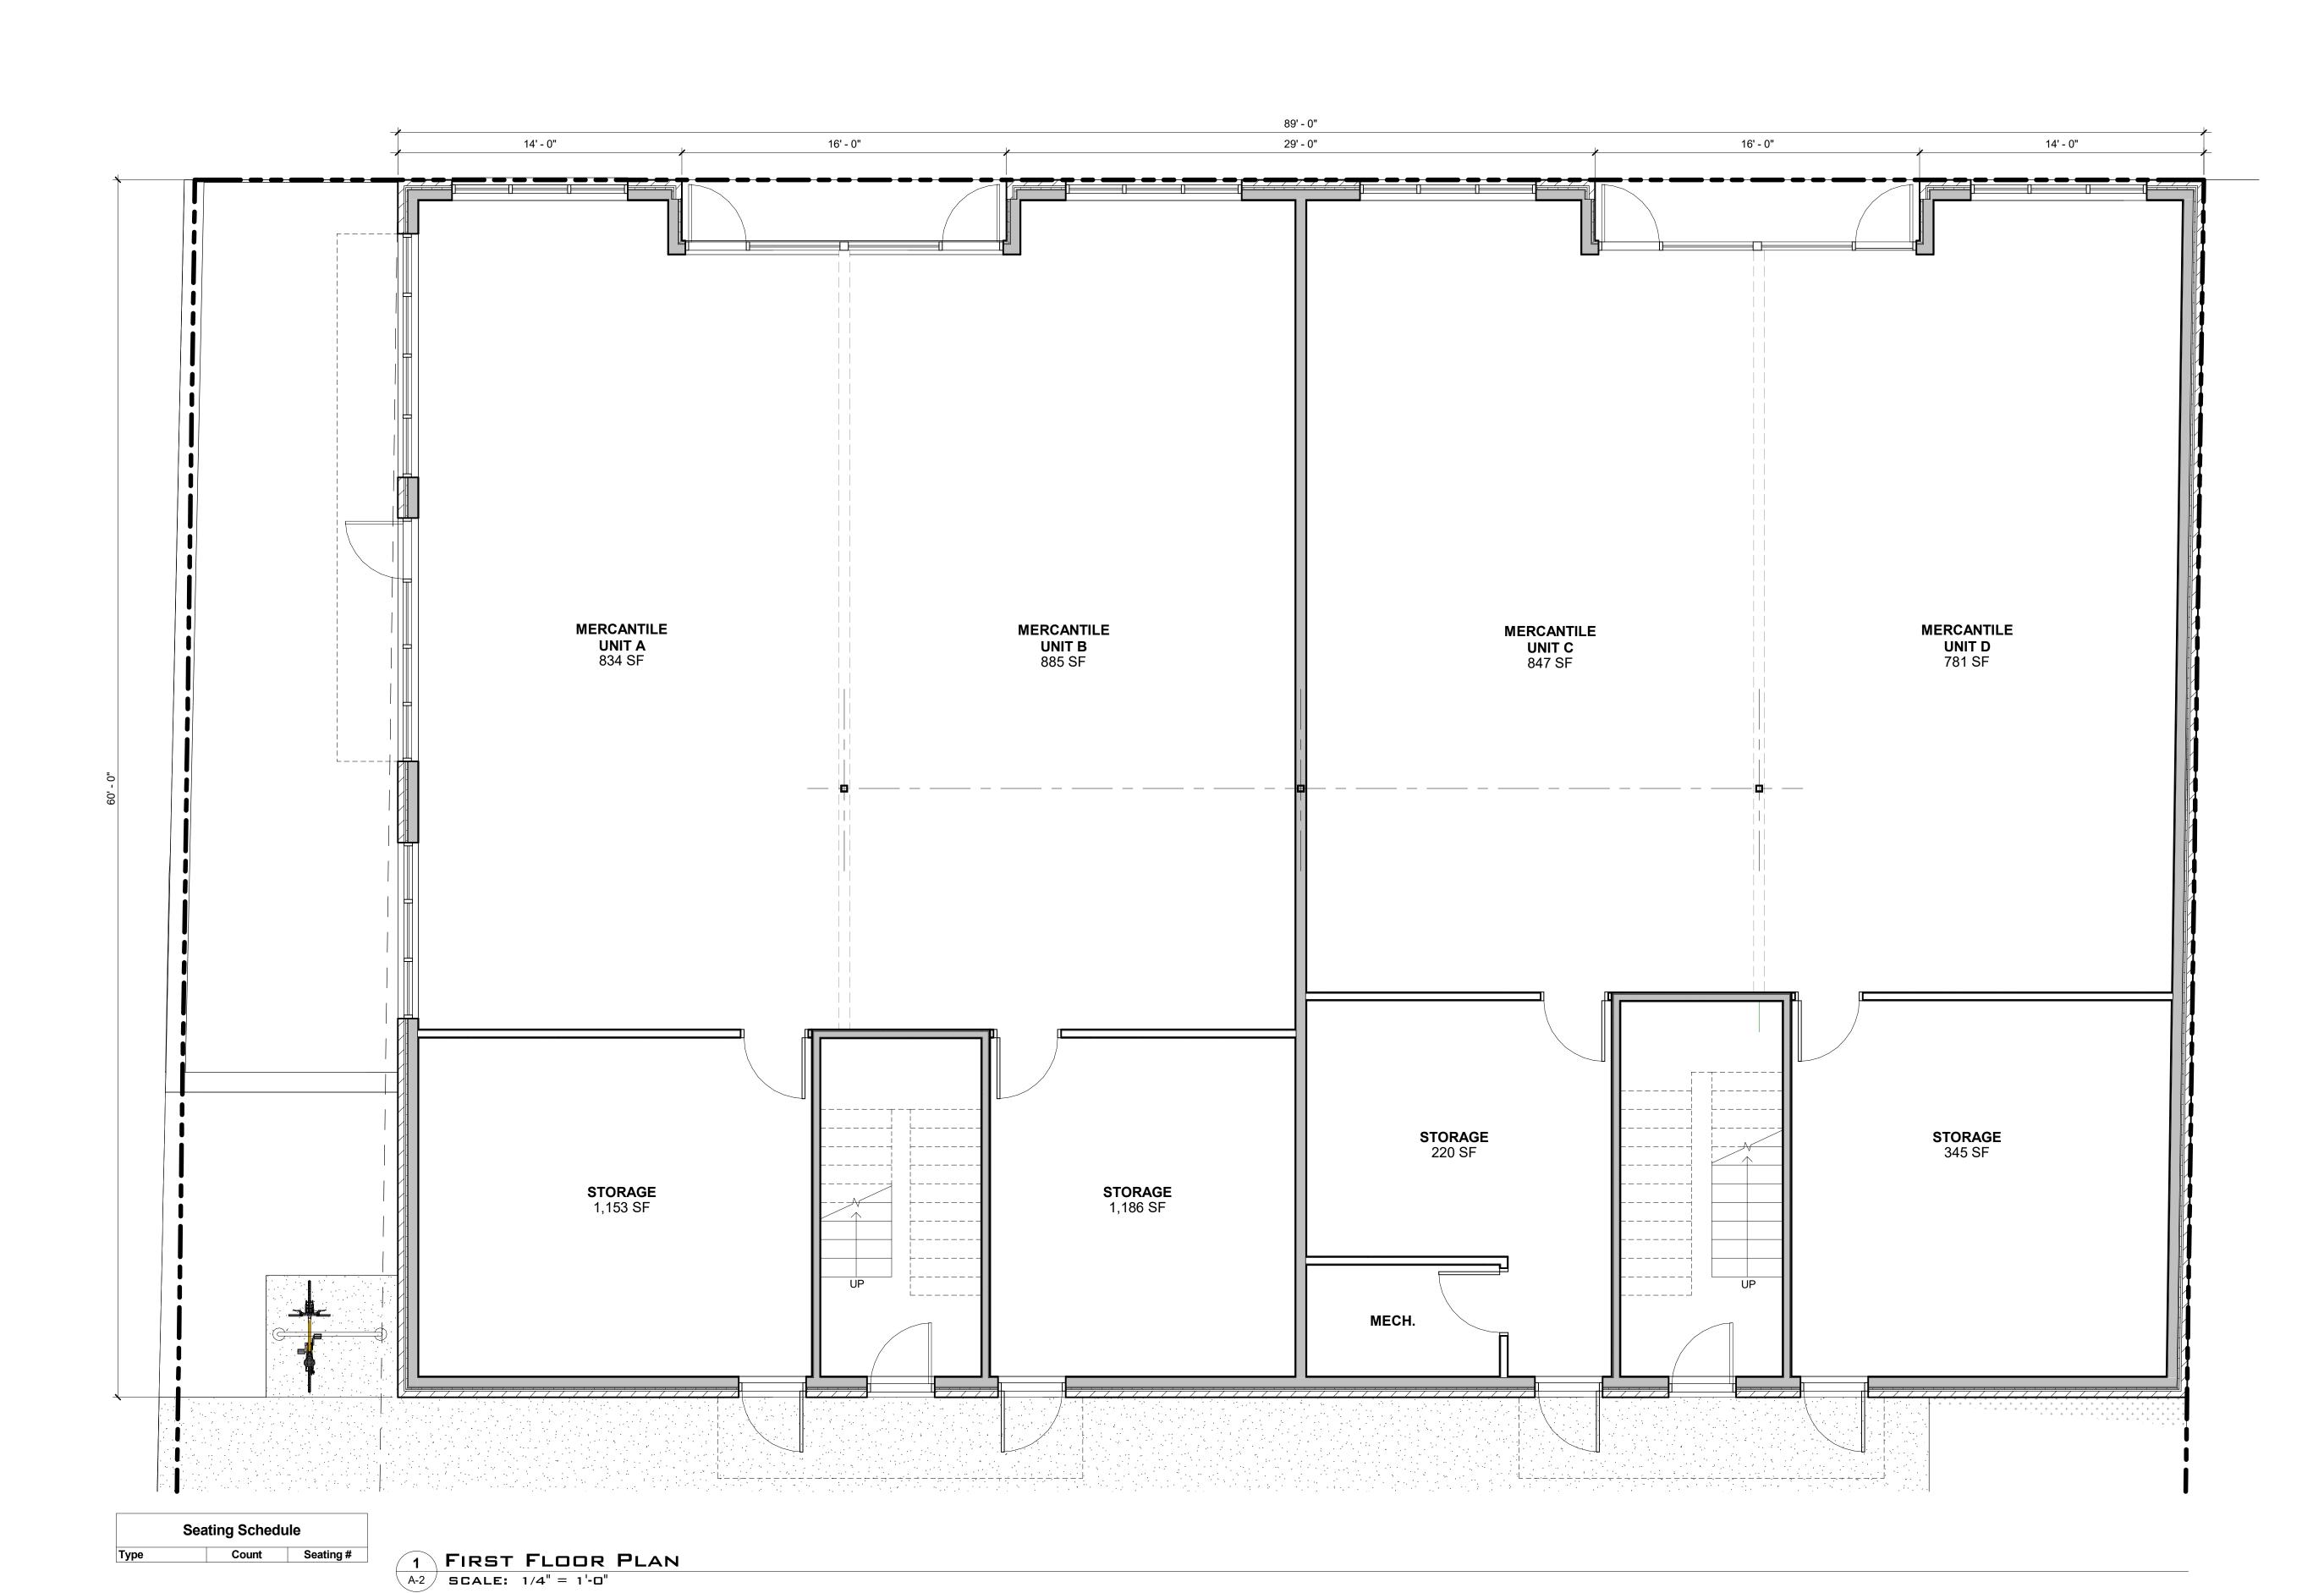

DANIEL
BOGGS
ARCHITECT


ARCHITECTURE & PLANNING

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Douglas Building

13 South Union Street
Douglas, MI 49406

PROFESSIONAL SEAL:

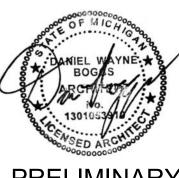

PRELIMINARY
NOT FOR CONSTRUCTION
ISSUED:

09-04-25 Client Review
09-12-25 Revision
10-03-25 PC Review
11-05-25 Revision

2025.12

Author


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First Floor Plan

SHEET NO:

A-2



DANIEL
BOGGS
ARCHITECT

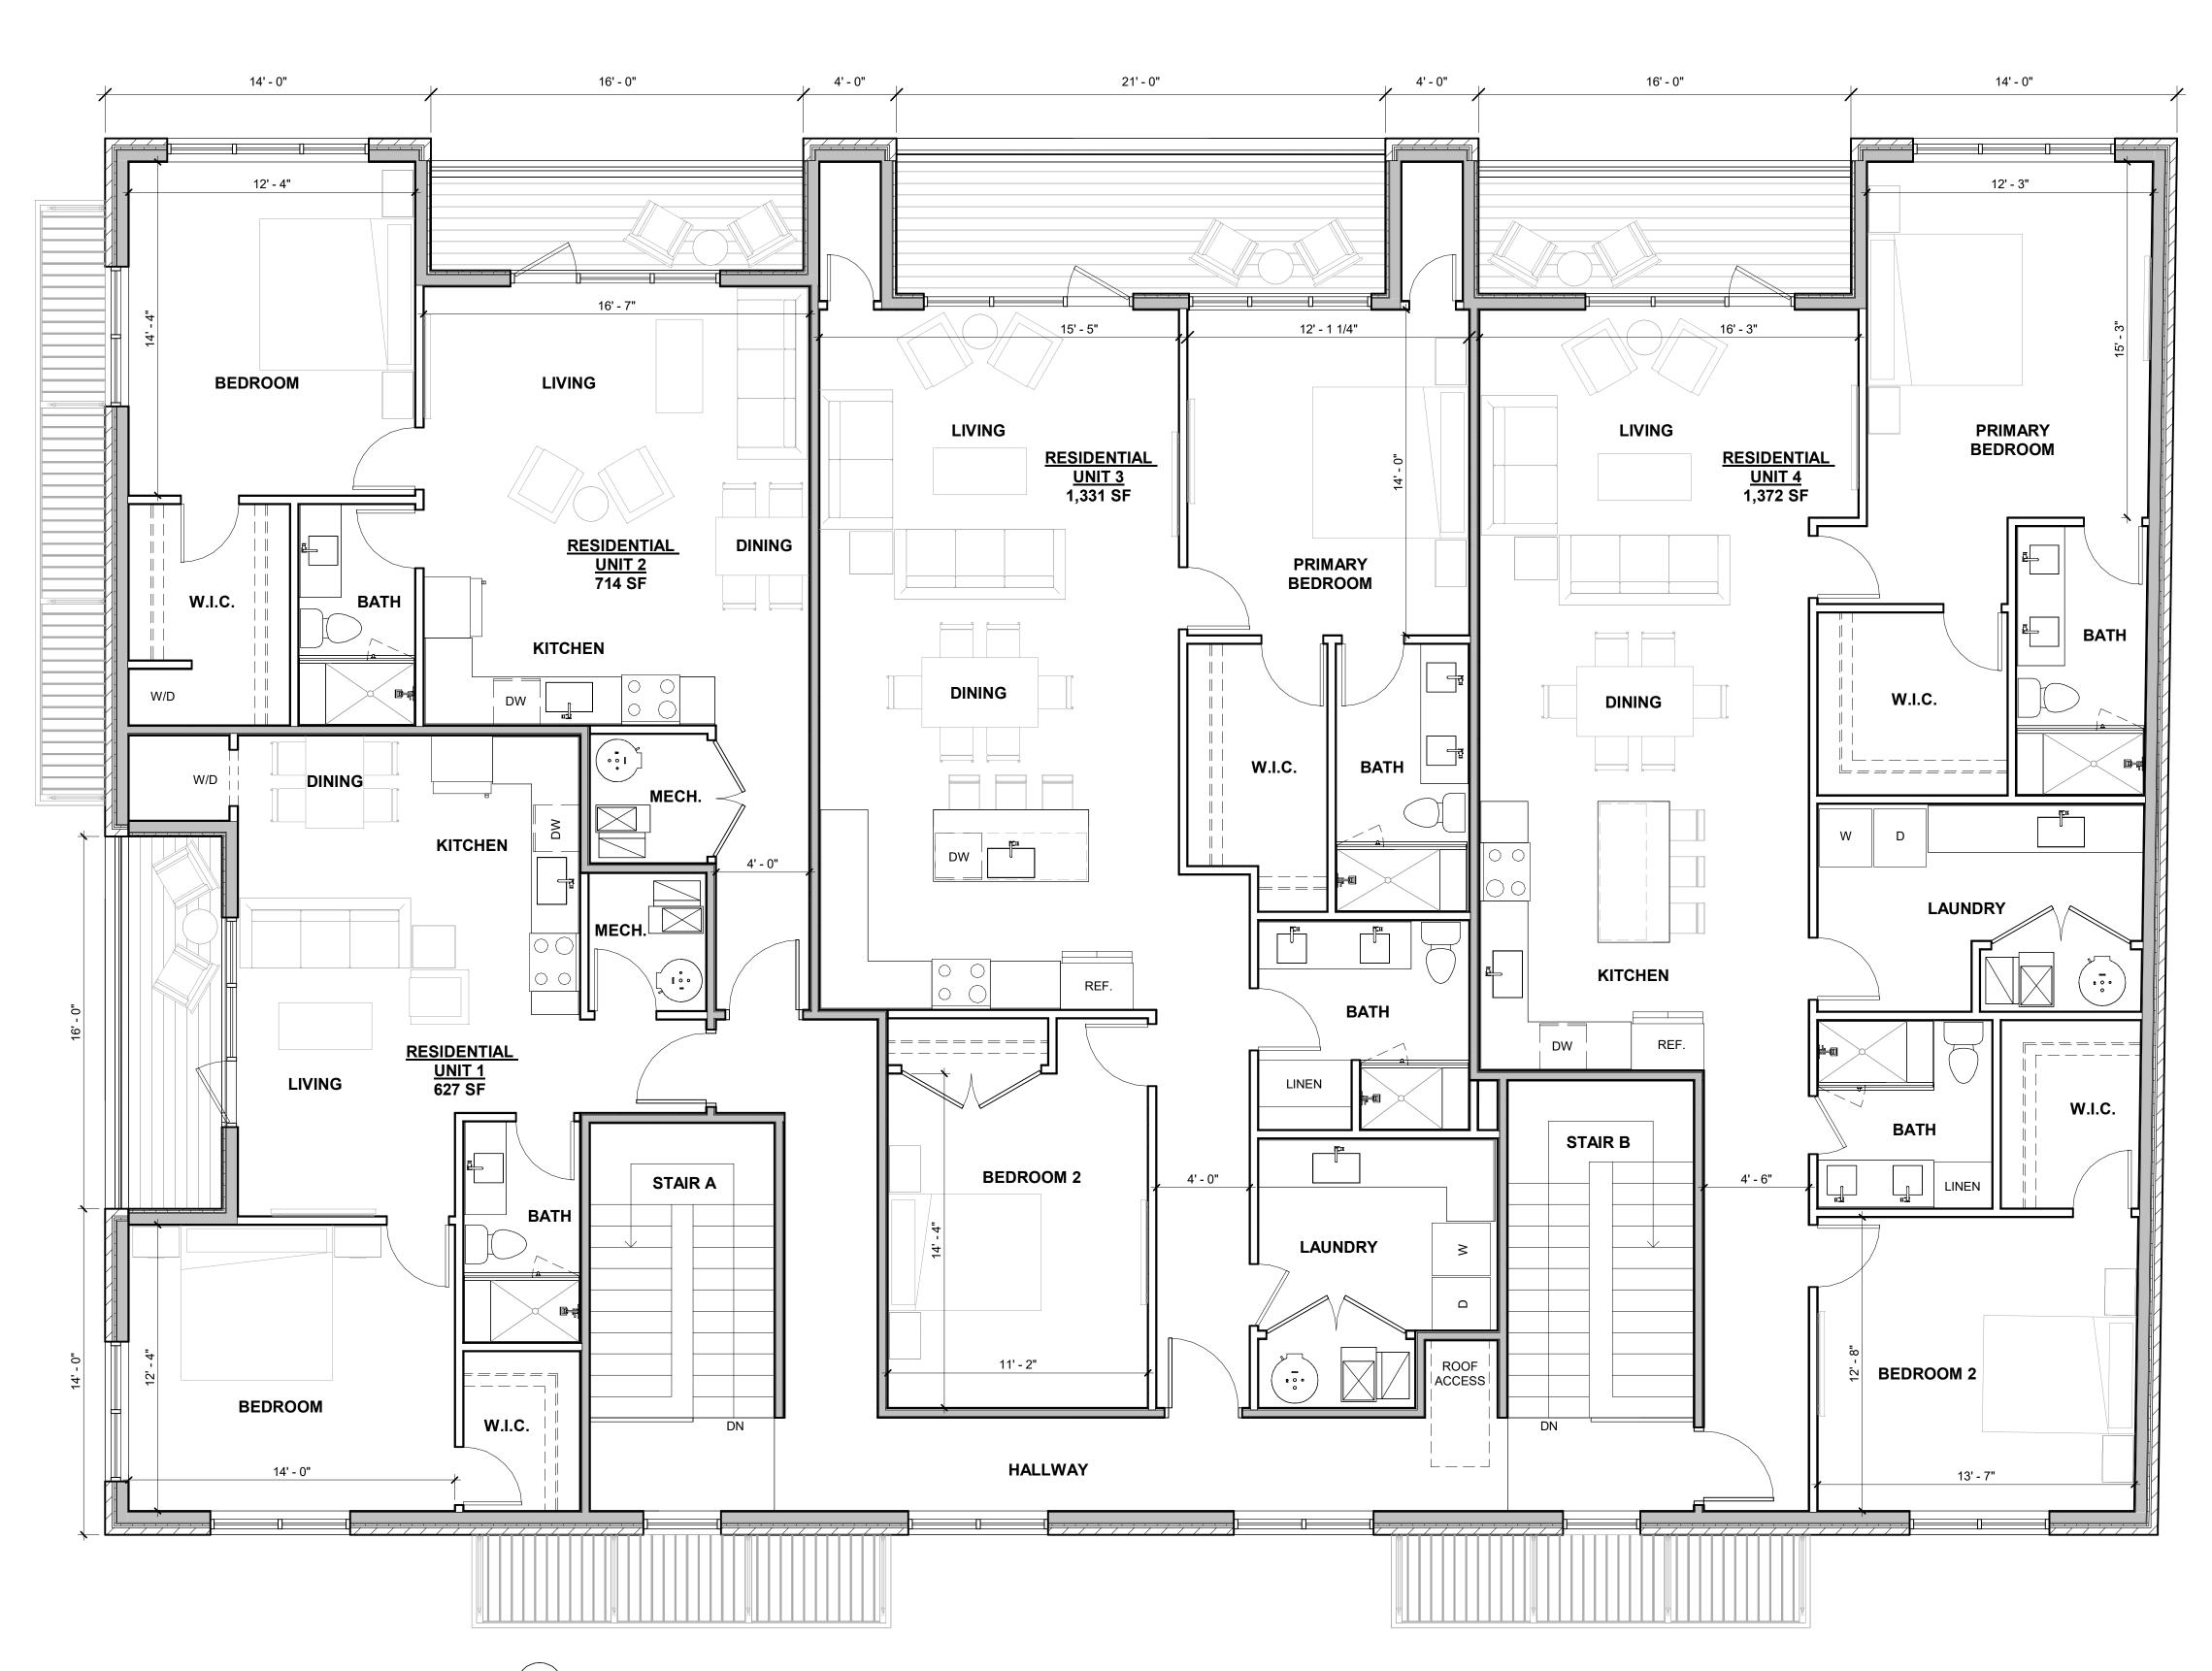ARCHITECTURE & PLANNING

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PROJECT:

Douglas Building

13 South Union Street
Douglas, MI 49406

PROFESSIONAL SEAL:



PRELIMINARY
NOT FOR CONSTRUCTION
ISSUED:

 09-04-25
 Client Review

 09-12-25
 Revision

 10-03-25
 PC Review

 11-05-25
 Revision

2025.12

DRAWN BY:

Author

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SHEET TITLE:
Second Floor Plan

SHEET NO:

A-3

SECOND FLOOR PLAN

A-3 SCALE: 1/4" = 1'-0"



1 EAST ELEVATION
A-4 SCALE: 1/4" = 1'-0"



NORTH ELEVATION

A-4 SCALE: 1/4" = 1'-0"

DANIEL
BOGGS
ARCHITECT


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Douglas Building

13 South Union Street
Douglas, MI 49406

PROFESSIONAL SEAL:



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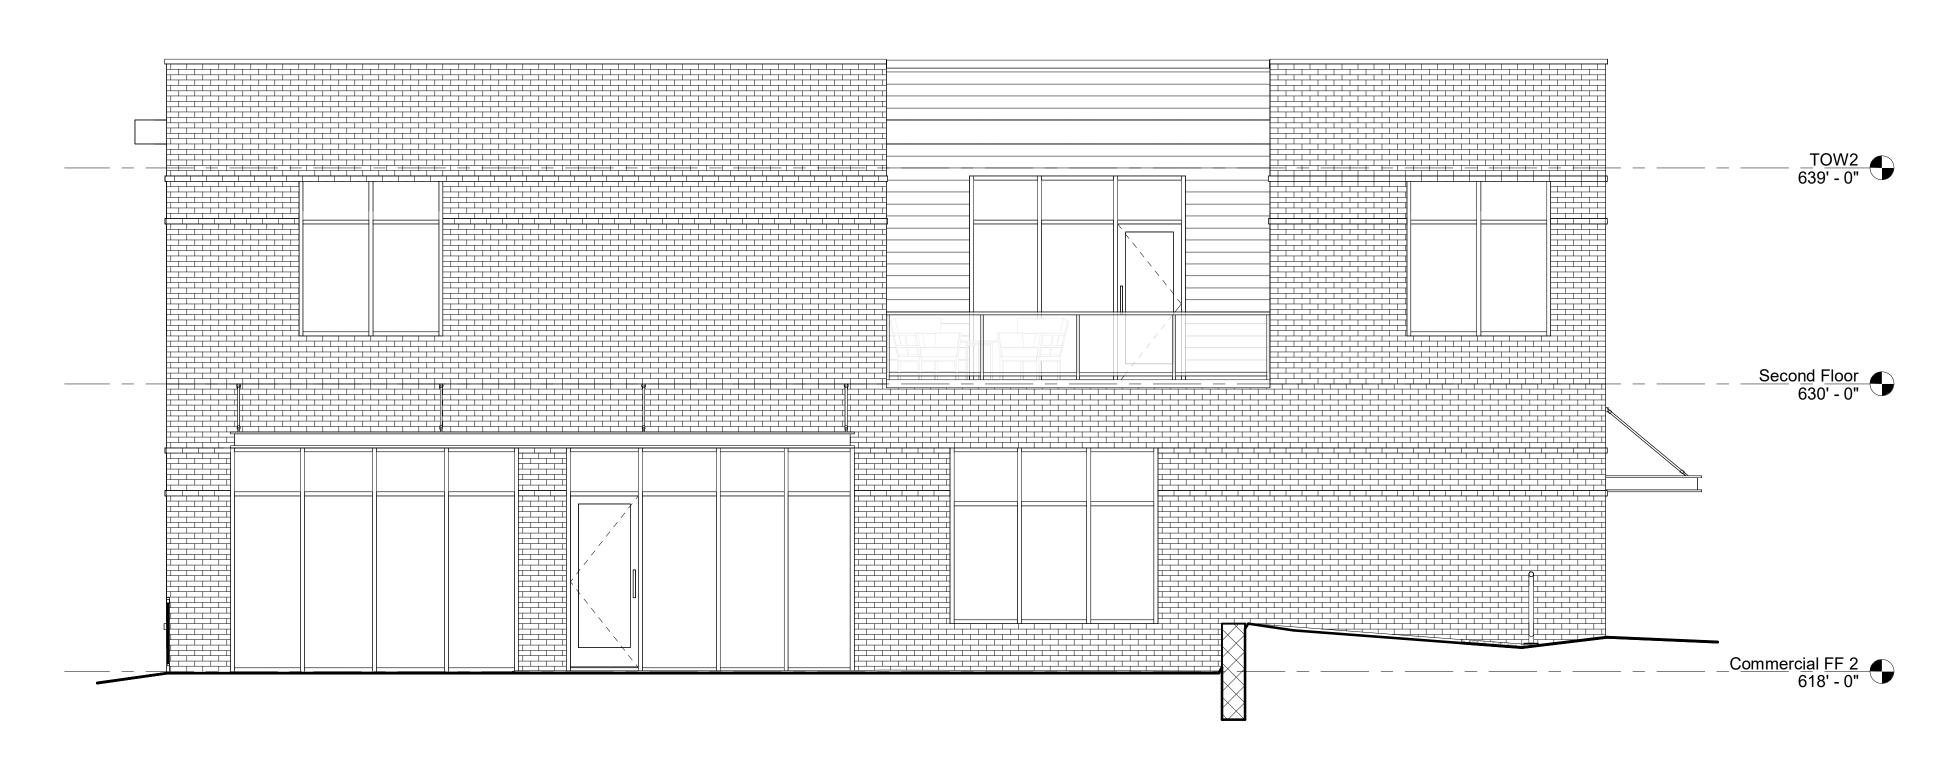
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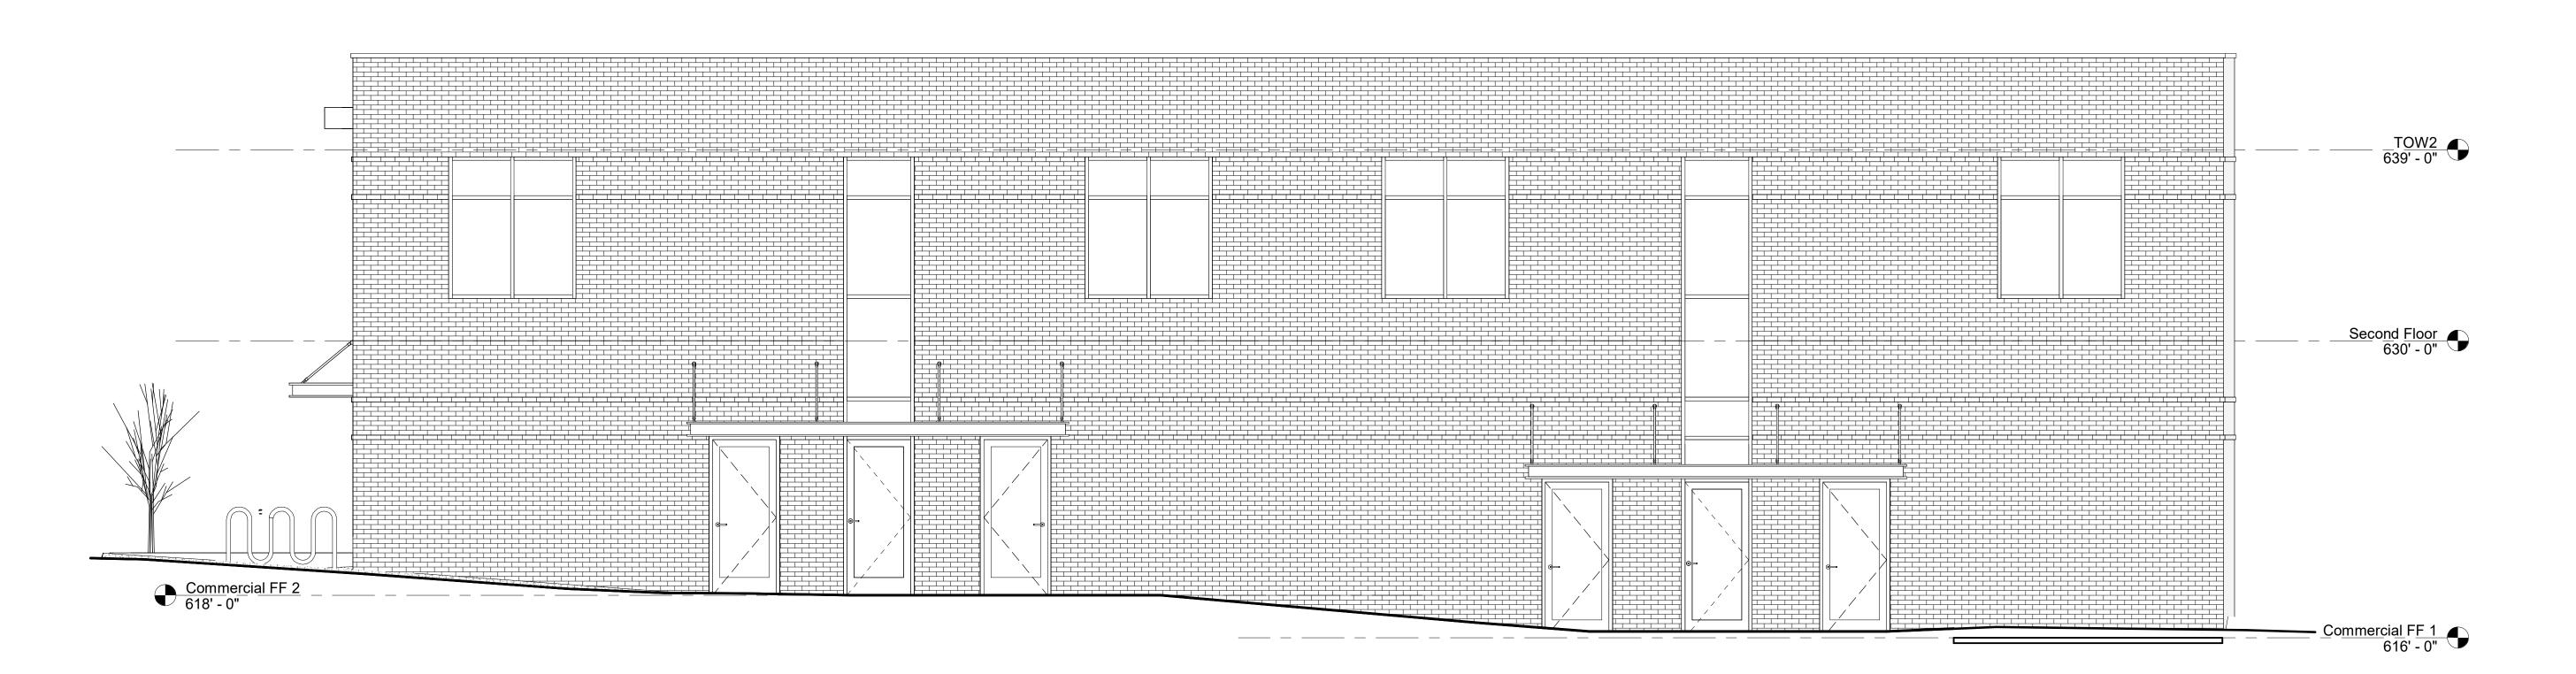
Exterior Elevations

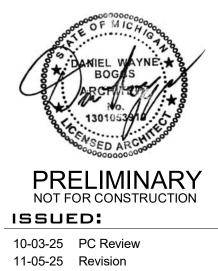SHEET NO:

A-4



2 WEST ELEVATION
A-5 SCALE: 1/4" = 1'-0"



1 SOUTH ELEVATION
A-5 SCALE: 1/4" = 1'-0"

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BOGGS
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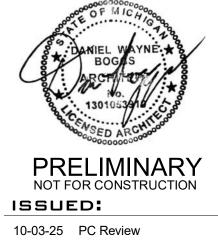
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Douglas, MI 49406

PROFESSIONAL SEAL:



2025.12

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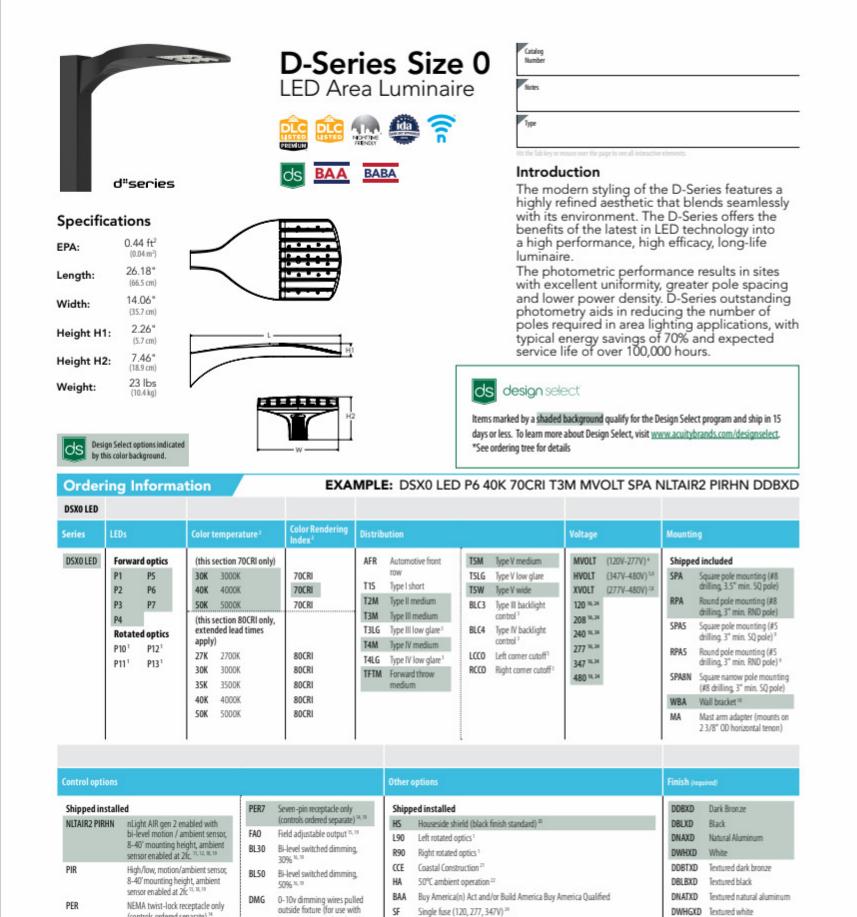
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Exterior Elevations

SHEET NO:

A-5



Single fuse (120, 277, 347V)

BSDB Bird Spikes (field install required)

EGSR External Glare Shield (reversible, field install required, matches housing finish)

DF Double fuse (208, 240, 480V) 34

Shipped separately

One Lithonia Way • Conyers, Georgia 30012 • Phone: 1-800-705-SERV (7378) • www.lithonia.com

an external control, ordered

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| CW0612UDPC | | | | СТ | | UP | TICS3 | | | RIVER / DIMMING4 | | LENS | МС | UNTING | | FINISH ⁷ | |
|------------|---------|----------------|-------------|--------------|--------|-----------|-------|----------------|-------|--|----|--------------|------|--------------------------------|----------------|---------------------|--|
| 6" x 12" | 10L | 1400 Lm | 80 | CRI | UPL | IGHT | DOWN | LIGHT | EX | Electronic Driver, 120V/277V | CL | Clear Lens | WM | Wall Mount | MW- | Matte White | |
| | 15L | 2050 Lm | 27K | 2700K | ND | 14° | ND | 14° | D010X | 1%, 0-10V, 120V/277V | so | Micro Prism | | | MB* | Matte Black | |
| CW0618UDPC | | 2800 Lm | | 3000K | MD | 31° | | 31° | DS2W1 | ELV/MLV, 120V | | Solite™ Lens | | | | Platinum Silver | |
| | | 4150 Lm | | 3500K | WD | 52° | | | | | | | | CC | Custom Color | | |
| | | 0000 Lm | 40K | 4000K | XW | 75° | xw | 75- | | | | | | | | | |
| | | | _ | CRI | | | | | | | | | - | BAT. OPTIONS | | | |
| | | | | | 2700K | | | | | | | | | | 7W Remote EM | | |
| | | | | 3000K | | | | | | | | | EMEN | 7W Remote EM with Enclosure | | | |
| | | | | | | | | 3500K 4000K | | | | | | | with Enclosure | | |
| | ombined | I Uplight/Down | nlight Lume | ans at 3500k | K 2Upi | ight & Do | | | | itput 3 See IES Files for Details 4 Con noe Color Sheet Located on Product We | | | | | D. | 4 | |

Dimensions and values shown are nominal. Spectrum Lighting continually works to improve products and reserves the right to make changes which may after the performance or appearance of products

2.0 STR 0.6 0.0 S1 @ 6^{.1}.3 0.0 **TOP + 0.0 | +0.0 | +0.0 | 0.0 | 0.0 0.0 +0.0 0.0 0.0 0.0 0.0 0.0 0.0 0.0 0.0 0.0 0.0 0.0 -S1 @ 6 0.0 0.0 0.0 0.0 0.0 0.0 0.0 0.0 0.0 0.1 0.0 . 04 1,0 0.8 0.5 ^2.4 0.1 0.2 0.7 1.6 2.3 2.6 2.6 2.5 2.6 2.5 2.5 0.9 0.2 *2.5 *2.3 *2.1 *1.9 *2.6 *2.9 *2.7 | *2.5 *2.3 *2.3 *2.4 || *2.6 || *2.5 0.4 0.2 0.1 0.0 0.0 $0.3 \quad 0.2 \quad 0.1 \quad 0.0 \quad 0.0$ 2.2 23 / 1.6 0.1 0.1 0.1 0.0

General Note

1. SEE SCHEDULE FOR LUMINAIRE MOUNTING HEIGHT.

(controls ordered separate) 16

Five-pin receptacle only (controls

ordered separate) 14, 15

LITHONIA LIGHTING

COMMERCIAL OUTDOOR

2. SEE LUMINAIRE SCHEDULE FOR LIGHT LOSS FACTOR 3. CALCULATIONS ARE SHOWN IN FOOTCANDLES AT: GRADE

THE ENGINEER AND/OR ARCHITECT MUST DETERMINE APPLICABILITY OF THE LAYOUT TO EXISTING / FUTURE FIELD CONDITIONS. THIS LIGHTING LAYOUT REPRESENTS ILLUMINATION LEVELS CALCULATED FROM LABORATORY DATA TAKEN UNDER CONTROLLED CONDITIONS IN ACCORDANCE WITH ILLUMINATING ENGINEERING SOCIETY APPROVED METHODS. ACTUAL PERFORMANCE OF ANY MANUFACTURER'S LUMINAIRE MAY VARY DUE TO VARIATION IN ELECTRICAL VOLTAGE, TOLERANCE IN LAMPS, AND OTHER VARIABLE FIELD CONDITIONS. MOUNTING HEIGHTS INDICATED ARE FROM GRADE AND/OR FLOOR UP.

THESE LIGHTING CALCULATIONS ARE NOT A SUBSTITUTE FOR INDEPENDENT ENGINEERING ANALYSIS OF LIGHTING SYSTEM SUITABILITY AND SAFETY. THE ENGINEER AND/OR ARCHITECT IS RESPONSIBLE TO REVIEW FOR MICHIGAN ENERGY CODE AND LIGHTING QUALITY COMPLIANCE.

UNLESS EXEMPT, PROJECT MUST COMPLY WITH LIGHTING CONTROLS REQUIRMENTS DEFINED IN ASHRAE 90.1 2019. FOR SPECIFIC INFORMATION CONTACT GBA CONTROLS GROUP AT CONTROLS@GASSERBUSH.COM OR 734-266-6705.

Alternates Note

THE USE OF FIXTURE ALTERNATES MUST BE RESUBMITTED TO THE CITY FOR APPROVAL.

Drawing Note

THIS DRAWING WAS GENERATED FROM AN ELECTRONIC IMAGE FOR ESTIMATION PURPOSE ONLY. LAYOUT TO BE VERIFIED IN FIELD BY OTHERS.

Ordering Note

FOR INQUIRIES CONTACT GASSER BUSH AT QUOTES@GASSERBUSH.COM OR 734-266-

Mounting Height Note

MOUNTING HEIGHT IS MEASURED FROM GRADE TO FACE OF FIXTURE. POLE HEIGHT SHOULD BE CALCULATED AS THE MOUNTING HEIGHT LESS BASE HEIGHT.

Rev. 11/15/24 Page 1 of 9

| Schedule | | | | | | | | | | |
|----------|-------|-----|-------------------|---|--|----------------|------|----------------|--|--|
| Symbol | Label | QTY | Manufacturer | Catalog | Description | Lamp Output | LLF | Input Power | | |
| | P1 | 2 | Lithonia Lighting | DSX0 LED P1 40K 80CRI LCCO EGS | D-Series Size 0 Area Luminaire P1 Performance Package 4000K CCT 80 CRI Left Corner Cutoff Extreme Backlight Control External Glare Shield | 3199 | 0.9 | 33.21 | | |
| | P2 | 1 | Lithonia Lighting | DSX0 LED P1 40K 80CRI RCCO EGS | D-Series Size 0 Area Luminaire P1 Performance Package 4000K CCT 80 CRI Right Corner Cutoff Extreme Backlight Control External Glare Shield | 3199 | 0.9 | 33.21 | | |
| | Р3 | 1 | Lithonia Lighting | DSX0 LED P1 40K 80CRI T4LG EGS | D-Series Size 0 Area Luminaire P1 Performance Package 4000K CCT 80 CRI Type 4 Low G Rating External Glare Shield | 3836 | 0.9 | 33.21 | | |
| | S1 | 10 | Spectrum Lighting | CW06XXUDPC 10L 35K ND MD XX CL WM XX | Nom 6" diam Gamma Cylinder (wet location), clear glass lens | 1413 | 0.45 | 6.5 | | |

| Statistics | | | | | | | | | | |
|-----------------------|--------|--------|---------|--------|---------|---------|--|--|--|--|
| Description | Symbol | Avg | Max | Min | Max/Min | Avg/Min | | | | |
| Overall/Grade | + | 0.7 fc | 34.3 fc | 0.0 fc | N/A | N/A | | | | |
| Parking & Drive Lanes | Ж | 2.1 fc | 3.5 fc | 0.4 fc | 8.8:1 | 5.3:1 | | | | |
| Property Line | + | 1.6 fc | 23.8 fc | 0.0 fc | N/A | N/A | | | | |

Designer Date 10/01/2025 REV 10/02/2025 Scale Not to Scale Drawing No.

PH-1