INTERURBAN ADDITION

100 WILEY ROAD DOUGLAS, MI 49406

ZONING

R-1, RESIDENTIAL DISTRICT

SETBACKS

35 FEET MIN.

7 FEET MIN. ONE SIDE, 18' MIN TOTAL

28 FEET MAX.

MIN LOT AREA:

15,000 SF W/O SEWER


MAX LOT COVERAGE: 35%

FLOOR AREA RATIO: 0.4

MAX BUILDING HEIGHT: 28 F

MIN FLOOR AREA: 1,200 SF

PER SECTION 4.02 OF THE CITY OF THE VILLAGE OF DOUGLAS ZONING ORDINANCE, BUILDINGS ASSOCIATED WITH PUBLIC FACILITIES ARE APPROVED SPECIAL LAND USES IN THE EXISTING B 1 ZONING DISTRICT

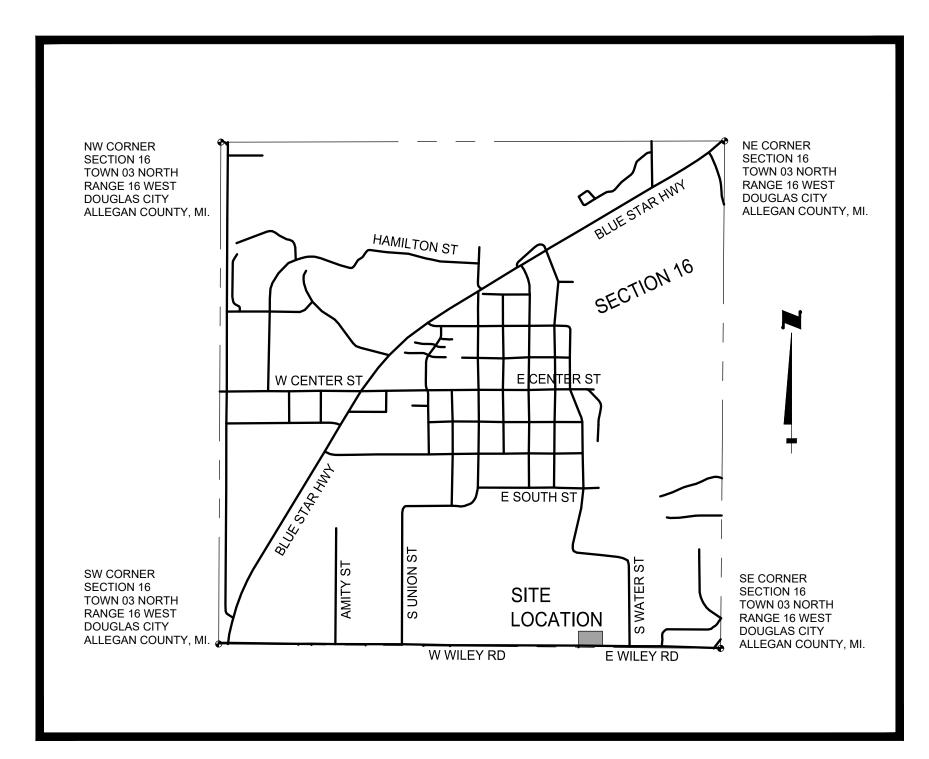

LOCATION MAP NOT TO SCALE

TABLE OF CONTENTS

SHEET G-100	COVER SHEET
SHEET V-101	EXISTING CONDITIONS
SHEET CD-101	CIVIL DEMOLITION PLAN

SHEET C-101 SITE LAYOUT PLAN

SHEET C-201 GRADING, DRAINAGE & SESC PLAN

DESCRIPTION

PER WARRANTY DEED RECORDED IN LIBER 2878, PAGE 763, ALLEGAN COUNTY PUBLIC RECORDS, MICHIGAN.

REAL PROPERTY LOCATED IN THE VILLAGE OF DOUGLAS, ALLEGAN COUNTY, MICHIGAN, LEGALLY DESCRIBED AS:

PART OF THE SOUTHEAST 1/4 OF SECTION 16, TOWN 3 NORTH, RANGE 16 WEST, VILLAGE OF DOUGLAS, ALLEGAN COUNTY, MICHIGAN DESCRIBED AS BEGINNING AT A POINT ON THE SOUTH LINE OF SECTION 16 DISTANT SOUTH 89° 07' 04" WEST 1279.62 FEET FROM THE SOUTHEAST CORNER OF SECTION 16 AND PROCEEDING THENCE SOUTH 89° 07' 04" WEST 256.86 FEET, ALONG THE SOUTH LINE OF SECTION 16; THENCE NORTH 02° 02' 18" WEST 169.62 FEET; THENCE NORTH 89° 07' 04" EAST 256.86 FEET; THENCE SOUTH 02° 02' 18" EAST 169.62 FEET PARALLEL WITH THE CENTERLINE OF WATER STREET TO THE POINT OF BEGINNING. SUBJECT TO ANY RESTRICTIONS AND LIMITATIONS OF RECORD.




100 E. Wiley Rd - Interurban Transit Authority - Site Plan Received #1 - 8/20/2025 Reviewed #1 - 9/10/2025 - 2102-CM Approved #1 per Review #1 - 9/10/2025 - 2102-CM

DDITION Project Manager RYAN T. YSSELDYKE, P.E. Vertical Datum Horz. Datum LOCAL NAVD '88 Drawn by AARON VENEMA Checked by Civil Struc. L. A. HEI Project Number 25-04-050 COVER SHEET

Sheet No.

G-100

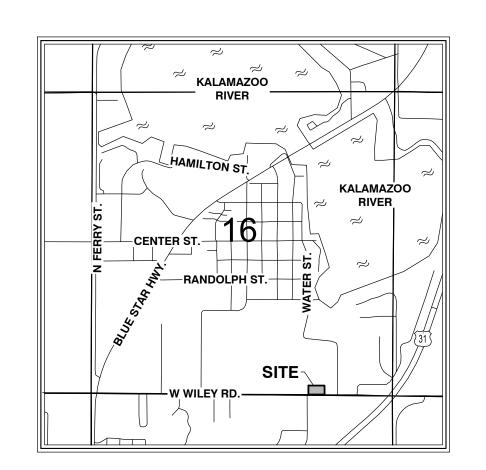

LOCATION MAP -NOT TO SCALE-



SCALE 1" = 20'

I, MARK O. SCOVILL, A LICENSED PROFESSIONAL SURVEYOR IN THE STATE OF MICHIGAN, HEREBY CERTIFY THAT I HAVE SURVEYED THE PARCEL(S) OF LAND DESCRIBED AND DELINEATED HEREON; THAT THE SURVEY MAP IS A TRUE REPRESENTATION OF THE SURVEY AS PERFORMED BY ME; THAT SAID SURVEY WAS PERFORMED RESULTING WITH A RELATIVE POSITIONAL PRECISION AT EACH BOUNDARY CORNER SHOWN HEREON WITHIN LIMITS ACCEPTED BY THE PRACTICE OF PROFESSIONAL SURVEYING. THIS SURVEY WAS MADE FROM THE ATTACHED LEGAL DESCRIPTION, THE DESCRIPTION WAS GIVEN TO US BY OTHERS, OR WAS PREPARED BY US FROM INFORMATION OR DOCUMENTS GIVEN TO US BY OTHERS, AND SHOULD BE COMPARED WITH THE ABSTRACT OF TITLE OR TITLE INSURANCE POLICY FOR

HOLLAND ENGINEERING, INC. 220 HOOVER BOULEVARD HOLLAND, MICHIGAN 49423 (616) 392-5938

mark o. Deavell MARK O. SCOVILL MICHIGAN PROFESSIONAL SURVEYOR #4001045504

ACCURACY, EASEMENTS OR EXCEPTIONS.

LEGAL DESCRIPTION

DESCRIBED AS:

PER WARRANTY DEED RECORDED IN LIBER 2878, PAGE 763, ALLEGAN COUNTY PUBLIC RECORDS,

REAL PROPERTY LOCATED IN THE VILLAGE OF DOUGLAS, ALLEGAN COUNTY, MICHIGAN, LEGALLY

PART OF THE SOUTHEAST 1/4 OF SECTION 16, TOWN 3 NORTH, RANGE 16 WEST, VILLAGE OF DOUGLAS, ALLEGAN COUNTY, MICHIGAN DESCRIBED AS BEGINNING AT A POINT ON THE SOUTH LINE OF SECTION 16 DISTANT SOUTH 89° 07' 04" WEST 1279.62 FEET FROM THE SOUTHEAST CORNER OF SECTION 16 AND PROCEEDING THENCE SOUTH 89° 07' 04" WEST 256.86 FEET, ALONG THE SOUTH LINE OF SECTION 16: THENCE NORTH 02° 02' 18" WEST 169.62 FEET; THENCE NORTH 89° 07' 04" EAST 256.86 FEET; THENCE SOUTH 02° 02' 18" EAST 169.62 FEET PARALLEL WITH THE CENTERLINE OF WATER STREET TO THE POINT OF BEGINNING. SUBJECT TO ANY RESTRICTIONS AND LIMITATIONS OF RECORD.

GENERAL NOTES

- THIS SURVEY WAS PREPARED FOR THE LANDS AS DESCRIBED WITHOUT THE BENEFIT OF CURRENT TITLEWORK. IT IS NOT A CERTIFICATION OF
- TITLE, ZONING OR FREEDOM OF ENCUMBRANCES. BEARINGS ARE BASED ON THE SOUTH LINE OF THE SOUTHEAST 1/4 OF
- SECTION 16, TOWN 3 NORTH, RANGE 16 WEST AS HAVING A BEARING OF
- ELEVATIONS HEREON ARE BASED ON THE NORTH AMERICAN VERTICAL DATUM OF 1988 (NAVD '88).
- SOURCE BENCHMARK MICHIGAN DEPARTMENT OF TRANSPORTATION CONTINUOUSLY OPERATING SYSTEM (CORS) - MIHO (HOLLAND)
- UTILITIES SHOWN HEREON ARE BASED UPON VISIBLE ABOVE GROUND OBSERVATIONS AT THE TIME OF THE FIELD SURVEY. THEY SHOULD NOT BE INTERPRETED TO BE EXACT LOCATIONS NOR SHOULD IT BE ASSUMED THAT THEY ARE THE ONLY UTILITIES IN THIS AREA. THIS SURVEY SHOULD NOT BE RELIED UPON TO DEPICT THE LOCATION OF ALL UNDERGROUND UTILITIES.
 - NOTE: CONNECTIVITY AS SHOWN HEREON IS BASED UPON BEST AVAILABLE INFORMATION. HOWEVER, LACKING EXCAVATION, THE EXACT LOCATION OF ALL UNDERGROUND FEATURES CANNOT BE ACCURATELY,
- COMPLETELY AND RELIABLY DEPICTED. ALL UTILITIES AND BELOW GROUND IMPROVEMENTS, IF ANY, WERE NOT LOCATED UNDER THE SCOPE OF THIS SURVEY.
- PER THE FLOOD INSURANCE RATE MAP CITY OF THE VILLAGE OF DOUGLAS ALLEGAN COUNTY, MICHIGAN MAP NUMBER: 26005C0164G EFFECTIVE DATE: JUNE 21, 2023

THE SUBJECT PARCEL LIES IN ZONE X, AREA OF MINIMAL FLOOD HAZARD, AND IS IN NOT IN A FLOOD HAZARD AREA

DATE OF FIELD SURVEY: MAY 15, 2025.

LEGEND

- SECTION CORNER O SET 1/2 DIA. STEEL BAR W/ CAP #45504
- FOUND 1/2" DIA. STEEL BAR W/ CAP "HEI" → FOUND 1/2" DIA. STEEL BAR W/ CAP #16042
- & DESIGNATED HANDICAP PARKING
- S SANITARY MANHOLE

- STORM CATCH BASIN BEE-HIVE
- FIRE HYDRANT WATER VALVE
- ---- SPRINKLER VALVE MONITORING WELL
- ELECTRIC METER
- ELECTRIC PANEL
- ** YARD LAMP
- GAS METER ABOVE GROUND UTILITY MARKER W/ TEST LEADS
- UTILITY POLE TELEPHONE RISER
- AIR CONDITIONER
- FLAG POLE BOLLARD
- ← SHRUB
- LARGE ROCK
- DECIDUOUS TREE ★ CONIFEROUS TREE

- ROAD RIGHT-OF-WAY LINE ------ UNDERGROUND SANITARY LINE ----- UNDERGROUND STORM LINE OVERHEAD UTILITY LINE

- WOOD FENCE LINE . LANDSCAPING LINE __ 611 ---NINOR CONTOUR ` MAJOR CONTOUR

CONCRETE SURFACE ASPHALT SURFACE GRAVEL SURFACE

(D) - DESCRIBED DIMENSION (M) - MEASURED DIMENSION

INV. - INVERT

ADDRESS: 60 E WILEY RD

PARCEL NUMBER: 59-016-096-21

N 89°07'04" E 256.86' (D&M) ELEV. - ELEVATION PVC - POLY VINYL CHLORIDE REMON. - REMONUMENTATION L.C.R.C. - LAND CORNER RECORDATION CERTIFICATE OF PARCEL LINE 1.4' TO GARAGE CORNER CONCRETE CORNER 2.9' EAST ELEVATION = 631.36' ELEVATION = 631.34' #100 METAL FRAME BUILDING FINISHED FLOOR - FINISHED FLOOR ELEVATION = 631.36' RESIDENCE - STORM CB#1543 RIM ELEV. = 628.48' SSE 8" PVC INV. ELEV. = 626.99' ELEVATION = 631.30' #486 CONCRETE BLOCK PARCEL NUMBER: 59-016-096-10 ADDRESS: 52 E WILEY RD PARCEL NUMBER: 59-016-101-10 ADDRESS: 486 S WATER ST. CONCRETE CORNER 3.0' EAS OF PARCEL LINE BASKETBALL HOOP PROPANE TANK ON CONCRETE PAD **PARCEL** AREA = 1.000 ACRES PARCEL NUMBER: 59-016-101-00 ADDRESS: 100 E WILEY RD SANITARY MH#1803 BEE-HIVE STORM CB#1806 W 12" PVC INV. ELEV. = 627.25' SOUTHEAST CORNER, SECTION 16 — TOWN 3 NORTH, RANGE 16 WEST VILLAGE OF THE CITY OF DOUGLAS ALLEGAN COUNTY, MICHIGAN SOUTH 1/4 CORNER, SECTION 16 REMON. L.C.R.C. LIBER 13, PAGES 435-436 TOWN 3 NORTH, RANGE 16 WEST SANITARY MH#1954 VILLAGE OF THE CITY OF DOUGLAS ALLEGAN COUNTY, MICHIGAN WILEY ROAD RIM ELEV. = 630.19' 630 — 1279.62' (D&M) E 12" INV. ELEV. = 616.64' (66' WIDE PUBLIC RIGHT-OF-WAY) 256.86' (D&M) REMON. L.C.R.C. LIBER 13, PAGES 429-430 S 12" INV. ELEV. = 616.64' SANITARY MH#1670
RIM ELEV. = 631.16'
E 12" PVC INV. ELEV. = 615.93'
W 12" PVC INV. ELEV. = 615.93' STORM CB#1514 RIM ELEV. = 629.93' S 89°07'04" W 2611.77' (M) BEE-HIVE STORM CB#1921 -BEE-HIVE STORM CB#1959 -NNW 8" PVC INV. ELEV. = 626.74' W 12" PVC INV. ELEV. = 623.19' SOUTH LINE, SOUTHEAST 1/4, SECTION 16 W 12" PVC INV. ELEV. = 626.17' E 12" PVC INV. ELEV. = 623.14' E 12" PVC INV. ELEV. = 622.55' E 12" PVC INV. ELEV. = 626.23' SITE BENCHMARK NORTH-NORTHWEST FLANGE BOLT ON HYDRANT UNDER "W" ELEVATION = 631.29' (NAVD '88)

> 100 E. Wiley Rd - Interurban Transit Authority - Site Plan Received #1 - 8/20/2025 Reviewed #1 - 9/10/2025 - 2102-CM

Approved #1 per Review #1 - 9/10/2025 - 2102-CM

V-101

O MIDWE


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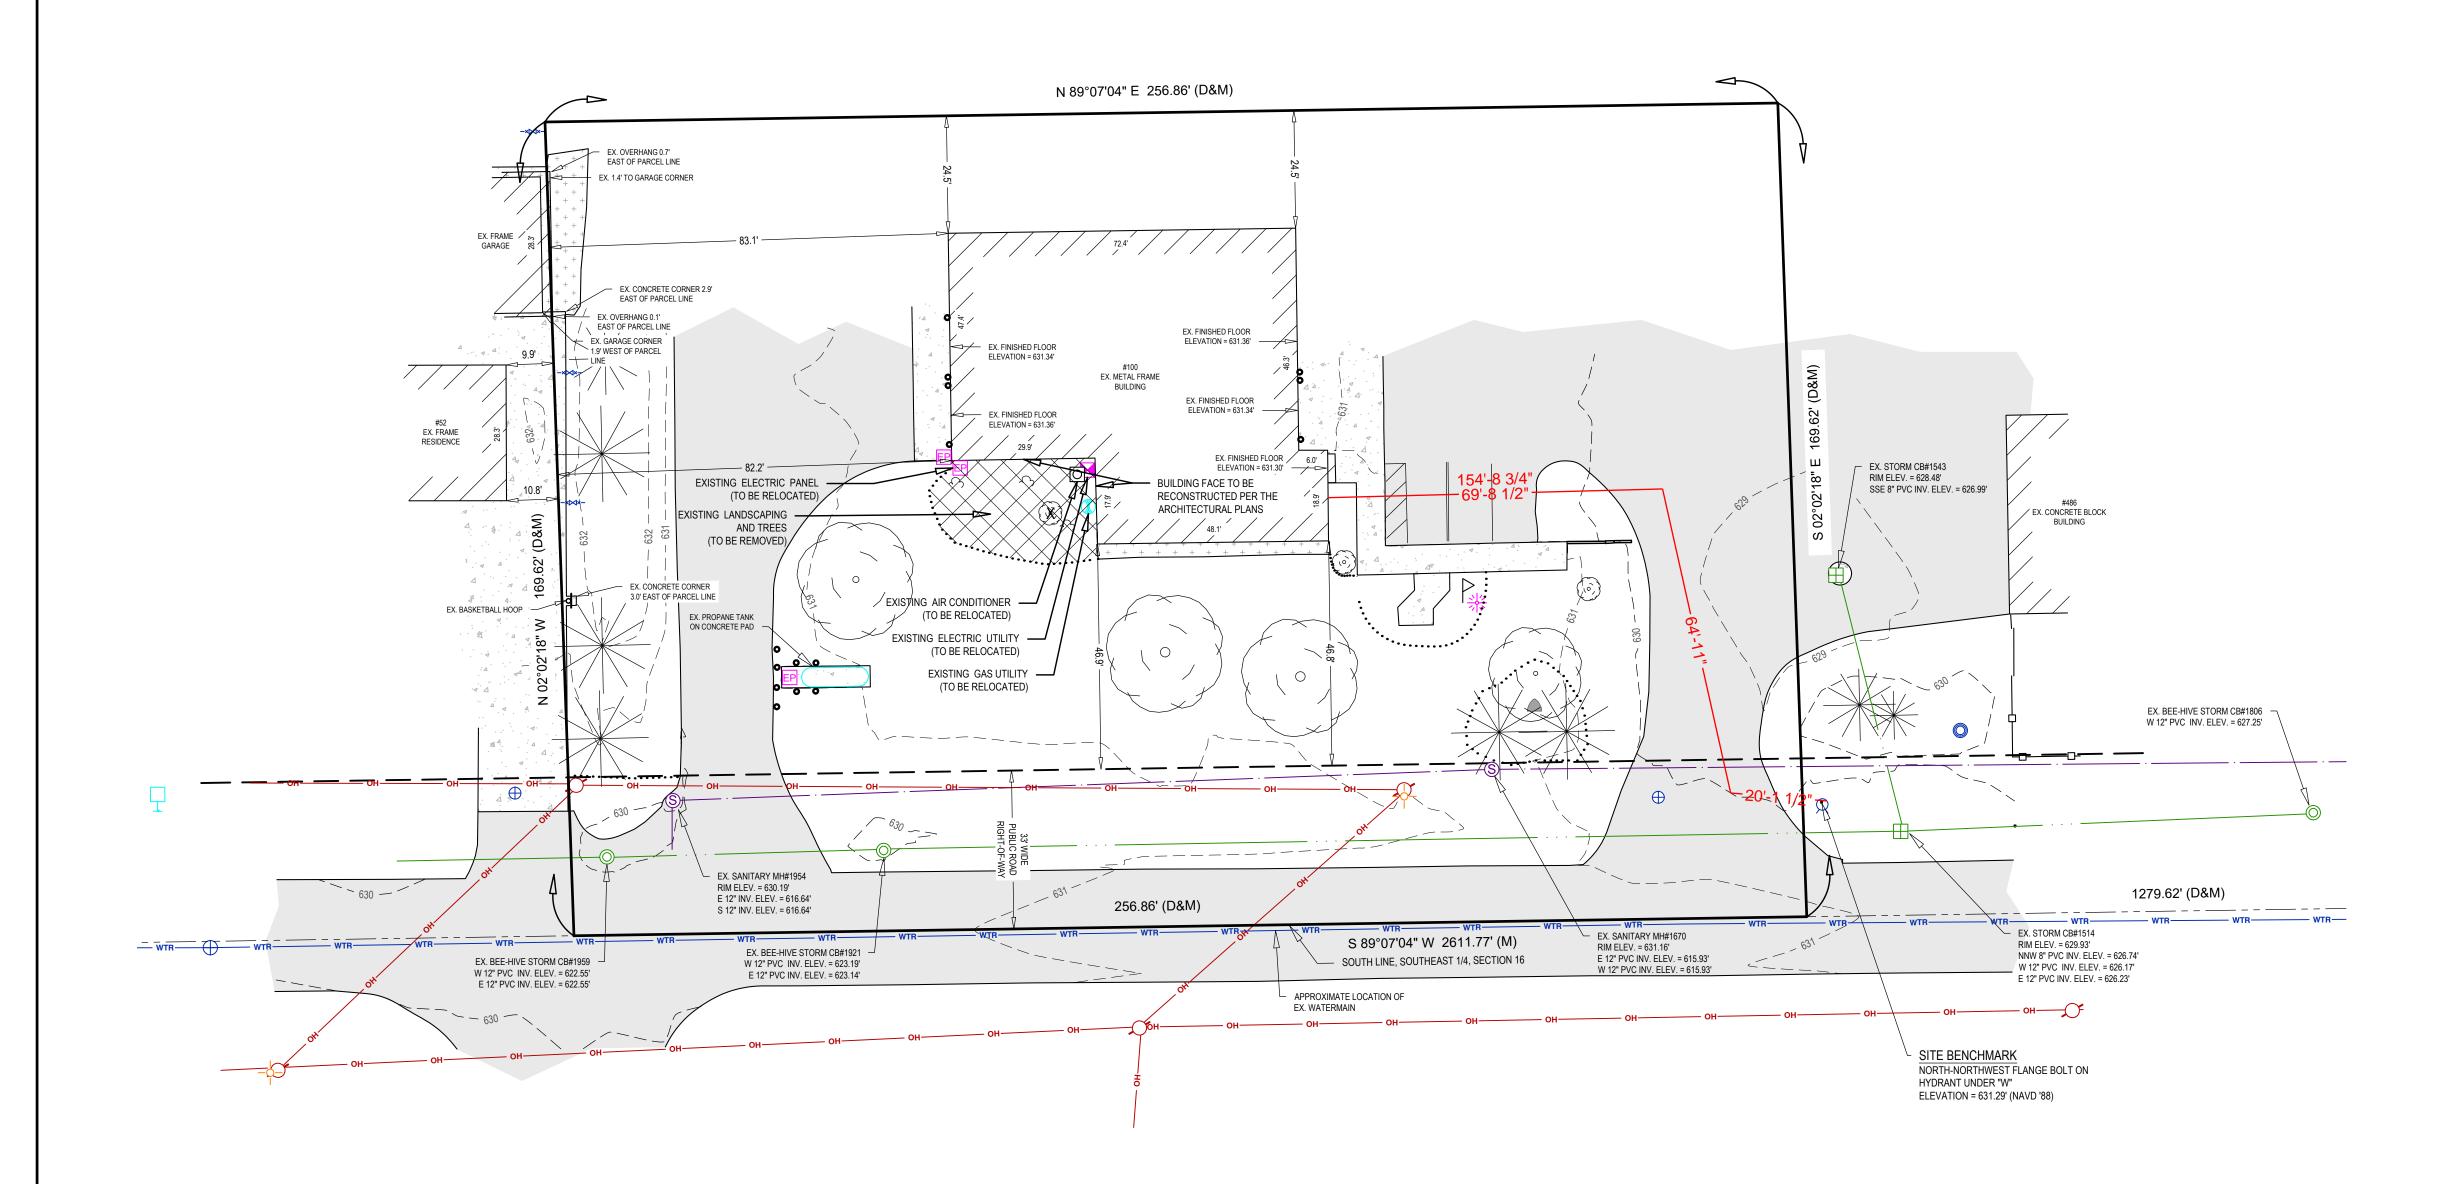
Project Manager RYAN T. YSSELDYKE Vertical Datum Horz. Datum LOCAL

NAVD '88 Drawn by JOHN M. RANKIN Checked by Survey JCD 06/03/2025

Civil Struc. L. A. HEI Project Number

25-04-050 **EXISTING CONDITIONS**



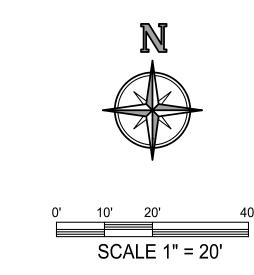

INFORMATION.

- CIVIL DEMOLITION NOTES: 1. SEE BOUNDARY AND TOPOGRAPHIC SURVEY SHEET FOR PROPERTY, EASEMENT, BENCHMARK, ETC.
- 2. LOCATION OF UNDERGROUND UTILITIES HAVE BEEN SHOWN BASED ON SURFACE EVIDENCE AND RECORD INFORMATION AVAILABLE. IT IS THE CONTRACTOR'S RESPONSIBILITY TO VERIFY UTILITY LOCATIONS PRIOR TO CONSTRUCTION.
- 3. DURING CONSTRUCTION, CONTRACTOR SHALL PROTECT ALL EXISTING AND NEW CONSTRUCTION FROM DAMAGE, SHOULD ANY DAMAGE OCCUR, CONTRACTOR SHALL MAKE ALL NECESSARY REPAIRS AT NO COST TO THE OWNER. THE PAVED ROADWAY SHALL BE SWEPT CLEAN AS NEEDED, BUT AT LEAST ONCE A WEEK.
- 4. CONTRACTOR SHALL PROVIDE BARRIERS, AS NECESSARY, TO PREVENT PEDESTRIAN AND VEHICULAR TRAFFIC FROM ENTERING THE CONSTRUCTION SITE.
- 5. CALL MISS DIG AT LEAST THREE (3) WORKING DAYS PRIOR TO STARTING ANY EXCAVATION. 6. REMOVAL ITEMS ARE SHOWN BASED ON BEST AVAILABLE INFORMATION AND ARE SHOWN SCHEMATICALLY. THE CONTRACTOR SHALL VISIT THE SITE PRIOR TO VERIFY THE EXTENT OF WORK
- 7. REMOVE ALL STRUCTURES, CONCRETE CURB, CONCRETE PAVING, ASPHALT PAVING, TREES, STUMPS, UTILITIES, AND OTHER EXISTING SITE FEATURES WITHIN THE LIMITS OF DEMOLITION. ALL DEMOLITION MATERIALS SHALL BE REMOVED FROM THE SITE UNLESS OTHERWISE NOTED AND DISPOSED OF IN A MANNER ACCEPTABLE TO THE LOCAL AUTHORITY HAVING JURISDICTION.
- 8. ALL UTILITY LINES SHOWN "X" OUT SHALL BE PHYSICALLY REMOVED ALONG WITH STRUCTURES AND APPURTENANCES. CONTRACTOR SHALL CONFIRM UTILITY LINES REMOVED WILL NOT IMPACT UTILITIES TO REMAIN.
- 9. ALL REMOVALS OF PAVEMENT, CONCRETE, CURB AND GUTTER, ETC. SHALL BE PERFORMED TO THE NEXT JOINT BEYOND THE LIMITS OF REMOVAL. ALL REMOVALS SHALL BE PERFORMED BY
- 10. PROTECT ALL TREES AND SHRUBS NOT SCHEDULED FOR REMOVAL. DO NOT OPERATE EQUIPMENT, STORE, STOCKPILE, OR PARK WITHIN DRIP LINE. HOLD NECESSARY DISTURBANCE TO
- 11. ALL TREE STUMPS SHALL BE REMOVED TO BELOW GRADE BY EITHER GRINDING OR COMPLETE REMOVAL IN ALL CASES NO WOODCHIPS AND/OR STUMPS SHALL BE LEFT IN PLACE.
- 12. IT IS THE CONTRACTOR'S RESPONSIBILITY TO COORDINATE ALL UTILITIES REMOVALS WITH PROPERTY OWNER AND UTILITY PROVIDER.
- ALLEGAN COUNTY ROAD COMMISSION, AND THE CITY OF THE VILLAGE OF DOUGLAS. 14. SEE OTHER SHEETS IN PLAN SET FOR MORE INFORMATION.

100 E. Wiley Rd - Interurban Transit Authority - Site Plan Received #1 - 8/20/2025

Reviewed #1 - 9/10/2025 - 2102-CM Approved #1 per Review #1 - 9/10/2025 - 2102-CM 13. ALL WORK IN ROAD RIGHTS OF WAY SHALL BE COMPLETED IN ACCORDANCE WITH MDOT, THE

16 S ELM STREET ZEELAND, MI 49464

- DOUGLAS . 16 T3N, R16W F DOUGLAS, AGE (4) SEC (5) CITY (5) TY, MI

DDITION

Project Manager RYAN T. YSSELDYKE, P.E. Vertical Datum Horz. Datum LOCAL

NAVD '88

Drawn by AARON VENEMA Checked by Survey


Civil Struc. L. A.

HEI Project Number 25-04-050


CIVIL **DEMOLITION**

NOTE:

THE INTERURBAN TRANSIT AUTHORITY IS OPERATED BY THE CITY OF THE VILLAGE OF DOUGLAS, THE CITY OF SAUGATUCK AND SAUGATUCK TOWNSHIP. INTERURBAN PROVIDES PUBLIC TRANSPORTATION SERVICES WITHIN THE PREVIOUSLY LISTED JURISDICTIONS, AND THE PROPOSED BUILDING ADDITION CONFORMS TO THE SPECIAL LAND USES FOR R-1 ZONING, AS THE BUILDING IS ASSOCIATED WITH PUBLIC FACILITIES.

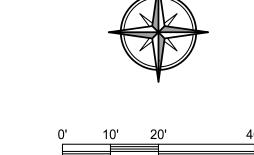

SCALE 1" = 20'

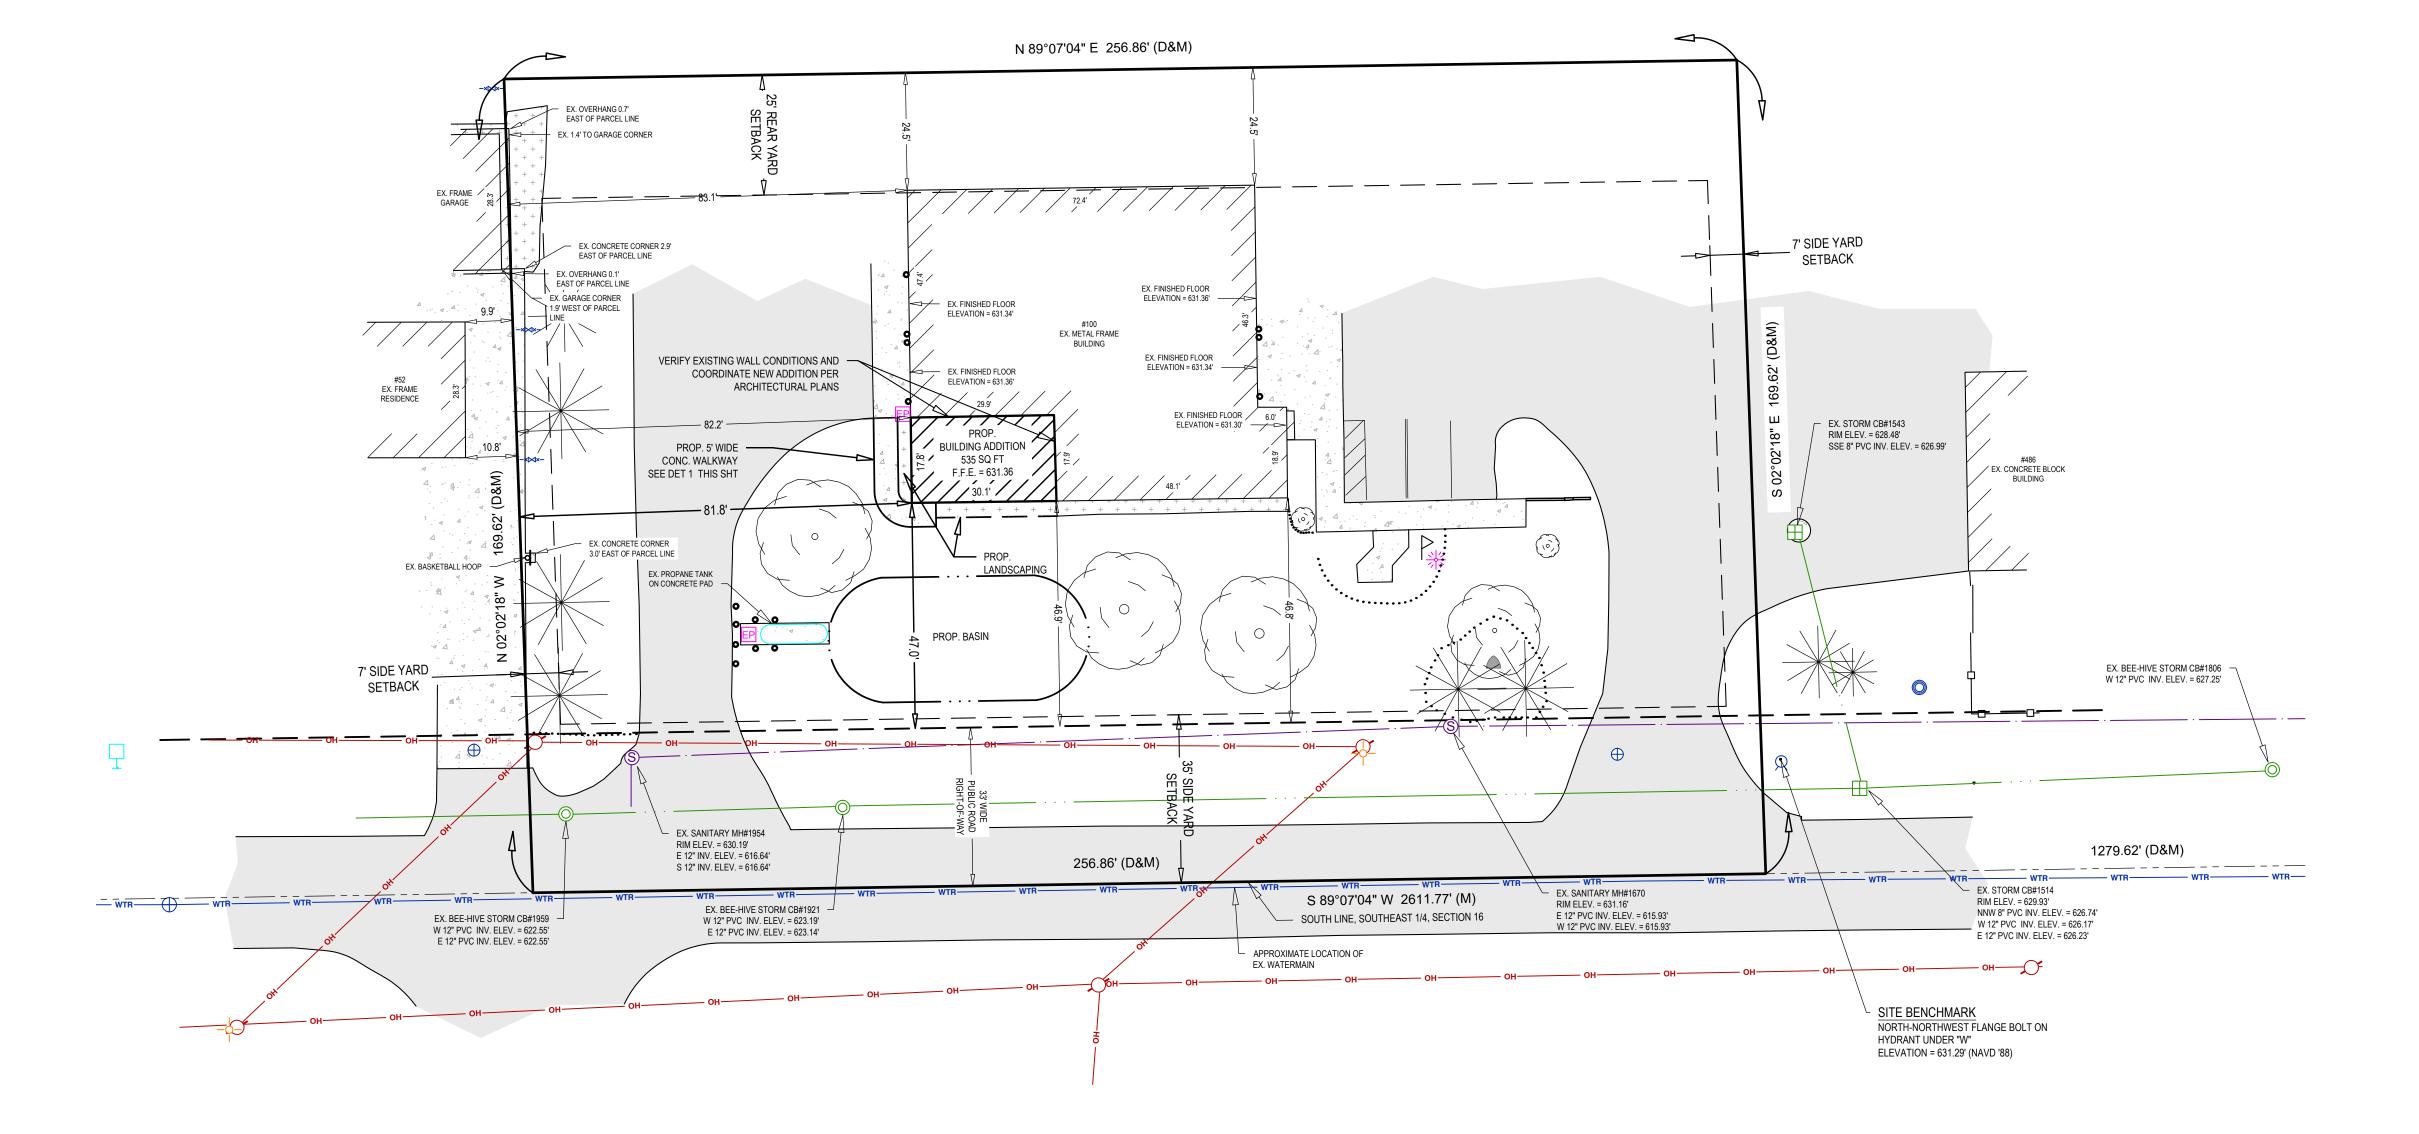

LAYOUT & UTILITY NOTES:

- 1. SITE DESIGN WAS DEVELOPED IN ACCORDANCE WITH THE INFORMATION CONTAINED IN THE GEOTECHNICAL REPORT AND SOIL BORINGS COMPLETED FOR THE PROJECT. CONTRACTOR SHALL ACQUIRE A COPY OF THE GEOTECHNICAL REPORT AND SOIL BORING INFORMATION. SOIL CONDITIONS MAY VARY FROM THE GEOTECHNICAL INFORMATION, WHICH MAY AFFECT THE SITE DESIGN, EARTHWORK QUANTITIES, USABLE SOILS, AND SOIL EROSION AND SEDIMENTATION CONTROL PRACTICES. CONTRACTOR SHALL NOTIFY DESIGN ENGINEER AND GEOTECHNICAL ENGINEER IF SITE CONDITIONS VARY FROM SOILS INFORMATION CONTAINED IN THE GEOTECHNICAL
- 2. IT IS THE CONTRACTOR'S RESPONSIBILITY TO VERIFY THAT ALL NECESSARY PERMITS AND APPROVALS HAVE BEEN ACQUIRED PRIOR TO CONSTRUCTION.
- 3. CALL MISS DIG AT LEAST THREE (3) WORKING DAYS PRIOR TO STARTING ANY EXCAVATION.
- 4. CONTRACTOR SHALL CONTACT ENGINEER IF ANY DISCREPANCIES ARE DETERMINED BETWEEN SITE LAYOUT DIMENSIONS AND ACTUAL SITE CONDITIONS.
- 5. COORDINATE ALL UTILITY CONSTRUCTION WITH UTILITY PROVIDER, AS REQUIRED.
- 6. CONTRACTOR SHALL VERIFY THAT THERE ARE NO UTILITY CONFLICTS PRIOR TO CONSTRUCTION.
- 7. ALL SANITARY SEWER WORK SHALL BE CONSTRUCTED IN ACCORDANCE WITH THE CURRENT EDITION OF THE KALAMAZOO LAKE SEWER AND WATER AUTHORITY STANDARDS & SPECIFICATIONS. 8. ALL WATERMAIN, WATER SERVICES, AND FIRE PROTECTION LINES SHALL BE INSTALLED IN
- ACCORDANCE WITH THE CURRENT EDITION OF THE KALAMAZOO LAKE SEWER AND WATER AUTHORITY STANDARDS & SPECIFICATIONS. 9. ALL WORK WITHIN THE PUBLIC ROAD RIGHT-OF-WAY WILL REQUIRE A PERMIT AND OR APPROVAL FROM THE ALLEGAN COUNTY ROAD COMMISSION AND SHALL BE CONSTRUCTED IN ACCORDANCE
- WITH THE CURRENT EDITION OF THEIR STANDARDS & SPECIFICATIONS. 10. COORDINATE ALL SIGNAGE REMOVAL AND RELOCATION WITHIN THE RIGHT-OF-WAY WITH
- ALLEGAN COUNTY ROAD COMMISSION. 11. SITE CONTRACTOR RESPONSIBLE TO CONNECT EXISTING AND PROPOSED BUILDING TO WATER SERVICE AND SANITARY SEWER LATERAL, REFER TO PLUMBING PLANS FOR CONNECTION LOCATION
- 12. REFER TO ARCHITECTURAL DRAWINGS FOR BUILDING DIMENSIONS. BUILDING SHALL BE STAKED BASED ON FOUNDATION PLAN. CONTRACTOR SHALL NOTIFY ENGINEER IF THERE ARE
- DISCREPANCIES BETWEEN THE BUILDING AND SITE DRAWINGS. 13. ONSITE LIGHTING SHALL DIRECTED DOWNWARD AND AWAY FROM ADJACENT PROPERTIES AS
- REQUIRED PER THE CITY OF THE VILLAGE OF DOUGLAS ZONING ORDINANCE. 14. SITE SIGNAGE SHALL MEET THE STANDARDS AND REQUIREMENTS OF THE CITY OF THE VILLAGE OF DOUGLAS ZONING ORDINANCE. A SIGN PERMIT SHALL BE ACQUIRED PRIOR TO CONSTRUCTION.
- 15. CONTRACTOR SHALL BE RESPONSIBLE TO MEETING THE STANDARDS AND REQUIREMENTS OF THE LOCAL NOISE ORDINANCE FOR ALL CONSTRUCTION PRACTICES. 16. SEE OTHER SHEETS IN PLAN SET FOR MORE INFORMATION.

100 E. Wiley Rd - Interurban Transit Authority - Site Plan Received #1 - 8/20/2025 Reviewed #1 - 9/10/2025 - 2102-CM Approved #1 per Review #1 - 9/10/2025 - 2102-CM

DDITION T3N, R16W OUGLAS, 70 6 70 70

Issued for:	Description	06/03/2025 EXISTING CONDITIONS TOPOG	06/24/2025 SITE LAYOUT PLAN						
	Date	/60/90	06/24/						
Proj	ect	Maı	nag	er				•	
RY	ΆN	ΙT.	YS	SSE	ELC)Yk	Œ,	P.E	Ξ.
Vort	iool	Da	tum	\Box	ПΩ	rz	Dati	ıım	

NAVD '88 LOCAL Drawn by AARON VENEMA Checked by Survey

Civil Struc. L. A.

HEI Project Number 25-04-050

LAYOUT PLAN

S.E.S.C. LEGEND MICHIGAN UNIFIED KEYING SYSTEM


S51	SILT FENCE	**************************************	Use adjacent to critical areas, to prevent sediment laden sheet flow from entering these areas.
S58	INLET PROTECTION FABRIC DROP		Use at stormwater inlets, especially at construction sites.


DISTURBANCE AREA: 0.08 ACRES


PROPOSED CONSTRUCTION SCHEDULE

A OTIV /ITV/	2025														2026								
ACTIVITY		AUG		SEP				OCT				NOV			DEC					JA	ıN		
INSTALL CONTROLS								\dashv		_	\dashv	_	+	+	+							-	\rightarrow
CLEARING					\rightarrow																		
GRADE														$ \neq $									
UTILITIES								\exists	\rightarrow														
BUILDING								\exists			1	4	1	7	+					\rightarrow			
PAVING																				\rightarrow			
RESTORE																					\rightarrow		

*NOTE: CONSTRUCTION SCHEDULE MAY VARY BASED ON CONTRACTOR'S SCHEDULE. CONTRACTOR SHALL UPDATE THE OCWRC IF CONSTRUCTION SCHEDULE VARIES FROM ABOVE.

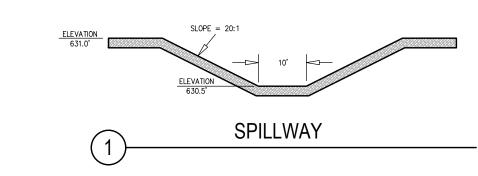


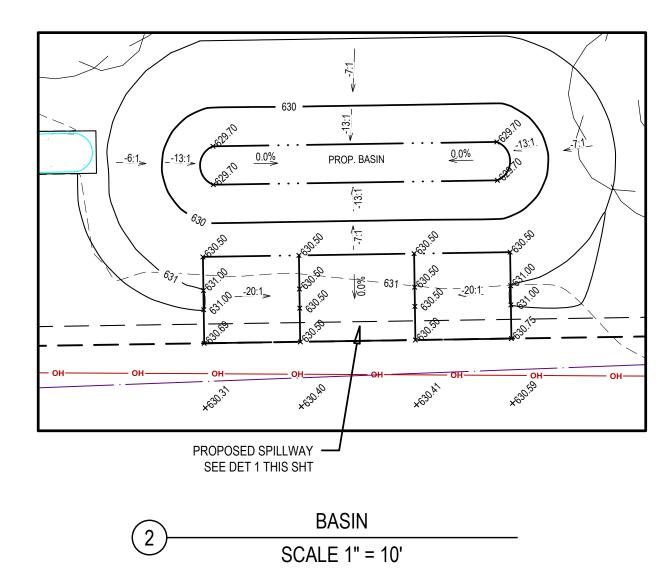

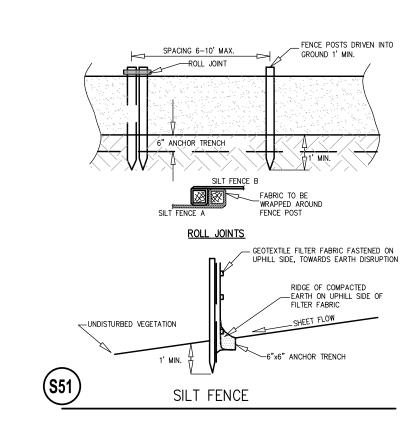

0' 10' 20'

SCALE 1" = 20'

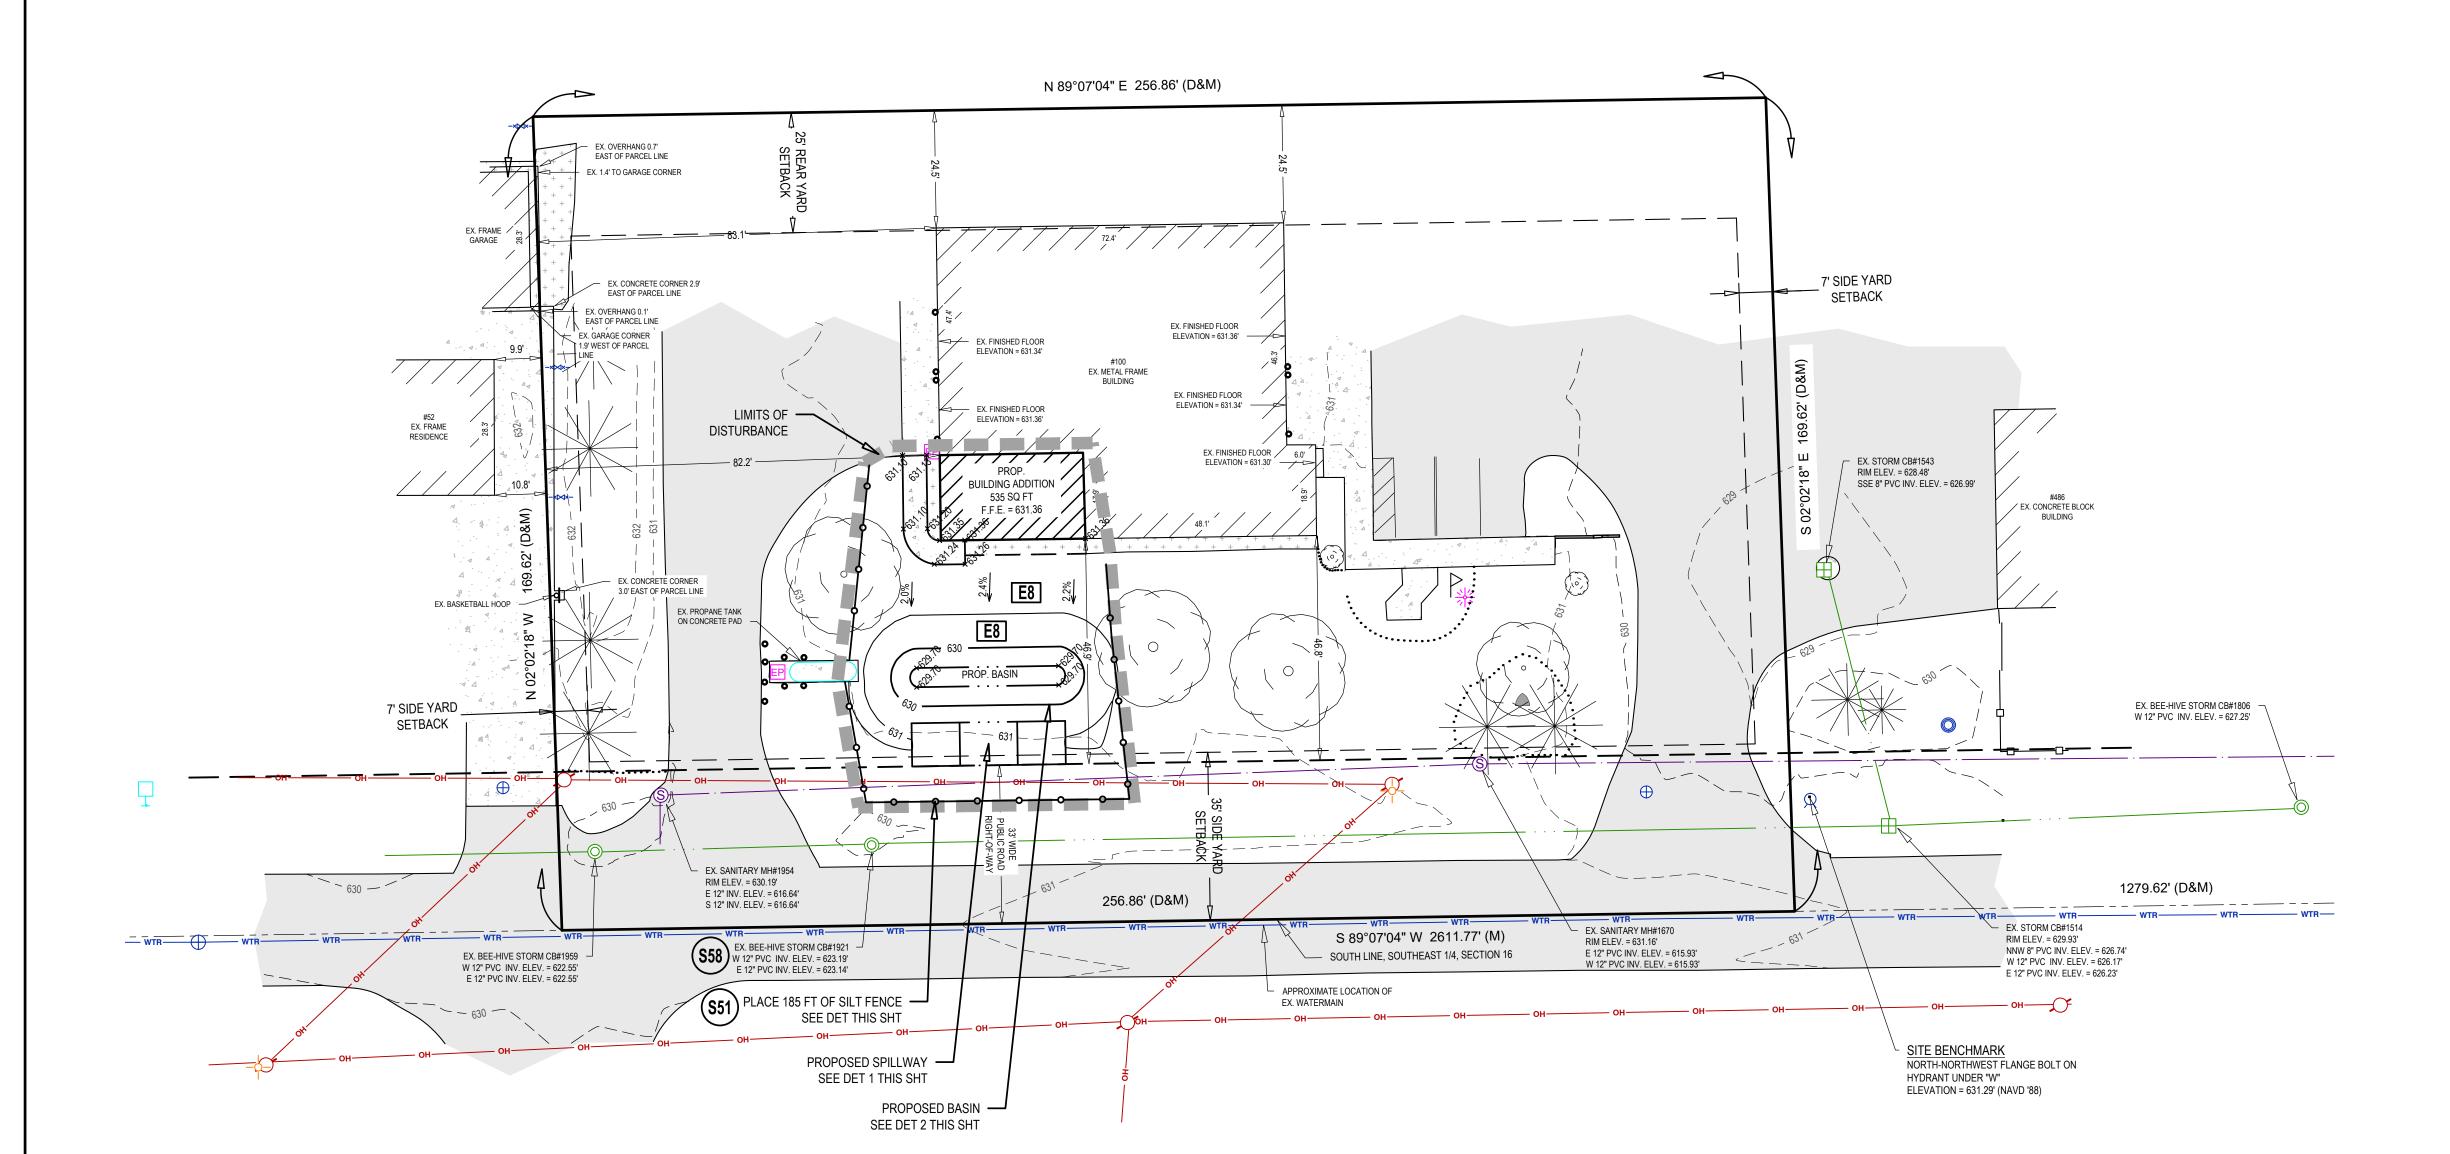

GRADING & STORM SEWER NOTES

- 1. IT IS THE CONTRACTOR'S RESPONSIBILITY TO VERIFY THAT ALL NECESSARY PERMITS AND APPROVALS HAVE BEEN ACQUIRED PRIOR TO CONSTRUCTION.
- 2. SITE DESIGN WAS DEVELOPED IN ACCORDANCE WITH THE INFORMATION CONTAINED IN THE GEOTECHNICAL REPORT AND SOIL BORINGS COMPLETED FOR THE PROJECT. CONTRACTOR SHALL ACQUIRE A COPY OF THE GEOTECHNICAL REPORT AND SOIL BORING INFORMATION. SOIL CONDITIONS MAY VARY FROM THE GEOTECHNICAL INFORMATION, WHICH MAY AFFECT THE SITE DESIGN, EARTHWORK QUANTITIES, USABLE SOILS, AND SOIL EROSION AND SEDIMENTATION CONTROL PRACTICES. CONTRACTOR
- SHALL NOTIFY DESIGN ENGINEER AND GEOTECHNICAL ENGINEER IF SITE CONDITIONS VARY FROM SOILS INFORMATION CONTAINED IN THE GEOTECHNICAL INFORMATION. 3. CALL MISS DIG AT LEAST THREE (3) WORKING DAYS PRIOR TO STARTING ANY
- 4. CONTRACTOR SHALL VERIFY THAT THERE ARE NO UTILITY CONFLICTS PRIOR TO CONSTRUCTION.
- 5. ALL WORK WITHIN THE RIGHT-OF-WAY WILL REQUIRE A PERMIT AND OR APPROVAL FROM ALLEGAN COUNTY ROAD COMISSION AND SHALL BE CONSTRUCTED IN ACCORDANCE WITH THE CURRENT EDITION OF THEIR STANDARDS & SPECIFICATIONS.
- THE ALLEGAN COUNTY DRAIN COMMISSION STORM WATER ORDINANCE. 7. SITE CONTRACTOR RESPONSIBLE TO CONNECT STORM / ROOF WATER TO STORM DRAIN

6. STORM WATER MANAGEMENT SYSTEM AND GRADING SHALL BE IN ACCORDANCE WITH

- AS SHOWN. REFER TO PLUMBING PLANS FOR CONNECTION TO THE BUILDING AND
- 8. SITE SHALL BE GRADED WITH SMOOTH CONTOURS IN ALL AREAS OF DISTURBANCE AND GRADED TO SLOPE AWAY FROM THE EXISTING AND PROPOSED BUILDINGS AND 9. ALL STORM SEWER PIPING SHALL BE ADS N-12, HANCOR HI-Q OR APPROVED EQUIVALENT
- POLYETHYLENE (PE) PLASTIC PIPE AND FITTINGS, UNLESS OTHERWISE NOTED. WHERE SPECIFIED IN THE PLANS, CONCRETE CLASS IV PIPE WITH RUBBER GASKETS IS
- 10. SEE OTHER SHEETS IN PLAN SET FOR MORE INFORMATION.

STORM WATER INFILTRATION BASIN NOTES:

- 1. CONTRACTOR SHALL OBTAIN ALL NECESSARY STATE AND LOCAL PERMITS AS NECESSARY FOR CONSTRUCTION.
- 2. CALL MISS DIG AT LEAST THREE (3) WORKING DAYS PRIOR TO STARTING ANY
- 3. THIS PROJECT RELIES ON THE INFILTRATION OF RUNOFF TO PROVIDE STORMWATER MANAGEMENT FOR THE SITE IMPROVEMENTS. THEREFORE, ALL APPROPRIATE MEASURES SHALL BE TAKEN TO MINIMIZE COMPACTION OF ONSITE SOILS IN THE AREA OF THE INFILTRATION BASIN AND/OR INFILTRATION TRENCHES.
- 4. CONTRACTOR SHALL CONSTRUCT SIDE SLOPES OF THE STORM WATER INFILTRATION BASIN UTILIZING A BOBCAT OR SMALL MECHANIZED EQUIPMENT IN AN EFFORT TO MAINTAIN THE INFILTRATION PROPERTIES OF THE SIDE SLOPES.
- 5. IF THE WATER TABLE IS ENCOUNTERED DURING CONSTRUCTION, THE CONTRACTOR SHALL CONTACT THE ENGINEER IMMEDIATELY TO VERIFY THAT THE WATER TABLE ELEVATION UTILIZED IN THE DESIGN MATCHES THE WATER TABLE ELEVATION WITNESSED ONSITE DURING CONSTRUCTION.
- 6. ONSITE SOILS WITHIN THE LIMITS OF THE INFILTRATION BASIN WERE DETERMINED TO BE TEKENINK LOAMY FINE SAND BASED ON USDA SOIL SURVEY DATA. SHOULD CONTRACTOR ENCOUNTER OTHER SOILS WITHIN THE LIMITS OF THE STORM WATER INFILTRATION BASIN AND/OR INFILTRATION TRENCHES, THE CONTRACTOR SHALL NOTIFY THE ENGINEER IMMEDIATELY SO THAT DESIGN CHANGES CAN BE MADE AS NECESSARY.
- 7. STORM WATER MANAGEMENT BASIN SHALL BE CONSTRUCTED IN ACCORDANCE WITH THE ALLEGAN COUNTY DRAIN COMMISSION MOST CURRENT STANDARDS AND REQUIREMENTS.
- 8. EXISTING ONSITE INFILTRATIVE SOILS SHALL BE LEFT IN PLACE WITHIN THE INFILTRATION
- 9. NO FILL OR ORGANIC MATERIAL SHALL BE PLACED WITHIN THE INFILTRATION BASIN, WITH THE EXCEPTION OF THE TOPSOIL AND SEED.
- 10. FOLLOWING CONSTRUCTION COMPLETION. THE CONTRACTOR SHALL REMOVE ANY SILT OR SEDIMENT THAT HAS ACCUMULATED IN THE STORM WATER INFILTRATION BASIN PRIOR TO FINAL RESTORATION.
- 11. THE STORM WATER MANAGEMENT BASIN WAS DESIGNED TO PROVIDE CAPACITY FOR 241 CUBIC FEET OF STORAGE. CONTRACTOR SHALL CONSTRUCT BASIN PER THE DESIGN DRAWINGS TO ACHIEVE THIS STORAGE VOLUME.
- 12. STORM SEWER AND STORMWATER BASIN AS-BUILTS AND CERTIFICATION, IS REQUIRED BY ALLEGAN COUNTY DRAIN COMISSION. CONTRACTOR SHALL NOTIFY ENGINEER WHEN CONSTRUCTION IS COMPLETED, PRIOR TO FINAL RESTORATION, TO PERFORM THE AS-BUILT SURVEY. CONTRACTOR IS RESPONSIBLE TO CORRECT ANY DEFICIENCIES' NOTED DURING AS-BUILT SURVEY
- 13. AFTER FINAL RESTORATION AND PROJECT COMPLETION, PROPERTY OWNER SHALL COMPLETE MAINTENANCE AND CLEANING PER THE SIGNED MAINTENANCE AGREEMENT. 14. SEE OTHER SHEETS IN PLAN SET FOR MORE INFORMATION.

- 1. CONTRACTOR SHALL OBTAIN ALL STATE AND LOCAL PERMITS AS NECESSARY FOR CONSTRUCTION.
- 2. SITE DESIGN WAS DEVELOPED IN ACCORDANCE WITH THE INFORMATION CONTAINED IN THE GEOTECHNICAL REPORT AND SOIL BORINGS COMPLETED FOR THE PROJECT. CONTRACTOR SHALL ACQUIRE A COPY OF THE GEOTECHNICAL REPORT AND SOIL BORING INFORMATION. SOIL CONDITIONS MAY VARY FROM THE GEOTECHNICAL INFORMATION, WHICH MAY AFFECT THE SITE DESIGN, EARTHWORK QUANTITIES, USABLE SOILS, AND SOIL EROSION AND SEDIMENTATION CONTROL PRACTICES. CONTRACTOR SHALL NOTIFY DESIGN ENGINEER AND GEOTECHNICAL ENGINEER IF SITE CONDITIONS VARY FROM SOILS INFORMATION CONTAINED IN THE GEOTECHNICAL INFORMATION.
- 3. CONTRACTOR IS RESPONSIBLE TO ACQUIRE THE ALLEGAN COUNTY HEALTH DEPARTMENT SOIL EROSION AND SEDIMENTATION CONTROL PERMIT AND THE NPDES NOTICE OF COVERAGE AND COMPLY WITH ALL PERMIT REQUIREMENTS AND WITH ALL STANDARDS AND REQUIREMENTS OF THE AGENCIES HAVING JURISDICTION.
- 4. BEST MANAGEMENT PRACTICES SHALL BE UTILIZED DURING AND AFTER CONSTRUCTION FOR TEMPORARY AND PERMANENT SOIL EROSION AND SEDIMENTATION CONTROL
- 5. CONTRACTOR SHALL PROVIDE A CERTIFIED STORM WATER OPERATOR FROM CONSTRUCTION COMMENCEMENT THROUGH FINAL SITE STABILIZATION. 6. THE TEMPORARY SOIL EROSION CONTROL MEASURES SHALL BE INSPECTED AND
- MAINTAINED WEEKLY AND AFTER EACH SIGNIFICANT RAIN EVENT IN ACCORDANCE WITH THE EGLE REQUIREMENTS. 7. CALL MISS DIG AT LEAST THREE (3) WORKING DAYS PRIOR TO STARTING ANY
- EXCAVATION. 8. ALL WORK SHALL BE DONE IN ACCORDANCE WITH THE CITY OF THE VILLAGE OF DOUGLAS AND THE ALLEGAN COUNTY ROAD COMMISSION STANDARDS AND SPECIFICATIONS.
- 9. SOIL EROSION CONTROL MEASURES SHALL BE PLACED PRIOR TO EARTH MOVING OR GROUND DISTURBANCE AND REMAIN IN PLACE UNTIL FINAL RESTORATION HAS BEEN ESTABLISHED. 10. THE STORM WATER MANAGEMENT BASIN SHALL BE CONSTRUCTED FIRST.
- CONTRACTOR IS RESPONSIBLE TO REMOVE SEDIMENT FROM BOTTOM OF DETENTION BASIN UNTIL THE SITE IS FULLY STABILIZED. 11. ALL FOREIGN MATERIAL OR DEBRIS FROM JOB SITE WHICH IS DEPOSITED ON PAVED
- ROADWAY SHALL BE REMOVED IMMEDIATELY. 12. THE PAVED ROADWAY SHALL BE SWEPT CLEAN AS NEEDED, BUT AT LEAST ONCE A
- 13. SOIL EROSION CONTROL MEASURES ARE THE RESPONSIBILITY OF THE CONTRACTOR DURING CONSTRUCTION AND THE OWNER UPON COMPLETION. 14. CONTRACTOR SHALL PHASE THE PLACEMENT OF THE SOIL EROSION CONTROL MEASURES AS NECESSARY FOR THE SITE IMPROVEMENTS WITHIN THE LIMITATIONS OF
- THE ACQUIRED SOIL EROSION CONTROL PERMIT 15. STOCKPILE AREAS SHALL BE STABILIZED WITH TEMPORARY OR PERMANENT SEED IN ACCORDANCE WITH THE ALLEGAN COUNTY HEALTH DEPARTMENT SOIL EROSION AND SEDIMENTATION CONTROL REQUIREMENTS. ALL EXCESS SPOILS SHALL BE REMOVED
- 16. ALL EXCESS SPOILS SHALL BE HAULED OFFSITE AND LEGALLY PLACED IN AN UPLAND AREA NOT ENCUMBERED BY WETLANDS OR FLOODPLAIN. 17. THERE SHALL BE NO EARTH MOVEMENT OR DISTURBANCE OUTSIDE THE LIMITS OF DISTURBANCE WITHOUT PRIOR AUTHORIZATION FROM THE ALLEGAN COUNTY HEALTH
- 18. THE MINIMUM AMOUNT OF SOIL EROSION AND SEDIMENTATION CONTROL MEASURES ARE SHOWN THE DRAWINGS. CONTRACTOR SHALL PROVIDE ADDITIONAL CONTROL MEASURES, MAINTENANCE, AND/OR STABILIZATION MEASURES AS NECESSARY FOR
- CONSTRUCTION ACTIVITIES. 19. SEE OTHER SHEETS IN PLAN SET FOR MORE INFORMATION.

100 E. Wiley Rd - Interurban Transit Authority - Site Plan Received #1 - 8/20/2025 Reviewed #1 - 9/10/2025 - 2102-CM Approved #1 per Review #1 - 9/10/2025 - 2102-CM

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Project Manager

RYAN T. YSSELDYKE, P.E Vertical Datum Horz. Datum NAVD '88 LOCAL Drawn by AARON VENEMA

Checked by Survey Civil Struc.

HEI Project Number 25-04-050

L. A.

GRADING **DRAINAGE &** SESC PLAN