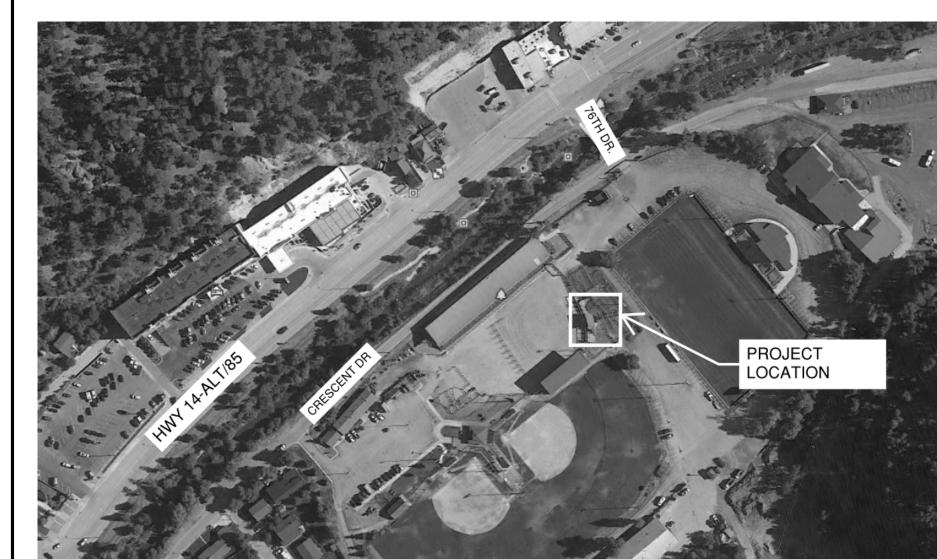
DAYS OF '76 CROW'S NEST ADDITION DEADWOOD, SOUTH DAKOTA **100% CD SUBMITTAL**

VICINITY MAPS

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OWNEF 108 SH DEADV 605-57

STRUCTURAL ENGINEER ALBERTSON ENGINEERING INC. 3202 W. MAIN ST SUITE C RAPID CITY, SD 57701

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PROJECT TEAM

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F DEADWOOD
IERMAN ST
NOOD, SD 57732
8-2082

SHEET INDEX

<u>SHEET</u> 1	<u>GENERAL</u> G001	COVER SI
<u>SHEET</u> 2 3 4 5 6 7 8 9 10 11 12 13 14	STRUCTURAL S001 S002 S003 S004 SB101 SB102 SB103 SB501 SF104 SF104 SF105 SF106 SF107 SF501	STRUCTU IBC INSPE 3D REPRE STANDAR FOUNDAT FOUNDAT FOUNDAT DETAILS DECK FRA DECK FRA VERTICAL DETAILS
<u>SHEET</u> 15 16 17 18 19 20 21 22 23 23 24	ARCHITECTUR A001 A002 A101 A102 A121 A201 A301 A302 A501 A611	<u>AL</u> NOTE, SY CODE CH LOWER LI UPPER LE REFLECTI EXTERIOF ENLARGE BUILDING ARCHITEC
<u>SHEET</u> 25 26 27 28 29 30 31 32	ELECTRICAL E000 E001 E101 E102 E201 E202 E400 E500	ELECTRIC ELECTRIC LOWER LI UPPER LE LOWER LI UPPER LE ELECTRIC ELECTRIC

605.343.9606 Ibertson Engineering In ONSULTAN PROJECT IDEN: DAYS OF '76 CROW'S **NEST ADDITION VER SHEET** SUE BLOCK: ISSUE TYPE) 100% CD **RUCTURAL GENERAL NOTES INSPECTION TABLES** REPRESENTATIONS ANDARD DETAILS / SCHEDULES UNDATION PLAN - OVERALL JNDATION PLAN - ZONE 1 UNDATION PLAN - ZONE 2 CK FRAMING PLAN - OVERALL ECK FRAMING PLAN - ZONE 1 ECK FRAMING PLAN - ZONE 2 RTICAL LIFT ROOF FRAMING PLAN MANAGEMENT: PROJECT NO: 17-356 DTE, SYMBOLS, ABBREVIATIONS AND WALL TYPES DRAWN BY: MDR CHECKED BY: JDS DDE CHECKLIST AND LIFE SAFETY PLAN WER LEVEL - FLOOR PLAN SHEET TITLE: PPER LEVEL - FLOOR PLAN **COVER SHEET** EFLECTED CEILING PLAN **(TERIOR ELEVATIONS** ILARGED STAIR PLANS & DETAILS ILARGED STAIR PLAND & DETAILS JILDING SECTIONS RCHITECTURAL DETAILS - EXTERIORS ECTRICAL LEGEND AND SHEET INDEX ECTRICAL SPECIFICATIONS WER LEVEL - LIGHTING PLAN PPER LEVEL - LIGHTING PLAN WER LEVEL - POWER AND SYSTEMS PLAN SHEET IDENTIFICATION: PPER LEVEL - POWER AND SYSTEMS PLAN ECTRICAL SCHEDULES G001 ECTRICAL RISER, PANEL SCHEDULE AND DETAILS

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GENERAL NOTES:

- STRUCTURAL DRAWINGS SHALL BE USED IN CONJUNCTION WITH JOB SPECIFICATIONS AND ARCHITECTURAL, MECHANICAL, ELECTRICAL, PLUMBING AND SITE DRAWINGS. CONSULT THESE DRAWINGS FOR SLEEVES, DEPRESSIONS AND OTHER DETAILS NOT SHOWN ON STRUCTURAL DRAWINGS.
- ALL DIMENSIONS AND CONDITIONS MUST BE VERIFIED IN THE FIELD. ANY DISCREPANCIES SHALL BE BROUGHT TO THE ATTENTION OF THE ENGINEER BEFORE PROCEEDING WITH THE AFFECTED PART OF THE WORK.
- THE STRUCTURE IS DESIGNED TO BE SELF SUPPORTING AND STABLE AFTER THE BUILDING IS COMPLETE. IT IS THE CONTRACTOR'S SOLE RESPONSIBILITY TO DETERMINE ERECTION PROCEDURES AND SEQUENCE TO ENSURE SAFETY OF THE BUILDING AND ITS COMPONENTS DURING ERECTION. THIS INCLUDES THE ADDITION OF NECESSARY SHORING, SHEETING, TEMPORARY BRACING (AND ACCOMPANYING FOOTINGS), GUYS OR TIE-DOWNS.
- ADDITIONAL OBSERVATIONS AS A RESULT OF REJECTION OF WORK COMPLETED AND/OR ADDITIONAL OBSERVATIONS DUE TO THE DEFICIENCIES IN WORK OBSERVED WILL BE AT THE EXPENSE OF THE CONTRACTOR.
- ALL STRUCTURAL SHOP DRAWINGS TO BE REVIEWED BY JOB SUPERINTENDENT IN ADDITION TO ALL PERSONNEL DEEMED NECESSARY BY CONTRACTOR PRIOR TO SUBMITTAL TO ENGINEER FOR APPROVAL.
- ALL SHOP DRAWINGS TO BE REVIEWED BY ALBERTSON ENGINEERING INC. SHALL HAVE ELECTRONIC COPIES PROVIDED TO ALBERTSON ENGINEERING INC. FOR REVIEW. AN ELECTRONIC MARKED SET OF THOSE DRAWINGS WILL BE RETURNED TO THE CONTRACTOR. NO ADDITIONAL HARD COPIES OF THE SHOP DRAWINGS NEED TO BE PROVIDED TO ALBERTSON ENGINEERING INC., ALTHOUGH OTHER PARTIES MAY REQUIRE HARD COPIES OF THE MARKED UP DRAWINGS. THESE REQUIREMENTS ARE IN ADDITION TO THE TYPICAL PROJECT SHOP DRAWING SUBMITTAL REQUIREMENTS STATED IN THE PROJECT SPECIFICATIONS.
- THE DESIGN OF THE STRUCTURE SHOWN IN THESE CONSTRUCTION THE GEOTECHNICAL REPORT.

DESIGN CODES:

- 2018 INTERNATIONAL BUILDING CODE.
- ACI 318-14 BUILDING CODE REQUIREMENTS FOR STRUCTURAL CONCRETE AND COMMENTARY.
- AISC 360-16 SPECIFICATIONS FOR STRUCTURAL STEEL BUILDINGS.
- ASCE 7-16 MINIMUM DESIGN LOADS AND ASSOCIATED CRITERIA FOR BUILDINGS AND OTHER STRUCTURES.
- NDS 2018 NATIONAL DESIGN SPECIFICATIONS FOR WOOD CONSTRUCTION.

DESIGN LOADS:

THE STRUCTURAL SYSTEM FOR THIS BUILDING HAS BEEN DESIGNED WITH THE FOLLOWING SUPERIMPOSED LOADINGS:

ROOF: SNOW LOAD	30 PSF + DRIFT + SLIDING
GROUND SNOW LOAD DEAD LOAD	42 PSF 15 PSF
DECKS & STAIRS: LIVE LOAD (VERTICAL) DEAD LOAD (VERTICAL) LIVE LOAD (HORIZONTAL) SNOW LOAD	100 PSF 20 PSF 12 PSF 50 PSF
WIND: ULTIMATE WIND SPEED EXPOSURE CATEGORY IMPORTANCE FACTOR	115 MPH C 1.0
SEISMIC: SEISMIC: GROUP SEISMIC DESIGN CATEGORY SITE CLASSIFICATION	l B D

FOUNDATIONS:

- FOUNDATIONS ARE DESIGNED FOR AN ALLOWABLE SOIL BEARING PRESSURE OF 3,000 PSF. ON EXISTING SOILS. BEFORE CONSTRUCTION COMMENCES, SOIL BEARING CAPACITY SHALL BE VERIFIED BY A SUBSURFACE INVESTIGATION, A CERTIFIED TESTING LABORATORY, WHOSE REPORT SHALL INCLUDE ANALYSIS AND RECOMMENDATIONS FOR SITE PREPARATION IN ORDER TO BEAR THE FOUNDATION LOADS. ABOVE REPORT SHALL BE SUBMITTED TO THE STRUCTURAL ENGINEER FOR REVIEW BEFORE FOUNDATION CONSTRUCTION BEGINS, COST OF REPORT SHALL BE PAID DIRECTLY BY THE CITY OF DEADWOOD. CONTRACTOR IS RESPONSIBLE FOR SCHEDULE COORDINATION.
- BASE BID TO ASSUME ADEQUATE SUBGRADE SOILS EXIST AND MINIMAL (12" MAX DEPTH), IF ANY, SCARIFICATION, MOISTURE CONDITIONING, AND RECOMPACTION OF EXISTING SOILS BELOW FOOTINGS.

PLUMBING SLEEVES:

MINIMUM SLEEVE SPACING SHALL BE TWO DIAMETERS CENTER TO CENTER TO THE LARGER SLEEVE OR 6" CLEAR BETWEEN SLEEVES, WHICHEVER IS GREATER. PRIOR TO CONSTRUCTION SLEEVE LOCATIONS AND SIZES SHALL BE APPROVED BY THE STRUCTURAL ENGINEER OF RECORD.

PENETRATIONS:

NO PENETRATIONS SHALL BE MADE IN ANY STRUCTURAL MEMBERS OTHER THAN THOSE LOCATED ON THESE DRAWINGS WITHOUT PREVIOUS APPROVAL OF THE ENGINEER.

FORMWORK AND SHORING:

NO STRUCTURAL CONCRETE SHALL BE STRIPPED UNTIL IT HAS REACHED AT LEAST TWO-THIRDS OF THE 28 DAY DESIGN STRENGTH. DESIGN, ERECTION AND REMOVAL OF ALL FORMWORK, SHORES AND RESHORES SHALL MEET THE REQUIREMENTS SET FORTH IN ACI STANDARDS 301 AND 347.

CONCRETE MIX DESIGN:

SHALL BE MIX DESIGNED BY A RECOGNIZED TESTING LABORATORY TO ACHIEVE A STRENGTH AT 28 DAYS AS LISTED BELOW WITH A PLASTIC AND WORKABLE MIX:

1. 4,000 PSI - ALL CONCRETE

CONCRETE MIX DESIGN CONTINUED:

- 2. SUBMIT PROPOSED MIX DESIGN WITH RECENT FIELD CYLINDER OR LAB TESTS CONCRETE TESTING S FOR REVIEW PRIOR TO USE. MIX SHALL BE UNIQUELY IDENTIFIED BY MIX NUMBER OR OTHER POSITIVE IDENTIFICATION. CONCRETE SHALL COMPLY WITH ALL THE REQUIREMENTS OF ASTM STANDARD C94 FOR MEASURING, MIXING, TRANSPORTING, ETC. CONCRETE TICKETS SHALL BE TIME STAMPED WHEN CONCRETE IS BATCHED. THE MAXIMUM TIME ALLOWED FROM THE TIME THE MIXING WATER IS ADDED UNTIL IT IS DEPOSITED IN ITS FINAL POSITION SHALL NOT EXCEED ONE AND ONE HALF (1-1/2) HOURS. IF FOR ANY REASON THERE IS A LONGER DELAY THAN STATED ABOVE. THE CONCRETE SHALL BE DISCARDED. IT SHALL BE THE RESPONSIBILITY OF THE TESTING LAB TO NOTIFY THE OWNER'S REPRESENTATIVE AND THE CONTRACTOR OF ANY NONCOMPLIANCE WITH THE ABOVE. ALL SLABS SHALL BE CURED USING CURING COMPOUND MEETING ASTM STANDARD C309 TYPE 1 AND SHALL HAVE A FUGITIVE DYE. THE COMPOUND SHALL BE PLACED AS SOON AS THE FINISHING IS COMPLETED OR AS SOON AS THE WATER HAS LEFT THE UNFINISHED CONCRETE. ALL SCUFFED OR BROKEN AREAS IN THE CURING MEMBRANE SHALL BE RECOATED DAILY. CALCIUM CHLORIDES SHALL NOT BE UTILIZED; OTHER ADMIXTURES MAY BE USED ONLY WITH THE APPROVAL OF THE ENGINEER.
- 3. CONCRETE SHALL UTILIZE TYPE I/II CEMENT W/ MINIMUM 20% FLY-ASH CONTENT BY WEIGHT.
- 4. THE CONCRETE STRENGTHS SHOWN IN THE SECTION ABOVE AND IN THE SPECIFICATIONS ARE MINIMUM COMPRESSIVE STRENGTHS. THE ENGINEER SHALL DETERMINE IF THE CONCRETE IS ACCEPTABLE, OR TO BE REMOVED, OR TO RECEIVE SPECIAL CURING IF THE COMPRESSIVE STRENGTHS ARE LESS THAN SPECIFIED.
- 5. ALL CONCRETE SHALL BE AIR ENTRAINED TO 5% TO 7%.
- 6. WATER REDUCING AGENTS MAY BE USED IN THE CONCRETE MIX. PLASTICIZERS AND SUPER-PLASTICIZERS MAY BE USED ONLY WHEN WRITTEN PERMISSION OF THE ENGINEER IS GIVEN.
- DOCUMENTS IS FOR THE ONE-TIME USE AT THE SPECIFIC SITE REFERENCED IN 7. NO SALTS OF ANY KIND MAY BE USED IN CONCRETE BEFORE OBTAINING THE ENGINEER'S WRITTEN PERMISSION FOR THEIR USE.
 - 8. MAXIMUM WATER TO CEMENTITIOUS MATERIAL FOR ALL CONCRETE SHALL NOT EXCEED 0.5 UNLESS NOTED OTHERWISE.

9.	MAXIMUM SLUMP LIMITS:	
	SLAB ON GRADE	3" ±1"
	FOOTINGS	4" ±1"
	ALL OTHER CONCRETE	4" ±1"

CONCRETE AND REINFORCING PLACEMENT:

- 1. ALL CONCRETE SHALL BE PLACED IN ACCORDANCE WITH ACI 301 AND ACI 117 EXCEPT AS MODIFIED BELOW:
- A. <u>ACI 117 ITEM 4.3.1.1</u> ELEVATIONS OF SLABS-ON-GRADE TOP OF SLAB ELEVATION SHALL BE WITHIN A 3/8" ENVELOPE EITHER SIDE OF THE THEORETICAL DESIGN SURFACE.
- ACI 117 ITEM 4.5.7 FLOOR FINISH TOLERANCES AS MEASURED BY PLACING A FREESTANDING (UNLEVELED) 10 FT. STRAIGHTEDGE ANYWHERE ON THE SLAB AND ALLOWING IT TO REST UPON TWO HIGH SPOTS WITHIN 28 DAYS AFTER SLAB CONCRETE PLACEMENT. THE GAP AT ANY POINT BETWEEN THE STRAIGHT EDGE AND THE FLOOR SHALL NOT EXCEED 1/4".
- 2. ALL REINFORCING STEEL TO BE ASTM A615. GRADE 60 (#4 AND LARGER). EXCEPT WHERE NOTED OTHERWISE. REINFORCING SHALL NOT BE WELDED
- 3. ALL REINFORCING STEEL BARS TO BE DETAILED AND PLACED IN ACCORDANCE WITH THE LATEST ACI MANUALS.
- 4. LAP ALL REINFORCING SPLICES IN CONCRETE A MINIMUM OF 48 BAR DIAMETERS OR 24 INCHES, WHICHEVER IS GREATER, UNLESS NOTED OTHERWISE ON DRAWINGS (CLASS B SPLICE).
- 5. PROVIDE FOUNDATION DOWELS AS SHOWN. MINIMUM SIZE DOWELS TO BE # 4, UNLESS OTHERWISE NOTED. ALL VERTICAL REINFORCING STEEL IN COLUMNS AND PIERS, OR VERTICAL REINFORCING IN WALLS, SHALL BE DOWELED INTO THE FOOTINGS WITH SAME SIZE AND QUANTITY DOWEL AS THE VERTICAL REINFORCING.
- 6. WHERE SHOWN ON THE DRAWINGS, PROVIDE WELD PLATES, WELDMENTS, OR CONCRETE INSERTS FOR FASTENING AND SECURING OTHER COMPONENTS. CONCRETE INSERTS SHALL BE FURNISHED BY THE CONTRACTOR REQUIRING THEM AND INSTALLED BY THE CONTRACTOR CASTING THE CONCRETE AROUND THEM. CLIP ANGLES SHALL BE FURNISHED 6. CONTRACTOR SHALL BY THE CONTRACTOR REQUIRING THEM.
- 7. REINFORCING STEEL SHALL RECEIVE CONCRETE COVER AS FOLLOWS:

DESCRIPTION	MINIMUM COVER
CAST AGAINST & PERMANENTLY EXPOSED TO EARTH	3"
EXPOSED TO EARTH OR WEATHER #6 THROUGH #18 BARS #5 BARS OR SMALLER	2" 1 1/2"
NOT EXPOSED TO EARTH OR WEATHER OR IN CONTACT WITH THE GROUND, SLABS AND WALLS #11 BARS OR SMALLER	3/4"
#14 AND #18	1 1/2"
BEAMS AND COLUMNS	1 1/2"
SHELLS, FOLDED PLATE MEMBERS: NO. 6 BAR AND LARGER NO. 5 BAR, W31 OR D31 WIRE AND SMALLER	3/4" 1/2"

8. COLD WEATHER AND HOT WEATHER PROVISIONS OF ACI 306 AND 305 (CURRENT EDITIONS), RESPECTIVELY, SHALL BE MAINTAINED.

GENERAL STRUCTURAL NC

- AGE AS FOLLOWS: a. AT 7 DAYS b. AT 28 DAYS C. PROVIDE ONE ADD
- DIRECTION OF THE ACHIEVED, THE A
- E. IN ADDITION TO TY SAMPLES SHALL BE PLACEMENT AND R PLACEMENT SHALL CONTINUE OF TES
- F. IF ANY SLUMP OR IMMEDIATELY REPO SUBSEQUENT LOAI COMPLIANCE PRIC FOR USE ON PROJ CREDITED TO THE

CHEMICAL ANCHORS

SHALL BE A POLYMER INJ EQUAL, INSTALLED IN ACC INSTALLERS SHALL BE TRA

ANCHOR BOLTS:

- 1. SHALL BE A36 THREAD ANCHOR BOLTS PERM PRESSURE TREATED I
- 2. THREADED ROD EMBE FROM TOP OF CONCRE

STRUCTURAL STEEL


- 1. STEEL SHALL CONFOR ASTM A36 (Fy=36 KSI) F STRUCTURAL TUBING STRUCTURAL PIPE SHA (Fy=35 KSI).
- A. WHERE INDICATED A242.
- 2. STEEL SHALL CONFOR STRUCTURAL STEEL B
- 3. ALL SHOP CONNECTIC FIELD CONNECTIONS RECEIVE ONE SHOP C PAINT, EXCEPT WHER
- 4. WELDS FOR ALL EXPO
- UNLESS NOTED OTHE 5. ALL BOLTED CONNEC
- STRENGTH BOLTS, UN A. FAILURE OF A BOLT
- A CRACK IN THE B THE FAILED BOLTS DOCUMENTATION BOLT(S) DOES NOT OR NUT(S) SHALL FAILED NUT(S) OR
- STEEL AND ARCHITECT CODE OF STANDARD P
- 7. ANCHOR BOLT HOLES THAN 1/8" MAX, UNLESS

<u>WOOD:</u>

- 1. STRUCTURAL WOOD (DOUGLAS FIR #1 OR BE ALLOWABLE FIBER STI
- MODULUS OF ELAS
- BENDING (Fb) SHEAR (Fv)
- 2. ALL WOOD SHALL BE AWPA UC4B.
- 3. MEMBER SIZES SHOWN
- 4. BOLTS IN WOOD ARE M BOLTS SHALL HAVE A S ARE ASTM 307 STEEL. STEEL IS CONNECTED PROVIDE STANDARD (AGAINST WOOD. WHE PLATE SHALL BE USED

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TURAL NOTES			SYME		GEND
 CDUCRETE TESTING SHALL BE PAID FOR BY THE OWNER. TESTING LABORATORY SHALL PERFORM THE FOLLOWING TEST ON CAST-IN-PLACE CONCRETE: A OCRETE TESTING SHALL BE PAID FOR BY THE OWNER. TESTING LABORATORY SHALL PERFORM THE FOLLOWING TEST ON CAST-IN-PLACE CONCRETE: A STM C143 - 'STANDARD TEST METHOD FOR SLUMP OF PORTLAND CEMENT CONDUCTED FOR EACH CLASS, FOR EVERY S0 CUBIC YARDS (OR FRACTION TAGE AS FOLLOWS: a. AT DAYS A T 20 AYS A T 20 AYS TESTING SHALL BE BASED UPON CONCRETE TAKEN AT POINT OF PLACEMENT ACIE AS FOLLOWS: a. AT 20 DAYS TESTING SHALL BE BASED UPON CONCRETE TAKEN AT POINT OF PLACEMENT ACIE AS FOLLOWS: ACIE AS FOLLOWS: TESTING SHALL BE BASED UPON CONCRETE TAKEN AT POINT OF PLACEMENT IN ADDITION TO TYPICAL TESTING REQUIREMENTS, SLUMP AND AIR CONTENT SACHEVED, THE ADDITIONAL CYLINDER(S) MAY BE DISCARDED. TESTING SHALL BE TAKEN AT BEGINNING OF FIRST TRUCK PRIOR TO ANY PLACEMENT AND REPATED AT THE MIDDLE OF FIRST TRUCK PRIOR TO ANY PLACEMENT AND REPATED AT THE MIDDLE OF FIRST TRUCK PRIOR TO ANY PLACEMENT AND REPATED AT THE MIDDLE OF FIRST TRUCK PRIOR TO ANY PLACEMENT AND REPATED AT THE MIDDLE OF FIRST TRUCK PRIOR TO ANY PLACEMENT AND REPATED AT THE MIDDLE OF FIRST TRUCK PRIOR SHALL BE INMEDIATELY REPORTED AND RETAKEN. IF RETAKEN TESTS FALL THEN ALL BUSEQUEVEL LOADS MUST BE TESTED AT ARRIVAL AND TEST MUST SHALL BE STALL BE A POLYMER INJECTION SYSTEM SUCH AS HILLI HY-200, OR APPROVED EQUAL. INSTALLED IN ACCORDANCE WITH THE MANUFACTURERS INSTRUCTIONS. INSTALLED IN ACCORDANCE WITH THE MANUFACTURERS INSTRUCTIONS. INTALLER SHALL BE TRINED BY THE MANUFACTURERS INSTRUCTIONS. INSTALLED IN ACCORDANCE WITH THE MANUFACTURERS INSTRUCTIONS	 WOOD DECKING: 1. MATERIAL GRADE SHALL BE PER "WOOD" SECTION ABOVE AND SHALL BE SISTE WITH ROUGH SIDE INSTALLED UP. 2. SCREW EACH COURSE OF DECKING WITH (2) EXTERIOR GRADE #10x4 12" SCREW INTO EACH SUPPORTING MEMBER. 3. ALL DECKING SHALL END ABOVE A SUPPORTING FRAMING MEMBER. 4. PROVIDE 1/8" MAX SPACE BETWEEN ADJACENT, PARALLEL WOOD DECKING PLANKS. SPECIAL INSPECTION AND TESTING REQUIREMENTS AS INDICATED ON SHEET S002. 	TO THE SHEE NORTH (COLUMN INDICATOR(S) 20GA TYPE ' DECK IN C1 C1 C1 C1 C1 C1 C1 S C0LUMN/FND GRID INDICATOR GRID INDICATOR S S C0LUMN/FND GRID INDICATOR S	VDICATOR VDICATOR CALE: FULL CORNER REINF	"ØX -X"/XX'-X" OUT INDICATOR MATCH L SEE XN/X MATCH LINE F1 A FOOTING/PIER IDENTIFIER XN XN XN XN XN XN SECTION INDICATOR DETAIL/SECTION/PLAN LOCK TITLE INDICATOR MASONRY PIER	
 STRUCTURAL STEEL: STEEL SHALL CONFORM TO ASTM A992 (Fy=50 KSI) FOR ALL W-SHAPES, AND ASTM A36 (Fy=36 KSI) FOR ALL OTHER MISCELLANEOUS SHAPES AND PLATES. STRUCTURAL TUBING SHALL CONFORM TO ASTM A500, GRADE B (Fy=46 KSI). STRUCTURAL PIPE SHALL CONFORM TO ASTM A53, GRADE B, TYPE "E" OR "S" (Fy=35 KSI). A. WHERE INDICATED IN DRAWINGS, "CORTEN" STEEL SHALL BE ASTM A588 OR 		HIX HOLDOWN INDICATOR 5:12 SLOPE INDICATOR WORK POINT INDICATOR STR	B CORNER REINF INDICATOR Hx LINTEL INDICATOR ₩ ASTERISK INDICATOR W ASTERISK INDICATOR CONCRETE BRICK	DETAIL/SECTION/PLAI DOCK TITLE INDICATOR	R R R R R R R R R R R R R R

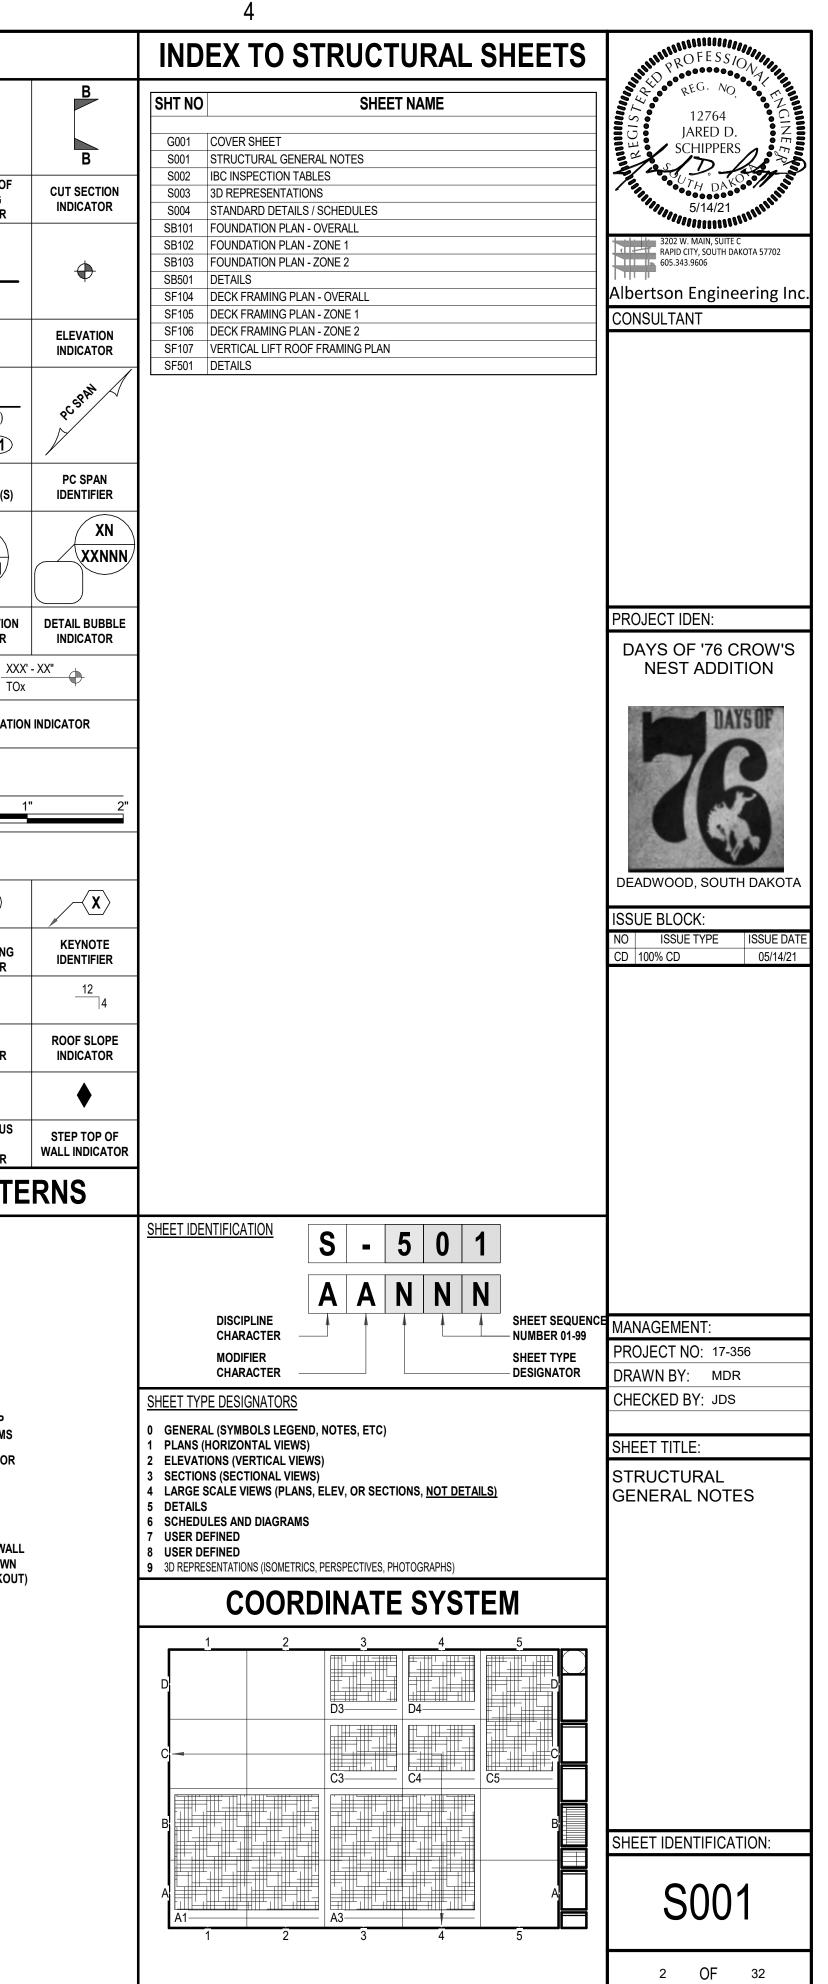


IBC 2018 TABLE 1705.3 REQUIRED SPECIAL INSPECTION

			CTION							
TYPE	CONTINUOUS SPECIAL INSPECTION	PERIODIC SPECIAL INSPECTION	REFERENCED STANDARD ^a	IBC REFERENCE	REQUIRED ON PROJECT	TABLE N5.4-1 INSPECTION TASKS PRIOR TO WELDING		AISC 360-16 TABLE N5.6- INSPECTION TASKS PRIOR TO I		
INSPECTION REINFORCEMENT, INCLUDING PRESTRESSING TENDONS, AND VERIFY PLACEMENT	-	X	ACI 318 CH 20, 25.2, 25.3, 26.6.1-26.6.3	1908.4	YES	INSPECTION TASKS PRIOR TO WELDING INSPECTION INTER	RVAL REQUIRED ON PROJECT	INSPECTION TASKS PRIOR TO BOLTING	INSPECTION INTERVA	AL REQUIRED ON PROJE
REINFORCING BAR WELDING:	-	X	AWS D1.4,			WELDER QUALIFICATION RECORDS AND CONTINUITY RECORDS P WELDING PROCEDURE SPECIFICATIONS (WPSs) AVAILABLE P	YES	MANUFACTURER'S CERTIFICATIONS AVAILABLE FOR FASTENER MATERIALS	0	YES
VERIFY WELDABILITY OF REINFORCING BARS OTHER THAN ASTM A706. INSPECT SINGLE-PASS FILLET WELDS, MAXIMUM 5/16".		v	AVVS D1.4, ACI 318: 26.6.4	-	NO	MANUFACTURER CERTIFICATIONS FOR WELDING CONSUMABLES AVAILABLE	YES	FASTENERS MARKED IN ACCORDANCE WITH ASTM REQUIREMENTS	0	YES
. INSPECT ALL OTHER WELDS	X	· ·	-			MATERIAL IDENTIFICATION (TYPE/GRADE)	YES	CORRECT FASTENERS SELECTED FOR THE JOINT DETAIL (GRADE, TYPE, BOLT LENGTH IF THREADS ARE TO EXCLUDED FROM SHEAR PLANE)	0	YES
NSPECT ANCHORS CAST IN CONCRETE.	-	X	ACI 318: 17.8.2	-	YES	WELDER IDENTIFICATION SYSTEM ^(a)	YES	CORRECT BOLTING PROCEDURE SELECTED FOR JOINT DETAIL	0	YES
NSPECT ANCHORS POST-INSTALLED IN HARDENED CONCRETE MEMBERS. ^b						FIT-UP OF GROOVE WELDS (INCLUDING JOINT GEOMETRY) JOINT PREPARATION 	2/50	CONNECTING ELEMENTS, INCLUDING THE APPROPRIATE FAYING SURFACE CONDITION AND HOLE PREPARATION, IF SPECIFIED, MEET APPLICABLE REQUIREMENTS	0	YES
ADHESIVE ANCHORS INSTALLED IN HORIZONTALLY OR UPWARDLLY INCLINED ORIENTATIONS TO RESIST SUSTAINED TENSION LOADS.	X		ACI 318: 17.8.2.4, ACI 318: 17.8.2	-	NO	 DIMENSIONS (ALIGNMENT, ROOT OPENING, ROOT FACE, BEVEL) CLEANLINESS (CONDITION OF STEEL SURFACES) TACKING (TACK WELD QUALITY AND LOCATION) 	YES	PRE-INSTALLATION VERIFICATION TESTING BY INSTALLATION PERSONNEL OBSERVED AND DOCUMENTED FOR FASTENER ASSEMBLIES AND METHODS USED	P	YES
MECHANICAL ANCHORS AND ADHESIVE ANCHORS NOT DEFINED IN 4A.		X			YES	FIT-UP OF CJP GROOVE WELDS OF HSS T-, Y- AND K-JOINTS WITHOUT BACKING JOINT PREPARATIONS DIMENSIONS (ALIGNMENT, ROOT OPENING, ROOT FACE, BEVEL) 	YES	PROTECTED STORAGE PROVIDED FOR BOLTS, NUTS, WASHERS AND OTHER FASTENER COMPONENTS	0	YES
VERIFY USE OF REQUIRED DESIGN MIX.	-	X	ACI 318: CH. 19, 26.4.3, 26.4.4	1904.1, 1904.2, 1908.2, 1908.3	YES	CLEANLINESS (CONDITION OF STEEL SURFACES) TACKING (TACK WELD QUALITY AND LOCATION)				
PRIOR TO CONCRETE PLACEMENT, FABRICATE SPECIMENS FOR STRENGTH TESTS, PERFORM SLUMP AND AIR CONTENT TESTS, AND DETERMINE THE TEMPERATURE OF THE CONCRETE.	X	-	ASTM C172, ASTM C31, ACI 318: 26.5, 26.12	1908.10	YES	CONFIGURATION AND FINISH OF ACCESS HOLES O FIT-UP OF FILLET WELDS • DIMENSIONS (ALIGNMENT, GAPS AT ROOT)	YES	AISC 360-16 TABLE N5.6- INSPECTION TASKS DURING B		
INSPECT CONCRETE AND SHOTCRETE PLACEMENT FOR PROPER APPLICATION TECHNIQUES	X	-	ACI 318: 26.5	1908.6, 1908.7, 1908.8	YES	O DIMENSIONS (ALIGNMENT, GAPS AT ROOT) CLEANLINESS (CONDITION OF STEEL SURFACES) TACKING (TACK WELD QUALITY AND LOCATION)	YES			REQUIRED ON PROJEC
VERIFY MAINTENANCE OF SPECIFIED CURING TEMPERATURE AND		v	ACI 318: 26.5.3-26.5.5	1908.9	YES	CHECK WELDING EQUIPMENT O	-			
TECHNIQUES.						^(a) THE FABRICATOR OR ERECTOR, AS APPLICABLE, SHALL MAINTAIN A SYSTEM BY WHICH A WELDER WHO HAS WELDE MEMBER CAN BE IDENTIFIED. STAMPS, IF USED, SHALL BE THE LOW-STRESS TYPE.	ED A JOINT OR	FASTENER ASSEMBLIES PLACED IN ALL HOLES AND WASHERS AND NUTS ARE POSITIONED AS REQUIRED	0	YES
NSPECT OF PRESTRESSED CONCRETE FOR:	X	-	A01040.00.40		NO			JOINT BROUGHT TO THE SNUG-TIGHT CONDITION PRIOR TO THE PRETENSIONING OPERATION	0	YES
. APPLICATION OF PRESTRESSING FORCES. . GROUTING OF BONDED PRESTRESSING TENDONS.	X	-	ACI 318: 26.10	-				FASTENER COMPONENT NOT TURNED BY THE WRENCH PREVENTED FROM ROTATING	0	YES
INSPECT ERECTION OF PRECAST CONCRETE MEMBERS.		X	ACI 318: CH. 26.9		NO			FASTENERS ARE PRETENSIONED IN ACCORDANCE WITH THE RCSC SPECIFICATION.	-	
VERIFY IN-SITU CONCRETE STRENGTH, PRIOR TO STRESSING OF TENDONS IN POST- TENSIONED CONCRETE AND PRIOR TO REMOVAL OF SHORES ANDFORMS FROM BEAMS		X	ACI 318: 26.11.2	-	NO	INSPECTION TASKS DURING WELDING		PROGRESSING SYSTEMATICALLY FROM THE MOST RIGID POINT TOWARD THE FREE EDGES	0	YES
AND STRUCTURAL SLABS.		+				INSPECTION TASKS DURING WELDING INSPECTION INTERVAL	L REQUIRED ON PROJECT			
INSPECT FORMWORK FOR SHAPE, LOCATION AND DIMENSIONS OF THE CONCRETE MEMBER BEING FORMED.	-	X	ACI 318: 26.11.1.2(b)	-	YES	USE OF QUALIFIED WELDERS O	YES	AISC 360-16 TABLE N5.6-	.3	
						CONTROL AND HANDLING OF WELDING CONSUMABLES	YES	INSPECTION TASKS AFTER BO		
						PACKAGING O EXPOSURE CONTROL	TES			
. SPECIFIC REQUIREMENTS FOR SPECIAL INSPECTION SHALL BE INCLUDED IN THE RESEARCH CI 318, OR OTHER QUALIFICATION PROCEDURES. WHERE SPECIFIC REQUIREMENTS ARE NOT	OT PROVIDED, SPECIAL II	INSPECTION REQUIF				NO WELDING OVER CRACKED TACK WELDS 0	YES	INSPECTION TASKS AFTER BOLTING	INSPECTION INTERVAL	REQUIRED ON PROJEC
DESIGN PROFESSIONAL AND SHALL BE APPROVED BY THE BUILDING OFFICIAL PRIOR TO THE (HE WORK.				ENVIRONMENTAL CONDITIONS WIND SPEED WITHIN LIMITS	YES	DOCUMENT ACCEPTANCE OR REJECTION OF BOLTED CONNECTIONS	Р	YES
VELDING OR REINFORCING BARS. SPECIAL INSPECTIONS OF WELDING AND QUALIFICATIONS OF SPECIAL INSPECTORS FOR REIN SPECIAL INSPECTION AND AWS D1.4 FOR SPECIAL INSPECTOR QUALIFICATION.	INFORCING BARS SHALL	L BE IN ACCORDAN(CE WITH THE REQUIREMENTS O	FAWS D1.4 FOR		PRECIPITATION AND TEMPERATURE				
						WPS FOLLOWED • SETTINGS ON WELDING EQUIPMENT		O-OBSERVE THESE ITEMS ON A RANDOM BASIS. OPERATIONS NEED NOT BE DELAYED PENE	DING THESE INSPECTIONS.	
MATERIAL TESTS. IN THE ABSENCE OF SUFFICIENT DATA OR DOCUMENTATION PROVIDING EVIDENCE OF CONFORMANCE TO QUALITY STANDARDS FOR MATERIALS IN CHAPTERS 19 AND 20 OF ACI 318, THE BUILDING OFFICIAL SHALL REQUIRE TESTING OF MATERIALS IN ACCORDANCE WITH THE APPROPRIATE STANDARDS AND CRITERIA FOR THE MATERIAL IN CHAPTERS 19 AND 20 OF ACI 318.			 TRAVEL SPEED SELECTED WELDING MATERIALS SHIELDING GAS TYPE/FLOW RATE PREHEAT APPLIED OBSERVATION OF WELDING OPERATIONS AND VISUAL INSPECTION OF IN-PROCESS AND COMPLETED WELDS SHALL BE THE PR METHOD TO CONFIRM THAT THE MATERIALS, PROCEDURES AND WORKMANSHIP ARE IN CONFORMANCE WITH THE CONSTRUCT 							
			INTERPASS TEMPERATURE MAINTAINED (MIN/MAX) PROPER POSITION (F, V, H, OH)		FOR STRUCTURES IN RISK CATEGORY III/IV (ASCE/SEI 7, TABLE 1.5-1), ULTRASONIC TESTING SHALL BE PERFORMED ON ALL COMPLETE-JOI					
						WELDING TECHNIQUES INTERPASS AND FINAL CLEANING EACH PASS WITHIN PROFILE LIMITATIONS 	YES	 FOR STRUCTURES IN RISK CATEGORY III/IV (ASCE/SEL7, TABLE 1.5-1), ULTRASONIC TESTING SHALL BE PERFORMED ON ALL COMPLETE-JOINT- PENETRATION GROOVE WELDS SUBJECT TO TRANSVERSELY APPLIED TENSION LOADING IN BUTT, T- AND CORNER JOINTS, IN MATERIALS 5/16" (8 MM) THICK OR GREATER. 		
						EACH PASS MEETS QUALITY REQUIREMENTS		 FOR STRUCTURES IN RISK CATEGORY II (ASCE/SEI 7, TABLE 1.5-1), ULTRASONIC TESTING SH JOINT-PENETRATION GROOVE WELDS SUBJECT TO TRANSVERSELY APPLIED TENSION LOAI 		
			PLACEMENT AND INSTALLATION OF STEEL HEADED STUD ANCHORS		MATERIALS 5/16" (8 MM) THICK OR GREATER.					
							YES	MATERIALS 5/10 (0 MINI) THICK OR GREATER.		
							YES	 ALL NONDESTRUCTIVE TESTING OF WELDED JOINTS SHALL BE DOCUMENTED. 		
						AISC 360-16 TABLE N5.4-3	YES			
						AISC 360-16 TABLE N5.4-3 INSPECTION TASKS AFTER WELDING	YES	ALL NONDESTRUCTIVE TESTING OF WELDED JOINTS SHALL BE DOCUMENTED.		
						INSPECTION TASKS AFTER WELDING		 ALL NONDESTRUCTIVE TESTING OF WELDED JOINTS SHALL BE DOCUMENTED. SEE AISC360-16 CHAPTER N FOR ADDITIONAL WELD INSPECTION REQUIREMENTS. SEE AISC360-16 CHAPTER N FOR ADDITIONAL BOLT INSPECTION REQUIREMENTS. EXPOSED CUT SURFACES OF GALVANIZED STRUCTURAL STEEL MAIN MEMBERS AND EXPOSED 		
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STEEL CONSTRUCTION

	Albertson Engineering Inc.
	PROJECT IDEN: DAYS OF '76 CROW'S NEST ADDITION DEADWOOD, SOUTH DAKOTA ISSUE BLOCK: NO ISSUE TYPE ISSUE DATE
	CD 100% CD 05/14/21 MANAGEMENT: PROJECT NO: 17-356 DRAWN BY: MDR CHECKED BY: JDS SHEET TITLE:
CT	IBC INSPECTION TABLES
	3 OF 32

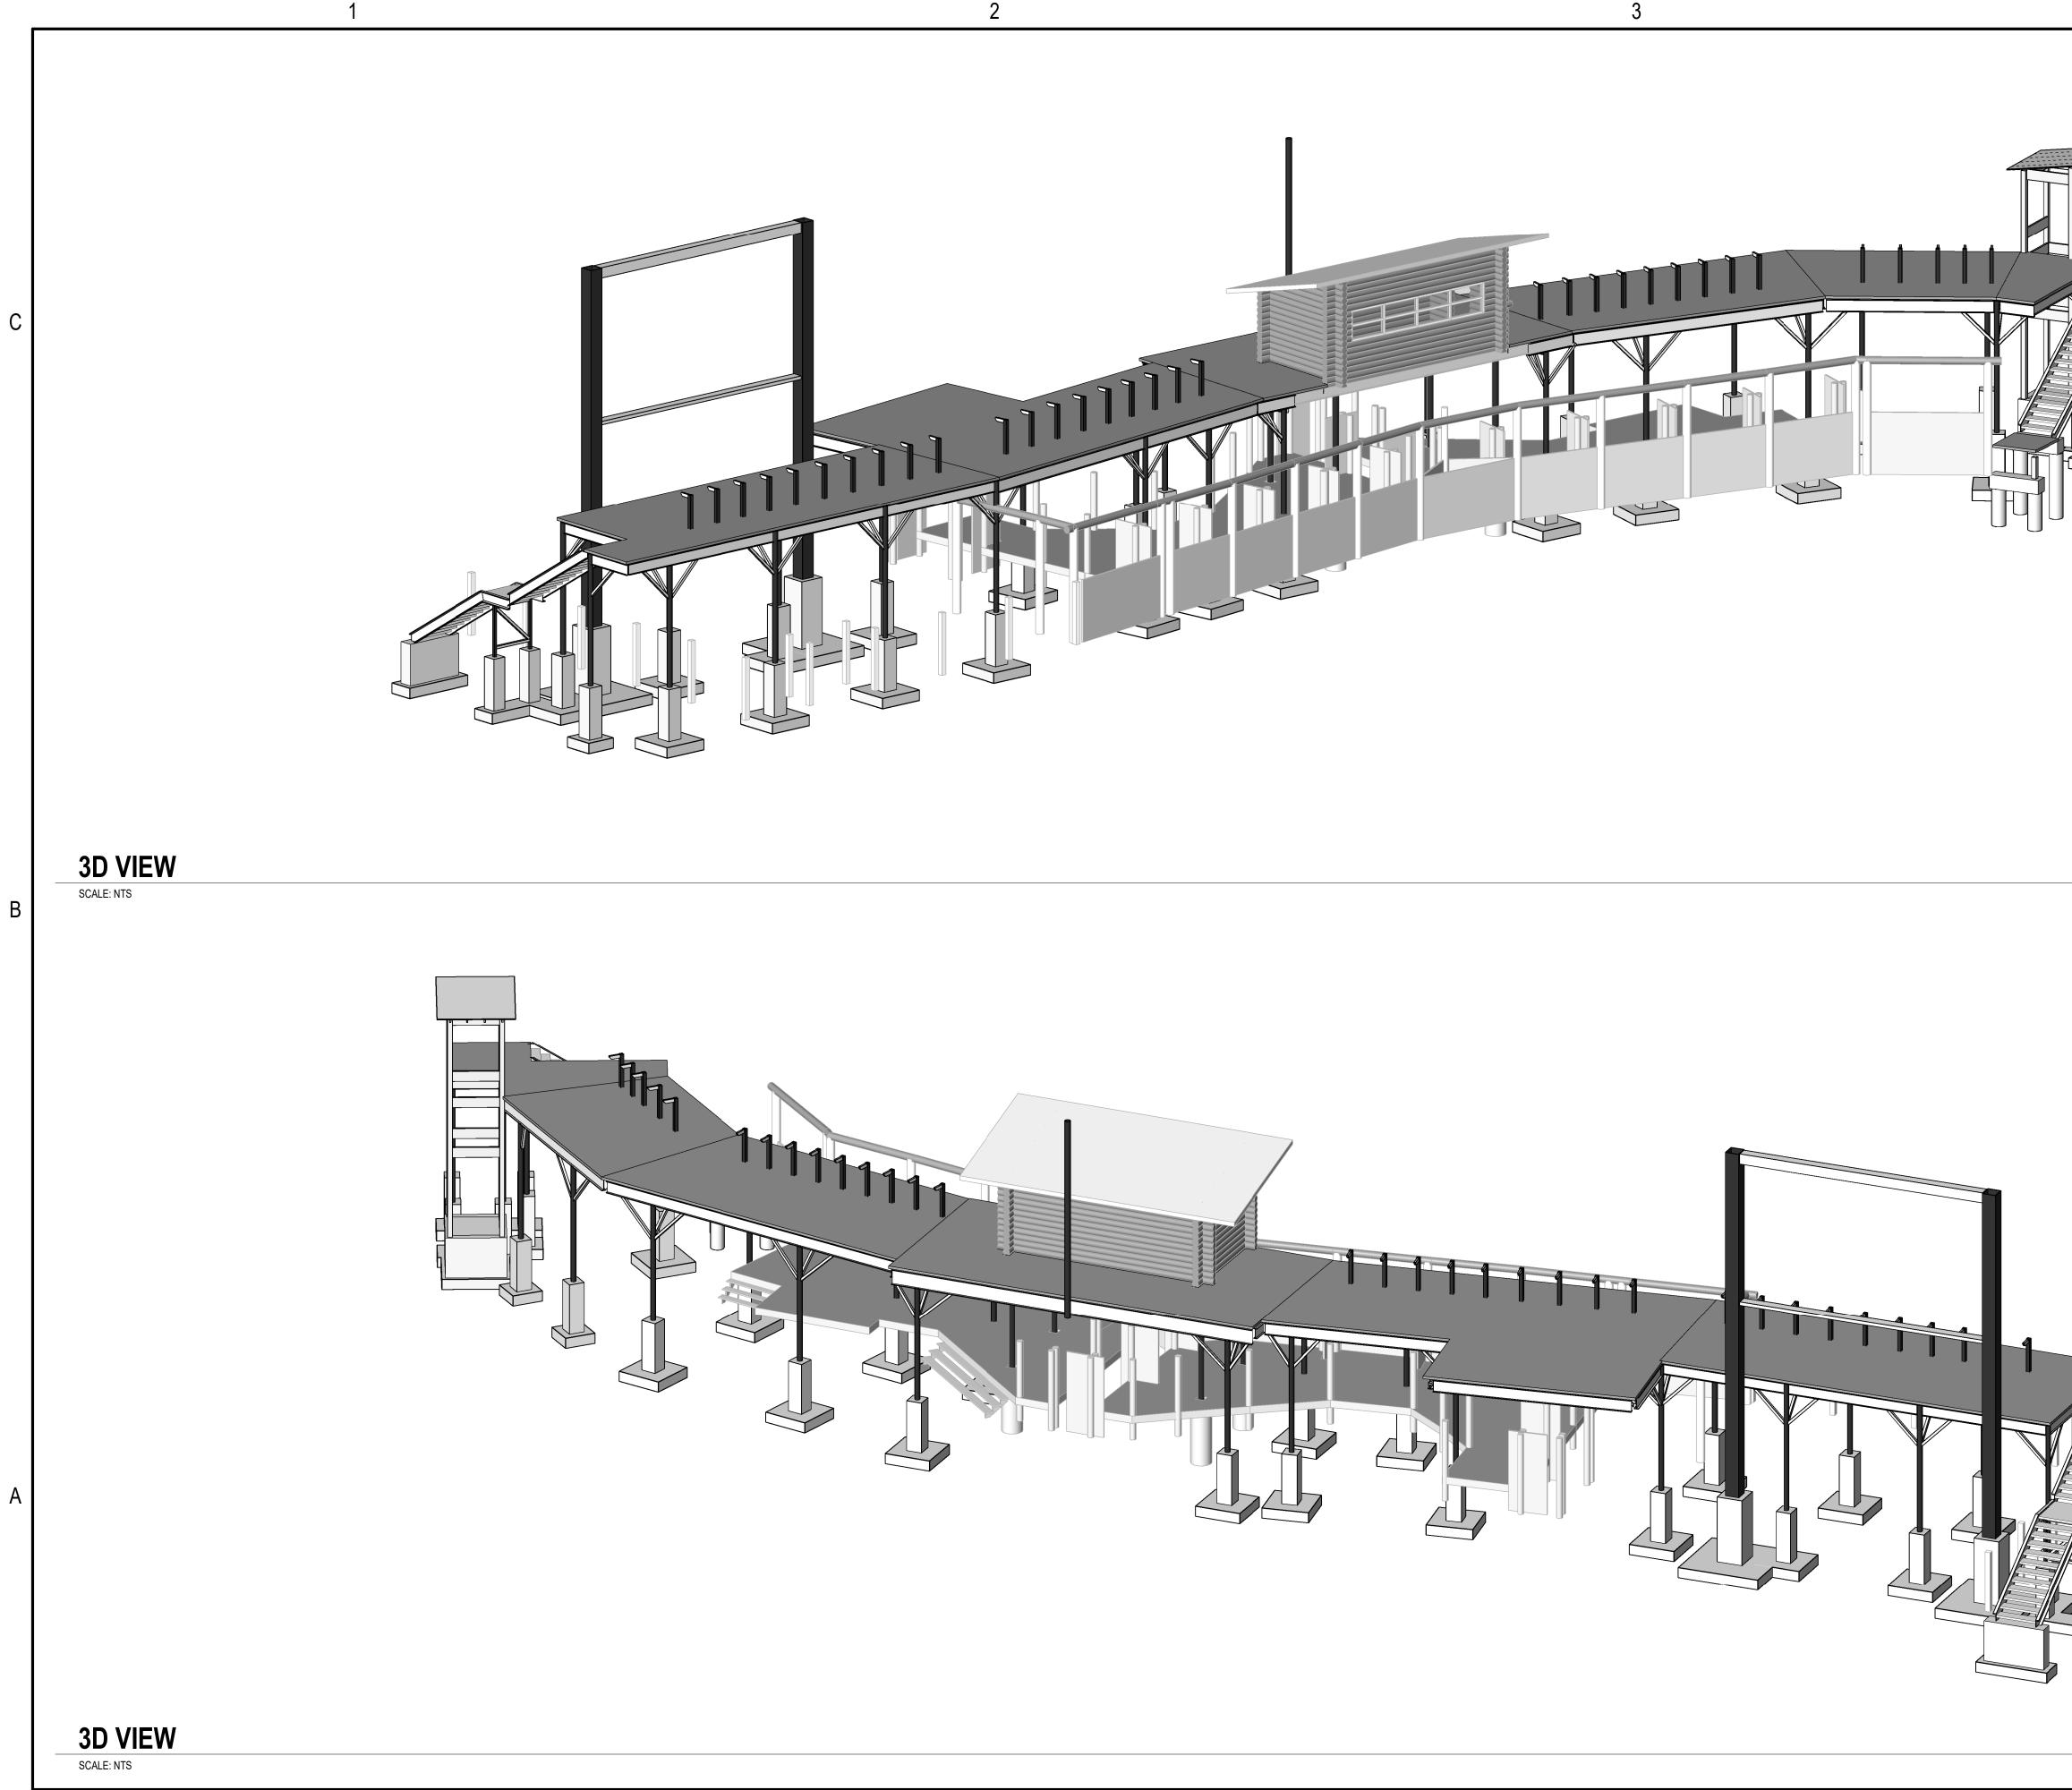



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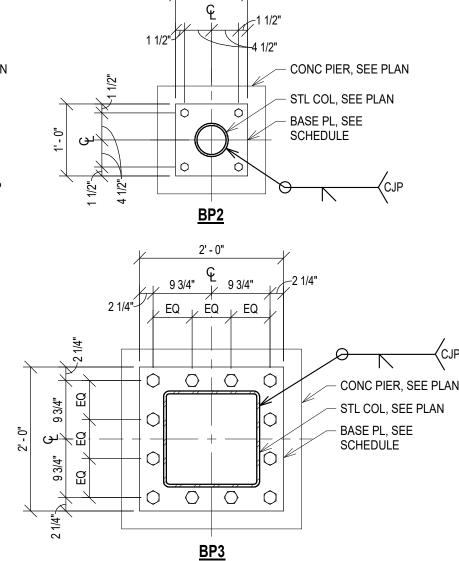
Albertson Engineering Inc. CONSULTANT
PROJECT IDEN:
DAYS OF '76 CROW'S NEST ADDITION
MANAGEMENT: PROJECT NO: 17-356 DRAWN BY: MDR
CHECKED BY: JDS SHEET TITLE: 3D
REPRESENTATIONS
SHEET IDENTIFICATION:

4 OF 32





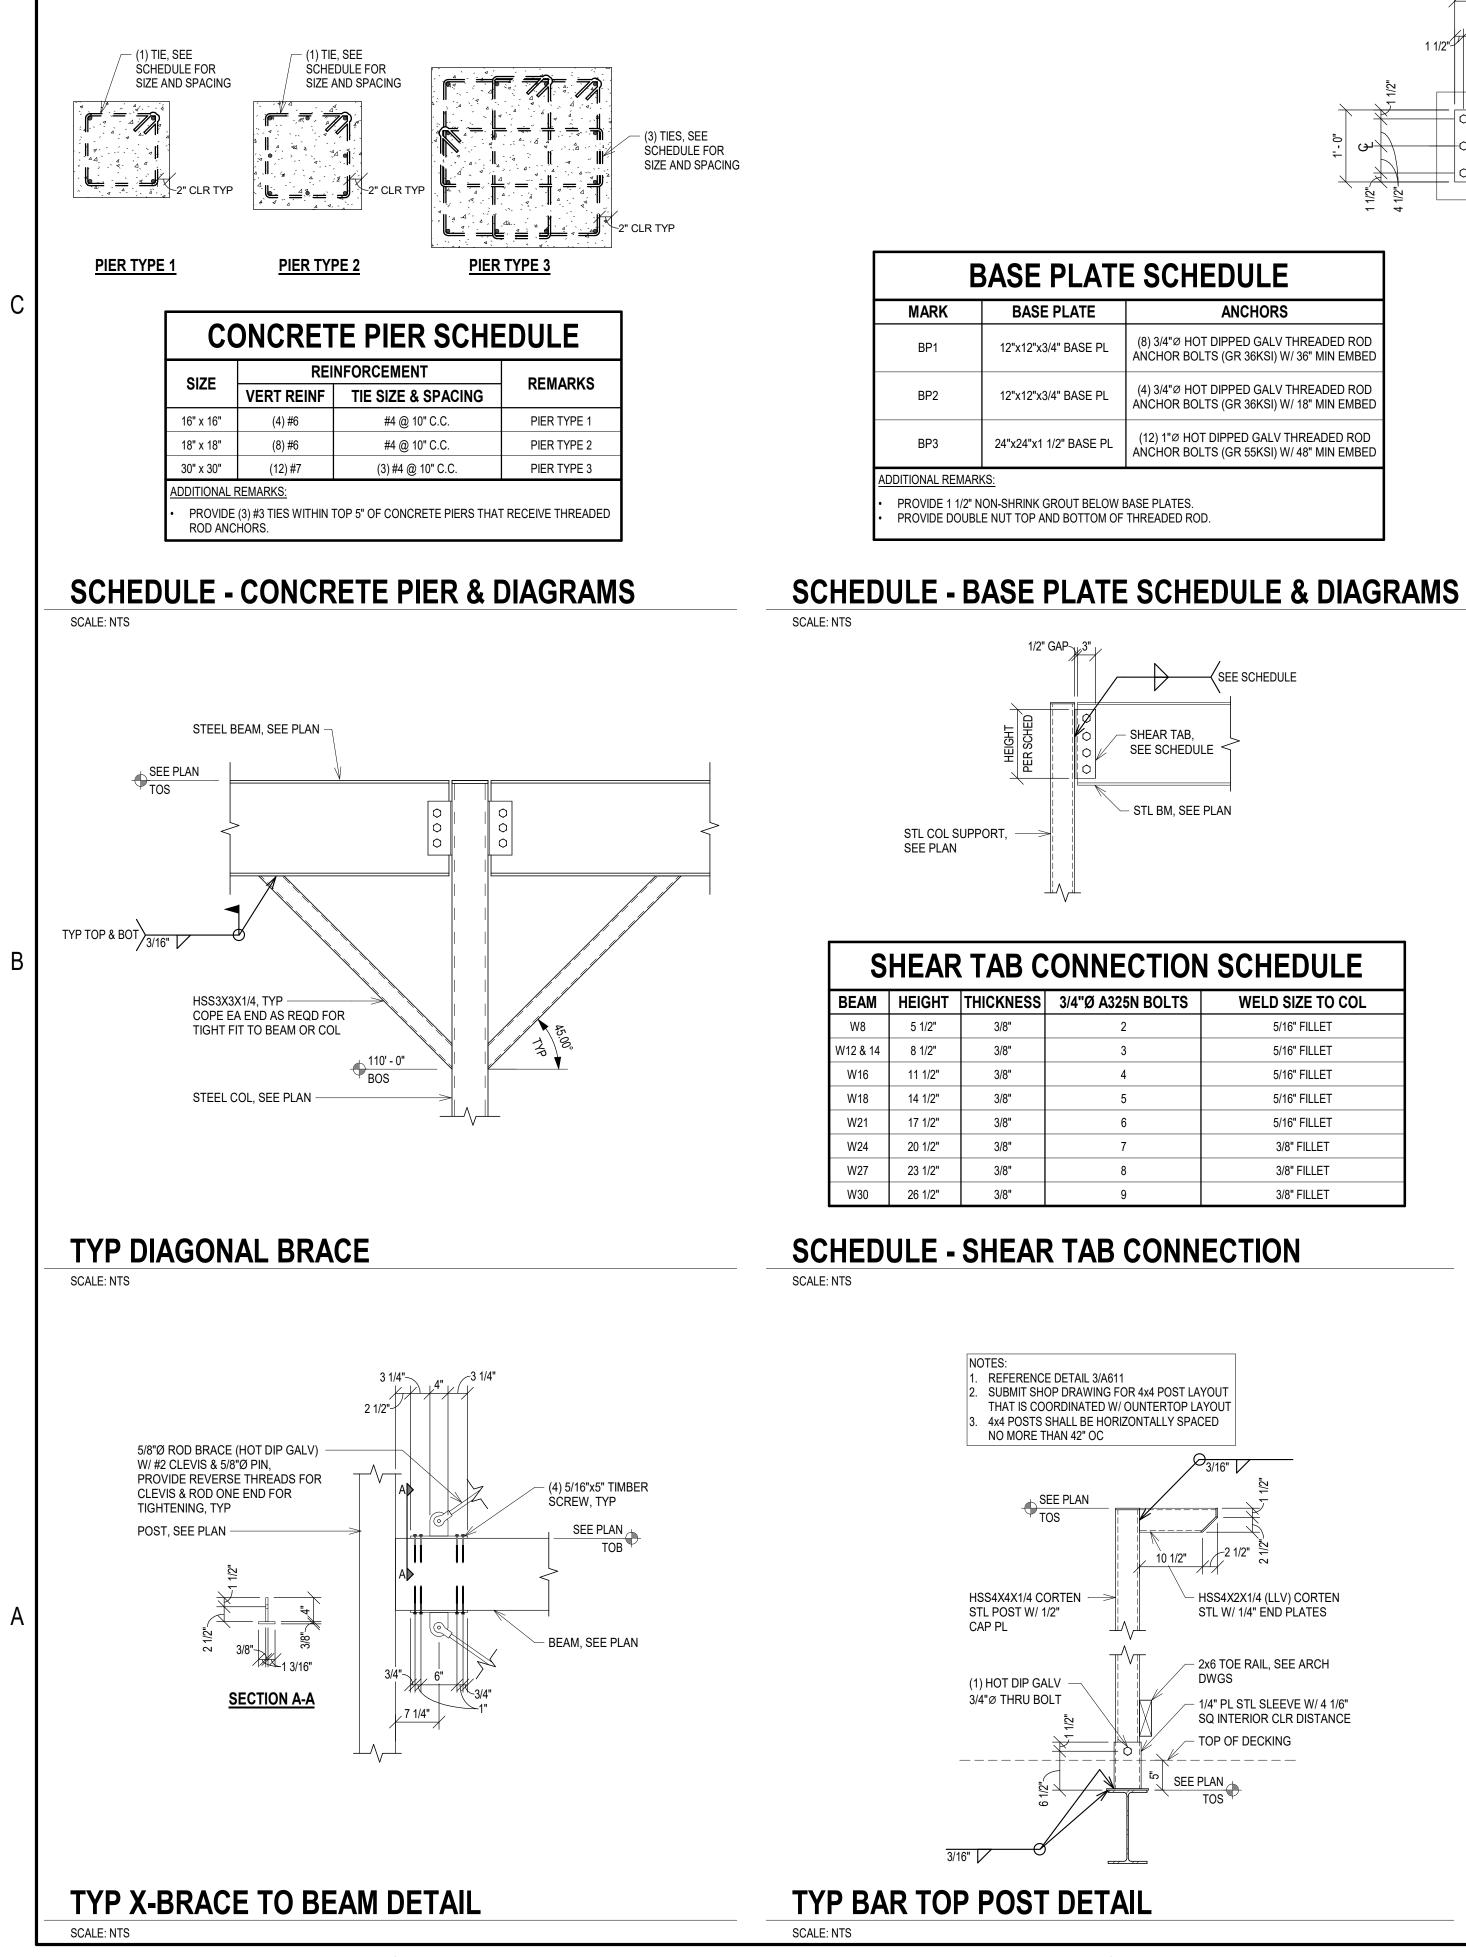

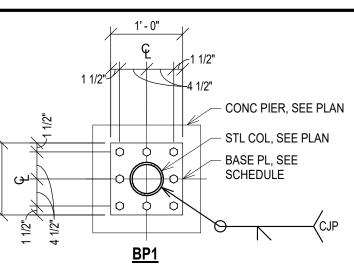


1' - 0"

3

(8) 3/4"Ø HOT DIPPED GALV THREADED ROD ANCHOR BOLTS (GR 36KSI) W/ 36" MIN EMBED
(4) 3/4"Ø HOT DIPPED GALV THREADED ROD ANCHOR BOLTS (GR 36KSI) W/ 18" MIN EMBED
(12) 1"Ø HOT DIPPED GALV THREADED ROD ANCHOR BOLTS (GR 55KSI) W/ 48" MIN EMBED

ECTION SCHEDULE						
325N BOLTS	WELD SIZE TO COL					
2	5/16" FILLET					
3	5/16" FILLET					
4	5/16" FILLET					
5	5/16" FILLET					
6	5/16" FILLET					
7	3/8" FILLET					
8	3/8" FILLET					
9	3/8" FILLET					

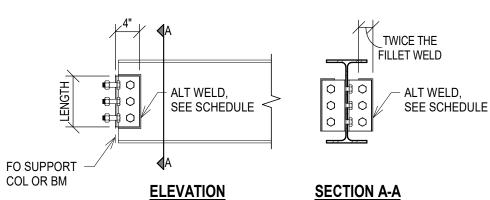


SECTION A-A

DOUBLE ANGLE CONNECTION SCHEDULE

BEAM	3/4"Ø A325N BOLTS	CONNECT	ION ANGLES	ALTERNATE WELD TO BM			
DEAIVI	3/4 10 A325N BULIS	LENGTH	THICKNESS	SIZE (SHOP WELD ONLY)			
W8	2	5 1/2"	5/16"	5/16" FILLET			
W12 & 14	3	8 1/2"	5/16"	5/16" FILLET			
W16	4	11 1/2"	5/16"	5/16" FILLET			
W18	5	14 1/2"	5/16"	5/16" FILLET			
W21	6	17 1/2"	5/16"	5/16" FILLET			
W24	7	20 1/2"	5/16"	5/16" FILLET			
W27	8	23 1/2"	5/16"	5/16" FILLET			
W30	9	26 1/2"	5/16"	5/16" FILLET			
ADDITION	ADDITIONAL REMARKS:						
1. USE E70XX ELECTRODES.							
I. USE ETUAA ELEUTRUDES.							

SIZE & NUMBER OF BOLTS INTO SUPPORTING MEMBER TO BE TWICE THE NUMBER OF BOLTS INTO THE BEAM & OF THE SAME SIZE.

SCHEDULE - DBL ANGLE CONNECTION SCALE: NTS

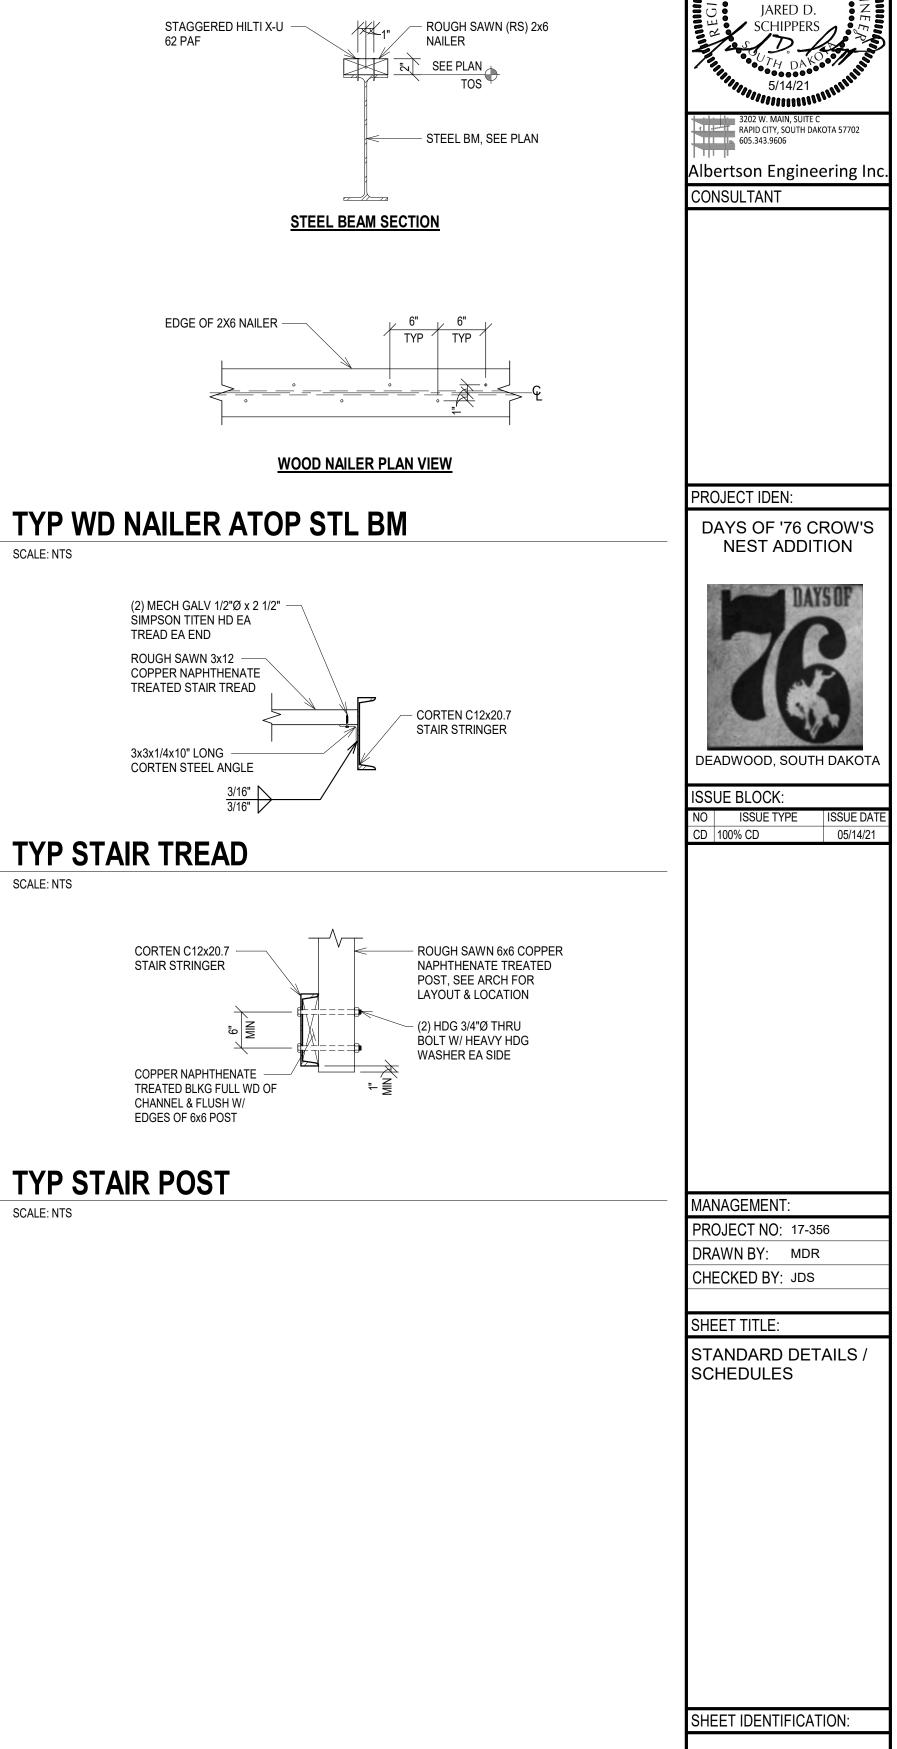

12764

S004


5 OF 32

STRUCTURAL SHEET NOTES


FOUNDATION & FLOOR SLAB PLAN NOTES SEE SHEET SERIES S001 FOR STRUCTURAL NOTES.


- VERIFY ALL DIMENSIONS & ELEVATIONS WITH ARCHITECTURAL DRAWINGS AND EXISTING CONDITIONS BEFORE CONSTRUCTION COMMENCES.
- ELEVATIONS ON THE STRUCTURAL DRAWINGS REFER TO THE TOP OF EXISTING STEEL REFERENCE ELEVATION SET AT 113'-9 1/2".
- SLAB ON GRADE CONTROL JOINTS SHALL BE TOOLED OR SAWCUT. THE JOINT PATTERN SHALL BE APPROXIMATELY SQUARE AND LIMITED TO AN AREA NOT TO EXCEED 225 S.F. JOINTS SHALL BE CUT WITHIN 8 HRS OF POURING THE SLAB.
- CENTERLINE OF FOOTING SHALL COINCIDE WITH THE FOUNDATION WALL & COLUMN CENTERLINE, UNLESS SHOWN OTHERWISE.


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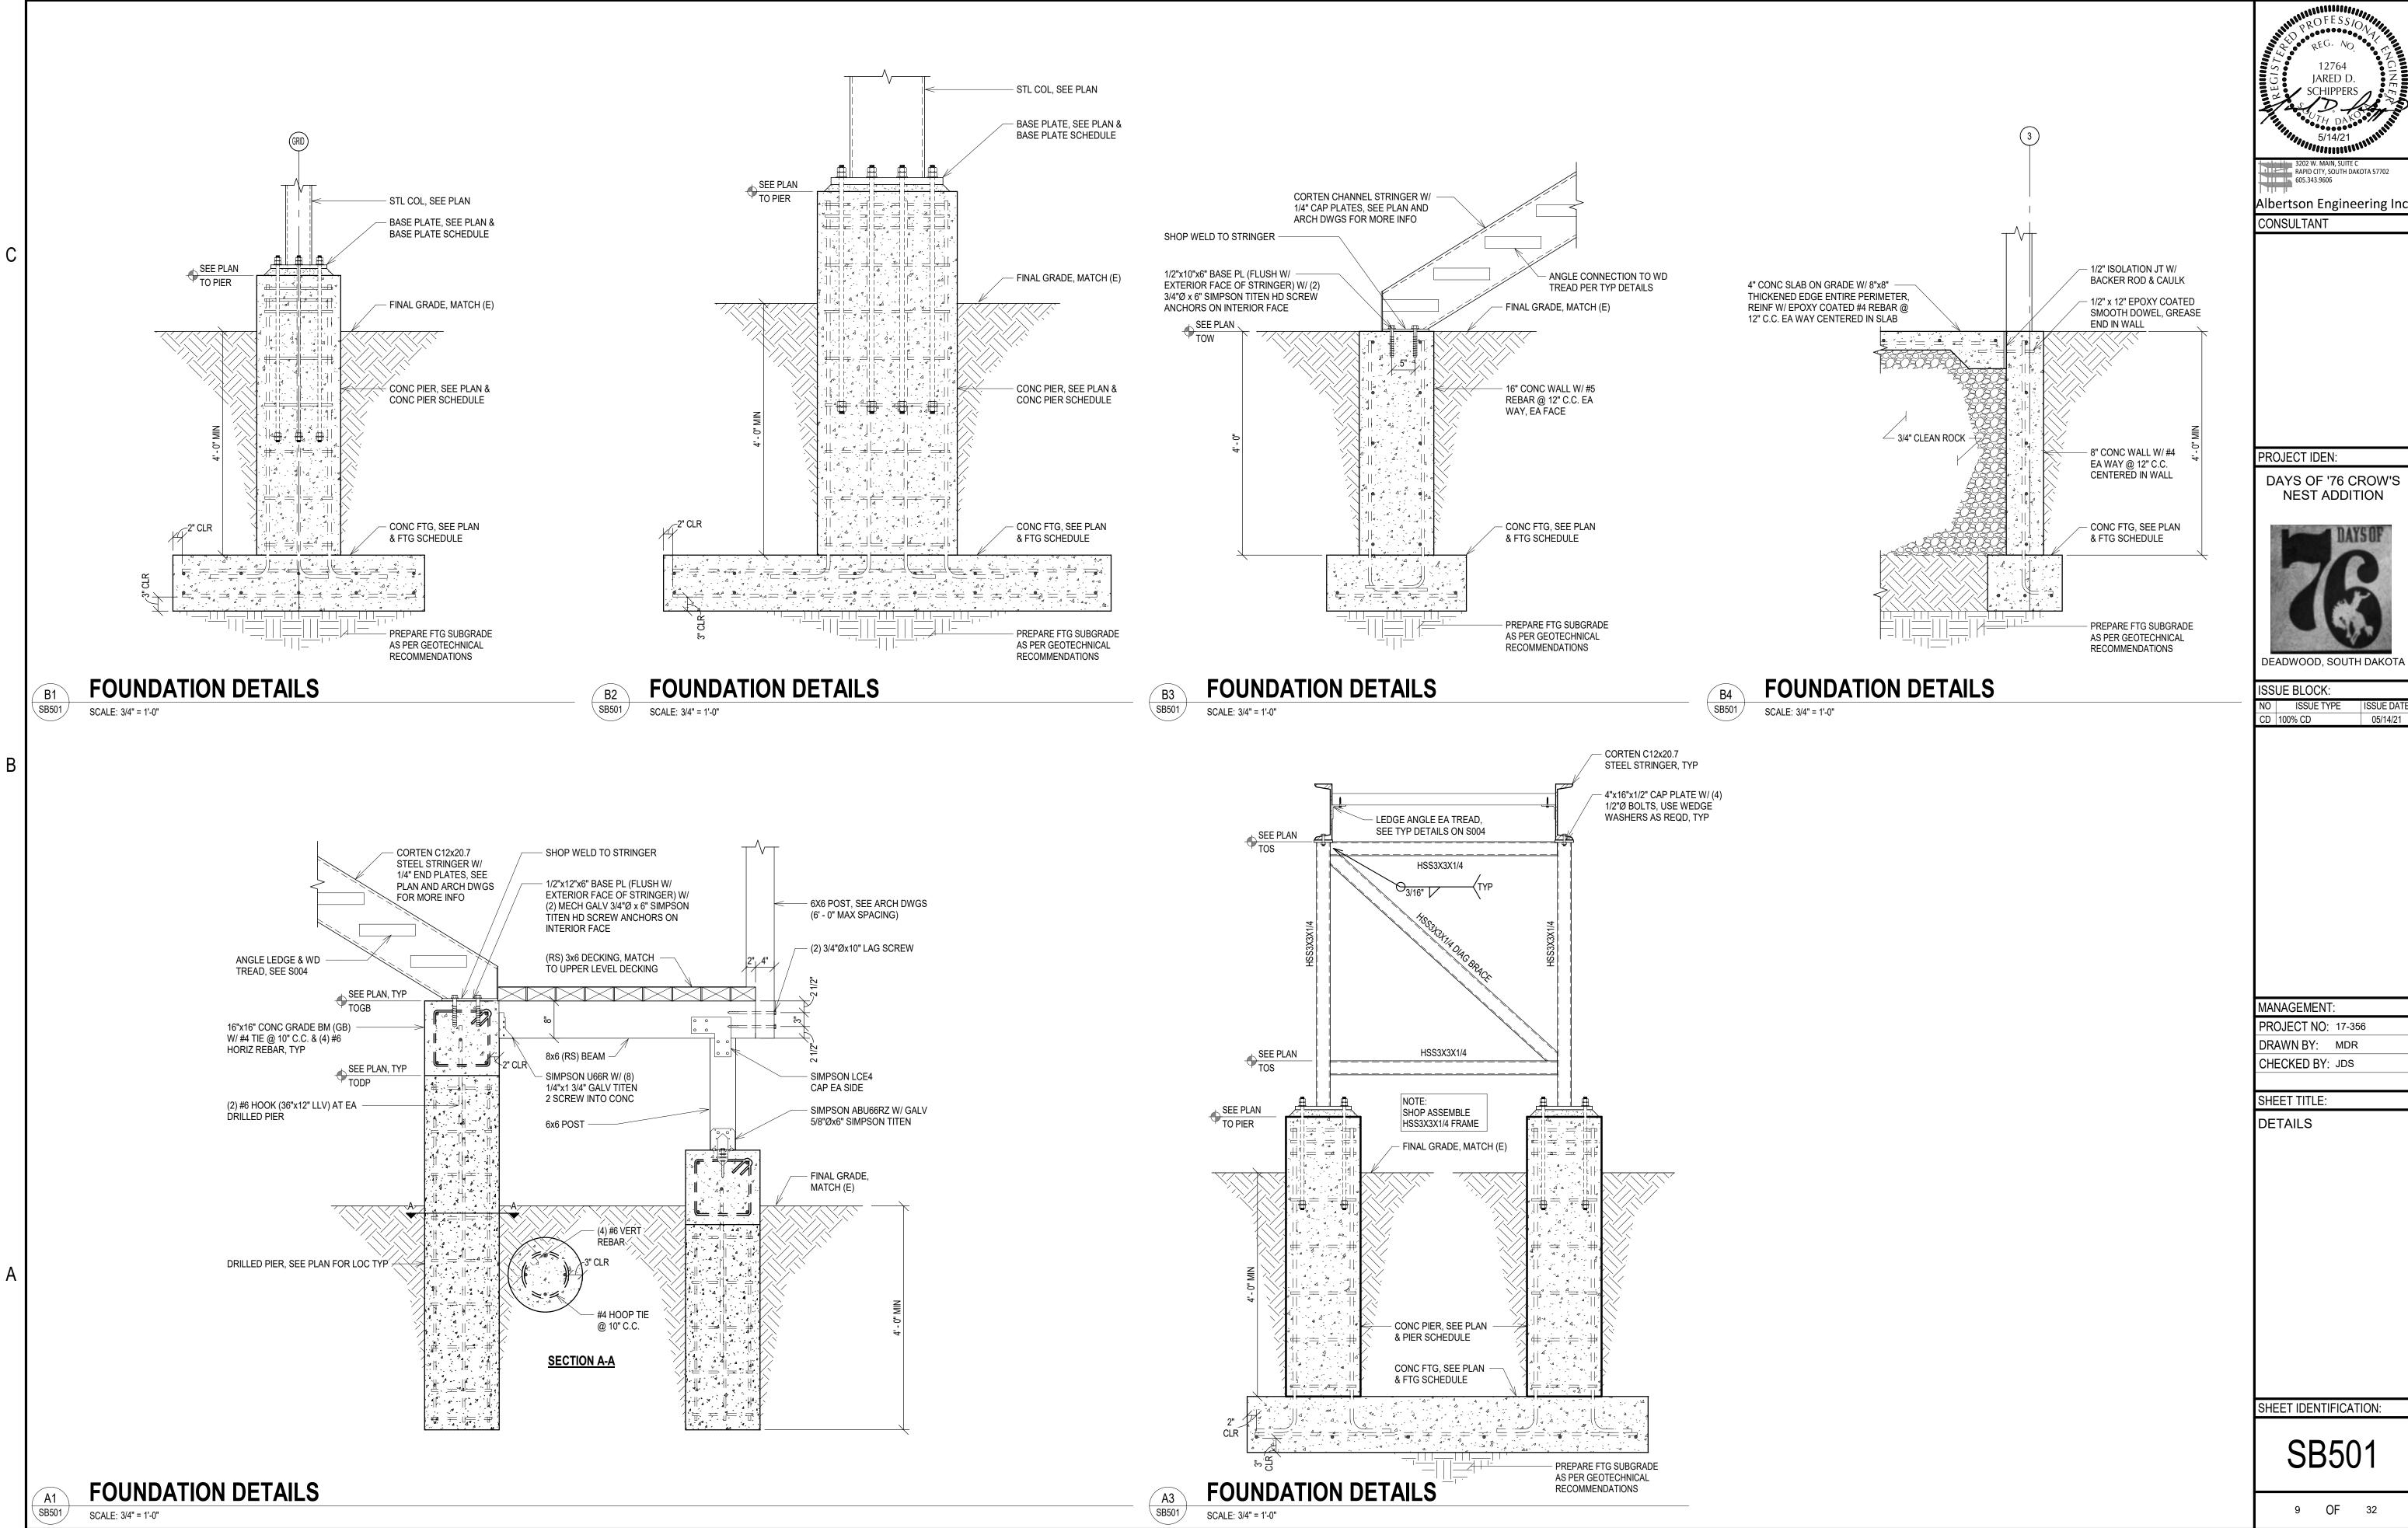
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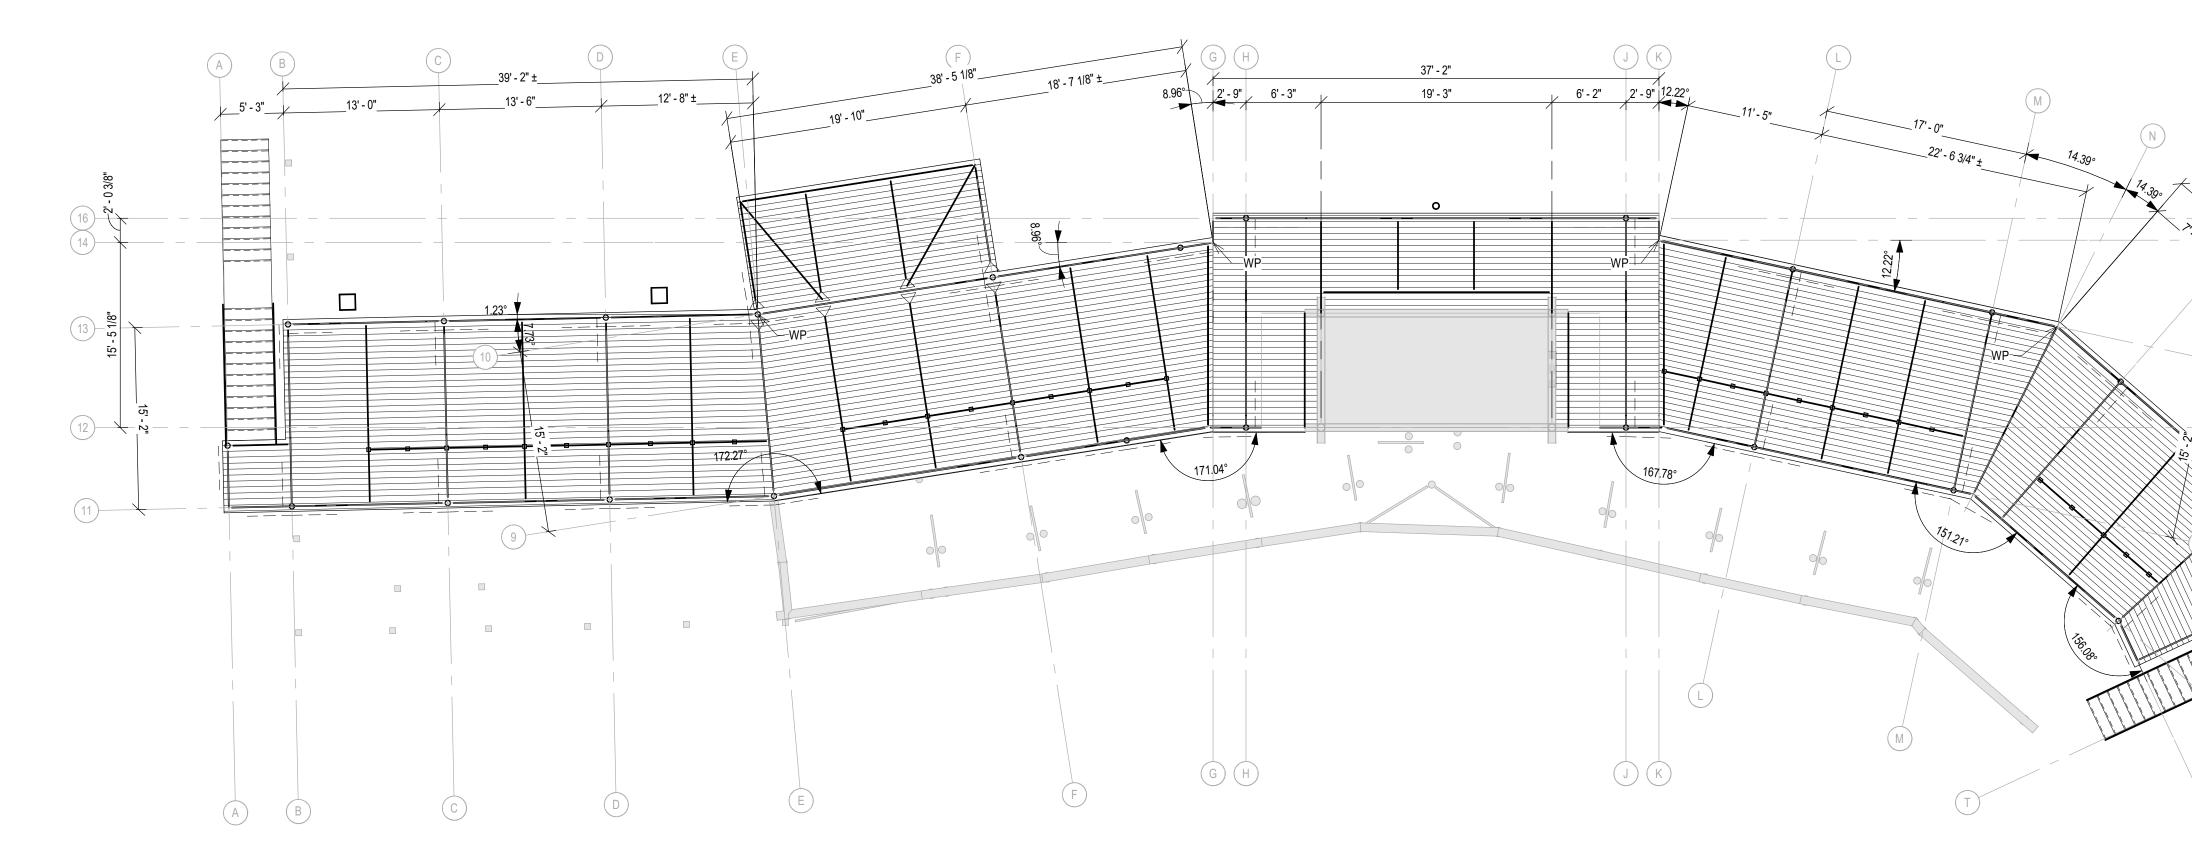
STRUCTURAL SHEET NOTES

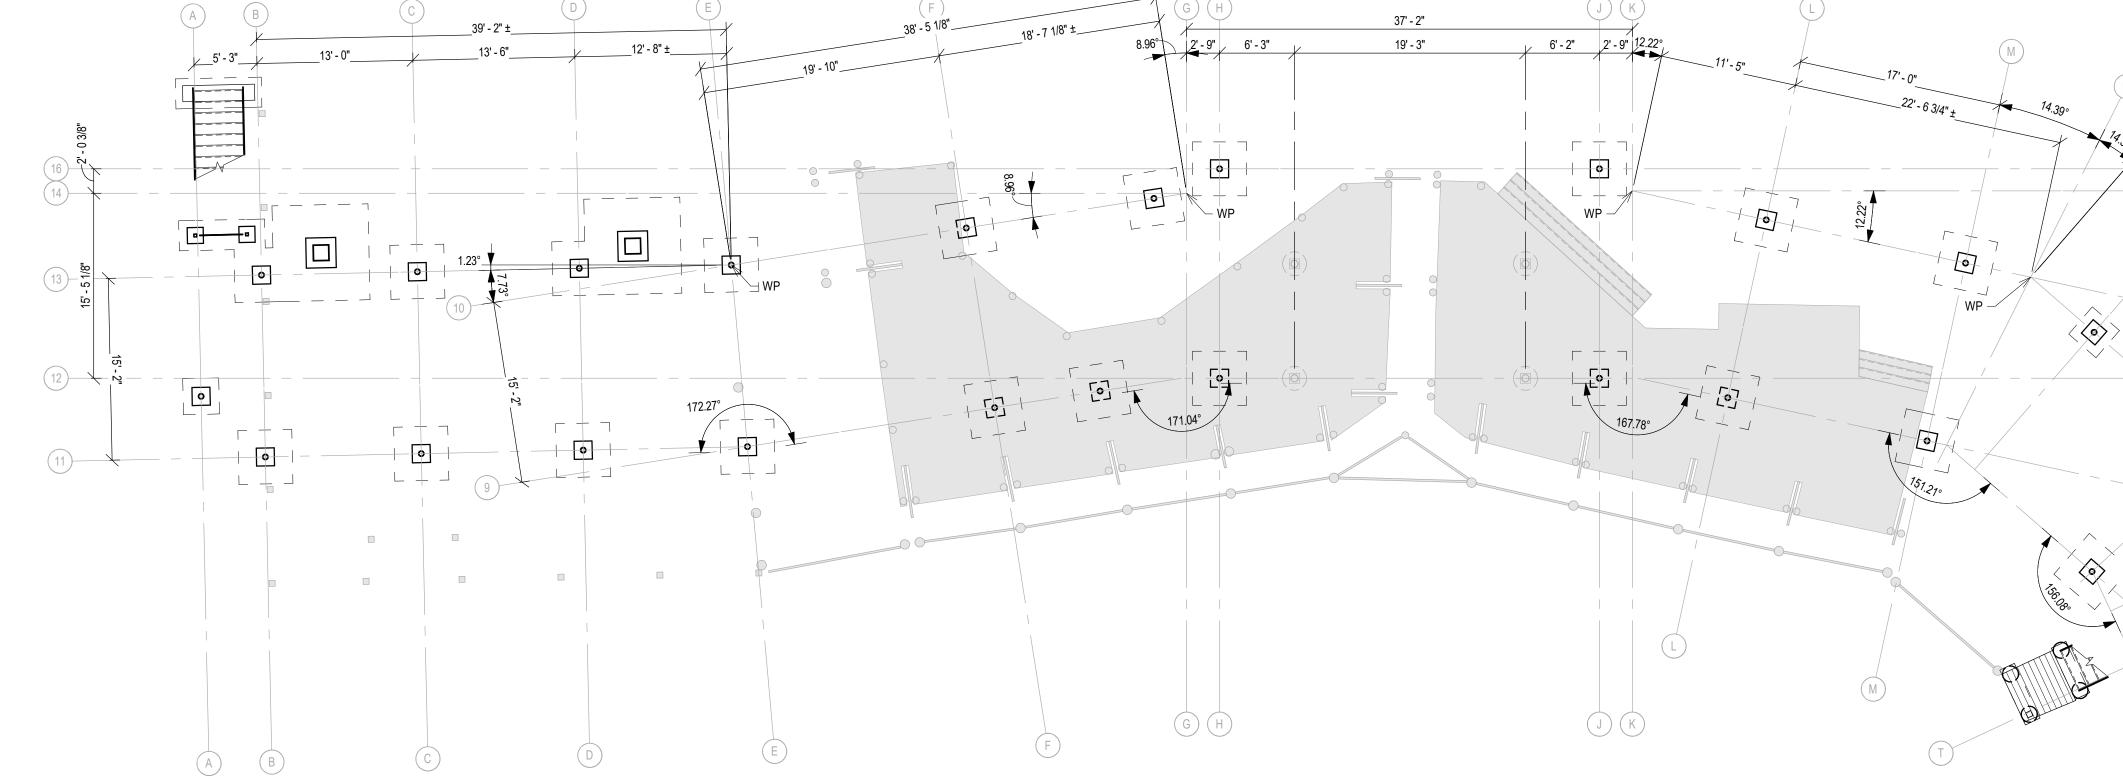FLOOR FRAMING PLAN NOTES

• SEE SHEET SERIES S001 FOR STRUCTURAL NOTES.

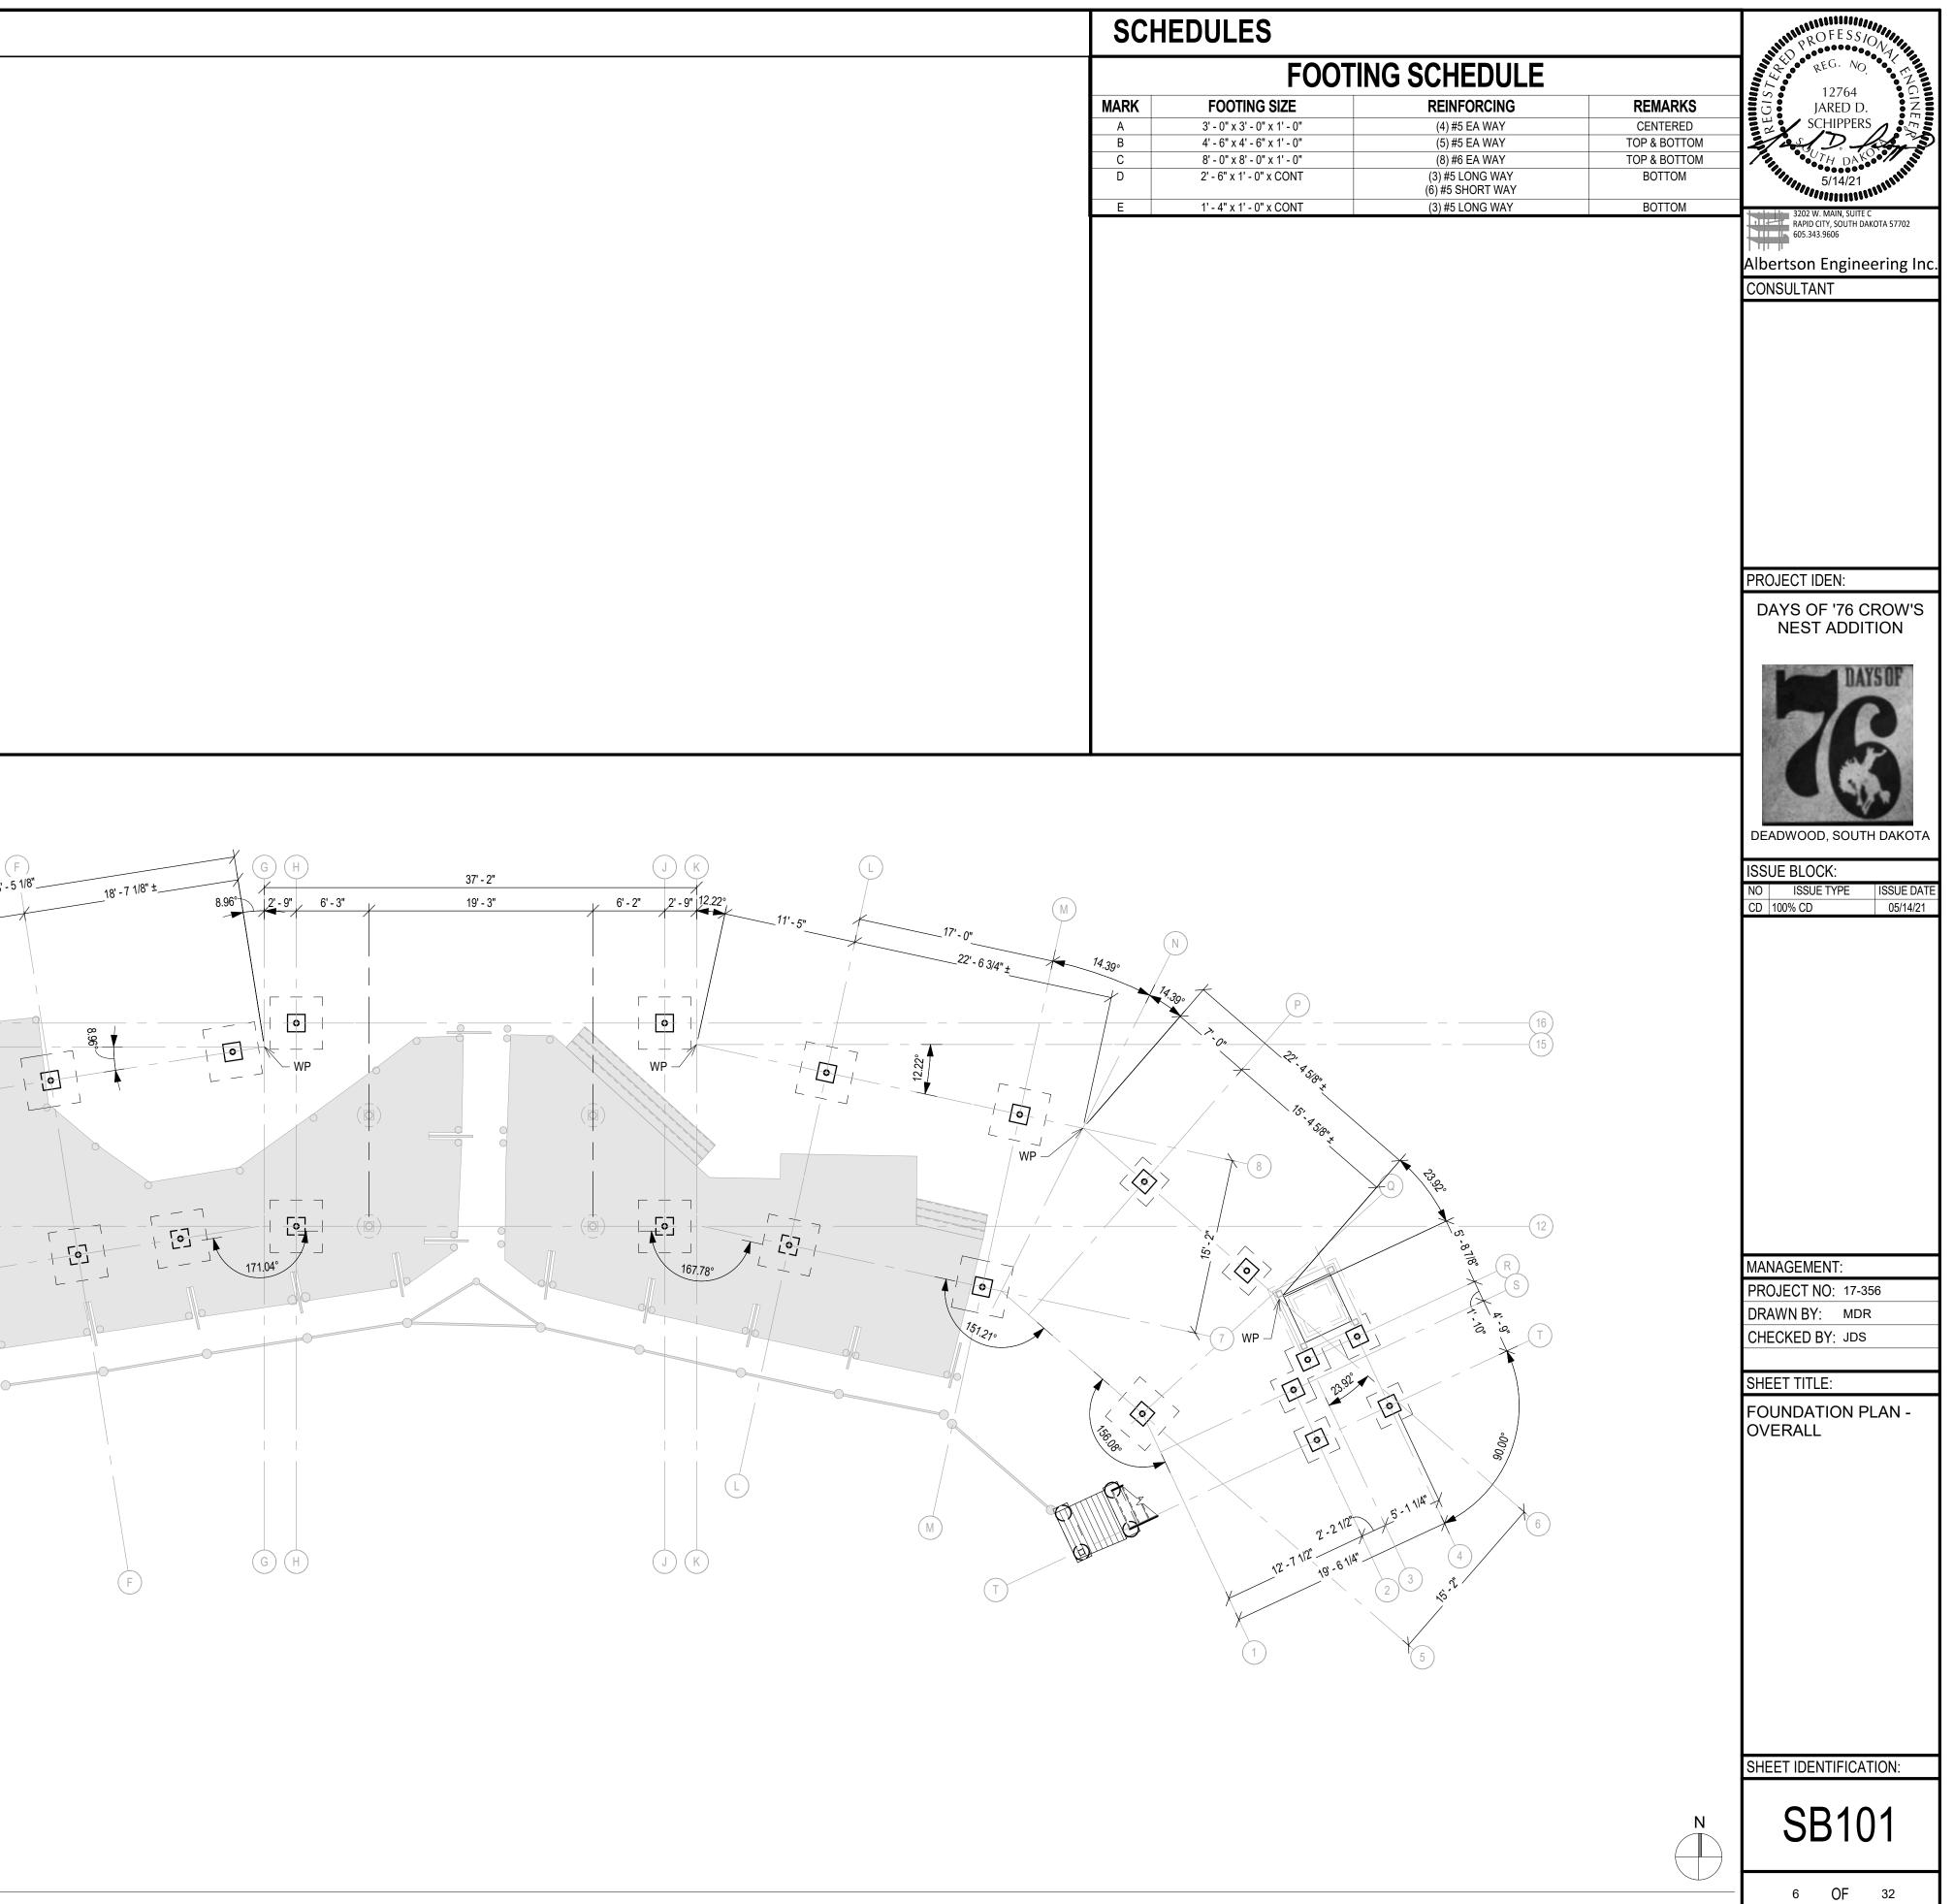- VERIFY ALL DIMENSIONS & ELEVATIONS WITH ARCHITECTURAL DRAWINGS BEFORE CONSTRUCTION COMMENCES.
- ELEVATIONS ON THE STRUCTURAL DRAWINGS REFER TO THE TOP OF EXISTING STEEL REFERENCE
- ELEVATION SET AT 113' 9 1/2".
- ALL DECKING SHALL BE ROUGH SAWN DOUGLAS FIR NO 1 OR BETTER 3x6 (ACTUAL DIMENSIONS = 3" x 6")
- EACH STEEL BEAM SHALL HAVE A ROUGH SAWN 2"x6" NAILER FASTENED TO TOP OF BEAM. FASTEN W/ HILTI X-U 62 PAF @ 12" C.C., STAGGER FASTENERS OPPOSITE SIDE OF BEAM WEB.
- INDICATES HSS2X2X1/4 DIAGONAL BRACE, SEE TYPICAL DETAILS FOR MORE INFORMATION
- DENOTES MOMENT CONNECTION

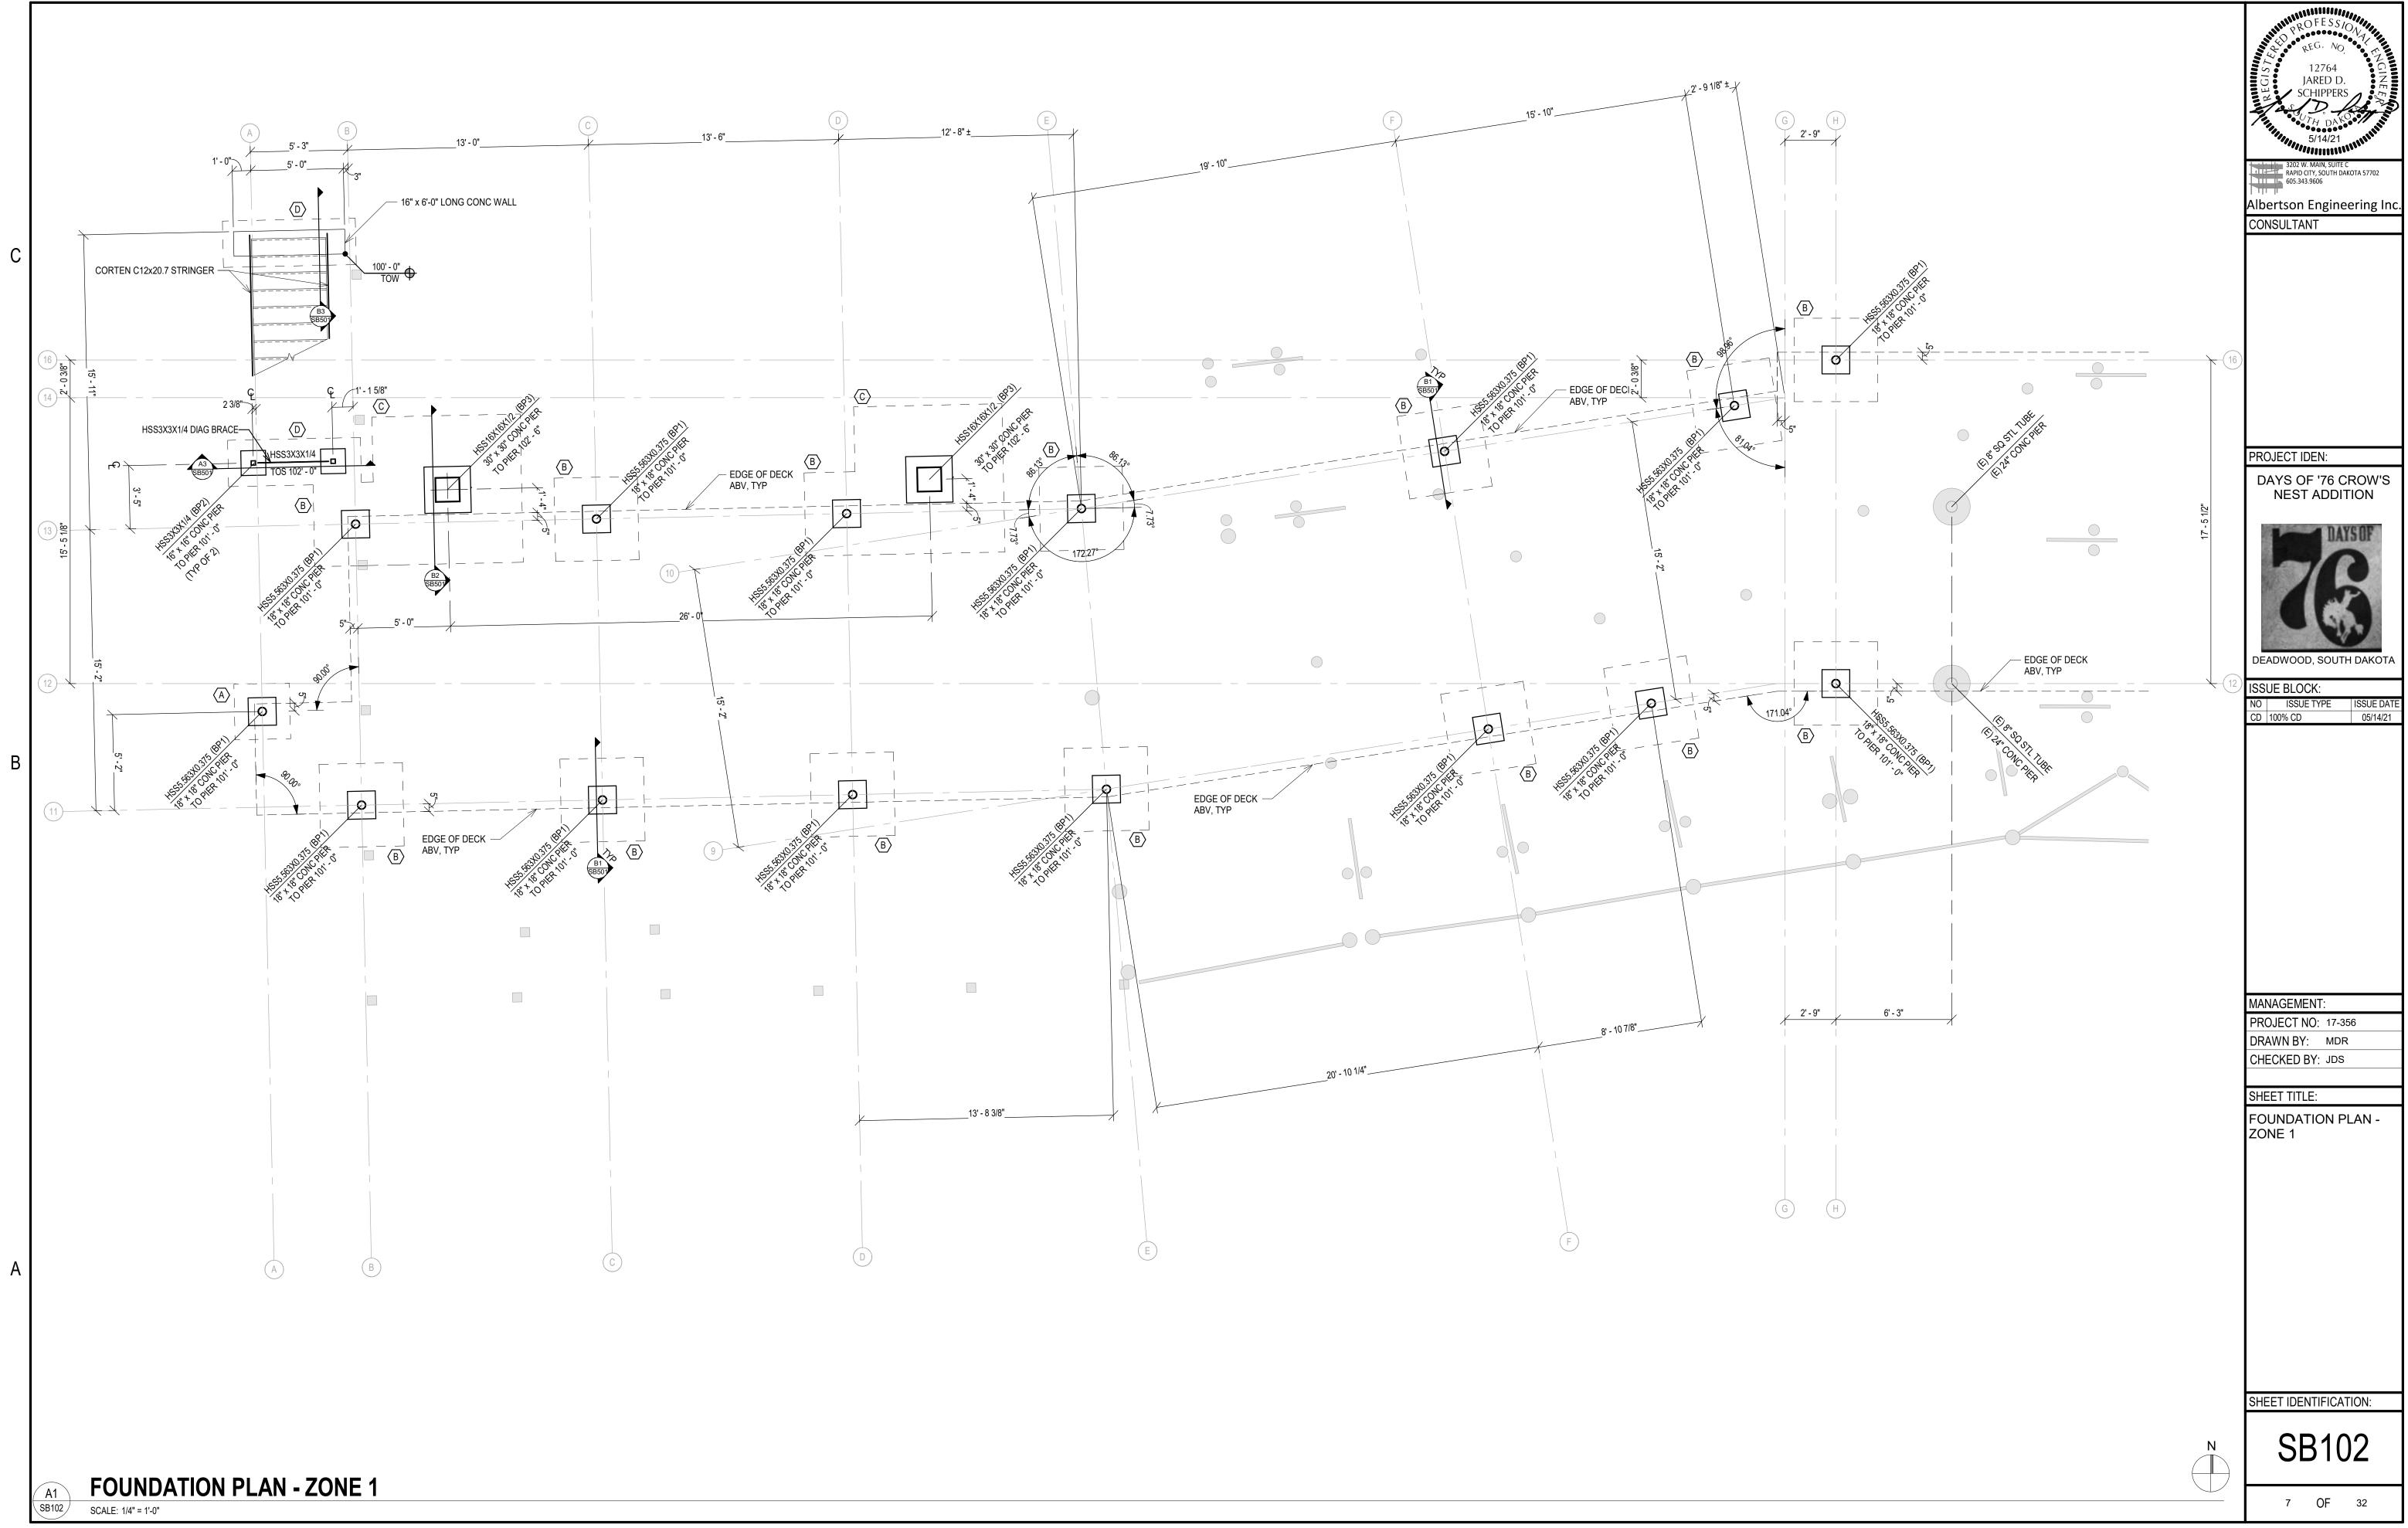С

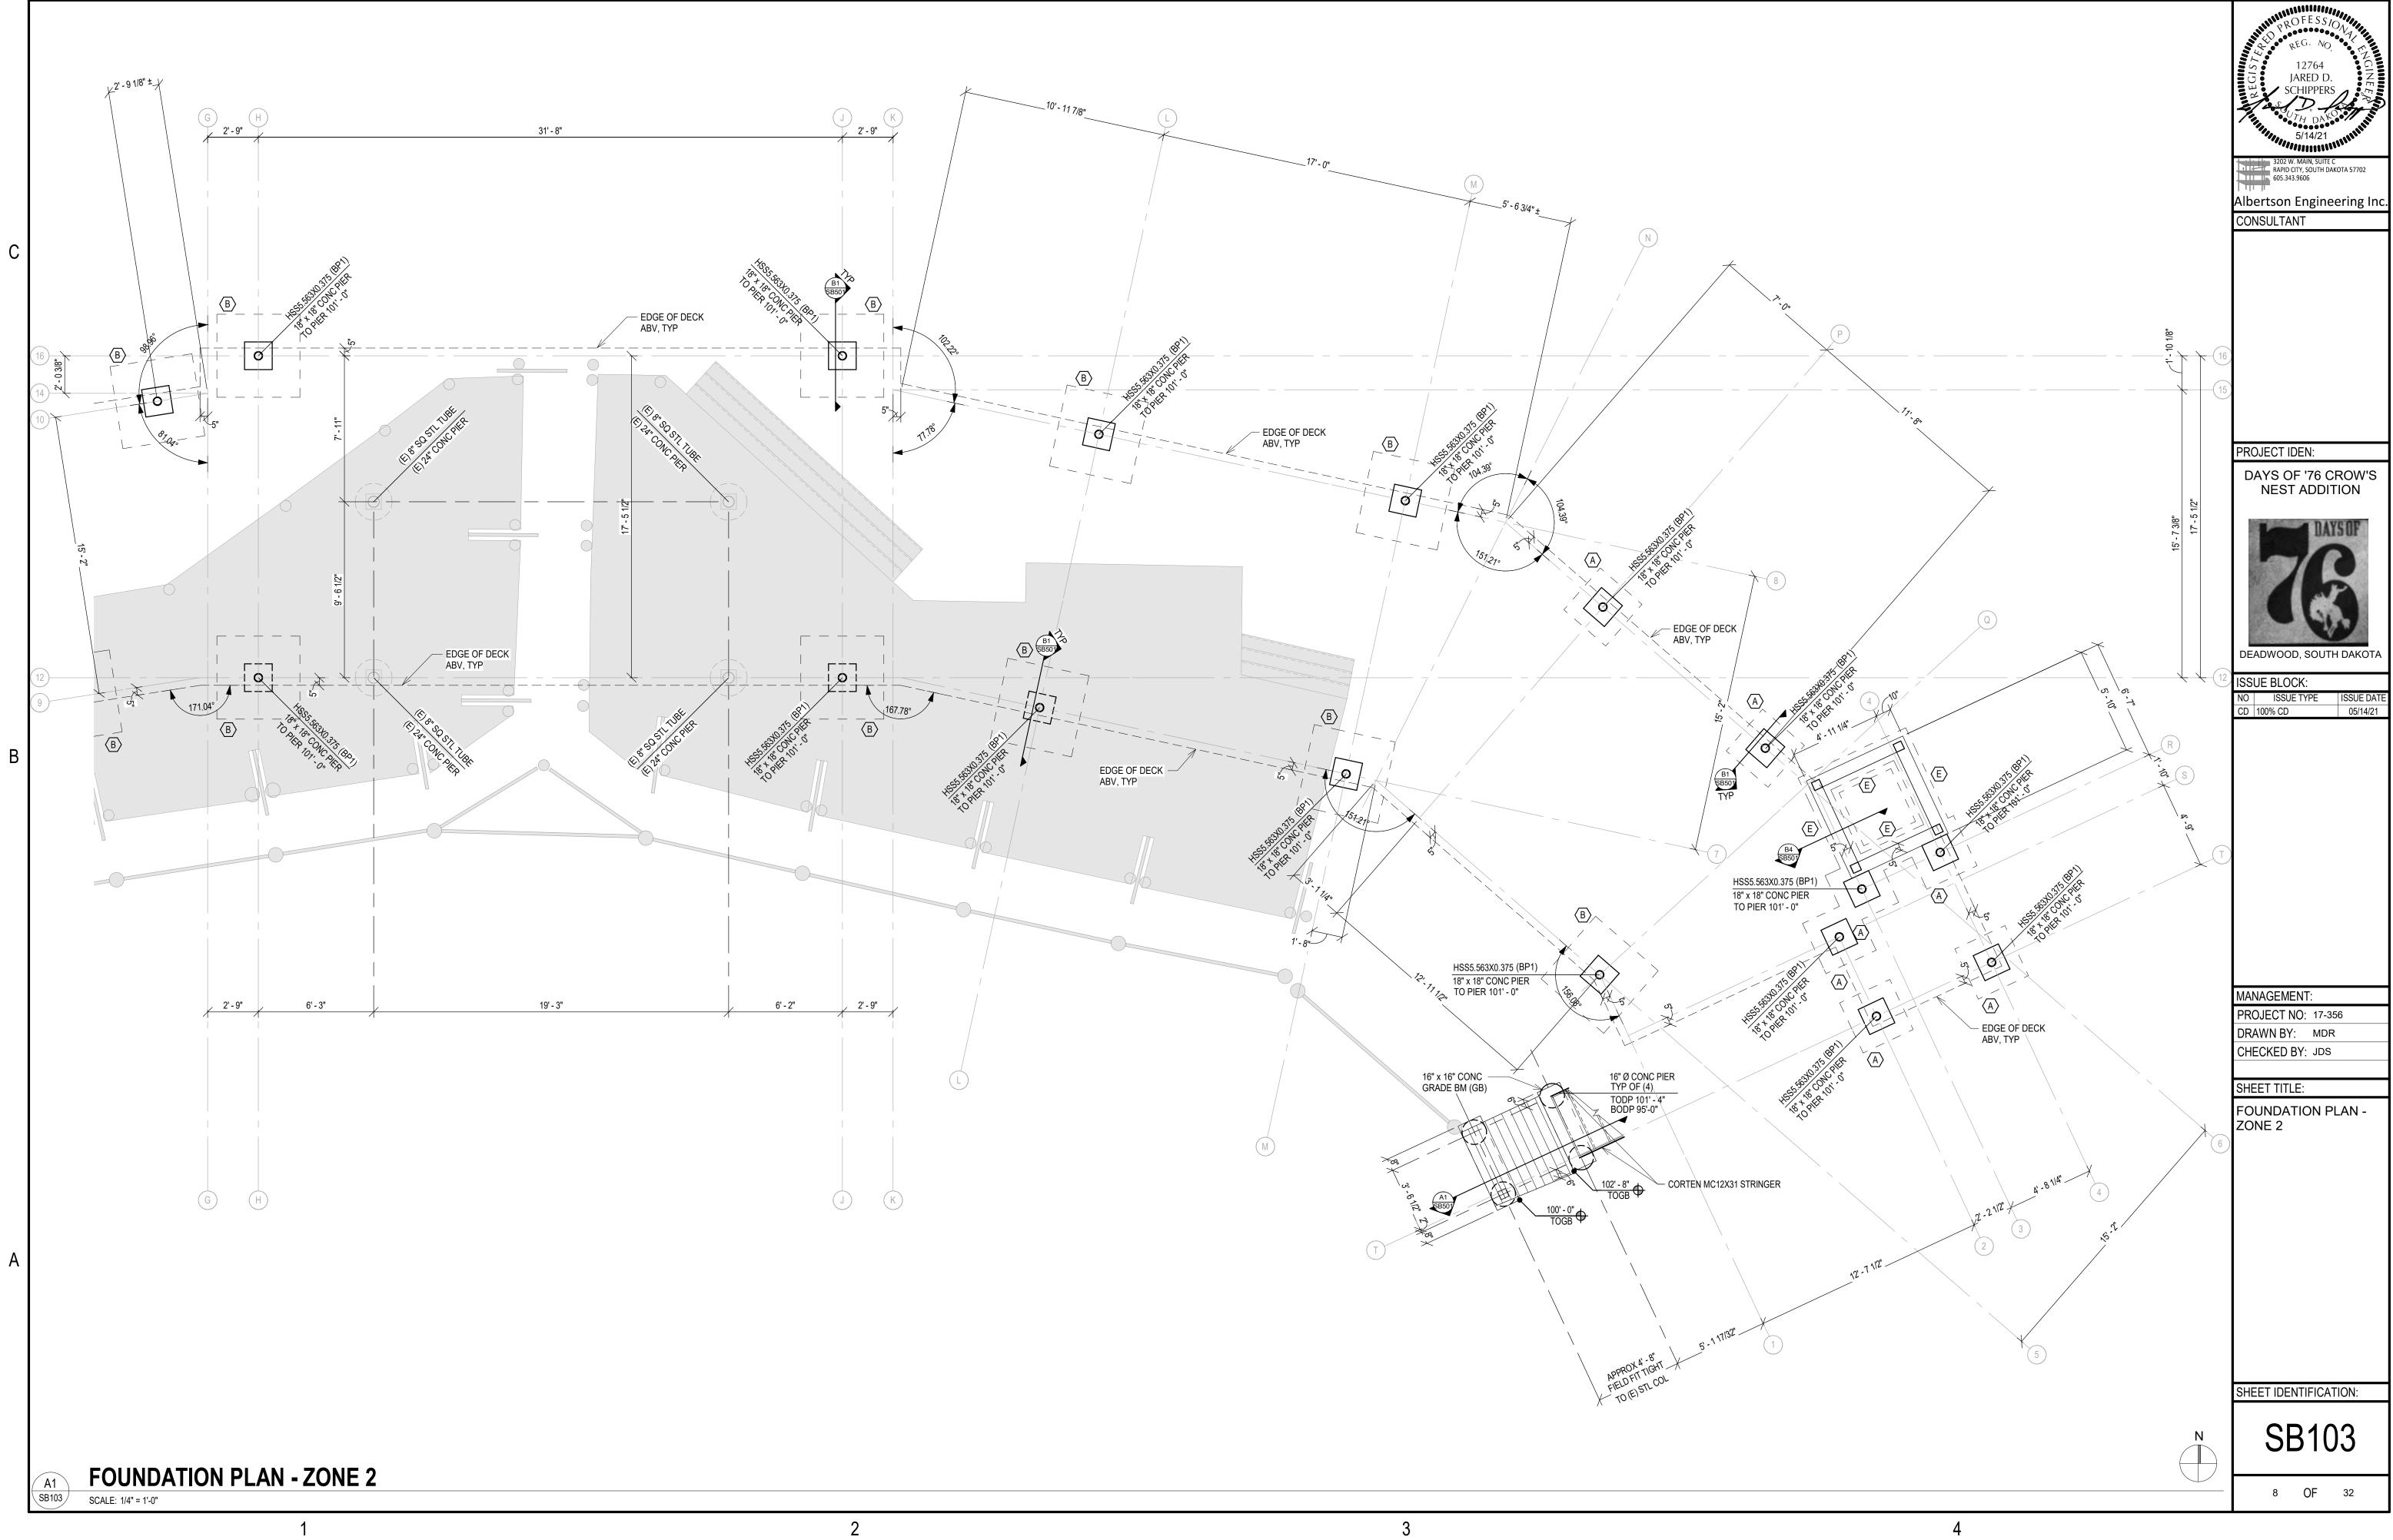

1 DECK FRAMING PLAN - OVERALL SF104 SCALE: 1/8" = 1'-0"

1


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2

SCHE

3

HEDULES

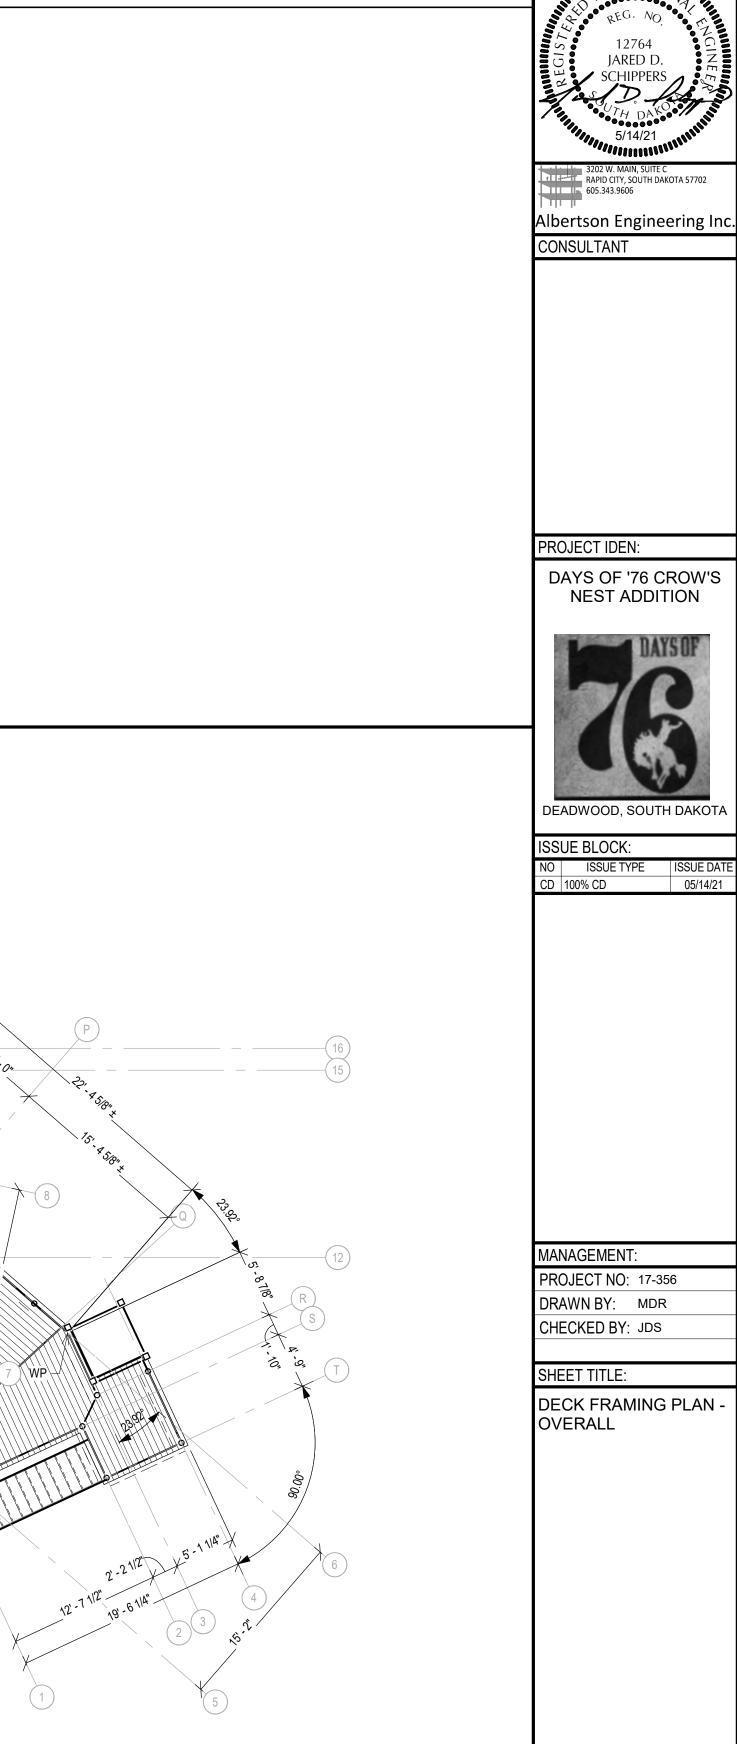


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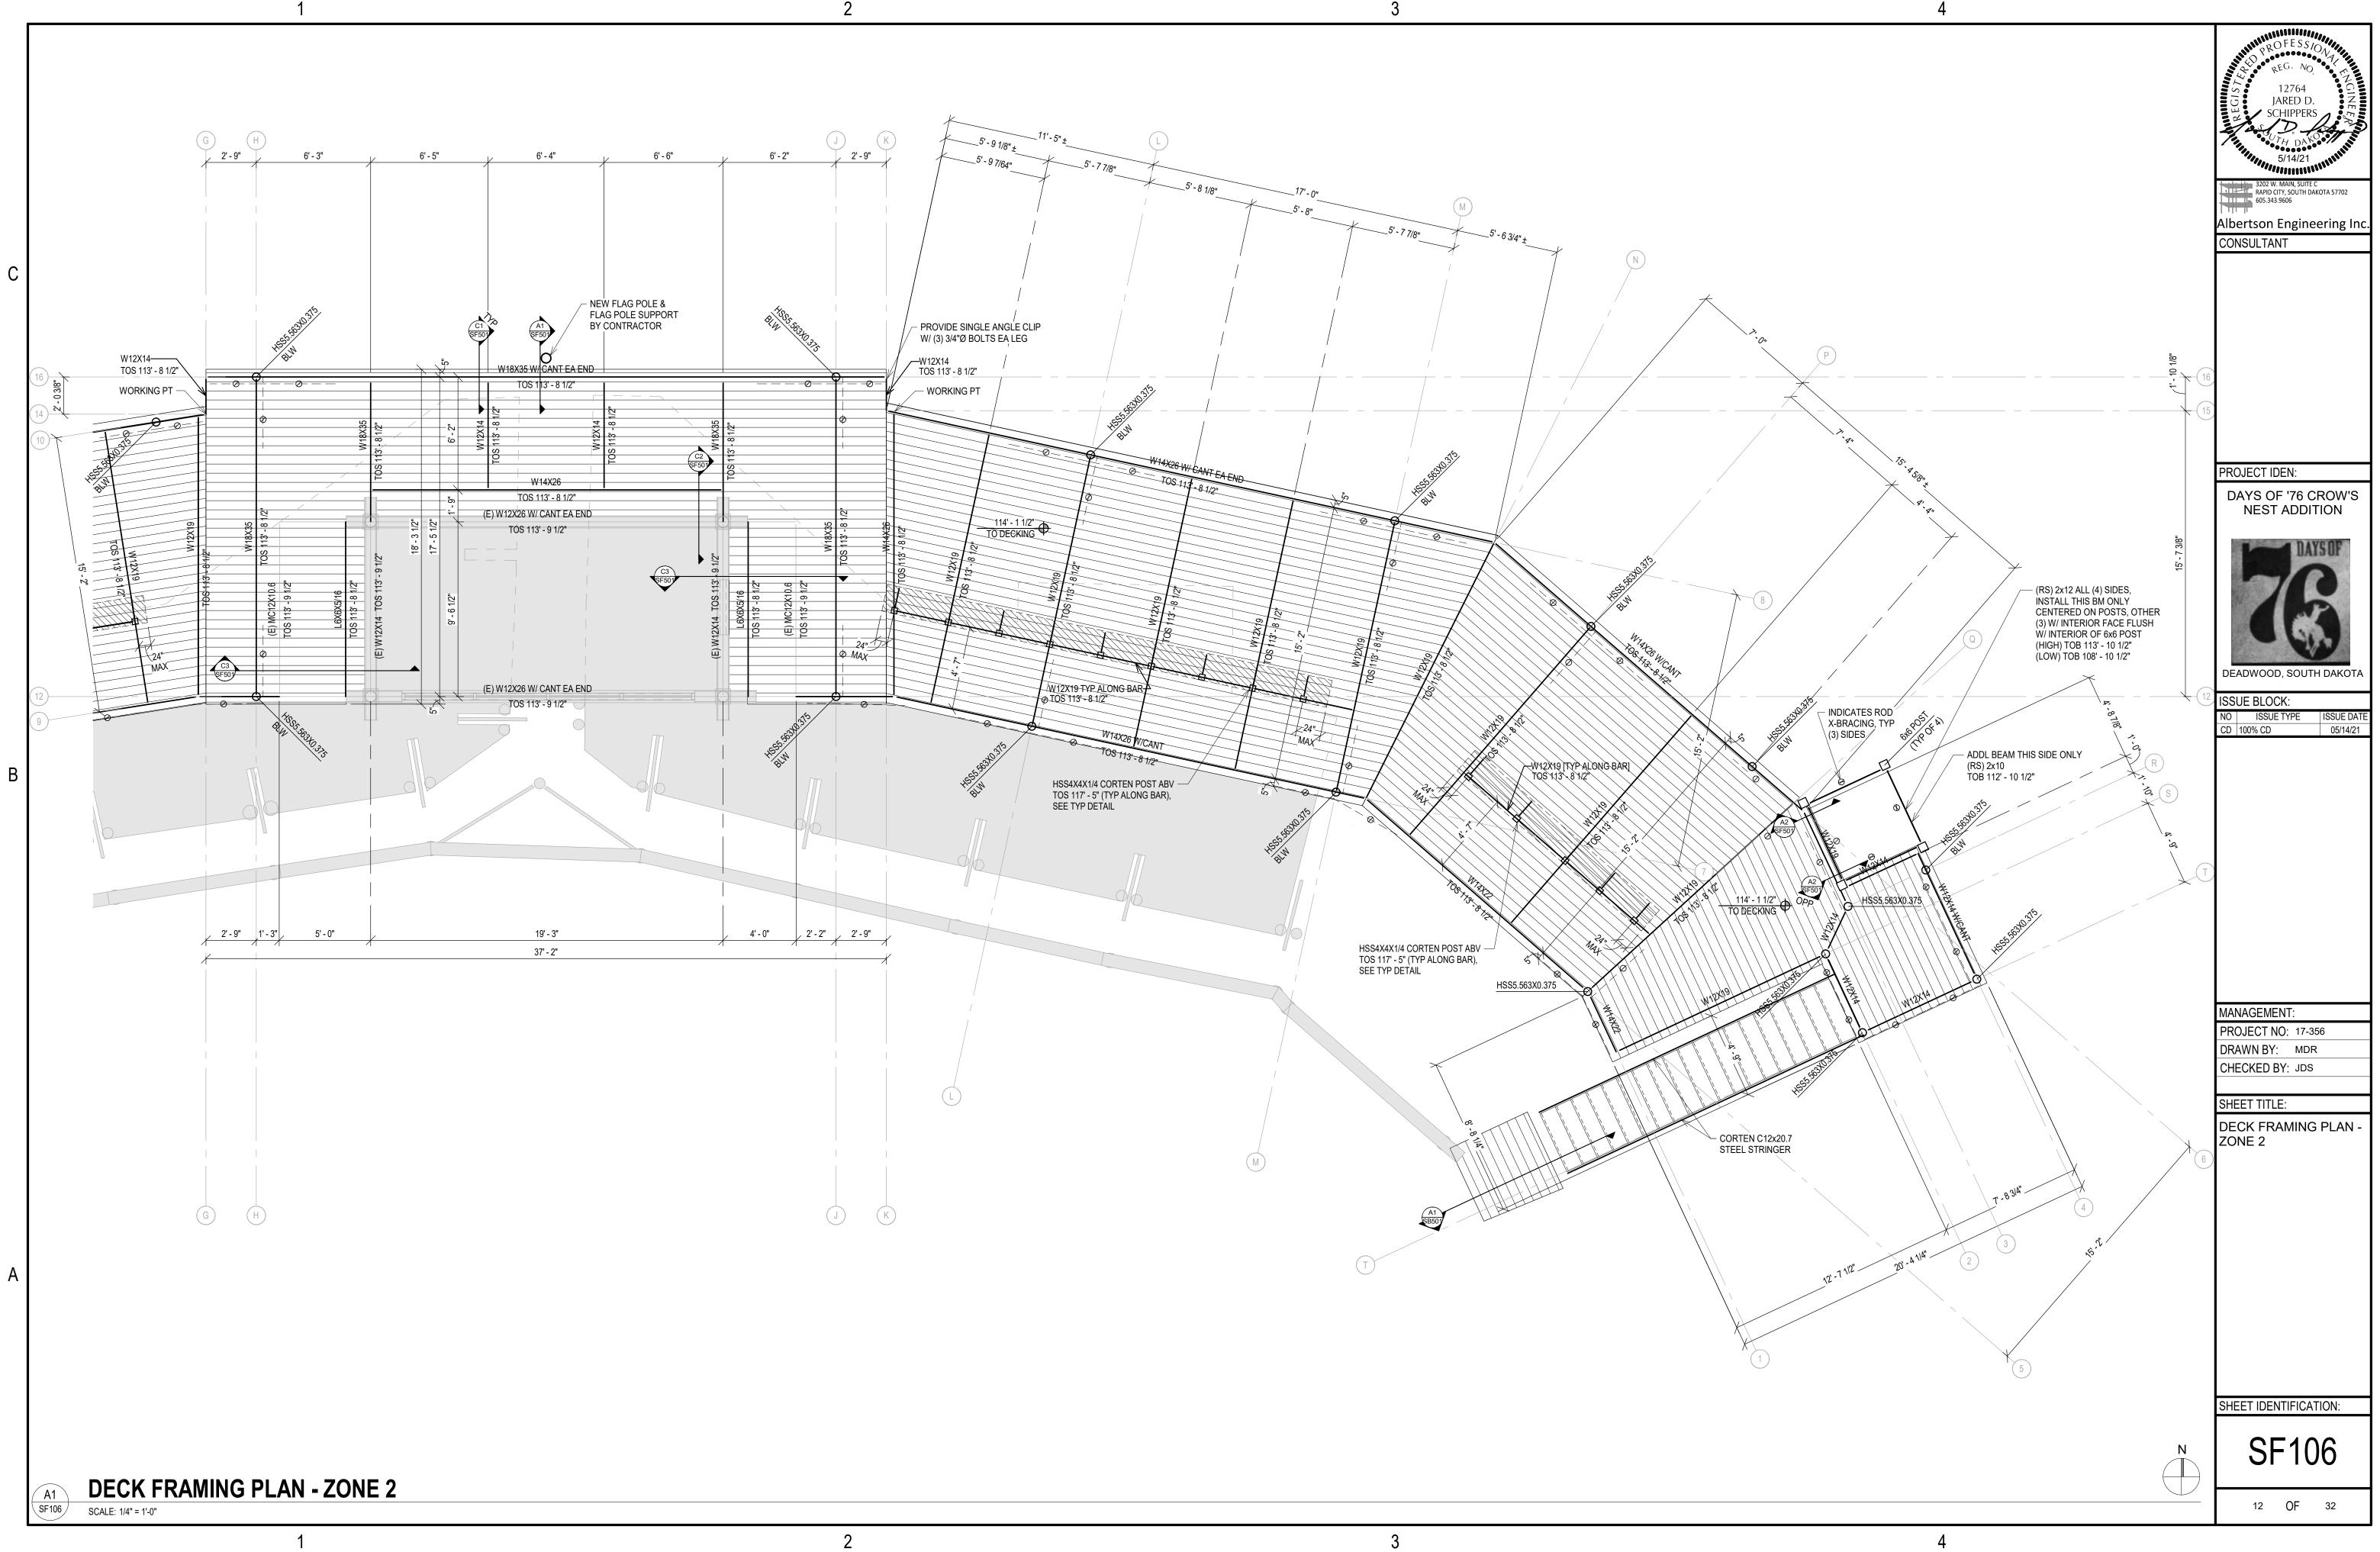
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SF104

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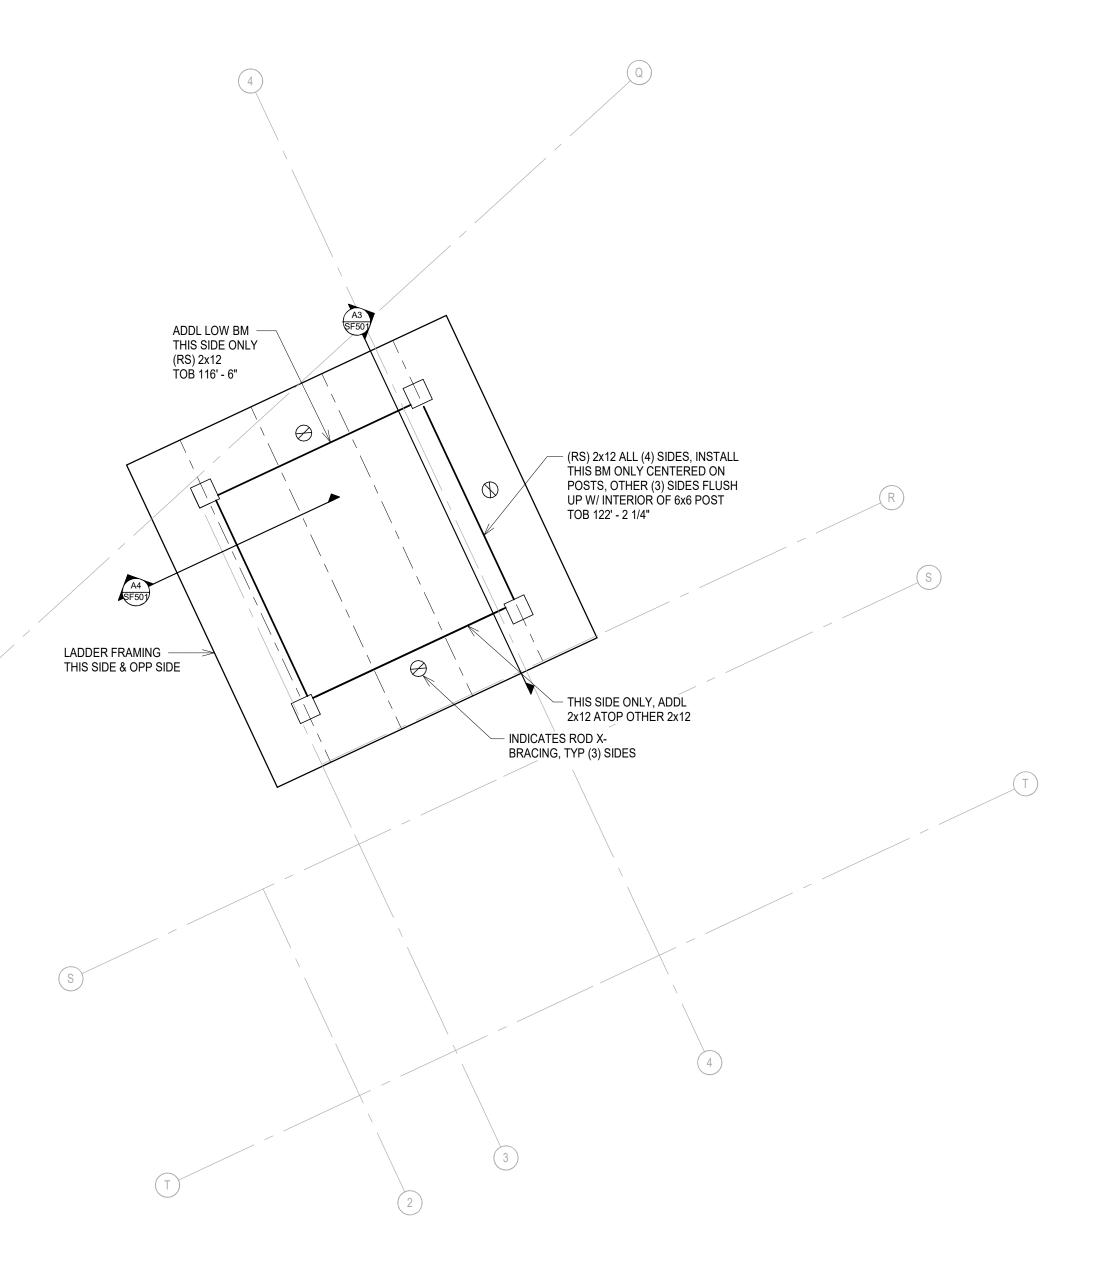
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А



VERTICAL LIFT ROOF FRAMING PLAN SCALE: 1/2" = 1'-0"

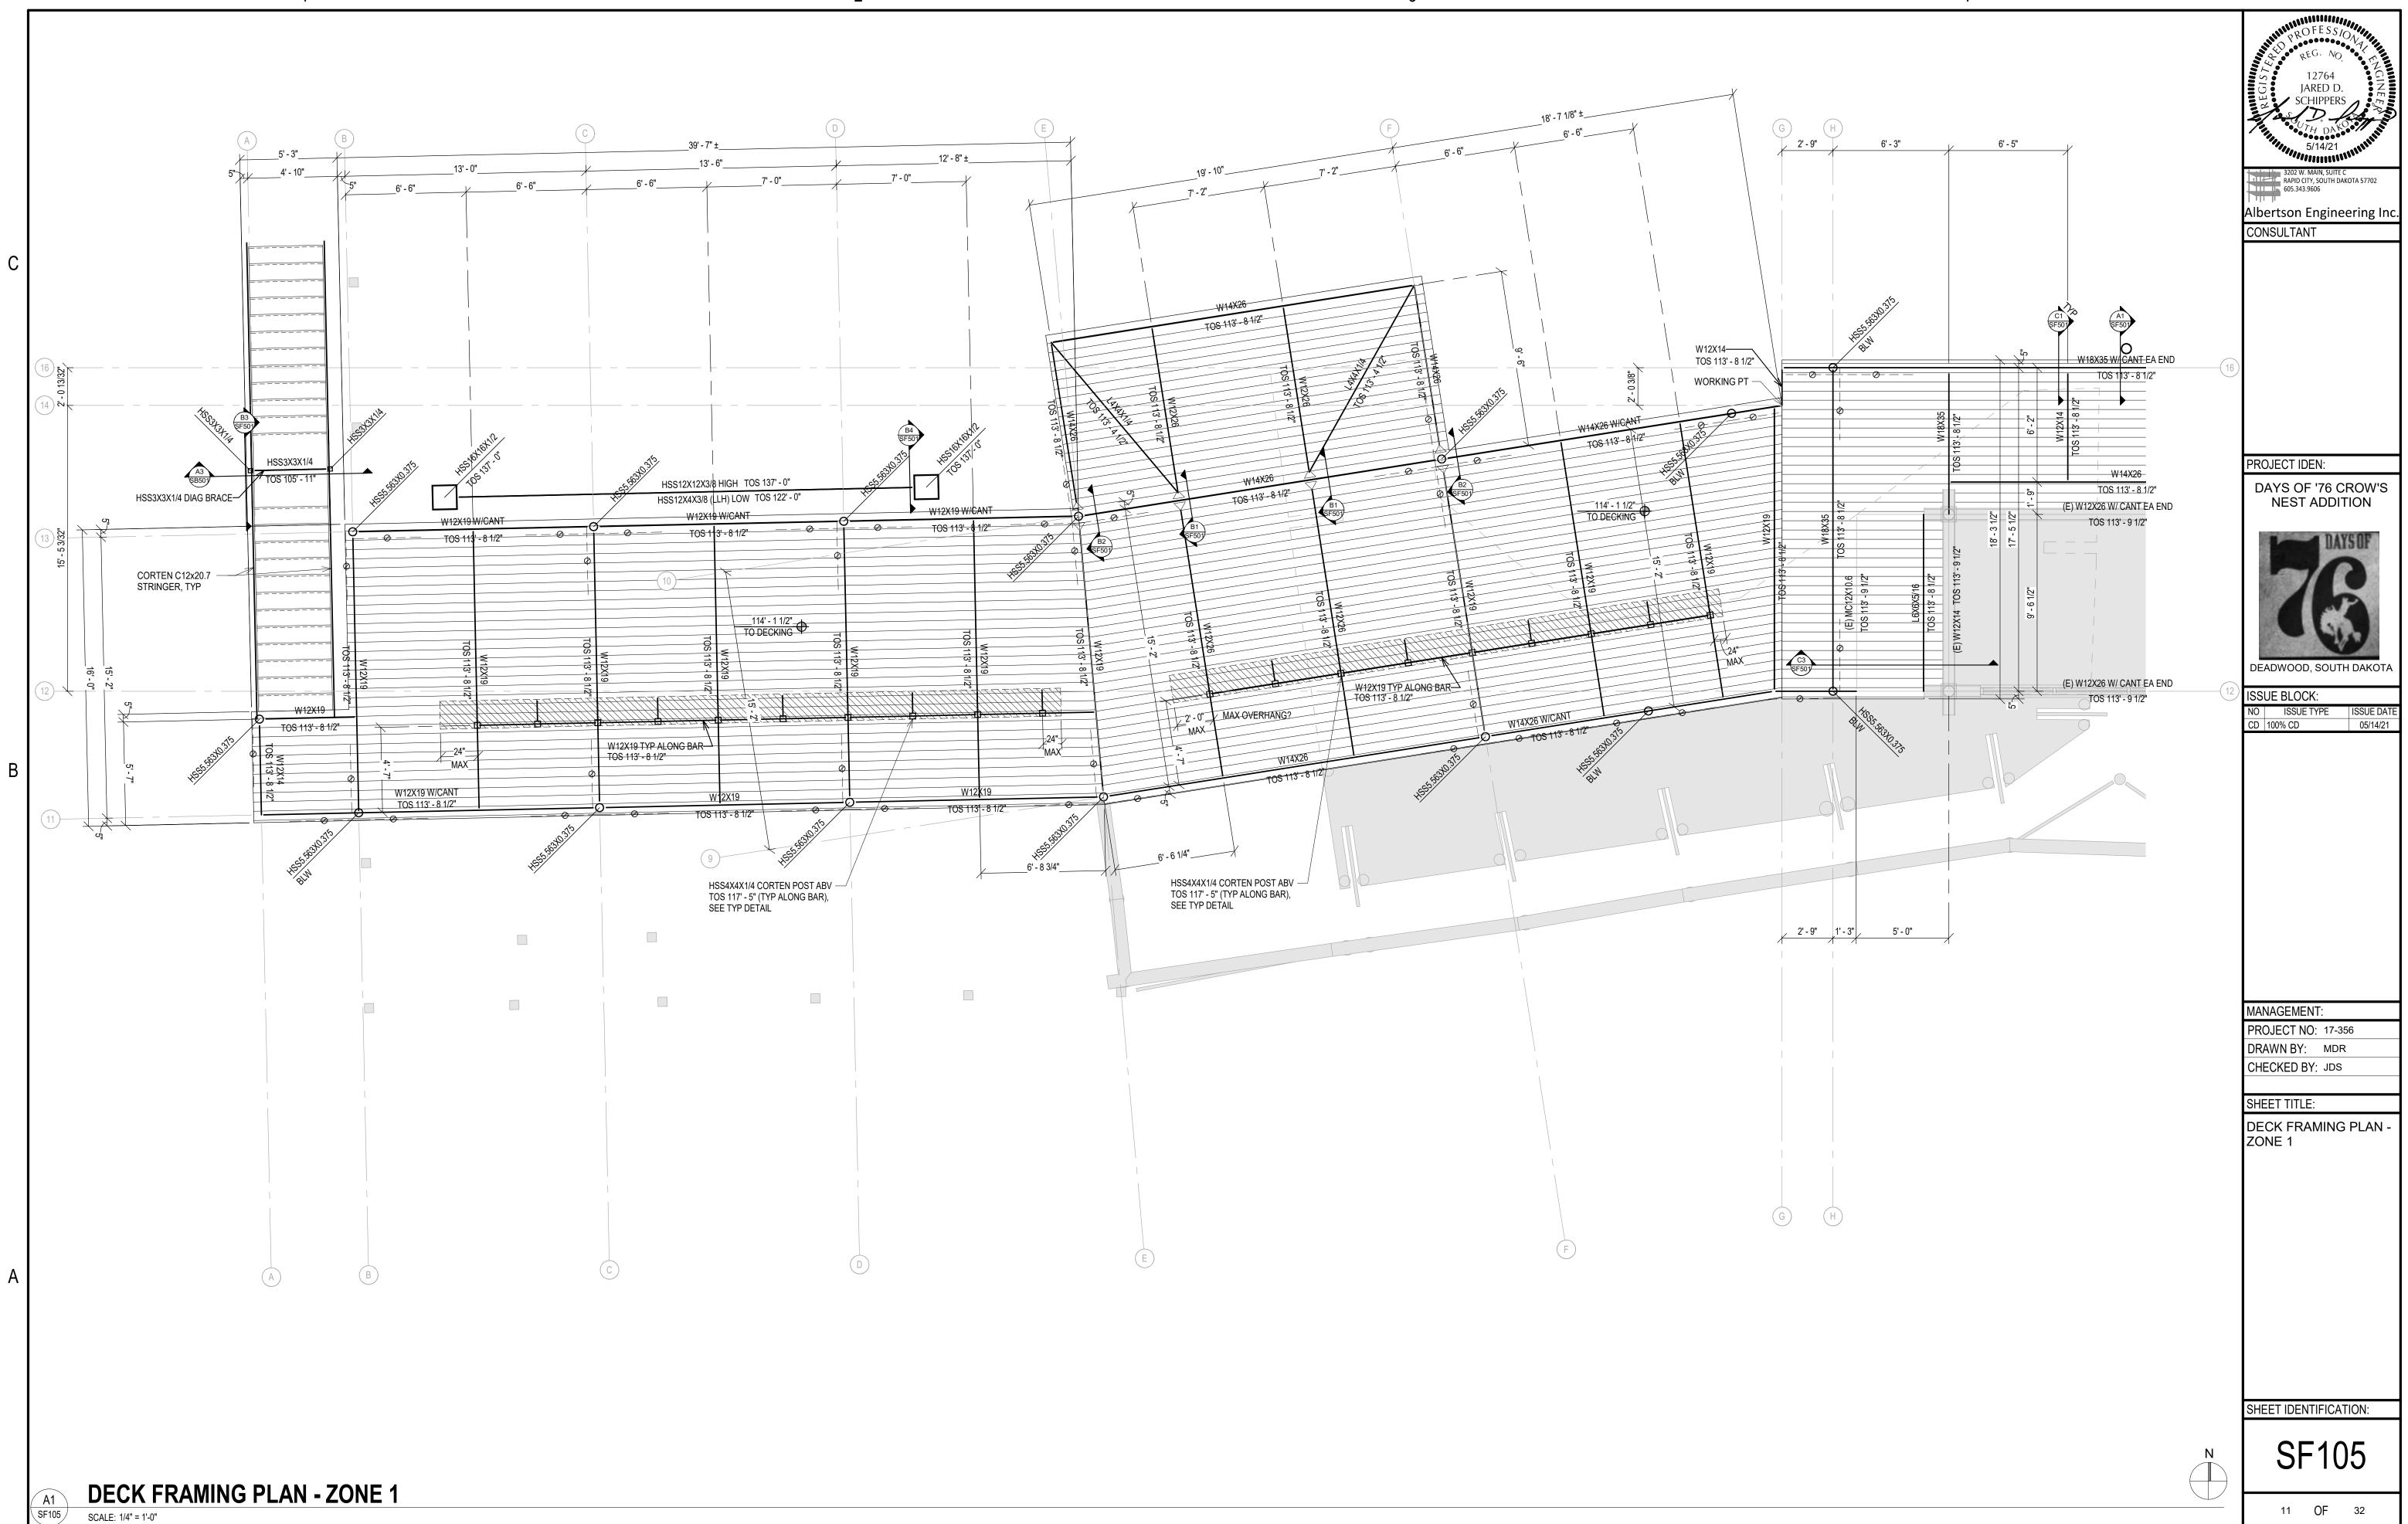1




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	A Consultant
	PROJECT IDEN: DAYS OF '76 CROW'S NEST ADDITION DEADWOOD, SOUTH DAKOTA ISSUE BLOCK:
	NO ISSUE TYPE ISSUE DATE CD 100% CD 05/14/21 MANAGEMENT: PROJECT NO: 17-356
	DRAWN BY: MDR CHECKED BY: JDS SHEET TITLE: VERTICAL LIFT ROOF FRAMING PLAN
	SHEET IDENTIFICATION:
-	13 OF 32

N





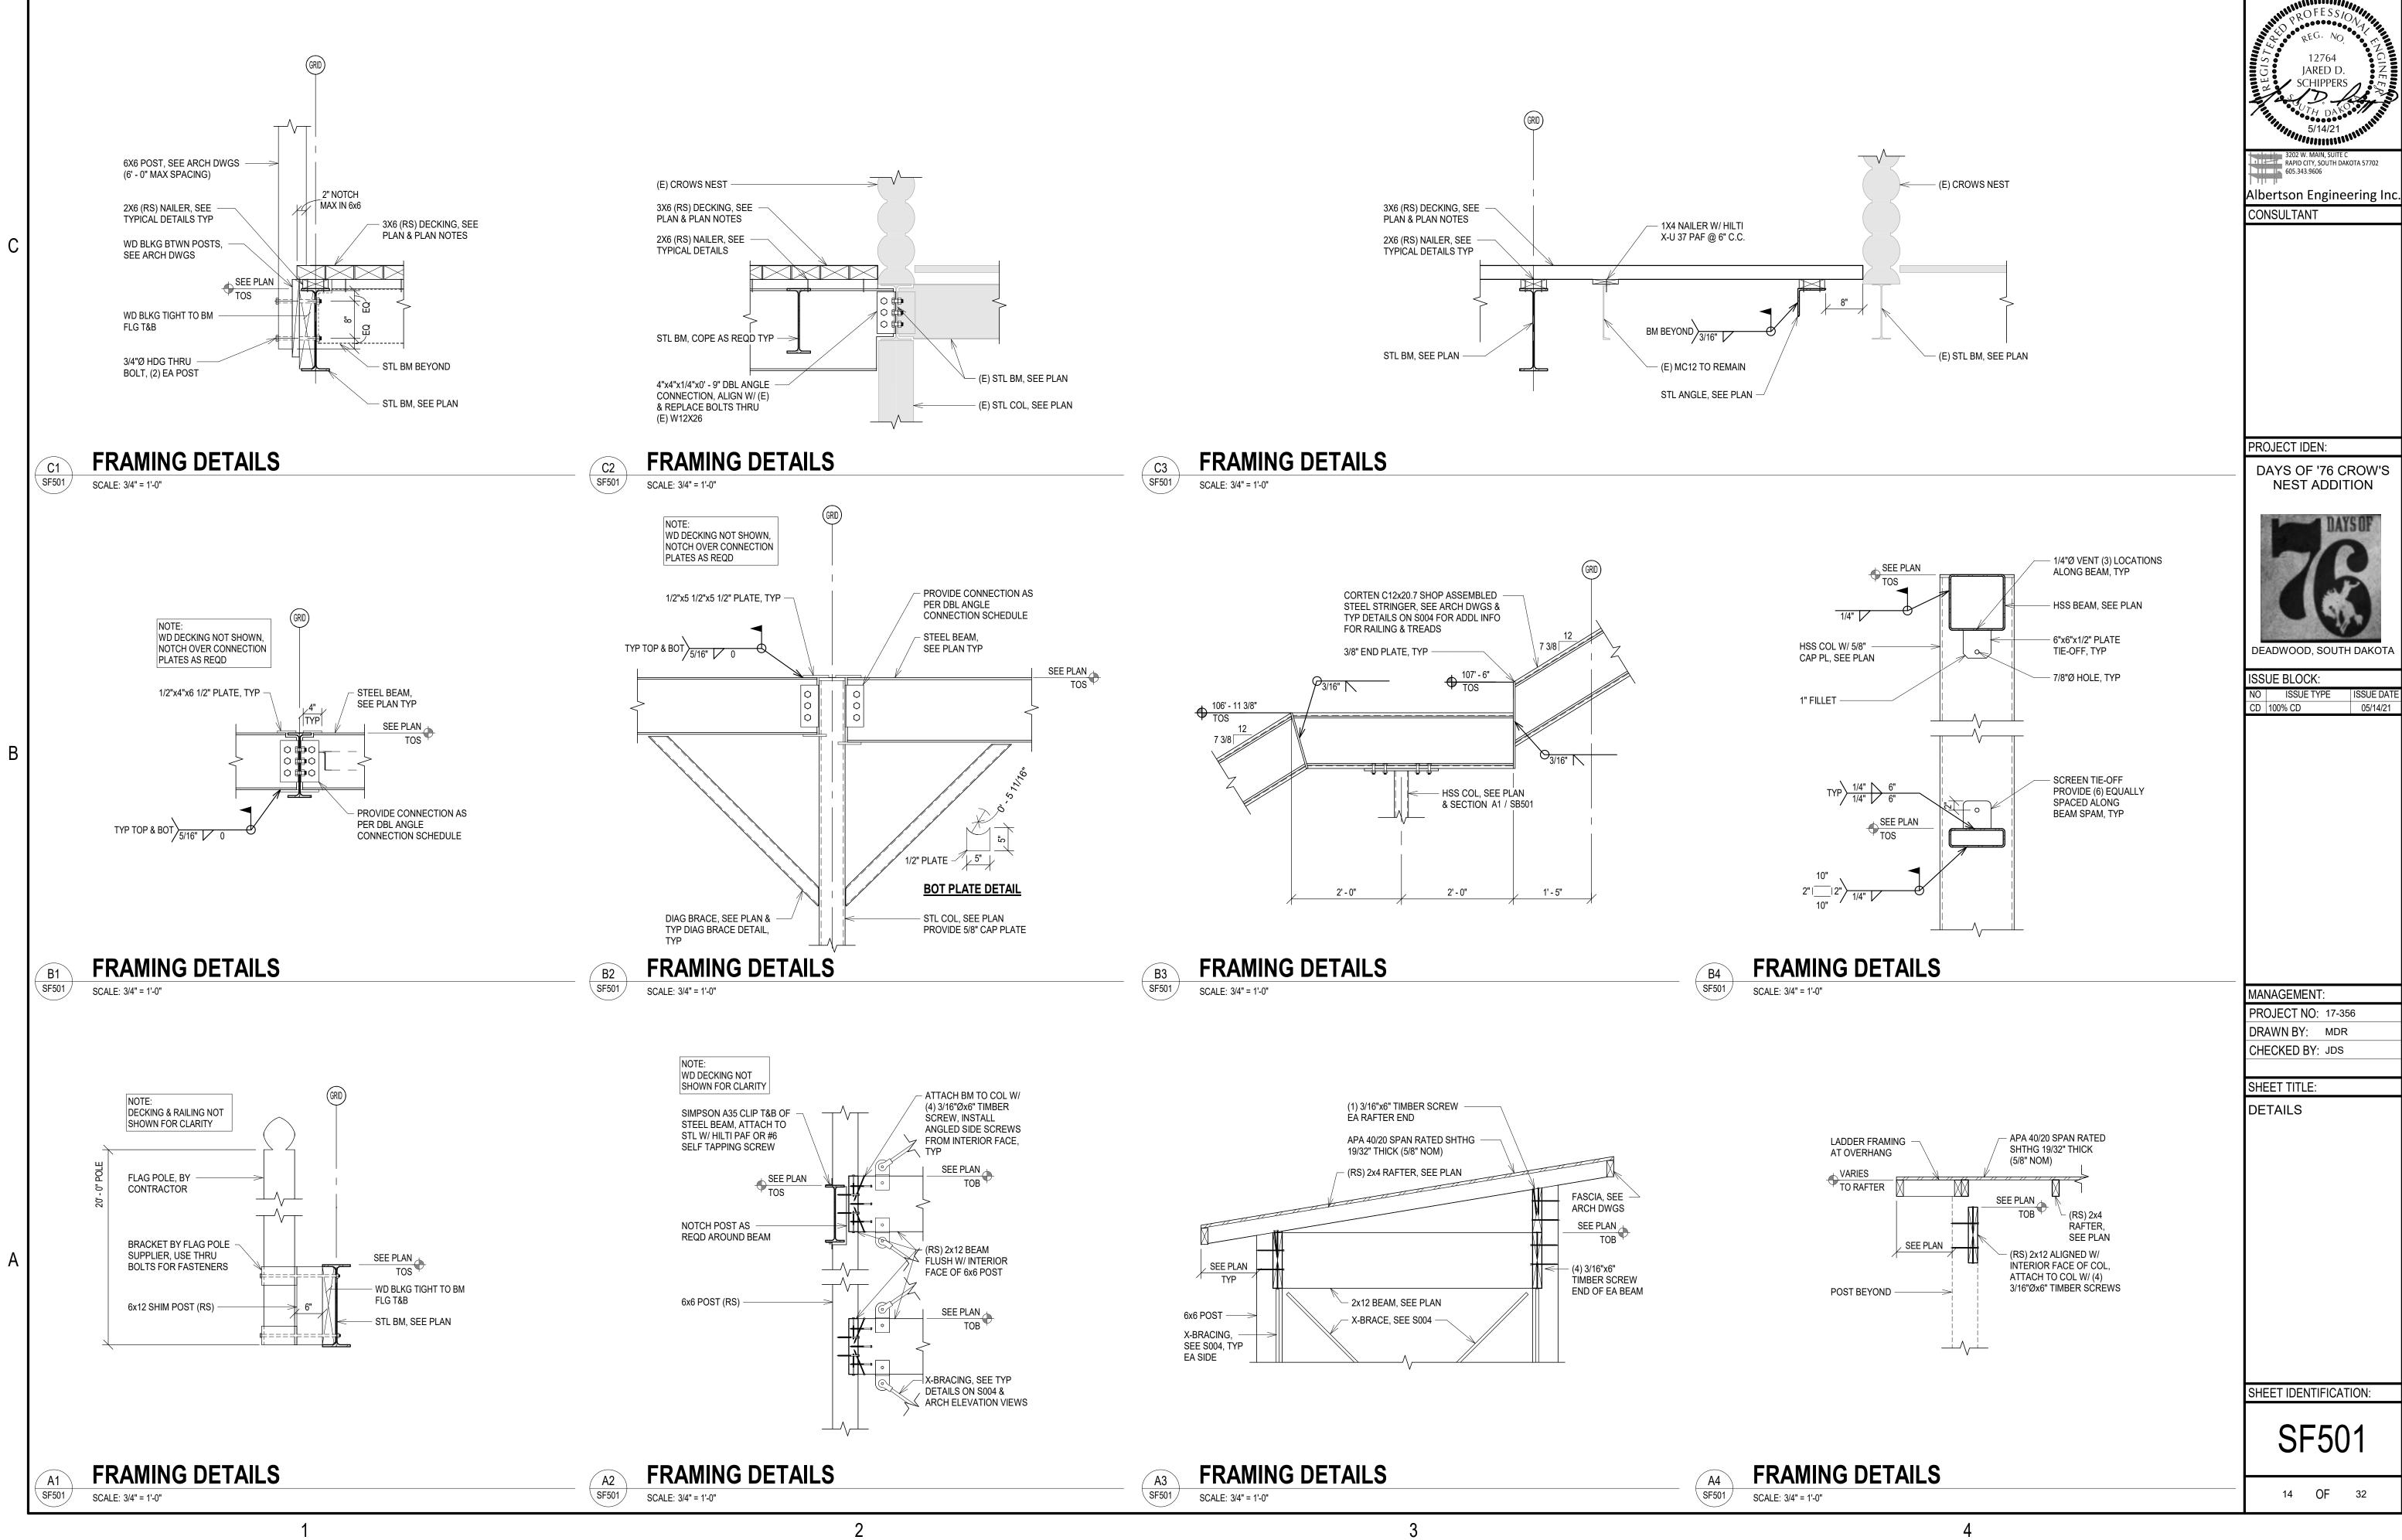

ARCHITECTURAL ABBREVIATIONS

ARCH	accessories above finished floor alternate aluminum acoustical panel ceiling architect (ural) asphalt	
BLKG BO BRG	baby changing station board building blocking bottom of bearing between	
CG CJ CLG CMU COL CONC CONT CORR CPET CPT CSMT CT CT CTR	control joint	
	direction dispenser down door downspout detail drawing	
E ea EA EC EG	ast each evaporative cooler etched glass/glazing	

EIFS EJ EL EN EWC EWG EQ EXG EXH EXP EXT	exterior insul finish sys expansion joint elevation electric (al) emergency electric water cooler end wall corner guard equal existing exhaust exposed exterior
FO	furnished by owner floor drain foundation fire extinguisher fire extinguisher cabinet finished end panel finished floor elevation finish flashing floor (ing) fluorescent face of framing fiber reinforced plastic foot (feet) footing
GA GAL GB GC GL GWB GYP	gage, gauge gallon galvanized grab bar general contractor glass, glazing gypsum wallboard gypsum
HAS HB HCP HDR HDW HM HOR HSS HT HVAC aii HWD	headed anchor stud hose bibb handicap (ed) header hardware hollow metal horizontal hollow structural sections height heating /ventilation / r conditioning hardwood

INCL	include (d) (ing)
INSUL	insulate (d) (ing)
INT	interior
INV	invert
JST	joist
JT ja	int
L le	ngth, angle
LAM	laminate (d)
LAV	lavatory
LB	pound
LF	lineal foot
LG	laminated glass, glazing
LIN	linoleum
LT	light
MA MAS MATL MAX MB MECH MFR MH MIN MISC MLD MO MT MTL	maximum marker board
N/A NIC NOM NTS	orth not applicable not in contract nominal not to scale necessary
OFD OFOI	on center (s) outside diameter owner furnished, ontractor installed overflow drain owner furnished, wner installed overhead occupant load occupant load factor

OPH OPP OSB OTS	opposite hand opposite oriented strand board open to structure
PLAM PLT PNL PR PROJ PSF PSI PT PTD PTD PTN PVC	particle board perforate (d) perimeter plastic laminate plate panel paint (ed) pair projector, projection pounds per square foot pounds per square inch pressure treated paper towel dispenser partition polyvinyl chloride pavement plywood
QT	quarry tile
RB REC REMD RE REF REIN REQ REV RD RFG RH RM RO ROW RR RS RTU RUB	er, radius rubber base recycling recommend (ed) (ations) reference refrigerator reinforce (d) (ing) required revision (s), revised roof drain roofing robe hook room rough opening right of way restroom rough sawn roof top unit rubber
S so SAG SC SCH	uth susp acoustic grid shower curtain rod & hooks

SD soap dispenser

OPG opening

SYMBOLS

SHT sheet		
SHTG sheathing	\sim	
SIM similar		
SND sanitary napkin disposal	$\zeta \rightarrow 1$	REVISION
SNV sanitary napkin vendor		NEVISION .
SPEC specification		
SPKR speaker	👝 TOP OF WALL	_ ELEVATION
SQ square	♥ 100' 0"	
SS solid surface		
SST stainless steel	\frown	COLUMN GRID LOCATION
STD standard	(A)— — —	COLDININ GIRID LOCATION
STL steel	\bigcirc	
STOR storage	(1014)	DOOR NUMBER
STR structural	(101A)	BOOK NOMBER
SUSP suspended	\sim \sim	
	(AL) (HM)	WINDOW TYPE
T tread		
TB towel bar	C	CENTER LINE
TD travel distance	ፍ	oen en en en
TEL telephone		
T.O. top of		LINE OF WALL ABOVE OR HIDDEN LINE
TOC top of concrete		
TOS top of steel		
TOW top of wall		
TPD toilet paper dispenser		BREAK LINE
TS tube steel	\vee	
TYP typical		MATCH LINE
T&G tongue and groove		
	Room	
UNO unless noted otherwise		ROOM NAME
	101	ROOM NUMBER
VB vapor barrier		
VCT vinyl composition tile	1	
VERT vertical		
VIF verify in field		
VM vending machine		INTERIOR WALL ELEVATION
VNL vinyl sheet	4 A101 2	REFERENCE DRAWING
VTR vent through roof	\sim	
W west, wide, width	3	
W/ with	5	
WB wood base	📥 TYP	
WC watercloset		REFERENCED SECTION NUMBER SHEET NUMBER
WD wood	1	SHEET NUMBER
WDW window	A101	
WF wide flange		
WG wire glass		
W/O without	— 1	BASIC WALL TYPE
WP waterproof (ing)		DASIG WALL I THE
WR waste receptacle		
WRB weather resistive barrier		
WWM welded wire mesh	1	WALL TYPE AND PROPERTIES, SEE "WALL
	2 SBXD	DESIGNATION KEY" BELOW
		DESIGNATION NET DELOW

DIAMETER PERPENDICULAR PLATE \pm PLUS OR MINUS FD FLOOR DRAIN FIRE EXTINGUISHER FE

ANGLE

<u>1</u> 1 A101

REFERENCED DETAIL NUMBER SHEET NUMBER


GENERAL NOTES


- 1. COMPLY WITH ALL MANUFACTURERS RECOMMENDATIONS AND INDUSTRY STANDARDS RELEVANT TO THE WORK HEREIN.
- 2. ALL DIMENSIONS ARE FROM FACE OF FINISH UNO.
- 3. ALL ALIGNMENTS ARE FACE OF FINISH UNO.
- 4. FIELD VERIFY ALL DIMENSIONS AND ROUGH OPENINGS PRIOR TO FABRICATION AND/OR INSTALLATION.

DRAWING LIST

ARCHITECTURAL

A002 CODE CHECKLIST & LIFE SAFETY PLAN A001 NOTES, SYMBOLS, ABBREVIATIONS AND WALL TYPES LOWER LEVEL - FLOOR PLAN A101 A102 UPPER LEVEL - FLOOR PLAN A121 REFLECTED CEILING PLAN A201 EXTERIOR ELEVATIONS A301 ENLARGED STAIR PLANS & DETAILS A302 ENLARGED STAIR PLANS & DETAILS A501 BUILDING SECTIONS A611 ARCHITECTURAL DETAILS - EXTERIORS

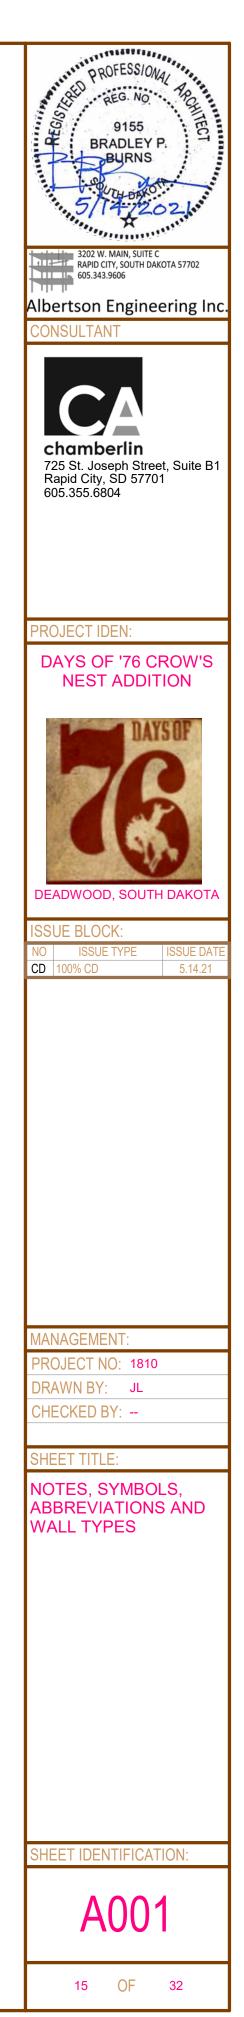

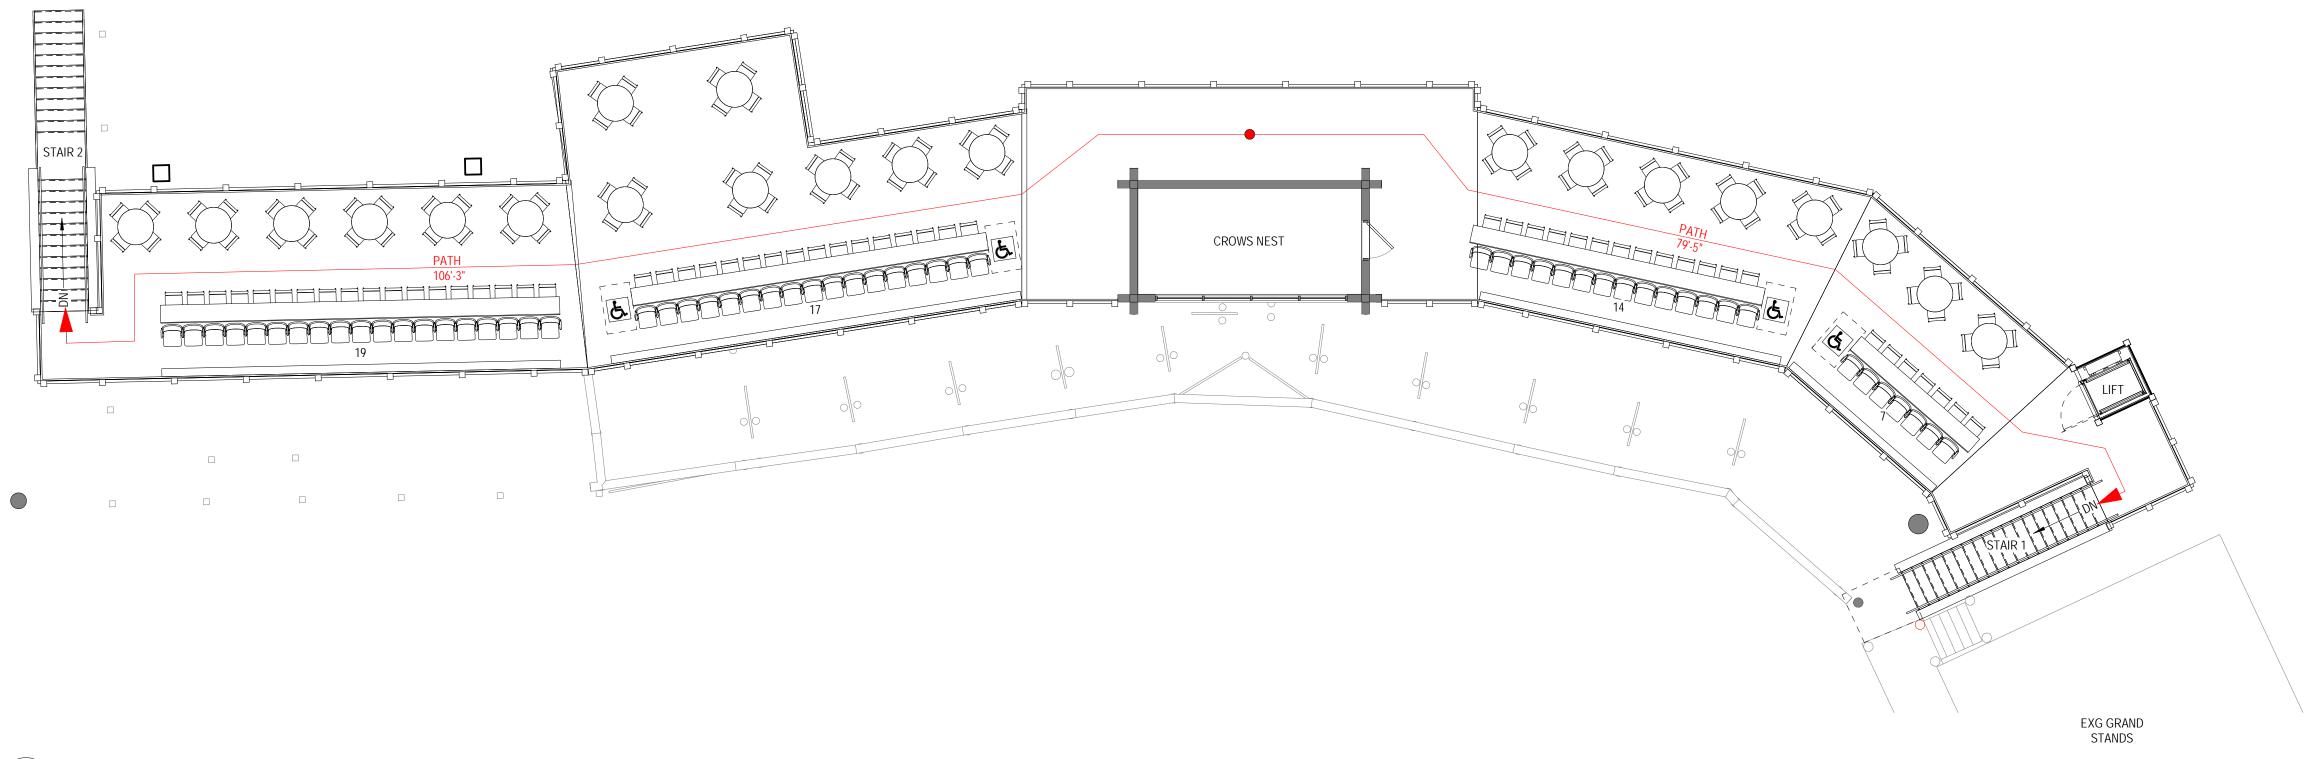




CODE CHECKLIST			
TOTAL OCCUPANT LOAD:		ALLOWABLE AREA INCREASES	
NUMBER OF EXITS REQUIRED FOR BUILDING (TABLE 1006.3.2):	2	AUTOMATIC SPRINKLER SYSTEM: (SECTION 506.3)	NO
OCCUPANT LOAD: UPPER LEVEL PATIO (ASSEMBLY) 2,735 SF	2,735/15 = 183	ALLOWABLE NUMBER OF STORIES:	UNLIMITED UNLIMITED
TOTAL TRIBUTARY OCCUPANT LOAD (TOL)	183	(504.4)	UNLIWITED
EXIT ACCESS TRAVEL DISTANCE (1017.2):	200 FEET	ALLOWABLE BUILDING HEIGHT: (504.3)	40 FEET
		ALLOWABLE NUMBER OF STORYS: (504.4)	UNLIMITED


CODE IN USE:

2018 INTERNATIONAL BUILDING CODE (IBC) 2018 INTERNATIONAL MECHANICAL CODE (IMC) 2019 INTERNATIONAL PLUMBING CODE (IPC) 2017 NATIONAL ELECTRICAL CODE (NEC) 2018 INTERNATIONAL FIRE CODE (IFC)


TYPE OF OCCUPANCY:	GROUP A-5
TYPE OF CONSTRUCTION:	TYPE V-B
BUILDING AREA FIRST FLOOR GSF:	2,735 SQ FT
TOTAL BUILDING AREA GSF:	2,735 SQ FT
TOTAL NUMBER OF STORIES:	1
BASIC ALLOWABLE FLOOR AREA (A) (TABLE 506.2)	UNLIMITED


Albertson Engineering Inc.
PROJECT IDEN: DAYS OF '76 CROVY'S NEST ADDITION
DEADWOOD, SOUTH DAKOTA ISSUE BLOCK: NO ISSUE TYPE ISSUE DATE CD
MANAGEMENT: PROJECT NO: 1810 DRAWN BY: Author CHECKED BY: Checker
SHEET TITLE: CODE CHECKLIST & LIFE SAFETY PLAN
SHEET IDENTIFICATION:
16 OF 32

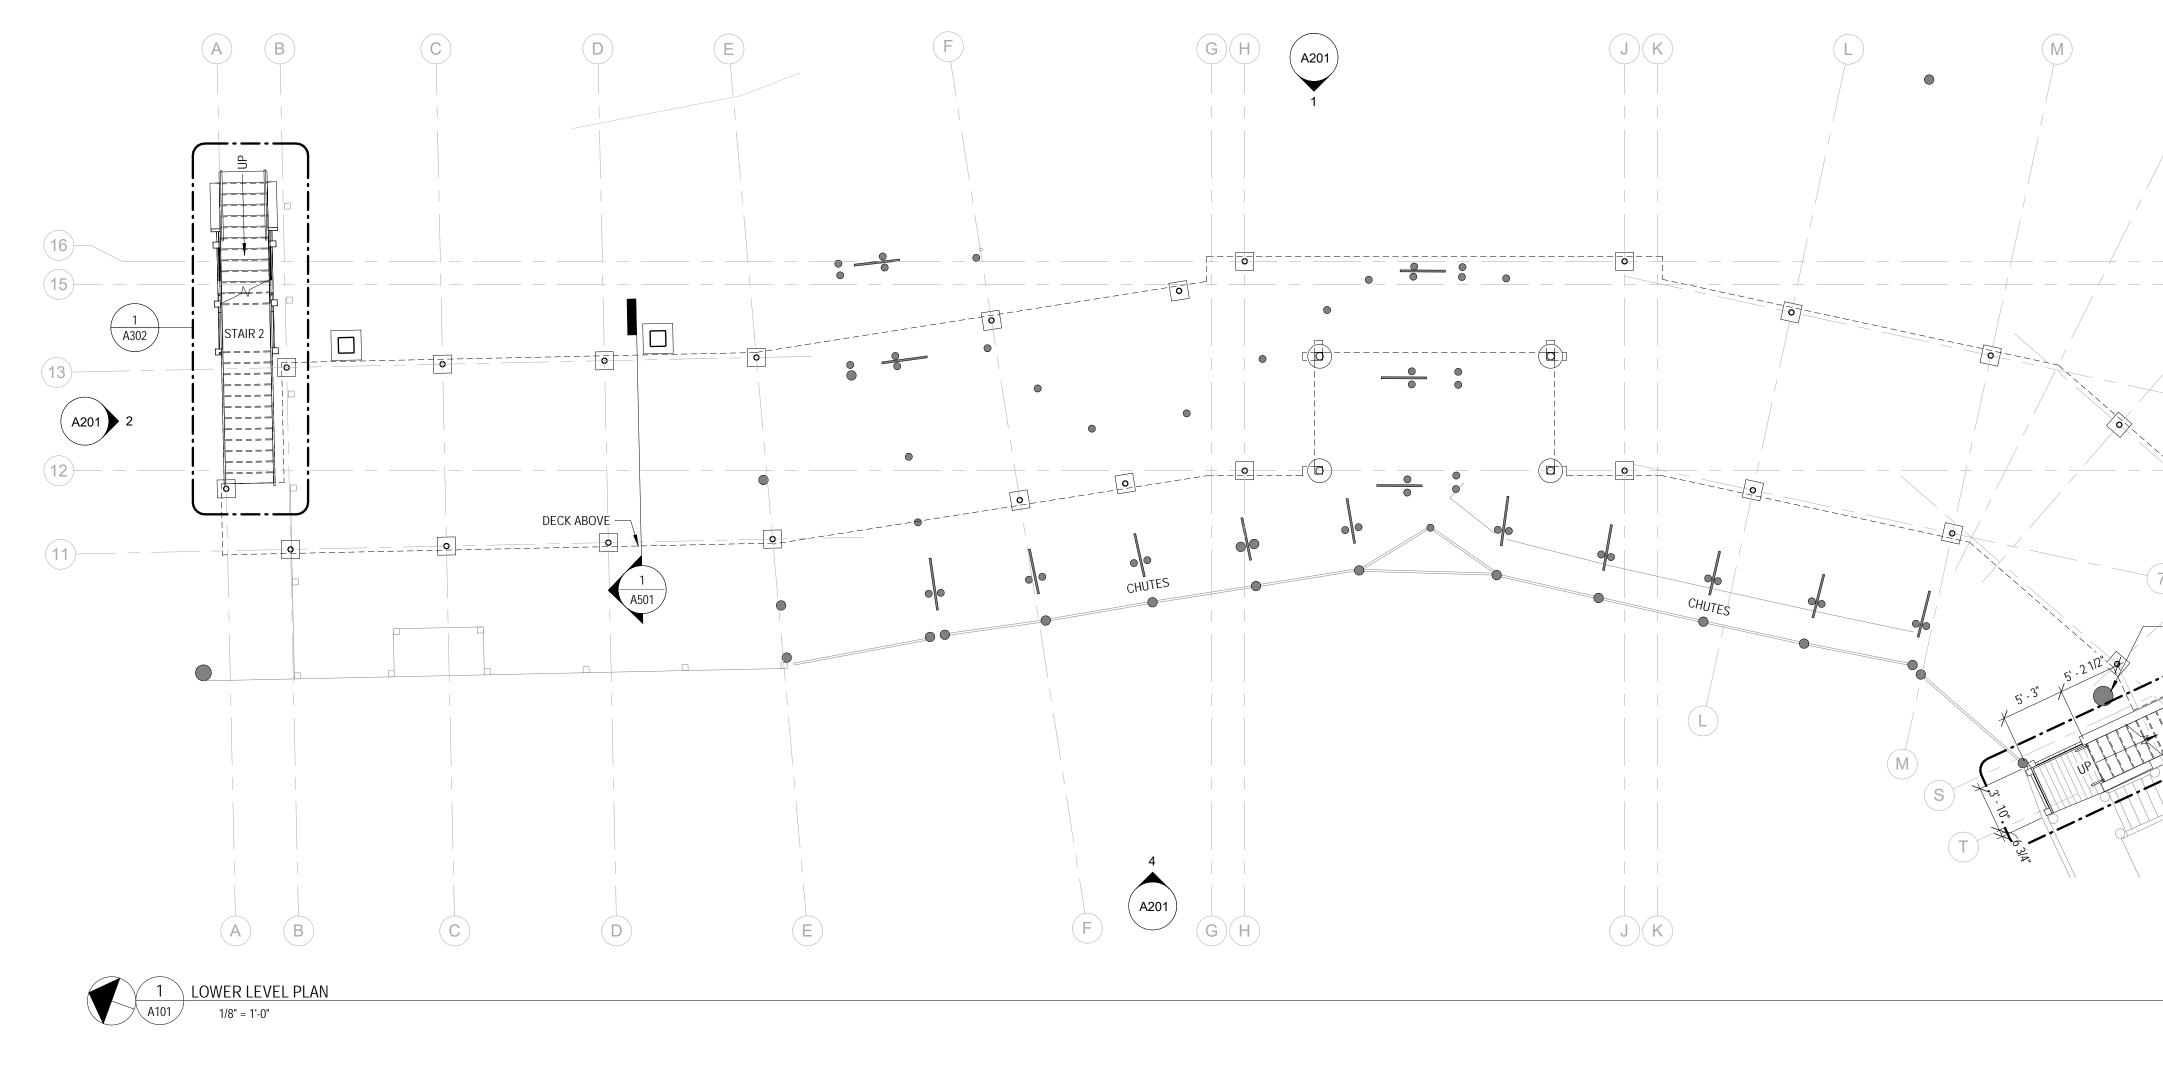

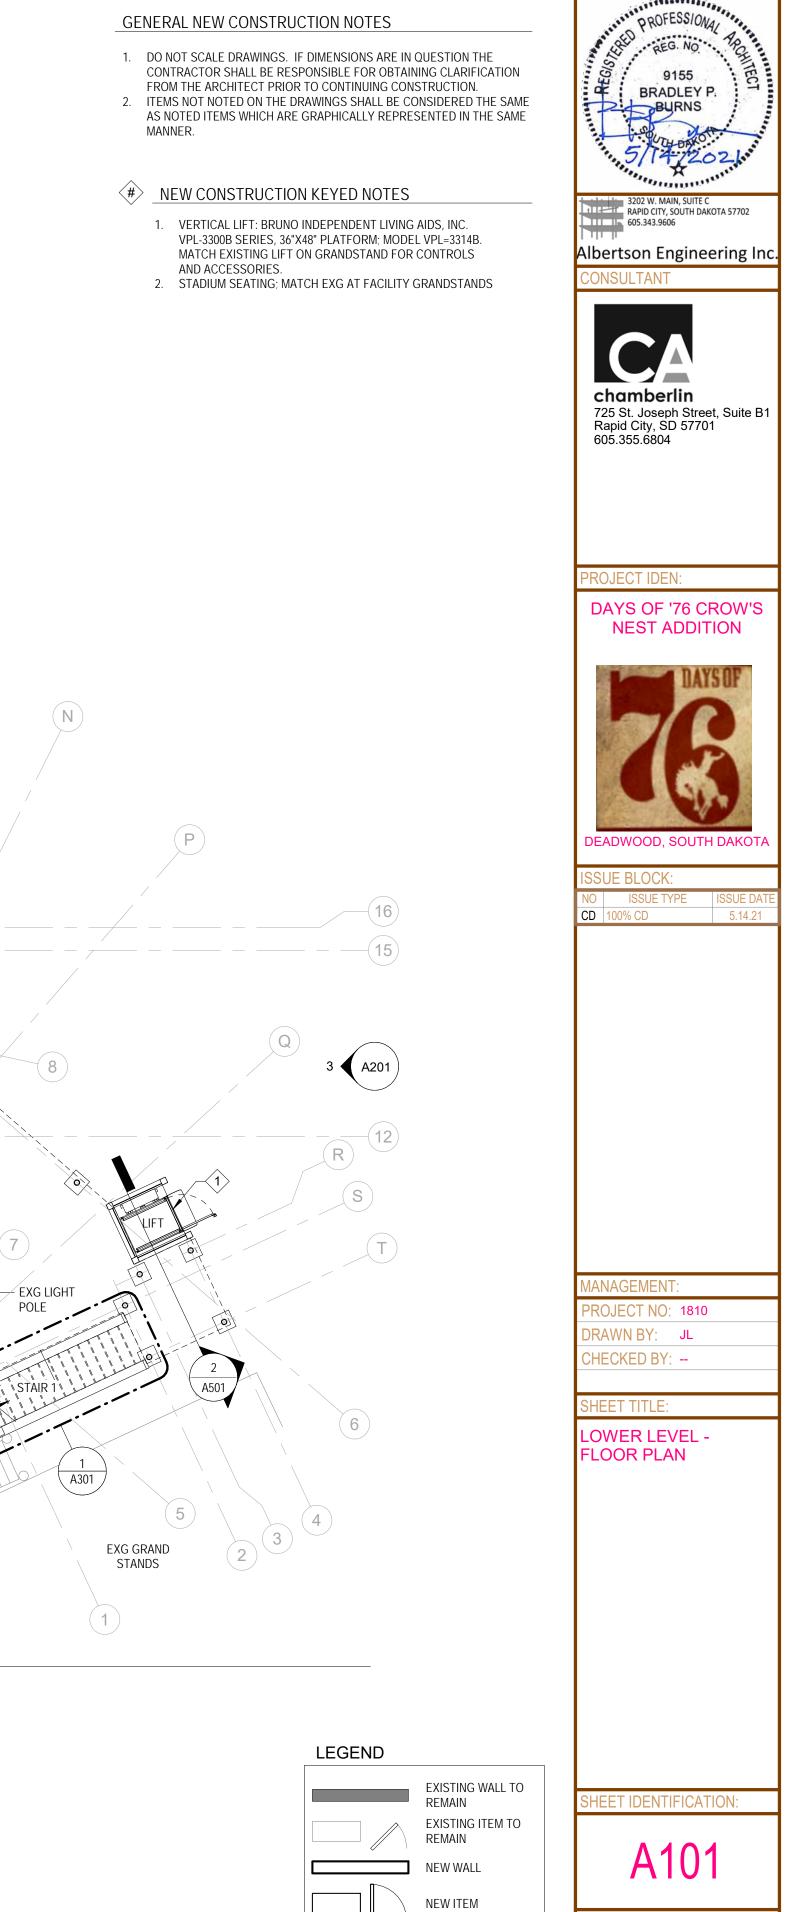


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LEGEND

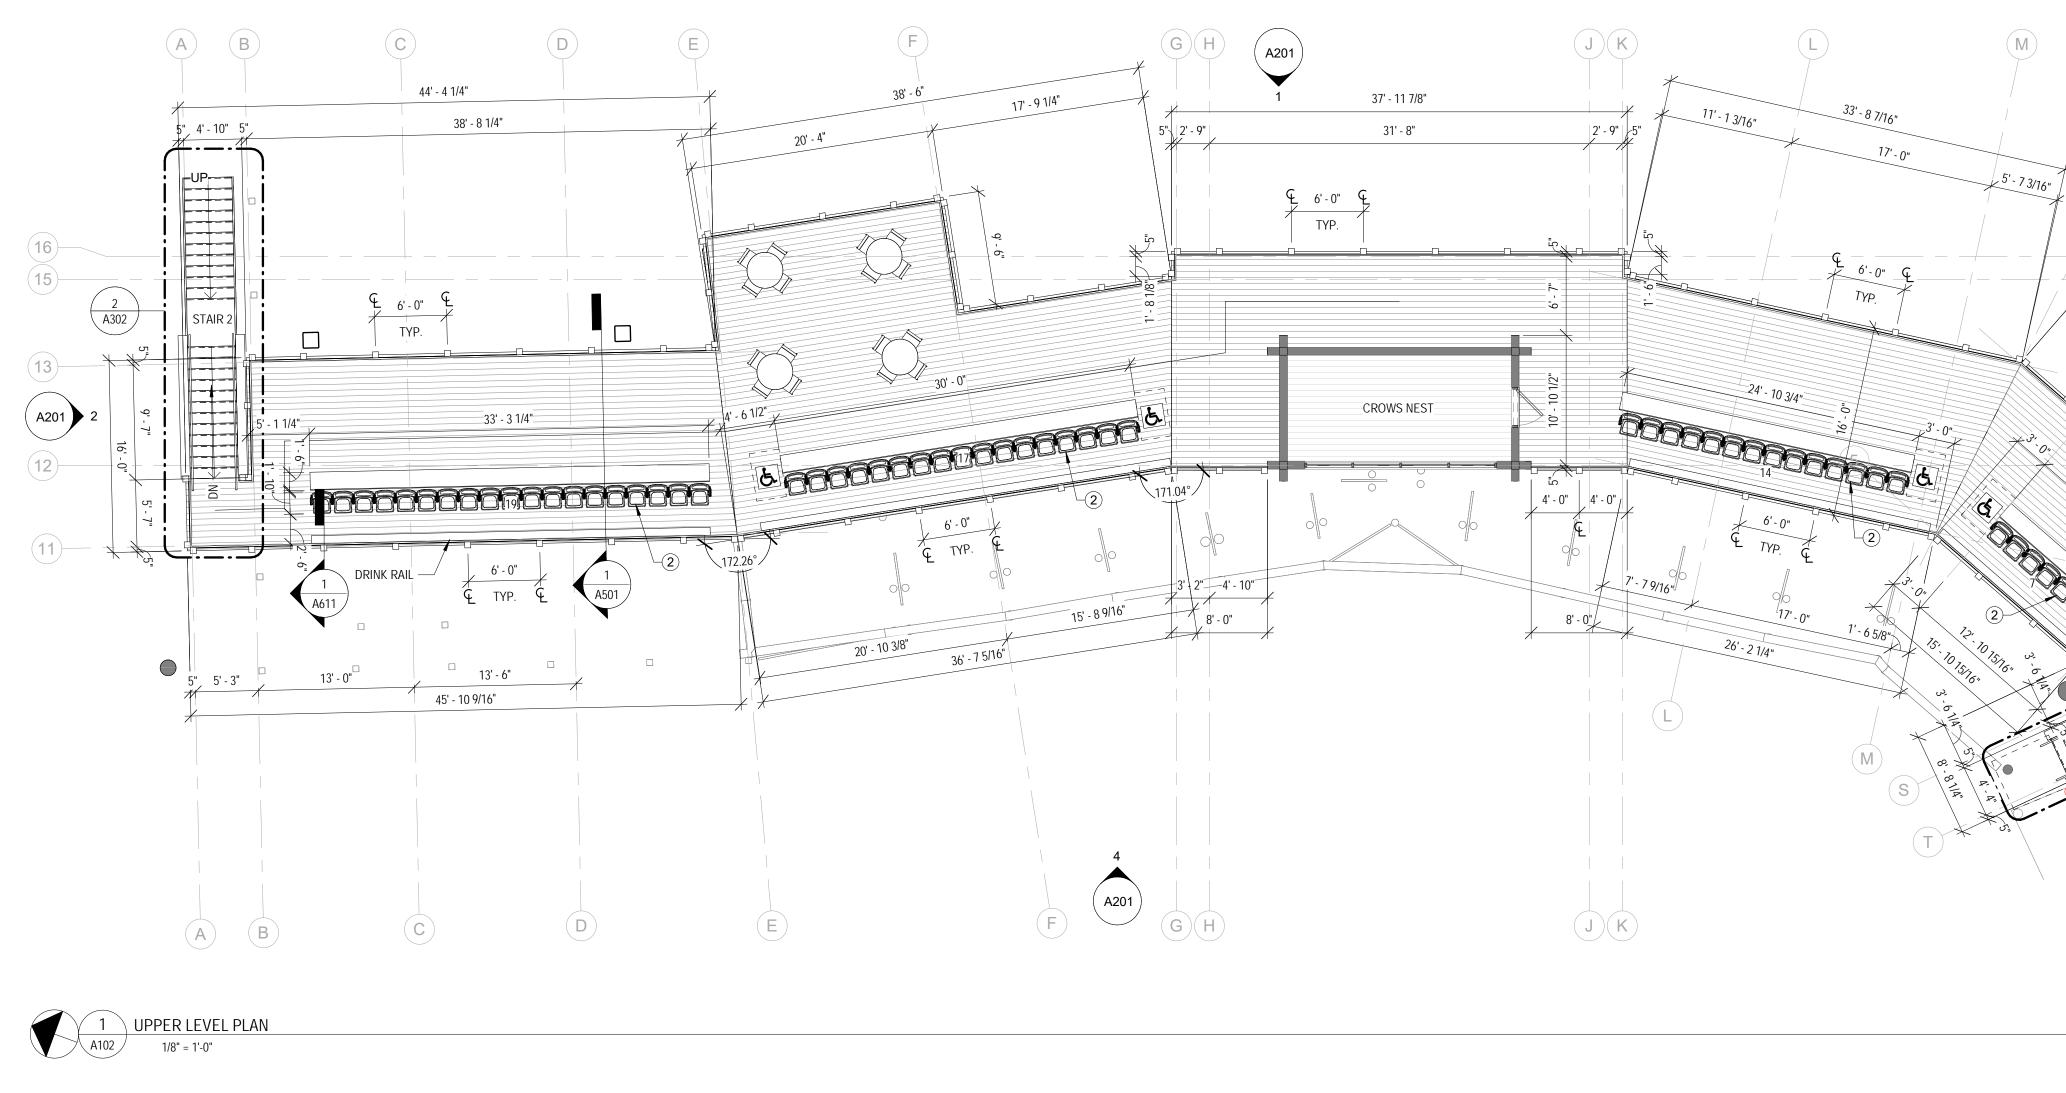


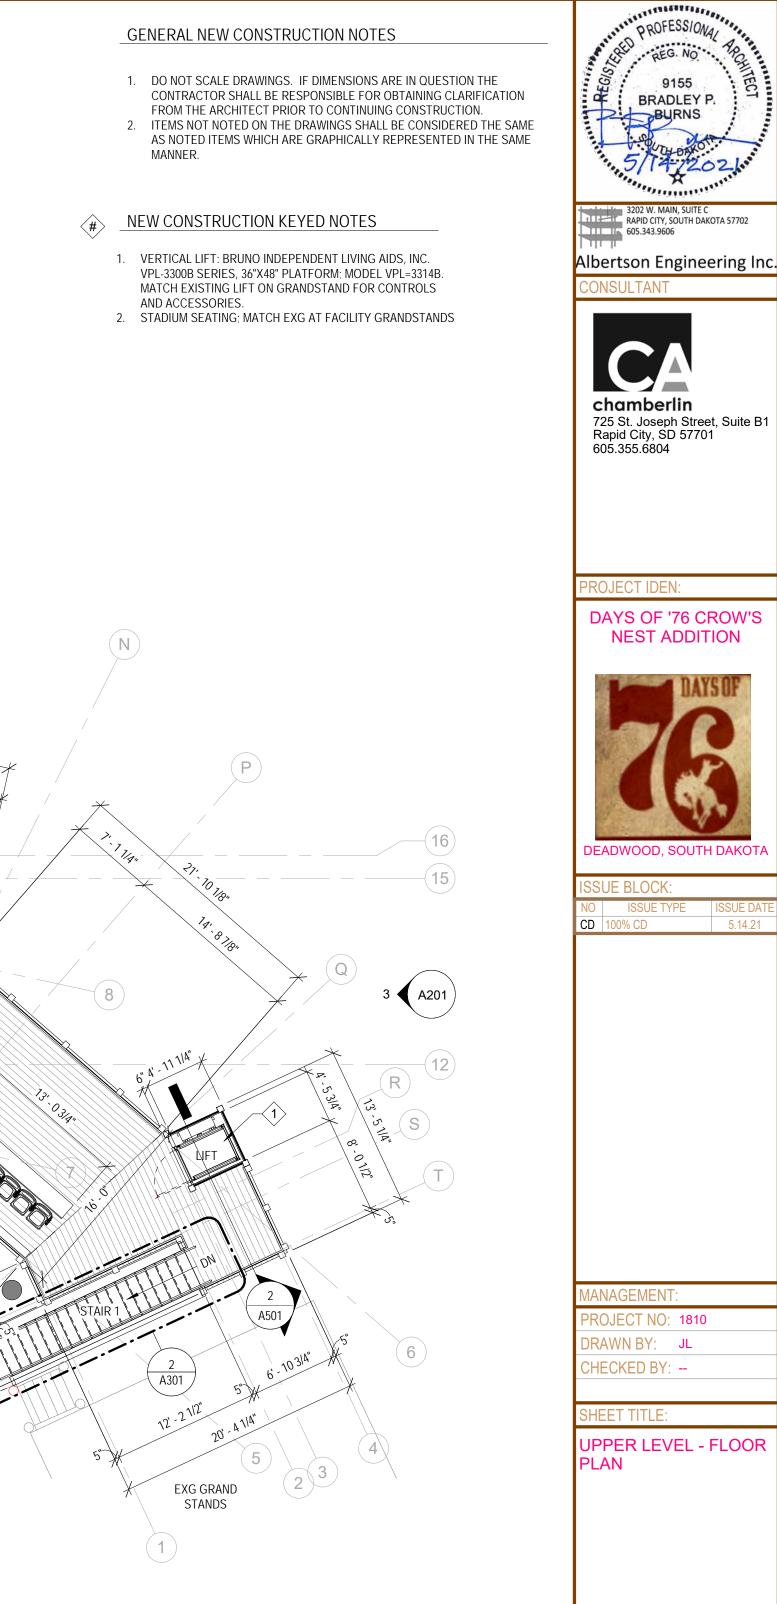EXISTING WALL TO REMAIN EXISTING ITEM TO REMAIN NEW WALL


chamberlin 725 St. Joseph Street, Suite B1 Rapid City, SD 57701 605.355.6804 **ROJECT IDEN:** DAYS OF '76 CROW'S NEST ADDITION DEADWOOD, SOUTH DAKOTA SUE BLOCK:
 NO
 ISSUE TYPE
 ISSUE DATE

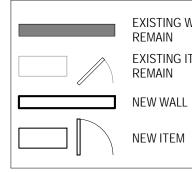
 CD
 100% CD
 5.14.21
 MANAGEMENT: PROJECT NO: 1810 DRAWN BY: JL CHECKED BY: --SHEET TITLE: UPPER LEVEL - FLOOR PLAN HEET IDENTIFICATION: A102

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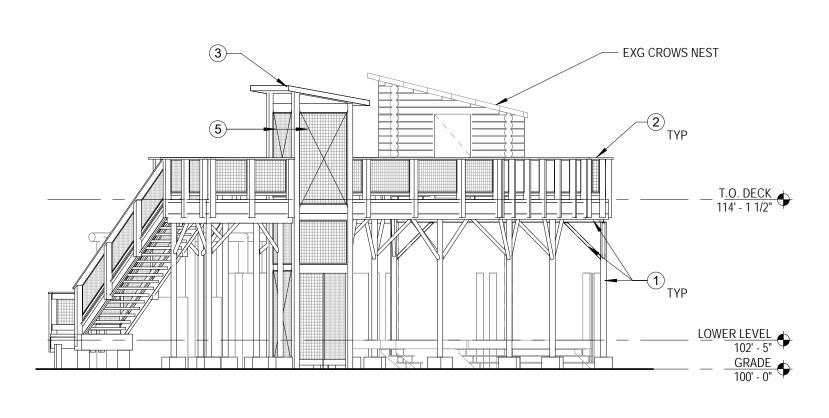


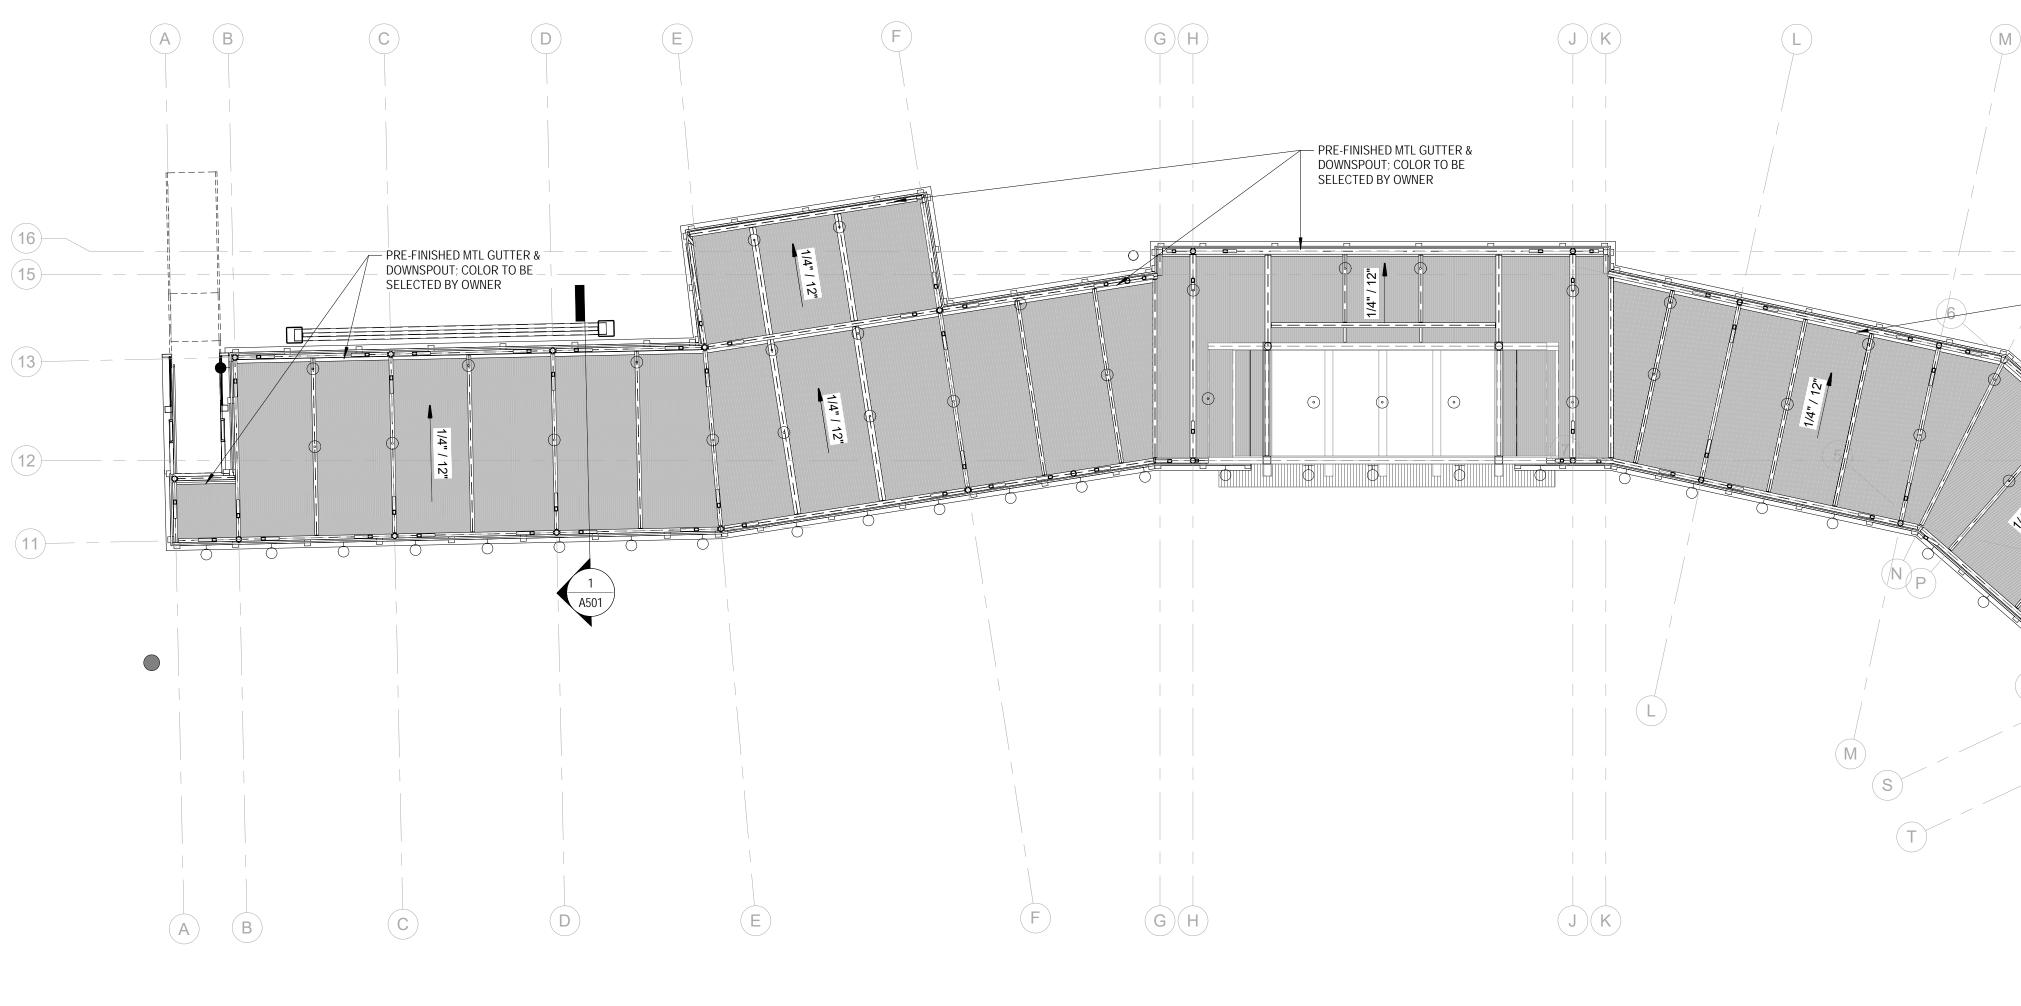

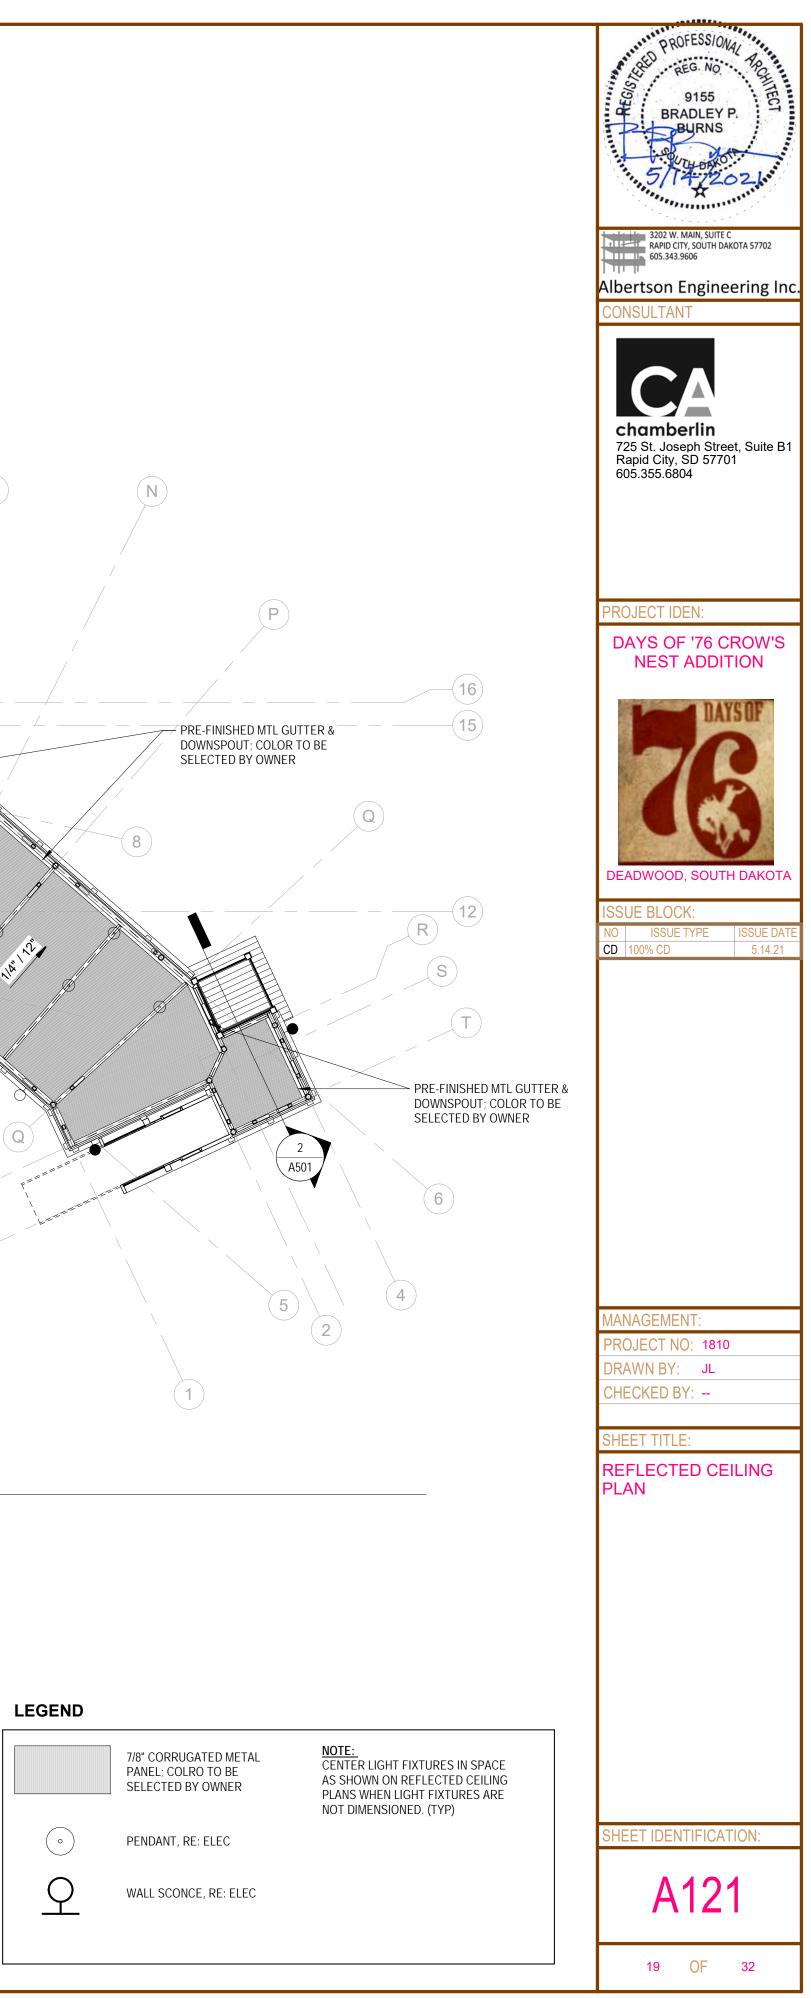


(#) <u>EXTERIOR ELEVATION KEYED NOTES</u>

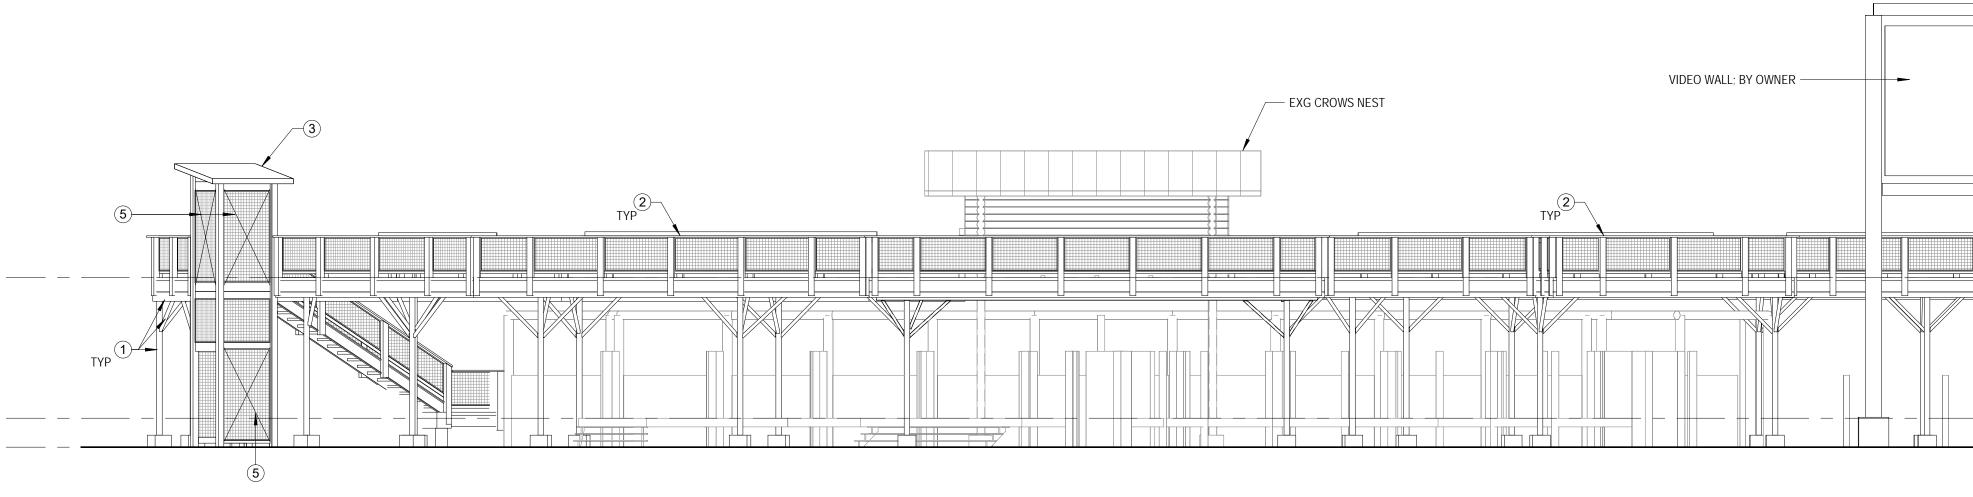
- 1. STL COLUMN; RE: STR; PNT (MATCH EXG STL AT CROWS
- NEST).
- GUARDRAIL; RE: DETAIL 2/A611
 STANDING SEAM MTL ROOF; MATCH CROWS NEST FOR COLOR & PROFILE.
 VIDEO WALL STRUCTURE; RE: STR; PNT(MATCH EXG STL AT ODOM(C NEST)
- CROWS NEST).
 5. CORTEN STL CROSS BRACING; RE: STR; WEATHERED FINIISH.





3 SOUTH EXTERIOR ELEVATION A201 1/8" = 1'-0"

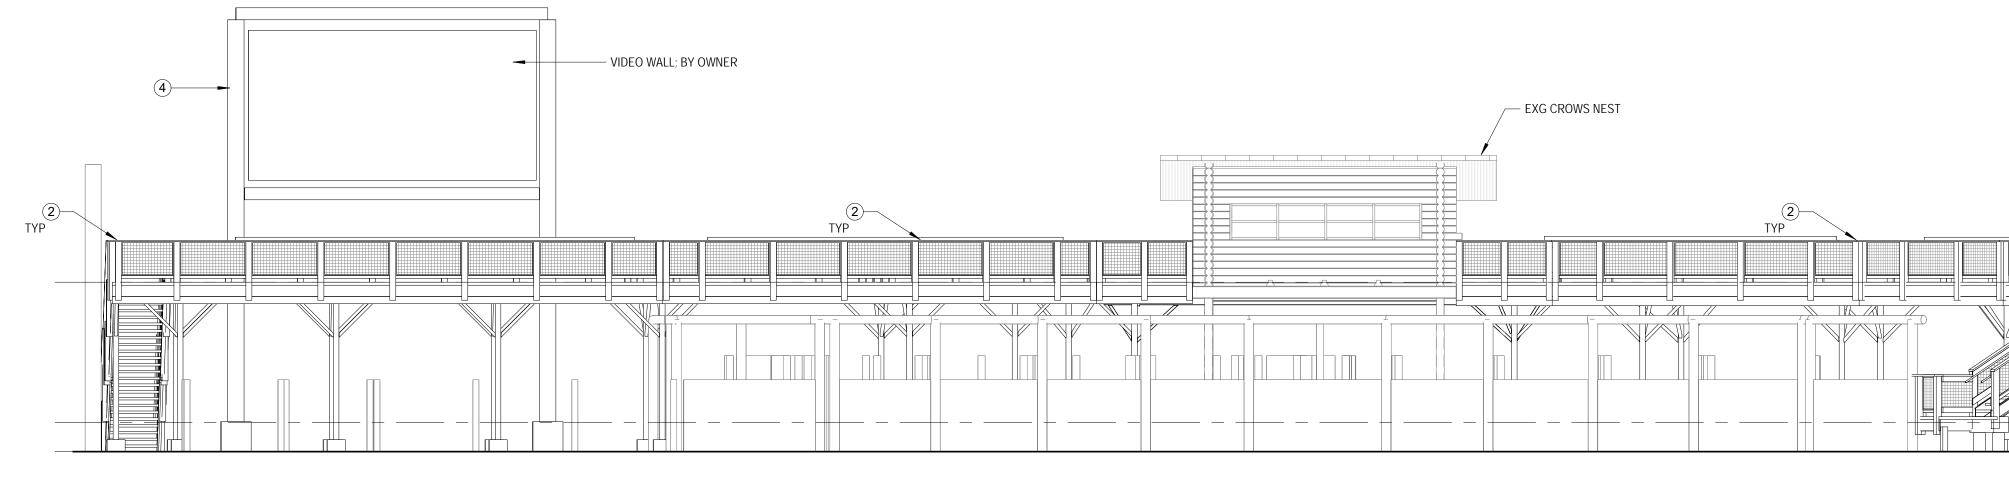



4 WEST EXTERIOR ELEVATION A201 1/8" = 1'-0"

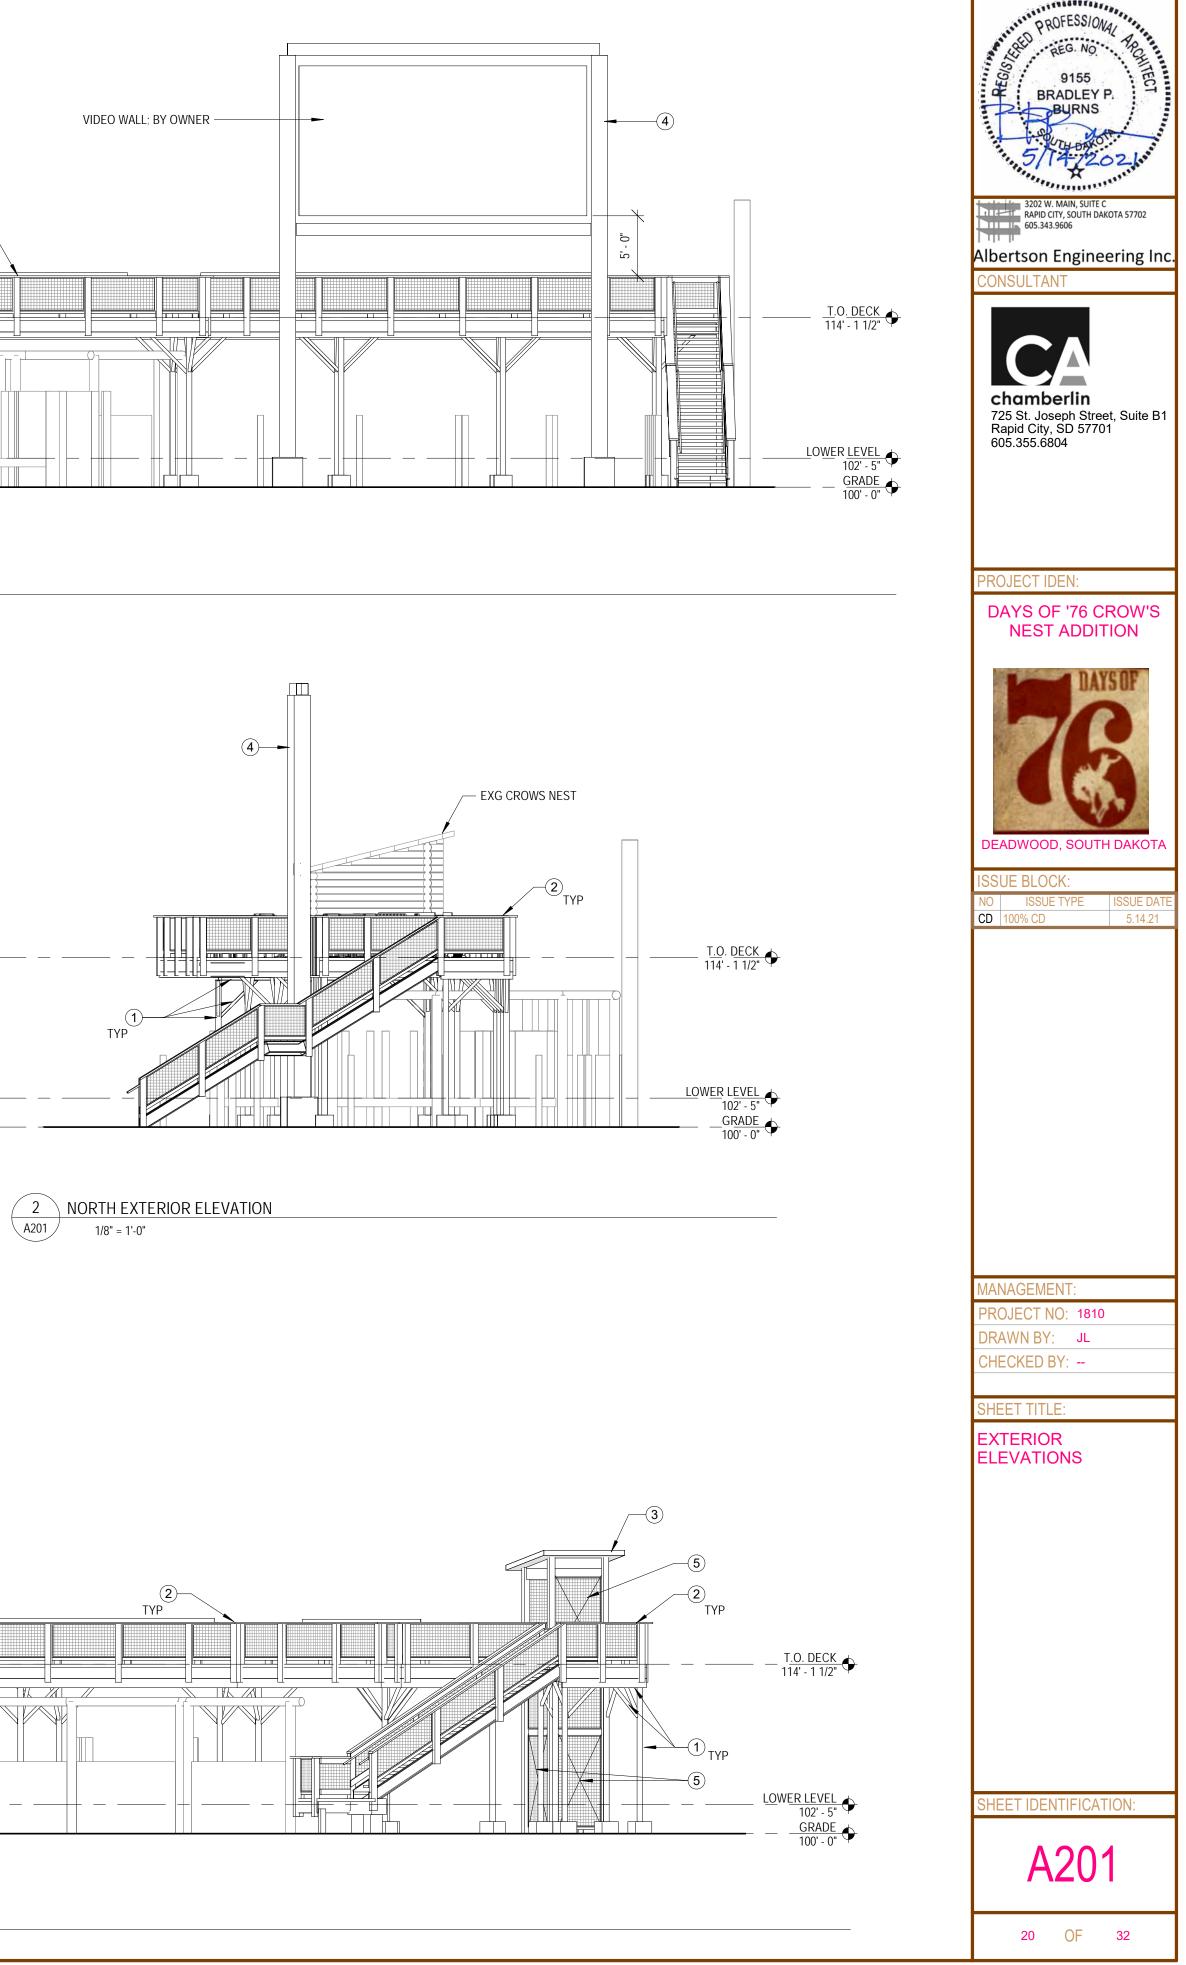

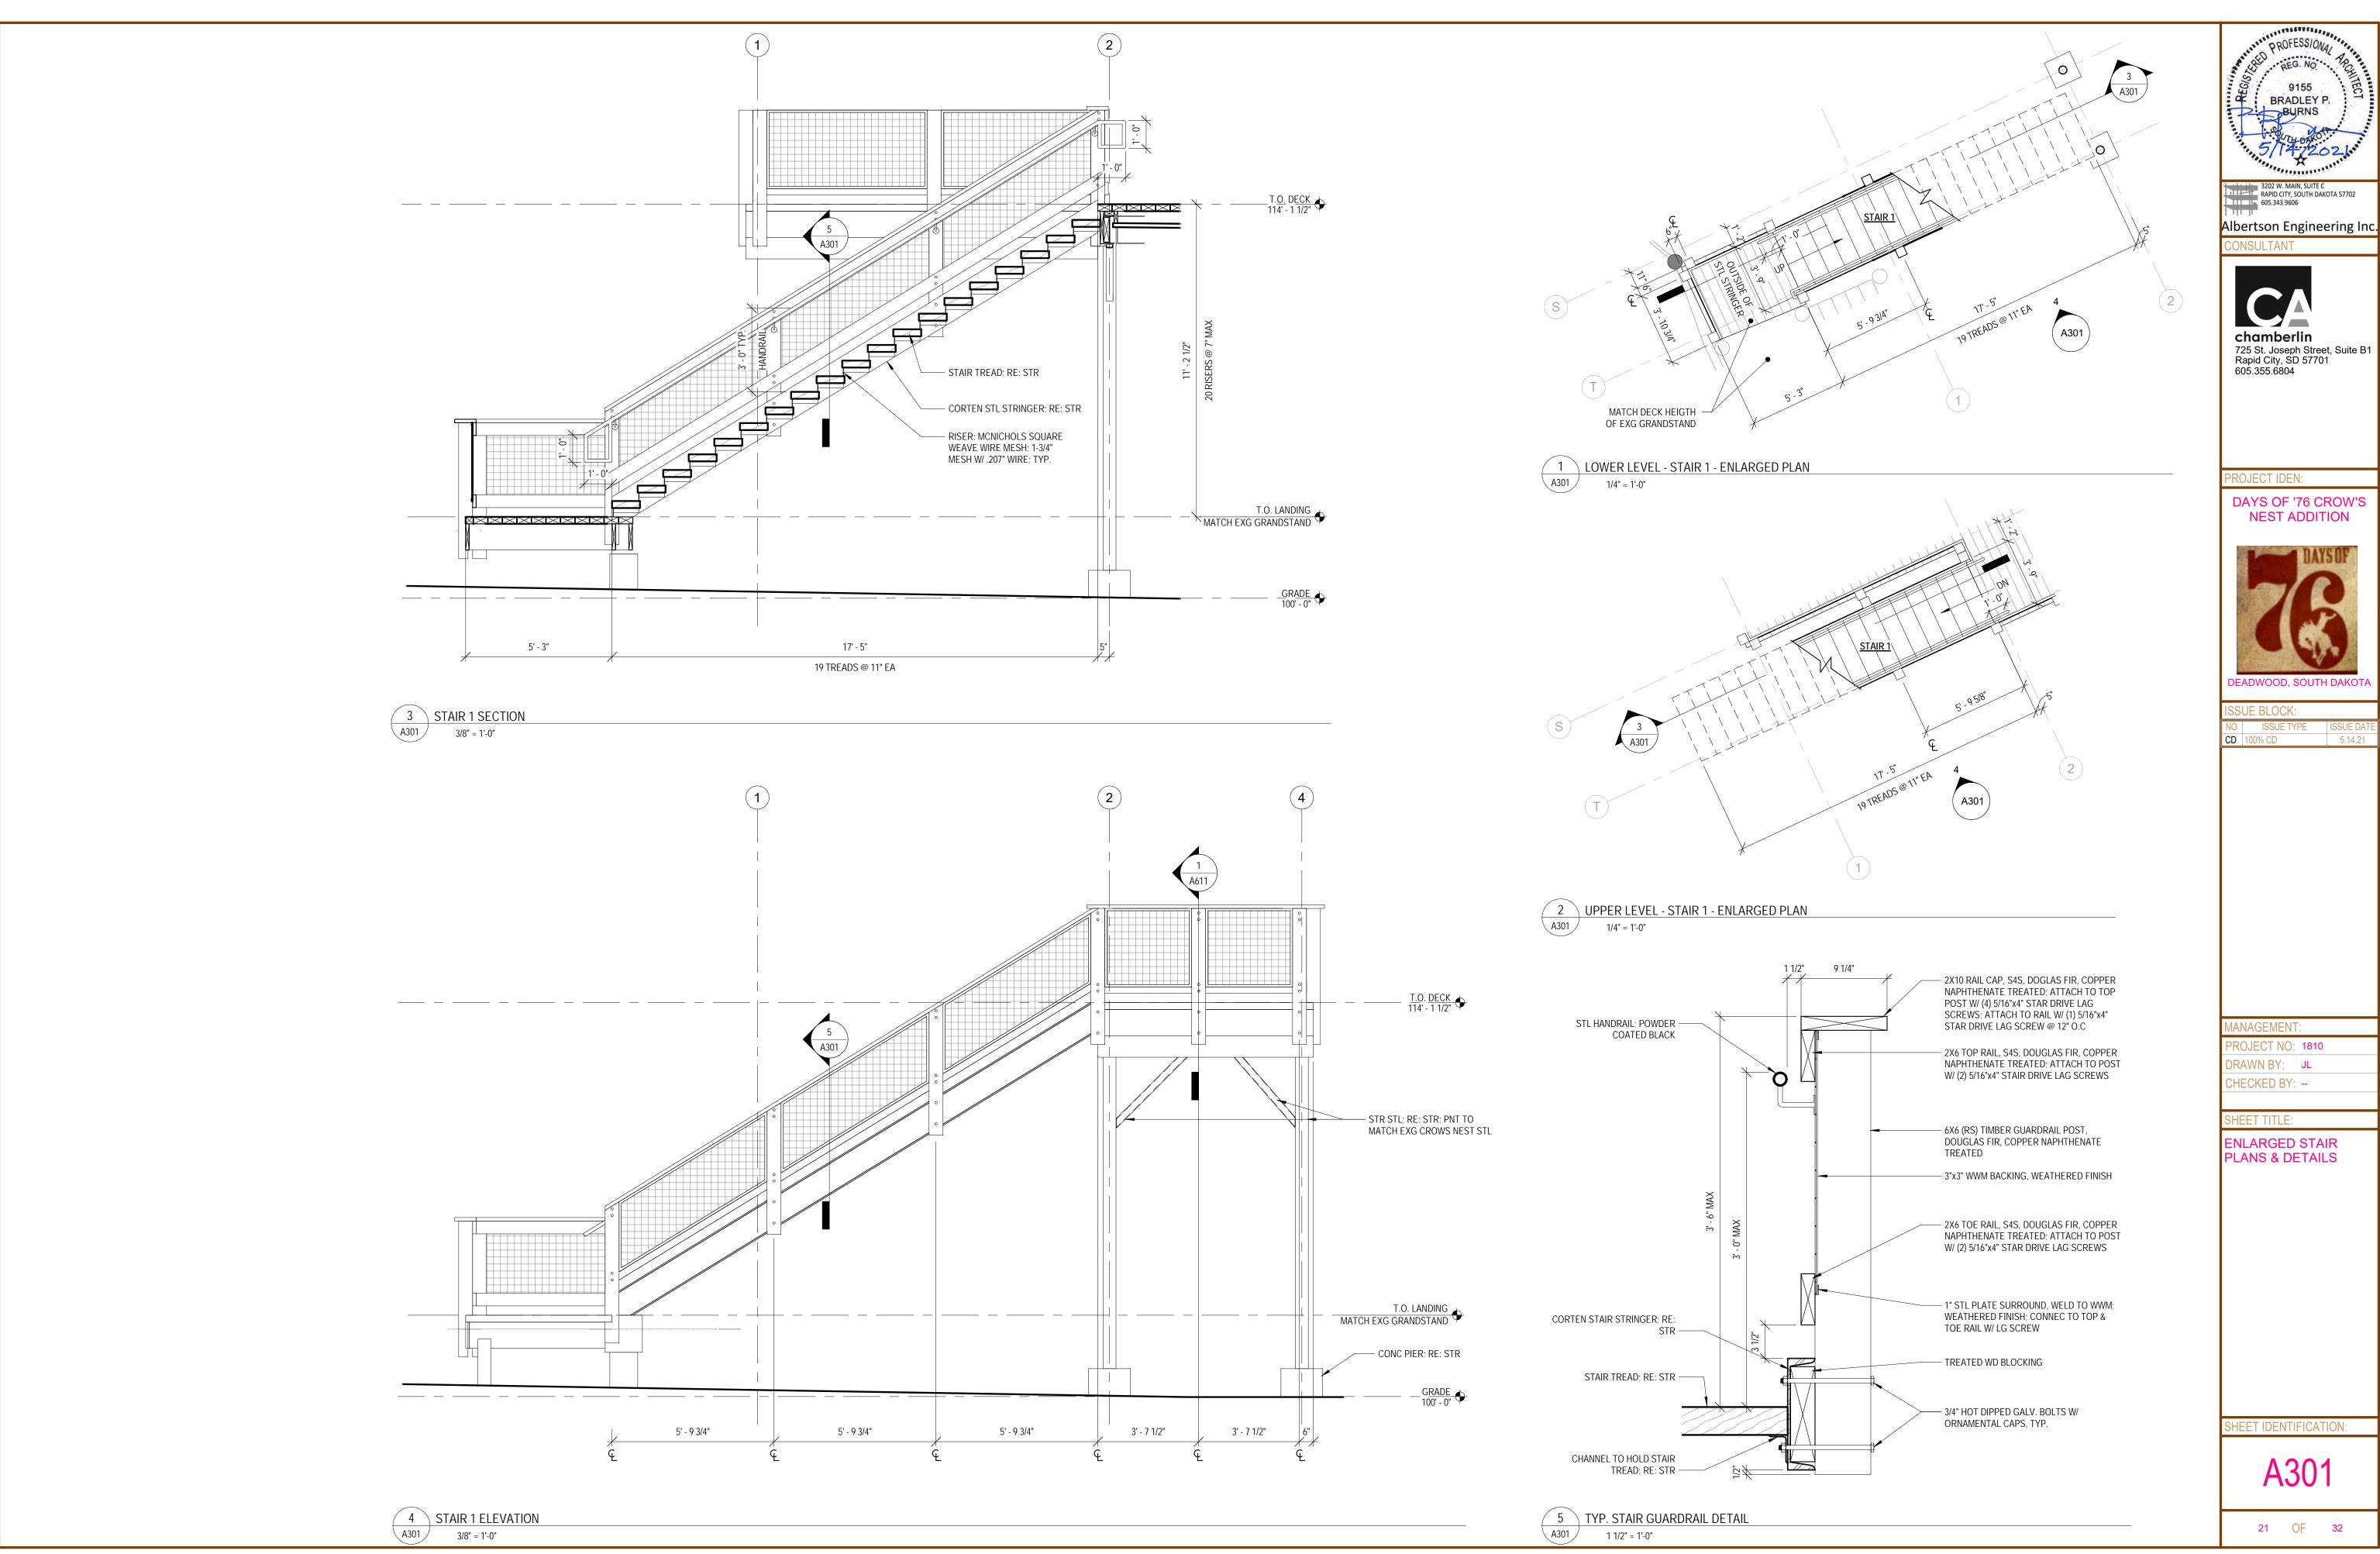


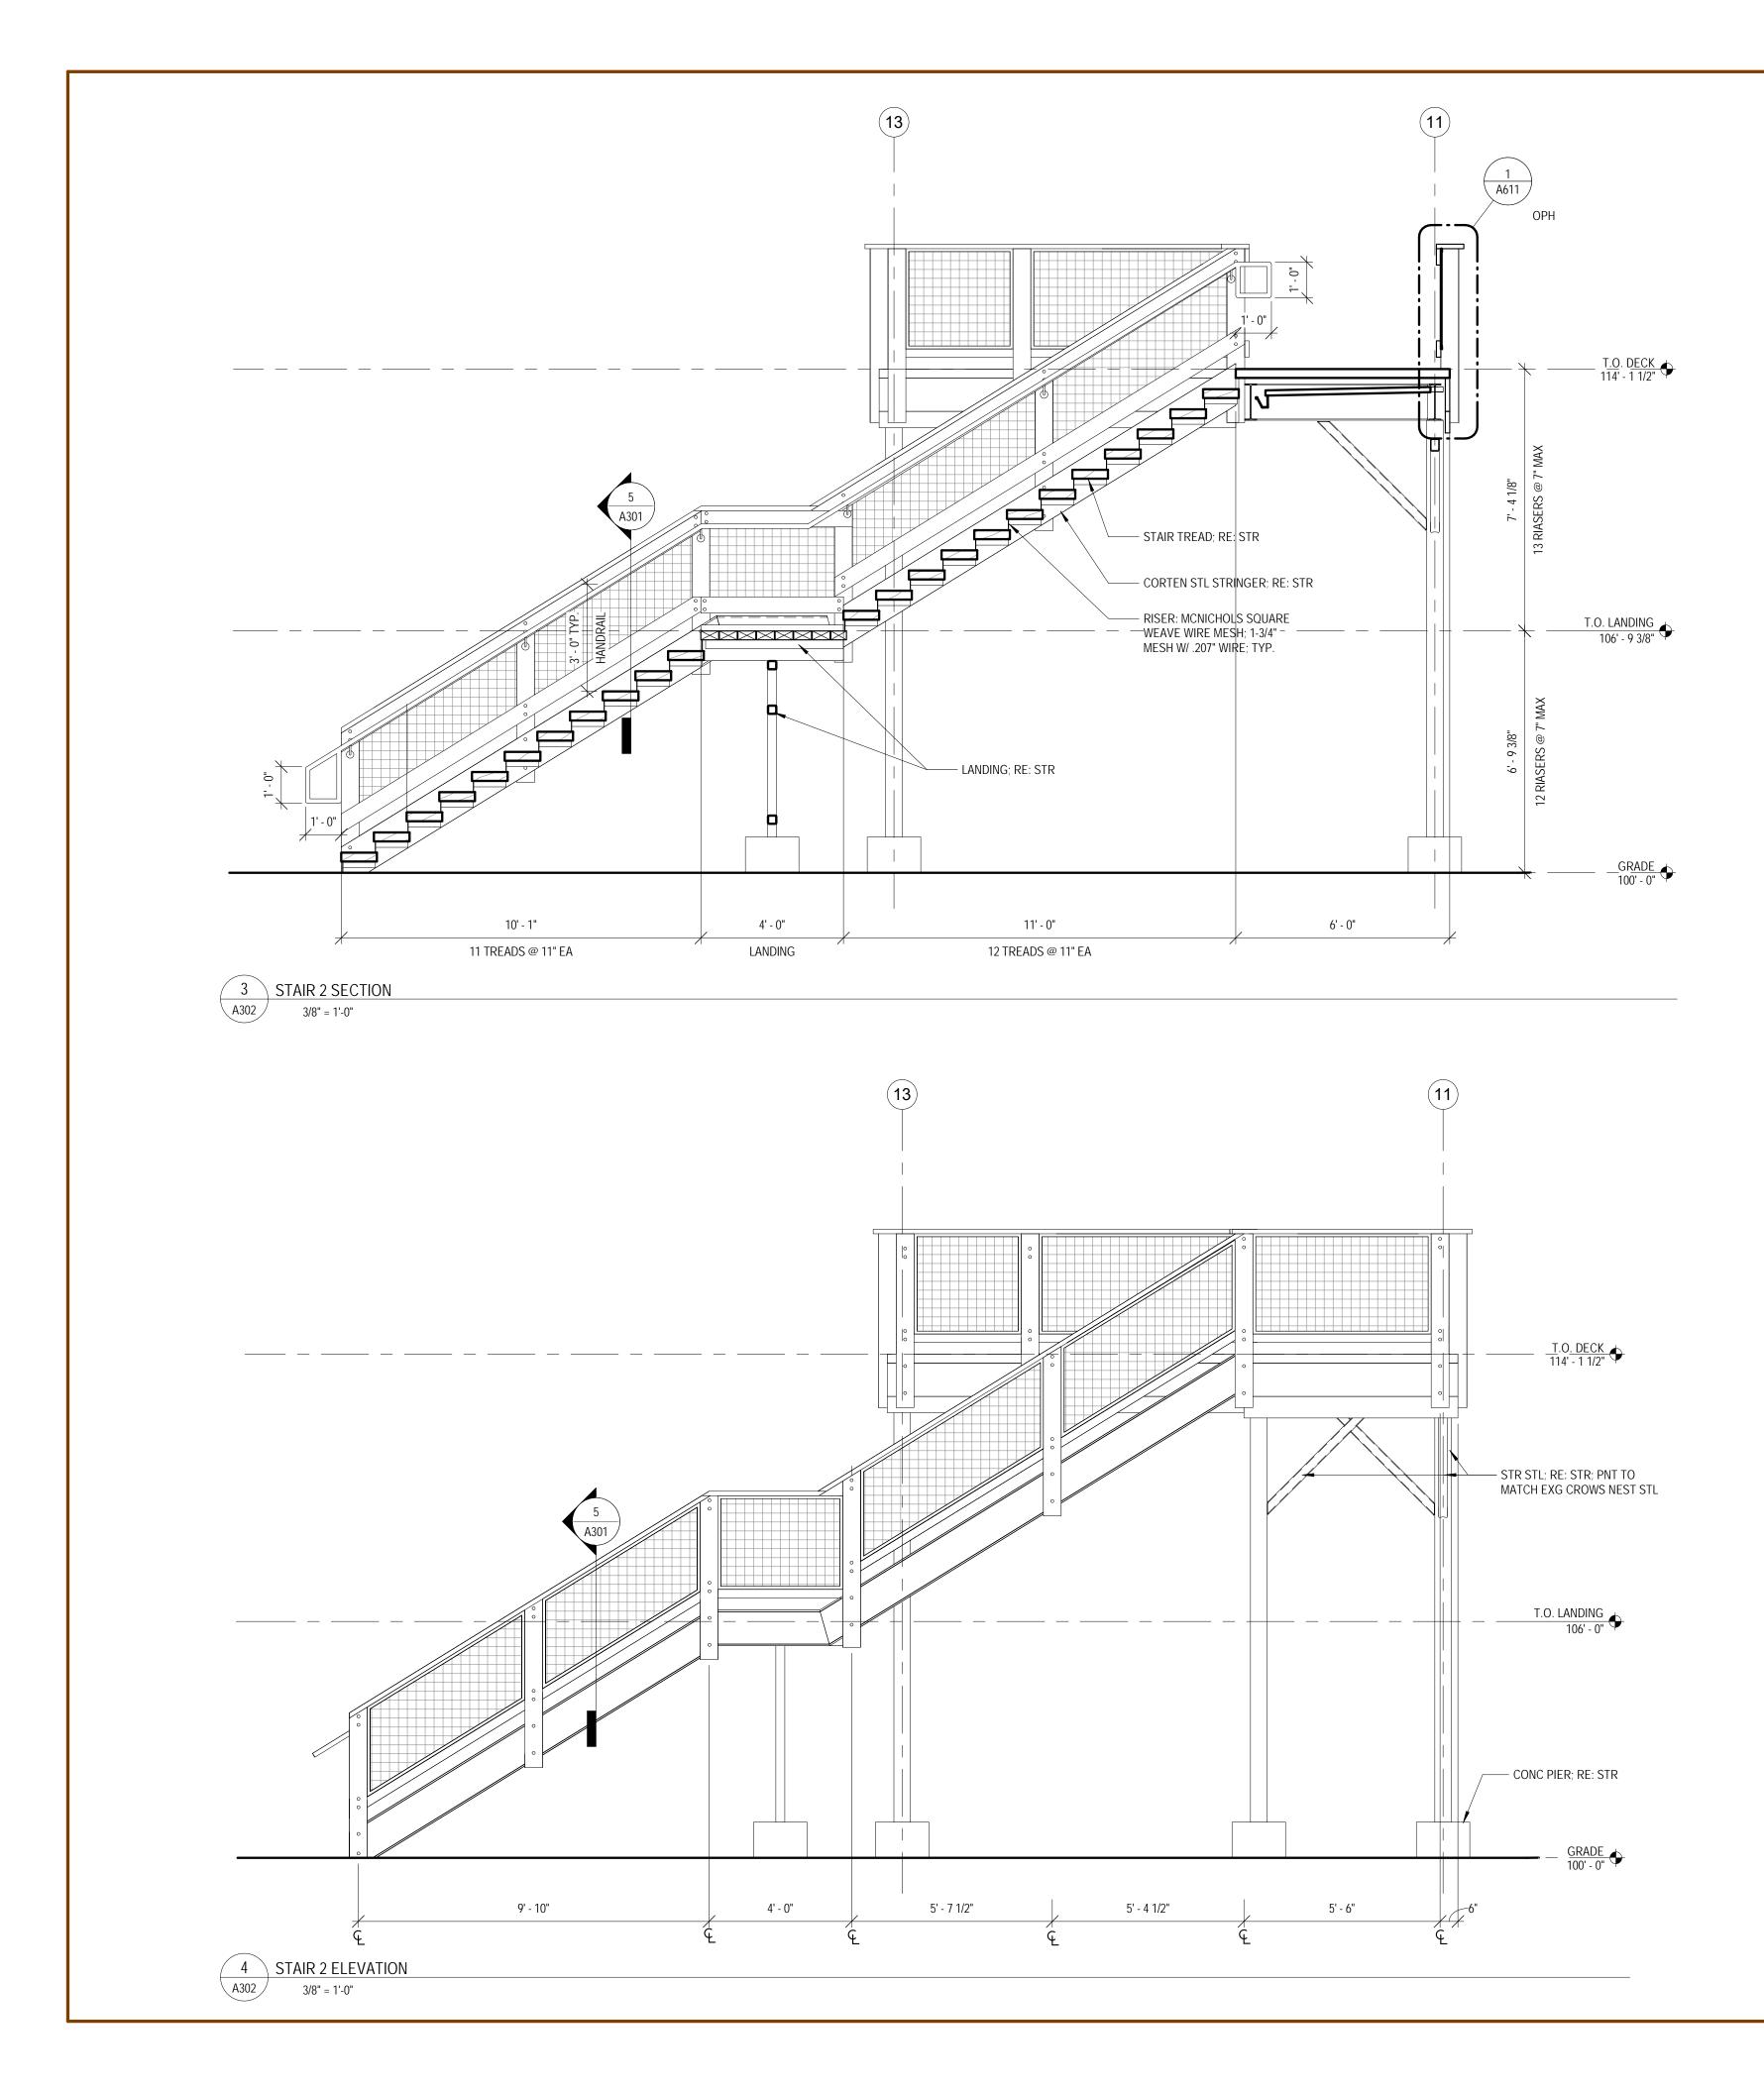


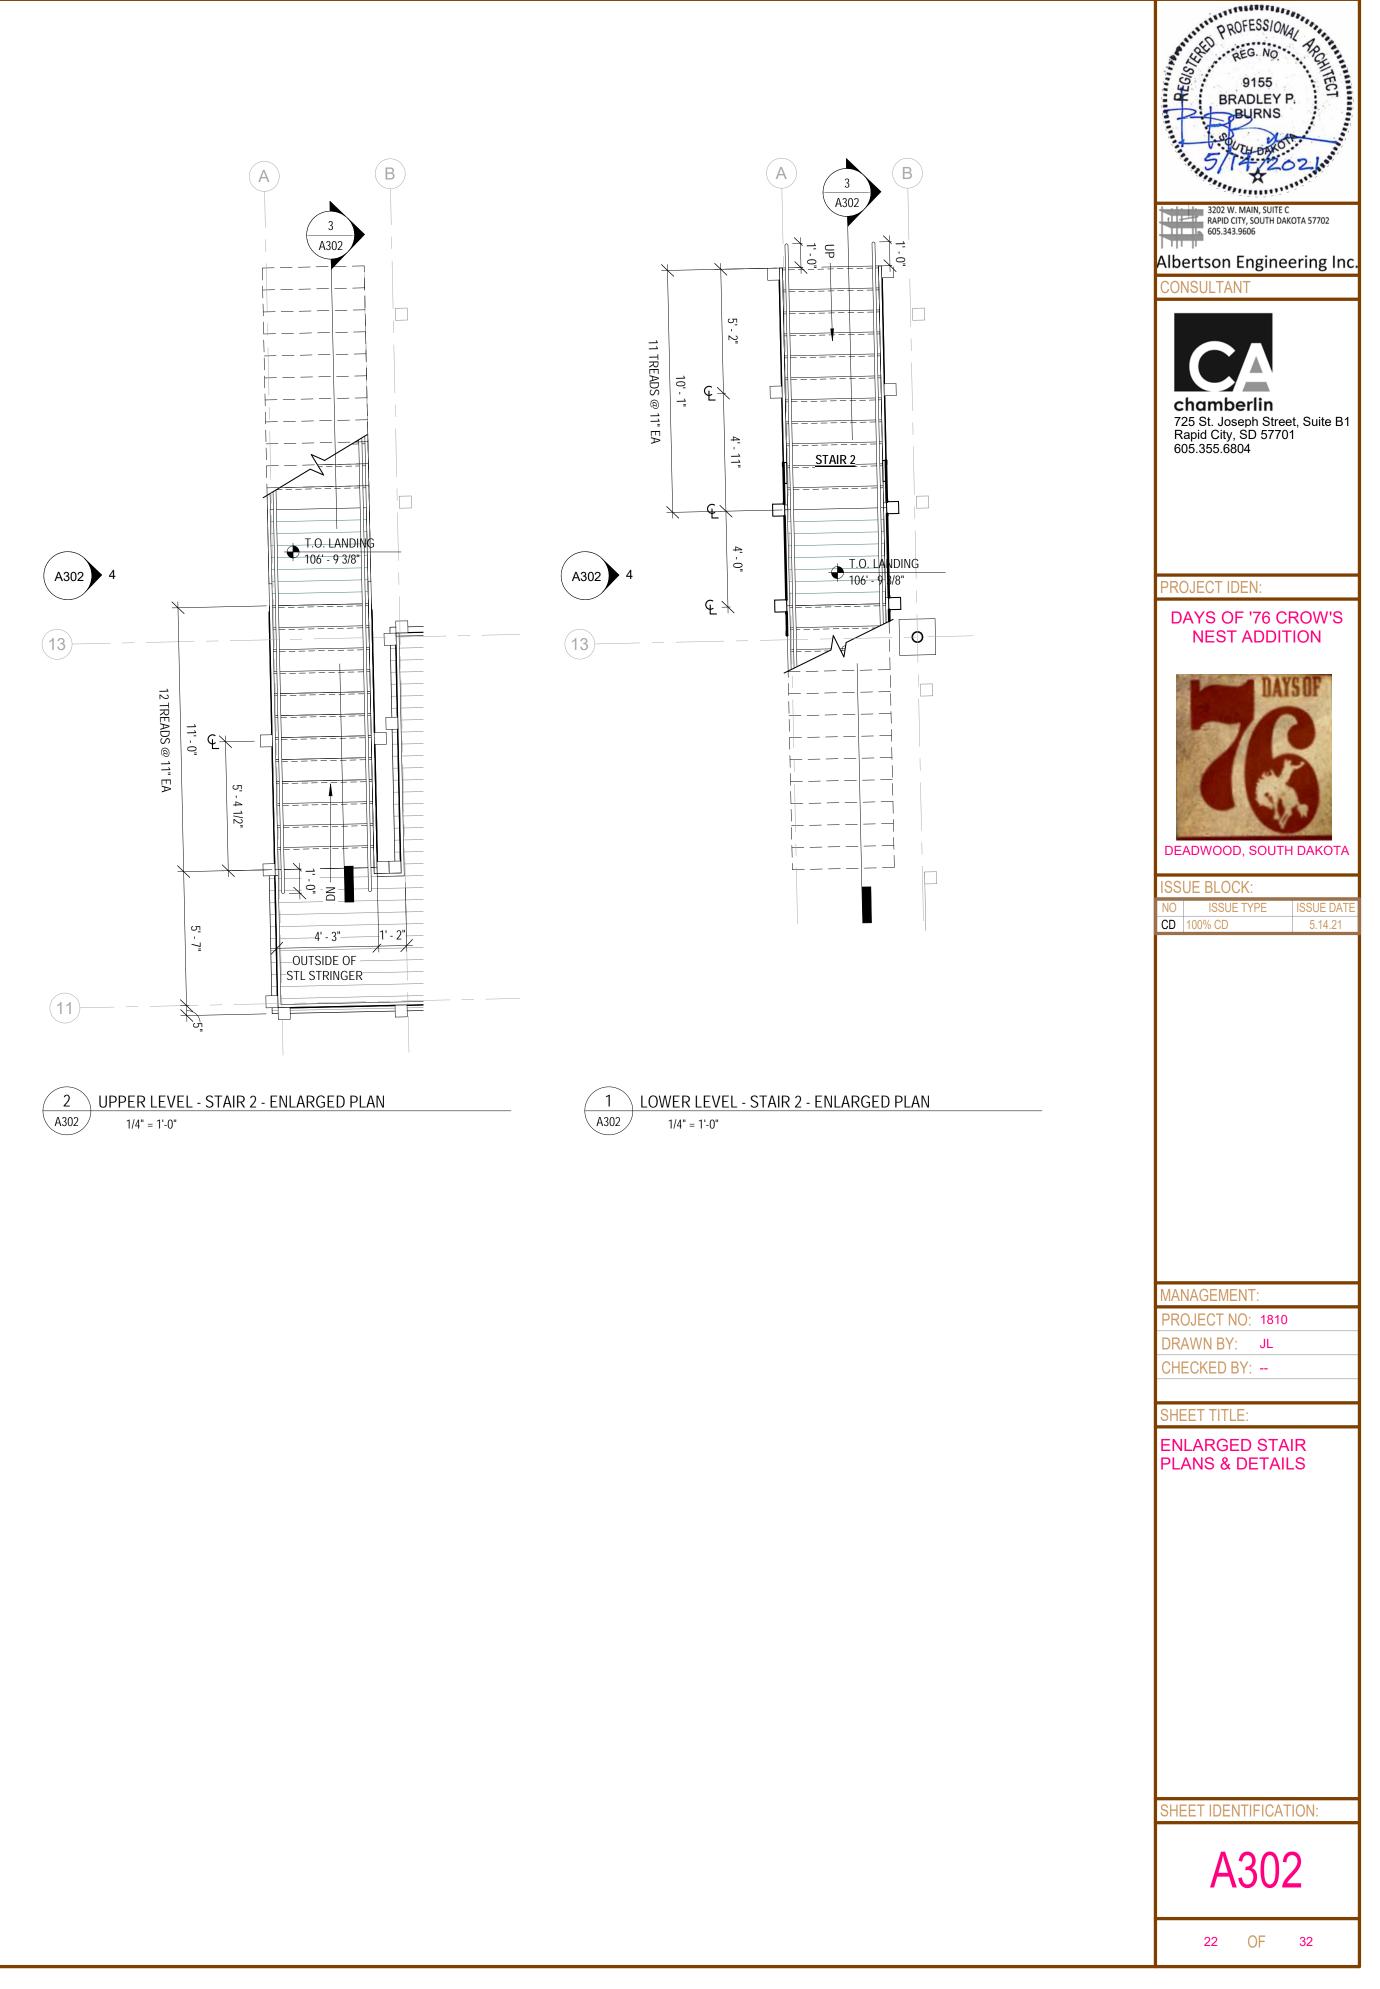

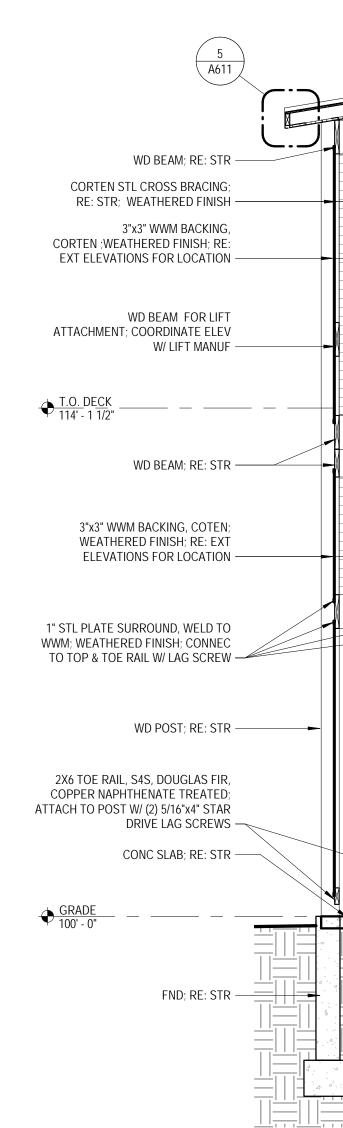

2 DECK SECTION 2 A501 3/8" = 1'-0"

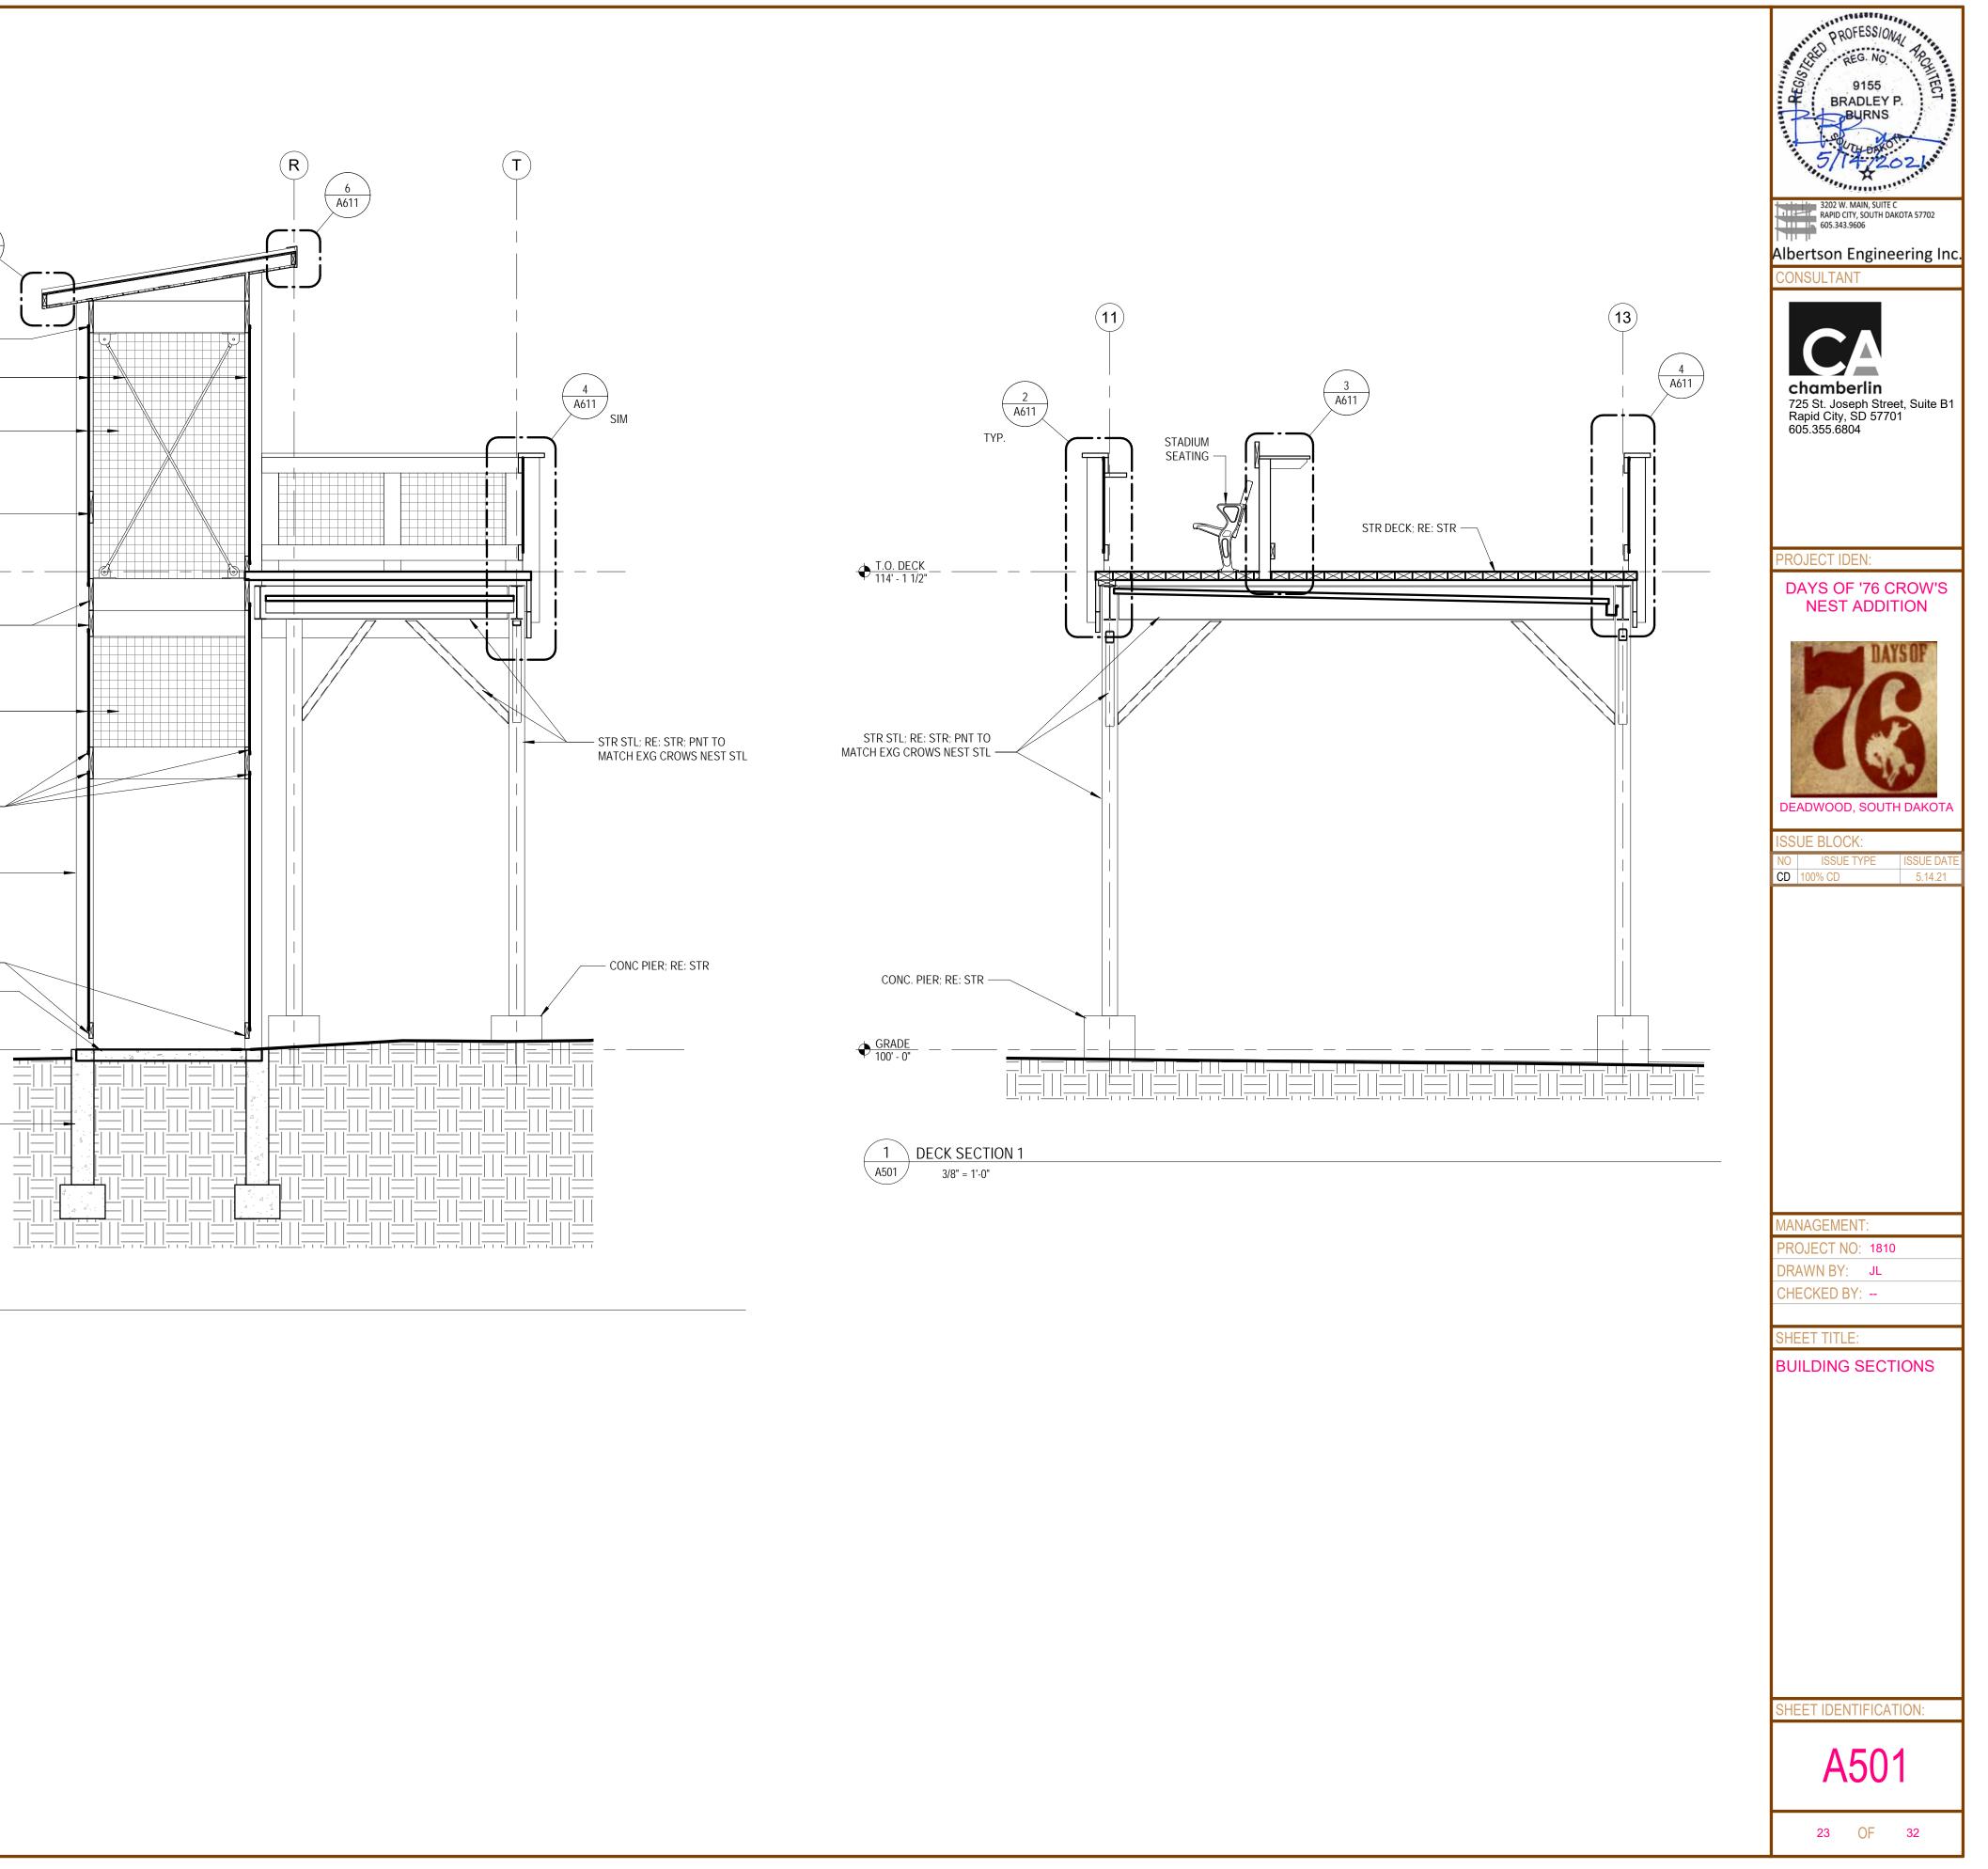

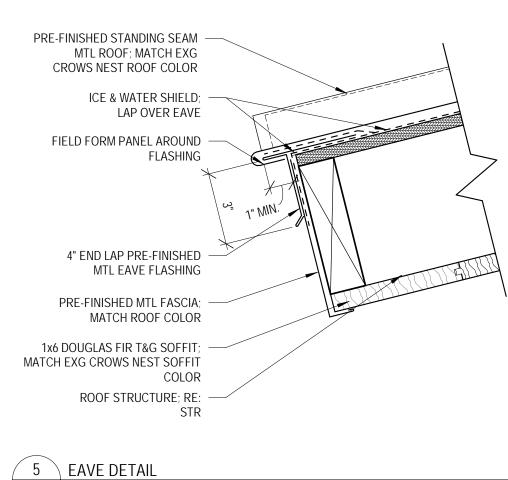

A611 3" = 1'-0"

MTL EAVE FLASHING COLOR STR

6 EAVE DETAIL 2 A611 3" = 1'-0"

PRE-FINISHED STANDING SEAM MTL ROOF; MATCH EXG CROWS NEST ROOF COLOR

- ICE & WATER SHIELD; LAP OVER EAVE


FIELD FORM PANEL AROUND FLASHING

4" END LAP PRE-FINISHED

PRE-FINISHED MTL FASCIA: STOP AT ROOF RAFTERS; MATCH CROWS NEST ROOF

1x6 DOUGLAS FUR T&G SOFFIT; MATCH EXG CROWS NEST SOFFIT COLOR

ROOF STRUCTURE; RE:

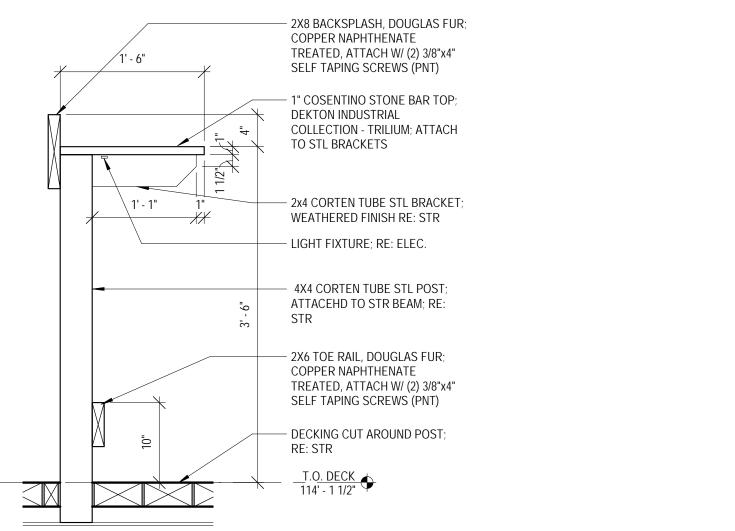



GRI⊅

2X10 RAIL CAP, S4S, DOGLAS FIR, COPPER NAPHTHENATE TREATED; ATTACH TO TOP POST W/ (4) 5/16"x5" STAR DRIVE LAG SCREWS; ATTACH TO RAIL W/ (1) 5/16"x4" STAR DRIVE LAG SCREW @ 12" O.C

2X6 TOP RAIL, S4S, DOUGLAS FIR, COPPER NAPHTHENATE TREATED; ATTACH TO POST W/ (2) 5/16"x5" STAIR DRIVE LAG SCREWS

- 3"x3" WWM BACKING, CORTEN; WEATHERED FINISH

- 2X6 TOE RAIL, S4S, DOUGLAS FIR, COPPER NAPHTHENATE TREATED; ATTACH TO POST W/ (2) 5/16"x4" STAR DRIVE LAG SCREWS

 – 1" STL PLATE SURROUND, WELD TO WWM; CORTEN; WEATHERED FINISH; CONNECT TO TOP & TOE RAIL W/ LAG SCREW

— 3X6 (RS) DECKING; RE: STR

<u>T.O. DECK</u> 114' - 1 1/2" – 2X12 RIM BOARD, S4S, DOUGLAS FIR, COPPER NAPHTHENATE TREATED; BWT POST; ATTACH TO BLOCKING W/ (4) 5/16"x4" STAR DRIVE LAG SCREWS

- TREATED WD BLOCKING

- 3/4" HOT DIPPED GALV. BOLTS COUNTER SUNK

2X8 RIM BOARD, S4S, DOUGLAS FIR, COPPER NAPHTHENATE TREATED; NOTCH FOR POST; ATTACH TO BLOCKING W/ (2) 5/16"x4" STAR DRIVE LAG SCREWS



MTL STD W/ TREATED FURRING @ 4'-0" O.C.

 \succ

7/8" CORRIGATED MTL PANEL

FURRING; RE: RCP; COLOR TO

PRE-FINISHED MTL GUTTER &

DOWNSPOUT; COLOR TO BE

ATTACEHD TO MTL STD

BE SELECTED BY OWNER -

SELECTED BY OWNER -

POST W/ (4) 5/16"x5" STAR DRIVE LAG SCREWS; ATTACH TO RAIL W/ (1) 5/16"x4" STAR DRIVE LAG SCREW @ 12" O.C

NAPHTHENATE TREATED; ATTACH TO POST W/ (2) 5/16"x5" STAIR DRIVE LAG SCREWS -

2X6 TOE RAIL, S4S, DOUGLAS FIR, COPPER NAPHTHENATE TREATED; ATTACH TO POST W/ (2) 5/16"x4" STAR DRIVE LAG SCREWS -

2X RIM BOARD, S4S, DOUGLAS FIR, COPPER 1

1" = 1'-0"

A611


NAPHTHENATE TREATED; ATTACH TO POST


CORTEN; WEATHERED FINISH; CONNECT TO

3/4" HOT DIPPED GALV. BOLTS COUNTER

2X8 RIM BOARD, S4S, DOUGLAS FIR, COPPER NAPHTHENATE TREATED; NOTCH FOR POST; ATTACH TO BLOCKING W/ (2) 5/16"x4" STAR DRIVE LAG SCREWS -



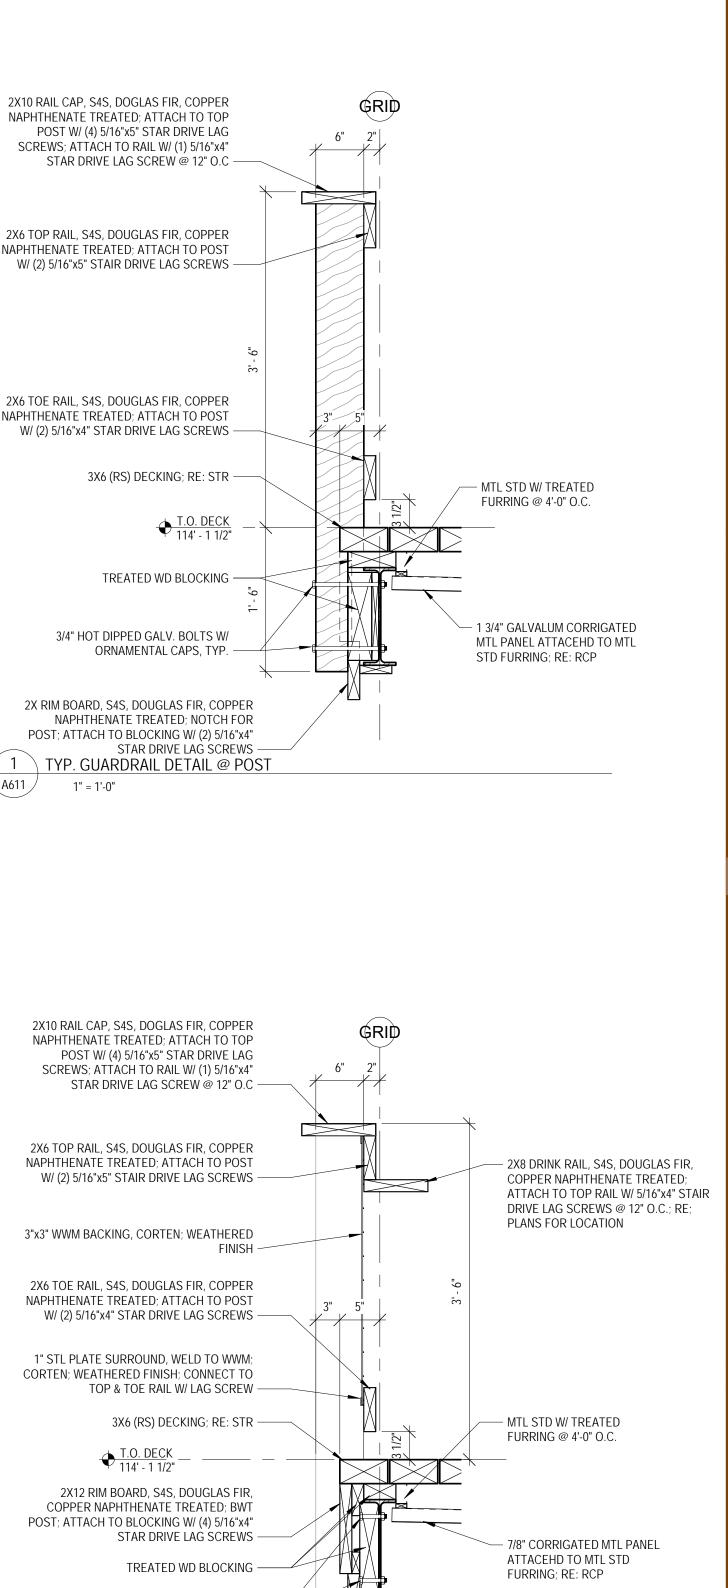

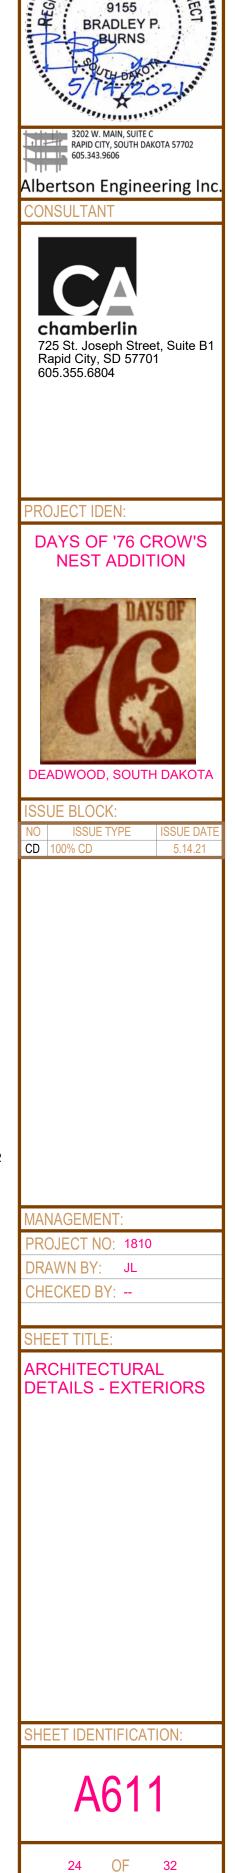

PROFESSIONA REG. NO

SUNK -

	ELECTRICAL A	BBREVIATIO	NS				EL	ECTRICAL SYMBOLS LEGEND				
A OR AMP AC	ALTERNATING CURRENT	MAX MBJ	MAXIMUM MAIN BONDING JUMPER		NOTES			POWER SYSTEMS	NTC		FIRE ALARM SYSTEM	MTC
AC ADD	6" ABOVE COUNTER HEIGHT or 4" ABOVE BACKSPLASH, WHICHEVER IS GREATER ADDENDUM	MC MCA	MECHANICAL CONTRACTOR DIV. 23 MINIMUM CIRCUIT AMPACITY	APPEAR	YMBOLS COMPRISE A STANDARD LIST, NOT ALL SYMBOLS MAY ON THESE DRAWINGS.			BRANCH CIRCUIT PANEL	HT TOP AT 72"	Ē	MANUAL STATION	46"
ADJS AFC	ADJUSTABLE AVAILABLE FAULT CURRENT	MCB MCC	MAIN CIRCUIT BREAKER MOTOR CONTROL CENTER	IS SHOW HEIGHTS	G HEIGHTS GIVEN ARE STANDARD. WHERE DIMENSIONAL NUMBER N AT DEVICE, THIS SHALL BE THE MOUNTING HEIGHT. MOUNTING ARE TO CENTER OF OUTLET UNLESS NOTED OTHERWISE.	G 🛛 🗖 🚟		POWER DISTRIBUTION PANEL OR SWITCHBOARD	SPEC SPEC	F ^H F ^{RR}	HEAT DETECTOR - FIXED TEMPERATURE HEAT DETECTOR - RATE OF RISE	VERIFY
AFF AFG	ABOVE FINISHED FLOOR ABOVE FINISHED GRADE	MDP MFR	MAIN DISTRIBUTION PANEL MANUFACTURER	** ***	DISTANCE ABOVE TOP OF DOOR FRAME DISTANCE TO TOP OF EQUIPMENT OR DEVICE DISTANCE TO HIGHEST OPERABLE PART OF EQUIPMENT		교 c/T]	METER C/T CABINET – 36"Wx12"Dx28"H	60"** 60"**	F R	RELAY HEAT DETECTOR - 135' INDICATES TEMP RATING	VERIFY
AFI	ARC FAULT INTERRUPTER AIR HANDLING UNIT	MH	METAL HALIDE MICROPHONE		DISTANCE BELOW CEILING DISTANCE TO BOTTOM OF DEVICE		G ^{ANN}	,	SPEC		SMOKE DETECTOR - IONIZATION	VERIFY
AL ALT	ALUMINUM	MIN MISC	MINIMUM MISCELLANEOUS	WHEN B	G HEIGHTS INDICATED ARE FOR STUD WALL CONSTRUCTION, LOCK OR BRICK CONSTRUCTION IS USED, ADJUST MOUNTING TO ALIGN DEVICES OR DEVICE PLATES WITH RUNNING JOINT.		<u>т</u> СК	TRANSFORMER AUTOMATIC TRANSFER SWITCH	TOP AT 72"	F F ^{P-SB}	SMOKE DETECTOR - PHOTOELECTRIC SMOKE DETECTOR WITH SOUNDER BASE	VERIFY VERIFY
	ANNUNCIATOR	MLO	MISCELLAREOUS MAIN LUGS ONLY MANUAL MOTOR STARTER WITH				$\overline{\mathbf{O}}$	MOTOR INDICATES EQUIPMENT SCHEDULE IDENTIFICATION NUMBER		F Ms	MULTI-STATION ALARM - PHOTOELECTRIC SINGLE STATION ALARM - PHOTOELECTRIC	
AQUA	APPROXIMATELY AQUASTAT	MMS MOCP	OVERLOAD MAXIMUM OVERCURRENT PROTECTION				×	(SEE EQUIPMENT SCHEDULE)	TOP		DUCT MOUNTED SMOKE DETECTOR STATION - REMOTE RESET/TEST STATION FOR	
AR ARCH	AS REQUIRED ARCHITECT	MON MRT	MONITOR MOTOR RATED TOGGLE SWITCH				VFD X	VARIABLE FREQUENCY DRIVE CONTROLLER OR STARTER	<u>AT 72"</u>	F ^{RS}	DUCT DETECTOR REMOTE INDICATOR LAMP	46" VERIFY
ATS AUC	AUTOMATIC TRANSFER SWITCH AUX CONTACTS	MSBD MSC	MAIN SWITCHBOARD MOTORIZED SPEED CONTROLLER				<u> </u>	COMBINATION STARTER & DISCONNECT DISCONNECT OR SAFETY SWITCH			BEAM DETECTOR TRANSMITTER	
AUTO AUX	AUTOMATIC AUXILIARY	MT(D) MTG	MOUNT(ED) MOUNTING		GENERAL		\$ ^{MRT} \$ ^{MMS}	MOTOR RATED TOGGLE SWITCH	46" 46"	F ^{FS}	BEAM DETECTOR RECEIVER FLOW SWITCH MONITOR MODULE	
AV AWG	AUDIO VISUAL AMERICAN WIRE GAUGE	MTR	MOTOR		MTG HT	; <u>-</u>	-•	MANUAL MOTOR STARTER, WITH OVERLOAD PROTECTION CONTROL STATION/PUSHBUTTON	46 "	F [™]	TAMPER SWITCH MONITOR MODULE MONITOR MODULE	
BFG C	BELOW FINISHED GRADE	N N3R	NORMAL POWER BRANCH NEMA 3R ENCLOSURE		INDICATES EXISTING ITEM TO BE REMOVED INDICATES EXISTING ITEM TO REMAIN		R C	RELAY CONTACTOR	TOP AT 72"	F ^{PIV}	PRESSURE INDICATOR VALVE PRESSURE SWITCH MONITOR MODULE	
CAB CATV	CABINET CABLE TELEVISION	NEC NEMA	NATIONAL ELECTRICAL CODE NATIONAL ELECTRICAL MANUFACTURER'S ASSOCIATION				- D	ADA PUSH PLATE LINE VOLTAGE ELECTRIC THERMOSTAT	42" 46"	E E ^{CM}	CONTROL MODULE	
СВ	CIRCUIT BREAKER	NF NFDS	NOT FUSED SAFETY DISC. SWITCH				Ð	SINGLE RECEPTACLE	18"	F ^{su} F ^{DH}	FIRE/SMOKE DAMPER MAGNETIC DOOR HOLDER	VERIFY
CCTV	CLOSED CIRCUIT TV	NIC	NOT IN CONTRACT		LIGHTING SYSTEM		⊖ ^{xxx} ⊖	DUPLEX RECEPTACLE - XXX, PER ABBREVIATIONS CEILING MOUNTED RECEPTACLE	18" CLG	↓ F	FIREMAN'S STATION	46" 80"
CLG CM	CEILING COMBINATION STARTER	NL NO or #	NIGHT LIGHT NUMBER		MTG HT	' ∣ ⊨	-	DUPLEX RECEPTACLE ON EMERGENCY CIRCUIT	18" 18"	110	STROBE - 110 INDICATES CANDELA IN SLEEPING AREAS, TOP OF LENS NOT LESS THAN 24" BELOW CEILING	
CNTL COMM	CONTROL COMMUNICATION(S)	NTS OC	NOT TO SCALE ON CENTER		TYPICAL FIXTURE DESIGNATION LIGHT FIXTURE TYPE	ŧ	€сн	DUPLEX RECEPTACLE WITH (2) USB CHARGING PORTS	18"	- E⊲	FIRE ALARM HORN TOP OF DEVICE NOT LESS THAN 90" AFF AND NOT LESS THAN 6" BELOW FINISHED CEILING. IN SLEEPING	80"
COND CONN	CONDUCTOR CONNECT (-ION)	OD OE	OUTSIDE DIAMETER OWNER FURNISHED EQUIPMENT		SWITCHING		⊖ ^{ss} ⊖™	RECEPTACLE WITH INTEGRAL SURGE SUPPRESSION RECEPTACLE – TAMPER RESISTANT	18" 18"		AREAS, TOP OF LENS NOT LESS THAN 24" BELOW CEILING	
CONT CONTR	CONTINUATION OR CONTINUOUS CONTRACTOR	OFCI OH	OWNER FURNISHED CONTRACTOR INSTALLED OVERHEAD		MISCELLANEOUS LIGHT FIXTURE CLG SURFACE STRIP FIXTURE CLG	; 4	⊕ ⊕	DOUBLE DUPLEX RECEPTACLE DOUBLE DUPLEX RECEPTACLE ON EMERGENCY CIRCUIT	18" 18"		FIRE ALARM HORN AND STROBE - 110 INDICATES CANDELA IN SLEEPING AREAS, TOP OF LENS NOT LESS THAN 24" BELOW CEILING	
CPT CT	CONTROL POWER TRANSFORMER	OHC OHP	OVERHEAD COMMUNICATION OVERHEAD POWER		TRACK LIGHTING (QUANTITY OF HEADS AS SCHEDULED)	`I —	• XX	SPECIAL PURPOSE OUTLET	18"	FO 110	FIRE ALARM CHIME AND STROBE - 110 INDICATES CANDEL IN SLEEPING AREAS, TOP OF LENS NOT LESS THAN 24" BELOW CEILING	_A 80"
CTR	CENTER COPPER	OL P	OVERLOADS POLE		AISLE/STEP LIGHT FIXTURE PLAN WALL MOUNTED FIXTURE DESIGNATION PLAN	╩┥┝╤		SPECIAL PURPOSE DIRECT CONNECTION FLOOR OUTLET (DEVICES AS INDICATED)		FS 110	FIRE ALARM SPEAKER AND STROBE - 110 INDICATES CANDELA, TOP OF LENS NOT LESS THAN 24" BELOW CEILIN	
	CABINET UNIT HEATER	PB	PULL BOX, PUSHBUTTON or POWER BASE	<u>~~~~</u> ~ 머 or PO	POLE MOUNTED LIGHT FIXTURES (QUANTITY OF HEADS AS INDICATED) PLAN		Р	POWER POLE		FACP F	FIRE ALARM CONTROL PANEL ANNUNCIATOR (RECESS MOUNTED, SEE SPEC)	SPEC SPEC
DC	DIRECT CURRENT	PC PE	PHOTOELECTRIC CELL PNEUMATIC ELECTRIC	● X ⊘ X	LIGHT FIXTURE ON LIFE SAFETY BRANCH (TYPE DENOTED)			PANELBOARD IDENTIFICATION			RACEWAY SYSTEM	
DIA	DIAMETER DISCONNECT	PF PH	POWER FACTOR PHASE	Øx	LIGHT FIXTURE ON EQUIPMENT BRANCH (TYPE DENOTED)	HIGH		NATION <u>CODE</u> 3ø4W, 277/480 H 5ø4W, 120/208 L				MTG HT
DIST DN	DISTRIBUTION DOWN	PIV PNL	POST INDICATING VALVE PANEL	● XE	LIGHT FIXTURE WITH EMERGENCY BALLAST (TYPE DENOTED) WALL WASH DIRECTION DESIGNATION	SYSTE	EM DESIGN				CONDUIT CONCEALED IN CEILING OR WALLS CONDUIT CONCEALED IN FLOOR OR BELOW	
DPDT DS	DOUBLE POLE, DOUBLE THROW DISCONNECT SWITCH	PL P&C	PILOT LIGHT CORD-N-PLUG		SUSPENDED FIXTURE DESIGNATION PLAN		MAL RGENCY SAFETY	E SYSTEM DESIGNATION			EXPOSED CONDUIT LIFE SAFETY BRANCH CIRCUIT	
DWG E	DRAWING EQUIP. BRANCH OF EMERGENCY PWR	PLBG	PLUMBING		SUBJECT SUBJECT FOR SURFACE MOUNTED FIXTURE DESIGNATION CLG			LE POWER SOURCE UPS			CRITICAL BRANCH CIRCUIT - PATIENT OR MECHANICAL	
EA EC	EACH ELECTRICAL CONTRACTOR DIV. 16	PRI PROJ	PRIMARY PROJECTION (OR)			_ }					EQUIPMENT BRANCH CIRCUIT	
EF	EXHAUST FAN ELECTRIC HEAT	PVC PWR	POLYVINYL CHLORIDE (CONDUIT) POWER		RECESSED FIXTURE DESIGNATION CLG	;		SIGNAL SYSTEMS	MTG	UE-	UNDERGROUND ELECTRICAL UNDERGROUND PRIMARY	
EHC		QUAN REC	QUANTITY RECESSED		FLANGE KIT DESIGNATION CLG			BUZZER	HI 80"	-UT-	UNDERGROUND TELEPHONE UNDERGROUND COMMUNICATIONS	
ELEC	ELECTRIC (-AL)	RECEPT REQD	RECEPTACLE REQUIRED		WALL MOUNTED EXIT SIGN. ARROW INDICATES EGRESS DIRECTION(S). SHADING DENOTES FACE 82" DIRECTION(S).		<u>1</u> 0 ◀	BELL, DOORBELL TELEPHONE OUTLET	80" 18"	-UTV-	UNDERGROUND CABLE TELEVISION (CATV OR CCTV)	
ELEV EM	ELEVATOR EMERGENCY	RIP RLA	REPLACE IN PLACE RUNNING LOAD AMPS	⊥ <u>↓</u>	CEILING MOUNTED EXIT SIGN. ARROW INDICATES EGRESS DIRECTION(S). SHADING DENOTES FACE CLG	;	∢ w	TELEPHONE OUTLET – WALL MOUNTED DATA OUTLET/DATA OUTLET	46"	UFIBR OHP	UNDERGROUND FIBER OPTIC OVERHEAD PRIMARY	
EMT ENCL	ELECTRICAL METALLIC TUBING ENCLOSURE	RM RMS	ROOM ROOT MEAN SQUARE		DIRECTION(S). EXIT/EMERGENCY COMBINATION FIXTURE CLG			IF MORE THAN (2)- # INDICATES QUANTITY OF CABLES AND JACKS	18"		OVERHEAD TELEPHONE	
EP EPO	ELECTRIC PNEUMATIC EMERGENCY POWER OFF	RMT RPM	REMOTE REVOLUTIONS PER MINUTE	\$	BATTERY POWERED EMERGENCY LIGHTING UNIT 82" SINGLE POLE SWITCH 46"		4	DATA OUTLET TELEPHONE OUTLET/DATA OUTLET	18"	UG 30"	UNDERGROUND ELECTRIC - 30" INDICATES BURIAL DEPTH CONDUIT INSTALLED INTO CEILING SPACE WITH BUSHED END	
EQUIP EWC	EQUIPMENT ELECTRIC WATER COOLER	RTU	ROOF TOP UNIT	\$2 \$3	DOUBLE POLE SWITCH 46" THREE WAY SWITCH 46"		∢ #	IF MORE THAN (2)- # INDICATES QUANTITY OF DATA CABLES AND JACKS	18"		(B) OR CAPPED END (C) (BUSHED IF NOT INDICATED) ELEVATION CHANGE IN CONDUIT UP	
EX EXH	EXISTING EXHAUST	SC SEC	SELF CONTAINED SECURITY	 \$⁴ \$ª	FOUR WAY SWITCH 46"		Owap S	WIRELESS ACCESS POINT SPEAKER (WALL OR CEILING MOUNTED)	CLG U.N.O. 80"		ELEVATION CHANGE IN CONDUIT DOWN	
EXP F	EXPLOSION PROOF FUSE	SHT SIM	SHEET SIMILAR	\$" \$"	SWITCH, "g" INDICATES SWITCH DESIGNATION46"SWITCH WITH ILLUMINATED TOGGLE46"			HORN TYPE SPEAKER (WALL OR CEILING MOUNTED) SPEAKER VIA LAN, SPEAKER TO BE POWER-OVER-	80"		CIRCUIT HOME RUN, L1 INDICATES PANEL,	
F@# FA	FUSED AT # AMPERES	SM	SURFACE MOUNT SURGE PROTECTION	\$ ^K \$ ^{TS}	KEY SWITCH 46" TIMER SWITCH 46"		୍ତ" ତ ଂ	STEARCH VIA DAN. STEARCH TO BE FOWER-OVER- ETHERNET STYLE. SEE DETAILS. SYSTEM CLOCK - DIAMETER IN INCHES	CLG U.N.O.	L1-1.3	1,3 INDICATES POLE NUMBER(S)	
		SP		I T			<u> </u>	I SISILW CLOCK - DAWLILK IN INCILS		L1-1,3		
FAA	FIRE ALARM FIRE ALARM ANNUNCIATOR FIRE ALARM CONTROL DANEL	SP SPEC SPKR	SPECIFICATIONS SPEAKER	\$°	DIMMER SWITCH 46"		<u>Q</u> Q	COMBINATION CLOCK/SPEAKER	80" 80"		"a" DESIGNATES LIGHTING SWITCH UNLESS OTHERWISE INDICATED, EACH CROSS HASH	
FACP FBO	FIRE ALARM ANNUNCIATOR FIRE ALARM CONTROL PANEL FURNISHED BY OTHERS	SPEC SPKR SPDT	SPEAKER SINGLE POLE DOUBLE THROW SINGLE POLE SINGLE THROW	\$P ••• •••	DIMMER SWITCH 46" PHOTO CELL			COMBINATION CLOCK/SPEAKER AUXILIARY OUTLET	80" 80"		UNLESS OTHERWISE INDICATED, EACH CROSS HASH DENOTES ONE # 12 CONDUCTOR. NO CROSS HASH DENOTES 3 # 12 CONDUCTORS.	
FACP	FIRE ALARM ANNUNCIATOR FIRE ALARM CONTROL PANEL	SPEC SPKR SPDT SPST SQ	SPEAKER SINGLE POLE DOUBLE THROW SINGLE POLE SINGLE THROW MOTOR RATED SQUARE		DIMMER SWITCH 46" PHOTO CELL			COMBINATION CLOCK/SPEAKER	80" 80" 18" 46"		UNLESS OTHERWISE INDICATED, EACH CROSS HASH DENOTES ONE # 12 CONDUCTOR. NO CROSS HASH DENOTES 3 # 12 CONDUCTORS. LONGER CROSS HASH INDICATES NEUTRAL CONDUCTOR. INDICATES GROUNDING CONDUCTOR	
FACP FBO FC	FIRE ALARM ANNUNCIATOR FIRE ALARM CONTROL PANEL FURNISHED BY OTHERS FOOT CANDLE	SPEC SPKR SPDT SPST	SPEAKER SINGLE POLE DOUBLE THROW SINGLE POLE SINGLE THROW MOTOR RATED	HC B ^X ^{PP} ⊗ ^{CMx} ⊗ ^{CMx}	DIMMER SWITCH 46" PHOTO CELL		♦	COMBINATION CLOCK/SPEAKER AUXILIARY OUTLET MICROPHONE OUTLET	80" 80" 18"		UNLESS OTHERWISE INDICATED, EACH CROSS HASH DENOTES ONE # 12 CONDUCTOR. NO CROSS HASH DENOTES 3 # 12 CONDUCTORS. LONGER CROSS HASH INDICATES NEUTRAL CONDUCTOR.	
FACP FBO FC FCU FD	FIRE ALARM ANNUNCIATOR FIRE ALARM CONTROL PANEL FURNISHED BY OTHERS FOOT CANDLE FAN COIL UNIT FIRE DAMPER	SPEC SPKR SPDT SPST SQ SS	SPEAKER SINGLE POLE DOUBLE THROW SINGLE POLE SINGLE THROW MOTOR RATED SQUARE STAINLESS STEEL	⊢EC SB ^X	DIMMER SWITCH 46" PHOTO CELL 1 TIME CLOCK 1 WALL MOUNTED OCCUPANCY SENSOR, "X" INDICATES TYPE 46" OCCUPANCY SENSOR POWER PACK (IN J-BOX) ABOVE CEILING MOUNTED OCCUPANCY SENSOR (DIRECTIONAL) 1 UNITARY LIGHTING RELAY (3A) ABOVE CLG ROOM LIGHTING RELAY (20A) ABOVE CLG		国	COMBINATION CLOCK/SPEAKER AUXILIARY OUTLET MICROPHONE OUTLET SPEAKER VOLUME CONTROL INTERCOM STATION EXTRA LARGE 4 SQUARE BOX WITH HDMI CONNECTION TV ANTENNA OUTLET	80" 80" 18" 46" 46" SEE PLAN VERIFY		UNLESS OTHERWISE INDICATED, EACH CROSS HASH DENOTES ONE # 12 CONDUCTOR. NO CROSS HASH DENOTES 3 # 12 CONDUCTORS. LONGER CROSS HASH INDICATES NEUTRAL CONDUCTOR. INDICATES GROUNDING CONDUCTOR PULL BOX JUNCTION BOX COMMUNICATIONS/DATA JUNCTION BOX W/ 1" EMT TO ACCESSIBLE CEILING, PLASTIC BUSHING. PROVIDE BLANK	18" UNO
FACP FBO FC FCU FD FDS FIN FL FL FLA	FIRE ALARM ANNUNCIATOR FIRE ALARM CONTROL PANEL FURNISHED BY OTHERS FOOT CANDLE FAN COIL UNIT FIRE DAMPER FUSED DISCONNECT SWITCH FINISHED	SPEC SPKR SPDT SPST SQ SS STD SUSP	SPEAKER SINGLE POLE DOUBLE THROW SINGLE POLE SINGLE THROW MOTOR RATED SQUARE STAINLESS STEEL STANDARD SUSPENDED	⊢⊡ В ^X ◇ ^{PP} ⊗ ^{CM×} ⊗ ^Q	DIMMER SWITCH 46" PHOTO CELL		 ♦ ♦ ♦ ↓ □ □	COMBINATION CLOCK/SPEAKER AUXILIARY OUTLET MICROPHONE OUTLET SPEAKER VOLUME CONTROL INTERCOM STATION EXTRA LARGE 4 SQUARE BOX WITH HDMI CONNECTION	80" 80" 18" 46" 46" SEE PLAN		UNLESS OTHERWISE INDICATED, EACH CROSS HASH DENOTES ONE # 12 CONDUCTOR. NO CROSS HASH DENOTES 3 # 12 CONDUCTORS. LONGER CROSS HASH INDICATES NEUTRAL CONDUCTOR. INDICATES GROUNDING CONDUCTOR PULL BOX JUNCTION BOX COMMUNICATIONS/DATA JUNCTION BOX W/ 1" EMT TO ACCESSIBLE CEILING, PLASTIC BUSHING. PROVIDE BLANK COVER MATCHING ADJACENT DEVICES. 4-11/16" BACKBOX, MUDRING AS REQUIRED	
FACP FBO FC FCU FD FDS FIN FL FL FLA FLUOR FSD	FIRE ALARM ANNUNCIATOR FIRE ALARM CONTROL PANEL FURNISHED BY OTHERS FOOT CANDLE FAN COIL UNIT FIRE DAMPER FUSED DISCONNECT SWITCH FINISHED FLOOR FULL LOAD AMPS FLUORESCENT FIRE/SMOKE DAMPER	SPEC SPKR SPDT SPST SQ SS SS STD SUSP SW SWBD SYS TC	SPEAKER SINGLE POLE DOUBLE THROW SINGLE POLE SINGLE THROW MOTOR RATED SQUARE STAINLESS STEEL STANDARD SUSPENDED SWITCH SWITCHBOARD SYSTEM TEMPERATURE CONTROL CONTRACTOR	⊢EC SB ^X	DIMMER SWITCH 46" PHOTO CELL		国	COMBINATION CLOCK/SPEAKER AUXILIARY OUTLET MICROPHONE OUTLET SPEAKER VOLUME CONTROL INTERCOM STATION EXTRA LARGE 4 SQUARE BOX WITH HDMI CONNECTION TV ANTENNA OUTLET COMMUNICATION BACKBOARD	80" 80" 18" 46" 46" SEE PLAN VERIFY		UNLESS OTHERWISE INDICATED, EACH CROSS HASH DENOTES ONE # 12 CONDUCTOR. NO CROSS HASH DENOTES 3 # 12 CONDUCTORS. LONGER CROSS HASH INDICATES NEUTRAL CONDUCTOR. INDICATES GROUNDING CONDUCTOR PULL BOX JUNCTION BOX COMMUNICATIONS/DATA JUNCTION BOX W/ 1" EMT TO ACCESSIBLE CEILING, PLASTIC BUSHING. PROVIDE BLANK COVER MATCHING ADJACENT DEVICES. 4-11/16" BACKBOX, MUDRING AS REQUIRED POWER JUNCTION BOX W/ 3/4" EMT TO ACCESSIBLE CEILING, PLASTIC BUSHING. PROVIDE BLANK COVER MATCHING ADJACENT DEVICES.	18" UNO 18" UNO
FACP FBO FC FCU FD FDS FIN FL FLA FLA FLUOR FSD FT or ' GA	FIRE ALARM ANNUNCIATOR FIRE ALARM CONTROL PANEL FURNISHED BY OTHERS FOOT CANDLE FAN COIL UNIT FIRE DAMPER FUSED DISCONNECT SWITCH FINISHED FLOOR FULL LOAD AMPS FLUORESCENT FIRE/SMOKE DAMPER FOOT or FEET GAUGE	SPEC SPKR SPDT SPST SQ SS STD SUSP SW SWBD SYS TC TDO TEL(E)	SPEAKER SINGLE POLE DOUBLE THROW SINGLE POLE SINGLE THROW MOTOR RATED SQUARE STAINLESS STEEL STANDARD SUSPENDED SWITCH SWITCHBOARD SYSTEM TEMPERATURE CONTROL CONTRACTOR TIME DELAY OFF TELEPHONE	⊢EC SB ^X	DIMMER SWITCH 46" PHOTO CELL		¤₃ d D	COMBINATION CLOCK/SPEAKER AUXILIARY OUTLET MICROPHONE OUTLET SPEAKER VOLUME CONTROL INTERCOM STATION EXTRA LARGE 4 SQUARE BOX WITH HDMI CONNECTION TV ANTENNA OUTLET COMMUNICATION BACKBOARD DATA RACK - FLOOR MOUNTED	80" 80" 18" 46" 46" SEE PLAN VERIFY SPEC		UNLESS OTHERWISE INDICATED, EACH CROSS HASH DENOTES ONE # 12 CONDUCTOR. NO CROSS HASH DENOTES 3 # 12 CONDUCTORS. LONGER CROSS HASH INDICATES NEUTRAL CONDUCTOR. INDICATES GROUNDING CONDUCTOR PULL BOX JUNCTION BOX COMMUNICATIONS/DATA JUNCTION BOX W/ 1" EMT TO ACCESSIBLE CEILING, PLASTIC BUSHING. PROVIDE BLANK COVER MATCHING ADJACENT DEVICES. 4-11/16" BACKBOX, MUDRING AS REQUIRED POWER JUNCTION BOX W/ 3/4" EMT TO ACCESSIBLE CEILING, PLASTIC BUSHING. PROVIDE BLANK COVER	18"
FACP FBO FC FCU FD FDS FIN FL FLA FLUOR FSD FT or ' GA GAL GALV	FIRE ALARM ANNUNCIATOR FIRE ALARM CONTROL PANEL FURNISHED BY OTHERS FOOT CANDLE FAN COIL UNIT FIRE DAMPER FUSED DISCONNECT SWITCH FINISHED FLOOR FULL LOAD AMPS FLUORESCENT FIRE/SMOKE DAMPER FOOT or FEET GAUGE GALLON GALVANIZED	SPEC SPEC SPKR SPDT SPST SQ SS STD SUSP SW SWBD SYS TC TDO TEL(E) TEMP TMB	SPEAKER SINGLE POLE DOUBLE THROW SINGLE POLE SINGLE THROW MOTOR RATED SQUARE STAINLESS STEEL STANDARD SUSPENDED SWITCH SWITCHBOARD SYSTEM TEMPERATURE CONTROL CONTRACTOR TIME DELAY OFF TELEPHONE TEMPERATURE TEMPERATURE	⊢EC SB ^X	DIMMER SWITCH 46" PHOTO CELL		¤₃ d D	COMBINATION CLOCK/SPEAKER AUXILIARY OUTLET MICROPHONE OUTLET SPEAKER VOLUME CONTROL INTERCOM STATION EXTRA LARGE 4 SQUARE BOX WITH HDMI CONNECTION TV ANTENNA OUTLET COMMUNICATION BACKBOARD DATA RACK – FLOOR MOUNTED CLOSED CIRCUIT TV CAMERA	80" 80" 18" 46" 46" SEE PLAN VERIFY SPEC VERIFY		UNLESS OTHERWISE INDICATED, EACH CROSS HASH DENOTES ONE # 12 CONDUCTOR. NO CROSS HASH DENOTES 3 # 12 CONDUCTORS. LONGER CROSS HASH INDICATES NEUTRAL CONDUCTOR. INDICATES GROUNDING CONDUCTOR PULL BOX JUNCTION BOX COMMUNICATIONS/DATA JUNCTION BOX W/ 1" EMT TO ACCESSIBLE CEILING, PLASTIC BUSHING. PROVIDE BLANK COVER MATCHING ADJACENT DEVICES. 4-11/16" BACKBOX, MUDRING AS REQUIRED POWER JUNCTION BOX W/ 3/4" EMT TO ACCESSIBLE CEILING, PLASTIC BUSHING. PROVIDE BLANK COVER MATCHING ADJACENT DEVICES. 4 SQ BACKBOX, MUDRING AS REQUIRED	18"
FACP FBO FC FCU FD FDS FIN FL FLA FLUOR FSD FT or ' GA GAL GALV GC GEN	FIRE ALARM ANNUNCIATOR FIRE ALARM CONTROL PANEL FURNISHED BY OTHERS FOOT CANDLE FAN COIL UNIT FIRE DAMPER FUSED DISCONNECT SWITCH FINISHED FLOOR FULL LOAD AMPS FLUORESCENT FIRE/SMOKE DAMPER FOOT or FEET GAUGE GALLON GALVANIZED GENERAL CONTRACTOR GENERATOR	SPEC SPEC SPKR SPDT SPST SQ SS STD SUSP SW SWBD SYS TC TDO TEL(E) TEMP TMB T-STAT TV	SPEAKER SINGLE POLE DOUBLE THROW SINGLE POLE SINGLE THROW MOTOR RATED SQUARE STAINLESS STEEL STANDARD SUSPENDED SWITCH SWITCHBOARD SYSTEM TEMPERATURE CONTROL CONTRACTOR TIME DELAY OFF TELEPHONE TEMPERATURE TELEPHONE MOUNTING BOARD THERMOSTAT TELEVISION	⊢EC SB ^X	DIMMER SWITCH 46" PHOTO CELL		¤₃ d D	COMBINATION CLOCK/SPEAKER AUXILIARY OUTLET MICROPHONE OUTLET SPEAKER VOLUME CONTROL INTERCOM STATION EXTRA LARGE 4 SQUARE BOX WITH HDMI CONNECTION TV ANTENNA OUTLET COMMUNICATION BACKBOARD DATA RACK – FLOOR MOUNTED CLOSED CIRCUIT TV CAMERA FLOOR OUTLET (DEVICES AS INDICATED)	80" 80" 18" 46" 46" SEE PLAN VERIFY SPEC		UNLESS OTHERWISE INDICATED, EACH CROSS HASH DENOTES ONE # 12 CONDUCTOR. NO CROSS HASH DENOTES 3 # 12 CONDUCTORS. LONGER CROSS HASH INDICATES NEUTRAL CONDUCTOR. INDICATES GROUNDING CONDUCTOR PULL BOX JUNCTION BOX COMMUNICATIONS/DATA JUNCTION BOX W/ 1" EMT TO ACCESSIBLE CEILING, PLASTIC BUSHING. PROVIDE BLANK COVER MATCHING ADJACENT DEVICES. 4-11/16" BACKBOX, MUDRING AS REQUIRED POWER JUNCTION BOX W/ 3/4" EMT TO ACCESSIBLE CEILING, PLASTIC BUSHING. PROVIDE BLANK COVER MATCHING ADJACENT DEVICES. 4 SQ BACKBOX, MUDRING AS REQUIRED MULTI-OUTLET ASSEMBLY CABLE TRAY - DEFAULT WIDTH = 8" - INDICATES WIDTH UNDERFLOOR DUCT AND JUNCTION BOX, NUMBER OF CELLS DENOTED BY NUMBER OF SPACES BETWEEN LINES.	18" UNO
FACP FBO FC FCU FD FDS FIN FL FLA FLUOR FSD FT or ' GA GAL GAL GAL GAL GC GC GEN GFI GND	FIRE ALARM ANNUNCIATOR FIRE ALARM CONTROL PANEL FURNISHED BY OTHERS FOOT CANDLE FAN COIL UNIT FIRE DAMPER FUSED DISCONNECT SWITCH FINISHED FLOOR FULL LOAD AMPS FLUORESCENT FIRE/SMOKE DAMPER FOOT or FEET GAUGE GALLON GALVANIZED GENERAL CONTRACTOR GENERATOR GROUND FAULT INTERRUPTER GROUND	SPEC SPEC SPKR SPDT SPST SQ SS STD SUSP SW SWBD SYS TC TDO TEL(E) TEMP TMB T-STAT TV TYP TR	SPEAKER SINGLE POLE DOUBLE THROW SINGLE POLE SINGLE THROW MOTOR RATED SQUARE STAINLESS STEEL STANDARD SUSPENDED SWITCH SWITCHBOARD SYSTEM TEMPERATURE CONTROL CONTRACTOR TIME DELAY OFF TELEPHONE TEMPERATURE TELEPHONE MOUNTING BOARD THERMOSTAT TELEVISION TYPICAL TAMPER RESISTANT	⊢EC SB ^X	DIMMER SWITCH 46" PHOTO CELL			COMBINATION CLOCK/SPEAKER AUXILIARY OUTLET MICROPHONE OUTLET SPEAKER VOLUME CONTROL INTERCOM STATION EXTRA LARGE 4 SQUARE BOX WITH HDMI CONNECTION TV ANTENNA OUTLET COMMUNICATION BACKBOARD DATA RACK – FLOOR MOUNTED CLOSED CIRCUIT TV CAMERA FLOOR OUTLET (DEVICES AS INDICATED) SECURITY SYSTEM	80" 80" 18" 46" 46" SEE PLAN VERIFY SPEC VERIFY		UNLESS OTHERWISE INDICATED, EACH CROSS HASH DENOTES ONE # 12 CONDUCTOR. NO CROSS HASH DENOTES 3 # 12 CONDUCTORS. LONGER CROSS HASH INDICATES NEUTRAL CONDUCTOR. INDICATES GROUNDING CONDUCTOR PULL BOX JUNCTION BOX COMMUNICATIONS/DATA JUNCTION BOX W/ 1" EMT TO ACCESSIBLE CEILING, PLASTIC BUSHING. PROVIDE BLANK COVER MATCHING ADJACENT DEVICES. 4-11/16" BACKBOX, MUDRING AS REQUIRED POWER JUNCTION BOX W/ 3/4" EMT TO ACCESSIBLE CEILING, PLASTIC BUSHING. PROVIDE BLANK COVER MATCHING ADJACENT DEVICES. 4-SQ BACKBOX, MUDRING AS REQUIRED MULTI-OUTLET ASSEMBLY CABLE TRAY – DEFAULT WIDTH = 8" – INDICATES WIDTH UNDERFLOOR DUCT AND JUNCTION BOX, NUMBER OF CELLS	18" UNO
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FACP FBO FC FCU FD FDS FIN FL FLA FLUOR FSD FT or ' GA GAL GAL GAL GAL GAL GC GEN GFI GND GFI GND GYP GRC H HD HID HOA HORIZ	FIRE ALARM ANNUNCIATOR FIRE ALARM CONTROL PANEL FURNISHED BY OTHERS FOOT CANDLE FAN COIL UNIT FIRE DAMPER FUSED DISCONNECT SWITCH FINISHED FLOOR FULL LOAD AMPS FLUORESCENT FIRE/SMOKE DAMPER FOOT or FEET GAUGE GALLON GALVANIZED GENERAL CONTRACTOR GENERATOR GROUND FAULT INTERRUPTER GROUND GYPSUM BOARD GALVANIZED RIGID CONDUIT HEATING EQUIPMENT HEAVY DUTY HIGH INTENSITY DISCHARGE HAND-OFF AUTO SWITCH HORIZONTAL	SPEC SPEC SPFR SPDT SPST SQ SS STD SUSP SW SWBD SYS TC TDO TEL(E) TEMP TMB T-STAT TV TYP TR UC UE UG UH UT UNO	SPEAKER SINGLE POLE DOUBLE THROW SINGLE POLE SINGLE THROW MOTOR RATED SQUARE STAINLESS STEEL STANDARD SUSPENDED SWITCH SWITCHBOARD SYSTEM TEMPERATURE CONTROL CONTRACTOR TIME DELAY OFF TELEPHONE TEMPERATURE TELEPHONE MOUNTING BOARD THERMOSTAT TELEVISION TYPICAL TAMPER RESISTANT UNDER COUNTER UNDERGROUND ELECTRICAL UNDERGROUND UNDERWRITERS LABORATORY UNIT HEATER UNDERGROUND TEL AND/OR TV UNLESS NOTED OTHERWISE	⊢EC SB ^X	DIMMER SWITCH 46" PHOTO CELL			COMBINATION CLOCK/SPEAKER AUXILIARY OUTLET MICROPHONE OUTLET SPEAKER VOLUME CONTROL INTERCOM STATION EXTRA LARGE 4 SQUARE BOX WITH HDMI CONNECTION TV ANTENNA OUTLET COMMUNICATION BACKBOARD DATA RACK – FLOOR MOUNTED CLOSED CIRCUIT TV CAMERA FLOOR OUTLET (DEVICES AS INDICATED) SECURITY SYSTEM AI PHONE/INTERCOM CARD READER KEYPAD KEY SWITCH REQUEST TO EXIT EXIT PUSHBUTTON ELECTRIC STRIKE MAGNETIC LOCK	80" 80" 18" 46" 46" SEE PLAN VERIFY SPEC VERIFY VERIFY MTTG HT 46" 46" 46"		UNLESS OTHERWISE INDICATED, EACH CROSS HASH DENOTES ONE # 12 CONDUCTOR. NO CROSS HASH DENOTES 3 # 12 CONDUCTORS. LONGER CROSS HASH INDICATES NEUTRAL CONDUCTOR. INDICATES GROUNDING CONDUCTOR PULL BOX JUNCTION BOX COMMUNICATIONS/DATA JUNCTION BOX W/ 1" EMT TO ACCESSIBLE CEILING, PLASTIC BUSHING. PROVIDE BLANK COVER MATCHING ADJACENT DEVICES. 4-11/16" BACKBOX, MUDRING AS REQUIRED POWER JUNCTION BOX W/ 3/4" EMT TO ACCESSIBLE CEILING, PLASTIC BUSHING. PROVIDE BLANK COVER MATCHING ADJACENT DEVICES. 4-SQ BACKBOX, MUDRING AS REQUIRED MULTI-OUTLET ASSEMBLY CABLE TRAY – DEFAULT WIDTH = 8" – INDICATES WIDTH UNDERFLOOR DUCT AND JUNCTION BOX, NUMBER OF CELLS DENOTED BY NUMBER OF SPACES BETWEEN LINES. TYPE OF CELL DENOTED BY P (POWER), T (TELEPHONE), C (COMMUNICATIONS). BACK BOX – INSTALL SINGLE GANG BACKBOX WITH 3/4" EMT CONDUIT UP TO ACCESSIBLE CEILING SPACE PROVIDE BLANK COVER MATCHING DECOR	18" UNO LS
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WILL BE REJECTED.

- UTILIZE ARCHITECTURAL DRAWINGS TO IDENTIFY PROJECT REQUIREMENTS AS REQUIRED BY THE PROJECT.
- CONDUIT.
- CONTRACTOR SHALL LOCATE OR SHALL HAVE THE SERVICING UTILITY LOCATE ALL
- UTILITIES.
- ALUMINUM.
- COLOR MATCHING ADJACENT DEVICES.
- TERMINATION LOCATIONS OF EACH CONDUIT. SATISFACTION OF THE ARCHITECT/ENGINEER.
- 13. PRIOR TO ROUGH-INS, VERIFY THE EXACT LOCATIONS OF EQUIPMENT TO BE FURNISHED BY OTHERS.
- OPERABLE & READY FOR CONTINUOUS OPERATION.
- THE UPSTREAM DEVICE.
- NEC. SEE SPECIFICATIONS FOR DE-RATING METHODS.
- FOR PROJECT SPECIFIC REQUIREMENTS.
- MATTE BLACK WITH EPOXY PAINT.

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PLAN PLAN

AND SYSTEMS PLAN

AND SYSTEMS PLAN

ISER, PANEL SCHEDULE AND DETAILS

GENERAL NOTES

. NOT ALL APPLICABLE REQUIREMENTS OF THE NEC ARE IDENTIFIED ON THESE CONSTRUCTION PLANS OR IN THE SPECIFICATION DOCUMENTS. IT IS EXPECTED THAT THE ELECTRICIAN ON SITE READ AND UNDERSTAND THE ASSOCIATED SPECIFICATIONS AND THE NEC. PRODUCT OR INSTALLATIONS NOT IN COMPLIANCE

ELECTRICAL CONTRACTOR TO COORDINATE ALL WORK AND DEVICE LOCATIONS WITH OTHER TRADES AND WITH ARCHITECTURAL PLANS AND DETAILS. CONTRACTOR TO

PROVIDE SEPARATE NEUTRAL FOR EACH CIRCUIT. INSTALL GROUND WIRE IN EACH

. FIELD VERIFY EXISTING CONDITIONS. CONTRACTOR SHALL VISIT THE SITE PRIOR TO BID AND VERIFY CONDITIONS ARE AS DELINEATED. CONTRACTOR SHALL INCLUDE IN BID, ALL COST ASSOCIATED WITH MODIFICATIONS OF EXISTING CONDITIONS.

. EQUIPMENT PLACEMENTS AND CONDUIT SHALL BE PLANNED SUCH THAT FOLLOWING INSTALLATION, ALL ELECTRICAL ENCLOSURES AND ALL EQUIPMENT SHALL BE SERVICEABLE.

UNDERGROUND CABLE, CONDUITS, PIPING UTILITIES, ETC. PRIOR TO COMMENCING CONSTRUCTION (UNDERGROUND EXCAVATION). CONTRACTOR SHALL BE RESPONSIBLE FOR THE REPAIR OF ANY DAMAGES DUE TO THE CONSTRUCTION ACTIVITIES. A WATERJET/VAC PROCESS IS RECOMMENDED TO UNCOVER EXISTING

ALL CONDUCTORS ARE TO BE COPPER UNLESS EXPLICITLY ALLOWED TO BE

. FOR ANY ELECTRICAL BOX THAT IS OR BECOMES ABANDONED DURING CONSTRUCTION, MAINTAIN ACCESS AND PROVIDE A BLANK COVERPLATE WITH

. FINAL CONNECTIONS TO EQUIPMENT SHALL BE PER MANUFACTURER'S APPROVED WIRING DIAGRAMS, DETAILS AND INSTRUCTIONS. IT SHALL BE THE CONTRACTOR'S RESPONSIBILITY TO PROVIDE MATERIALS AND EQUIPMENT REQUIRED. THIS REQUIREMENT SHALL NOT BE CONSTRUED TO PROVIDE LESS THAN SPECIFIED.

10. ALL EMPTY RACEWAY SYSTEMS SHALL BE PROVIDED WITH A PULLWIRE/PULLCORD AND SHALL BE IDENTIFIED AT ALL JUNCTION, PULL, AND TERMINATION POINTS USING PERMANENT TAGS. TAGS SHALL INDICATE FUTURE USE, ORIGINATION, AND

. ALL WORK SHALL BE PERFORMED IN A WORKMANLIKE MANNER TO THE

12. WORK, MATERIALS, AND EQUIPMENT SHALL BE NEW AND CONFORM TO THE LATEST EDITION OF LOCAL, STATE AND NATIONAL CODES & STANDARDS.

14. VERIFY <u>ACTUAL</u> RATINGS, LOADS & CAPACITIES OF EQUIPMENT FURNISHED BY OTHERS PRIOR TO ROUGH-INS. ALL SHOP SUBMITTALS SHALL REFLECT THE <u>ACTUAL</u> EQUIPMENT PLANNED FOR INSTALLATION.

15. ALL NEW ELECTRICAL SYSTEMS SHALL BE TESTED FOR PROPER OPERATION. IF TESTS INDICATE WORK IS DEFECTIVE, THE CONTRACTOR SHALL MAKE ALL NECESSARY CORRECTIONS AT NO COST TO THE OWNER. ALL SYSTEMS SHALL BE

16. GFI RECEPTACLES SHALL NOT BE "WIRED TO PROTECT DOWNSTREAM" FOR THE PURPOSE OF REDUCING THE QUANTITY OF GFI RECEPTACLES. IF DOWNSTREAM DEVICES ARE NOT GFI AND MUST BE GFI PROTECTED, THE CONTRACTOR MAY ASSUME THIS WAS THE ENGINEER'S INTENT AND PROVIDE GFI PROTECTION FROM

17. IF NOT ALREADY APPLIED, APPLY AMBIENT TEMPERATURE DE-RATING PER THE

18. UPSIZE BRANCH CIRCUITS PER VOLTAGE DROP REQUIREMENTS PER NEC, 6% TOTAL DROP. CONDUCTORS APPLICATION OF SCHEDULE 310. SEE SPECIFICATIONS

19. EXPOSED CONDUITS SHALL BE RMC. EQ, BOXES AND CONDUIT SHALL BE PAINTED

PROFESSIONAL PROFESSIONAL SOLUTION SOLU
3202 W. MAIN, SUITE C RAPID CITY, SOUTH DAKOTA 57702 605.343.9606
Albertson Engineering Inc.
chamberlin 725 St. Joseph Street, Suite B1 Rapid City, SD 57701 605.355.6804
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DAYS OF '76 CROW'S NEST ADDITION
DEADWOOD, SOUTH DAKOTA ISSUE BLOCK:
NO ISSUE TYPE ISSUE DATE CD 100% CD 05/14/21
MANAGEMENT:
PROJECT NO: 1810 DRAWN BY: SMD CHECKED BY: JBS
SHEET TITLE: ELECTRICAL
LEGEND AND SHEET INDEX
SHEET IDENTIFICATION:
E000
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<u>SCOPE</u>

FURNISH AND INSTALL COMPLETELY WIRED AND OPERATIONAL ELECTRICAL LIGHTING AND POWER SYSTEMS AS SHOWN ON THE DRAWINGS AND SPECIFIED HEREIN. DATA, COMMUNICATIONS, AND SECURITY AS SPECIFIED.

CODES. REGULATIONS. AND STANDARDS

THE INSTALLATION SHALL COMPLY WITH APPLICABLE LOCAL AND STATE CODES AND ORDINANCES, WITH THE REGULATIONS OF THE NATIONAL ELECTRIC CODE AND WITH THE REQUIREMENTS OF THE POWER AND TELEPHONE COMPANIES FURNISHING SERVICES TO THIS INSTALLATION.

EDITION OR THAT EDITION WHICH HAS BEEN ADOPTED BY THE AHJ:

- 1. THE NATIONAL ELECTRICAL MANUFACTURER'S ASSOCIATION STANDARDS.
- THE NATIONAL ELECTRICAL CODE & STATE WIRING RULES. UNDERWRITER LABORATORIES INCORPORATED STANDARDS.
- AMERICAN STANDARDS ASSOCIATION. INTERNATIONAL BUILDING CODE, INTERNATIONAL FIRE CODE.
- NATIONAL FIRE PROTECTION (NFPA 72) 7. LOCAL CITY & COUNTY REQUIREMENTS.

STORAGE AND HANDLING OF MATERIAL

DELIVER MATERIALS AND EQUIPMENT TO THE PROJECT IN THE MANUFACTURER'S ORIGINAL, UNOPENED, LABELED CONTAINERS. PROTECT AGAINST MOISTURE, TAMPERING, OR DAMAGE FROM IMPROPER HANDLING OR STORAGE, CONTRACTOR SHALL PROTECT AND BE RESPONSIBLE FOR ANY DAMAGE TO WORK OR MATERIALS UNTIL FINAL ACCEPTANCE BY THE OWNER AND SHALL MAKE GOOD WITHOUT COST TO THE OWNER ANY DAMAGE OR LOSS THAT MAY OCCUR DURING THIS PERIOD.

ARRANGE FOR TIMELY DELIVERY OF MATERIALS AND EQUIPMENT TO THE JOB SITE IN ORDER TO MINIMIZE THE LENGTH OF TIME BETWEEN DELIVERY AND INSTALLATION.

COVER AND PROTECT ANY MATERIAL WHICH MAY BE AFFECTED BY THE WEATHER WHILE IN TRANSIT OR STORED AT THE PROJECT SITE, ANY MATERIAL FOUND DEFECTIVE OR NOT INSTALLED IN ACCORDANCE WITH THE CONTRACT DOCUMENTS MAY BE REJECTED BY THE ENGINEER.

EQUIPMENT IDENTIFICATION AND CLEAN-UP

ALL ELECTRICAL EQUIPMENT SHALL BE PROVIDED WITH IDENTIFICATION LABELS INDICATING ITS USE OR FUNCTION. EQUIPMENT TO BE IDENTIFIED SHALL INCLUDE PANELBOARDS. SPECIAL SYSTEMS PANELS, MOTOR STARTERS, CONTROL SWITCHES, DISCONNECTS, JUNCTION BOXES AND EMPTY CONDUITS FOR FUTURE USE, ALL PANELS SHALL HAVE TYPED CIRCUIT DIRECTORIES. ALL ELECTRICAL EQUIPMENT MUST BE KEPT COMPLETELY PROTECTED FROM WEATHER, PAINTING, ETC. DAMAGE FROM RUST, PAINT, SCRATCHES, ETC. SHALL BE CORRECTED.

KEEP THE PREMISES FREE FROM ACCUMULATION OF WASTE MATERIALS, OR RUBBISH CAUSED BY THE EMPLOYEES OR WORK UNDER THIS DIVISION OF THE SPECIFICATIONS. AT THE COMPLETION OF THE WORK, REMOVE ALL SURPLUS MATERIALS, TOOLS, ETC.

DRAWINGS

PRESENTED ON THESE DRAWINGS ARE AS ACCURATE AS PLANNING CAN DETERMINE, BUT FIELD VERIFICATION OF ALL DIMENSIONS, LOCATIONS, LEVELS, ETC., TO SUIT FIELD CONDITIONS IS REQUIRED. REVIEW ALL ARCHITECTURAL, STRUCTURAL. AND MECHANICAL DRAWINGS AND ADJUST ALL WORK TO MEET THE REQUIREMENTS OF CONDITIONS SHOWN, THE ARCHITECTURAL DRAWINGS SHALL TAKE PRECEDENCE OVER ALL OTHER DRAWINGS, DISCREPANCIES BETWEEN DIFFERENT PLANS, OR BETWEEN DRAWINGS AND SPECIFICATION, OR REGULATIONS AND CODES GOVERNING THE INSTALLATION SHALL BE BROUGHT TO THE ATTENTION OF THE ENGINEER IN WRITING. CONTRACTOR SHALL BE RESPONSIBLE TO FIELD MEASURE AND CONFIRM MOUNTING HEIGHTS AND LOCATIONS OF ELECTRICAL EQUIPMENT WITH RESPECT TO COUNTERS, RADIATION HEATING, ETC. DO NOT SCALE DISTANCES OFF THE ELECTRICAL DRAWINGS, USE ACTUAL BUILDING DIMENSIONS.

CUTTING AND FITTING

PERFORM THE CUTTING, FITTING, REPAIRING AND FINISHING OF THE WORK NECESSARY FOR THE INSTALLATION OF THE EQUIPMENT OF THIS SECTION. HOWEVER, NO CUTTING OF THE WORK OF OTHER TRADES OR OF ANY STRUCTURAL MEMBER SHALL BE DONE WITHOUT THE CONSENT OF THE ARCHITECT.

COOPERATION WITH OTHER CONTRACTORS

COOPERATE WITH THE OTHER TRADES SO THAT THE INSTALLATION OF THE ELECTRICAL OUTLETS AND EQUIPMENT WILL BE PROPERLY COORDINATED. CONDUIT, FIXTURES, AND OTHER EQUIPMENT LOCATIONS SHALL BE CHECKED WITH THE OTHER TRADES TO AVOID CONFLICT WITH THE PIPING, DUCTWORK, STEEL, PIPING, BEAMS OR OTHER OBSTRUCTIONS. E.C. WILL YIELD TO OTHER TRADES WHENEVER POSSIBLE.

CAREFULLY CHECK THE LOCATIONS OF THE OUTLET BOXES AND DETERMINE THAT THEY HAVE NOT BEEN DISTURBED

DURING THE INSTALLATION OF MATERIALS OF OTHER TRADES.

EXCAVATION AND BACKFILL

SPECIFICATIONS. TRENCH BOTTOMS SHALL BE GRADED TRUE AND FREE FROM STONES OR SOFT SPOTS. USI EXCAVATED MATERIALS FOR BACKFILL UNLESS OFF-SITE MATERIALS ARE DEEMED NECESSARY BY THE ARCHITECT, ENGINEER OR THE UTILITY COMPANY. TRENCHING AND BACKFILLING FOR ELECTRICAL AND WORK SHALL BE PROVIDED BY THIS CONTRACTOR. THE EC SHALL PERFORM OR COORDINATE SURFACE REPAIR WITH THE GENERAL CONTRACTOR.

<u>WORKMANSHIP</u>

THE INSTALLATION WORK INCLUDED IN THIS SPECIFICATION SHALL BE PERFORMED IN A NEAT WORKMANLIKE MANNER BY PERSONS EXPERIENCED AND SKILLED IN THE ELECTRICAL TRADE. ONLY THE BEST QUALITY WORKMANSHIP WILL BE ACCEPTED. ALL EXPOSED PARTS OF THE ELECTRICAL WIRING SYSTEMS SUCH AS EXPOSED CONDUITS, FLUSH PLATES, CABINET TRIM, FIXTURES, ETC. SHALL BE INSTALLED SQUARE AND TRUE WITH THE BUILDING CONSTRUCTION.

MATERIALS

ALL MATERIALS SHALL BE NEW AND OF QUALITY AS SPECIFIED ON THE PLANS OR SPECIFICATIONS AND MUST CARRY THE UNDERWRITER'S LABORATORIES APPROVAL COVERING THE PURPOSE FOR WHICH THEY ARE USED, IN ADDITION TO MEETING ALL REQUIREMENTS OF THE CURRENT APPLICABLE CODES AND REGULATIONS.

ELECTRICAL SPECIFICATION

THE FOLLOWING INDUSTRY STANDARDS, SPECIFICATIONS AND CODES ARE MINIMUM REQUIREMENTS USING THE LATEST

THE DRAWINGS INDICATE THE GENERAL ARRANGEMENT AND LOCATIONS OF THE ELECTRICAL WORK. INFORMATION

PERFORM ALL EXCAVATION AND BACKFILLING REQUIRED FOR WORK PERFORMED UNDER THIS DIVISION OF THE

CONDUIT ALL ELECTRICAL WIRING SHALL BE INSTALLED IN RACEWAY. RACEWAY SHALL BE UL LISTED AND MAY CONSIST OF RIGID GALVANIZED STEEL (RGS), ELECTRICAL METALLIC TUBING (EMT), FLEXIBLE METAL CONDUIT (FMC), METAL CLAD NQO. OR APPROVED EQUAL CUTLER HAMMER/EATON OR SIEMENS EQUIPMENT WITH VOLTAGE, SIZES AND RATINGS AS CABLING (MC), POLYVINYL CLORIDE (PVC), HIGH DENSITY POLYETHELENE (HDPE) CABLE IN CONDUIT (CIC) TYPE, OR SURFACE METAL RACEWAY (SMR).

- APPLICATIONS UNLESS NOTED OTHERWISE ON PLANS OR AS REQUIRED BY THE NEC:
- RGS MAY BE USED IN ALL AREAS. EMT - MAY NOT BE USED.
- FMC SHALL BE USED FOR FINAL CONNECTIONS TO MECHANICAL EQUIPMENT NOT TO EXCEED 36" (LIQUIDTIGHT FOR OUTDOOR CONNECTIONS). FMC - MAY NOT BE USED.
- PVC UNDERGROUND INSTALLATIONS SHALL UTILIZE SCHEDULE 40 PVC CONDUIT. MC - MAY NOT BE USED.

WHERE THE CONDUIT ENTERS OUTLET BOXES, OR FIXTURES, FIRMLY FASTEN TO THE ENCLOSURE WITH LOCKNUTS OR OTHER APPROVED CONNECTOR, BUSHINGS MUST BE INSTALLED OR PART OF THE APPROVED CONNECTOR AND STRAP OR OTHERWISE SUPPORT CONDUIT AS REQUIRED. ALL EMPTY CONDUIT SYSTEMS SHALL HAVE 200 LB. TEST PULL CORD WITH OPPOSITE-END MARKINGS TO FACILITATE INSTALLATION OF FUTURE WIRE.

WHERE PVC IS INSTALLED, ALL FITTINGS SHALL BE UL APPROVED AND WITH CEMENTED JOINTS. UNDERGROUND HDPE SHALL BE A CONTINUOUS RUN.

WHERE METALLIC CONDUIT WILL COME IN CONTACT WITH EARTH, COVER WITH POLYETHYLENE TAPE SPIRAL WRAPPED AND OVERLAPPED TO PROVIDE A DOUBLE THICKNESS. TAPE SHALL BE SCOTCH NO. 50 TAPE OR EQUAL. CONDUITS SHALL BE RUN MINIMUM OF 24" BFG.

MINIMUM METALLIC CONDUIT SIZE FOR HOMERUNS SHALL BE 3/4". MINIMUM CONDUIT SIZE FOR UNDERGROUND PVC RUNS SHALL BE 1", U.N.O.

OUTLET. PULL AND JUNCTION BOXES

INSIDE THE CROW'S NEST EACH SWITCH: LIGHT, RECEPTACLE OR OTHER OUTLET SHALL BE PROVIDED WITH A CODE GAUGE, GALVANIZED STEEL OUTLET BOX. JUNCTION BOXES SHALL BE CODE GAUGE, GALVANIZED STEEL. OUTLET BOXES SHALL BE OF THE ONE PIECE, KNOCKOUT TYPE, IN GENERAL 4" SQUARE WITH PLASTER RING. PLASTER RINGS SHALL BE SET TO PROVIDE NOT MORE THAN 1/8" FROM WALL SURFACE TO RING. IN NO CASE SHALL PLASTER RING PROJECT BEYOND SURFACE OF WALL. ALL OUTLET BOXES SHALL BE FLUSH EXCEPT WHERE SHOWN OR NOTED OTHERWISE. ALL OUTLET BOXES SHALL BE PROTECTED FROM ENTRANCE OF FOREIGN MATERIALS DURING THE CONSTRUCTION PERIOD.

EACH JUNCTION BOX OUTSIDE SHALL BE A FS OR SIMILAR SURFACE PVC OR METALLIC ENCLOSURE WITH GASKETED SEALS. UNDER CANOPY DECK BOXES MAY BE NEMA 3R OR NEMA 4 STEEL GASKETED TO PREVENT TO PREVENT WATER ENTRY FROM ABOVE.

<u>CONDUCTORS</u>

OUTDOORS

UNLESS OTHERWISE SPECIFIED, ALL WIRE SHALL BE TYPE THWN/THHN AS APPROPRIATE FOR THE APPLICATION. ALL WIRING SHALL BE COPPER UNLESS NOTED OTHERWISE. THE WIRES SHALL BE MARKED WITH COLOR TO SIMPLIFY CIRCUIT IDENTIFICATION. UNLESS OTHERWISE REQUIRED BY LOCAL ORDINANCES, GROUND WIRES SHALL BE GREEN, NEUTRAL SHALL BE WHITE OR GRAY AND HOT SHALL BE BLACK (PHASE A), RED (PHASE B). OR BLUE (PHASE C). NEUTRAL CONDUCTOR SHALL BE WHITE, COLOR CODED TO THE CORRESPONDING HOT CONDUCTOR, AT EVERY JUNCTION, PULL, OR TERMINATION. THE WIRE SHALL BE A MINIMUM OF #12 AWG UNLESS OTHERWISE INDICATED. WIRES SHALL BE SIZED AT THE LARGER OF THE NEC REQUIREMENT OR THAT SPECIFIED BY PLAN. EACH BRANCH CIRCUIT SHALL HAVE A SEPARATE NEUTRAL UNLESS EXPLICITLY SPECIFIED ON PLAN AND FED BY A MULTI-POLE CIRCUIT BREAKER WITH A HANDLE-TIE. ALL CONDUITS TO HAVE A SEPARATE GROUNDING CONDUCTOR.

NO WIRE SHALL BE INSTALLED IN THE CONDUIT SYSTEM UNTIL THE CONDUIT SYSTEM IS COMPLETE.

IN GENERAL, NUMBER OF CONDUCTORS INDICATED ON THE DRAWINGS DOES NOT INCLUDE THE GROUND CONDUCTOR UNLESS SPECIFICALLY NOTED. WHERE GROUND CONDUCTORS ARE SPECIFIED OR REQUIRED, CONDUIT SIZES SHALL BE INCREASED AS NECESSARY TO MEET NEC CONDUIT FILL REQUIREMENTS.

WIRING DEVICES

SWITCHES: MANUAL ON/OFF WALL SWITCHES SHALL BE COMMERCIAL GRADE AC SILENT TYPE SWITCHES 20A, 120V, COLOR TO MATCH EXISTING.

DIMMABLE SWITCHES TO BE MATCHED TO SELECTED LAMPING SYSTEM SOURCES. SEE PLANS.

GFCI RECEPTACLES: SHALL BE SPECIFICATION GRADE, DUPLEX TYPE, NEMA 5-20R, 20 AMPERE, 120 VOLT, GROUNDED TYPE, BLACK IN COLOR. SPECIAL APPLICATION RECEPTACLES SHALL BE AS INDICATED ON PLANS.

WEATHERPROOF RECEPTACLES (WP) W/IN-USE COVERS: SHALL BE VERTICAL MOUNT LEVITON 5976-DGY. INTERMATIC NP-1000RC OR EQUAL WITH A WEATHER-RESISTANT GET RECEPTACLE. WHERE SUBJECT TO DAMAGE, A METALLIC BOX SHALL BE USED.

LIGHTING FIXTURES

THE EC SHALL RECEIVE, INSTALL, AND CONNECT LIGHT FIXTURES FURNISHED BY OWNER AS INDICATED ON THE DRAWINGS. THE CONTRACTOR SHALL ALSO COMMISSION THE LIGHT FIXTURES.

VERIFY CONSTRUCTION AND FIXTURE VOLTAGE BEFORE ORDERING OR INSTALLING FIXTURES.

SAFETY SWITCHES

SAFETY SWITCHES, UNLESS OTHERWISE INDICATED ON THE DRAWINGS, SHALL BE HEAVY DUTY TYPE, 250 VOLT, QUICK-MAKE, QUICK-BREAK, HORSEPOWER RATED, NEMA-1 ENCLOSURE OF THE NUMBER OF POLES REQUIRED. THE SWITCH SIZE SHALL BE AS REQUIRED BY CODE AND AS INDICATED ON THE DRAWINGS. WHERE OUTSIDE THE BUILDING. THE SWITCHES SHALL BE RAIN-TIGHT TYPE NEMA 3R ALL SWITCHES SHALL BE LOCKABLE.

MOTORS SHALL BE PROTECTED BY DUAL-ELEMENT FUSES ABLE TO CARRY 500% OF RATING FOR A MINIMUM OF 10 SECONDS, UNLESS NOTED OTHERWISE, MOTOR FUSING SHALL BE SIZED AT 125% OF NAME PLATE RATING. FUSES SHALL BE OF THE TYPE, SIZE, AND RATING AS SCHEDULED ON THE DRAWINGS. ALL FUSES SHALL BE BUSSMAN-FUSETRON, FRN (250V), OR EQUAL. VERIFY FUSE AND SWITCH REQUIREMENTS WITH THE EQUIPMENT SUPPLIED.

PANELBOARDS

CIRCUIT BREAKER TYPE PANELBOARDS SHALL HAVE COPPER BUSS AND BE GENERAL ELECTRIC NLTQ, SQUARE D TYPE INDICATED ON DRAWINGS. PANELBOARDS SHALL BE RATED 120/208V, 3 PHASE, AND BE DEAD FRONT CONSTRUCTION, NO KNOCKOUTS WITH KEY LOCKED DOORS. MAIN BREAKERS/BUSS SHALL BE RATED A MINIMUM OF 1.2X THE AVAILABLE FAULT CURRENT OR AS INDICATED ON THE PANEL SCHEDULES/OR RISER DRAWINGS.

THE CIRCUIT BREAKERS SHALL BE OPERABLE IN ANY POSITION AND BE REMOVABLE FROM THE FRONT OF THE PANELBOARD WITHOUT DISTURBING THE ADJACENT UNITS, BRANCH BREAKERS SHALL BE OF SUCH DESIGN THAT COMBINATION OF SINGLE-POLE, DOUBLE-POLE AND THREE-POLE BREAKERS CAN BE ASSEMBLED ON THE SAME PANEL. EACH BRANCH CIRCUIT SHALL BE CLEARLY NUMBERED AND PLACED PER THE PANEL SCHEDULES. BRANCH AND MAIN TERMINALS SHALL BE OF THE SOLDERLESS TYPE. HANDLE TIES TO FORM MULTI-POLE BREAKERS ARE NOT ACCEPTABLE UNLESS UL APPROVED FOR THE ASSOCIATED BREAKERS. CIRCUIT BREAKERS SHALL BE THE BOLT ON TYPE WITH MIN. 12,000 AIC RATING AND MAY BE SERIES RATED PER MANUFACTURER.

PROVIDE A TYPEWRITTEN CIRCUIT INDEX BEHIND CLEAR PLASTIC COVER ON INSIDE OF DOOR. INFORMATION SHALL INCLUDE ROOM AND TYPE OF LOAD SERVED. ALL CIRCUIT BREAKERS SHALL BE IDENTIFIED, INCLUDING SPARES. INDEX CARD FRAME SHALL BE METAL, SECURED TO DOOR. BREAKERS SHALL BE INSTALLED IN THE POSITION INDICATED ON SCHEDULES.

PANELS LOCATED OUTDOORS SHALL BE SURFACE-MOUNTED WITHIN A NEMA 3R ENCLOSURE WITH ALL PENETRATIONS LOCATED ON THE BOTTOM OF THE PANEL.

MOTOR WIRING

ALL MOTORS SHALL BE WIRED TO CONFORM WITH MANUFACTURERS' RECOMMENDATIONS AND WITH APPLICABLE CODES. FURNISH NECESSARY MATERIALS, SUCH AS WIRE, CONDUIT, FITTINGS, ETC. REQUIRED BY THE SUPPLIER OF THE DRIVEN EQUIPMENT. VERIFY EQUIPMENT LOCATION AND SIZES WITH THE TRADE SUPPLYING THE MOTOR BEFORE INSTALLING THE CONDUIT OR OUTLETS.

TELEPHONE/DATA/TV RACEWAY SYSTEM TELEPHONE/DATA/TV OUTLETS LOCATED OUTDOORS SHALL CONSIST OF A STANDARD NEMA 3R, 6"x6" BOXES MOUNTED 18" ABOVE THE GROUND. INSTALL A 3/4" PVC/GRC CONDUIT SHALL BE RATED FROM THE EQUIPMENT/OUTLET TO THE CROW'S NEST.

ALL WIRING SHALL BE CONCEALED WITHIN RACEWAYS OR BUILDING CONSTRUCTION, FISHED AS REQUIRED.

TELEPHONE/DATA WIRING/CONNECTIVITY PROVIDE 1.2.3 OR 4 COMM-JACKS AND WIRING FROM OUTLET TO THE CROW'S NEST, EACH DATA/TELEPHONE CABLE/COMPONENT SHALL BE CATEGORY 5, CERTIFIABLE TO 350 MHZ OSP RATED AND RATED FOR DIRECT BURIAL. ALL WIRING SHALL BE CONCEALED WITHIN RACEWAYS OR BUILDING CONSTRUCTION, FISHED AS REQUIRED.

GUARANTEE

GUARANTEE ALL MATERIAL FURNISHED AND ALL WORKMANSHIP PERFORMED FOR A PERIOD OF ONE YEAR FROM THE DATE OF FINAL ACCEPTANCE OF THE WORK. ANY DEFECTS DEVELOPING WITHIN THIS PERIOD, TRACEABLE TO MATERIAL FURNISHED AS A PART OF THIS SECTION OR WORKMANSHIP PERFORMED HERE UNDER, SHALL BE REPLACED, REPAIRED OR ALTERED AT NO EXPENSE TO THE OWNER.

SHOP DRAWINGS AND APPROVALS THE ITEMS SPECIFIED HEREIN AND ON DRAWINGS ARE USED AS A STANDARD OF QUALITY. ANY MATERIALS OF EQUAL QUALITY AND AESTHETIC VALUE WILL BE GIVEN CONSIDERATION AS A SUBSTITUTE FOR THE MATERIALS SPECIFIED. SUBMITTALS FOR PRIOR APPROVAL WILL BE ACCEPTED NO LESS THAN 3 DAYS. THE DECISION OF THE ARCHITECT AND/OR ENGINEER, DETERMINING EQUAL MATERIALS, WILL BE FINAL.

THE CONTRACTOR SHALL SUBMIT TWO (2) IDENTICAL BOUND SETS OF SHOP DRAWINGS. SHOP DRAWING SUBMITTALS SHALL INCLUDE MANUFACTURER'S NAME AND ADDRESS, EQUIPMENT OR MATERIAL DESCRIPTIVE NAMES AND CATALOG NUMBER. SHOP DRAWINGS SHALL INDICATE DIMENSIONS, VOLTAGE, AND CURRENT CHARACTERISTICS, WIRE SIZES, TEST AND CONFORMANCE DATA, CONSTRUCTION AND ROUGH-IN DATA OF ALL MATERIALS TO BE USED. SHOP DRAWINGS SHALL BE PROVIDED FOR, BUT NOT LIMITED TO, THE FOLLOWING LIST OF EQUIPMENT: a. WIRING DEVICES b. PANELBOARDS c. LIGHT FIXTURES

OPERATING AND MAINTENANCE MANUALS

AT COMPLETION OF THIS PROJECT, SUBMIT (2) SETS ELECTRICAL EQUIPMENT OPERATING AND MAINTENANCE MANUALS, INCLUDING PARTS LISTS, BOUND IN HARD COVERED MANUALS. MANUALS SHALL BE LABELED WITH LOCAL SUPPLIER'S CONTACT INFORMATION. INFORMATION NOT DEFINITELY APPLYING TO THESE PARTICULAR PIECES OF EQUIPMENT SHALL BE CROSSED OUT.


PROJECT RECORD DRAWINGS


CONTRACTOR SHALL MAINTAIN A SET OF RECORD AS-BUILT DRAWINGS AT THE JOB SITE, RECORDING ANY CHANGES OR DEVIATIONS FROM THE CONTRACT DRAWINGS AS WORK PROGRESSES AND AVAILABLE FOR INSPECTION BY THE ENGINEER, ARCHITECT OR OWNER AT ANY TIME. UPON COMPLETION OF WORK, UP-TO-DATE AS-BUILT DRAWINGS SHALL BE SUBMITTED TO THE ENGINEER


CONSTRUCTION TESTING


1. APPROVED FINAL INSPECTION REPORTS FROM BUILDING OFFICIALS.

UPON COMPLETION, SUBJECT WORK TO SUCH TESTS AS ARE REQUIRED UNDER INDUSTRY STANDARDS AND/OR SPECIFIED HEREIN. PERFORM TESTS TO DEMONSTRATE PROPER FUNCTIONING OF ALL EQUIPMENT AND DEVICES. TESTS SHALL BE RECORDED AND THE REPORTS SUBMITTED TO THE ENGINEER, INCLUDING:

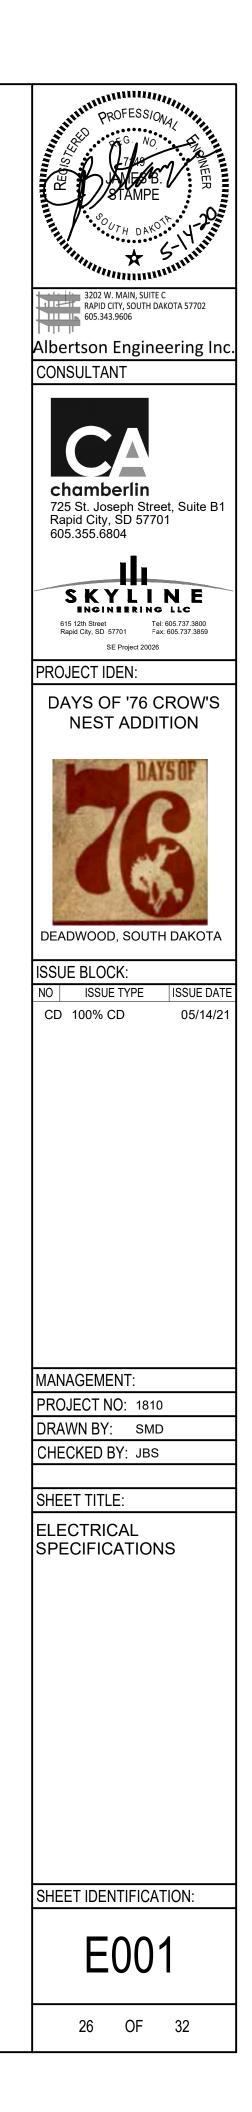

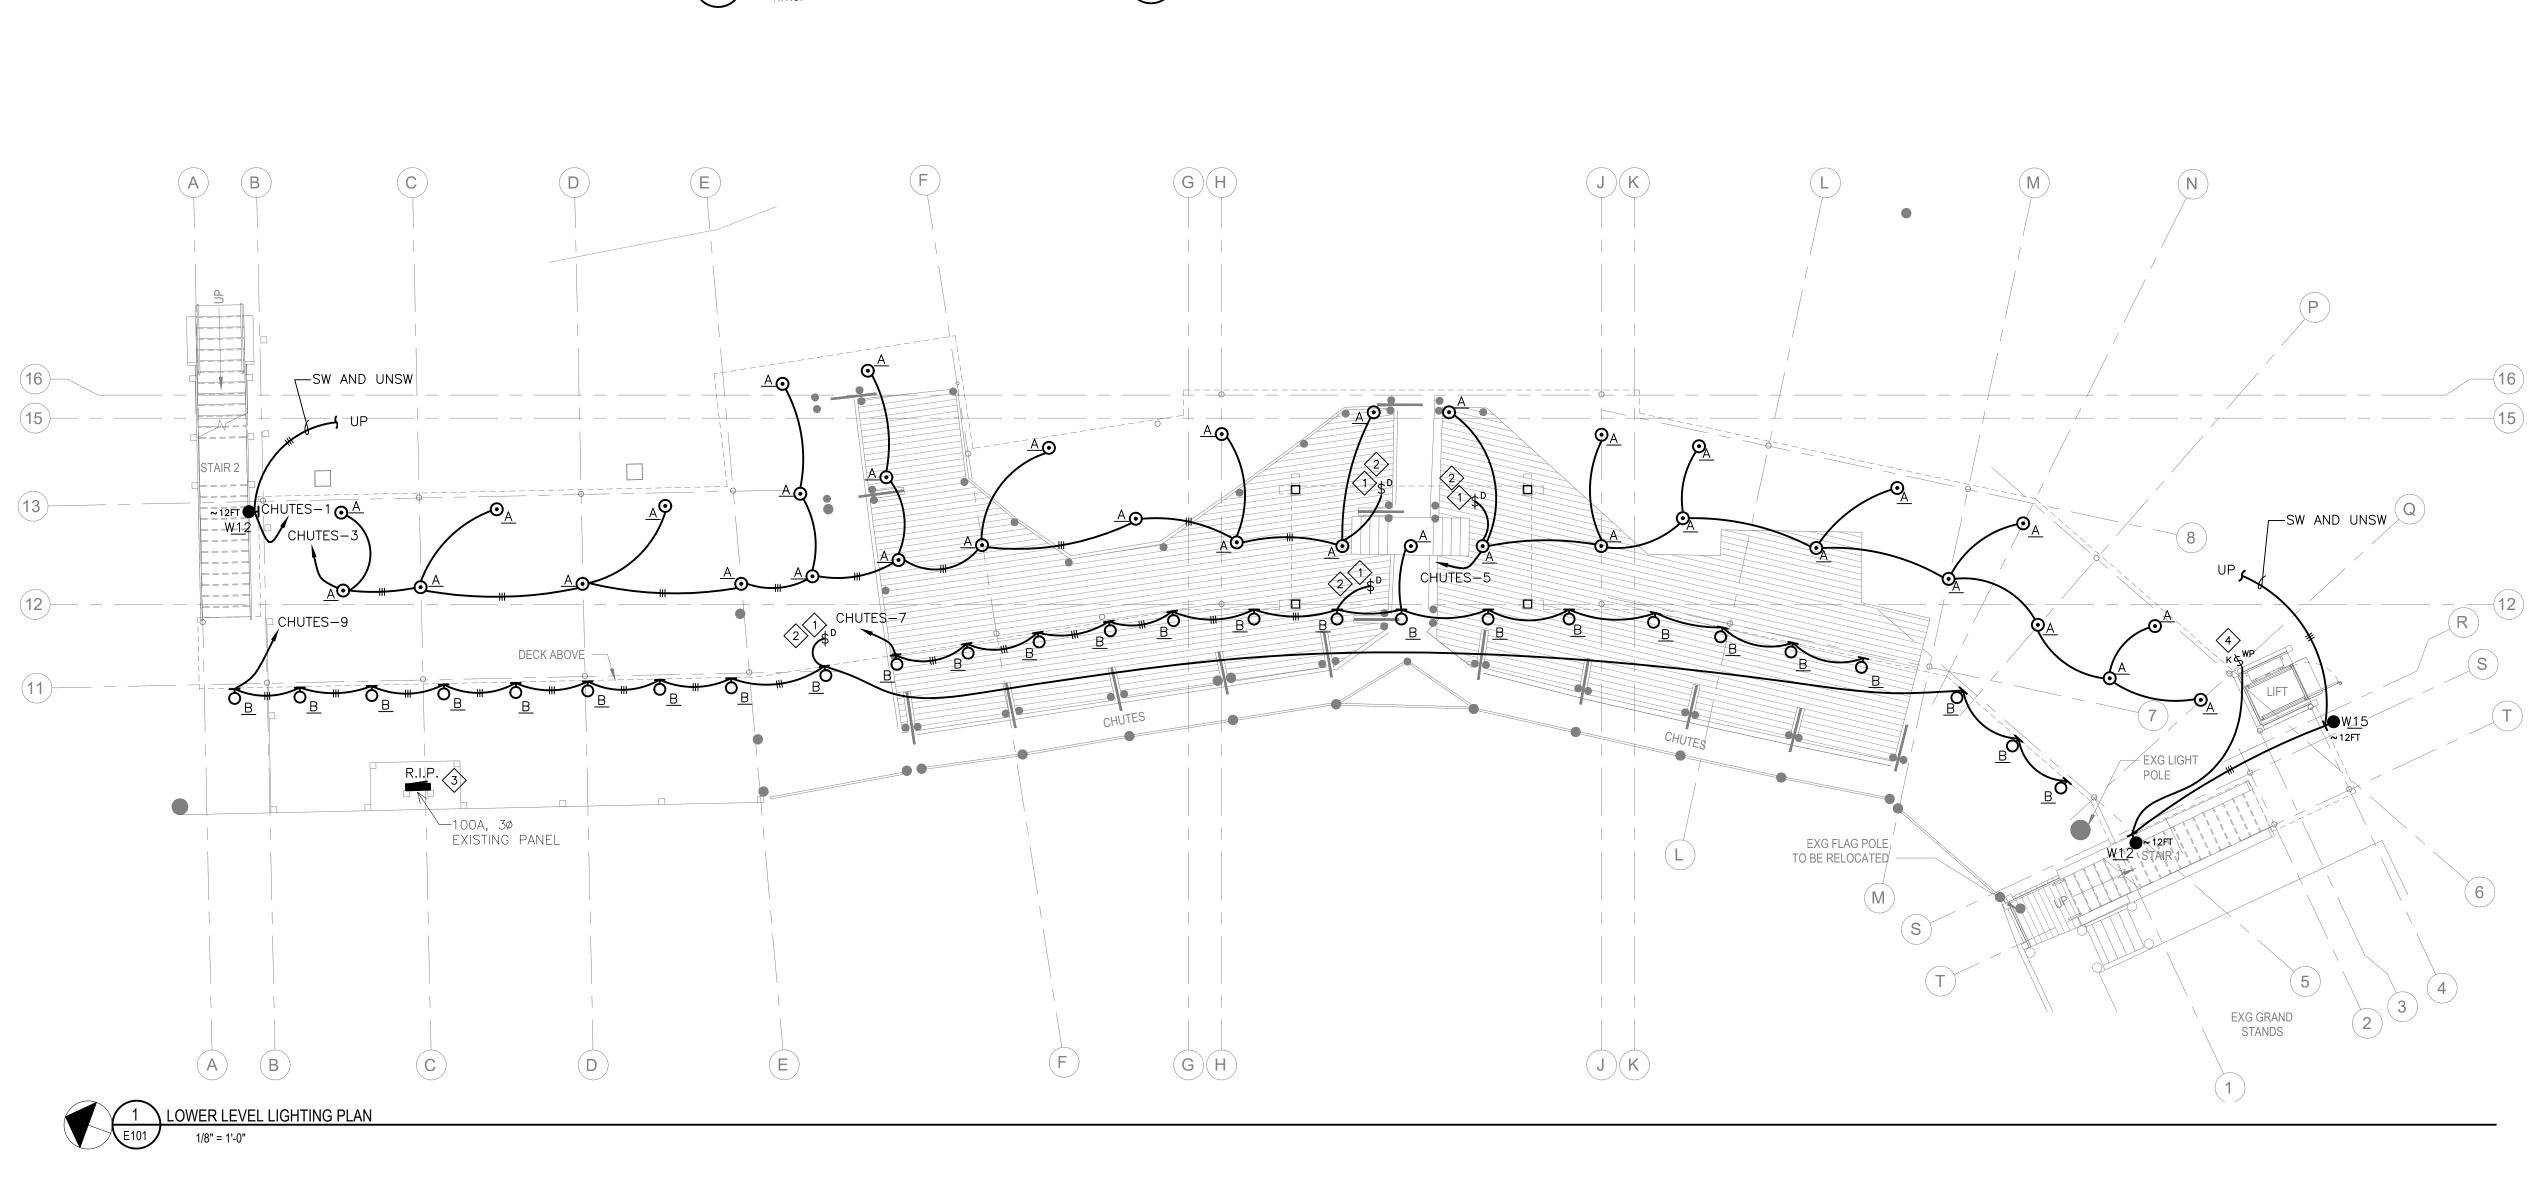


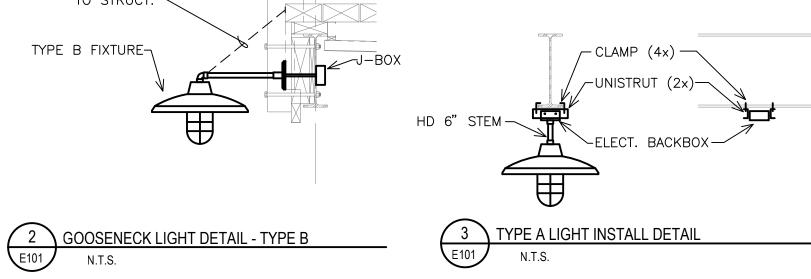

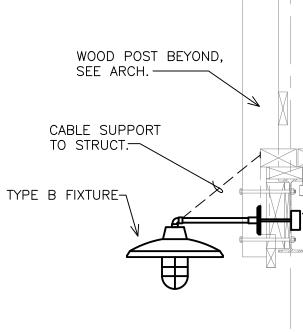


GENERAL NOTES (THIS SHEET ONLY)

- A. COORDINATE LOCATIONS OF LIGHT FIXTURES WITH ARCHITECTURAL PLANS, ELEVATIONS AND DETAILS.
- B. CONTRACTOR TO COORDINATE INSTALLATION WITH EXISTING CONDITIONS AND OTHER TRADES.
- C. NEUTRAL CONDUCTOR REQUIRED TO EACH LIGHT SWITCH BOX CODE.
- D. EXISTING CIRCUITING OR DEVICES SHOWN IS DERIVED FROM ON-SITE OBSERVATION AND RECORD DRAWINGS. EC SHALL CONFIRM.

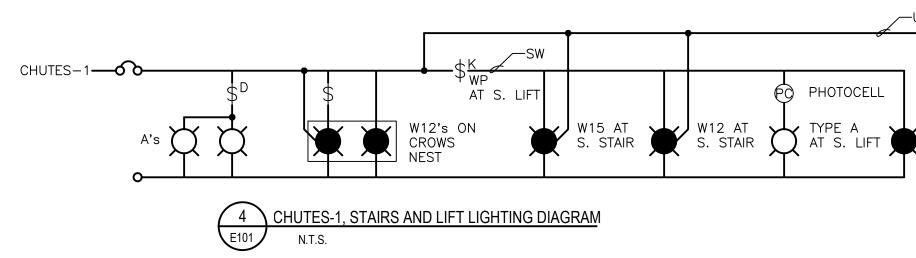


KEYED NOTES (THIS SHEET ONLY)

- LOCATE SWITCH IN CROWS NEST AS DIRECTED BY OWNER. SEE DETAIL. DIMMER SWITCHES FOR TAPE LIGHT FIXTURES SHALL BE LUTRON DVEL-300P.
- FENCE TO BE REWORKED TO MAKE PANEL ACCESSIBLE.
- KEYED WP SWITCH AS OVER-RIDE OFF FOR STAIRS 1 AND 2, W15 FIXTURE AND TYPE A FIXTURE OVER THE LIFT. SEE DETAILS.

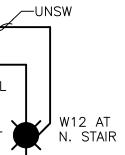


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cho 725 S Rapid 605.3	City, SD 57701 Fax. SE Project 20026	1 NEE 605.737.3800 605.737.3859
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- 450-WATT LED LEVITON DIMMER, MODEL DSM10-ILZ AS LISTED COMPATIBLE WITH SATCO A-21 LED AS LAMP, MODEL S8735. DIMMERS SHALL PROVIDE SMOOTH AND FLICKER-FREE CONTROL FROM 25% TO
- TO EXTENT POSSIBLE, PROVIDING WIRING/CONTROLS
- 5 PROVIDE AN OVER-RIDER OFF SWITCH TO SHUT OFF FIXTURES BACK ON, POWERED FROM THE INTEGRAL
- 6 INSTALL ON SLOPED STRUCTURE VIA BLACK PAINTED

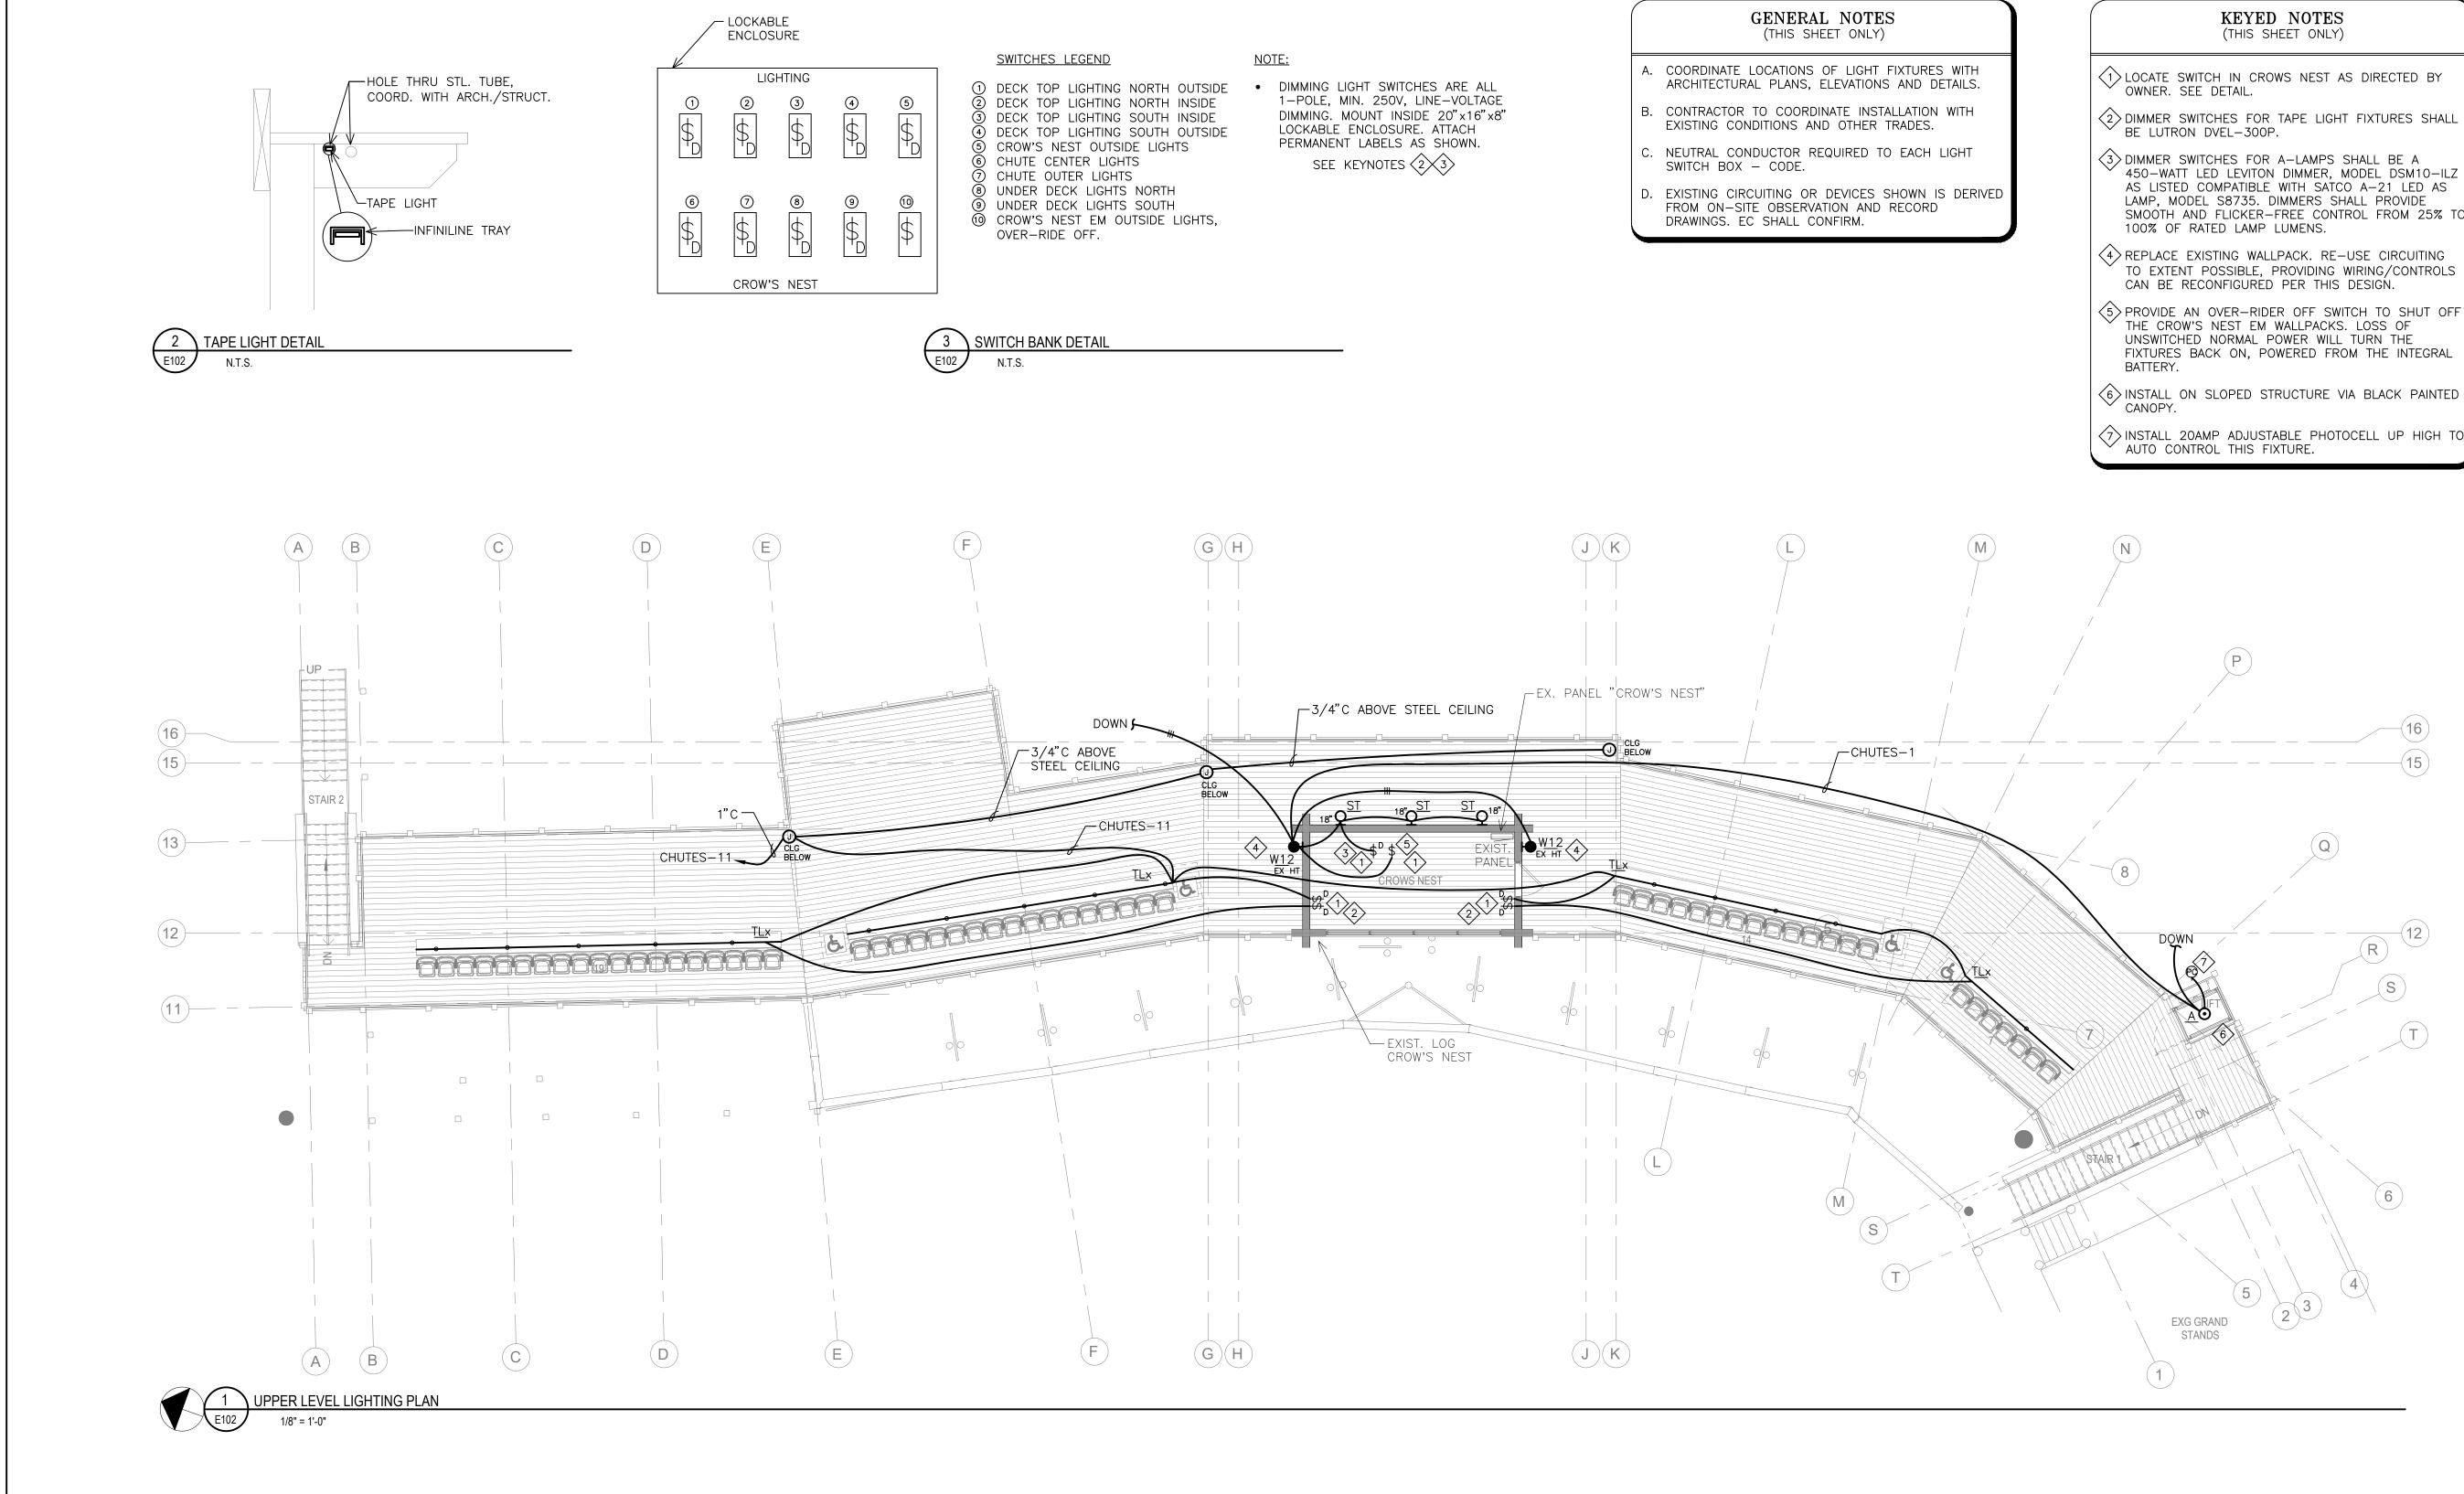T INSTALL 20AMP ADJUSTABLE PHOTOCELL UP HIGH TO

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Albertson Engineering Inc
chamberlin
725 St. Joseph Street, Suite B1 Rapid City, SD 57701 605.355.6804
SKYLINE INGINERING LLC 615 12th Street Tel: 605.737.3800
Rapid City, SD 57701 Fax: 605.737.3859 SE Project 20026
PROJECT IDEN: DAYS OF '76 CROW'S
NEST ADDITION
DAYSOF
-
DEADWOOD, SOUTH DAKOTA
ISSUE BLOCK: NO ISSUE TYPE ISSUE DATE
CD 100% CD 05/14/21
MANAGEMENT:
PROJECT NO: 1810
DRAWN BY: SMD CHECKED BY: JBS
SHEET TITLE:
UPPER LEVEL -
LIGHTING PLAN
SHEET IDENTIFICATION:
E102
28 OF 32




GENERAL NOTES (THIS SHEET ONLY)

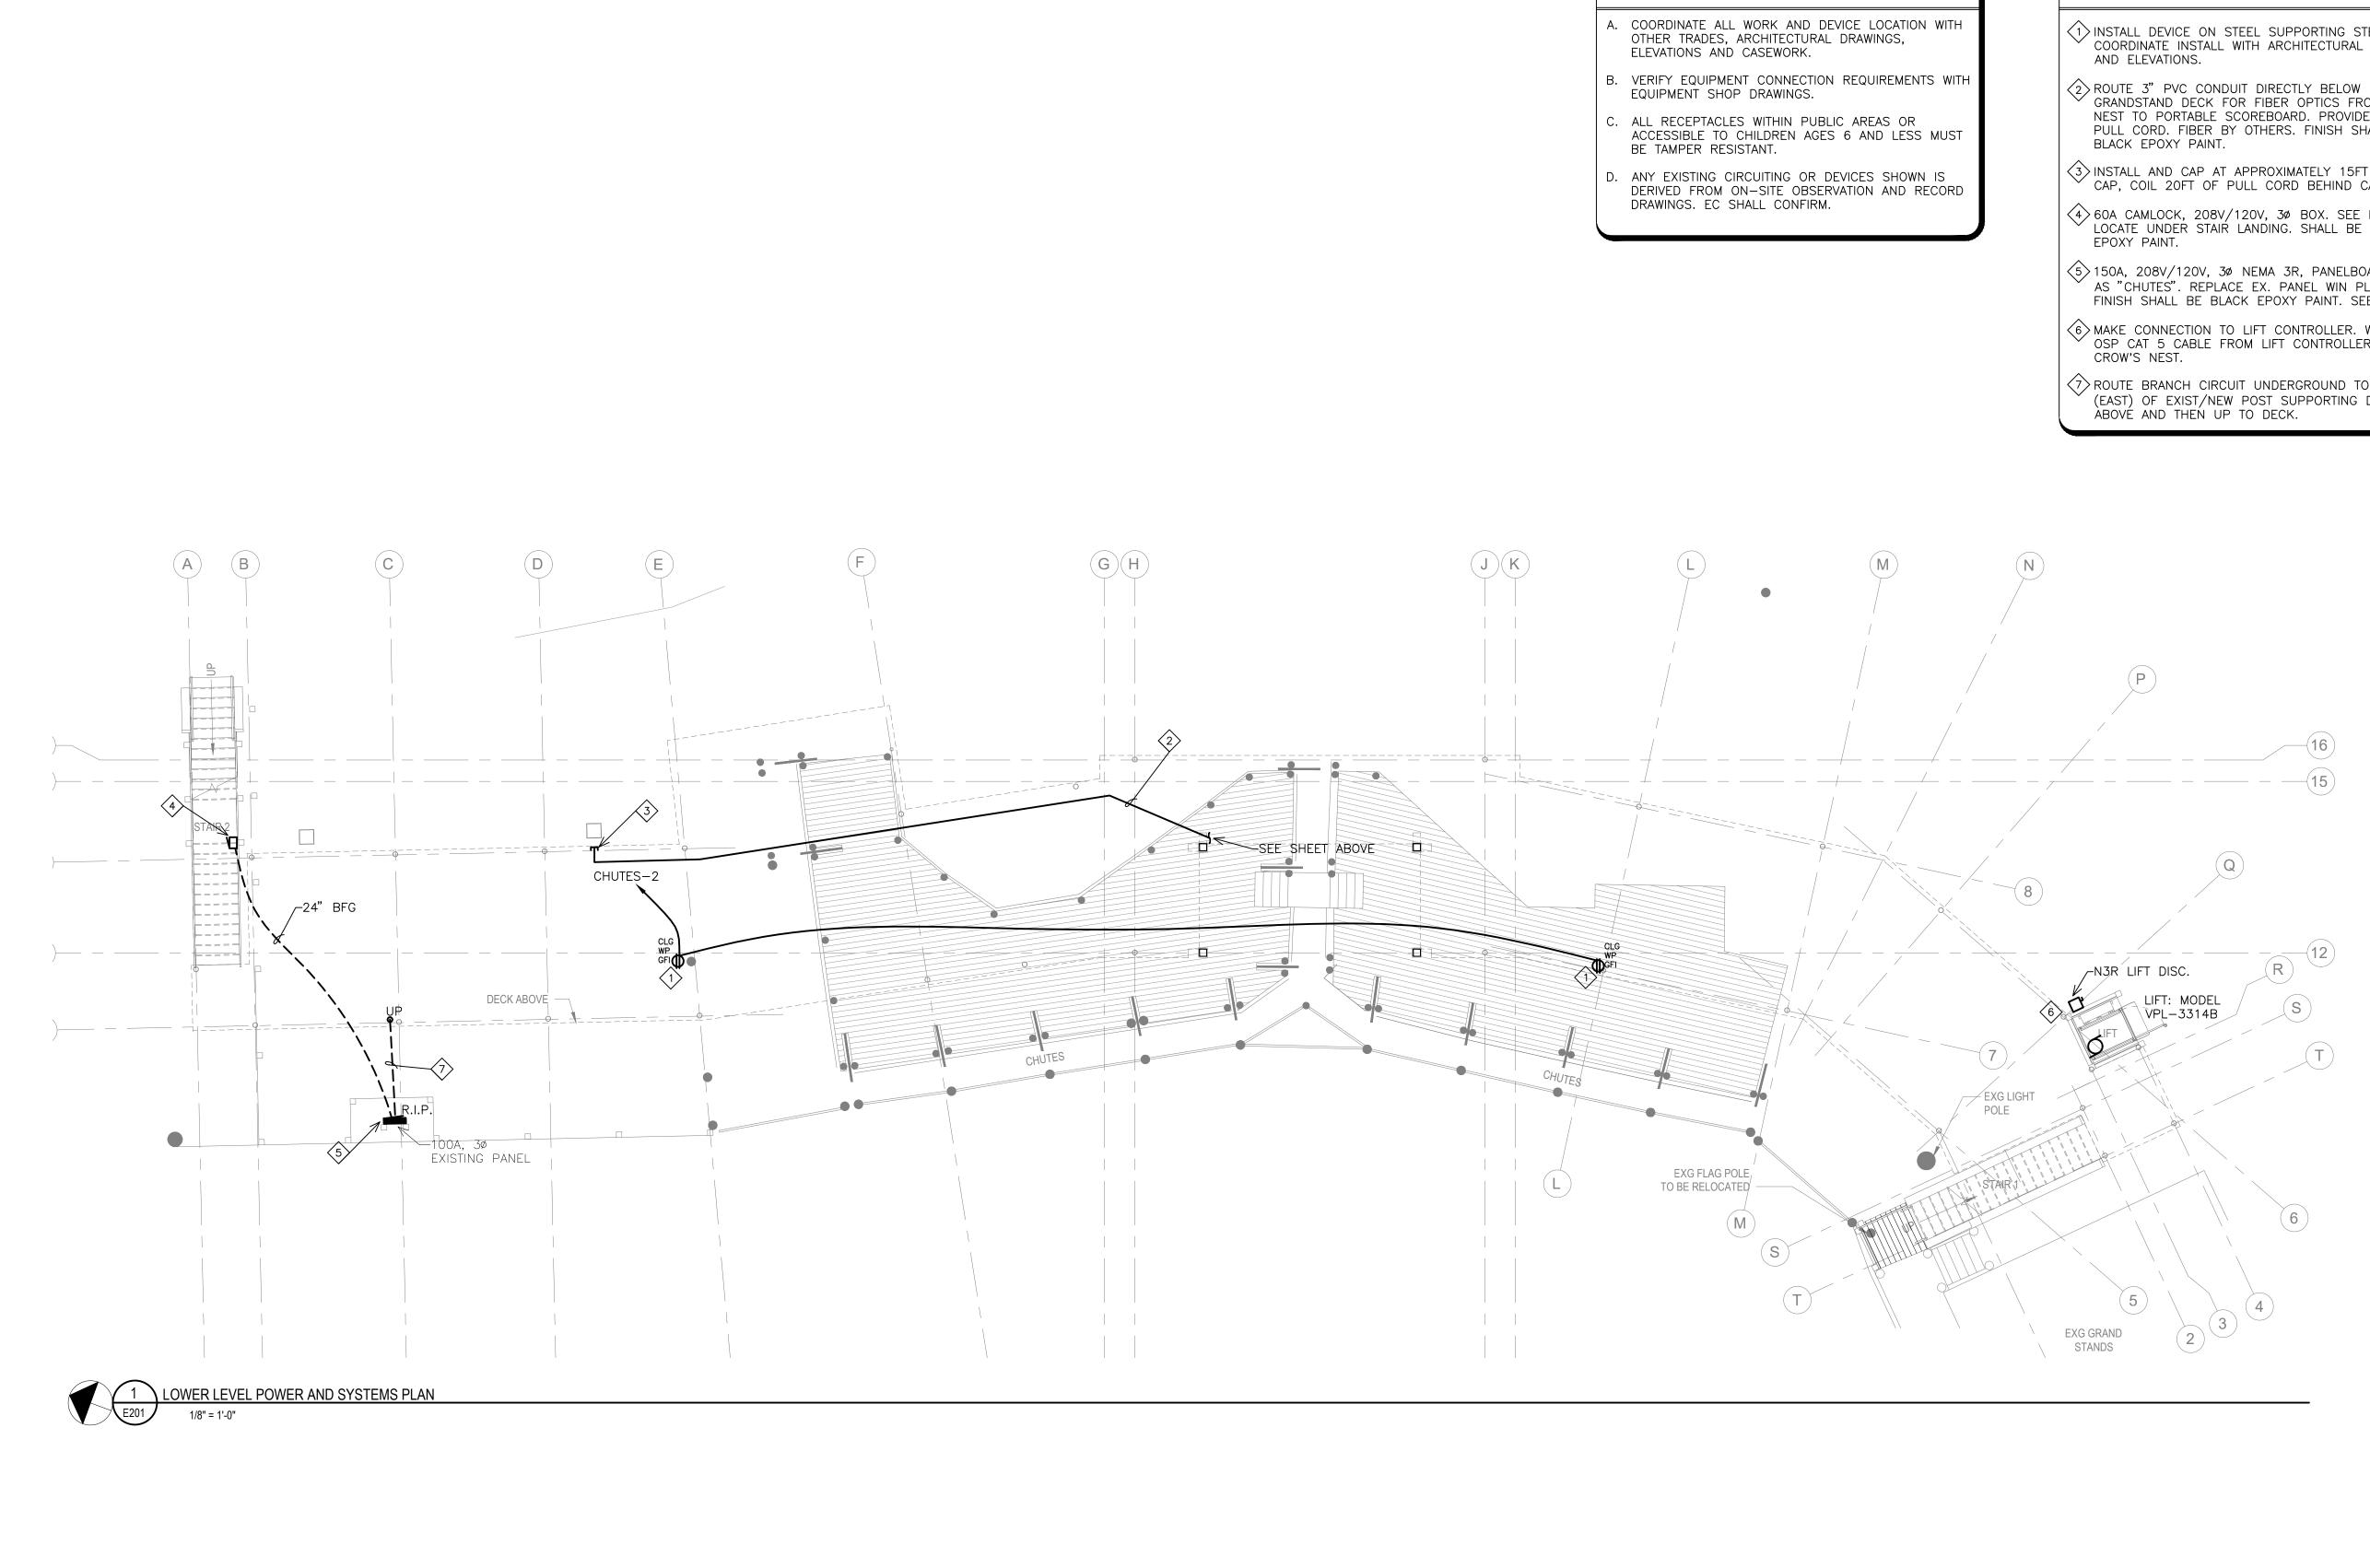
KEYED NOTES (THIS SHEET ONLY)

- INSTALL DEVICE ON STEEL SUPPORTING STEEL DECK. COORDINATE INSTALL WITH ARCHITECTURAL DETAILS
- GRANDSTAND DECK FOR FIBER OPTICS FROM CROWS NEST TO PORTABLE SCOREBOARD. PROVIDE A 200LB PULL CORD. FIBER BY OTHERS. FINISH SHALL BE
- (3) INSTALL AND CAP AT APPROXIMATELY 15FT AFG. CAP, COIL 20FT OF PULL CORD BEHIND CAP.
- 60A CAMLOCK, 208V/120V, 3Ø BOX. SEE RISER. LOCATE UNDER STAIR LANDING. SHALL BE BLACK
- 5 150A, 208V/120V, 30 NEMA 3R, PANELBOARD. NAME AS "CHUTES". REPLACE EX. PANEL WIN PLACE. FINISH SHALL BE BLACK EPOXY PAINT. SEE RISER.
- $\langle 6 \rangle$ Make connection to lift controller. Wire (1) $m ^{\prime}$ OSP CAT 5 CABLE FROM LIFT CONTROLLER TO $m ^{\circ}$
- TROUTE BRANCH CIRCUIT UNDERGROUND TO BEHIND (EAST) OF EXIST/NEW POST SUPPORTING DECK

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SKYLINE SKYLINE NGINERRING LLC 615 12th Street Rapid City, SD 57701 Fax: 605.737.3859 SE Project 20026
PROJECT IDEN:
DAYS OF '76 CROW'S NEST ADDITION
DEADWOOD, SOUTH DAKOTA
ISSUE BLOCK: NO ISSUE TYPE ISSUE DATE
CD 100% CD 05/14/21
PROJECT NO: 1810 DRAWN BY: SMD
CHECKED BY: JBS
SHEET TITLE:
LOWER LEVEL - POWER AND
SYSTEMS PLAN
SHEET IDENTIFICATION:
E201
29 OF 32

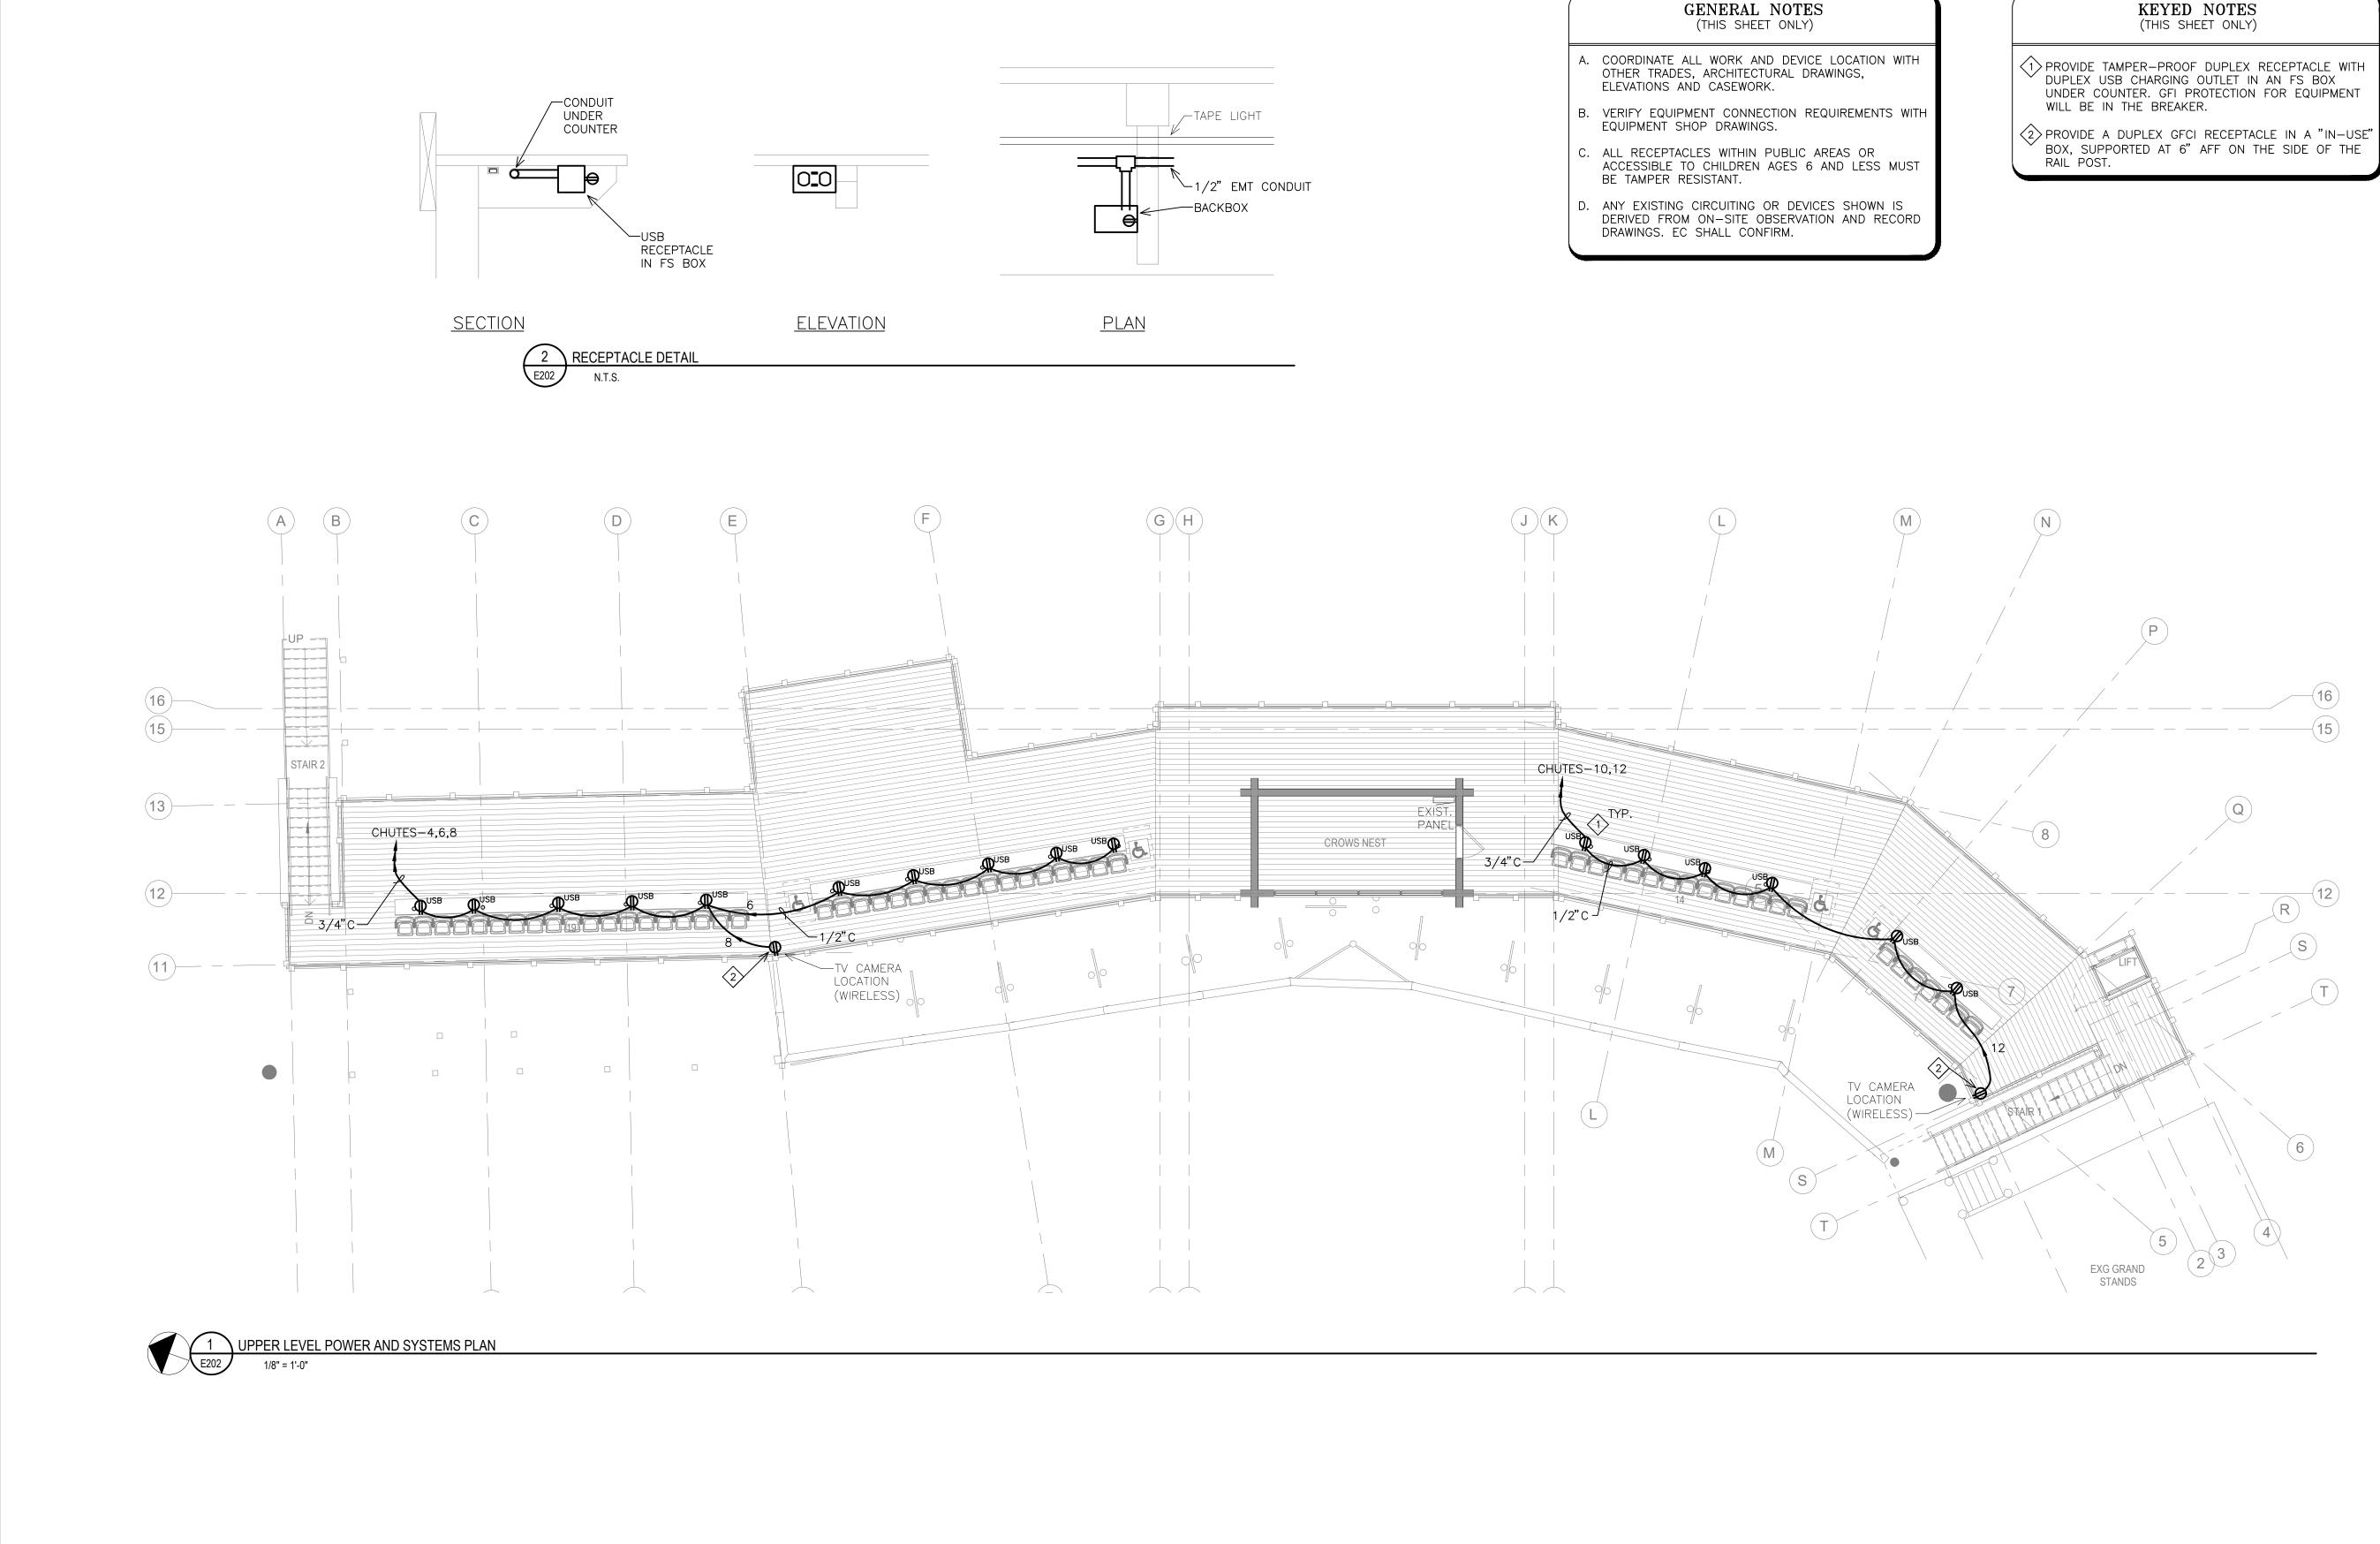

KEYED NOTES

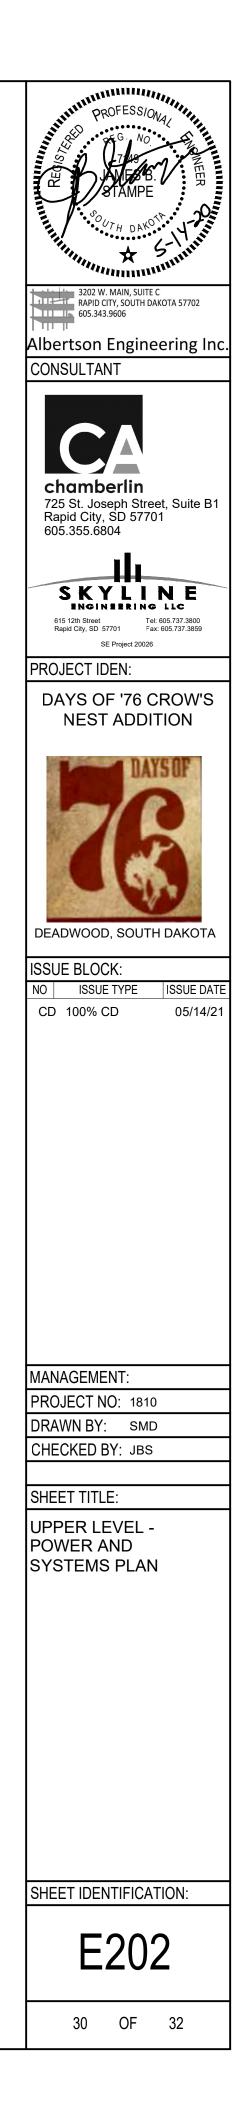

FIXTURE TYPE	FIXTURE DESCRIPTION (FEATURES)	VOLTS	MOUNTING	LAMPS	CONTROL MEDIA: LENS, LO ETC.
A	STEM MOUNT PENDANT FIXTURE WITH LED LAMP, E26 BASE	UNIVERSAL	6" STEM, HEAVY DUTY	2700K, DIMMABLE 20W LED LAMP EQUAL TO SATCO S8735	WIRE GUARD AND CLEAR (
В	GOOSENECK MOUNTED WITH LED LAMP, E26 BASE	UNIVERSAL	GOOSENECK BRACKET	2700K, DIMMABLE 20W LED LAMP EQUAL TO SATCO S8735	WIRE GUARD AND CLEAR (
TLx	LED STRIP LIGHT, VERIFY LENGTH IN FIELD	UNIVERSAL	MOUNTING CHANNEL, SATIN BLACK	INTEGRAL LED, 3000K	DIMMABLE, OUTDOOR/WET LO RATED STRIP LIGHT
	LED STEP LIGHT FIXTURES				
ST	LED STEP LIGHT, ENCAPSULATED	120V	STANDARD BACKBOX	INTEGRAL LED, 3000K	DIMMABLE, OUTDOOR/WET LO RATED STEP LIGHT
	LED WALLPACKS AND SOFFIT FIXTURES				
W12	2000 LUMENS, LOW-PROFILE WALL PACK, FULL CUTOFF, LED, TYPE III DISTRIBUTION, INTEGRAL 4K SURGE PROTECTION, INTEGRAL PHOTO CELL, EM BATTERY PACK	120/277	WALL/SURFACE	INTEGRAL LED, 3000K	DIE-CASE ALUMINUM HOUSING DISTRIBUTION, B1-U0-G1 BUG COMFORT SCHIELD, BUTTO PHOTOCONTROL
W15	4000 LUMENS, LOW-PROFILE WALL PACK, FULL CUTOFF, LED, TYPE II DISTRIBUTION, INTEGRAL 4K SURGE PROTECTION, INTEGRAL PHOTO CELL, EM BATTERY PACK	120/277	WALL/SURFACE	INTEGRAL LED, 3000K	DIE-CASE ALUMINUM HOUSING DISTRIBUTION, B1-U0-G1 BUG BUTTON TYPE PHOTOCON
GENERAL NOTES	<u> </u>				
	SAME TYPE MUST BE FROM THE SAME MANUF	ACTURER.			

D. ALL FIXTURES TO BE 120/277V UNLESS NOTED AS ONE VOLTAGE. ALL FIXTURES/LAMPS TO BE 2700k OR 3000K +/- 5%. All PROPOSED EQUALS MUST HAVE ESSENTIALLY EQUAL OPTICS/PATTERN.

E. THE MANUFACTURER AND CATALOG NUMBER LISTED FOR ALL FIXTURES IS THE BASIS OF DESIGN (BOD). ANY PRIOR APPROVALS MUST BE COMPAIRED TO THE BOD FIXTURE.

SPECIFIC NOTES:

1. LISTED FOR DAMP LOCATION.

2. LISTED FOR WET LOCATION.


3. CONFIRM MOUNTING BRACKET WITH FIXTURE CUTSHEETS/MANUFACTURER PRIOR TO ORDERING.


4. PROVIDE INFINITE MOUNTING CHANNEL TO SUPPORT THE LED TAPE LIGHT. SECURE AT AN INTERVAL OF NOT MORE THAN 12". IF TAPE IS NOT FIELD CUTTABLE, THE EC MUST SCALE AND ORDER PER ANTICIPATED INSTALLATION. LOW-VOLTAGE CONNECTIONS IS SECURED TO TAPE LIGHT FOR EXTERNAL MOUNTING. SECURE.

	LIGHT	FIXTURE SCHEDULE					
OUVERS,	MFR.	CATALOG NUMBER	FIXTURE COLOR/ FINISH	MIN. FIXTURE CRI	UV LENS OR LAMP COVER	LIGHT LOSS FACTOR (5% TOL.)	D I E
GLASS	BARN LIGHT	MARATHON SERIES: BLE-S-YDM16-100-ST506-100-NA-WGG-100-CLR-HDSMC-E26	POWDER COAT BLACK	84	GLASS	0.95	
GLASS	BARN LIGHT	MARATHON SERIES: BLE-G-YDM16-100-G64-100-NA-WGG-100-CLR-DBPC-E26	POWDER COAT BLACK	84	GLASS	0.95	
LOCATION		INFINILINE BASICS: DI-120V-INFBSC3-30-H-XX-CHA		90+	NONE	0.95	
	PROGRESS LIGHTING	P6832 - 120V	BLACK	80+	NONE	0.95	
	ILLUM SYS - McGRAW EDISON						
NG, TYPE 3 G RATING, ON TYPE	LUMEN FX - LITHONIA MLAZGAR - HUBBELL WYOMING LTG HOLOPHANE LTG	LNC2-12L-3K-035-3-U-BL-PCU-8F-EH-CS	BLACK	70	NONE	0.90	
NG, TYPE 2 G RATING, NTROL	ILLUM SYS - McGRAW EDISON LUMEN FX - LITHONIA MLAZGAR - HUBBELL WYOMING LTG HOLOPHANE LTG	LNC2-18L-3K-070-2-U-BL-PCU-20F-EH	BLACK	70	NONE	0.90	

RTS MUST BE SUBMITTED TO THE ENGINEER AT LEAST 10 DAYS PRIOR TO BID DATE. IF THE SUBMITTED FIXTURE IS DETERMINED NOT TO BE EQUAL OR BETTER BY THE ENGINEER IT WILL NOT BE A

Designed FFTURE EFFICACY WATTS INTO FIXTURE LUMENS OUT OF FIXTURE MMINT REFICACY SPECIFIC NOTES 75 20 2.070 72 1.2.3 75 20 2.070 72 1.2.3 75 20 2.070 72 1.2.3 75 20 2.070 72 1.2.3 80 3.7/FT 270 2.3.4 21 5 59 20 2 107 14 1.350 103 2.3 86 43 3.330 83 2.3	DEALANTE	MAX	MIN.		
75 20 2,070 72 1,2,3 80 3.7/FT 270 2.3,4 21 5 59 20 2 107 14 1,350 103 2,3 86 43 3,330 83 2,3		WATTS INTO	LUMENS OUT OF		SPECIFIC NOTES
80 3.7/FT 270 2.3.4 80 3.7/FT 270 2.3.4 21 5 59 20 2 107 14 1,350 103 2.3	75	20	2,070	72	1,2,3
21 5 59 20 2 21 5 59 20 2 107 14 1,350 103 2,3 86 43 3,330 83 2,3	75	20	2,070	72	1,2,3
107 14 1,350 103 2,3 86 43 3,330 83 2,3	80	3.7/FT	270		2,3,4
86 43 3,330 83 2,3	21	5	59	20	2
	107	14	1,350	103	2,3
T BE APPROVED BY ADDENDUM.	86	43	3,330	83	2,3

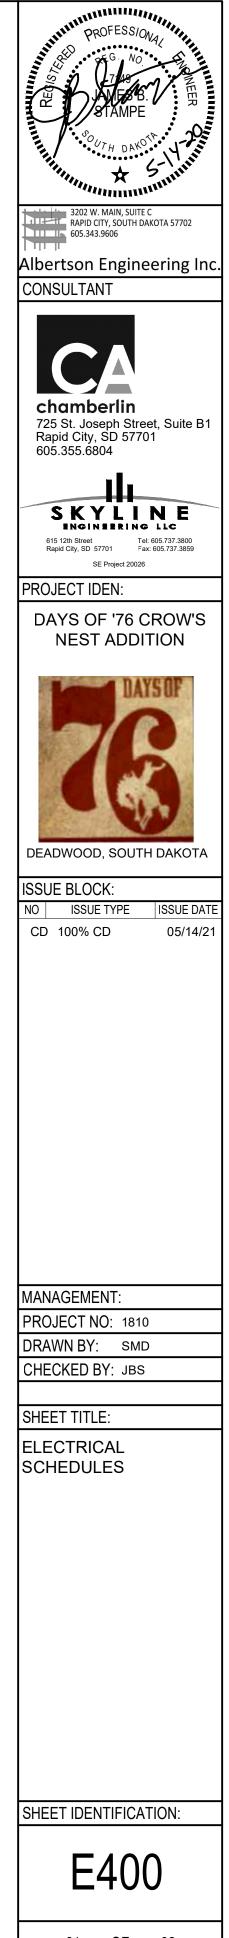

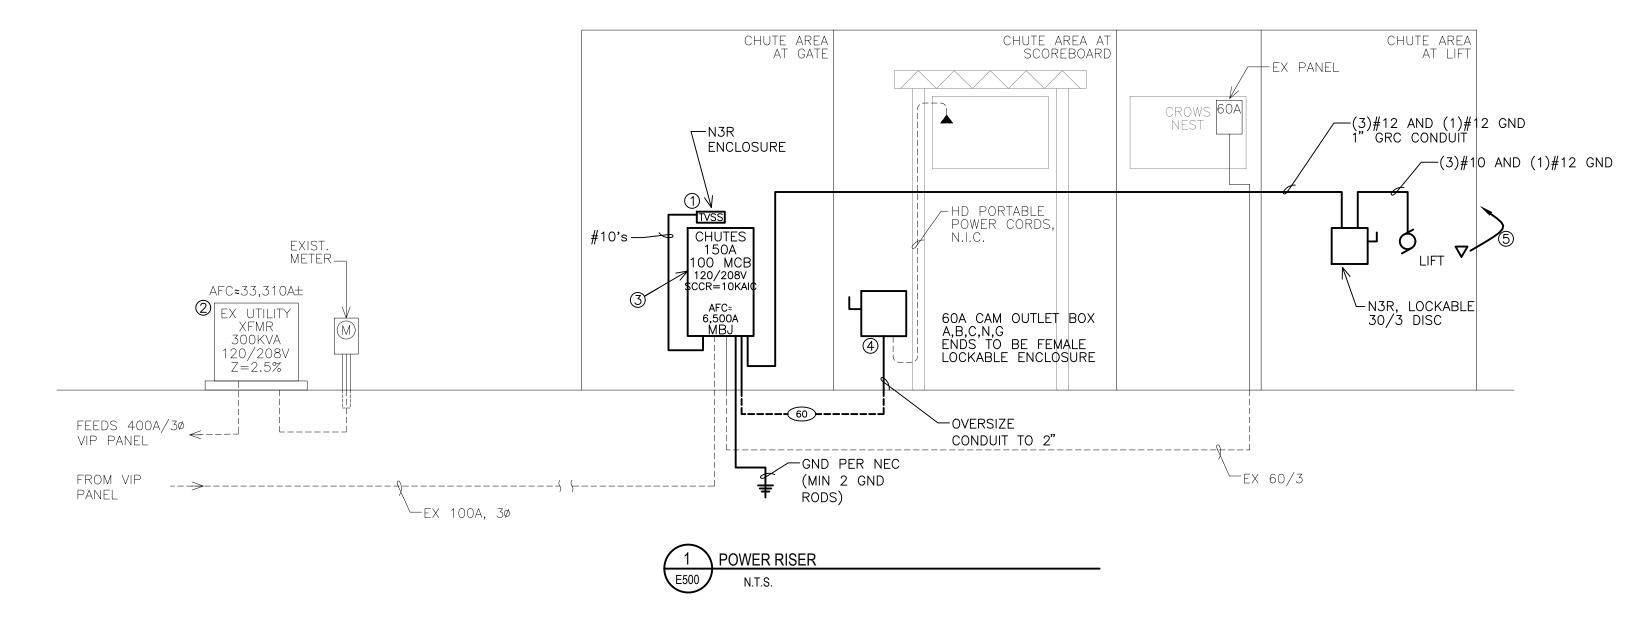

- ⑤ OSP CAT 5 TO CROW'S NEST.

- ④ 60AMP CAM OUTLET BOX EQUAL TO LEX POWERGATE, 10KAIC RATED.
- ③ REPLACE EXISTING 100/3 IN PLACE WITH 150/3.
- ② TRANSFORMER LOCATED ALONG CRESCENT DRIVE.
- SPECIFIC NOTES: 1) TVSS UNIT SHALL BE EQUAL TO EATON MODEL 560 WITH SURGE COUNTER AND AUDIBLE ALARM SURGE RATING ON MAIN SHALL BE 200KA/400KA.
- A. LABEL PER NEC AND OWNER DIRECTIVES.

<u>GENERAL NOTES</u>:

RISER CONDUIT/WIRE FEEDER SCHEDULE-COPPER

60 60A-3P (1)1 1/4"C WITH (4)#4 AND (1)#10 GND

GROUND AND CONDUIT ACCORDINGLY.

APPLICATION NOTE: A. FEEDER SCHEDULE DOES NOT REFLECT REQUIRED TEMPERATURE DE-RATINGS OR VOLTAGE DROP. B. WHERE RISER INDICATES A "+" AFTER THE FEEDER AMPACITY WITHIN THE MARK, SUCH AS 400+, THE FEEDER SIZE SHALL BE INCREASED BY ONE WIRE SIZE FOR EACH "+" SYMBOL. INCREASE

C. RISER INDICATES A SERVICE LATERAL WITH AN "S" AFTER THE AMPACITY VALUE. NO GROUND CONDUCTORS REQUIRED WITHIN THE SERVICE LATERAL.

			PAN	IEL CHU	TES			
120/208V, 3 PHASE, 4 WIRE, 150 AMP FRAME, 100A M.C.B., SURFACE MOUNTED, N3R, 10KAIC					3R, 10KAIC			
LOAD	POLES	AMPS	ССТ	PHASE	ССТ	AMPS	POLES	LOAD
LTG - STAIR LIGHTS AND BACK OF CROW'S NEST	20	1	1	A	2	20 *	1	REC - UNDER DECK CEILING
LTG - UNDER DECK NORTH	20	1	3	В	4	20 *	1	REC - UNDER BARTOP NORTH
LTG - UNDER DECK - SOUTH	20	1	5	С	6	20 *	1	REC - UNDER BARTOP NORTH
LTG - CHUTE FRONT CENTER	20	1	7	А	8	20	1	REC - TV CAMERA NORTH
LTG - CHUTE FRONT SIDES	20	1	9	В	10	20 *	1	REC - UNDER BARTOP SOUTH
LTG - BAR TOPS	20	1	11	С	12	20	1	REC - TV CAMERA SOUTH
SPARE	20 *	1	13	А	14	20	1	PLATFORM LIFT
SPARE	20 *	1	15	В	16			SPACE
SPACE			17	С	18			SPACE
SPACE			19	А	20	20	1	EX LOAD
SPACE			21	В	22	60	2	EX LOAD - CROW'S NEXT PANEL
EX LOAD	50 *	2	23	С	24			
			25	А	26	60	3	SCOREBOARD CAM OUTLET
EX LOAD	50 *	2	27	В	28			
			29	С	30			

Remarks: SERVICE ENTRANCE RATED * DENOTES GFCI PROTECTION - 5mA (1505) 150A-3P 2"C WITH (4)#1/0 AND (1)#6 GND

XFMR SECONDARY 120/208V 3PH

PROFESSIONAL PR
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SKYLING LLC BIG INTERING LLC BIG INTERING LLC BIG INTERING LLC BIG INTERING LLC BIG INTERING LLC BIG INTERING LLC Tel: 605.737.3800 Fax: 605.737.3859 SE Project 20026 PROJECT IDEN:
DAYS OF '76 CROW'S NEST ADDITION
NO ISSUE TYPE ISSUE DATE CD 100% CD 05/14/21
MANAGEMENT: PROJECT NO: 1810 DRAWN BY: SMD CHECKED BY: JBS SHEET TITLE: ELECTRICAL RISER, PANEL SCHEDULE AND DETAILS
SHEET IDENTIFICATION: E500 32 OF 32