


WHISPER WAY STORM IMPROVEMENTS FOR CITY OF DACULA

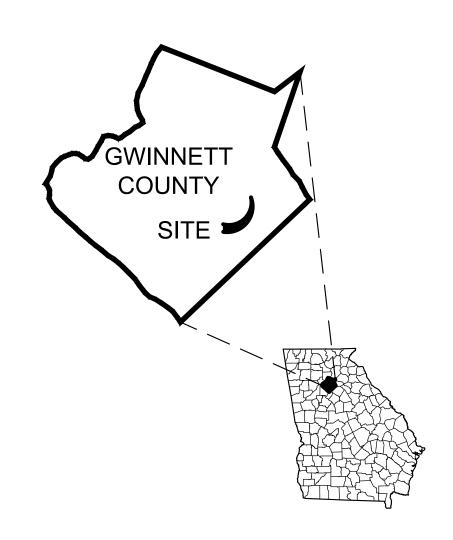

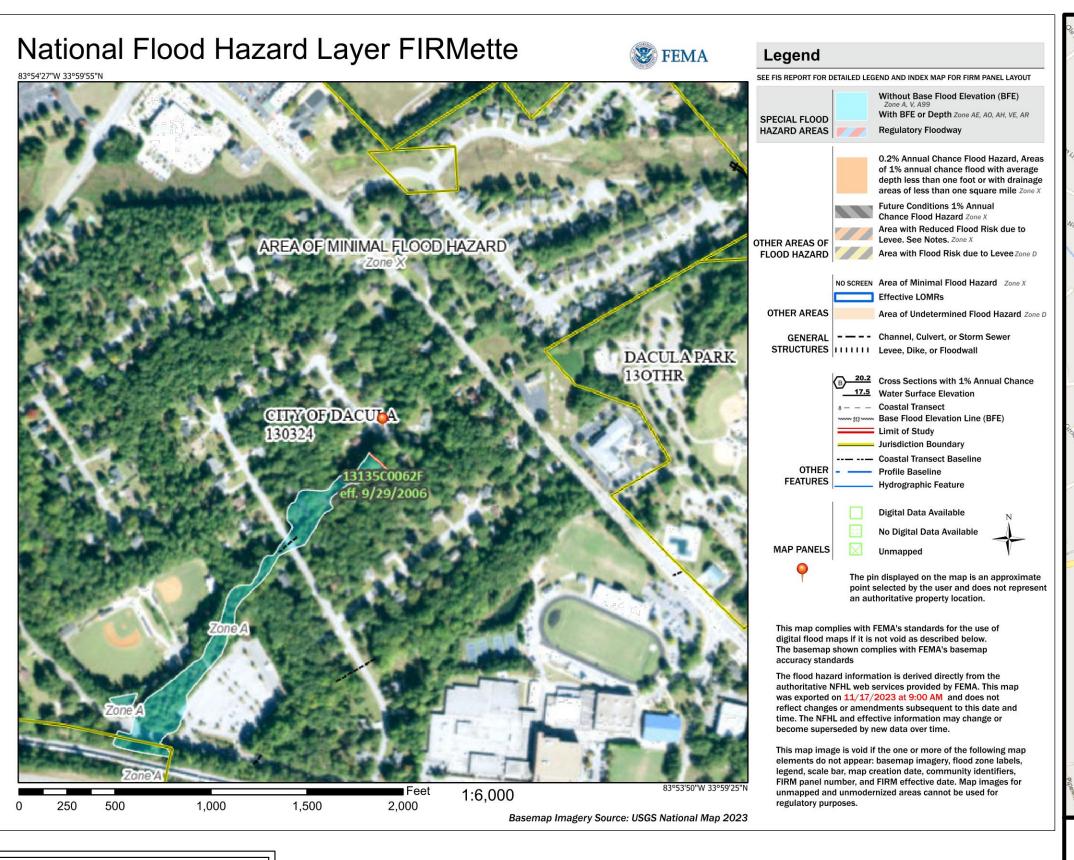

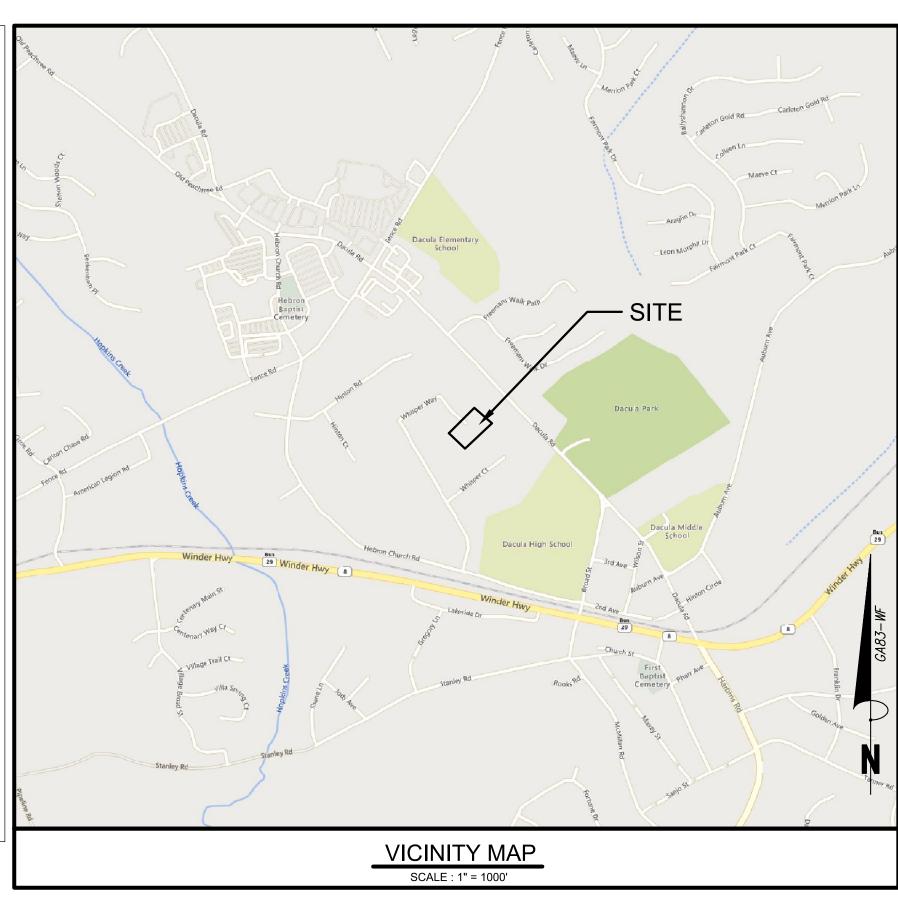

UTILITY	PROVIDER	TELEPHONE	
ELECTRICITY	GEORGIA POWER	1-888-660-5890	
	JACKSON EMC	770-822-3235	
NATURAL GAS	CITY OF BUFORD	770-945-6761	
WATER & SEWER	GWINNETT COUNTY PUBLIC UTILITIES	678-376-6800	
CABLE TV / INTERNET	CHARTER COMMUNICATIONS	1-877-906-9121	
	DIRECT TV	1-855-229-4377	
	COMCAST	1-800-934-6489	
	AT&T	1-877-862-7873	
	VIASAT SATELLITE INTERNET	1-855-393-3302	

Sheet List Table		
Sheet Number	Sheet Title	
C0.0	COVER SHEET	
C1.0	DEMOLITION PLAN	
C2.0	SITE PLAN	
C3.0	GRADING & DRAINAGE PLAN	
C3.1	STORM PROFILE	
C4.0	EROSION CONTROL NOTES	
C4.1	EROSION COTNROL PLAN PHASE-I	
C4.2	EROSION CONTROL PLAN PHASE-II	
C4.3	EROSION CONTROL PLAN PHASE-III	
C4.4	EROSION CONTROL DETAILS	
C5.0	CONSTRUCTION DETAILS	
C5.1	CONSTRUCTION DETAILS	

24 HOUR CONTACT BRITTNI NIX CONTACT NUMBER

FLOOD PLAN NOTE:



THIS PROJECT DOES NOT LAY WITHIN A SPECIAL FLOOD HAZARD AREA (SFHA) PER FEMA FIRM PANEL 13135C0062F DATED 9/29/2006. (770) 963-7451

CONSULTANT PROJECT # 200510-01-001


LEVEL II E&S CERT.#945 EXP. DATE 09-27-24

2024/1/22 FOR CONSTRUCTION

DATE DESCRIPTION DESIGN DRAWN CHKD

200510-01-001 01/22/2024

SHEET No.

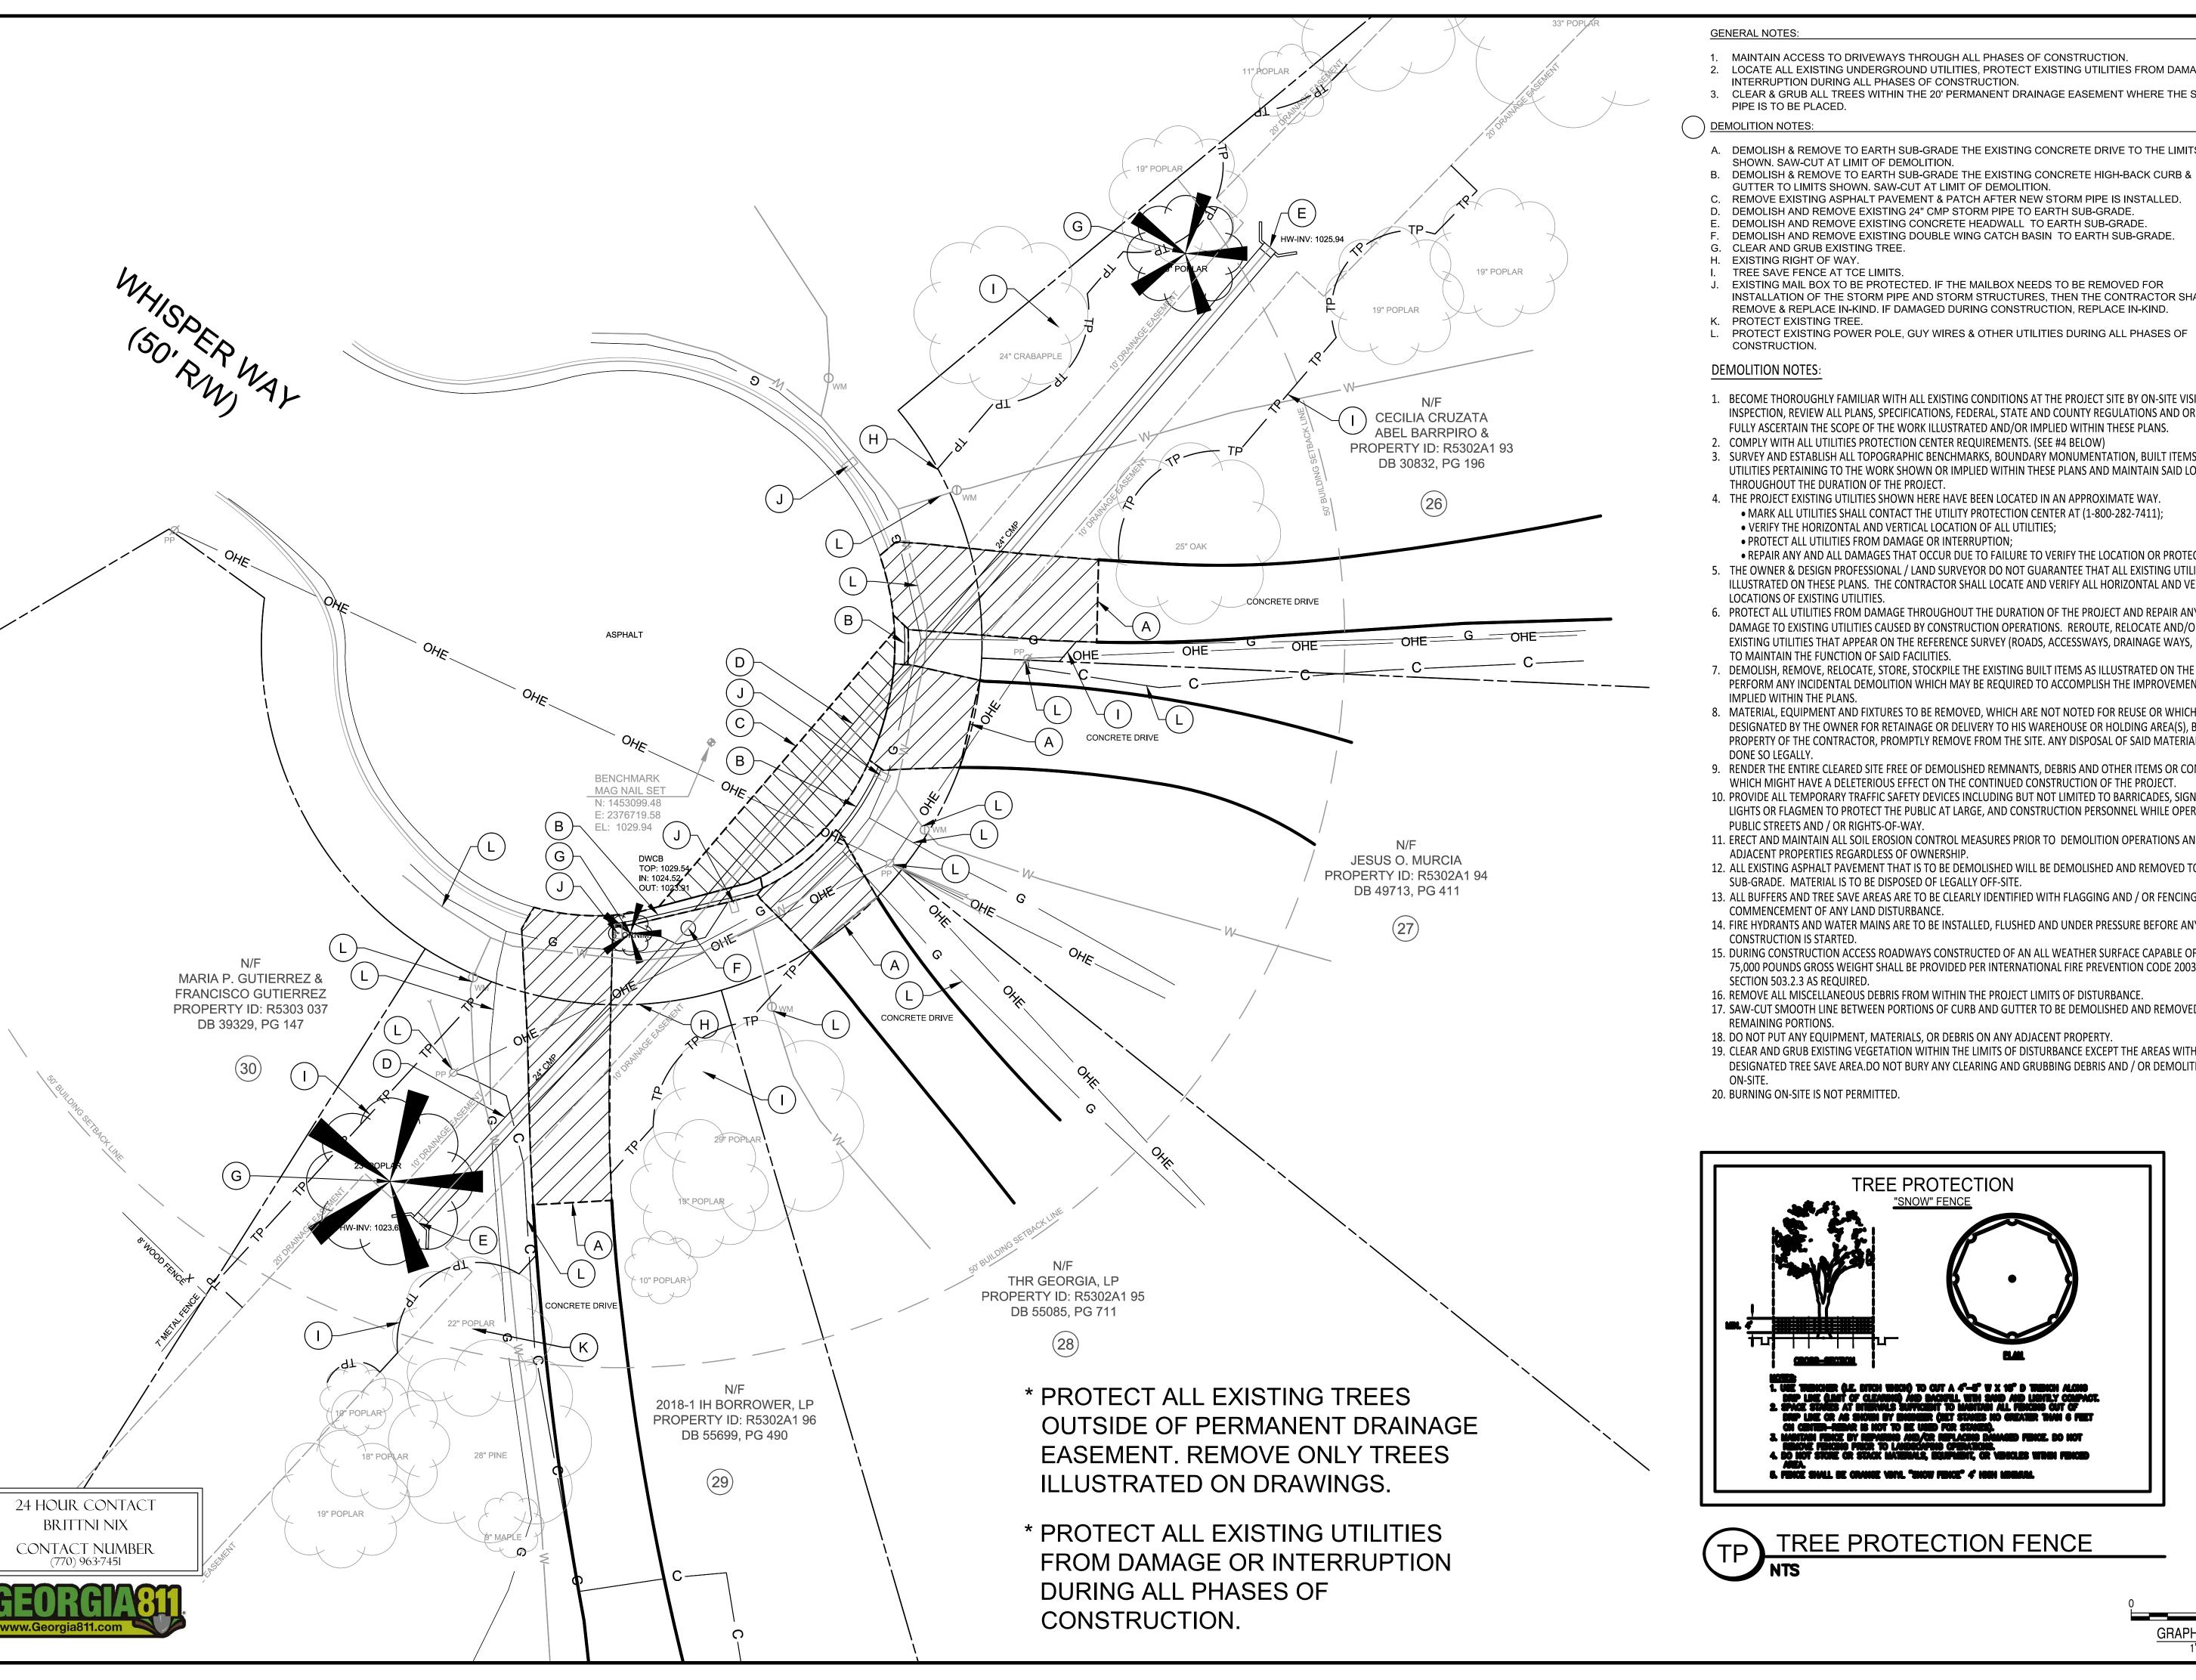

MAINTAIN ACCESS TO DRIVEWAYS THROUGH ALL PHASES OF CONSTRUCTION.

2. LOCATE ALL EXISTING UNDERGROUND UTILITIES, PROTECT EXISTING UTILITIES FROM DAMAGE OR INTERRUPTION DURING ALL PHASES OF CONSTRUCTION.

3. CLEAR & GRUB ALL TREES WITHIN THE 20' PERMANENT DRAINAGE EASEMENT WHERE THE STORM PIPE IS TO BE PLACED.

A. DEMOLISH & REMOVE TO EARTH SUB-GRADE THE EXISTING CONCRETE DRIVE TO THE LIMITS SHOWN. SAW-CUT AT LIMIT OF DEMOLITION.

GUTTER TO LIMITS SHOWN. SAW-CUT AT LIMIT OF DEMOLITION.

REMOVE EXISTING ASPHALT PAVEMENT & PATCH AFTER NEW STORM PIPE IS INSTALLED.

DEMOLISH AND REMOVE EXISTING 24" CMP STORM PIPE TO EARTH SUB-GRADE. DEMOLISH AND REMOVE EXISTING CONCRETE HEADWALL TO EARTH SUB-GRADE.

DEMOLISH AND REMOVE EXISTING DOUBLE WING CATCH BASIN TO EARTH SUB-GRADE.

H. EXISTING RIGHT OF WAY.

TREE SAVE FENCE AT TCE LIMITS.

EXISTING MAIL BOX TO BE PROTECTED. IF THE MAILBOX NEEDS TO BE REMOVED FOR INSTALLATION OF THE STORM PIPE AND STORM STRUCTURES, THEN THE CONTRACTOR SHALL REMOVE & REPLACE IN-KIND. IF DAMAGED DURING CONSTRUCTION, REPLACE IN-KIND.

L. PROTECT EXISTING POWER POLE, GUY WIRES & OTHER UTILITIES DURING ALL PHASES OF CONSTRUCTION.

DEMOLITION NOTES:

1. BECOME THOROUGHLY FAMILIAR WITH ALL EXISTING CONDITIONS AT THE PROJECT SITE BY ON-SITE VISITATION AND INSPECTION, REVIEW ALL PLANS, SPECIFICATIONS, FEDERAL, STATE AND COUNTY REGULATIONS AND ORDINANCES TO FULLY ASCERTAIN THE SCOPE OF THE WORK ILLUSTRATED AND/OR IMPLIED WITHIN THESE PLANS.

2. COMPLY WITH ALL UTILITIES PROTECTION CENTER REQUIREMENTS. (SEE #4 BELOW)

3. SURVEY AND ESTABLISH ALL TOPOGRAPHIC BENCHMARKS, BOUNDARY MONUMENTATION, BUILT ITEMS AND EXISTING UTILITIES PERTAINING TO THE WORK SHOWN OR IMPLIED WITHIN THESE PLANS AND MAINTAIN SAID LOCATIONS THROUGHOUT THE DURATION OF THE PROJECT.

4. THE PROJECT EXISTING UTILITIES SHOWN HERE HAVE BEEN LOCATED IN AN APPROXIMATE WAY.

• MARK ALL UTILITIES SHALL CONTACT THE UTILITY PROTECTION CENTER AT (1-800-282-7411);

 VERIFY THE HORIZONTAL AND VERTICAL LOCATION OF ALL UTILITIES; • PROTECT ALL UTILITIES FROM DAMAGE OR INTERRUPTION;

• REPAIR ANY AND ALL DAMAGES THAT OCCUR DUE TO FAILURE TO VERIFY THE LOCATION OR PROTECT UTILITIES. 5. THE OWNER & DESIGN PROFESSIONAL / LAND SURVEYOR DO NOT GUARANTEE THAT ALL EXISTING UTILITIES ARE

ILLUSTRATED ON THESE PLANS. THE CONTRACTOR SHALL LOCATE AND VERIFY ALL HORIZONTAL AND VERTICAL LOCATIONS OF EXISTING UTILITIES.

6. PROTECT ALL UTILITIES FROM DAMAGE THROUGHOUT THE DURATION OF THE PROJECT AND REPAIR ANY AND ALL DAMAGE TO EXISTING UTILITIES CAUSED BY CONSTRUCTION OPERATIONS. REROUTE, RELOCATE AND/OR MODIFY ANY EXISTING UTILITIES THAT APPEAR ON THE REFERENCE SURVEY (ROADS, ACCESSWAYS, DRAINAGE WAYS, ETC.) IN ORDER TO MAINTAIN THE FUNCTION OF SAID FACILITIES.

7. DEMOLISH, REMOVE, RELOCATE, STORE, STOCKPILE THE EXISTING BUILT ITEMS AS ILLUSTRATED ON THE PLANS AND PERFORM ANY INCIDENTAL DEMOLITION WHICH MAY BE REQUIRED TO ACCOMPLISH THE IMPROVEMENTS SHOWN OR

8. MATERIAL, EQUIPMENT AND FIXTURES TO BE REMOVED, WHICH ARE NOT NOTED FOR REUSE OR WHICH HAVE NOT BEEN DESIGNATED BY THE OWNER FOR RETAINAGE OR DELIVERY TO HIS WAREHOUSE OR HOLDING AREA(S), BECOME THE PROPERTY OF THE CONTRACTOR, PROMPTLY REMOVE FROM THE SITE. ANY DISPOSAL OF SAID MATERIALS SHALL BE DONE SO LEGALLY.

9. RENDER THE ENTIRE CLEARED SITE FREE OF DEMOLISHED REMNANTS, DEBRIS AND OTHER ITEMS OR CONDITIONS WHICH MIGHT HAVE A DELETERIOUS EFFECT ON THE CONTINUED CONSTRUCTION OF THE PROJECT.

10. PROVIDE ALL TEMPORARY TRAFFIC SAFETY DEVICES INCLUDING BUT NOT LIMITED TO BARRICADES, SIGNAGE, SIGNAL LIGHTS OR FLAGMEN TO PROTECT THE PUBLIC AT LARGE, AND CONSTRUCTION PERSONNEL WHILE OPERATING WITHIN PUBLIC STREETS AND / OR RIGHTS-OF-WAY.

11. ERECT AND MAINTAIN ALL SOIL EROSION CONTROL MEASURES PRIOR TO DEMOLITION OPERATIONS AND PROTECT ALL ADJACENT PROPERTIES REGARDLESS OF OWNERSHIP.

12. ALL EXISTING ASPHALT PAVEMENT THAT IS TO BE DEMOLISHED WILL BE DEMOLISHED AND REMOVED TO EARTH

SUB-GRADE. MATERIAL IS TO BE DISPOSED OF LEGALLY OFF-SITE. 13. ALL BUFFERS AND TREE SAVE AREAS ARE TO BE CLEARLY IDENTIFIED WITH FLAGGING AND / OR FENCING PRIOR TO


14. FIRE HYDRANTS AND WATER MAINS ARE TO BE INSTALLED, FLUSHED AND UNDER PRESSURE BEFORE ANY COMBUSTIBL 15. DURING CONSTRUCTION ACCESS ROADWAYS CONSTRUCTED OF AN ALL WEATHER SURFACE CAPABLE OF SUPPORTING

16. REMOVE ALL MISCELLANEOUS DEBRIS FROM WITHIN THE PROJECT LIMITS OF DISTURBANCE.

18. DO NOT PUT ANY EQUIPMENT, MATERIALS, OR DEBRIS ON ANY ADJACENT PROPERTY.

19. CLEAR AND GRUB EXISTING VEGETATION WITHIN THE LIMITS OF DISTURBANCE EXCEPT THE AREAS WITHIN A DESIGNATED TREE SAVE AREA.DO NOT BURY ANY CLEARING AND GRUBBING DEBRIS AND / OR DEMOLITION DEBRIS

20. BURNING ON-SITE IS NOT PERMITTED.

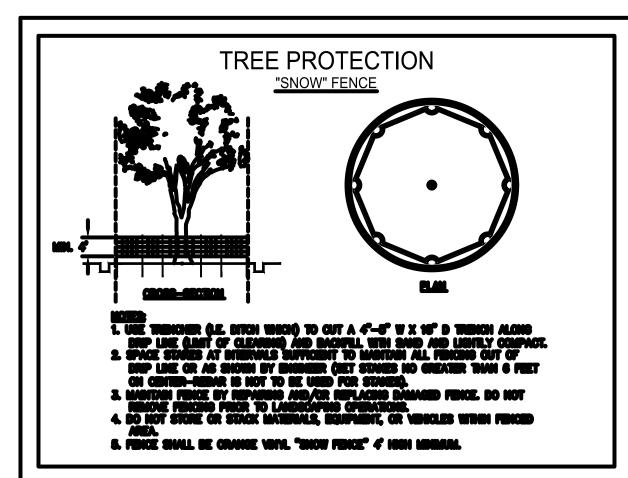



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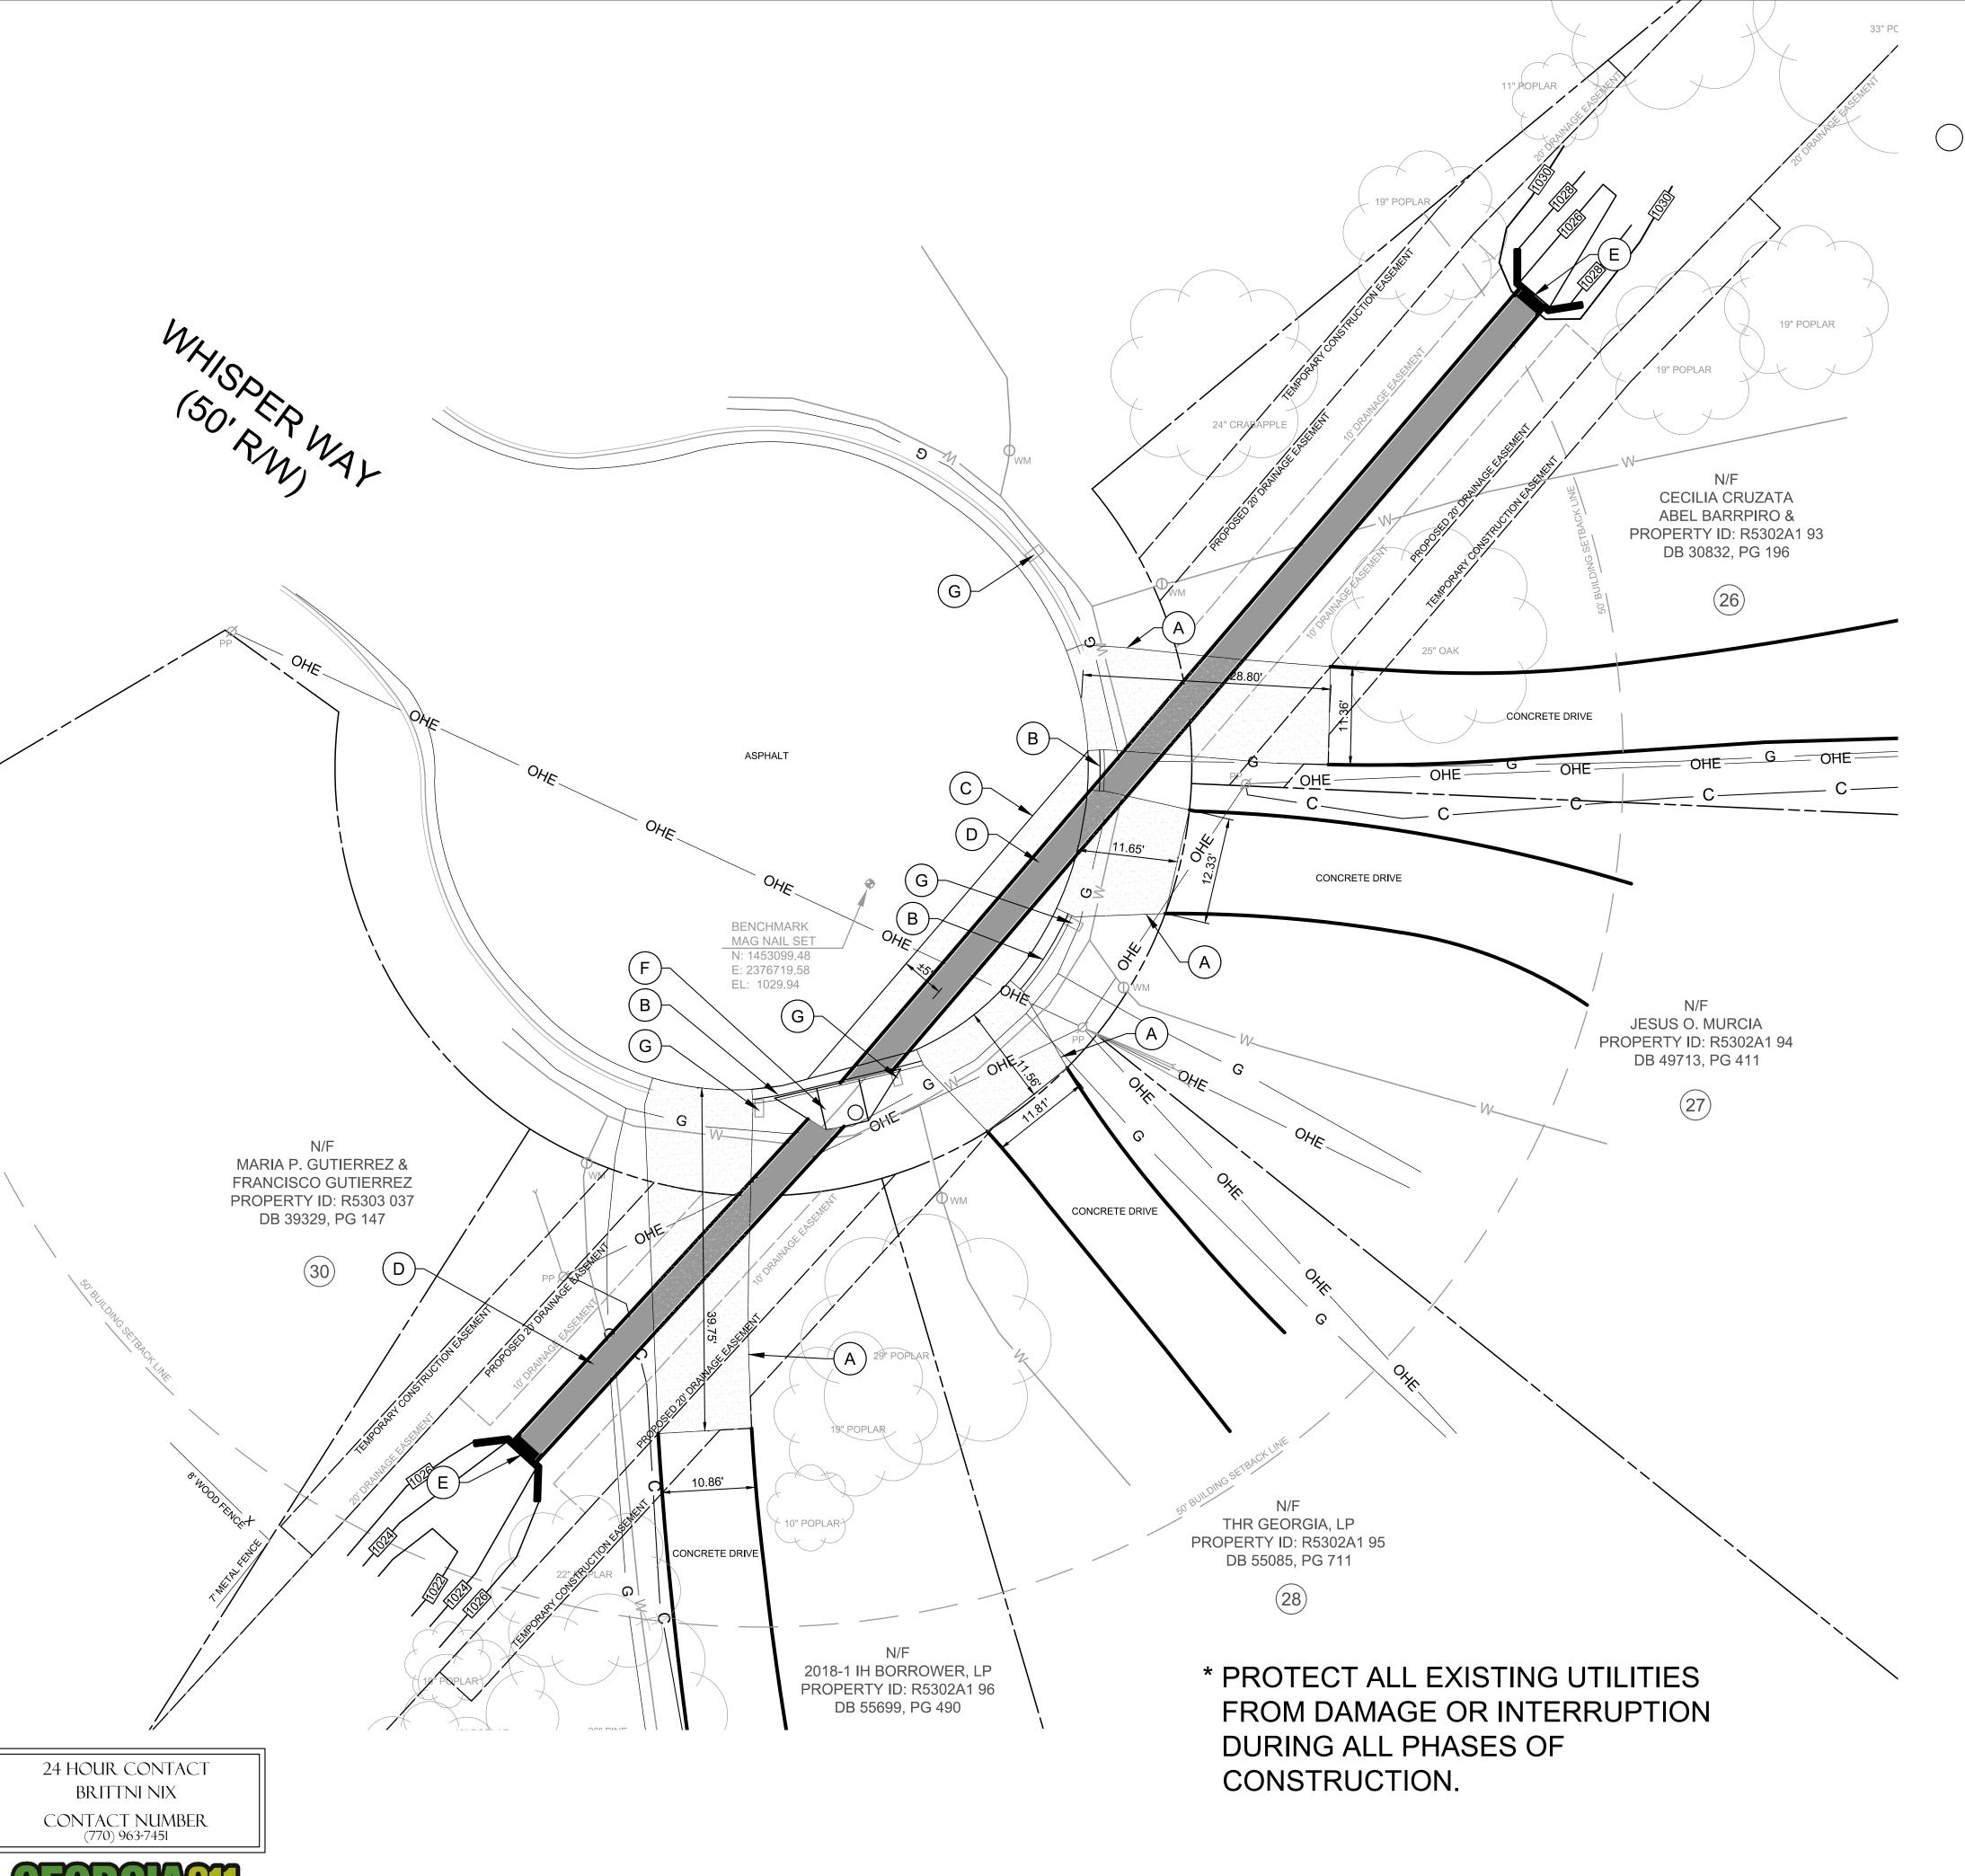
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200510-01-001

024/1/22 FOR CONSTRUCTION DATE DESCRIPTION

DESIGN | DRAWN | CHKD 200510-01-00°

C1.0 SHEET No.




GENERAL NOTES:

- MAINTAIN ACCESS TO DRIVEWAYS THROUGH ALL PHASES OF CONSTRUCTION.
- 2. LOCATE ALL EXISTING UNDERGROUND UTILITIES, PROTECT EXISTING UTILITIES FROM DAMAGE OR INTERUPTION DURING ALL PHASES OF CONSTRUCTION.

- A. PROPOSED CONCRETE DRIVE TO THE LIMITS SHOWN. SEE DETAIL 1 / C5.0, 1 / C5.1.
- B. PROPOSED CONCRETE HIGH-BACK CURB & GUTTER TO LIMITS SHOWN. SEE DETAIL 2 / C5.0.
- C. PROPOSED ASPHALT PAVEMENT PATCH AFTER NEW STORM PIPE IS INSTALLED. SEE DETAIL 5 / C5.0.
- D. PROPOSED 36" RCP STORM PIPE. SEE DETAIL 6 / C5.0.
- PROPOSED PRECAST CONCRETE HEADWALL. SEE DETAIL 3 / C5.0.
- PROPOSED PRECAST DOUBLE WING CATCH BASIN. SEE DETAIL 4 / C5.0, 7 / C5.0. G. MAILBOX - REINSTALL OR REPLACE IF DAMAGED DURING CONSTRUCTION IN-KIND.

- 1. BECOME THOROUGHLY FAMILIAR WITH ALL EXISTING CONDITIONS AT THE PROJECT SITE BY ON-SITE VISITATION AND INSPECTION, REVIEW ALL PLANS, SPECIFICATIONS, FEDERAL, STATE AND COUNTY REGULATIONS AND ORDINANCES TO FULLY ASCERTAIN THE SCOPE OF THE WORK
- ILLUSTRATED AND/OR IMPLIED WITHIN THESE PLANS. 2. COMPLY WITH ALL UTILITIES PROTECTION CENTER REQUIREMENTS. (SEE #4 BELOW)
- 3. SURVEY AND ESTABLISH ALL TOPOGRAPHIC BENCHMARKS, BOUNDARY MONUMENTATION, BUILT ITEMS AND EXISTING UTILITIES PERTAINING TO THE WORK SHOWN OR IMPLIED WITHIN THESE PLANS AND MAINTAIN SAID LOCATIONS THROUGHOUT THE DURATION OF THE PROJECT.
- 4. THE PROJECT EXISTING UTILITIES SHOWN HERE HAVE BEEN LOCATED IN AN APPROXIMATE WAY.
- MARK ALL UTILITIES SHALL CONTACT THE UTILITY PROTECTION CENTER AT (1-800-282-7411);
- VERIFY THE HORIZONTAL AND VERTICAL LOCATION OF ALL UTILITIES; • PROTECT ALL UTILITIES FROM DAMAGE OR INTERRUPTION;
- REPAIR ANY AND ALL DAMAGES THAT OCCUR DUE TO FAILURE TO VERIFY THE LOCATION OR PROTECT UTILITIES.
- 5. THE OWNER & DESIGN PROFESSIONAL / LAND SURVEYOR DO NOT GUARANTEE THAT ALL EXISTING UTILITIES ARE ILLUSTRATED ON THESE PLANS. THE CONTRACTOR SHALL LOCATE AND VERIFY ALL HORIZONTAL AND VERTICAL LOCATIONS OF EXISTING UTILITIES.
- 6. PROTECT ALL UTILITIES FROM DAMAGE THROUGHOUT THE DURATION OF THE PROJECT AND REPAIR ANY AND ALL DAMAGE TO EXISTING UTILITIES CAUSED BY CONSTRUCTION OPERATIONS. REROUTE, RELOCATE AND/OR MODIFY ANY EXISTING UTILITIES THAT APPEAR ON THE
- REFERENCE SURVEY (ROADS, ACCESSWAYS, DRAINAGE WAYS, ETC.) IN ORDER TO MAINTAIN THE FUNCTION OF SAID FACILITIES. 7. PROVIDE ALL TEMPORARY TRAFFIC SAFETY DEVICES INCLUDING BUT NOT LIMITED TO BARRICADES, SIGNAGE, SIGNAL LIGHTS OR FLAGMEN TO
- PROTECT THE PUBLIC AT LARGE, AND CONSTRUCTION PERSONNEL WHILE OPERATING WITHIN PUBLIC STREETS AND / OR RIGHTS-OF-WAY. 8. ERECT AND MAINTAIN ALL SOIL EROSION CONTROL MEASURES PRIOR TO DEMOLITION OPERATIONS AND PROTECT ALL ADJACENT PROPERTIES
- 9. ALL EXISTING ASPHALT PAVEMENT THAT IS TO BE DEMOLISHED WILL BE DEMOLISHED AND REMOVED TO EARTH SUB-GRADE. MATERIAL IS TO BE DISPOSED OF LEGALLY OFF-SITE.
- 10. ALL BUFFERS AND TREE SAVE AREAS ARE TO BE CLEARLY IDENTIFIED WITH FLAGGING AND / OR FENCING PRIOR TO COMMENCEMENT OF ANY
- 11. REMOVE ALL MISCELLANEOUS DEBRIS FROM THE SITE. THAT ARE DESIGNATED TO BE REMOVED BY THE CITY OF DACULA AND THE DESIGN
- ENGINEER OR AS DIRECTED IN THE CONSTRUCTION DOCUMENTS. 12. SAW-CUT SMOOTH LINE BETWEEN PORTIONS OF CURB AND GUTTER TO BE DEMOLISHED AND REMOVED AND REMAINING PORTIONS.
- 13. DO NOT PUT ANY EQUIPMENT, MATERIALS, OR DEBRIS ON ANY ADJACENT PROPERTY. 14. CLEAR AND GRUB EXISTING VEGETATION WITHIN THE LIMITS OF DISTURBANCE EXCEPT THE AREAS WITHIN A DESIGNATED TREE SAVE AREA. SEE
- SHEET C1.0 DEMOLITION PLAN FOR TREE FENCE LOCATION.
- 15. DO NOT BURY ANY CLEARING AND GRUBBING DEBRIS AND / OR DEMOLITION DEBRIS ON-SITE.
- 16. BURNING ON-SITE IS NOT PERMITTED.

DETAIL LEGEND	
ITEM	DETAIL / SHEET
CONCRETE DRIVEWAY PAVEMENT	1 / C5.0
24" CONCRETE CURB AND GUTTER	2 / C5.0
CONCRETE HEADWALL DETAIL (HW)	3 / C5.0
LID AND STORM STRUCTURE DETAIL	4 / C5.0
PAVEMENT PATCH DETAIL	5 / C5.0
STANDARD PIPE BEDDING DETAILS	6 / C5.0
DOUBLE WING CATCH BASIN (DWCB)	7 / C5.0
CONCRETE DRIVEWALK APRON	1 / C5.1

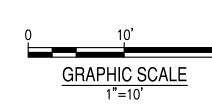

'EMEN' ROV

ORM IMPR S

200510-01-001




2024/1/22 FOR CONSTRUCTION

ATE	DESCRIF	PTION
KDW	RWH	KDW
ESIGN	DRAWN	CHKD
CALE		1" = 20'
OB No.	2005	10-01-001

01/22/2024

C2.0 SHEET No.

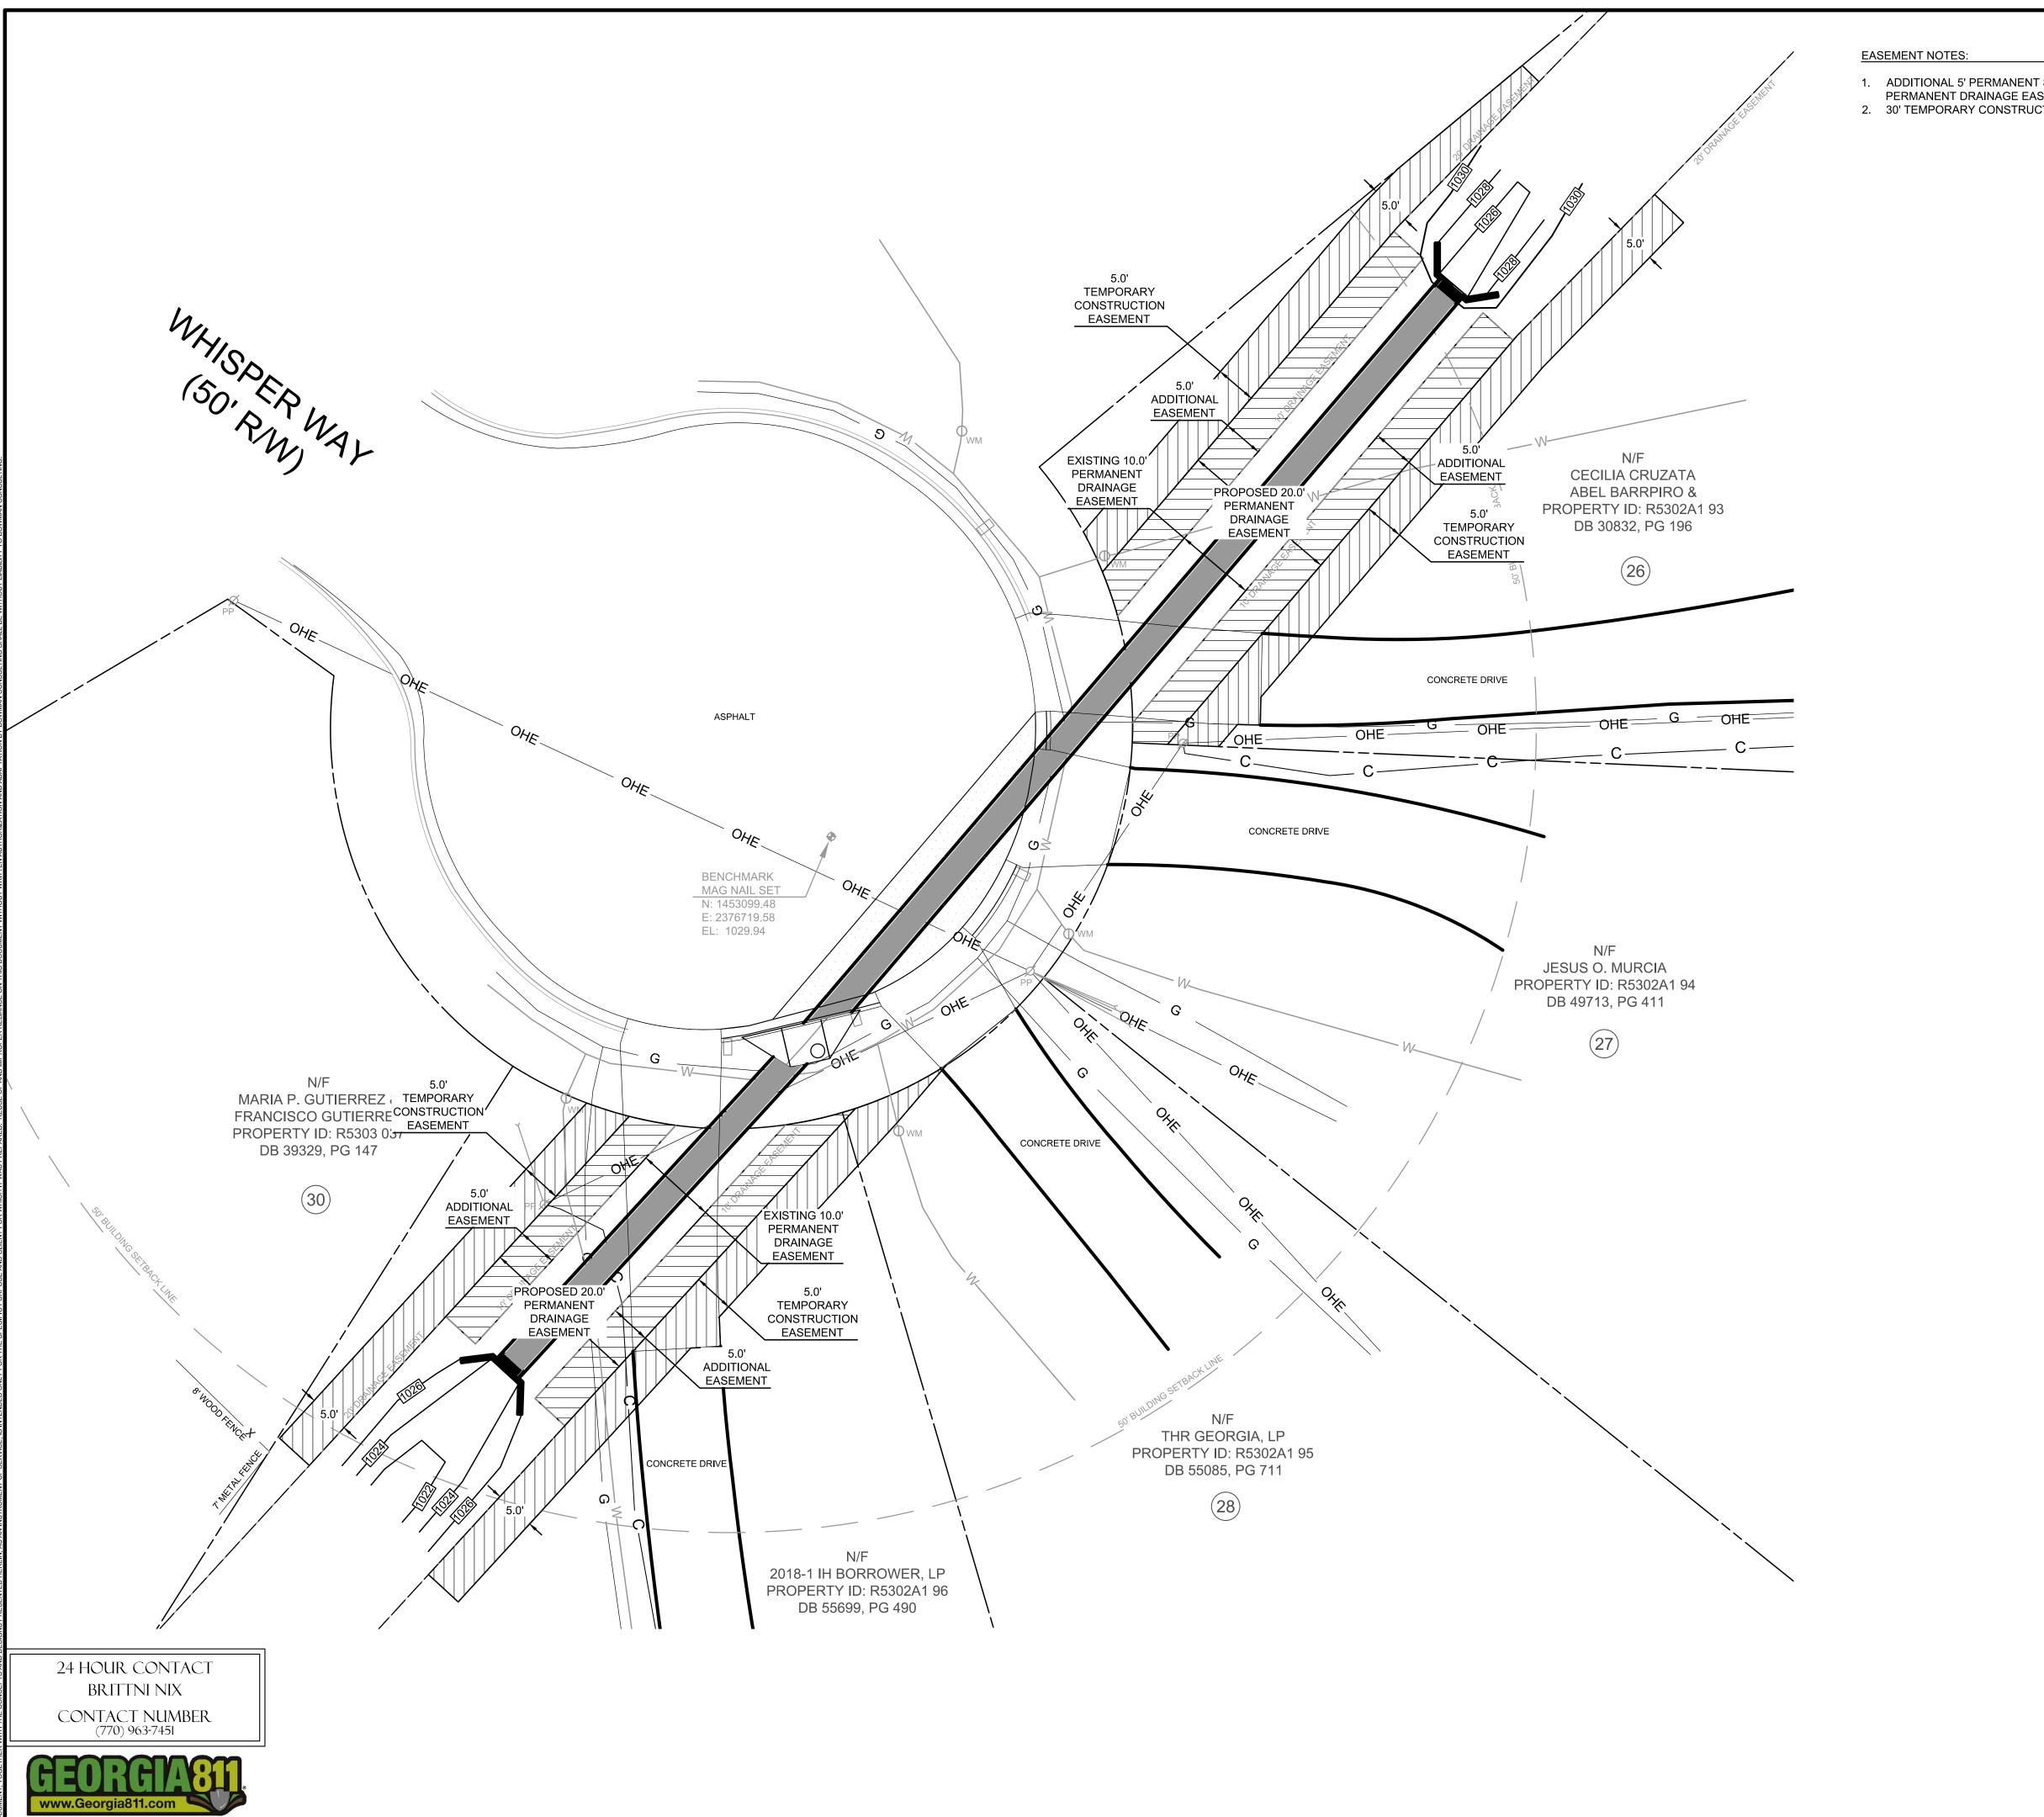

- 1. ADDITIONAL 5' PERMANENT STORM DRAINAGE EASEMENT TO EXPAND THE EXISTING 10'
- PERMANENT DRAINAGE EASEMENT TO 20' PERMANENT DRAINAGE EASEMENT.
- 2. 30' TEMPORARY CONSTRUCTION EASEMENT, 5' BEYOND 20' PERMANENT DRAINAGE EASEMENT.

ORM IMPROVEMENTS

ST WAY

CONSULTANT PROJECT # 200510-01-001

WHISPER



LEVEL II E&S CERT.#945 EXP. DATE 09-27-24 PLAN STATUS

2024/1/22 FOR CONSTRUCTION

DATE	DESCRIF	PTION
KDW	RWH	KDW
DESIGN	DRAWN	CHKD

DESIGN | DRAWN | CHKD 1" = 20' 200510-01-001 01/22/2024

C2.1 SHEET No.

DETAIL / SHEET

1 / C5.0

2 / C5.0

3 / C5.0 4 / C5.0

5 / C5.0

6 / C5.0

7 / C5.0

1 / C5.1

DETAIL LEGEND

ITEM

CONCRETE DRIVEWAY PAVEMENT

24" CONCRETE CURB AND GUTTER CONCRETE HEADWALL DETAIL (HW)


LID AND STORM STRUCTURE DETAIL

STANDARD PIPE BEDDING DETAILS

CONCRETE DRIVEWALK APRON

DOUBLE WING CATCH BASIN (DWCB)

PAVEMENT PATCH DETAIL

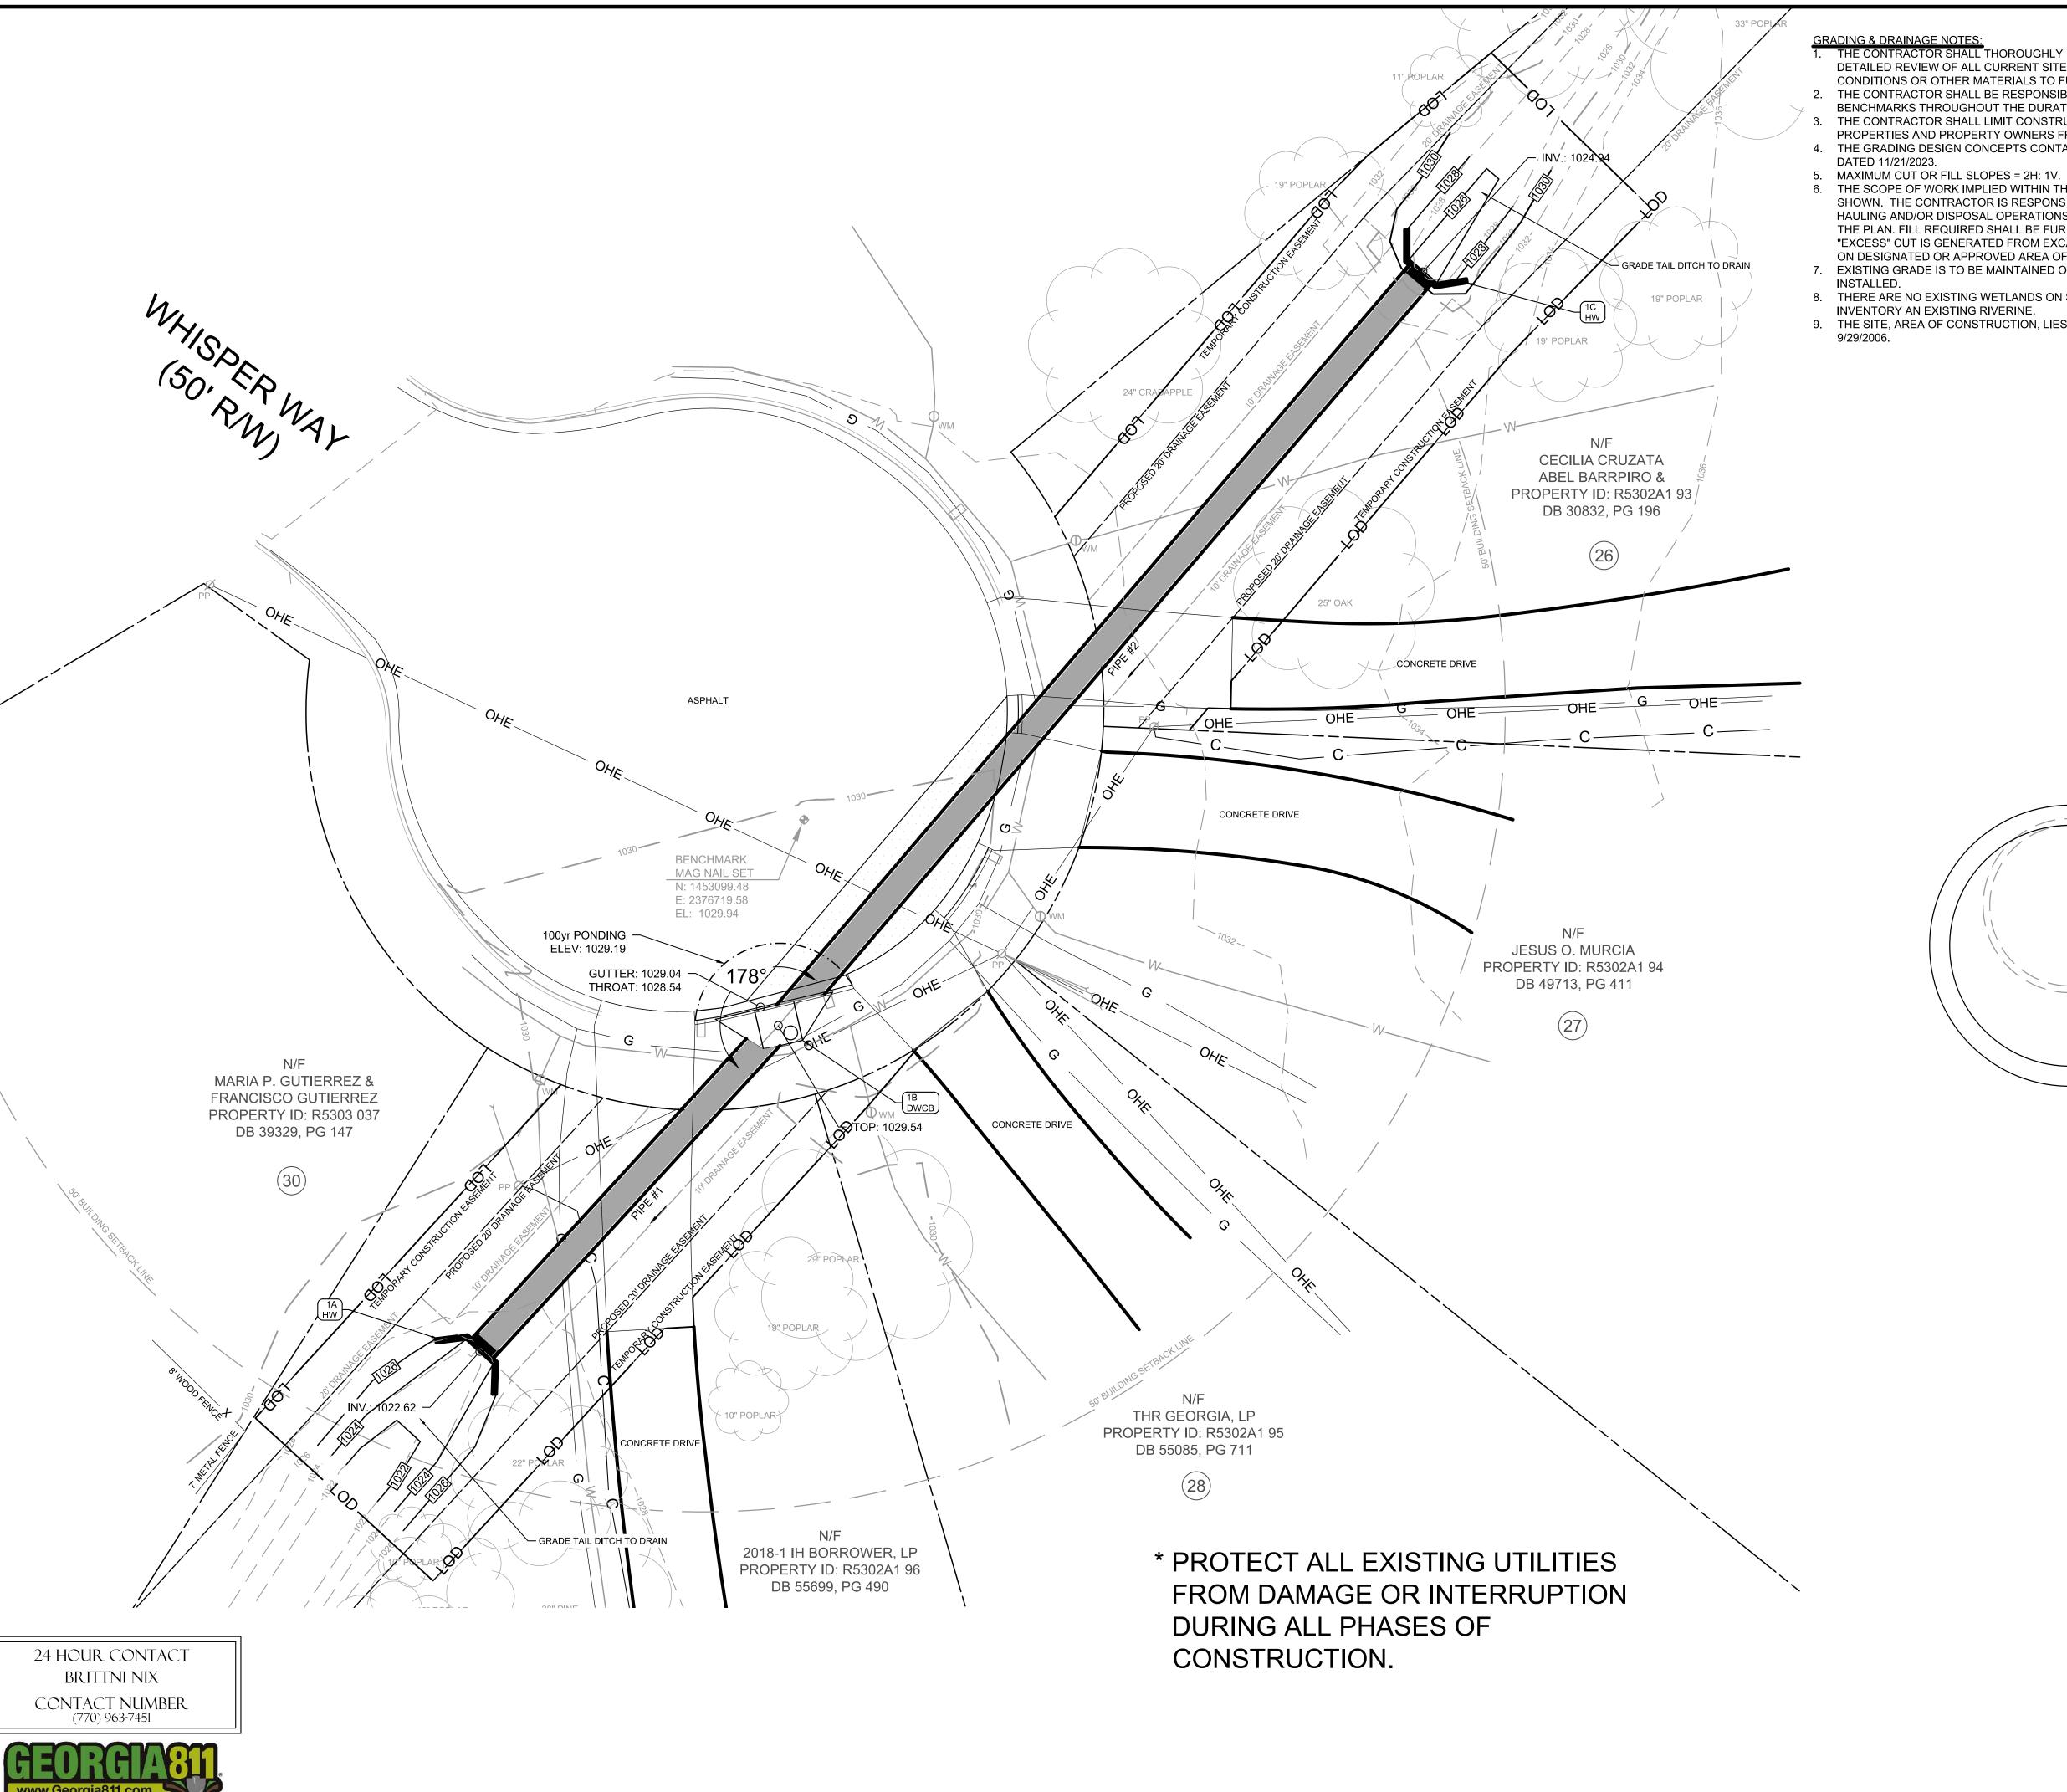

GRADING & DRAINAGE NOTES:

1. THE CONTRACTOR SHALL THOROUGHLY FAMILIARIZE HIMSELF WITH ALL EXISTING SITE CONDITIONS BY SITE VISITATION, DETAILED REVIEW OF ALL CURRENT SITE PLANS, PREVIOUS INFORMATION OF SURROUNDING LAND USES AND ZONING CONDITIONS OR OTHER MATERIALS TO FULLY ASCERTAIN THE SCOPE OF THE WORK IMPLIED WITHIN THE PLANS.

2. THE CONTRACTOR SHALL BE RESPONSIBLE FOR THE ESTABLISHMENT AND MAINTENANCE OF HORIZONTAL AND VERTICAL BENCHMARKS THROUGHOUT THE DURATION OF THE PROJECT.

THE CONTRACTOR SHALL LIMIT CONSTRUCTION OPERATIONS TO THE PROJECT SITE AND SHALL PROTECT ADJACENT

PROPERTIES AND PROPERTY OWNERS FROM ENCROACHMENT BY SOIL EROSION. 4. THE GRADING DESIGN CONCEPTS CONTAINED HEREIN ARE BASED UPON THE FIELD SURVEY PERFORMED BY BOWMAN,


DATED 11/21/2023.

THE SCOPE OF WORK IMPLIED WITHIN THIS PLAN INCLUDES ALL GRADING OPERATIONS FOR FINAL GRADE ELEVATIONS AS SHOWN. THE CONTRACTOR IS RESPONSIBLE FOR ALL EARTH QUANTITIES, GRADING OPERATIONS AND MISCELLANEOUS HAULING AND/OR DISPOSAL OPERATIONS TO RENDER THE SITE TO THE FINAL CONTOUR AND GRADE ELEVATIONS SHOWN ON THE PLAN. FILL REQUIRED SHALL BE FURNISHED, INSTALLED AND COMPACTED AS PART OF CONTRACTOR'S BASE BID. IF "EXCESS" CUT IS GENERATED FROM EXCAVATIONS, SAID "EXCESS" SHALL BE DISTRIBUTED AND FINE GRADED AND GRASSED ON DESIGNATED OR APPROVED AREA OF THE OWNER'S PROPERTY AT NO ADDITIONAL COST TO THE OWNER.


7. EXISTING GRADE IS TO BE MAINTAINED OR RESTORED TO EXISTING GRADE AFTER STORM WATER PIPE & STRUCTURES ARE

8. THERE ARE NO EXISTING WETLANDS ON SITE, WITHIN THE ARE OF CONSTRUCTION PER THE NATIONAL WETLANDS INVENTORY AN EXISTING RIVERINE.

9. THE SITE, AREA OF CONSTRUCTION, LIES WITHIN A ZONE X FLOOD ZONE PER THE FIRM PANEL 13135C0062F EFFECTIVE DATE

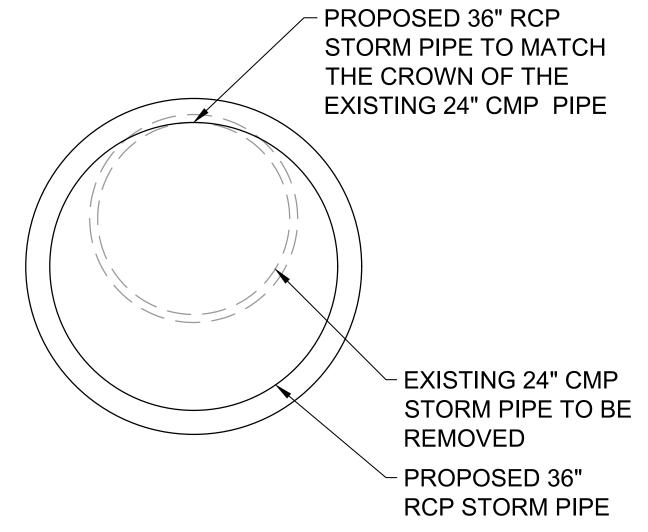

DETAIL LEGEND	
ITEM	DETAIL / SHEET
CONCRETE DRIVEWAY PAVEMENT	1 / C5.0
24" CONCRETE CURB AND GUTTER	2 / C5.0
CONCRETE HEADWALL DETAIL (HW)	3 / C5.0
LID AND STORM STRUCTURE DETAIL	4 / C5.0
PAVEMENT PATCH DETAIL	5 / C5.0
STANDARD PIPE BEDDING DETAILS	6 / C5.0
DOUBLE WING CATCH BASIN (DWCB)	7 / C5.0
CONCRETE DRIVEWALK APRON	1 / C5.1

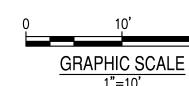

DATE DESCRIPTION DESIGN DRAWN CHKD 200510-01-001 01/22/2024 C3.0 SHEET No.

JRM IMPROV


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WAY

WHISPER

200510-01-001

2024/1/22 FOR CONSTRUCTION

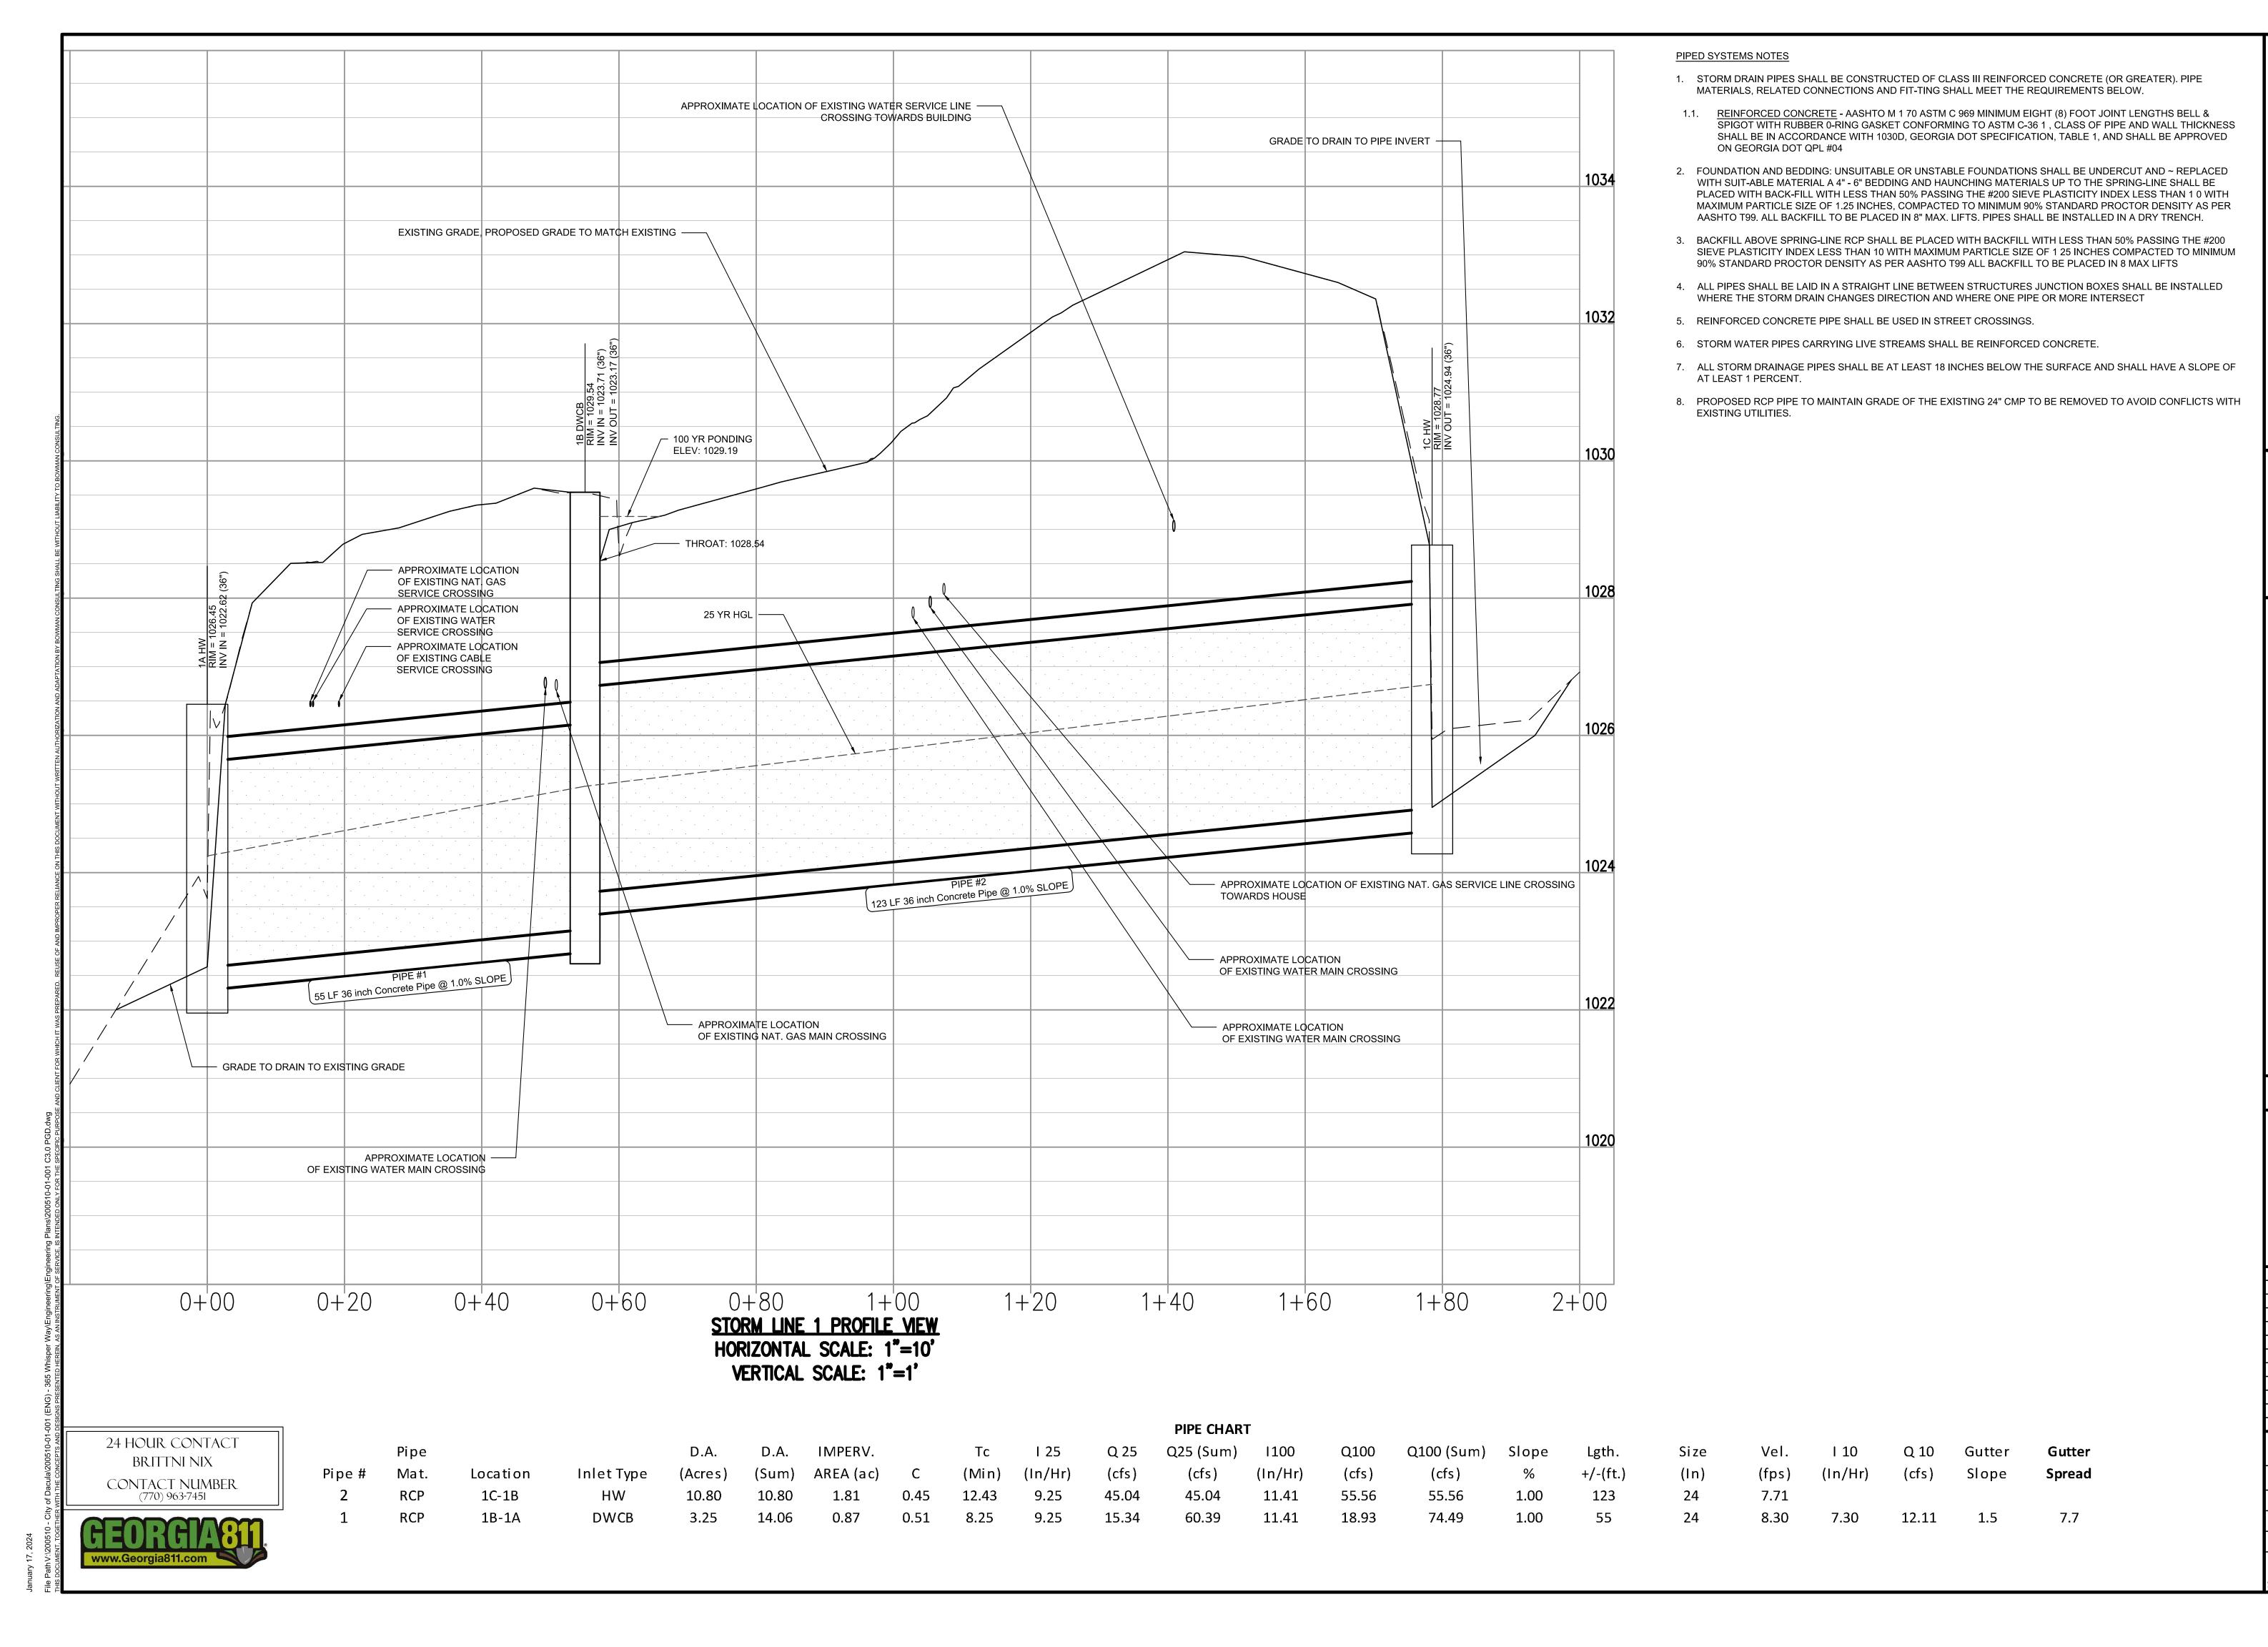

Certificate of Authorization License No. LSF001241

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ROVEMENTS GWINNETT COUN

STORM IMF FOR SITY OF DACULA

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WAY

WHISPER

' OF DACULA, GA

CONSULTANT PROJECT # 200510-01-001



LEVEL II E&S CERT.#945 EXP. DATE 09-27-24 PLAN STATUS

2024/1/22 FOR CONSTRUCTION

\TE	DESCRIPTION		
(DW	RWH	KDW	
SIGN	DRAWN	CHKD	
CALE		1" = 20'	

JOB No. 200510-01-001

DATE: 01/22/2024

FILE No.

C3.1 SHEET No.

EROSION, SEDIMENTATION AND POLLUTION CONTROL PLAN (ES&PC) NOTES:

CONTACT

- EXISTING LAND USE: STORM DRAINAGE SYSTEM
- SITE LOCATION: WHISPER WAY, DACULA

DACULA, GEORGIA COUNTY

- LAND LOTS 302 & 303, 5TH DISTRICT
- PROPOSED USE AND DESCRIPTION OF CONSTRUCTION ACTIVITY: STORM DRAINAGE SYSTEM
- TOTAL SITE AREA: 0.11 ACRES
- TOTAL DISTURBED AREA: 0.11 ACRES
- OWNER/DEVELOPER/PRIMARY PERMITTEE: THE CITY OF DACULA 442 HARBINS ROAD DACULA, GA 30019

(770) 963-7451

SECONDARY PERMITTEES:

NAME:	NAME:	
COMPANY:	COMPANY:	
ADDRESS:	ADDRESS:	
PHONE NO:	PHONE NO:	
FAX NO:	FAX NO:	
·		
SIGNATURE:	SIGNATURE:	

24 HOUR LOCAL CONTACT FOR EROSION, SEDIMENTATION AND POLLUTION CONTROL: BRITTNI NIX PHONE: 770-963-7451

THERE ARE NOT STATE WATERS LOCATED ON-SITE. NO CREEK BUFFERS.

- 10. THE WETLAND INVENTORY MAP HAS BEEN CONSULTED AND SHOW THAT WETLANDS ARE NOT LOCATED ON THE SITE, HOWEVER THE SITE WAS EXAMINED BY A WETLAND SPECIALIST AND THERE ARE WETLANDS LOCATED ON THE SITE WITHIN THE BUFFERS OF THE STATE WATERS.
- 11. RECEIVING WATER(S) IS: OF HOPKINS CREEK
- 12. SOIL SERIES FOR THE PROJECT SITE INCLUDE: AmC2 & WkB.
- 13. DESCRIPTION OF THE MEASURES TO BE INSTALLED DURING CONSTRUCTION PROCESS TO CONTROL POLLUTANTS IN STORMWATER THAT WILL OCCUR AFTER CONSTRUCTION OPERATIONS HAVE BEEN COMPLETED: PRODUCT SPECIFIC PRACTICES

PETROLEUM BASED PRODUCTS - CONTAINERS FOR PRODUCTS SUCH AS FUELS, LUBRICANTS, AND TARS WILL BE INSPECTED DAILY FOR LEAKS AND SPILLS. THIS INCLUDES ONSITE VEHICLES AND MACHINERY DAILY INSPECTIONS AND REGULAR PREVENTATIVE MAINTENANCE OF SUCH EQUIPMENT. EQUIPMENT MAINTENANCE AREAS WILL BE LOCATED AWAY FROM STATE WATERS, NATURAL DRAINS, AND STORM WATER DRAINAGE INLETS. IN ADDITION, TEMPORARY FUELING TANKS SHALL HAVE A SECONDARY CONTAINMENT LINER TO PREVENT/MINIMIZE SITE CONTAMINATION. DISCHARGE OF OILS, FUELS, AND LUBRICANTS IS PROHIBITED. PROPER DISPOSAL METHODS WILL INCLUDE COLLECTION IN A SUITABLE CONTAINER AND DISPOSAL AS REQUIRED BY LOCAL AND STATE REGULATIONS.

PAINTS/FINISHES/SOLVENTS - ALL PRODUCTS WILL BE STORED IN TIGHTLY SEALED ORIGINAL CONTAINERS WHEN NOT IN USE. EXCESS PRODUCTS WILL NOT BE DISCHARGED TITHE STORM WATER COLLECTION SYSTEM. EXCESS PRODUCT, MATERIALS USED WITH THESE PRODUCTS, AND PRODUCT CONTAINERS WILL BE DISPOSED OF ACCORDING TO MANUFACTURER'S SPECIFICATIONS AND RECOMMENDATIONS.

CONCRETE TRUCK WASHING - NO CONCRETE TRUCKS WILL BE ALLOWED TO WASH OUT OR DISCHARGE SURPLUS CONCRETE OR DRUM WASH WATER ONSITE.

FERTILIZER/HERBICIDES - THESE PRODUCTS WILL BE APPLIED AT RATES THAT DO NOT EXCEED THE MANUFACTURER'S SPECIFICATIONS OR ABOVE THE GUIDELINES SET FORTH IN THE CROP ESTABLISHMENT OR IN THE GSWCC MANUAL FOR EROSION AND SEDIMENT CONTROL IN GEORGIA. ANY STORAGE OF THESE MATERIALS WILL BE UNDER ROOF IN SEALED CONTAINERS. BUILDING MATERIALS - NO BUILDING OR CONSTRUCTION MATERIALS WILL BE BURIED OR DISPOSED OF ON-SITE. ALL SUCH

- MATERIAL WILL BE DISPOSED OF IN PROPER WASTE DISPOSAL PROCEDURES. 14. INITIAL PERIMETER BEST MANAGEMENT PRACTICES (BMP'S): Co, Sd1, Du, Ds1, Ds2, St, Tr.
- 15. INTERMEDIATE GRADING AND DRAINAGE BMP'S: Sd1, Ds1, Ds2, Du, Co, St, Sd2-F/P, & Tr.
- 16. FINAL BMP'S: Ds3, St, Sd2-P.
- 17. THIS SITE DOES NOT LIE WITHIN A 100 YEAR FLOOD HAZARD AREA PER FIRM MAP 13135C0062F, DATED 9/29/2006.
- 18. ESTIMATE OF PRE-CONSTRUCTION 25 YEAR PEAK DISCHARGE FLOW AT 1A = 41.17 CFS
- 19. ESTIMATE OF POST-CONSTRUCTION 25 YEAR PEAK DISCHARGE FLOW AT 1A = 41.16 CFS
- 20. CRITICAL AREAS LOCATED ON-SITE ARE IDENTIFIED AS: Ss. AT THE END OF EACH WORK DAY ALL SLOPES 2:1 OR STEEPER AND HIGHER THAN 5 FEET SHALL RECEIVE SURFACE ROUGHENING, POLYMERS, AND EROSION CONTROL MATTING. ADDITIONALLY, ALL FILL SLOPES SHALL RECEIVE A DIVERSION DIKE AND TEMPORARY DOWN DRAINS ALONG THE TOP OF THE SLOPE PREVENTING DRAINAGE SPILLING OVER THE EDGE AND DOWN THE FACE OF THE SLOPE. THE TEMPORARY DOWN DRAINS SHALL BE CONSTRUCTED WITH PERFORATED STAND PIPES AT THE TOP OF THE SLOPE AND RECONSTRUCTED EACH DAY AS THE SLOPE
- 21. "THE ESCAPE OF SEDIMENT FROM THE SITE SHALL BE PREVENTED BY THE INSTALLATION OF EROSION AND SEDIMENT CONTROL MEASURES AND PRACTICES PRIOR TO LAND DISTURBING ACTIVITIES."
- 22. "EROSION CONTROL MEASURES WILL BE MAINTAINED AT ALL TIMES. IF FULL IMPLEMENTATION OF THE APPROVED PLAN DOES NOT PROVIDE FOR EFFECTIVE EROSION CONTROL, ADDITIONAL EROSION AND SEDIMENT CONTROL MEASURES SHALL BE IMPLEMENTED TO CONTROL OR TREAT THE SEDIMENT SOURCE.'
- 23. "ANY DISTURBED AREA LEFT EXPOSED FOR A PERIOD GREATER THAN 14 DAYS SHALL BE STABILIZED WITH MULCH OR TEMPORARY SEEDING."
- 24. "STABILIZATION MEASURES SHALL BE INITIATED AS SOON AS PRACTICABLE IN PORTIONS OF THE SITE WHERE CONSTRUCTION ACTIVITIES HAVE TEMPORARILY OR PERMANENTLY CEASED, BUT IN NO CASE MORE THAN 14 DAYS AFTER THE CONSTRUCTION ACTIVITY IN THAT PORTION OF THE SITE HAS TEMPORARILY CEASED. WHERE THE INITIATION OF STABILIZATION MEASURES BY THE 14TH DAY AFTER CONSTRUCTION ACTIVITY TEMPORARILY OR PERMANENTLY CEASES IS PRECLUDED BY SNOW COVERS OR OTHER ADVERSE WEATHER CONDITIONS. STABILIZATION MEASURES SHALL BE INITIATED AS SOON AS PRACTICABLE. WHERE CONSTRUCTION ACTIVITY WILL RESUME ON A PORTION OF THE SITE WITHIN 21 DAYS FROM WHEN ACTIVITIES CEASE, (E.G. THE TOTAL TIME PERIOD THAT CONSTRUCTION ACTIVITY IS TEMPORARILY CEASED IS LESS THAN 21 DAYS) THE STABILIZATION MEASURES DO NOT HAVE TO BE INITIATED ON THAT PORTION OF THE SITE BY THE 14TH DAY AFTER CONSTRUCTION ACTIVITY HAS TEMPORARILY CEASED."
- 25. "TEMPORARY SEDIMENT BASIN, RETROFITTED DETENTION POND, AND/OR EXCAVATED INLET SEDIMENT TRAPS FOR EACH COMMON DRAINAGE LOCATION PROVIDING A MINIMUM 67 CUBIC YARDS OF SEDIMENT STORAGE PER ACRE DRAINED MUST BE IN PLACE PRIOR TO AND DURING ALL LAND DISTURBING ACTIVITIES UNTIL FINAL STABILIZATION OF THE SITE HAS BEEN ACHIEVED."
- 26. "SEDIMENT STORAGE MAINTENANCE INDICATORS MUST BE INSTALLED IN SEDIMENT STORAGE STRUCTURES, INDICATING THE 1/3

27. "CONTRACTOR TO CLEAN OUT ACCUMULATED SILT IN DETENTION POND AT THE END OF CONSTRUCTION ACTIVITIES WHEN THE

- DISTURBED AREAS HAVE BEEN STABILIZED. 28. "CONTRACTOR TO PROVIDE DETENTION POND AS-BUILTS AND RECORD DRAWINGS THAT SHALL INCLUDE TOPO OF POND TO CALCULATE POND VOLUMES AND OUTLET CONTROL STRUCTURE DETAILS AND INFORMATION TO COMPLETE AN AS-BUILT
- HYDROLOGY STUDY TO VERIFY THAT THE DETENTION POND WILL FUNCTION AS IT WAS DESIGNED." 29. "MAINTENANCE OF ALL SOIL EROSION AND SEDIMENTATION CONTROL MEASURES AND PRACTICES, WHETHER TEMPORARY OR PERMANENT, SHALL BE AT ALL TIMES THE RESPONSIBILITY OF THE PROPERTY OWNER."
- "ADDITIONAL SOIL EROSION CONTROL MEASURES WILL BE ADDED IF DETERMINED TO BE NEEDED BY ON-SITE INSPECTIONS."
- 31. "STANDARDS AND SPECIFICATIONS: ALL DESIGN SHALL CONFORM TO AND ALL WORK SHALL BE PERFORMED IN ACCORDANCE WITH THE STANDARDS AND SPECIFICATIONS OF THE PUBLICATION ENTITLED "MANUAL FOR EROSION AND SEDIMENT CONTROL" BY THE GA. SOIL & WATER CONSERVATION COMMISSION."
- 32. "NON-EXEMPT ACTIVITIES SHALL NOT BE CONDUCTED WITHIN THE 25 OR 50-FOOT UNDISTURBED STREAM BUFFERS AS MEASURED FROM THE POINT OF WRESTED VEGETATION OR WITHIN 25-FEET OF THE COASTAL MARSHLAND BUFFER AS MEASURED FROM THE JURISDICTIONAL DETERMINATION LINE WITHOUT FIRST ACQUIRING THE NECESSARY VARIANCES AND PERMITS."
- 33. "CONCENTRATED FLOW AREAS AND ALL SLOPES STEEPER THAN 2.5:1 WITH A HEIGHT OF TEN FEET OR GREATER SHALL BE STABILIZED WITH THE APPROPRIATE EROSION CONTROL MATTING OR BLANKET."
- 34. "ALL CUT AND FILL SLOPES MUST BE SURFACED ROUGHENED AND VEGETATED WITHIN SEVEN (7) DAYS OF THEIR CONSTRUCTION.
- CUT AND FILL OPERATIONS SHALL BE KEPT TO A MINIMUM." 35. "ADEQUATE PROVISIONS SHALL BE PROVIDED TO MINIMIZE DAMAGE FROM SURFACE WATER TO THE CUT FACE OF EXCAVATIONS
- OR THE SLOPING SURFACES OF FILLS." 36. "GRADING OPERATIONS SHALL NOT ENDANGER ADJOINING PROPERTIES."

- "STRIPPING OF VEGETATION, REGRADING, AND OTHER DEVELOPMENT ACTIVITIES SHALL BE CONDUCTED IN SUCH A MANNER SO AS TO MINIMIZE EROSION."
- 38. FILLS SHALL NOT ENCROACH UPON NATURAL COURSES OR CONSTRUCTED CHANNELS IN A MANNER SO AS TO ADVERSELY AFFECT OTHER PROPERTY OWNERS."
- "ALL FILL SLOPES SHALL HAVE SILT FENCE PLACED AT THE SLOPE'S TOE."
- "CONTRACTOR SHALL REMOVE ALL SILT FENCE AND ALL OTHER TEMPORARY EROSION SEDIMENTATION AND POLLUTION CONTROL MEASURES ONCE SITE IS FINAL STABILIZED AND AFTER ALL GRASSING REQUIREMENTS HAVE BEEN COMPLETED BY THE CONTRACTOR TO THE OWNER'S AND CODE SATISFACTION AND BEFORE THE CONTRACTOR LEAVES THE SITE."
- 41. "ALL WASTE DISPOSAL SHALL BE HAULED OFF TO A STATE AUTHORIZED LANDFILL. NO WASTE/DEBRIS MATERIAL WILL BE BURIED. ON-SITE WITHOUT COUNTY/STATE PERMIT. SOLID MATERIALS, INCLUDING BUILDING MATERIALS, SHALL NOT BE DISCHARGED TO WATERS OF THE STATE, EXCEPT AS AUTHORIZED BY A SECTION 404 PERMIT FROM THE U.S. ARMY CORPS OF ENGINEERS (NATIONAL POLLUTANT DISCHARGE ELIMINATION SYSTEM (NPDES) IV.D.2.C.(1)."
- "ALL PERMITTEE'S SHALL ENSURE AND DEMONSTRATE THAT THE SITE IS IN COMPLIANCE WITH THE ES&PC PLAN WITH RESPECT TO ALL APPLICABLE STATE AND LOCAL WASTE WATER DISPOSAL, SANITARY SEWER OR SEPTIC SYSTEM REGULATIONS. (NPDES IV.D.2.C.(3)."
- 43. "CONTRACTOR SHALL MAINTAIN CONSTRUCTION EXITS TO PREVENT TRACKING OF MUD INTO PUBLIC RIGHT-OF-WAY."
- "OFF-SITE VEHICLE TRACKING OF DIRT, SOILS, AND SEDIMENTS AND THE GENERATION OF DUST SHALL BE MINIMIZED OR ELIMINATED TO THE MAXIMUM EXTENT PRACTICAL (NPDES IV.D.2.C.(2). CONTRACTOR SHALL USE PM-POLYACRYLAMIDE (PAM) FOR DUST CONTROL, ETC. AT CONSTRUCTION EXITS, VEHICLE WASHING AREAS AND ANY OTHER AREAS WHERE SEDIMENT CAN BE
- 45. "CONTRACTOR TO FURNISH AND INSTALL APS 600 SERIES 'SILT STOP' AS MANUFACTURED BY APPLIED POLYMER SYSTEMS, NORCROSS GA. OR EQUAL AT A RATE OF 1.5 GALLONS/ACRE IN A HYDROSEEDER MIX OF APPROPRIATE SEED, FERTILIZER, LIME AND MULCH FOR THE SAME ACRE ON ALL DISTURBED OR EXPOSED SOIL SURFACES. FOLLOW ALL MANUFACTURER'S INSTRUCTIONS AND RECOMMENDATIONS. DO NOT MECHANICALLY DISTURB TREATED AREAS AFTER APPLICATION."
- "CONTRACTOR SHALL INSPECT ALL VEHICLES AND PETROLEUM STORAGE CONTAINERS REGULARLY, MAKING REPAIRS TO MINIMIZE ALL PETROLEUM SPILLS AND LEAKS AND SHALL KEEP ON HAND DRY, POROUS PETROLEUM ABSORBENT MATERIALS SUCH AS VERMICULITE, SAND AND LEAN SOIL, AND SHALL CLEAN UP ALL SAID SPILLS AND DISPOSE OF SAID MATERIALS IN ACCORDANCE WITH ALL STATE AND FEDERAL REGULATIONS (NPDES IV.D.2.C.(4)."
- "NO CONSTRUCTION ACTIVITIES SHALL BE CONDUCTED WITHIN A STREAM BUFFER AND THE STREAM BUFFER SHALL REMAIN IN ITS UNDISTURBED, STATE OF VEGETATION UNTIL ALL LAND-DISTURBING ACTIVITIES ON THE CONSTRUCTION SITE ARE COMPLETED.
- 48. THE DESIGN PROFESSIONAL WHO PREPARED THE ES&PC PLAN IS TO INSPECT THE INSTALLATION OF THE INITIAL SEDIMENT STORAGE REQUIREMENTS AND PERIMETER CONTROLS BMPS WITHIN 7 DAYS AFTER INSTALLATION. PROOF OF SITE VISIT SHALL
- 49. "NON-STORM WATER DISCHARGES SUCH AS FIRE HYDRANT FLUSHING, POTABLE WATER SOURCES INCLUDING WATER LINE FLUSHING; IRRIGATION DRAINAGE; AIR CONDITIONING CONDENSATE; SPRINGS; UNCONTAMINATED GROUNDWATER; AND FOUNDATION OR FOOTING DRAINS ARE TO BE TREATED IN THE SAME MANNER AS STORM WATER DISCHARGES."
- "CONTRACTOR SHALL MONITOR, REPORT REQUIREMENTS, AND RETAIN RECORDS PER THE GENERAL NPDES PERMIT NO. GAR 100003. "CONTRACTOR SHALL COMPLY WITH ALL REQUIREMENTS AS SET FORTH IN THE GENERAL NPDES PERMIT NO. GAR 100003.'
- 51. "A 25 FOOT BUFFER ADJACENT TO ALL STREAMS, CREEKS, LAKES, PONDS, ETC. IS REQUIRED TO BE MAINTAINED BY THE SOIL EROSION CONTROL AND SEDIMENT CONTROL ORDINANCE (ARTICLE 4 SECTION 4.3 PARAGRAPH 15). AN EXEMPTION IS GRANTED TO HOMEOWNERS WHO PERFORM MINOR LANDSCAPING ACTIVITIES SUCH AS HOME LANDSCAPING, HOME GARDENS, REPAIRS AND MAINTENANCE WORK . (ARTICLE 3 SECTION 3.1 PARAGRAPH 3)."
- "CONTRACTOR SHALL ACQUIRE A COPY OF "FIELD MANUAL FOR EROSION AND SEDIMENT CONTROL IN GEORGIA, VEGETATION AND STRUCTURAL BEST MANAGEMENT PRACTICES (BMP'S) FOR LAND DISTURBING ACTIVITIES, AS PUBLISHED BY THE GEORGIA SOIL AND WATER CONSERVATION COMMISSION, LATEST EDITION."
- "THE PRIMARY PERMITEE MUST KEEP AN APPROVED ES&PC PLAN ON-SITE. PRIMARY PERMITEE MUST MAINTAIN A BMP INSPECTION LOG, A DAILY RAINFALL LOG BOOK, AND A DAILY CONSTRUCTION ENTRANCE/EXIT AREA LOG BOOK. TURBIDITY DATA MUST BE KEPT UP-TO-DATE AND ON-SITE. (NPDES IV.D.5.A.(3)."
- "THE PRIMARY PERMITTEE MUST SAMPLE ALL RECEIVING WATER(S), AND/OR ALL OUTFALLS, OR A COMBINATIONOF RECEIVING WATERS AND OUTFALLS. RECEIVING WATERS MUST HAVE AN UPSTREAM AND DOWNSTREAM SAMPLE LOCATION. (NPDES IV.D.5.C.(1)." "NPDES SAMPLING FOR ALL MONITORING POINTS ON THIS SITE WILL BE BY GRAB SAMPLE METHOD. SAMPLES WILL BE PERFORMED BY THE PRIMARY PERMITTEE OR ITS AGENT TAKEN AND ANALYZED NO LATER THAN 48 HOURS AFTER A GRAB SAMPLES SHALL BE COLLECTED WHERE THE STREAM IS WELL MIXED FROM HORIZONTAL AND VERTICAL CENTER OF FLOW. WHEN COLLECTING THE SAMPLE. FACE SAMPLING CONTAINER UPSTREAM AND DO NOT STIR SEDIMENT AT BOTTOM OF STREAM, LIFT SAMPLE OUT OF STREAM KEEPING SAMPLES FREE OF FLOATING DEBRIS. AFTER SAMPLES HAVE BEEN COLLECTED IT SHALL BE ANALYZED USING A DIRECT READ, PROPERLY CALIBRATED TURBIDIMETER WITHIN 48 HOURS. (NPDES IV.D.5.A.(2) * FOR THIS SITE THE GRAB METHOD WILL BE USED FOR UPSTREAM MONITORING POINTS 'MP-1' AND DOWNSTREAM MONITORING

POINTS 'MP-2' * SEE ADDITIONAL PERMIT COVERAGE NOTES THIS SHEET FOR AUTHORIZED COVERAGE, LIMITATIONS OF COVERAGE, WATER AND FREQUENCY.

- QUALITY COMPLIANCE, SAMPLING METHODOLOGY 55. "THE PRIMARY PERMITTEE MAY USE AN ALTERNATE DESIGN PROFESSIONAL TO CONDUCT THE SEVEN (7) DAY BMP INSPECTION, PROVIDED THAT THE PRIMARY MAKES A WRITTEN REQUEST TO EPD TO CHANGE FROM THE DESIGN PROFESSIONAL WHO DEVELOPED THE PLAN AND THE E.P.D. HAS AGREED."
- "PRIMARY PERMITTEE IS TO PROVIDE EACH SECONDARY PERMITTEE WITH THE APPLICABLE PORTION OF THE ES&PC THAT PERTAINS TO THEIR CONSTRUCTION ACTIVITY AND EACH SECONDARY PERMITTEE SHALL SIGN THE PLAN OR PORTION OF THE PLAN APPLICABLE TO THEIR SITE. NOT APPLICABLE FOR STAND ALONE AND INFRASTRUCTURE PROJECTS." SECONDARY
- "AMENDMENTS/REVISIONS TO THE ES&PC PLAN WHICH HAVE A SIGNIFICANT EFFECT ON BMP'S WITH A HYDRAULIC COMPONENT MUST BE CERTIFIED BY THE DESIGN PROFESSIONAL."
- CONTRACTOR TO PROVIDE BMPS FOR CONCRETE WASHDOWN OF TOOLS, CONCRETE MIXER CHUTES, HOPPERS AND THE REAR OF THE VEHICLES. WASHOUT OF THE DRUM AT THE CONSTRUCTION SITE IS PROHIBITED.
- ""WASTE MATERIALS SHALL NOT BE DISCHARGED TO WATERS OF THE STATE, EXCEPT AS AUTHORIZED BY A SECTION 404 PERMIT."
- APPROVED PLANS AND NPDES DAILY LOG MUST BE ON SITE AT ALL TIMES.
- 61. SEDIMENT STORAGE VOLUME MUST BE IN PLACE PRIOR TO AND DURING ALL LAND DISTURBING ACTIVITIES UNTIL FINAL
- STABILIZATION OF THE SITE HAS BEEN ACHIEVED.

PERMITTEE UNKNOW AT THE TIME OF NDPES PERMITTING.

- 62. PETROLEUM STORAGE SHALL BE DONE IN ACCORDANCE WITH ONE OF THE FOLLOWING METHODS TO PREVENT STORM WATER DISCHARGES ON THE SITE.
- a. ALL PETROLEUM STORAGE CONTAINERS SHALL BE COVERED WITH PLASTIC SHEETING OR BE LOCATED UNDER A TEMPORARY
- b. ALL PETROLEUM STORAGE CONTAINERS SHALL BE LOCATED IN A SECONDARY CONTAINMENT AREA.



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CONSULTANT PROJECT # 200510-01-001



EXP. DATE 09-27-24 PLAN STATUS 2024/1/22 FOR CONSTRUCTION

LEVEL II E&S CERT.#945

DATE DESCRIPTION KDW | RWH | KDW DESIGN DRAWN CHKD SCALE

200510-01-00 01/22/2024


HEET No.

24 HOUR CONTACT

BRITTNI NIX

CONTACT NUMBER

(770) 963-7451

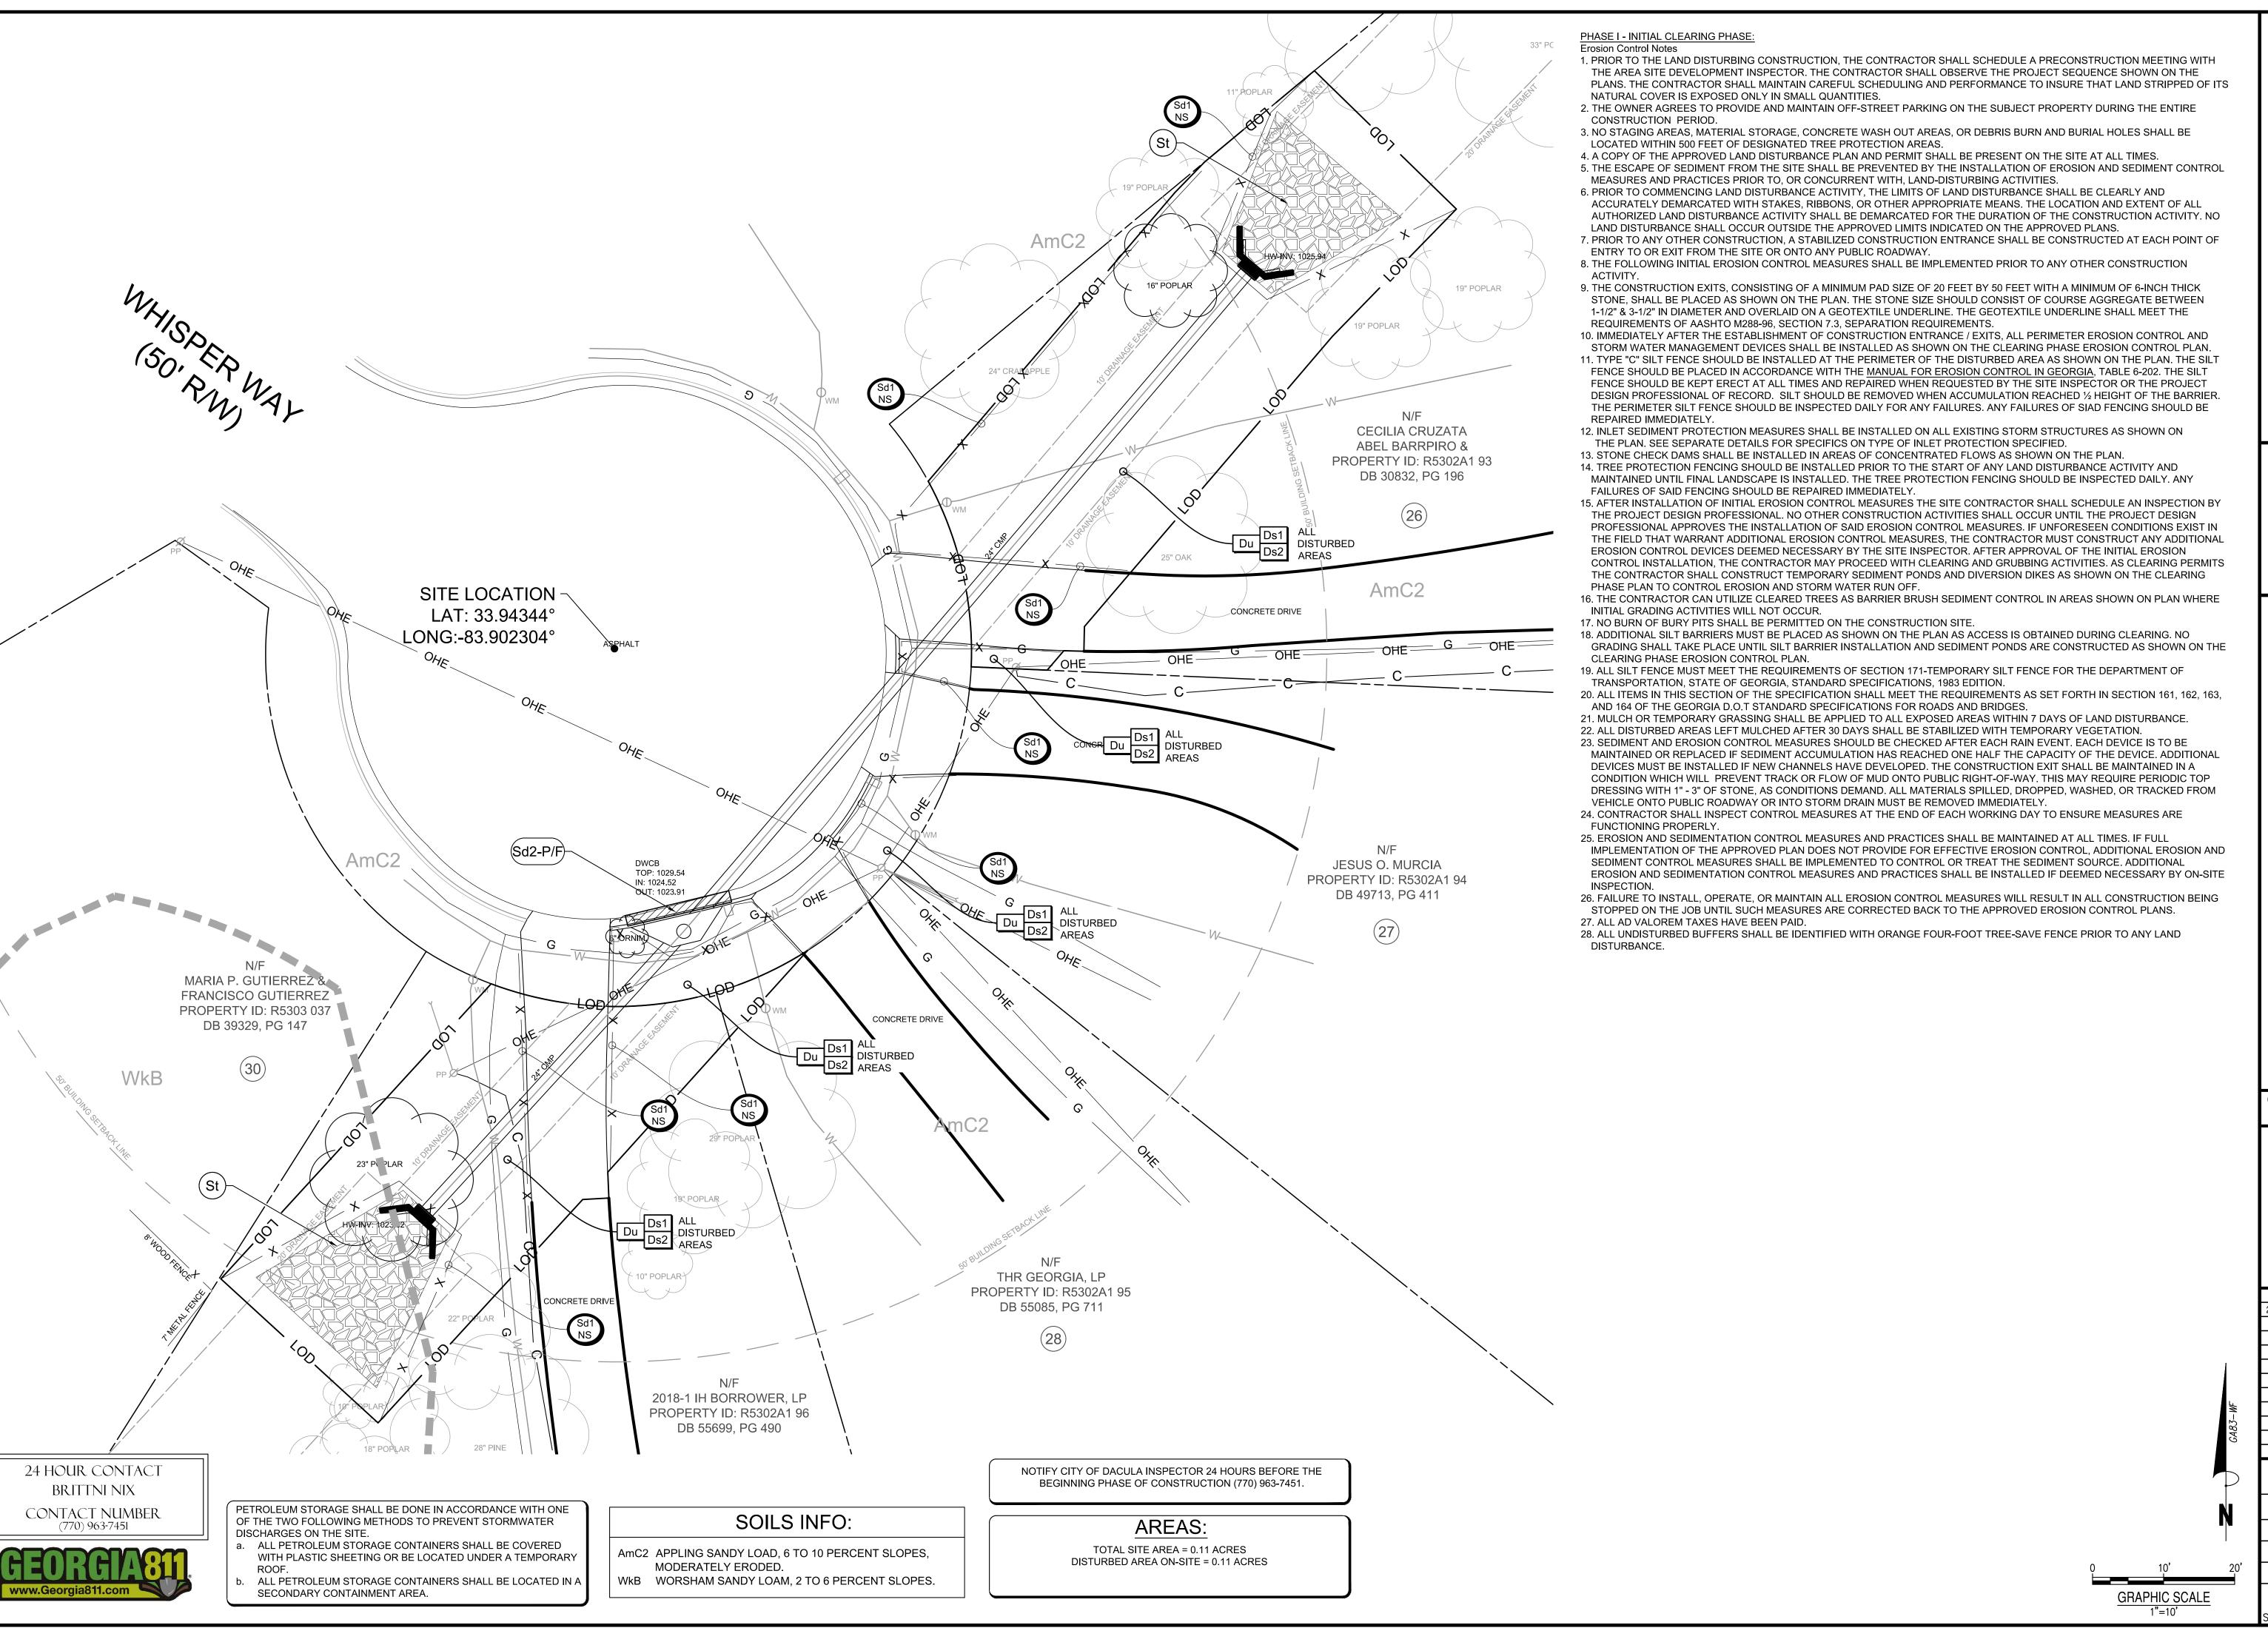

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CONSULTANT PROJECT # 200510-01-001



LEVEL II E&S CERT.#945 EXP. DATE 09-27-24 PLAN STATUS


2024/1/22 FOR CONSTRUCTION

DATE DESCRIPTION

DESIGN | DRAWN | CHKD 1" = 20'

200510-01-00 01/22/2024

C4.1 SHEET No.

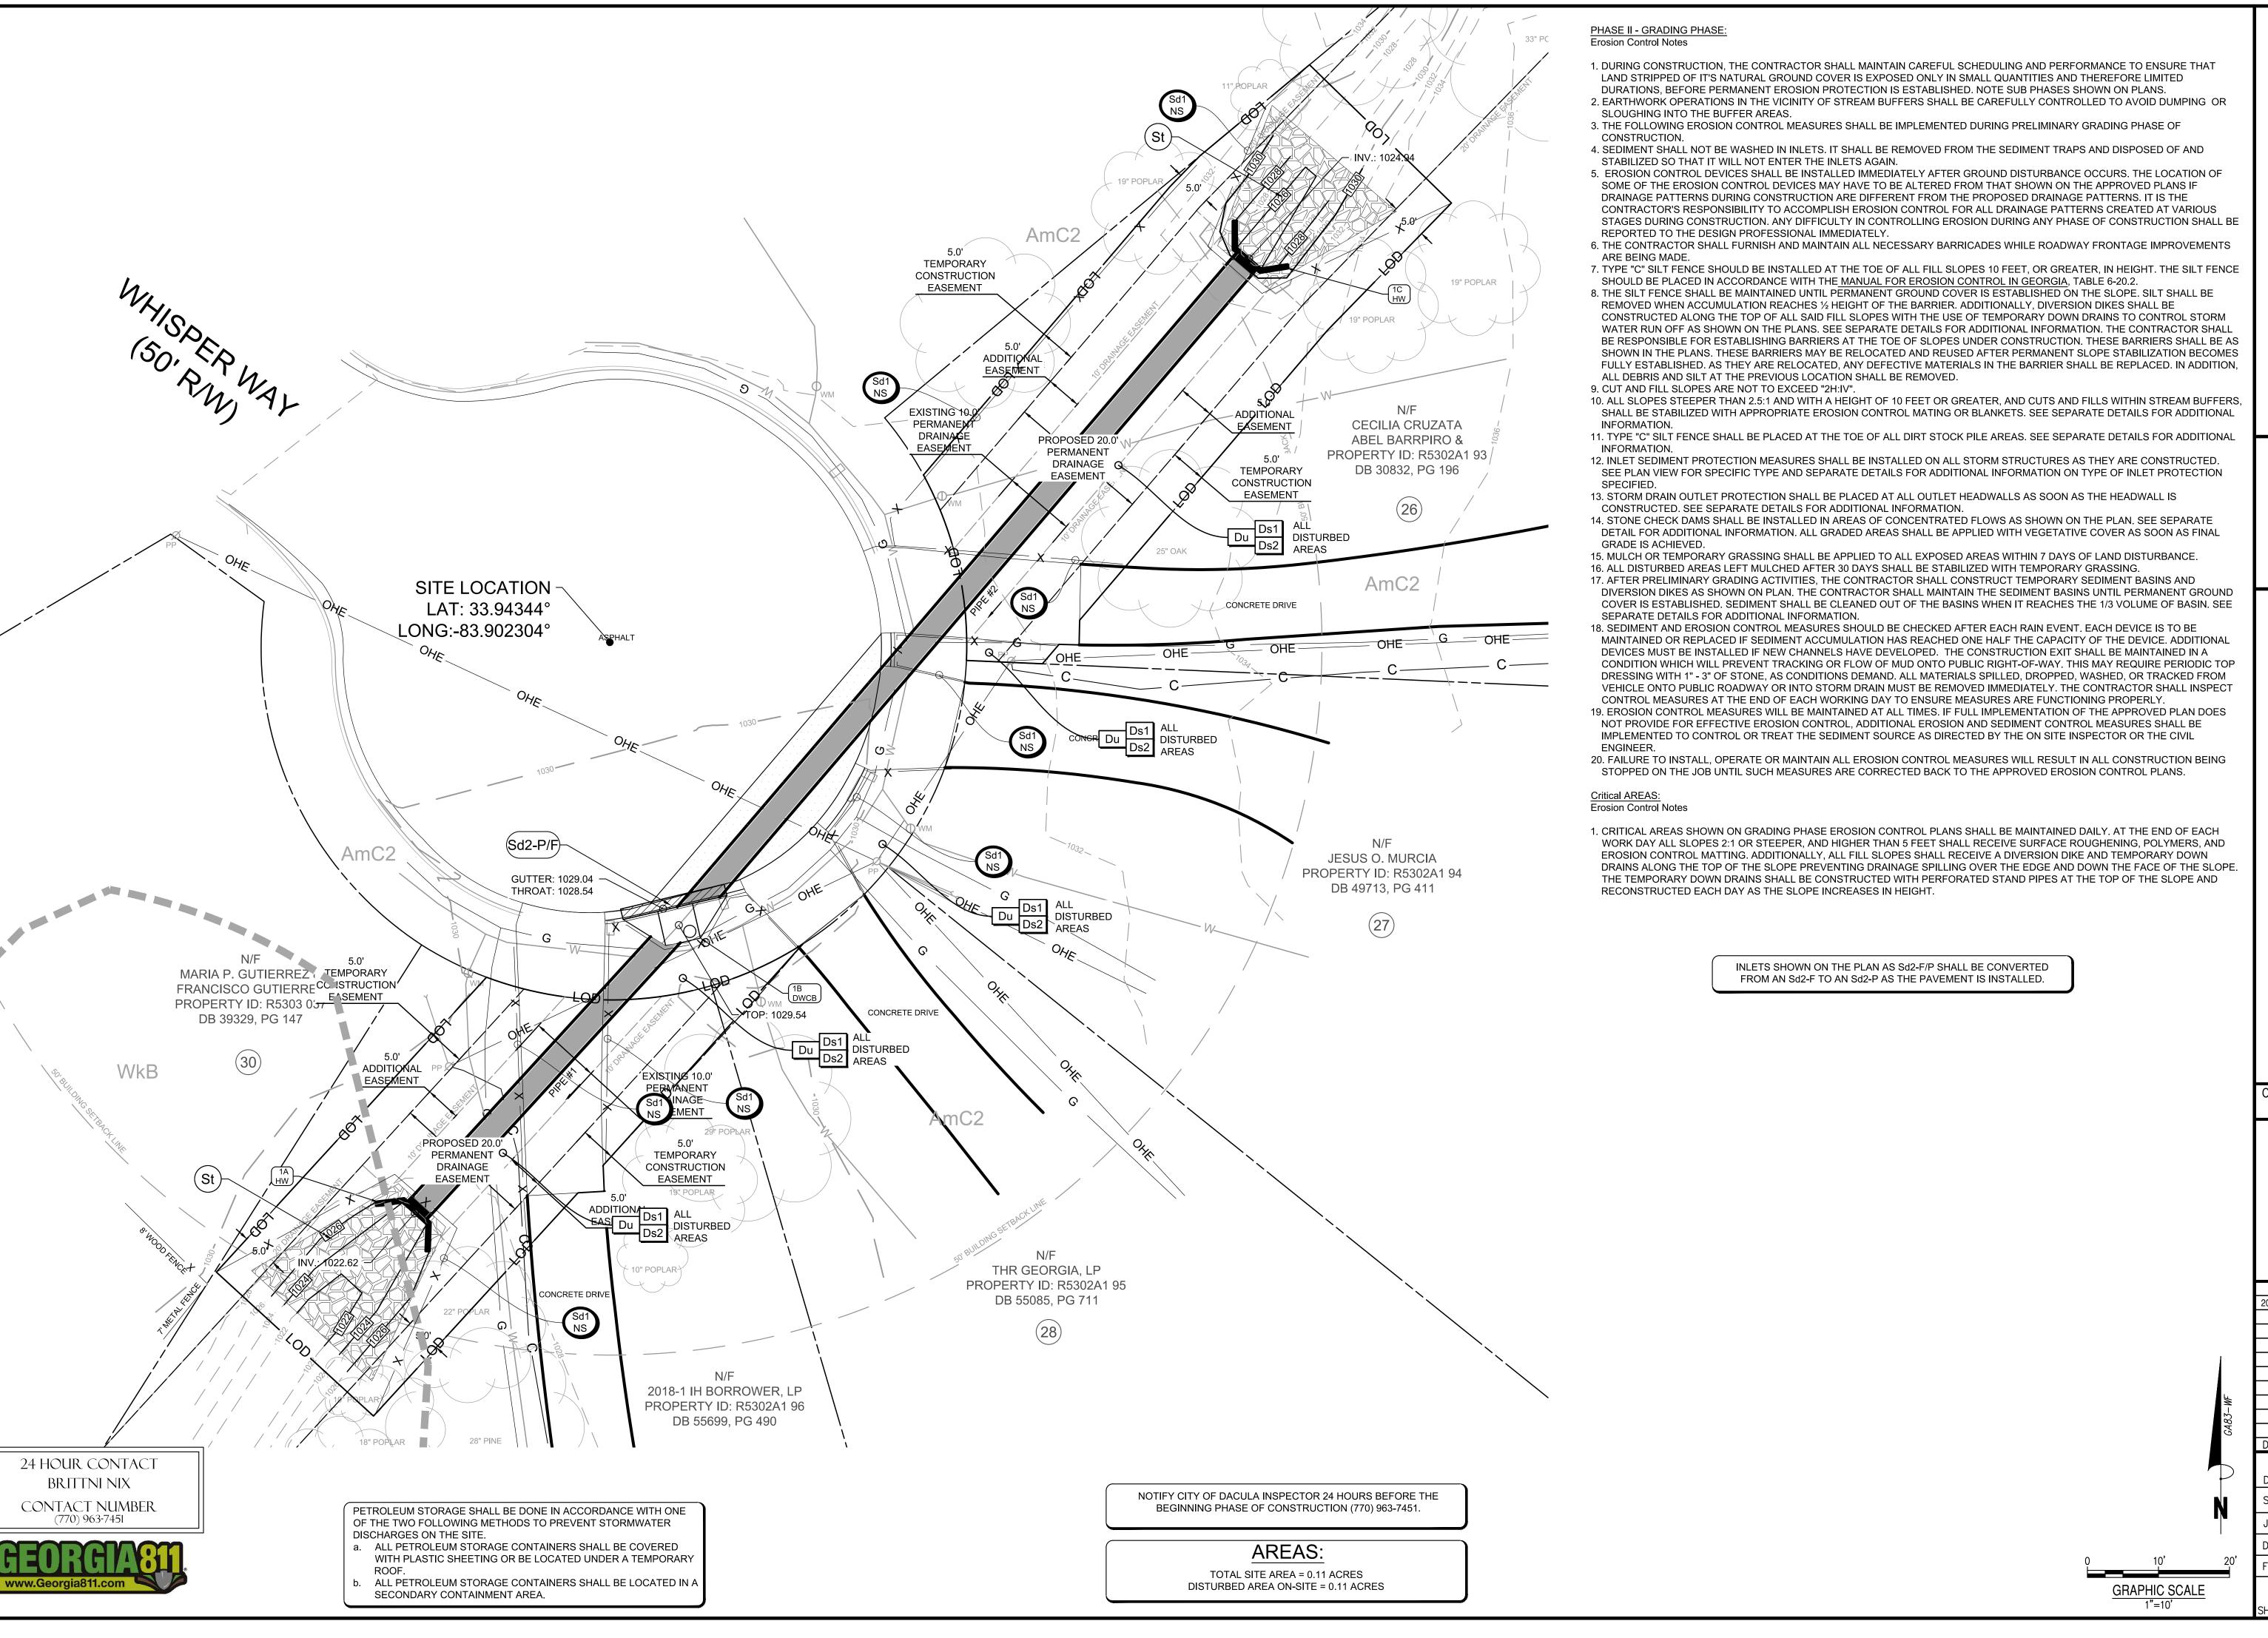

Certificate of Authorization License No. LSF001241

Suwanee, GA 30024
Phone: (770) 932-6550
www.bowman.com

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WAY STORM IMP

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CONSULTANT PROJECT # 200510-01-001

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EXP. DATE 09-27-24

PLAN STATUS

2024/1/22 FOR CONSTRUCTION

DATE DECODIDION

DATE DESCRIPTION

KDW RWH KDW


DESIGN DRAWN CHKD

SCALE 1" = 20'

JOB No. 200510-01-001

No. 200510-01-001 : 01/22/2024 No.

C4.2 SHEET No.

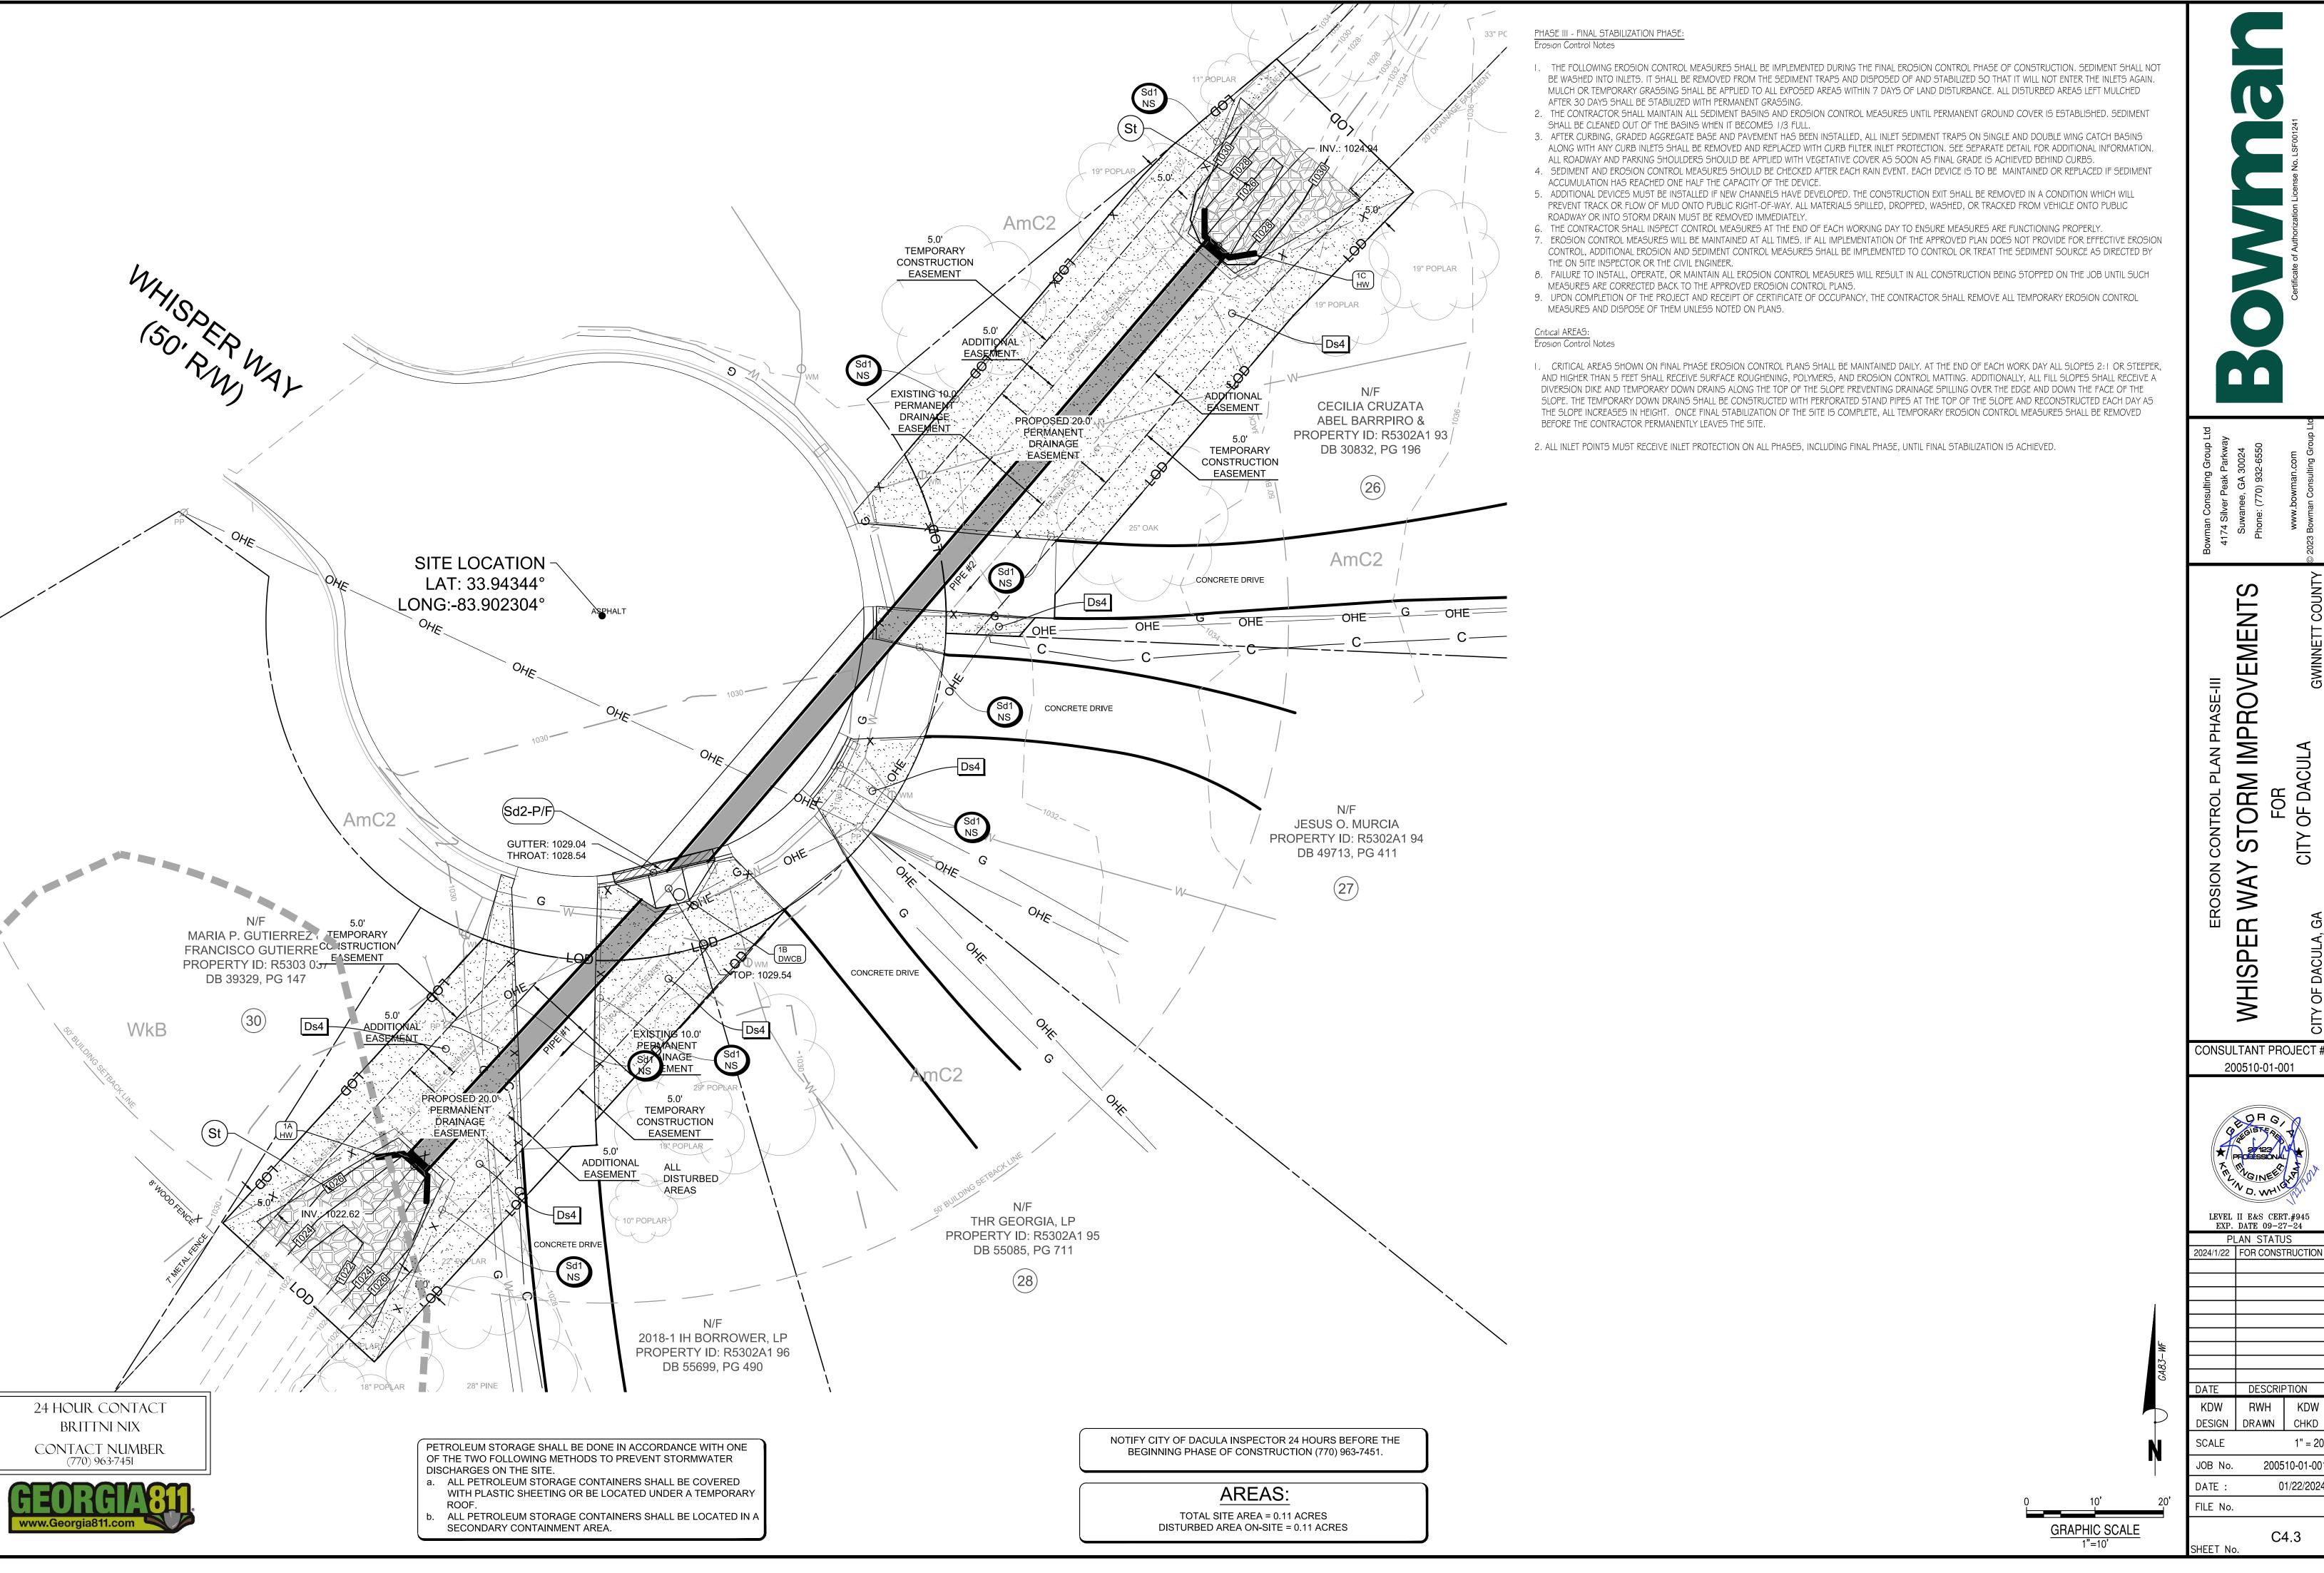


CONSULTANT PROJECT # 200510-01-001




DATE | DESCRIPTION DESIGN | DRAWN | CHKD

200510-01-001 01/22/2024

C4.3

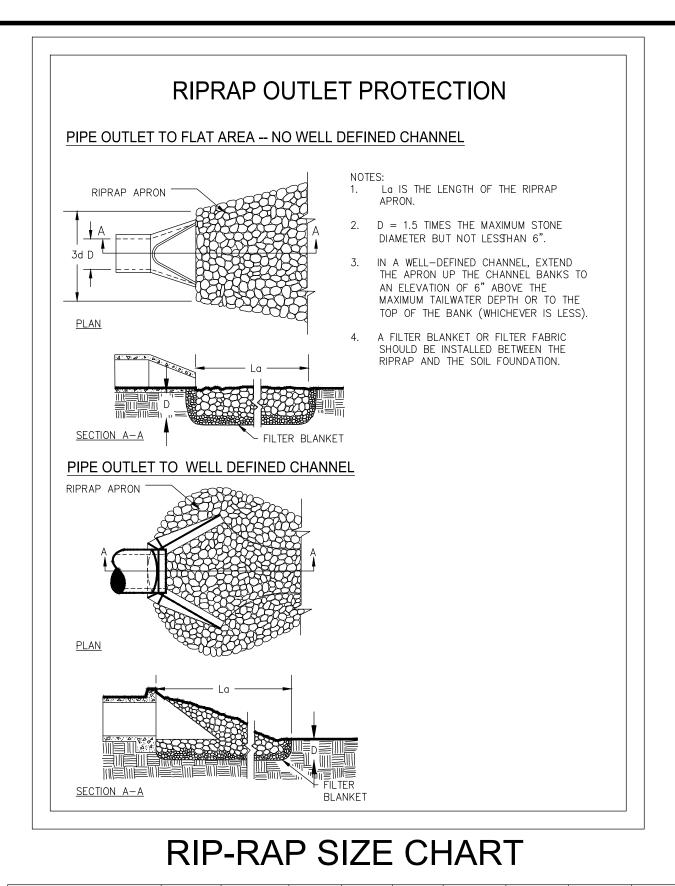

CURB INLET FILTER "PIGS IN BLANKET" 8" CONCRETE BLOCK WRAPPED IN FILTER FABRIC — CATCH BASIN ← GUTTER PAVEMENT NOTES: 1. INSTALL FILTER AFTER ANY ASPHALT PAVEMENT INSTALLATION. 2. WRAP 8" CONCRETE BLOCKS IN FILTER FABRIC AND SPAN ACROSS CATCH BASIN INLET. 3. FACE OPENINGS IN BLOCKS 4. LEAVE A GAP OF APPROXIMATELY PAVEMENT — 4 INCHES BETWEEN THE CURB GUTTER -AND THE FILTERS TO ALLOW FOR OVERFLOW TO PREVENT 8" CONCRETE -HAZARDOUS PONDING. BLOCK WRAPPED INSTALL OUTLET PROTECTION IN FILTER FABRIC BELOW STORM DRAIN OUTLETS CATCH BASIN 8" CONCRETE BLOCKS WRAPPED IN FILTER FABRIC --- CURB APRON (GUTTER) --- PAVEMENT

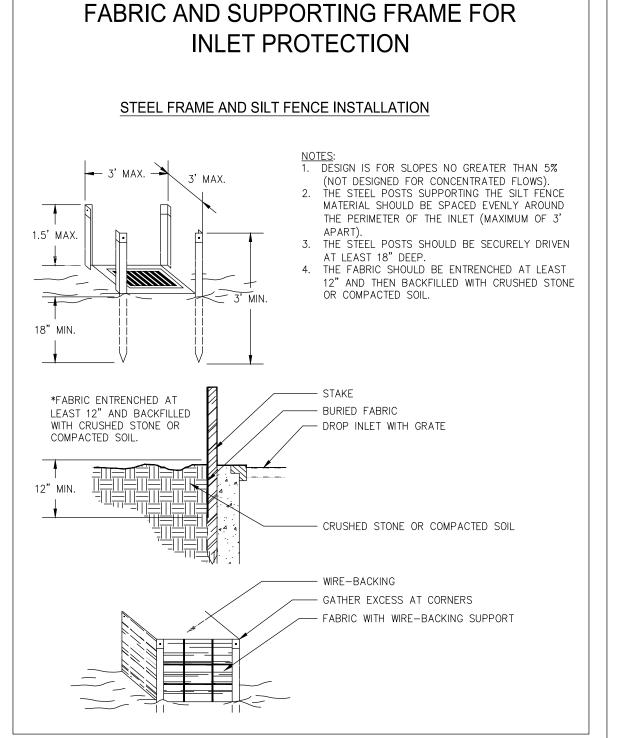





OUTLET PROTECTION

STRUCTURES

|MONTH|MONTH|MONTH|MONTH|MONTH|MONTH|MONTH|MONTH|MONTH|MONTH|MONTH|MONTH 1 | 2 | 3 | 4 | 5 | 6 | 7 | 8 | 9 | 10 | 11 | 12 | 13 | 14 | 15 START CONSTRUCTION 8/1/2016 INSTALLATION OF SILT FENCE CLEARING & GRUBBING GRADING INSTALLATION OF STORM WATER STRUCTURES AND PIPES TEMPORARY GRASSING PERMANENT VEGETATION MAINTENANCE OF EROSION CONTROL MEASURES REMOVE TEMPORARY STRUCTURES

La

WATER

PROPOSED HW 1C | 36" | 31.02 | 7.71 | MIN | 20' | 9.0' | 23' | 0.60' | 0.90' | 1.35'

EROSION CONTROL CONSTRUCTION SCHEDULE

PROPOSED HW 1A | 36" | 41.16 | 8.30 | MAX | 20' | 9.0' | 23' | 0.60'

THIS SCHEDULE IS FOR EROSION CONTROL ONLY, AND IS NOT A PROJECT CONSTRUCTION SCHEDULE

LIME AND FERTILIZER - RATES AND ANALYSIS

A. WHERE PERMANENT VEGETATION IS TO BE ESTABLISHED, AGRICULTURAL LIME SHALL BE APPLIED AS INDICATED BY SOIL TEST OR AT THE RATE OF 1 TO 2 TONS PER ACRE. AGRICULTURAL LIME SHALL BE WITHIN THE SPECIFICATIONS OF THE GEORGIA DEPARTMENT OF AGRICULTURE. LIME SPREAD BY CONVENTIONAL EQUIPMENT CALCITIC OR DOLOMITIC LIMESTONE GROUND SO THAT 90 PERCENT OF THE MATERIAL WILL PASS THOUGH A 10-MESH SIEVE, NOT LESS THAN 25 PERCENT WILL PASS THROUGH A 100-MESH SIEVE. AGRICULTURAL LIME SPREAD BY HYDRAULIC SEEDING EQUIPMENT LIMESTONE." FINELY GROUND LIMESTONE IS CALCITIC OR DOLOMITIC LIMESTONE GROUND SO THAT 98 PERCENT OF THE MATERIAL WILL PASS THROUGH A 20-MESH SIEVE AND NOT LESS THAN 70 PERCENT WILL PASS THROUGH 100-MESH SIEVE. IT IS DESIRABLE TO USE DOLOMITIC LIMESTONE IN

APRON

- THE SAND HILLS, SOUTHERN COASTAL PLAIN AND ATLANTIC COAST FLATWOOD AREAS. B. NO AGRICULTURAL LIME IS REQUIRED WHERE ONLY TEMPORARYSEEDING IS TO BE DONE OR WHERE ONLY TREES ARE PLANTED.
- C. INITIAL FERTILIZATION REQUIREMENTS FOR EACH SPECIES OR COMBINATION OF SPECIES ARE LISTED IN TABLE 6-25.1, P 6-144. APPLY FERTILIZER: 5-10-15 @ 1500LBS/ACRE. (TYPICAL)

LIME FERTILIZER - APPLICATION A. WHEN HYDRAULIC SEEDING EQUIPMENT IS USED:

- A.A. THE INITIAL FERTILIZER WILL BE MIXED WITH SEED, INOCULANT (IF NEEDED) AND WOOD CELLULOSE OR WOOD PULP FIBER MULCH AND APPLIED IN A SLURRY. THE SLURRY MIXTURE WILL BE AGITATED DURING APPLICATION TO KEEP THE INGREDIENTS THOROUGHLY MIXED. THE MIXTURE WILL BE SPREAD UNIFORMLY OVER THE AREA WITHIN ONE HOUR AFTER BEING PLACED IN THE HYDROSEEDER.
- A.B. FINELY GROUND LIMESTONE WILL BE MIXED WITH WATER AND APPLIED IMMEDIATELY AFTER MULCHING IS COMPLETED OR IN COMBINATION WITH THE TOP DRESSING. B. WHEN CONVENTIONAL PLANTING IS TO BE DONE, LIME AND FERTILIZER WILL BE APPLIED UNIFORMLY
- IN ONE OF THE FOLLOWING WAYS: B.A. APPLY BEFORE LAND PREPARATION SO THAT IT WILL BE MIXED THE SOIL DURING SEEDBED
- PREPARATION: OR, MIX WITH THE SOIL USED TO FILL THE HOLES, DISTRIBUTE IN FURROWS, OR
- B.C. BROADCAST AFTER STEEP SURFACES ARE SCARIFIED, PITTED OR TRENCHED. B.D. 'JA' FERTILIZER PELLET WILL BE PLACED AT ROOT DEPTH BESIDE EACH PINE TREE SEEDLING.


TYPE OF SPECIES	YEAR	ANALYSIS OR EQUIVALENT	RATE	N TOP DRESSING
	127	N-P-K		RATE
1. Cool season	First	6-12-12	1500 lbs./ac.	50-100 lbs./ac. 1/2
grasses	Second	6-12-12	1000 lbs./ac.	00 100 100.740. 172
g. 40000	Maintenance	10-10-10	400 lbs./ac.	30
2. Cool season	First	6-12-12	1500 lbs./ac.	0-50 lbs./ac. 1/
grasses and	Second	0-10-10	1000 lbs./ac.	
legumes	Maintenance	0-10-10	400 lbs./ac.	
3. Ground covers	First	10-10-10	1300 lbs./ac. 3/	
	Second	10-10-10	1300 lbs./ac. 3/	
	Maintenance	10-10-10	1100 lbs./ac.	
4. Pine seedlings	First	20-10-5	one 21-gram pellet	
			per seedling placed	
			in the closing hole	
5. Shrub Lespedeza	First	0-10-10	700 lbs./ac.	
	Maintenance	0-10-10	700 lbs./ac. 4/	
6. Temporary	First	10-10-10	500 lbs./ac.	30 lbs./ac. 5/
cover crops seeded alone				
7. Warm season	First	6-12-12	1500 lbs./ac.	50-100 lbs./ac. 2/6
grasses	Second	6-12-12	800 lbs./ac.	50-100 lbs./ac. 2/
	Maintenance	10-10-10	400 lbs./ac.	30 lbs./ac.
8. Warm season	First	6-12-12	1500 lbs./ac.	50 lbs./ac./6/
grasses and	Second	0-10-10	1000 lbs./ac.	
legumes	^I Maintenance ^I	0-10-10	¹ 400 lbs./ac.	

 Apply in spring following seeding. 2/ Apply in split applications when high rates are used. 3/ Apply in 3 split applications.


4/ Apply when plants are pruned.

5/ Apply to grass species only. 6/ Apply when plants grow to a height of 2 to 4 inches.

TYPICAL INSTALLATION GUIDELINES FOR ROLLED **EROSION CONTROL PRODUCTS (RECP) BLANKET AND MATTING CROSS-SECTIONS** TRANSVERSE CHECK SLOT UPSTREAM TERMINAL DOWNSTREAM TERMINAL STEP 1: CUT TERMINAL SLOT STEP 2: WORK UPSTREAM ACROSS CHECK SLOT AND LAP BACK 15". STEP 3: TUCK MAT LAP INTO SLOT B. USE 1" X 3" PRESSURE TREATED BOARD TO SPACE MAT AGAINST VERTICAL CUT. STEP 4: A. REVERSE MAT ROLL DIRECTION TO B. PULL OUT TEMPORARY STAKES WHEN STREAM OVER REFILLED TERMINAL STAKE MAT DOWN TO ANCHOR C. PROGRESS UPSTREAM WITH ROLL. SEQUENTIAL ROLL RUN OUT IN PICTORAL VIEW OF TRANSVERSE SLOT IOIES: START AT DOWNSTREAM TERMINAL AND PROGRESS UPSTREAM. FIRST ROLL IS CENTERED LONGITUDINALLY IN MID—CHANNEL AND PINNED WITH TEMPORARY STAKES TO MAINTAIN ALIGMMENT. SUBSEQUENT ROLLS FOLLOW IN STAGGERED SEQUENCE BEHIND THE FIRST ROLL. USE THE CENTER ROLL FOR ALIGNMENT TO THE CHANNEL CENTER. WORK OUTWARDS FROM THE CHANNEL CENTER TO THE EDGE. USE 3" OVERLAPS AND STAKE AT 5' INTERVALS ALONG THE SEAMS. USE 3' OVERLAPS AND SHINGLE DOWNSTREAM TO CONNECT THE LINING AT THE ROLL ENDS.

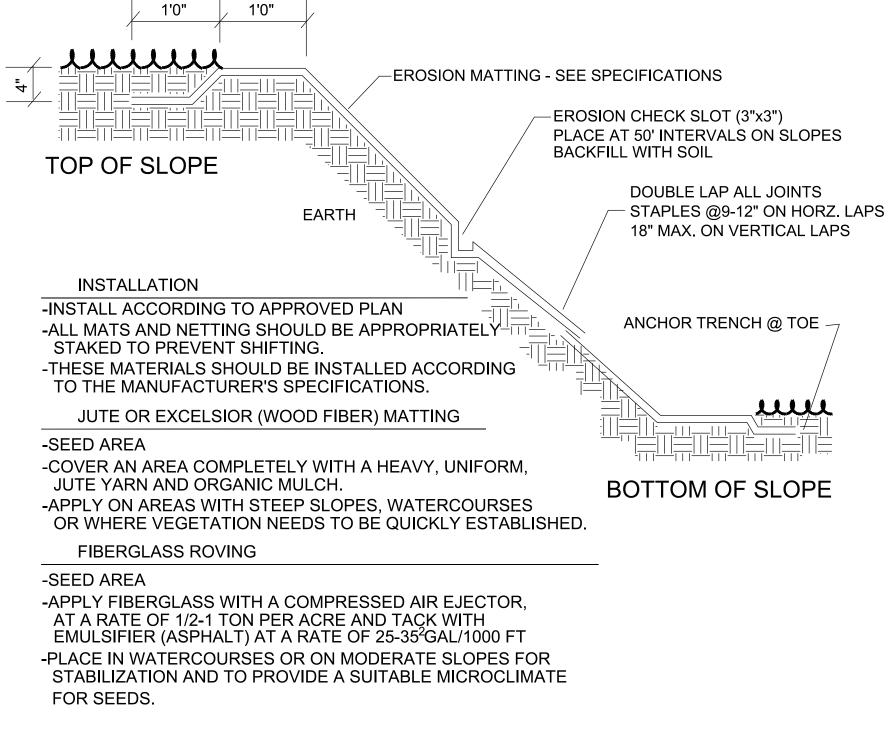

Ss | SLOPE STABILIZATION

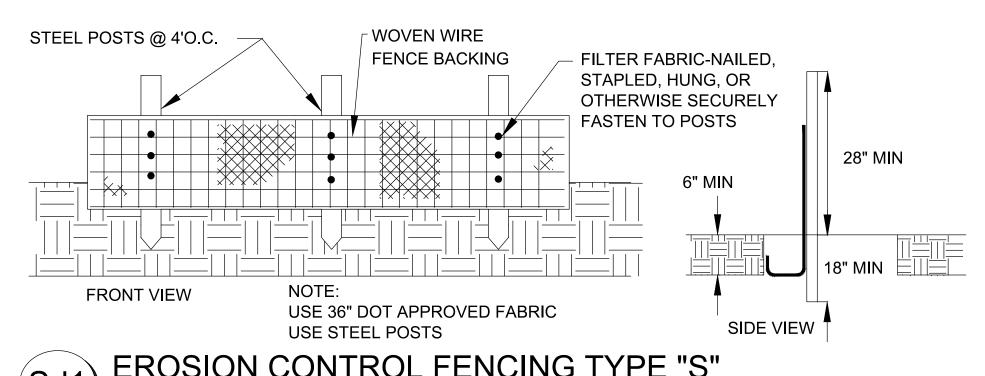

EROSION CONTROL FENCING TYPE "S"



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CONSULTANT PROJECT # 200510-01-001



LEVEL II E&S CERT.#945 EXP. DATE 09-27-24

2024/1/22 FOR CONSTRUCTION DATE DESCRIPTION RWH KDW KDW DESIGN DRAWN CHKD

1" = 20' 200510-01-00 01/22/2024

C4.4




24 HOUR CONTACT

BRITTNI NIX


CONTACT NUMBER

(770) 963-7451

END OF CONSTRUCTION

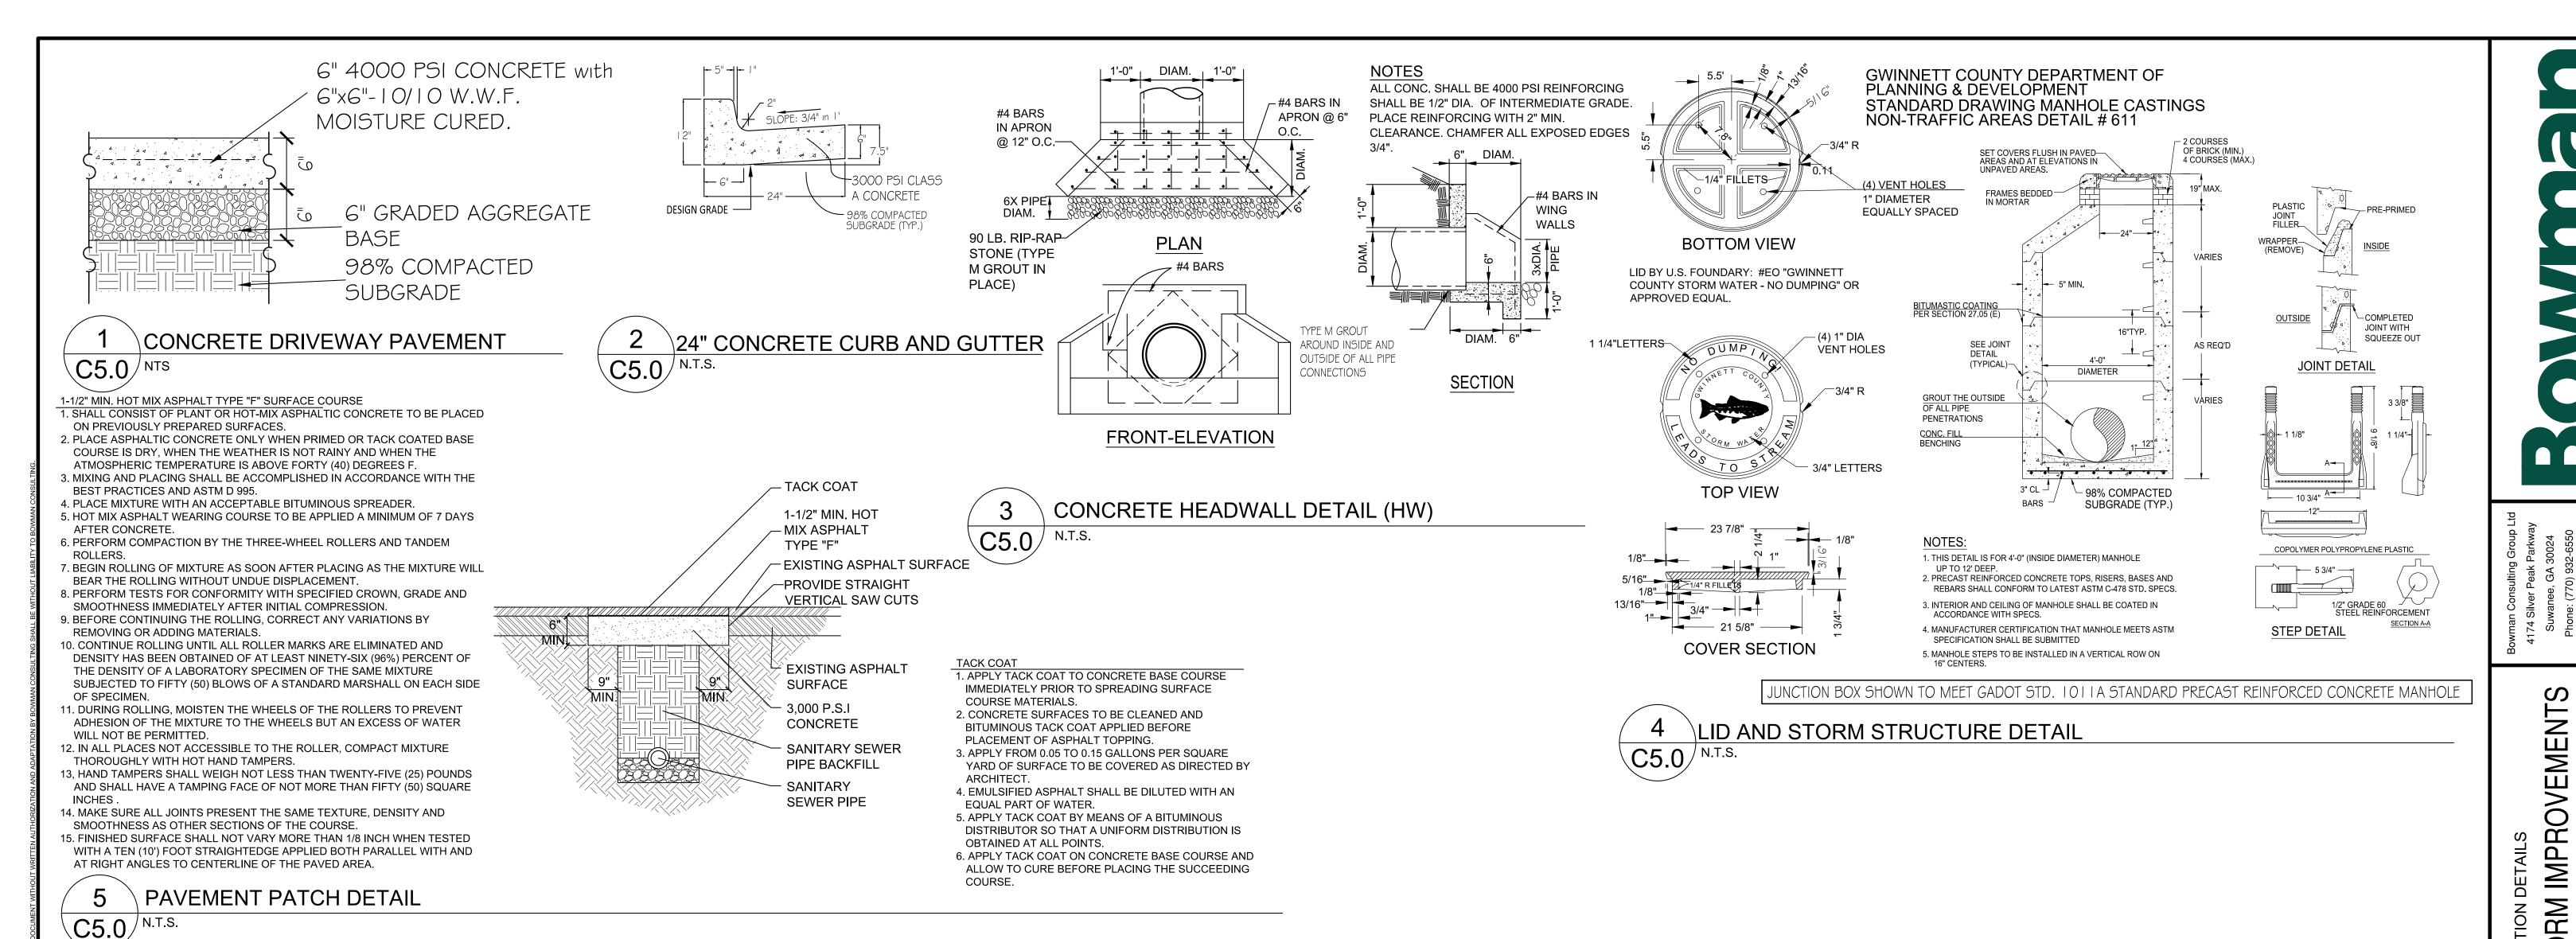




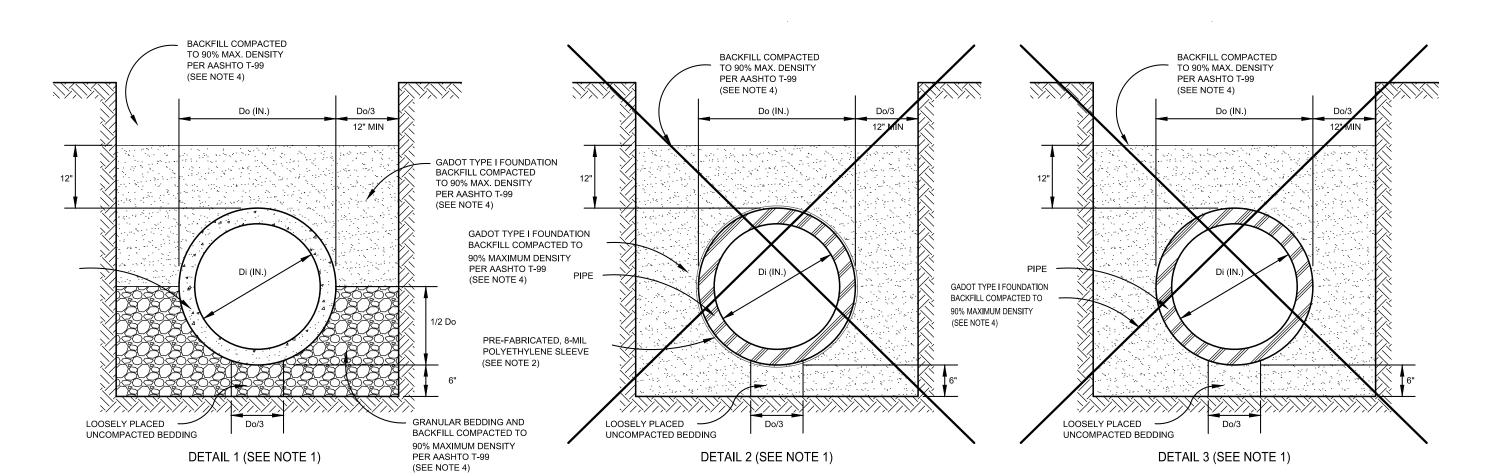

REPRESENTATIVE SOIL pH RESULTS SHALL BE PROVIDED FOR ALUMINIZED TYPE 2 STEEL OR REINFORCED CONCRETE PIPE WHERE THE SOIL TYPE, AS INDICATED IN THE GWINNETT COUNTY SOIL SURVEY, HAS A pH RANGE WITH pt VALUES LESS THAN 5. DETAIL 1 OR DETAIL 2 SHALL BE USED WHEN THE SOIL pH < 5. DETAIL 1 OR DETAIL 2 MAY BE USED IN LIEU OF SOIL pH TESTING FOR ALUMINIZED TYPE 2 STEEL OR REINFORCED CONCRETE PIPE. NO pH TESTING SHALL BE REQUIRED FOR HDPE, ALUMINUM PIPE, OR POLYMER PRECOAT CSP. PRE-FABRICATED, 8-MIL POLYETHYLENE SLEEVE SHALL BE SLIPPED OVER THE PIPE DURING INSTALLATION, OVERLAPPED WHERE NECESSARY, AND SECURED WITH POLYETHYLENE TAPE TO COMPLETELY PREVENT THE

ENTRANCE OF SOILS. 3. ALLOWABLE GRANULAR MATERIALS SHALL BE GRADED AGGREGATE BASE CRUSHER RUN, GADOT FOUNDATION BACKFILL MATERIAL TYPE II, OR GADOT MECHANICALLY STABILIZED EMBANKMENT BACKFILL. WITHIN STREET


RIGHT-OF-WAY. 4. BACKFILL SHALL BE COMPACTED TO 95% MAX DENSITY PER AASHTO T-99

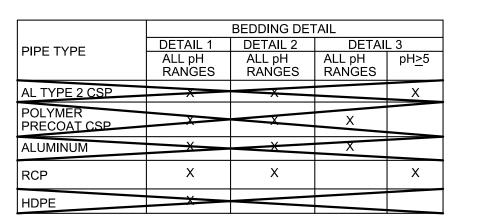



24 HOUR CONTACT BRITTNI NIX CONTACT NUMBER (770) 963-7451

STANDARD PIPE BEDDING DETAILS C5.0/N.T.S.

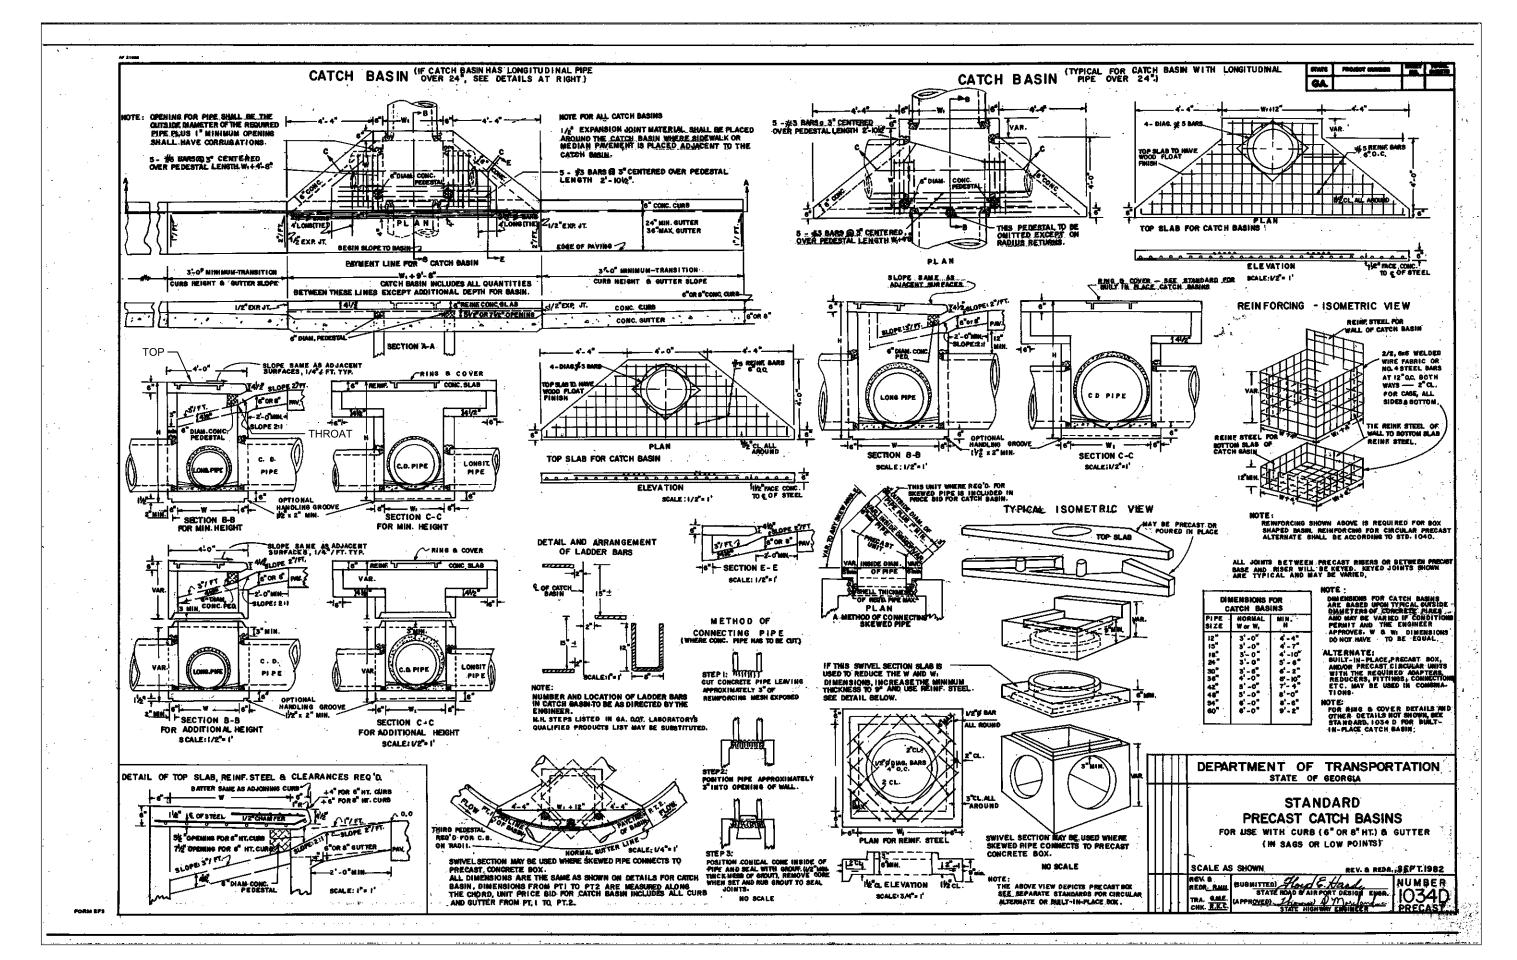

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CONSULTANT PROJECT #

200510-01-001

LEVEL II E&S CERT.#945

EXP. DATE 09-27-24

PLAN STATUS

DATE DESCRIPTION RWH

DESIGN DRAWN CHKD

1" = 20'

200510-01-00

C5.0


01/22/2024

KDW

HEET No.

2024/1/22 FOR CONSTRUCTION

DOUBLE WING CATCH BASIN DETAIL (DWCB) (GADOT STD. 1034D) C5.0/ NTS

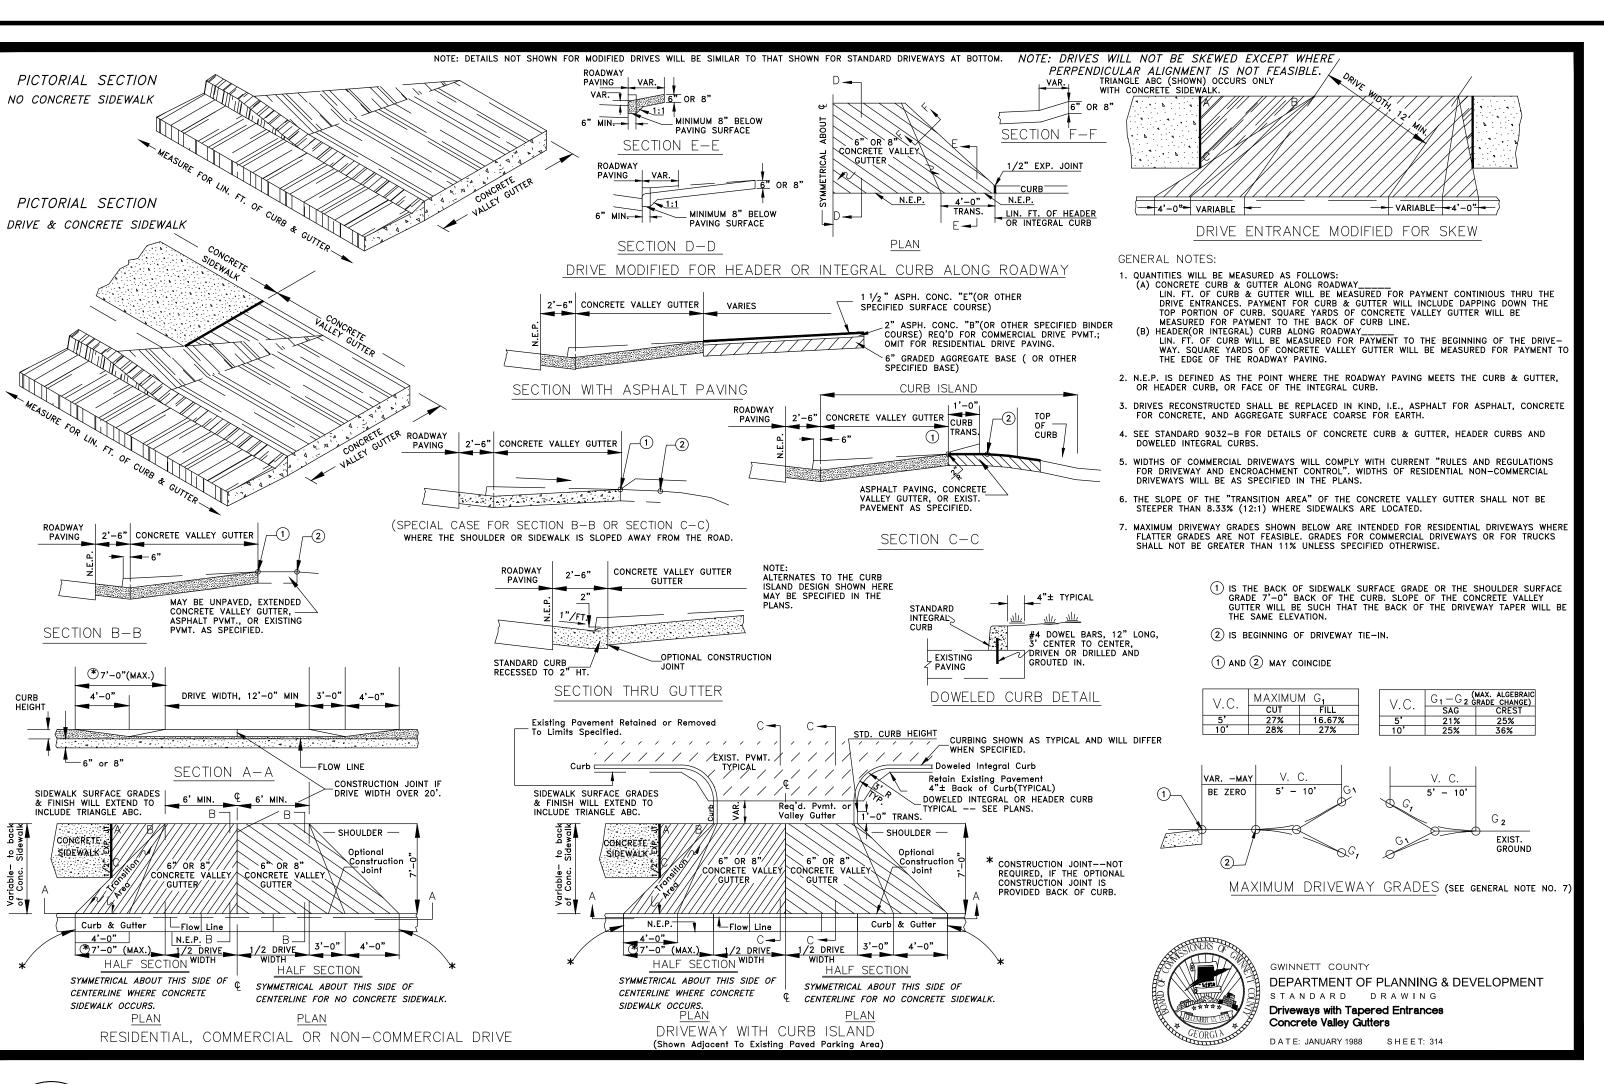

CONCRETE DRIVEWAY APRON C5.1/NTS

24 HOUR CONTACT BRITTNI NIX CONTACT NUMBER (770) 963-7451



ORM IMPROVEMEN S WAY

WHISPER

CONSULTANT PROJECT # 200510-01-001



LEVEL II E&S CERT.#945 EXP. DATE 09-27-24

2024/1/22 FOR CONSTRUCTION

DATE DESCRIPTION DESIGN DRAWN CHKD 1" = 20'

200510-01-001 01/22/2024

C5.1 SHEET No.