

2025 CDBG FOR CITY OF DACULA SANJO STREET WIDENING, PAVING, DRAINAGE, AND SIDEWALK IMPROVEMENT PROJECT

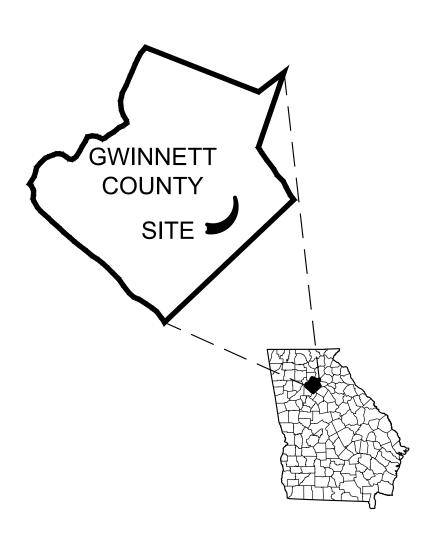

UTILITIES CONTACT INFORMATION									
UTILITY	CONTACT								
GWINNETT COUNTY WATER AND SEWER	SHAWNA DOBSON, EMAIL: shawna.dobson@gwinnettcounty.com								
GWINNETT COUNTY DOT	MICHELLE ARNOLD. PHONE: 770-822-7443								
GAS	DARREN PERKINS, EMAIL: dperkins@cityofbuford.com								
ELECTRICAL	TRISTAN PAYNE, EMAIL: tripayne@southernco.com								
AT&T	ANTHONY STANCIL, EMAIL: as925n@att.com								
AT&T	BILL SZYMANSKI, EMAIL: bs0368@att.com								
CHARTER	JIMMY PRICE, EMAIL: Jimmy.Price@charter.com								
MCI / VERIZON	ASH BELAVADI, EMAIL: ash.belavadi@verizon.com								
ZAYO	COBB FINDLEY, EMAIL: ZayoGeorgiaRelocations@cobbfendley.com								

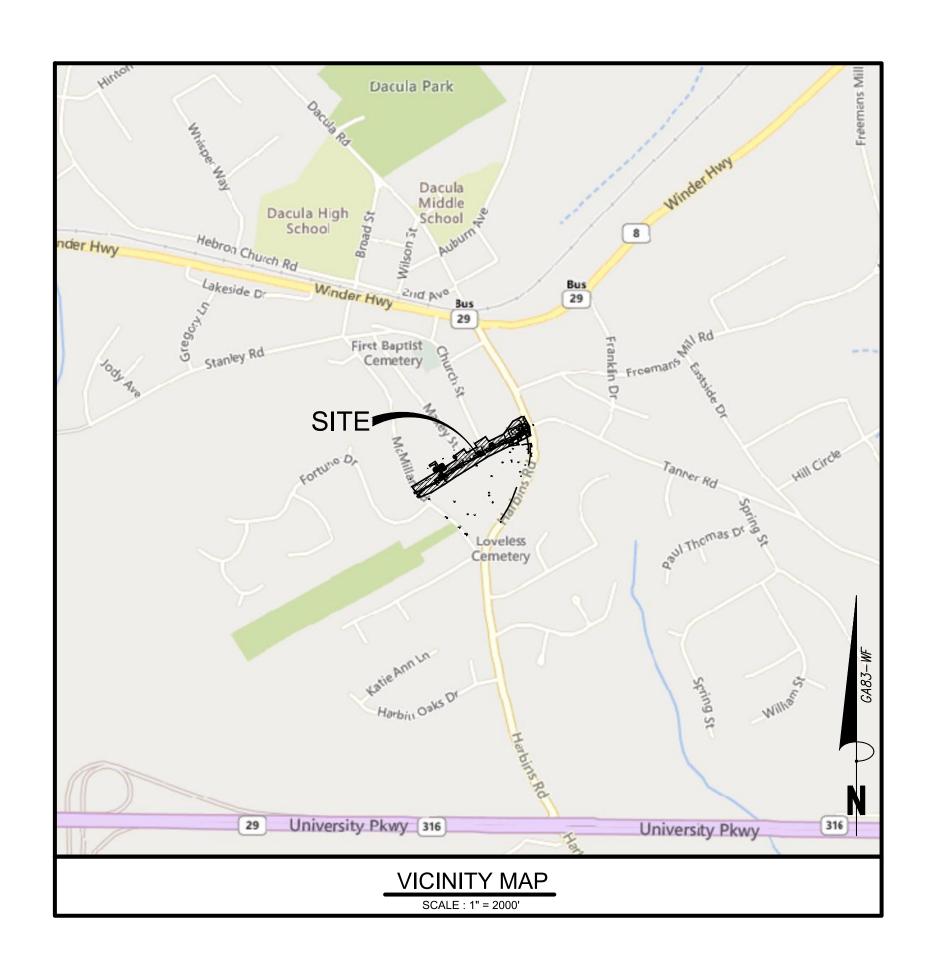

GENERAL NOTES:

- 1. SITE AREA: 1.79 ACRES, DISTURBED AREA: 0.99 ACRES
- 2. EXISTING ZONING: RIGHT OF WAY
- LOCATION: LAND LOTS 301 5th DISTRICT
 CITY OF DACULA
 GWINNETT COUNTY, GEORGIA
- EXISTING USE: RESIDENTIAL AND UNDEVELOPED LAND.
 PROPOSED USE: CITY RESIDENTIAL TWO-WAY STREET.
- 6. OWNER/DEVELOPER: CITY OF DACULA
- 6. OWNER/DEVELOPER: CITY OF DACULA CONTACT PERSON: BRITTNI NIX (770) 963-7451 P.O. BOX 400 DACULA, GEORGIA, 30019
- 7. DESIGNER/ENGINEER: BOWMAN. CONTACT PERSON: STEVE DUREN (770)932-6550 4174 SILVER PEAK PARKWAY SUWANEE, GEORGIA 30024
- 8. DO NOT SCALE DRAWINGS.

WETLANDS

THE DESIGN PROFESSIONAL, WHOSE SEAL APPEARS HEREON, CERTIFIES THE FOLLOWING: 1)THE NATIONAL WETLAND INVENTORY MAPS HAVE BEEN CONSULTED; AND, 2) THE APPROPRIATE PLAN SHEET () DOES / (X) DOES NOT INDICATE AREAS OF UNITED STATES ARMY CORPS OF ENGINEERS JURISDICTIONAL WETLANDS AS SHOWN ON THE MAPS; AND, 3) IF WETLANDS ARE INDICATED, THE LAND OWNER OR DEVELOPER HAS BEEN ADVISED THAT LAND DISTURBANCE OF PROTECTED WETLANDS SHALL NOT OCCUR UNLESS THE APPROPRIATE FEDERAL WETLANDS ALTERATION ("SECTION 404") PERMIT HAS BEEN OBTAINED.

PROJECT DESCRIPTION:

THE PROJECT CONSISTS OF DEMOLITION OF ALL EXISTING ASPHALT, CURB & GUTTER, STRUCTURES AND HARDSCAPE, CLEARING AND GRUBBING EXISTING TREES WITHIN THE LIMITS OF THE RIGHT OF WAY OF SANJO STREET. CONSTRUCTION CITY STREET WIDENING.

ENGINEER/SURVEYOR:

4174 SILVER PEAK PARKWAY
SUWANEE, GEORGIA 30024
PH: 770-932-6550 FX: 770-932-6551
ENGINEER CONTACT: VICTOR DANG, P.E. EMAIL: victor.dang@bowman.com

SITE VISIT CERTIFICATION:

IFY UNDER PENALTY OF LAW THAT THIS PLAN WAS PREPARED AFTER A SITE VISIT TO THE LOCATION DESCRIBED HEREIN BY MYSELF OR MY AUTHORIZED AGENT, UNDER MY SUPERVISION."

VICTOR DANG, P.E. - GSWCC LEVEL II CERTIFICATION #90012 EXP: 12/19/2028 DATE

FLOODPLAIN:

PART OF THIS PROPERTY DOES NOT LIE WITHIN A SPECIAL FLOOD HAZARD AREA (SFHA) PER FEMA FIRM PANEL 13135C0076F DATED 9/29/2006.

STATE WATERS

STATE WATERS ARE NOT ON THIS SITE REQUIRING A 25' STATE UNDISTURBED BUFFER, 50' COUNTY UNDISTURBED BUFFER AND 75' IMPERVIOUS SETBACK MEASURED FROM THE TOP OF BANK.

RECEIVING WATERS UNNAMED TRIBUTARY
TO HOPKINS CREEK

SURVEY:

THE BOUNDARY AND TOPOGRAPHIC INFORMATION SHOWN IS FROM A SURVEY PERFORMED BY BOWMAN DATED 08/09/2024. DATUM, MEAN SEA LEVEL, NAD83 GA WEST FOOT

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Certificate of Authorization License No. LSF001241

www.bowman.com 021 Bowman Consulting Gro

FOR CITY OF DACULA WIDENING, PAVING, DRAINAGE, K IMPROVEMENTS PROJECT

CONSULTANT PROJECT # 200577-01-001

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JOB No. 24-204(200577-01-001 DATE: 11/14/2025



- CONTRACTOR SHALL VISIT THE SITE AND ACQUAINT HIMSELF WITH SITE CONDITIONS AND MAKE AN INSPECTION OF EXISTING CONDITIONS IN ORDER TO INFORM HIMSELF OF ALL THE EXISTING CONDITIONS ON THE PROJECT SITE.
- CONTRACTOR IS RESPONSIBLE AS PART OF HIS CONTRACT FOR THE COMPLETION, SUBMITTAL AND ACQUISITION OF ANY CITY OF DACULA CERTIFICATION OF DEVELOPMENT COMPLIANCE OR EQUIVALENT DOCUMENTATION IN CONNECTION WITH ALL DOMESTIC WATER AND FIRE SERVICE SYSTEMS AS MAY BE REQUIRED BY GWINNETT COUNTY DEPARTMENT OF WATER RESOURCES OR THE GEORGIA STATE FIRE MARSHALL.
- CONTRACTOR MAY, AT HIS OWN EXPENSE AND PRIOR TO BIDDING, MAKE SOILS SURVEYS AND INVESTIGATIONS HE CONSIDERS NECESSARY.
- ALL CONSTRUCTION SHALL CONFORM TO THE CITY OF DACULA AND GWINNETT COUNTY DEVELOPMENT REGULATIONS AND ALL APPLICABLE GWINNETT COUNTY, STATE AND FEDERAL CODES, STANDARDS AND REGULATIONS.
- ALL MATERIALS, METHODS OF CONSTRUCTION, AND WORKMANSHIP SHALL CONFORM TO APPLICABLE REQUIREMENTS OF ASTM AND AASHTO STANDARDS, UNLESS
- OTHERWISE SPECIFIED. ALL SPECIFIED PRODUCTS ARE TO BE PROVIDED AS SPECIFIED OR "APPROVED EQUAL."
- THE UTILITIES SHOWN HAVE BEEN LOCATED IN AN APPROXIMATE WAY. THE CONTRACTOR IS RESPONSIBLE FOR HAVING ALL UTILITIES MARKED AND SHALL CONTACT THE UTILITY PROTECTION CENTER AT (1-800-282-7411) AND SHALL VERIFY THE HORIZONTAL AND VERTICAL LOCATION OF ALL UTILITIES, PROTECT ALL UTILITIES FROM DAMAGE OR INTERRUPTION, AND SHALL BE SOLELY RESPONSIBLE FOR ANY AND ALL DAMAGES OCCASIONED DUE TO HIS FAILURE TO VERIFY THE LOCATION OR PROTECT
- LOCATE EXISTING UNDERGROUND UTILITIES BY CAREFUL HAND EXCAVATION. PROTECT FROM DAMAGE OR INTERRUPTION ALL EXISTING SANITARY SEWER, WATER SERVICE, NATURAL GAS, POWER, ETC. DURING ALL PHASES OF CONSTRUCTION. DAMAGE TO EXISTING UTILITIES AND THE COST OF REPAIRS TO THOSE DAMAGED EXISTING UTILITY SERVICES ARE THE CONTRACTOR'S RESPONSIBILITY
- COST RELATED TO THE REMOVAL, RELOCATION, REPLACEMENT AND/OR REROUTING OF ANY, AND ALL EXISTING UTILITIES OR OTHER BUILT, STORED, STOCKPILED ITEMS OF ANY KIND, SURFACE OR SUBSURFACE IS THE RESPONSIBILITY OF THE CONTRACTOR AND WILL BE INCLUDED IN THE CONTRACT SUM.
- .0. CONTRACTOR SHALL BE FULLY RESPONSIBLE FOR ALL DAMAGE TO ANY PART OF THE SITE, BUILDING STRUCTURES OR OTHER INSTALLATIONS, CAUSED DURING
- CONSTRUCTION. 1. EROSION CONTROL MEASURES SHALL BE INSTALLED PRIOR TO ANY LAND DISTURBANCE ACTIVITY AND SHALL BE MAINTAINED THROUGHOUT THE DURATION OF
- CONSTRUCTION UNTIL PERMANENT VEGETATIVE COVER HAS BEEN ESTABLISH. 12. THE CONTRACTOR SHALL MAINTAIN THE EROSION CONTROL DEVICES DURING ALL PHASES OF CONSTRUCTION.
- 13. SUBMITTALS ARE TO BE TRANSMITTED IN ELECTRONIC FORMAT, AS APPROPRIATE TO THE DOCUMENT, AND TRANSMITTED VIA THE COUNTY'S INTERNET-BASED SUBMITTAL SERVICE.
- 13.1. IN ADDITION TO SUBMITTALS FOR REVIEW, AND CLOSEOUT, THIS PROCEDURE APPLIES TO REQUESTS FOR INFORMATION (RFI'S), PROGRESS DOCUMENTATION, CONTRACT MODIFICATION DOCUMENTS (E.G., SUPPLEMENTARY INSTRUCTIONS, CHANGE PROPOSALS, CHANGE ORDERS), APPLICATIONS FOR PAYMENT, FIELD REPORTS AND MEETING MINUTES, CONTRACTOR'S CORRECTION PUNCH-LIST, AND ANY OTHER DOCUMENT ANY PARTICIPANT WISHES TO MAKE PART OF THE
- 14. BY MAKING HIS SUBMITTAL THE CONTRACTOR REPRESENTS THAT HE HAS SELECTED THE PRODUCTS CONSISTENT WITH THE DRAWINGS AND SPECIFICATIONS; AND HAS DETERMINED AND CONFIRMED THE FITNESS OF THE SELECTED PRODUCTS WITH ALL DETAILS AND DIMENSIONS CAN BE INTEGRATED TO COMPLETE THE WORK. THE CONTRACTOR'S APPROVAL AND SUBMITTAL REPRESENTS THAT THE CONTRACTOR HAS DETERMINED AND VERIFIED MATERIALS. FIELD MEASUREMENTS AND FIELD CONSTRUCTION CRITERIA RELATED THERETO, OR WILL DO SO, AND HAS CHECKED AND COORDINATED THE INFORMATION WITHIN SUCH SUBMITTALS WITH THE
- REQUIREMENTS OF THE WORK AND OF THE CONTRACT DOCUMENTS. 16. SUBMITTALS NOT DATED, STAMPED, AND SIGNED BY THE CONTRACTOR WILL BE RETURNED AS "INCOMPLETE".
- FOR EACH SUBMITTAL, ALLOW 14 DAYS FOR REVIEW, EXCLUDING DELIVERY TIME TO AND FROM CONTRACTOR.
- 18. CONTRACTOR WILL BE BACK CHARGED FOR COST OF ADDITIONAL SUBMITTAL REVIEWS. 19. SHOP DRAWINGS SHALL BE SUBMITED IN ELECTRONIC FORMAT THROUGH SELECTED SUBMITTAL SERVICE. OWNER WILL RETURN TO CONTRACTOR THROUGH
- SUBMITTAL SERVICE FOR PRINTING AND DISTRIBUTION.
- 19.1. PRESENT INFORMATION IN CLEAR AND THOROUGH MANNER.
- 19.2. IDENTIFY DETAILS BY REFERENCE TO SHEET AND DETAIL NUMBERS SHOWN ON DRAWINGS. 19.3. SUBMIT SHOP DRAWINGS FOR REVIEW AND APPROVAL PRIOR TO PURCHASE, CONSTRUCTION OR PLACEMENT OF PRODUCTS/MATERIALS REQUIRING SHOP
- DRAWING REVIEW. 19.4. CONTRACTOR SHALL ASSUME TOTAL RESPONSIBILITY FOR STEEL REINFORCING COVERED WITH CONCRETE FOR WHICH SHOP DRAWINGS HAVE NOT BEEN REVIEWED.
- 19.5. SHOP DRAWINGS SUBMITTED AFTER MATERIAL IS INSTALLED SHALL NOT BE REVIEWED BY THE LANDSCAPE ARCHITECT/ENGINEER. 19.6. CONTRACTOR WILL BE BACK CHARGED FOR COST OF ADDITIONAL SHOP DRAWING REVIEWS.
- PRIOR TO INITIATION OF AN RFI, CAREFULLY STUDY ALL CONTRACT DOCUMENTS TO CONFIRM THAT THE INFORMATION SUFFICIENT FOR INTERPRETATION OR CLARIFICATION IS DEFINITELY NOT INCLUDED. INCLUDE IN EACH REQUEST CONTRACTOR'S SIGNATURE ATTESTING TO GOOD FAITH EFFORT TO DETERMINE FROM
- CONTRACT DOCUMENTS INFORMATION REQUIRING INTERPRETATION OR CLARIFICATION. ANY IMPROPER OR FRIVOLOUS RFI'S WILL BE RETURNED WITHOUT A RESPONSE, WITH AN EXPLANATORY NOTATION.
- 21.1. THE OWNER RESERVES THE RIGHT TO ASSESS THE CONTRACTOR FOR THE COSTS INCURRED BY THE ARCHITECT/ENGINEER, AND ANY OF ITS CONSULTANTS, DUE TO PROCESSING OF SUCH RFI'S.
- 22. WHERE ONE CONDITION IS SHOWN FOR A PLAN DETAIL, IT SHALL ALSO APPLY FOR ALL LIKE OR SIMILAR CONDITIONS UNLESS NOTED OTHERWISE.
- 23. MATERIALS STORAGE: STORE MATERIALS IN A MANNER TO ENSURE PROPER VENTILATION AND DRAINAGE. PROTECT AGAINST DAMAGE, WEATHER, VANDALISM, AND
- 4. SHORING: PROVIDE ALL NECESSARY SHORING, SHEETING, AND BRACING FOR THE PROTECTION OF WORK AND SAFETY OF PERSONNEL. ENGAGE A GEORGIA REGISTERED PROFESSIONAL ENGINEER HIGHLY EXPERIENCED IN THE DESIGN OF SUCH SHORING AND BRACING SYSTEMS TO PERFORM THE DESIGN ENGINEERING FOR SAID SHORING AND BRACING. DO NOT BACKFILL OR LOAD WALLS AND STRUCTURAL SYSTEMS UNTIL SAID WALLS OR SYSTEMS ARE COMPLETELY DEVELOPED AND STRUCTURALLY
- 24.1. SUBMIT DETAILED SHOP DRAWINGS AND SCHEMATIC DIAGRAMS AS NECESSARY TO GRAPHICALLY DESCRIBE ALL SHORING AND BRACING PROCEDURES. INCLUDE CALCULATIONS AND SCHEDULES. ILLUSTRATE SEQUENCING OF ALL SHORING AND BRACING.
- ALL THE RECORD DOCUMENT INFORMATION REQUIRED BY THE DEVELOPMENT INSPECTIONS PROJECT CLOSEOUT CHECKLIST FOR CITY OF DACULA PROJECTS SHALL BE
- INCLUDED IN THE CONTRACT WITH NO ADDITIONAL COST TO OWNER. 26. PROJECT RECORD DOCUMENTS REQUIRED INCLUDE THE FOLLOWING:
- 26.1. MARKED-UP COPIES OF CONTRACT DRAWINGS.
- 26.2. MARKED-UP COPIES OF SPECIFICATIONS, ADDENDA, AND CHANGE ORDERS.

COMPLETE, THE CONTRACTOR SHALL PAY ALL SUBSEQUENT INSPECTION COSTS.

- 26.3. MARKED-UP COPIES OF SHOP DRAWINGS OF PRODUCT DATA SUBMITTALS AND RECORD SAMPLES. 26.4. FIELD RECORDS FOR VARIABLE AND CONCEALED CONDITIONS.
- 26.5. RECORDED INFORMATION ON WORK THAT IS DEPICTED ONLY SCHEMATICALLY ON DRAWINGS.
- 26.6. RECORDED DRAWING SUB-SURFACE WATER QUALITY FACILITIES, I.E., "AS-BUILT" DRAWING.
- 26.7. MARK THESE DRAWINGS TO SHOW THE ACTUAL INSTALLATION, WHERE THE INSTALLATION VARIES FROM THE INSTALLATION SHOWN ORIGINALLY. GIVE PARTICULAR ATTENTION TO INFORMATION ON CONCEALED ELEMENTS THAT WOULD BE DIFFICULT TO IDENTIFY OR MEASURE AND RECORD LATER. 26.8. "AS-BUILT" HYDROLOGY ANALYSIS/REPORT.
- CONTRACTOR SHALL EMPLOY THE SERVICES OF AN INDEPENDENT REGISTERED LAND SURVEYOR (R.L.S.) FOR THE "AS-BUILT" RECORD DRAWINGS. THE R.L.S. WILL HOLD ACTIVE LICENSURE AND REGISTRATION IN THE STATE OF GEORGIA.
- TESTS AND INSPECTIONS NOT EXPLICITLY ASSIGNED TO OWNER ARE CONTRACTOR'S RESPONSIBILITY. PERFORM ADDITIONAL QUALITY-CONTROL ACTIVITIES REQUIRED TO VERIFY THAT THE WORK COMPLIES WITH REQUIREMENTS, WHETHER SPECIFIED OR NOT.
- 29. THE OWNER & OWNER'S REPRESENTATIVE WILL PERFORM ONE INSPECTION FOR SUBSTANTIAL COMPLETION, UPON THE REQUEST OF THE CONTRACTOR. ONLY ONE CERTIFICATE OF SUBSTANTIAL COMPLETION WILL BE ISSUED; THIS CERTIFICATE WILL INCLUDE ALL OF THE WORK AND NOT A PORTION OR PORTIONS.
- io. Prior to requesting landscape architect/engineer's inspection for certificate of substantial completion: 30.1. OBTAIN AND SUBMIT THE CERTIFICATE OF OCCUPANCY AND /OR CERTIFICATE OF COMPLETION AND ANY APPLICABLE OPERATING PERMITS FROM AUTHORITIES
- 30.2. SUBMIT ALL SUBMITTALS SPECIFIED IN THE CONTRACT DOCUMENTS TO BE COMPLETED BEFORE SUBSTANTIAL COMPLETION.
- PRIOR TO REQUESTING OWNER & OWNER'S REPRESENTATIVE 'S FINAL INSPECTION FOR CERTIFICATE OF FINAL COMPLETION AND FINAL PAYMENT, SUBMIT SPECIAL WARRANTIES, WORKMANSHIP BONDS, MAINTENANCE AGREEMENTS, FINAL CERTIFICATIONS AND SIMILAR DOCUMENTS REQUIRED BY CONTRACT DOCUMENTS OR

SUBMITTING HIS REQUEST. IF THE OWNER & OWNER'S REPRESENTATIVE IS UNABLE TO ISSUE THE CERTIFICATE FOR FINAL PAYMENT BECAUSE THE WORK IS NOT

RELATED TO INSTALLED EQUIPMENT AND MATERIALS. THE OWNER & OWNER'S REPRESENTATIVE WILL PERFORM ONLY ONE INSPECTION FOR FINAL COMPLETION, UPON THE REQUEST OF THE CONTRACTOR. THE CONTRACTOR SHOULD TAKE CARE THAT ALL REQUIREMENTS FOR FINAL COMPLETION AS INDICATED IN THE SPECIFICATIONS HAVE BEEN COMPLETED PRIOR TO

- GWINNETT COUNTY DEPARTMENT OF WATER RESOURCES NOTES:
- ALL WATER AND SEWER FACILITIES SHALL BE INSTALLED BY A LICENSED UTILITY CONTRACTOR IN THE STATE OF GEORGIA. 12 GAUGE, SOLID STRAND DETECTION WIRE IS REQUIRED TO BE INSTALLED ABOVE ALL WATER LINES WITH WATERPROOF CONNECTORS AND CONNECTIONS AT EVERY
- MARKING TAPE SHOWING "CAUTION BURIED WATERLINE" SHALL BE INSTALLED APPROXIMATELY 18-INCHES ABOVE ALL WATERLINES. AS-BUILTS RECORD DRAWINGS (HARD COPIES AND DIGITAL FORMAT) FOR THIS PROJECT MUST BE SUBMITTED AND APPROVED BY GWINNETT COUNTY PRIOR TO FINAL
- ACCEPTANCE BY THE OWNER. THE GWINNETT COUNTY WATER DEPARTMENT SHALL BE NOTIFIED A MINIMUM OF 48 HOURS (MONDAY THROUGH FRIDAY) PRIOR TO COMMENCING ANY WORK,
- TESTING, AND PRIOR TO MAKING ANY CONNECTIONS TO EXISTING WATERLINES.
- THE GWINNETT COUNTY SEWER DEPARTMENT SHALL BE NOTIFIED A MINIMUM OF 48 HOURS (MONDAY THROUGH FRIDAY) PRIOR TO COMMENCING ANY WORK,
- TESTING, AND PRIOR TO MAKING ANY CONNECTIONS TO EXISTING SEWER LINES OR MANHOLES. ALL WATER AND SEWER LINE CONSTRUCTION SHALL BE IN ACCORDANCE WITH GWINNETT COUNTY STANDARD SPECIFICATIONS AND DETAILS, LATEST EDITION.
- FOR D.I.P. SEWER LINES. THE MINIMUM WALL THICKNESS SHALL BE CLASS 350 AND THE INTERIOR LINING
- SHALL BE CEMENT. WALL THICKNESS GREATER THAN THE MINIMUM CALLED FOR ABOVE MAY BE REQUIRED 10. DUE TO GREATER DEPTHS OR VARYING BEDDING REQUIREMENTS. CLASS C BEDDING IS THE MINIMUM ALLOWED.
- 11. USE OF PRE-CAST INVERTS IS ACCEPTABLE PROVIDED INVERTS ARE NOT MODIFIED
- 12. ALL NEW PIPE TIE-INS REQUIRE NEW INVERTS IN MANHOLES (3.5.12F)
- 13. IN THE FIRST NEWLY INSTALLED MANHOLE UPSTREAM OF THE EXISTING TIE-IN MANHOLE, CONTRACTOR SHALL INSTALL TEMPORARY MECHANICAL PLUGS ON THE INFLOW AND OUTFLOW INVERTS. SAID MECHANICAL PLUGS SHALL BE TIED TO THE MANHOLE STEP WITH STEEL CABLE AND PADLOCKED TO PREVENT TAMPERING AND GCDWR SHALL INSTALL A LOCKING COVER. (SEE DETAIL \$15).
- PER THE FEE RESOLUTION THERE IS A "PENALTY FEE" OF 100% OF THE PERMIT FEE FOR SITE ACTIVITY PRIOR TO ISSUANCE OF APPROPRIATE PERMITS (LAND DISTURBANCE, DEVELOPMENT, OR UTILITY CONSTRUCTION)
- INFORMATION REGARDING UNDERGROUND UTILITIES ON THESE PLANS IS NOT GUARANTEED AS TO ACCURACY OR COMPLETENESS. PRIOR TO BEGINNING WORK, THE CONTRACTOR SHALL REQUEST A FIELD LOCATION THROUGH THE UTILITIES PROTECTION CENTER AND ANY UTILITY OWNERS THOUGHT TO HAVE FACILITIES IN THE AREA. THE CONTRACTOR SHALL PROMPTLY COMPARE THESE FIELD-MARKED LOCATIONS WITH THE PROJECT PLANS AND THEN NOTIFY THE DESIGNER OF ANY ANTICIPATED PROBLEMS OR NEED FOR DESIGN CHANGES. IT IS THE CONTRACTOR'S RESPONSIBILITY TO EXCAVATE OR CAUSE THE UTILITY OWNER TO EXCAVATE FOR THE PURPOSE OF DETERMINING EXACT ELEVATIONS OR LOCATIONS AT UTILITY CROSSINGS AND OTHER CRITICAL LOCATIONS WELL IN ADVANCE OF THE WORK UNDER THIS CONTRACT.
- DAMAGE TO EXISTING UTILITIES RESULTING FROM THE CONTRACTOR'S NEGLIGENCE SHALL BE REPAIRED AT THE CONTRACTOR'S EXPENSE. THE DEVELOPER AND/OR THE DEVELOPER'S CONTRACTOR IS RESPONSIBLE FOR VERIFYING THE EXACT LOCATION, SIZE, AND MATERIAL OF ANY EXISTING WATER OR SANITARY SEWER FACILITY PROPOSED FOR CONNECTION OR USE BY THIS PROJECT.
- ALL CUT AND FILL SLOPES MUST BE ROUGHENED AND VEGETATED WITHIN SEVEN (7) DAYS OF THEIR CONSTRUCTION.
- 18. BORE WITHIN THE VICINITY OF THE MANHOLE AND CORE FROM THE INSIDE OF THE MANHOLE IN THE PRESENCE OF AN INSPECTOR
- 19. TAP TO BE PERFORMED ONLY BY GCDWR TO SCHEDULE CALL 678-376-7029 72 HOURS IN ADVANCE. CONTRACTOR IS RESPONSIBLE FOR ALL EXCAVATION AND BACKFILL MATERIAL. EXCAVATION AREA MUST MEET OR EXCEED OSHA STANDARDS AND BE READY PRIOR TO SCHEDULED TIME FOR COUNTY FORCES TO ARRIVE AND A CONSTRUCTION PERMIT IS TO BE ACQUIRED BY A GCDWR APPROVED CONTRACTOR PRIOR TO INSTALLATION. CALL 678-518-6000 FOR INFORMATION AND COPY OF
- APPROVED CONTRACTOR'S LIST. A MANDATORY PRE-CONSTRUCTION CONFERENCE WITH INSPECTOR, BY APPOINTMENT ONLY, IS REQUIRED 48 HOURS PRIOR TO ANY UTILITY CONSTRUCTION. ANY UTILITY DESIGN CHANGES MUST BE APPROVED BY THE WATER AND SEWER REVIEW SECTION OF P&d PRIOR TO INSTALLATION.
- AS-BUILT/RECORD DRAWINGS FOR SEWER SYSTEM REQUIRED PRIOR TO REQUESTING FINAL PLAT APPROVAL, TEMPORARY CERTIFICATE OF OCCUPANCY OR ISSUANCE OF CERTIFICATE OF OCCUPANCY. ALLOW MINIMUM 10 BUSINESS DAYS FOR INITIAL REVIEW AND ADDITIONAL TIME FOR RE-REVIEW(S). DRAWINGS TO BE SUBMITTED TO, REVIEWED AND APPROVED BY DEPARTMENT OF WATER RESOURCES.
- . ALL WORK TO BE PERFORMED ACCORDING TO GWINNETT COUNTY DEPARTMENT OF WATER RESOURCES WATER MAIN AND SANITARY SEWER DESIGN AND CONSTRUCTION STANDARDS AND SPECIFICATIONS (APRIL 5, 2016). ACTUAL FIELD CONDITIONS COULD DICTATE MORE STRINGENT REQUIREMENTS, IF DEEMED NECESSARY BY INSPECTOR.
- 23. GCDWR DOES NOT AUTHORIZE ANY PAVEMENT CUTS IF CUT IS NECESSARY PERMISSION MUST BE OBTAINED FORM THE OWNER OF STREET.
- 24. MAINTAIN 10' SEPARATION BETWEEN WATER AND SEWER LINES.
- 25. TREATMENT OF REMAINING GROUND SHALL BE SOD, SEEDED OR HYDRO SEEDED WITH GRASS, AND/OR PLANTED WITH GROUND COVER SPECIES AND/OR PROVIDED WITH OTHER LANDSCAPING MATERIAL, OR ANY COMBINATION THEREOF.

GCDOT NOTE:

THE GENERAL CONTRACTOR IS RESPONSIBLE FOR ALL COSTS ASSOCIATED WITH ANY RELOCATION OR DAMAGE TO GWINNETT COUNTY DOT (GCDOT) TRAFFIC SIGNAL OR ATMS INFRASTRUCTURE (LOOP, LEAD-IN, FIBER OPTICS, CONDUIT, PULL BOX, ETC.) DUE TO CONSRUCTION ACTIVITIES AND MUST USE A GCDOT APPROVED CONTRACTOR TO PERFORM ANY WORK ON SAID INFRASTRUCTIRE. NOTIFY GCDOT AT 678-639-8800 OF ANY ACTIVITY.

TRAFFIC SIGNAGE NOTE:

ALL TRAFFIC CONTROL SIGNS THAT ARE REMOVED OR DAMAGES SHALL BE REINSTALLED OR REPLACED. SIGNS MUST BE REINSTALLED TO THE STANDARDS IN THE MANUAL UNIFORM TRAFFIC CONTROL DEVICES (MUTCD).

WINNETT COUNTY FIRE NOTES

- 1. PLACEMENT OF FIRE HYDRANTS SHALL BE A MINIMUM OF 3 FT. AND A MAXIMUM OF 15 FT. FROM THE BACK OF CURB OR ROAD EDGE WITH THE LARGE FIRE DEPARTMENT CONNECTION FACING THE NEAREST FIRE DEPARTMENT ACCESS POINT AND SET A MINIMUM OF 18" AND A MAXIMUM OF 36" ABOVE FINISHED GRADE T TO THE CENTER OF THE LARGE FIRE DEPARTMENT CONNECTION. AUTHORITY HAVING JURISDICTION.
- (GROUND AND FLOOR SURFACES) ALONG ACCESSIBLE ROUTES AND WALKS, RAMPS, STAIRS AND CURBS RAMPS, SHALL BE STABLE, FIRM, SLIP-RESISTANT AND SHALL COMPLY WITH RULE 120-3-20-.16&19.
- (FIRE HYDRANTS AND WATER MAINS) ARE TO BE INSTALLED, FLUSHED, AND UNDER PRESSURE BEFORE ANY COMBUSTIBLE CONSTRUCTION IS STARTED. GWINNETT COUNTY ORDINANCE FOR FIRE PROTECTION AND LIFE SAFETY, SECTION 46-38(a).
- FIRE HYDRANT SPACING IN INDUSTRIAL & COMMERCIAL DEVELOPMENTS. ADDITIONAL HYDRANTS MAY BE REQUIRED TO PERMIT ALL PORTIONS, OF ALL BUILDINGS, TO BE REACHED BY HOSE LAYS NOT TO EXCEED 400 FT BY ROAD TRAVEL. GWINNETT COUNTY ORDINANCE FOR FIRE PROTECTION AND LIFE SAFETY, SECTION 46-37 (C) DURING CONSTRUCTION AND FOR PERMANENT ACCESS, ROADWAYS CONSTRUCTED OF AN ALL WEATHER SURFACE CAPABLE OF SUPPORTING 75,000 POUNDS GROSS WEIGHT SHALL BE PROVIDED PER INTERNATIONAL FIRE CODE, CHAPTER 5, SECTION 503.2.3, 2006 EDITION.

PLANTS AND LANDSCAPING NOTES

- CONTRACTOR IS RESPONSIBLE FOR ALL MEANS. METHODS, LABOR, MATERIALS, AND EQUIPMENT REQUIRED BY OR INDICATED BY THE DRAWINGS AND SPECIFICATIONS TO SATISFACTORILY COMPLETE THE CONSTRUCTION OF THE PROJECT INCLUDING ALL LANDSCAPE AND PLANTING WORK.
- BEFORE COMMENCING ANY WORK. THE CONTRACTOR SHALL LOCATE ALL UTILITIES. SUBSURFACE DRAINAGE. AND UNDERGROUND CONSTRUCTION SO THAT PROPER PRECAUTIONS MAY BE TAKEN NOT TO DISTURB OR DAMAGE ANY SUBSURFACE IMPROVEMENTS. CONTRACTOR SHALL BE HELD RESPONSIBLE FOR MAKING ALL REPAIRS, AT HIS OWN EXPENSE TO DAMAGED UTILITIES RESULTING FROM THE WORK.
- SELECTION OF ALL MATERIALS AND THE EXECUTION OF ALL OPERATIONS REQUIRED SHALL BE SUBJECT TO THE APPROVAL OF THE LANDSCAPE ARCHITECT, WHO SHALL HAVE THE RIGHT TO REJECT ANY AND ALL MATERIALS AND ANY AND ALL WORK WHICH, IN THEIR OPINION, DOES NOT MEET THE REQUIREMENTS OF THE DRAWINGS
- AND SPECIFICATIONS. ANY DEVIATION FROM THE DRAWINGS AND SPECIFICATIONS MUST BE SUBMITTED IN WRITING BY CONTRACTOR TO LANDSCAPE ARCHITECT FOR APPROVAL PRIOR TO ANY WORK TAKING PLACE.
- CONTRACTOR MUST PROVIDE PLANTS THAT MEET ALL REQUIREMENTS INCLUDING HEIGHT AND SPREAD, REGARDLESS OF SPECIFIED CALIPER OR CONTAINER SIZE. SUBSTITUTIONS MUST BE APPROVED BY ADDENDUM PRIOR TO BID AND APPROVED BY ARBORIST PRIOR TO PLANTING. TREE CALIPER TO BE VERIFIED PRIOR TO
- PLANTING. UNDERSIZED PLANTS MAY BE REJECTED BY THE OWNER, THE OWNER'S REPRESENTATIVE AND / OR THE LOCAL ISSUING AUTHORITY. TOPPING TREES IS NOT ALLOWED. TREES REMOVED OR HAVING THEIR TOPS CUT AFTER COMPLIANCE WITH THIS ORDINANCE SHALL BE REPLACED WITH THE EQUIVALENT INCHES OF REMOVED TREES.
- ALL BUFFERS AND TREE SAVE AREAS ARE TO BE CLEARLY IDENTIFIED WITH PROTECTIVE FENCING PRIOR TO COMMENCEMENT OF ANY LAND DISTURBANCE.



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CONSULTANT PROJECT # 200577-01-001




PLAN STATUS


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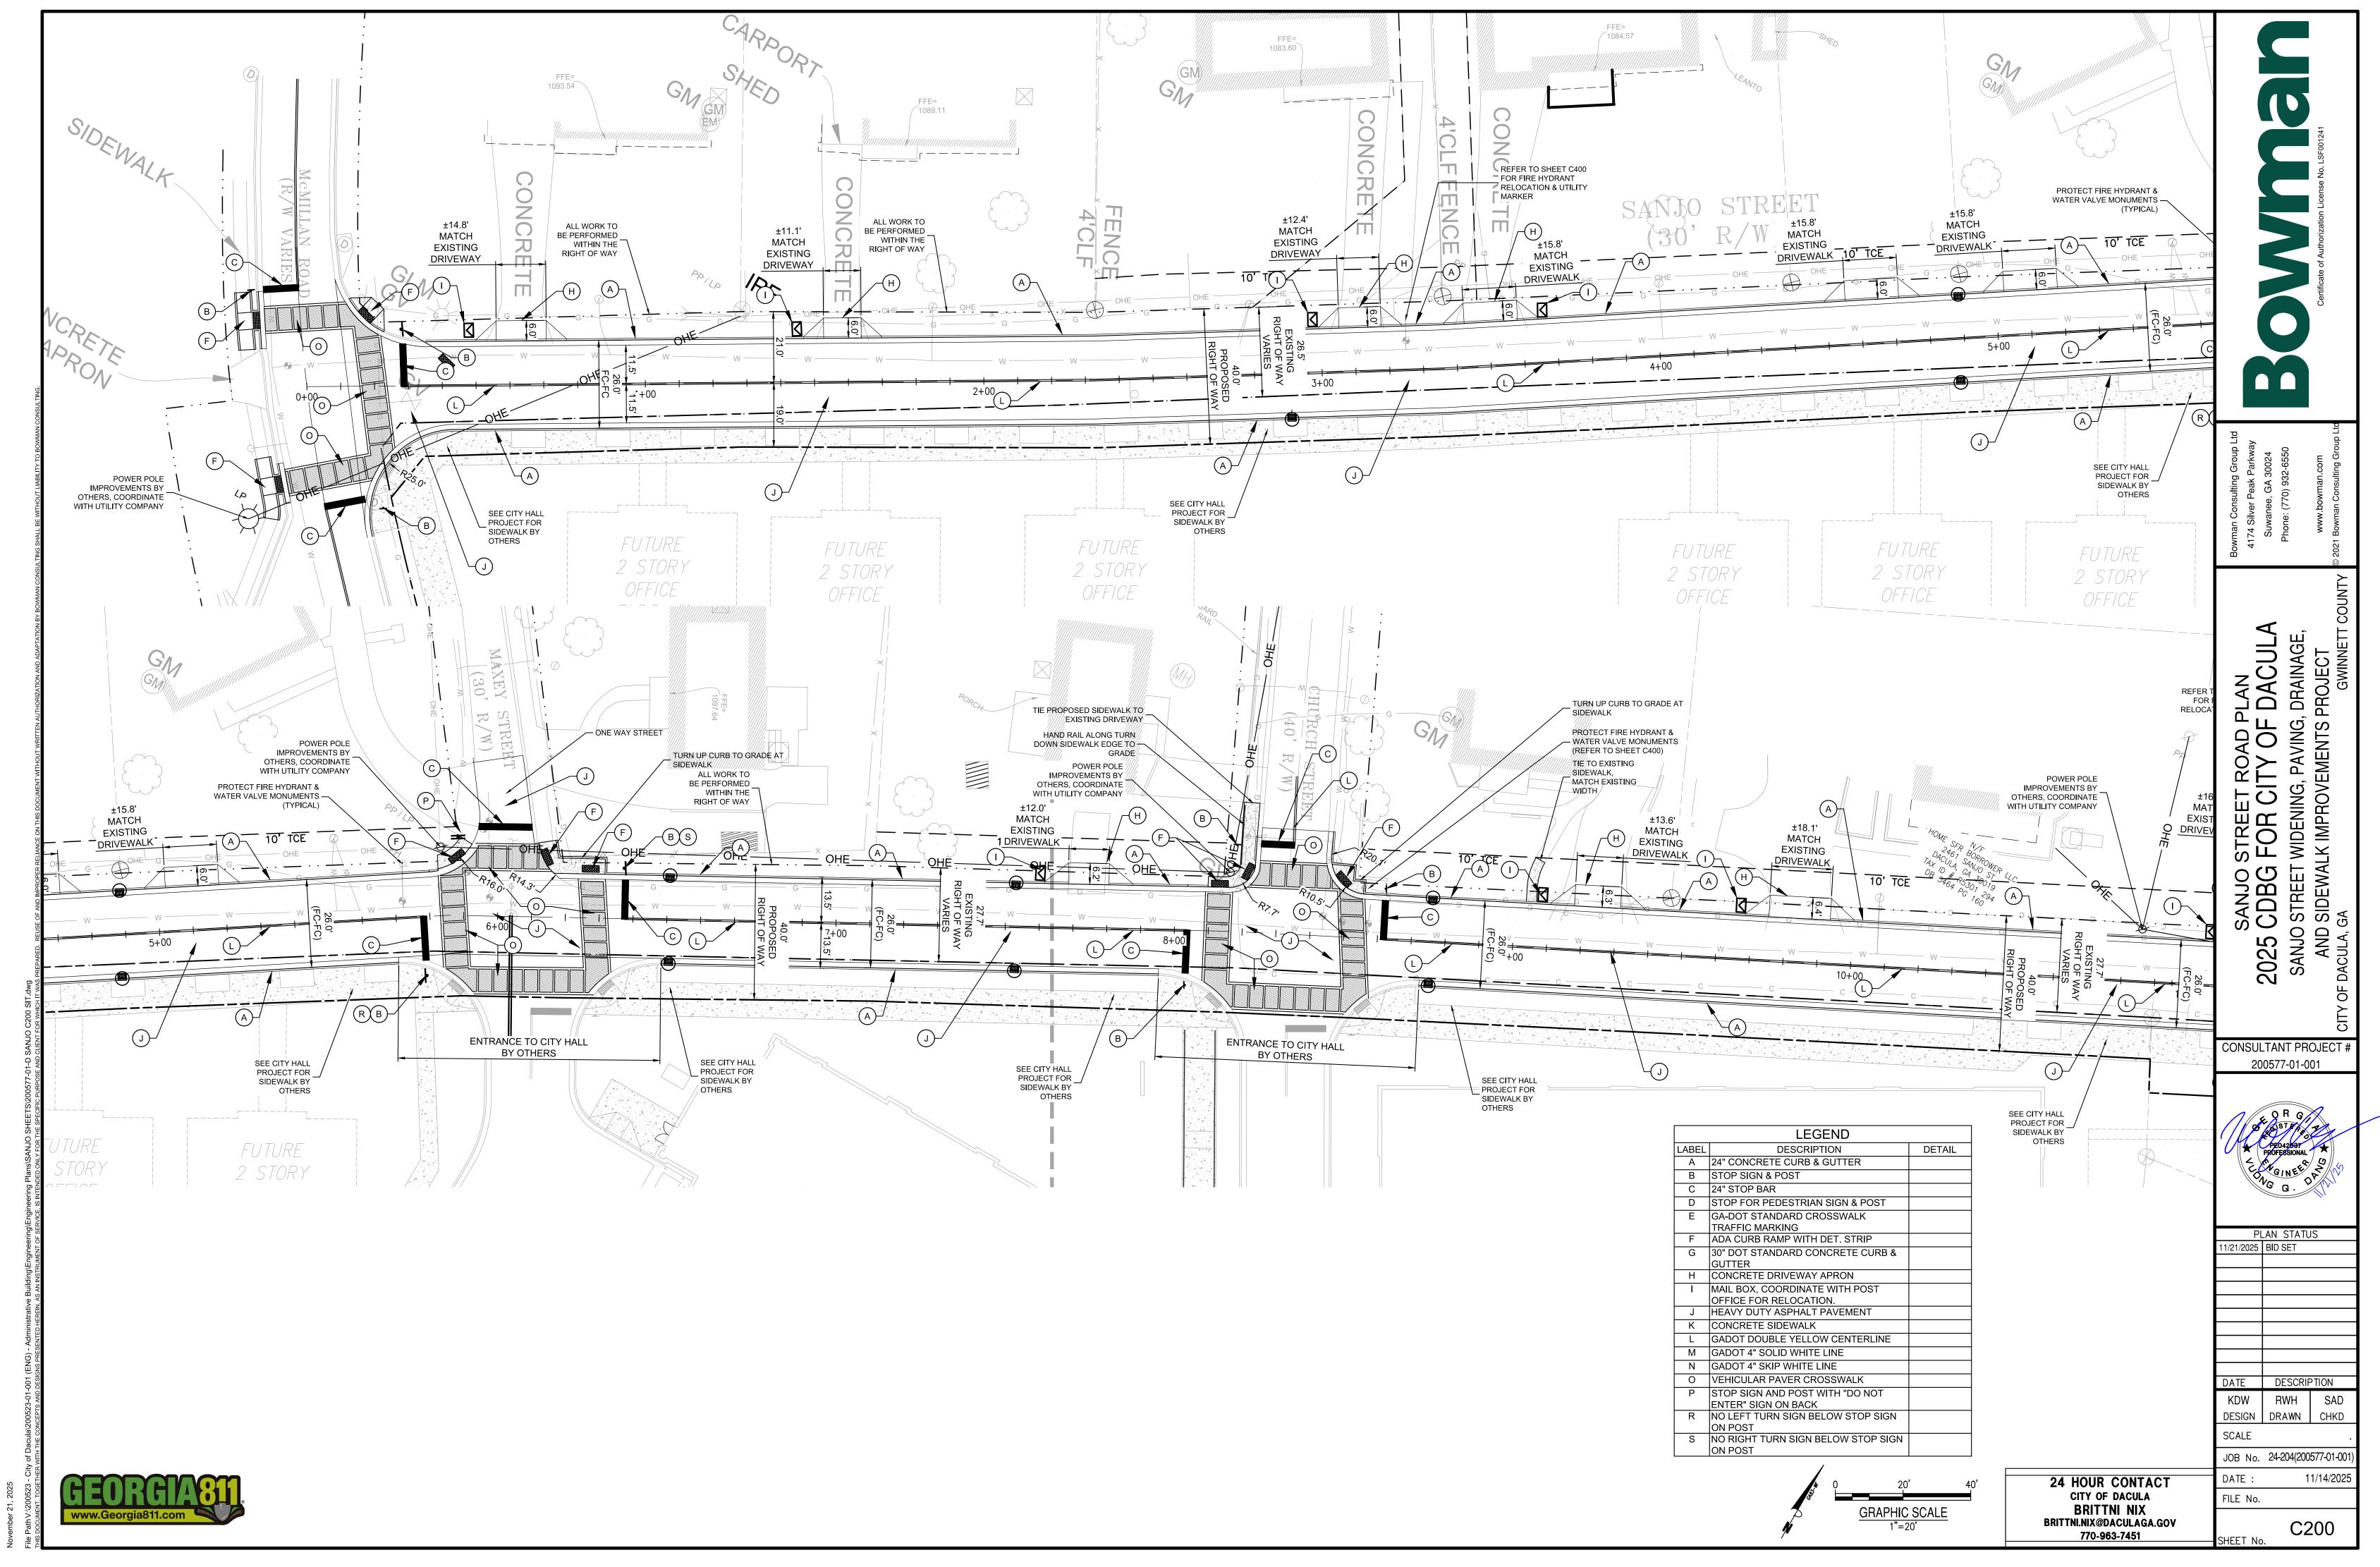
DATE DESCRIPTION RWH DESIGN | DRAWN | CHKD

JOB No. 24-204(200577-01-001 11/14/202





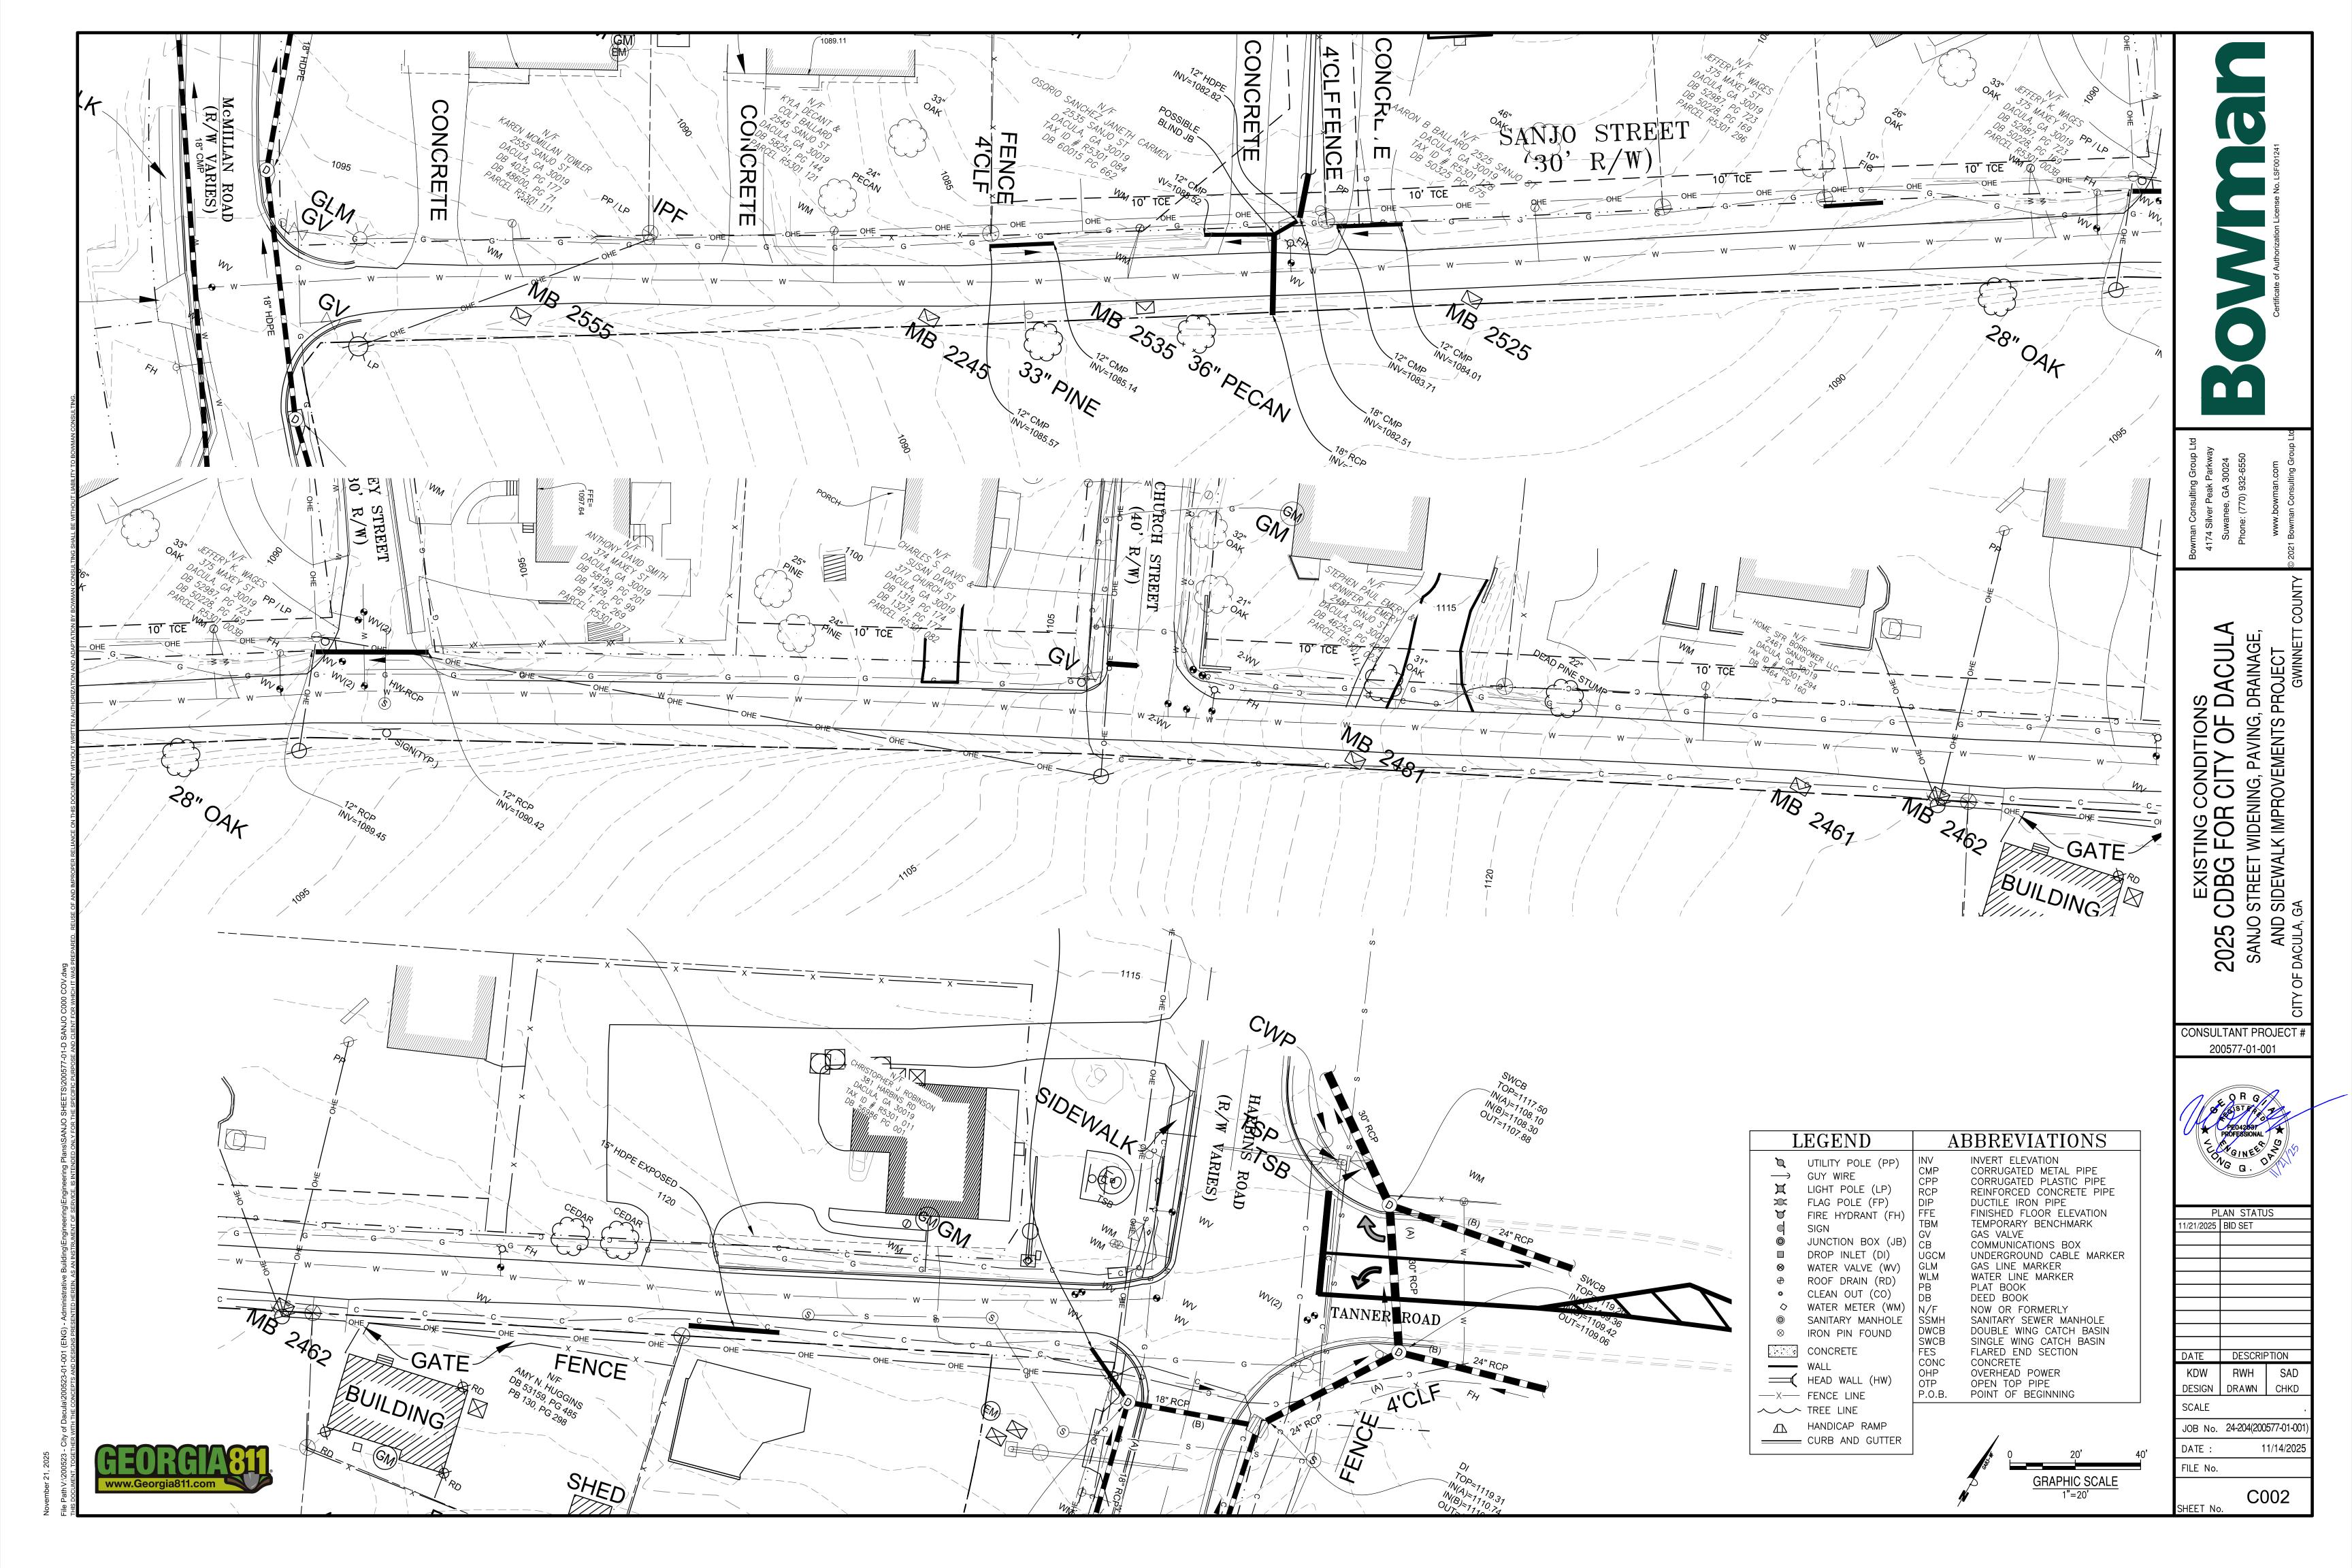

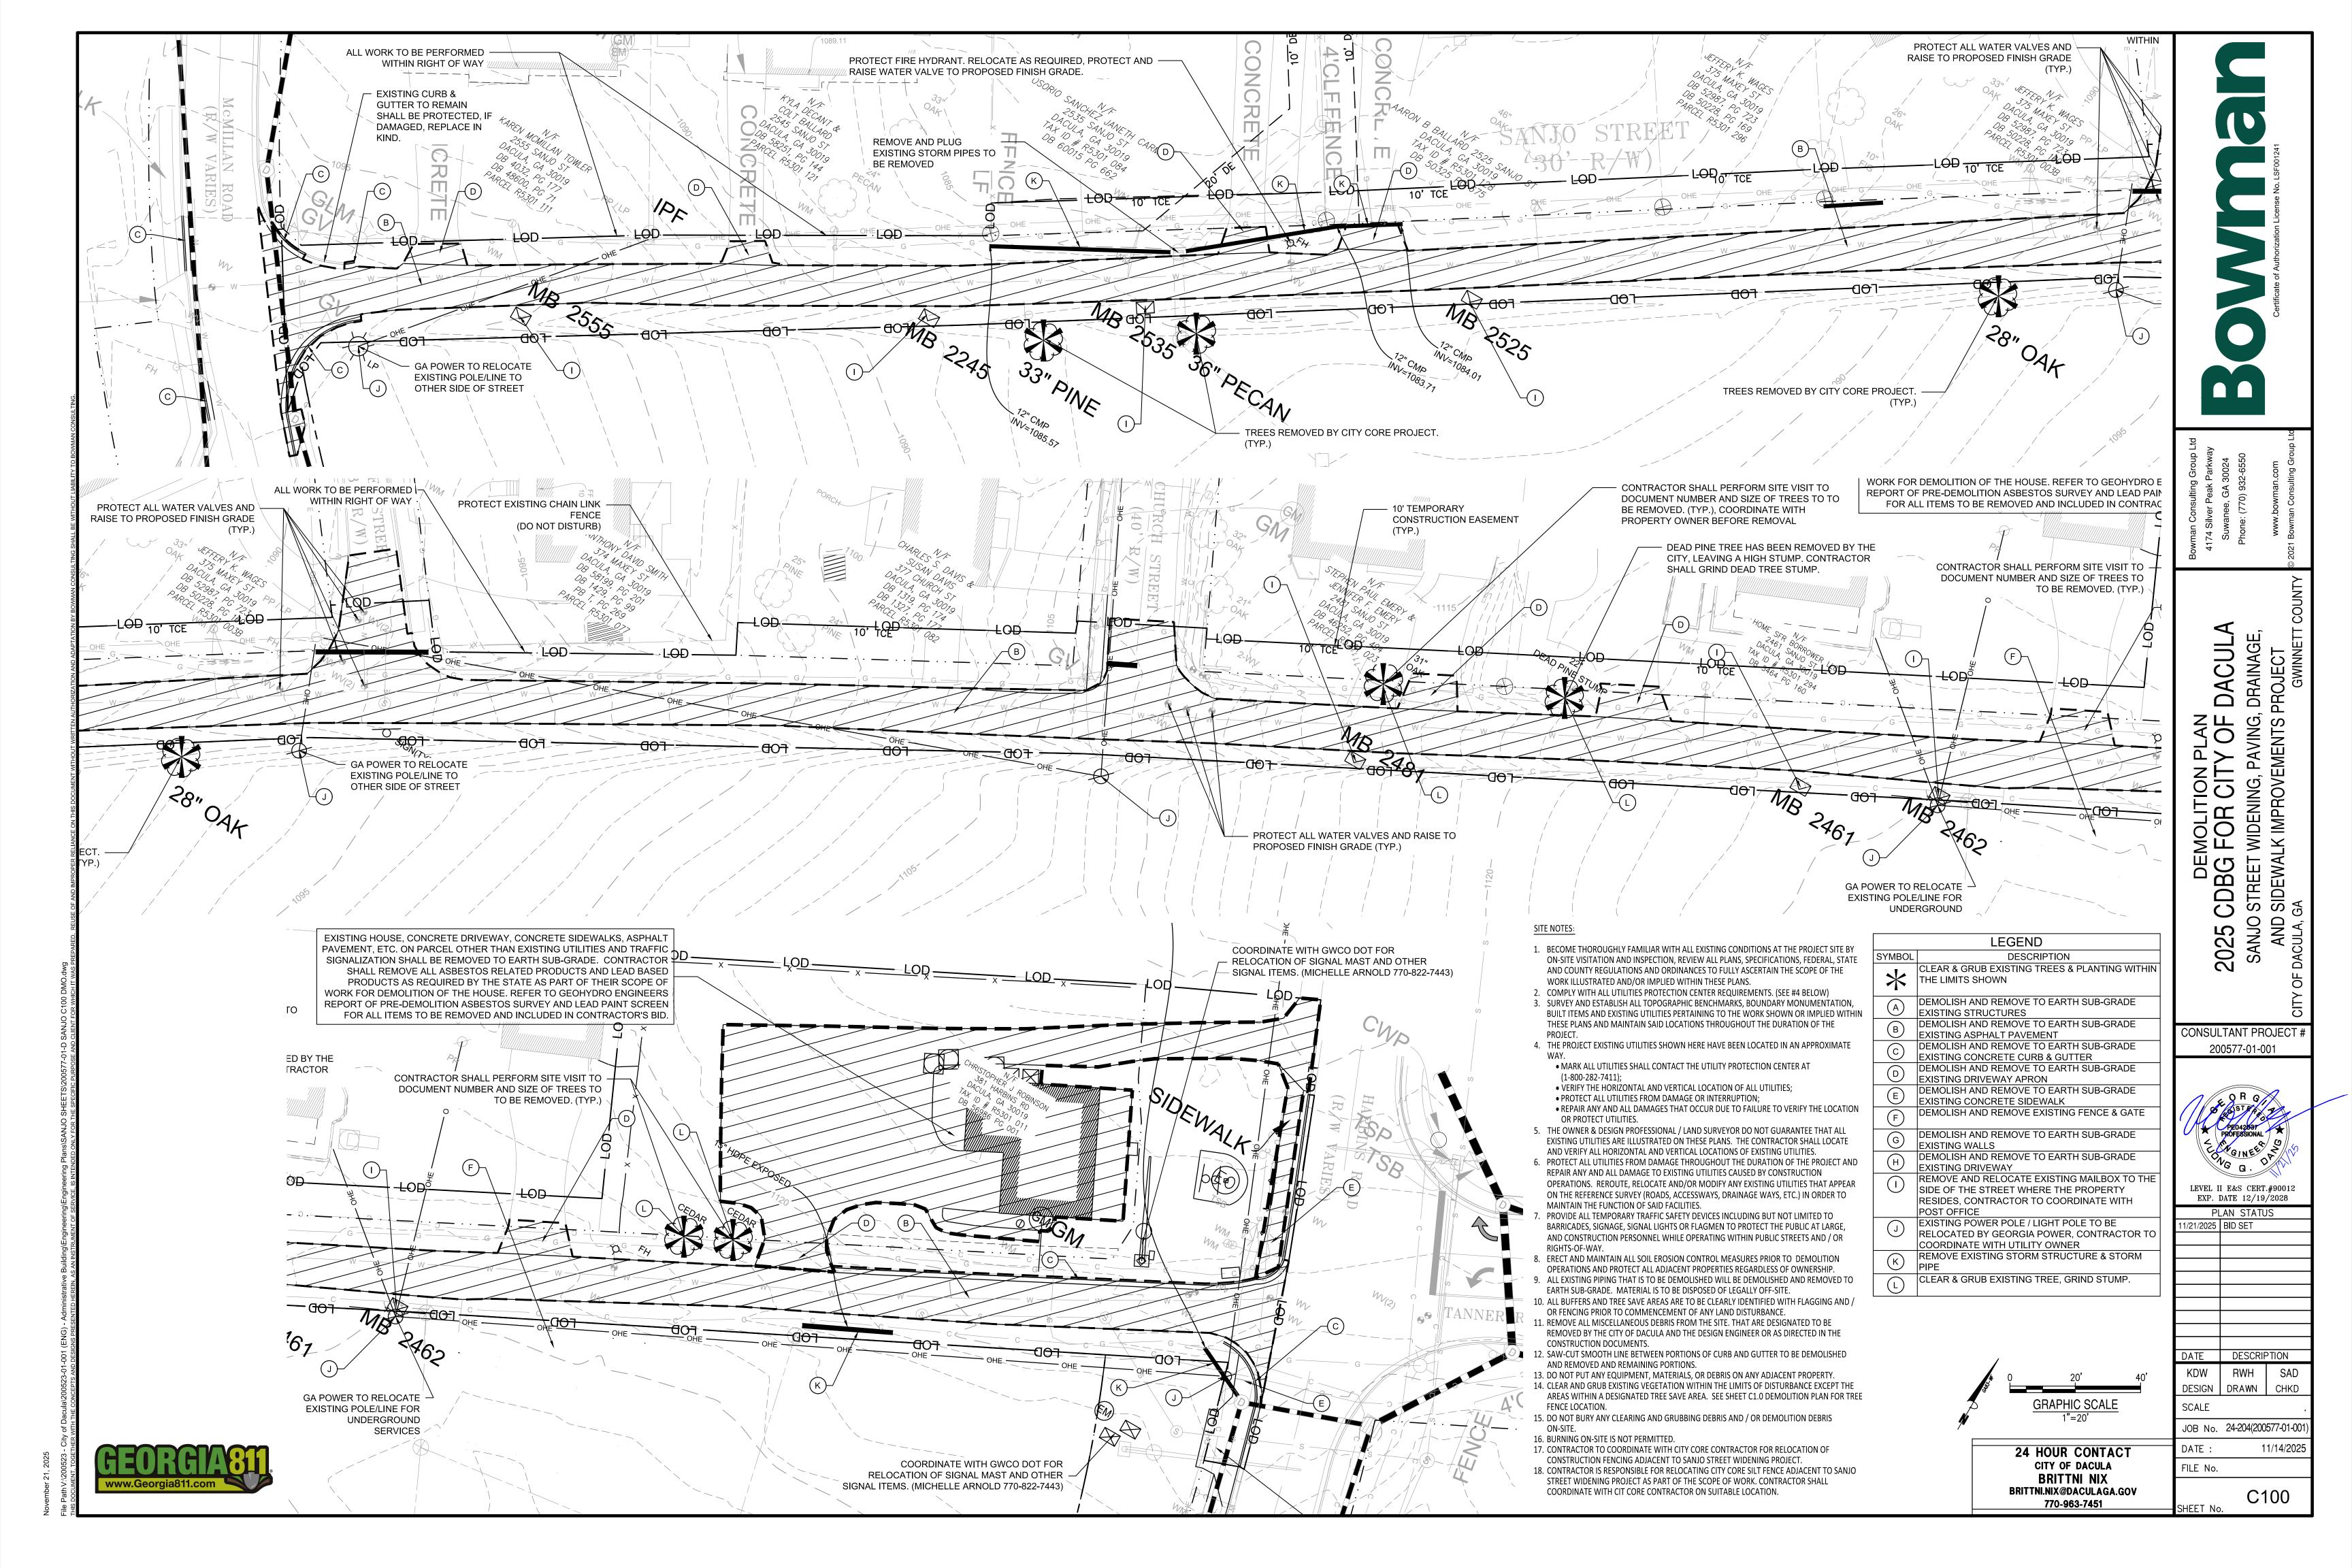

LEGEND DESCRIPTION DETAIL A 24" CONCRETE CURB & GUTTER B STOP SIGN & POST C 24" STOP BAR D STOP FOR PEDESTRIAN SIGN & POST E GA-DOT STANDARD CROSSWALK TRAFFIC MARKING

F ADA CURB RAMP WITH DET. STRIP G 30" DOT STANDARD CONCRETE CURB & H CONCRETE DRIVEWAY APRON I MAIL BOX, COORDINATE WITH POST OFFICE FOR RELOCATION. J HEAVY DUTY ASPHALT PAVEMENT K CONCRETE SIDEWALK L GADOT DOUBLE YELLOW CENTERLINE M GADOT 4" SOLID WHITE LINE N GADOT 4" SKIP WHITE LINE O VEHICULAR PAVER CROSSWALK P STOP SIGN AND POST WITH "DO NOT ENTER" SIGN ON BACK
R NO LEFT TURN SIGN BELOW STOP SIGN ON POST S NO RIGHT TURN SIGN BELOW STOP SIGN ON POST

SANJO & TANNER INTERSECTION PI 2025 CDBG FOR CITY OF DACL SANJO STREET WIDENING, PAVING, DRAINA AND SIDEWALK IMPROVEMENTS PROJECTOR DACULA, GA

CONSULTANT PROJECT # 200577-01-001



PLAN STATUS


11/21/2025 BID SET

DATE	DESCRIF	PTION
KDW	RWH	SAD
DESIGN	DRAWN	CHKD


SCALE JOB No. 24-204(200577-01-001


11/14/2025

C201 SHEET No.

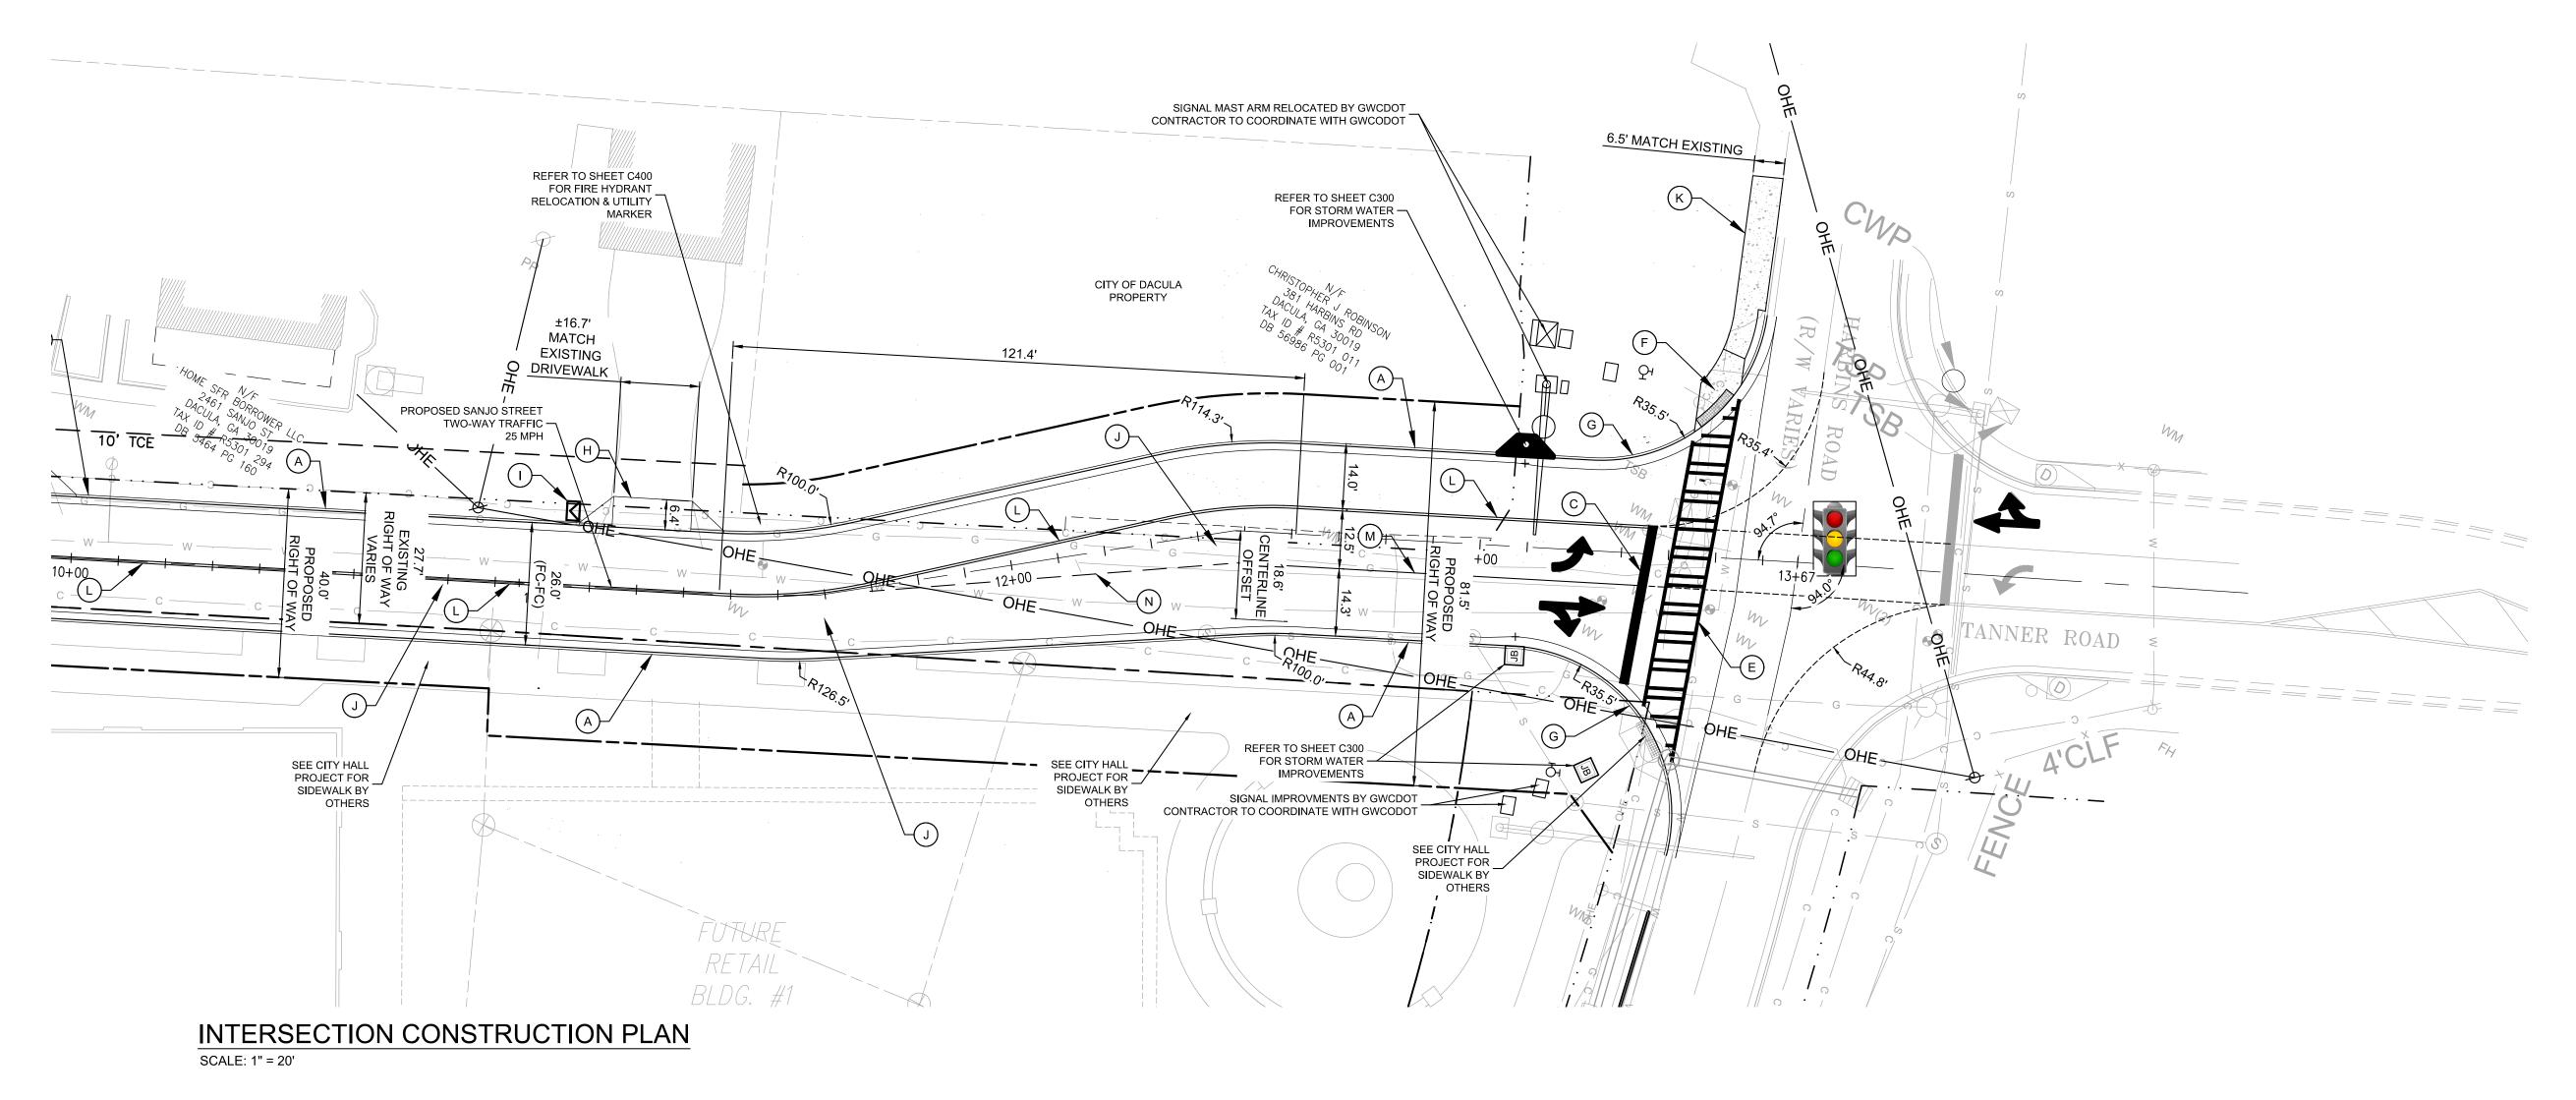



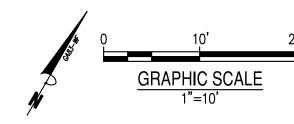

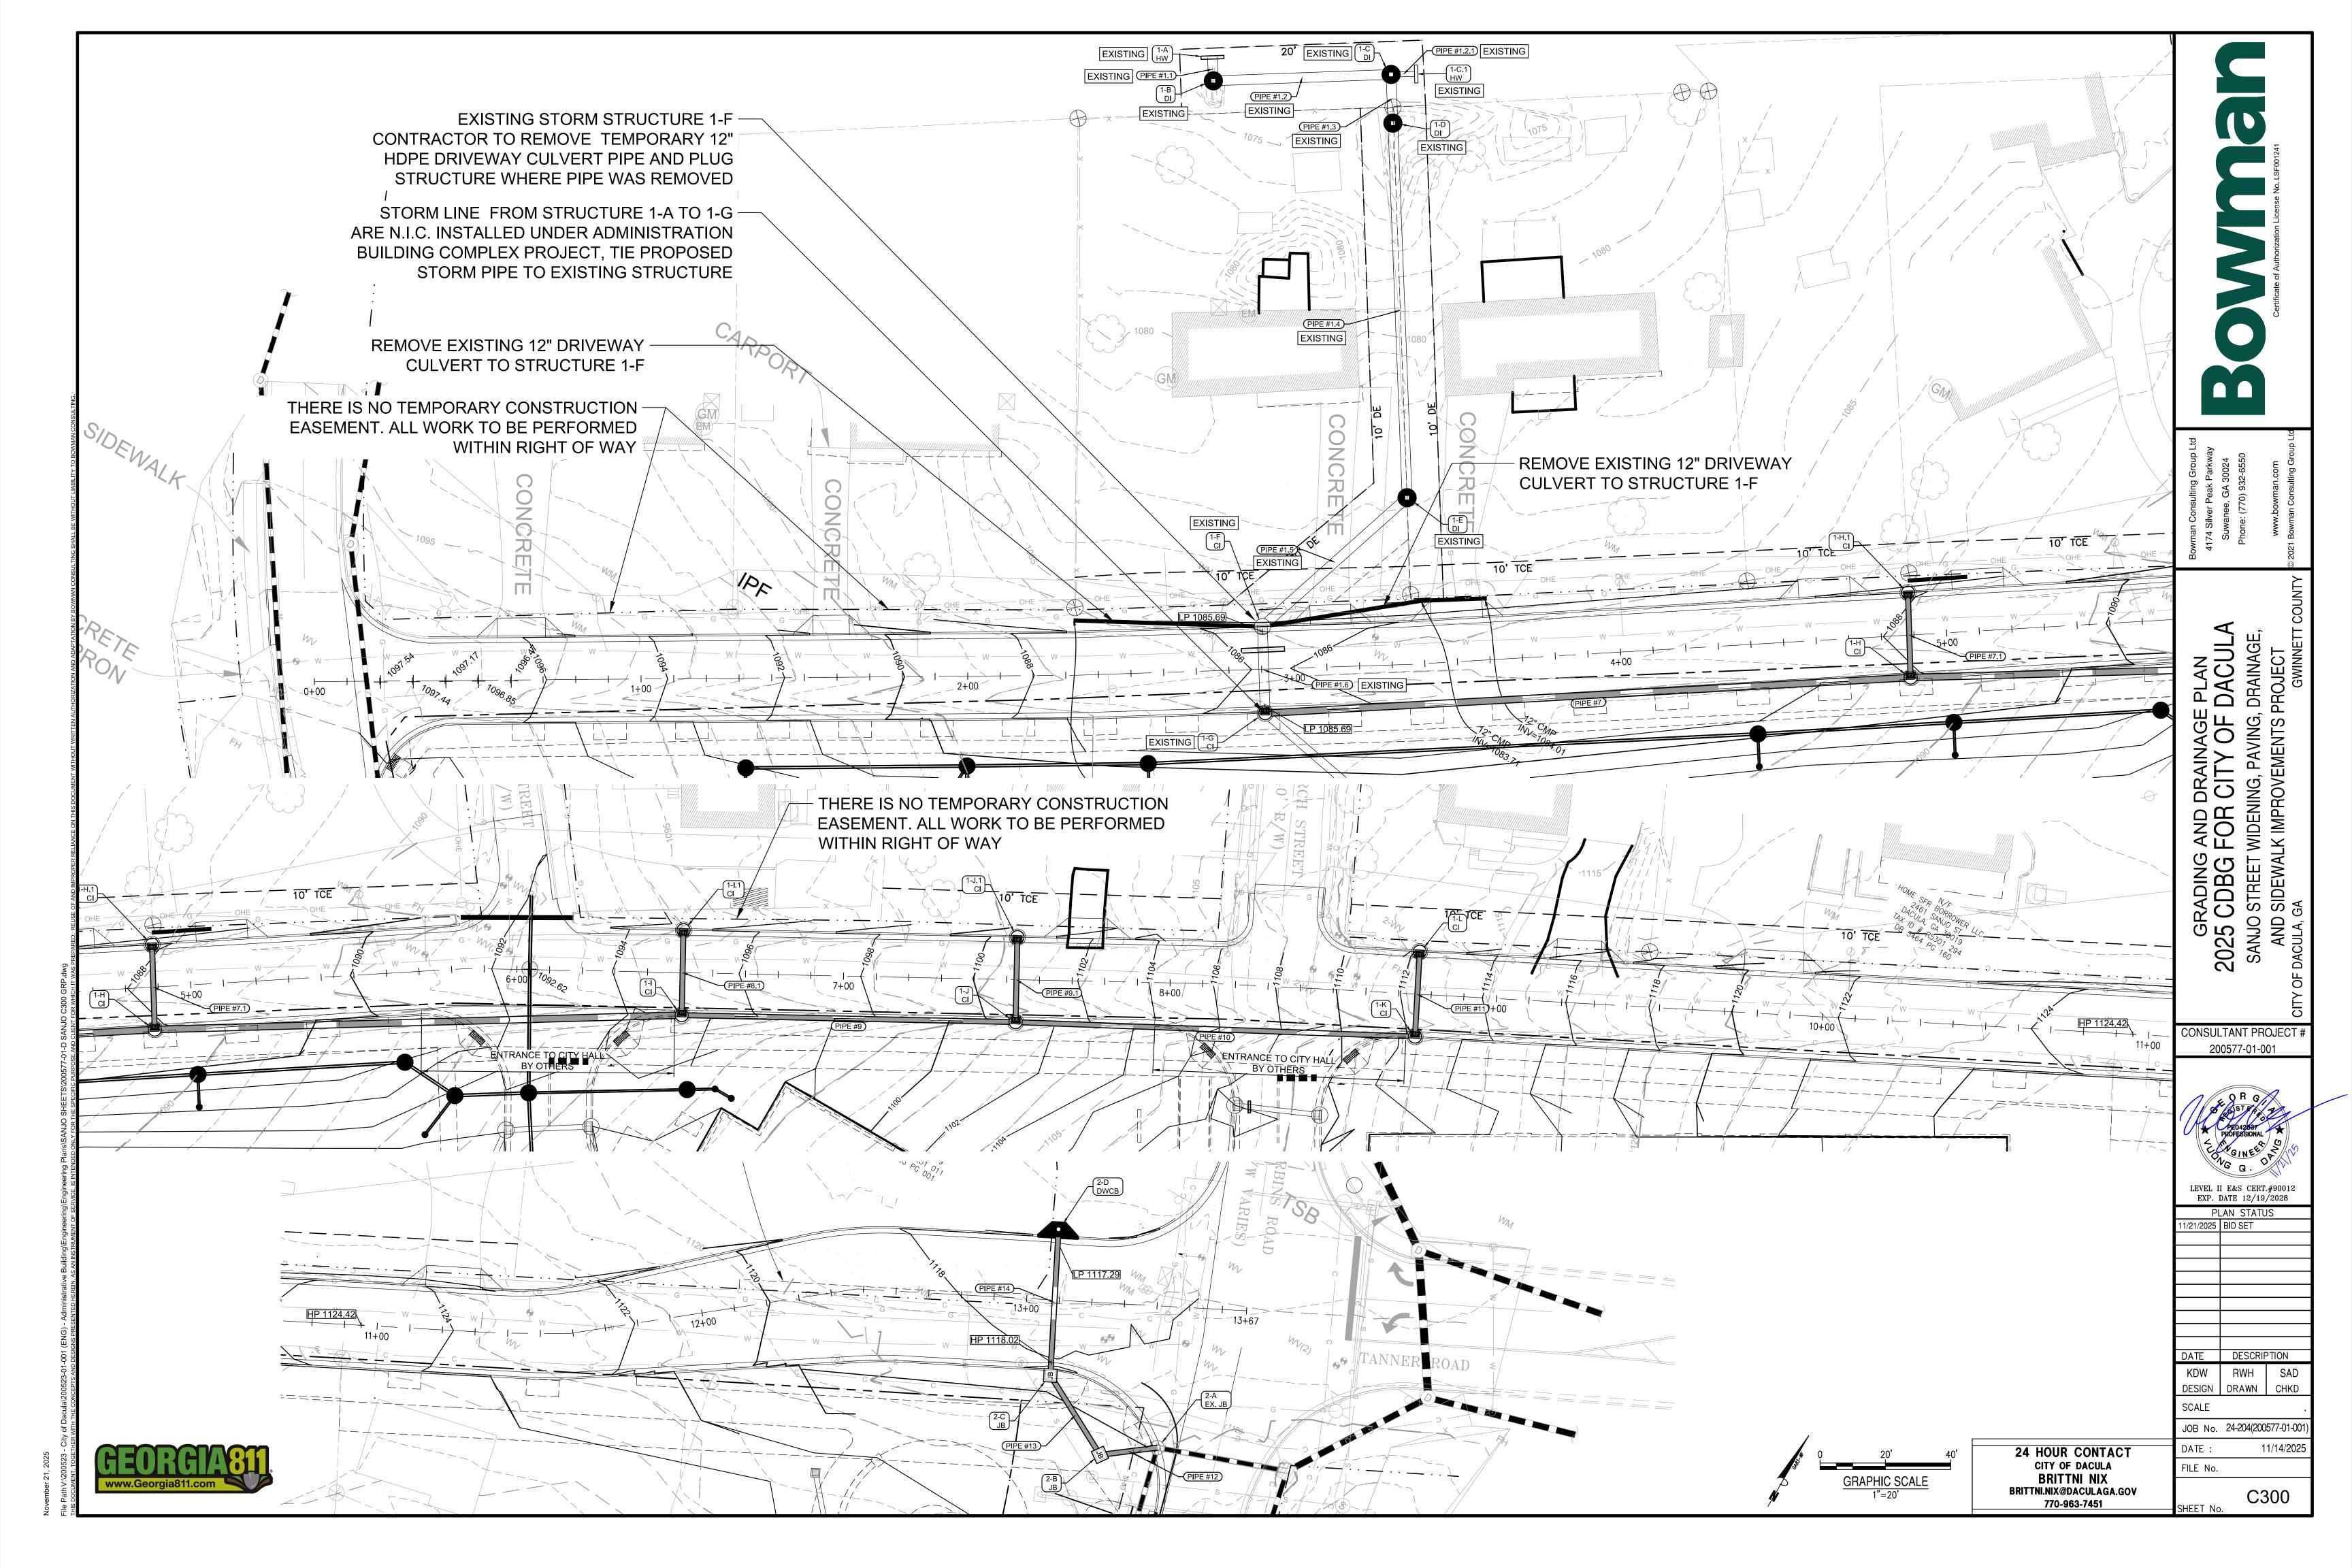

HIGH PT ELEV = 1124.37 HIGH PT STA = 11+12.00 PVI STA = 10+87.98PVI ELEV = 1124.61 PVI STA = 11+13.19AD = -3.53%PVI ELEV = 1124.36AD = -2.53%K=13.59-_K=0.95 47.91' VC 2.40' VC PVC = 10+64.02ELEV = 1124.00PVC = 11+12.00LOW PT ELEV = 1117.64PVT = 11+11.93ELEV = 1124.37LOW PT STA = 13+10.90ELEV = 1124.37PVT = 11+14.39PVI STA = 13+08.56HIGH PT ELEV = 1123.31ELEV = 1124.32HIGH PT ELEV = 1123.39PVI ELEV = 1117.62HIGH PT STA = 11+42.90HIGH PT STA = 10+39.77AD = 1.52%PVI STA = 11+65.81PVI STA + 10+38.70 ,–K=9.72 | PVI ELEV = 1122.50 14.73° VC PVC = 13+01.20 ELEV = 1117.69 PVI ELEV = 1123.36AD = -0.23%AD = -0.20%—K=200.09 K=10.60-2.16' VC 45.81' VC PVT = 13+15.93PVC = 11+42.90 PVC = 10+37.62 ELEV = 1123.33 PVT = 10+39.77 LOW PT ELEV = ELEV 3.88 1123.39 LOW PT STA = 8+94.14 ELEV = 1117.65 **1125** ELEV = 1123.31PVT = 11+88.71 ELEV = 1121.64 PVI ELEV = 1116.97 AD = 0.07% HIGH PT ELEV = 1123.33 HIGH PT STA = 10+37.56 PVI STA = 10+15.99 LOW PT ELEV = 1109.45 LOW PT STA = 8+46.02 PVI STA = 8+47.71 PVI ELEV = 1109.63 PVI ELEV = 1122.74 LOW PT ELEV = 1117.69 LOW PT STA = 13+00.81 AD = -3.39%K=12.72 AD = 0.95% K = 3.56 3.52 + 600 PVI STA = 12+74.29 PVI ELEV = 1117.96 AD = 2.17% HIGH PT ELEV = 1112.54 HIGH PT STA = 8+76.92 43.14 VC PVC = 9+94.42 ELEV = 1121.42 PVT = 10+37.56 PVI STA = 8+64.53 PVI ELEV = 1111.57 AD = -3.71% K=24.41 ELEV = 1123.3353.04° VC LOW PT ELEV = 1096.07 LOW PT STA = 6+69.39 PVI STA = 7+21.93 PVC + 12 + 47.77ELEV = 1118.80 PVT = 13+00.81 ELEV = 1117.69 24.77' VC PVI ELEV = 1098.78 AD = 1.33% K=79.23 PVC = 8+52.15 ELEV = 1110.14 PVT = 8+76.92 ELEV = 1112.54 HIGH PT ELEV = 1120.36 HIGH PT STA = 9+77.24 LOW PT ELEV = 1088.26 LOW PT STA = 4+92.28 HIGH PT ELEV = 1097.75 105.09' VC PVI STA = 9 + 75.27HIGH PT STA = 0+14.89 PVI STA = 0+51.29 LOW PT ELEV = 1118.84 LOW PT STA = 12+46.38 PVI ELEV = 1120.24 PVI STA = 5+45.07AD = -1.75%PVI ELEV = 1097.19 PVI STA = 12+41.27PVI ELEV = 1089.42 ****K=2.26 PV ELEV = 1119.00 AD = -4.08%AD = 3.25%HIGH PT ELEV = 1094.08 0 3.95' VC PVC = 9+73.29 ELEV = 1120.09 PVT = 9+77.24 ELEV = 1120.36 AD = 1.70% K=32.46-HIGH PT STA = 6+30.63 6 8 9 9 ⊢K⊨17.85 105.59' VC V_K=5.99 10.21' VC PVC = 12+36.17 ELEV = 1119.25 PVT = 12+46.38 PVC = 4+92.28 ELEV = 1088.26 PVC = 0+14.89PVI ELEV = 1093.94 HLOW PT ELEV = 1089.43 LOW PT STA = 1+91.37 PVI STA = 1+89.78 PVI ELEV = 1089.56W PT ELEV = 1086.65 AD = 0.07% LOW PT STA = 2+55.57 K=47.47 PVI STA = 2+54.14 3.19 WC PVI ELEV = 1086.68 AD = 1.31% K=2.18 AD = -0.30% 으 글 K=17.38 ELEV = 1097.75 K=17.38 5.28 VC PVT = 0+87.68 ELEV = 1095.15 PVT = 5+97.87 ELEV = 1092.30 LOW PT ELEV = 1102.19 LOW PT STA = 7+74.61 PVI STA = 7+77.24 PVI ELEV = 1102.36 ELEV = 1118.84 LOW PT ELEV = 1119.27 LOW PT STA = 12+35.90 PVI STA = 12+14.06 PVI ELEV = 1120.33 AD = 0.38% K=115.46 43.68' VC PVC = 11+92.21 ELEV = 1121.48 PVT = 124.35.90 LOW PT ELEV = 1086.96 LOW PT STA = 3+99.28 PVI STA = 4+29.43 PVI ELEV = 1087.25 AD = 0.08% K=802.36 87.25 60.30' VC 65.25 ELEV = 1087.25 AD = 0.08% K=802.36 80.36 ELEV = 1087.25 AD = 3.65%**Ч-**К=1.**4**4 LOW PT ELEV = 1089.75 5.25' VC PVC = 7+74.61 ELEV = 1102.19 LOW PT STA = 1+85.37 PV STA = 1+56.15 PV ELEV = 1091.31 PVT = 7 + 79.87AD = 0.26% K=222.30— ELEV = 1102.62 PVT = 12+35.90 ELEV = 1119.27 58.43' VC LOW PT ELEV = 1087.56LOW PT STA = 4+59.66PVC = 1+26.94 ELEV = 1092.95 PVT = 1+85.37 HIGH PT ELEV = 1121.64 HIGH PT STA = 11+88.77 PVI \$TA = 4+61.17 PVI ELEV = 1087.57 PVI STA = 11+89.92 PVI ELEV = 1121.60 AD = -1.50% -K=1.53 2.29' VC ELEV = 1089.75AD = 1.17% LOW PT ELEV = 1086.74–K=2.58 LOW PT STA = 2+52.40PVC = 4+59.66 ELEV = 1087.56 PVI STA = 2 + 23.71PVI ELEV = 1087.72 PVC = 11+88.77 ELEV = 1121.64 AD = 1.88% PVT = 4+62.68K=30.55— ELEV = 1087.61 57.38' VC PVC = 1+95.02 ELEV = 1089.23 PVT = 11 + 91.06ELEV = 1121.54 PVT = 2 + 52.40 $^{\text{El}}_{0} + 50^{086.74} + 1 + 00$ 2+50 3+00 5+50 6+00 8+50 10+00 10+50 11+50 2+00 4+00 5+'00 6+50 7+00 8+00 11+00 12+00 12+50 PROPOSED SANJO PROFILE VIEW

HIGH PT ELEV = 1124.44

HIGH PT STA = 10+98.46

24 HOUR CONTACT CITY OF DACULA **BRITTNI NIX** BRITTNI.NIX@DACULAGA.GOV

770-963-7451

DATE: 11/14/2025 FILE No.

HORIZONTAL SCALE: 1"=20'

VERTICAL SCALE: 1"=2"

PLAN STATUS 1/21/2025 | BID SET

LEVEL II E&S CERT.#90012 EXP. DATE 12/19/2028

CONSULTANT PROJECT #

200577-01-001


ROAD PROFILE

2025 CDBG FOR CITY OF DACULA
SANJO STREET WIDENING, PAVING, DRAINAGE,
AND SIDEWALK IMPROVEMENTS PROJECT
OF DACULA, GA
GWINNETT CO

DATE DESCRIPTION KDW RWH SAD DESIGN DRAWN CHKD

SCALE JOB No. 24-204(200577-01-001

C310 SHEET No.

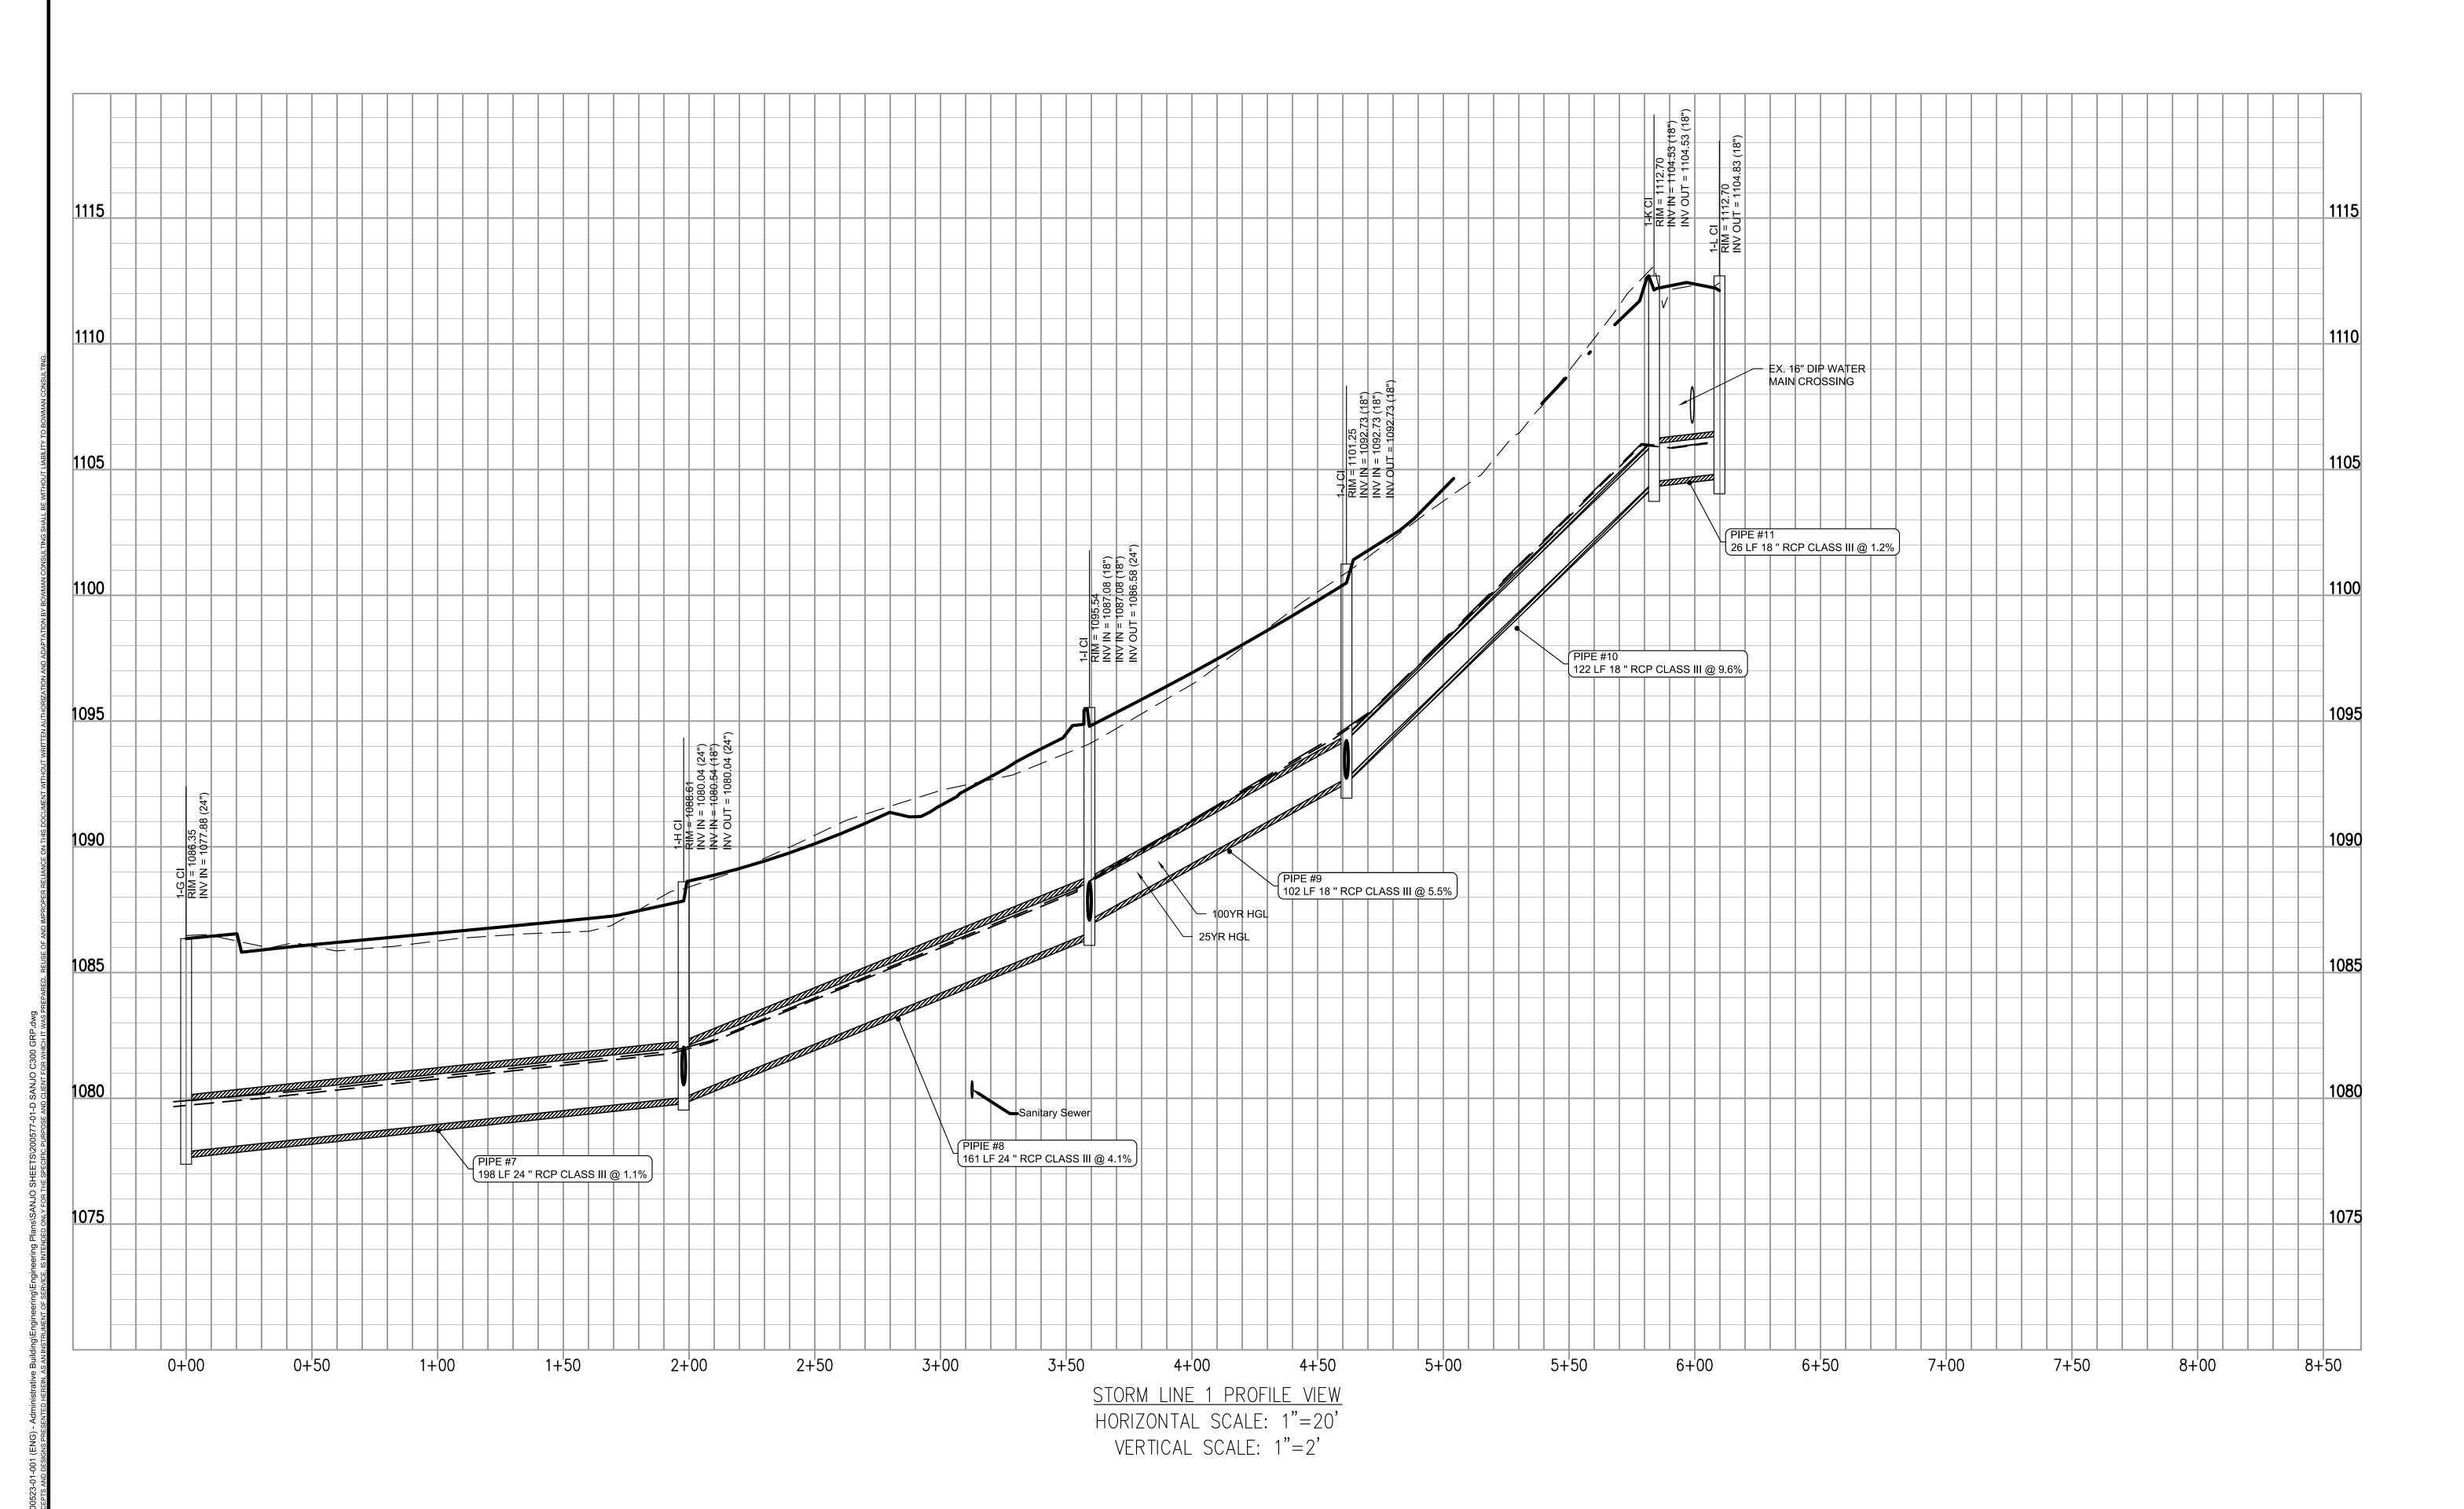

24 HOUR CONTACT
CITY OF DACULA
BRITTNI NIX
BRITTNI.NIX@DACULAGA.GOV
770-963-7451

STORM PROFILE

2025 CDBG FOR CITY OF DACULA
SANJO STREET WIDENING, PAVING, DRAINAGE,
AND SIDEWALK IMPROVEMENTS PROJECT
OF DACULA, GA
GWINNETT COL

CONSULTANT PROJECT # 200577-01-001

LEVEL II E&S CERT.#90012 EXP. DATE 12/19/2028 PLAN STATUS


11/21/2025 BID SET

DATE DESCRIPTION KDW RWH SAD
DESIGN DRAWN CHKD SCALE


JOB No. 24-204(200577-01-001) 11/14/2025

C320 SHEET No.

STORM LINE 2 PROFILE VIEW HORIZONTAL SCALE: 1"=20' VERTICAL SCALE: 1"=2"

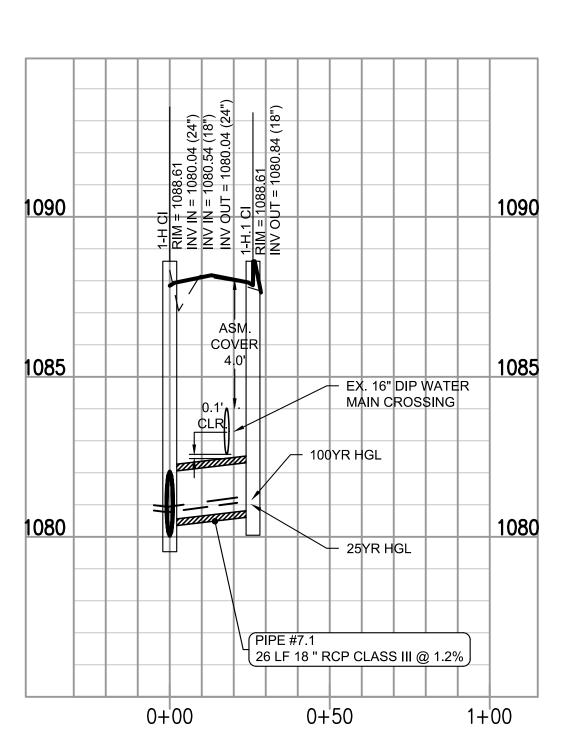

STORM LINE 1-H PROFILE VIEW HORIZONTAL SCALE: 1"=20' VERTICAL SCALE: 1"=2'

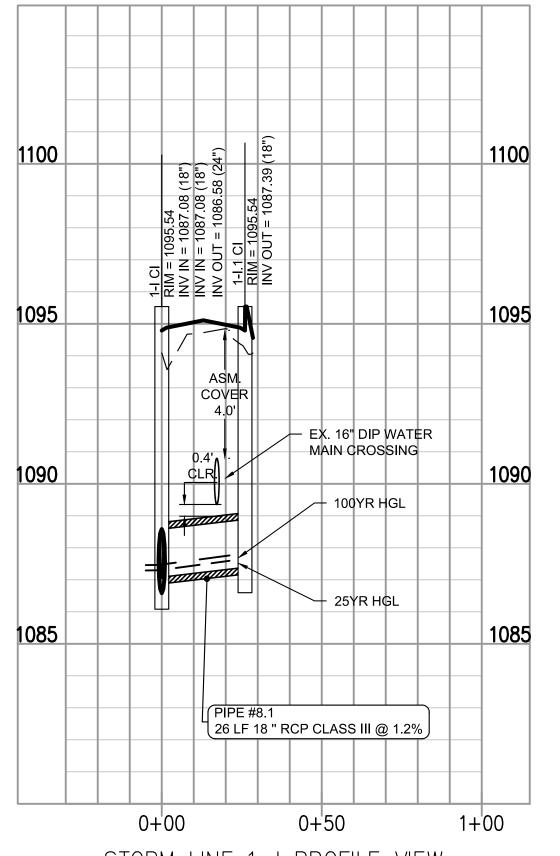


STORM LINE 1-I PROFILE VIEW HORIZONTAL SCALE: 1"=20' VERTICAL SCALE: 1"=2"

1.30

9.33

7.44

30

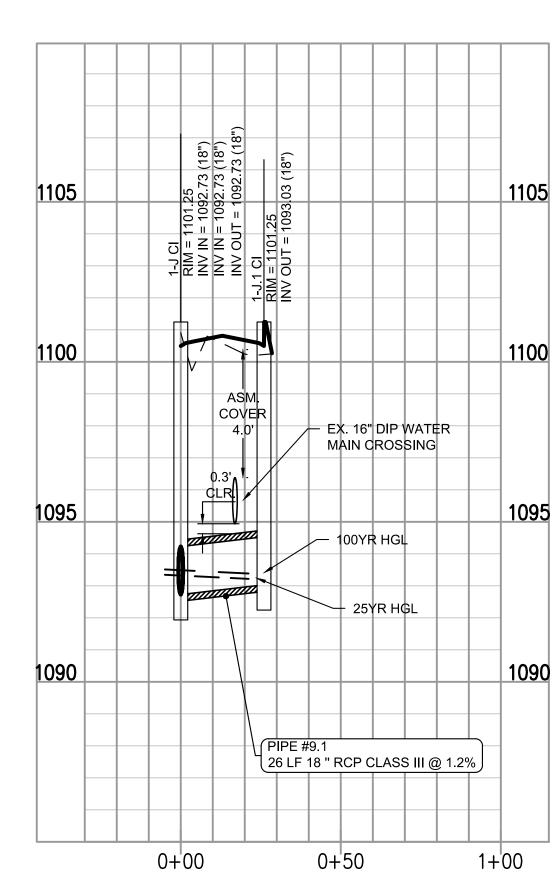

STORM LINE 1-J PROFILE VIEW HORIZONTAL SCALE: 1"=20' VERTICAL SCALE: 1"=2'

											PIPE CHAR	т										
	Pipe			D.A.	D.A.	IMPERV.		Тс	I 25	Q 25	Q25 (Sum)	1100	Q100	Q100 (Sum)	Slope	Lgth.	Size	Vel.	I 10	Q 10	Gutter	Gutter
Pipe #	Mat.	Location	Inlet Type	(Acres)	(Sum)	AREA (ac)	С	(Min)	(In/Hr)	(cfs)	(cfs)	(In/Hr)	(cfs)	(cfs)	%	+/-(ft.)	(In)	(fps)	(In/Hr)	(cfs)	Slope	Spread
EX2	RCP	2A.1-2A	DWCB	0.37	0.37	0.37	0.95	5	9.276	3.22	3.22	11.436	3.98	3.98	10.86	58	18	4.60	7.30	2.54	1.5	4.3
14	RCP	2D-2C	DWCB	0.45	0.45	0.37	0.85	5	9.276	3.53	3.53	11.436	4.35	4.35	0.50	45	18	4.26	7.30	2.78	1.1	4.7
13	RCP	2C-2B	JB	0.00	0.45			5	9.276	0.00	3.53	11.436	0.00	4.35	0.50	29	18	3.51				
12	RCP	2B-2A	JB	0.00	0.45			5	9.276	0.00	3.53	11.436	0.00	4.35	0.50	18	18	3.51				
EX1	RCP	2A-EX-8	JB	0.00	0.82			5	9.276	0.00	6.76	11.436	0.00	8.33	1.26	41	18	6.67				
OUTFAL	L EX.RCP	1G.1-1G	EX.JB*	SEE (CITY HALL	HYDRO REPO	ORT			9.96			44.31		1.00		24	6.38				
9.1	RCP	1J.1-1J	Cl	0.04	0.04	0.04	0.88	5	9.276	0.33	0.33	11.436	0.40	0.40	1.00	31	18	2.03	7.30	0.26	7.1	2.7
8.1	RCP	11.1-11	Cl	0.03	0.03	0.03	0.94	5	9.276	0.26	0.26	11.436	0.32	0.32	1.00	31	18	2.05	7.30	0.21	5.6	2.6
7.1	RCP	1H.1-1H	Cl	0.05	0.05	0.05	0.95	5	9.276	0.41	0.41	11.436	0.51	0.51	1.00	31	18	2.02	7.30	0.32	3.5	3.4
11	RCP	1L-1K	Cl	0.06	0.06	0.06	0.95	5	9.276	0.53	0.53	11.436	0.65	0.65	1.00	31	18	2.01	7.30	0.42	8.7	3.1
10	RCP	1K-1J	CI	0.20	0.26	0.12	0.71	5	9.276	1.32	1.85	11.436	1.63	2.28	9.70	122	18	3.00	7.30	1.04	7.1	4.6
9	RCP	1J-1I	CI	0.10	0.36	0.08	0.86	5	9.276	0.79	2.65	11.436	0.98	3.26	5.50	102	18	6.89	7.30	0.62	5.6	3.9
8	RCP	1I-1H	CI	0.20	0.56	0.06	0.52	5	9.276	0.96	3.61	11.436	1.19	4.45	4.10	161	24	3.69	7.30	0.76	5.6	4.2
7	RCP	1H-1H	CI	0.17	_ 0.73	0.11	0.72	5	9.276	1.14	_ 4.75	11.436	1.40	_ 5.85	1.00	158	24	5.31	7.30	0.90	3.5	4.9
1.6	EX.RCP	1G-1F	EX.CI	0.49	0.49	0.34	0.76	5	9.276	3.47	3.47	11.436	4.28	4.28	1.00	41	30	5.68	7.30	2.73	1.5	4.4
1.5	EX.RCP	1F-1E	EX.CI	0.13	0.62	0.13	0.95	5	9.276	1.18	4.65	11.436	1.46	5.74	1.00	20	30	5.88	7.30	0.93	1.5	2.9
1.4	EX.HDPE	1E-1D	EX.JB	0.00	0.62	0.00		5	9.276	0.00	4.65	11.436	0.00	5.74	3.50	125	30	5.65				
1.3	EX.HDPE	1D-1C	EX.JB	0.68	1.30	0.13	0.46	5	9.276	2.92	7.57	11.436	3.59	9.33	1.00	15	30	6.11				
1.2	EX.HDPE	1C-1B	EX.JB	0.00	1.30	0.00		5	9.276	0.00	7.57	11.436	0.00	9.33	1.00	54	30	6.12				

11.436

1B-1A

EX.JB

1.30

1.1 EX.HDPE

24 HOUR CONTACT
CITY OF DACULA
BRITTNI NIX
BRITTNI.NIX@DACULAGA.GOV
770-963-7451

STORM PROFILE

2025 CDBG FOR CITY OF DACULA
SANJO STREET WIDENING, PAVING, DRAINAGE,
AND SIDEWALK IMPROVEMENTS PROJECT
OF DACULA, GA
GWINNETT COL


CONSULTANT PROJECT # 200577-01-001

LEVEL II E&S CERT.#90012 EXP. DATE 12/19/2028 PLAN STATUS 1/21/2025 BID SET

DATE DESCRIPTION KDW RWH SAD DESIGN DRAWN CHKD

SCALE JOB No. 24-204(200577-01-001 11/14/2025

C321 SHEET No.

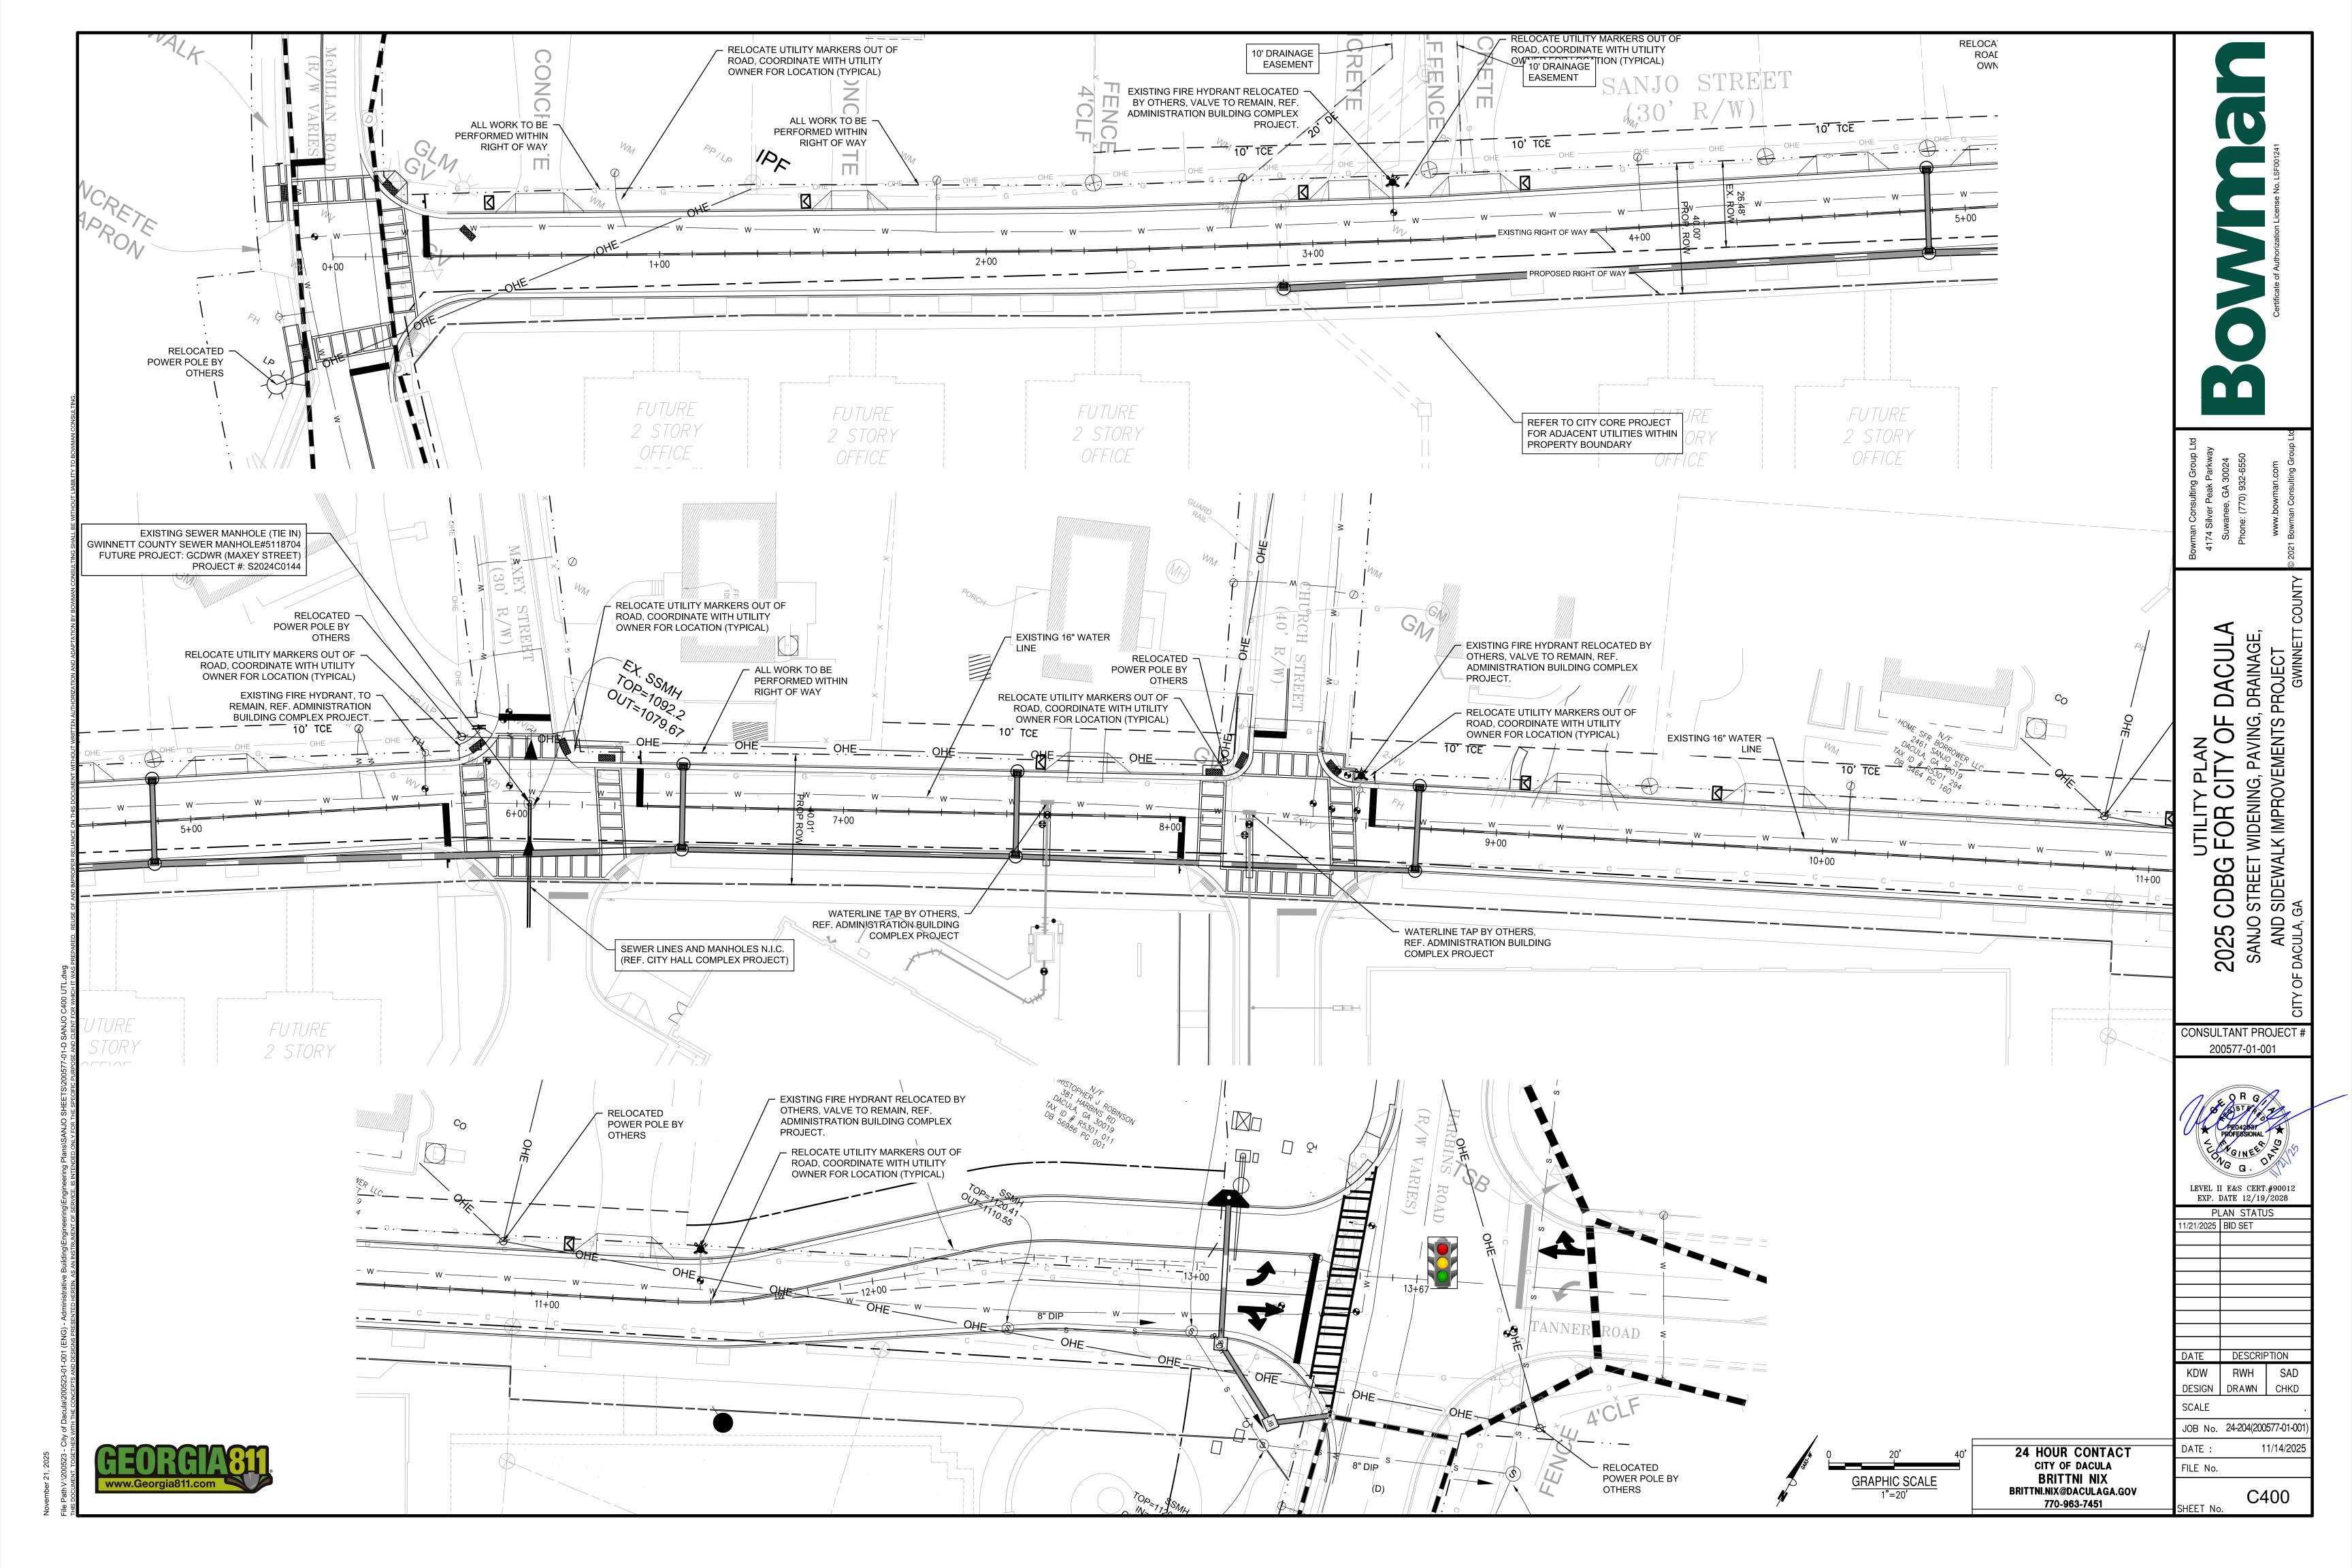

PRODUCT DISPOSAL PRACTICES TO COMPLY WITH WASTE DISPOSAL, SANITARY SEWER, OR SEPTIC TANK REGULATIONS

CONTAINERS FOR SUCH PRODUCTS SUCH AS FUELS, LUBRICANTS AND TARS WILL BE INSPECTED DAILY FOR LEAKS AND SPILLS. THIS INCLUDES ON-SITE VEHICLES AND MACHINERY DAILY INSPECTIONS AND REGULAR PREVENTATIVE MAINTENANCE OF SUCH EQUIPMENT. EQUIPMENT MAINTENANCE AREAS WILL BE LCATED AWAY FROM STATE WATER, NATURAL DRAINS AND STORM WATER DRAINAGE INLETS. IN ADDITION, TEMPORARY FUELING TANKS SHALL HAVE A SECONDARY CONTAINMENT LINER TO PREVENT/MINIMIZE SITE CONTAMINATION. DISCHARGE OF OILS, FUELS, AND LUBRICANTS IS PROHIBITED. PROPER DISPOSAL METHODS WILL INCLUDE COLLECTION IN A SUITABLE CONTAINER AND DISPOSAL AS REQUIRED BY LOCAL AND STATE REGULATIONS.

ALL PRODUCTS WIL BE STORED IN TIGHTLY SEALED ORIGINAL CONTAINERS WHEN NOT IN USE. EXCESS PRODUCT WILL NOT CONTRACTOR ONCE THE LOCATIONS HAVE BEEN DETERMINED. BE DISCHARGED TO THE STORM WATER COLLECTION SYSTEM, EXCESS PRODUCE, MATERIALS USED WITH THESE PRODUCTS AND PRODUCT CONTAINERS WILL BE DISPOSED OF ACCORDING TO MANUFACTURER'S SPECIFICATIONS AND

NO CONCRETE TRUCK WASHING WILL BE ALLOWED TO WASH OUT OR DISCHARGE SURPLUS CONCRETE OR DRUM WASH WATER ONSITE.

FERTILIZERS/HERBICIDES

THESE PRODUCTS WILL BE APPLIED AT RATES THAT DO NOT EXCEED THE MANUFACTURER'S SPECIFICATIONS OR ABOVE THE GUIDELINES SET FORTH IN THE CROP ESTABLISHMENT OR IN THE GSWCC MANUAL FOR EROSION AND SEDIMENT CONTROL IN GEORGIA. ANY STORAGE OF THESE MATERIALS WILL BE UNDER ROOF IN SEALED

A MINIMUM OF ONE PORTABLE SANITARY UNIT WILL BE PROVIDED FOR EVERY TEN (10) WORKERS ON THE SITE. ALL SANITARY WASTE WILL BE COLLECTED FROM THE PORTABLE UNITS A MINIMUM OF ONE TIME PER WEEK BY A LICENSED PORTABLE FACILITY PROVIDER IN COMPLETE COMPLIANCE WITH LOCAL AND STATE REGULATIONS.

ALL SANITARY SEWER WASTE UNTIS WILL BE LOCATED IN ONE AREA WHERE THE LIKELIHOOD OF THE UNIT CONTRIBUTING TO STORM WATER DISCHARGE IS NEGLIGIBLE. ADDITIONAL CONTAINMENT BMP'S MUST BE IMPLEMENTED, SUCH AS GRAVEL BAGS OR SPECIALLY DESIGNED PLASTIC SKID CONTAINERS AROUND THE BASE TO PREVENT WASTES FROM CONTRIBUTING TO STORM WATER DISCHARGES. THE LOCATION OF SANITARY WASTE UNITS MUST BE IDENTIFIED ON THE EROSION CONTROL PLAN GRADING PHASE SHEET BY THE

SANITARY SEWER WILL BE PROVIDED BY MUNICIPAL AUTHORITY AT THE COMPLETION OF THE PROJECT.

ILL HAZARDOUS WASTE MATERIALS WILL BE DISPOSED OF IN THE MANNER SPECIFIED BY LOCAL STATE, AND/OR FEDERAL REGULATIONS AND BY THE MANUFACTURER OF SUCH PRODUCTS. THE JOB SITE SUPERINTENDENT WHO WILL ALSO BE RESPONSIBLE FOR SEEING THAT THESE PRACTICES ARE FOLLOWED, WILL INSTRUCT SITE PERSONNEL IN THESE PRACTICES. MATERIAL SAFETY DATA SHEETS FOR EACH SUBSTANCE WITH HAZARDEOUS PROPERTIES THAT IS USED ON THE JOB SITE WILL BE OBTAINED AND USED FOR THE PROPER MANAGEMENT OF POTENTIAL WASTES THAT MAY RESULT FROM THESE PRODUCTS. AN MSDS WILL BE POSTED IN THE IMMEDIATE AREA WHERE SUCH PRODUCT IS STORED AND/OR USED AND ANOTHER COPY OF EACH MSDS WILL BE MAINTAINED IN THE ESPCP FILE AT THE JOB SITE CONSTRUCTION TRAILER OFFICE. EACH EMPLOYEE WHO MUST HANDLE A SUBSTANCE WITH HAZARDOUS PROPERTIES WILL BE INSTRUCTED ON THE USE OF MSDS SHEETS AND THE SPECIFIC INFORMATION IN THE APPLICABLE MSDS FOR THE PRODUCT HE/SHE IS USING, PARTICULARLY REGARDING SPILL CONTROL TECHNIQUES.

BUILDING MATERIALS

NO BUILDING OR CONSTRUCTION MATERIALS WILL BE BURIED OR DISPOSED ON-SITE. ALL SUCH MATERIAL WILL BE DISPOSED OF IN PROPER WASTE DISPOSAL PROCEDURES.

THE CONTRACTOR WILL IMPLEMENT THE SPILL PREVENTION CONTROL AND COUNTERMEASURES LISTED WITHIN THIS ESPCP AND WILL TRAIN ALL PERSONNEL IN THE PROPER CLEANUP AND HANDLING OF SPILLED MATERIALS. NO SPILLED HAZARDOUS MATERIALS OR HAZARDOUS WASTE WILL BE ALLOWED TO COME IN CONTACT WITH STORMWATER DISCHARGES. IF SUCH CONTACT OCCURS, THE STORM-WATER DISCHARGE WILL BE CONTAINED ON SITE UNTIL APPROPRIATE MEASURES IN COMPLIANCE WITH STATE AND FEDERAL REGULATIONS ARE TAKEN TO DISPOSE OF SUCH CONTAMINATED STORMWATER, IT SHALL BE THE RESPONSIBILITY OF THE JOB SITE SUPERINTENDENT TO PROPERLY TRAIN ALL PERSONNEL IN THE USE OF THE SPILL PREVENTION CONTROL AND COUNTERMEASURES FOR ALL HAZARDOUS MATERIALS AND WASTE ON THE SITE.

DISTURBED AREA ± 0.99 ACRES (ONSITE)

FON MEDIA EROSION CDBG F SANJO 2025

CONSULTANT PROJECT # 200577-01-001 LEVEL II E&S CERT.#90012 EXP. DATE 12/19/2028

PLAN STATUS

/21/2025 | BID SET

DATE DESCRIPTION RWH DESIGN | DRAWN | CHKD

JOB No. 24-204(200577-01-001 11/14/202

24 HOUR CONTACT

CITY OF DACULA


BRITTNI NIX


BRITTNI.NIX@DACULAGA.GOV 770-963-7451

SHEET No.


SITE AREA

+ 1.79 ACRES

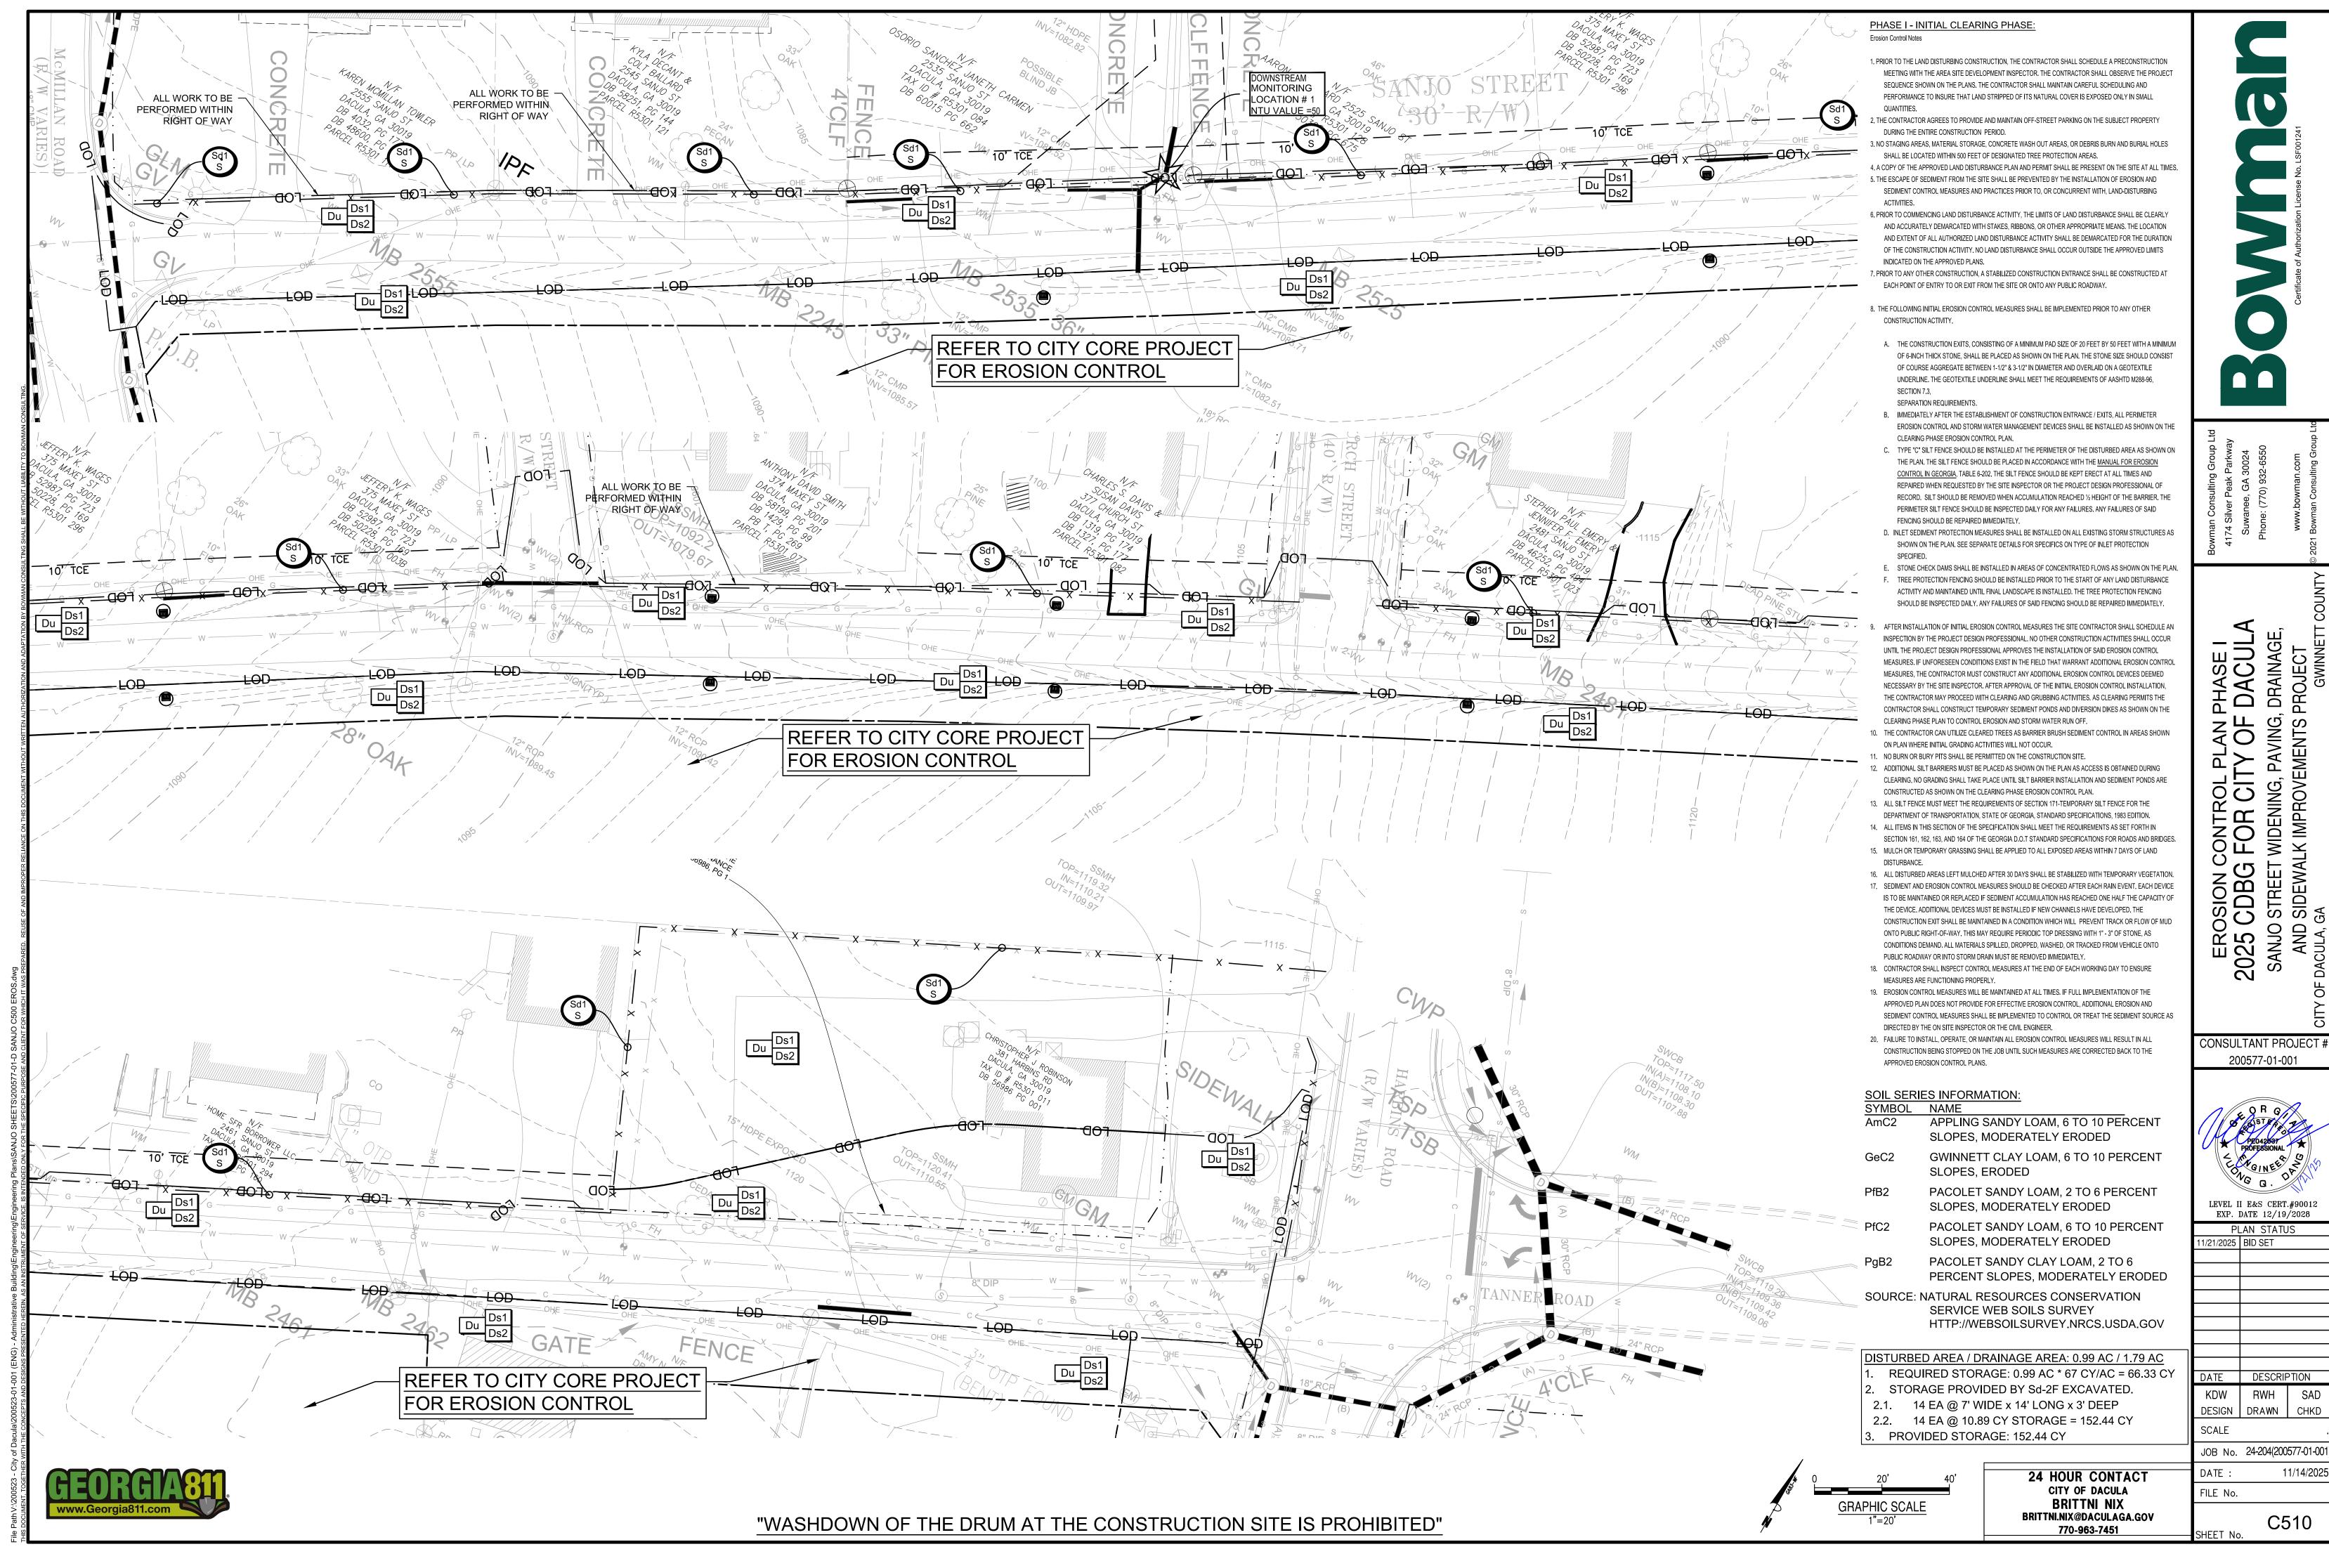

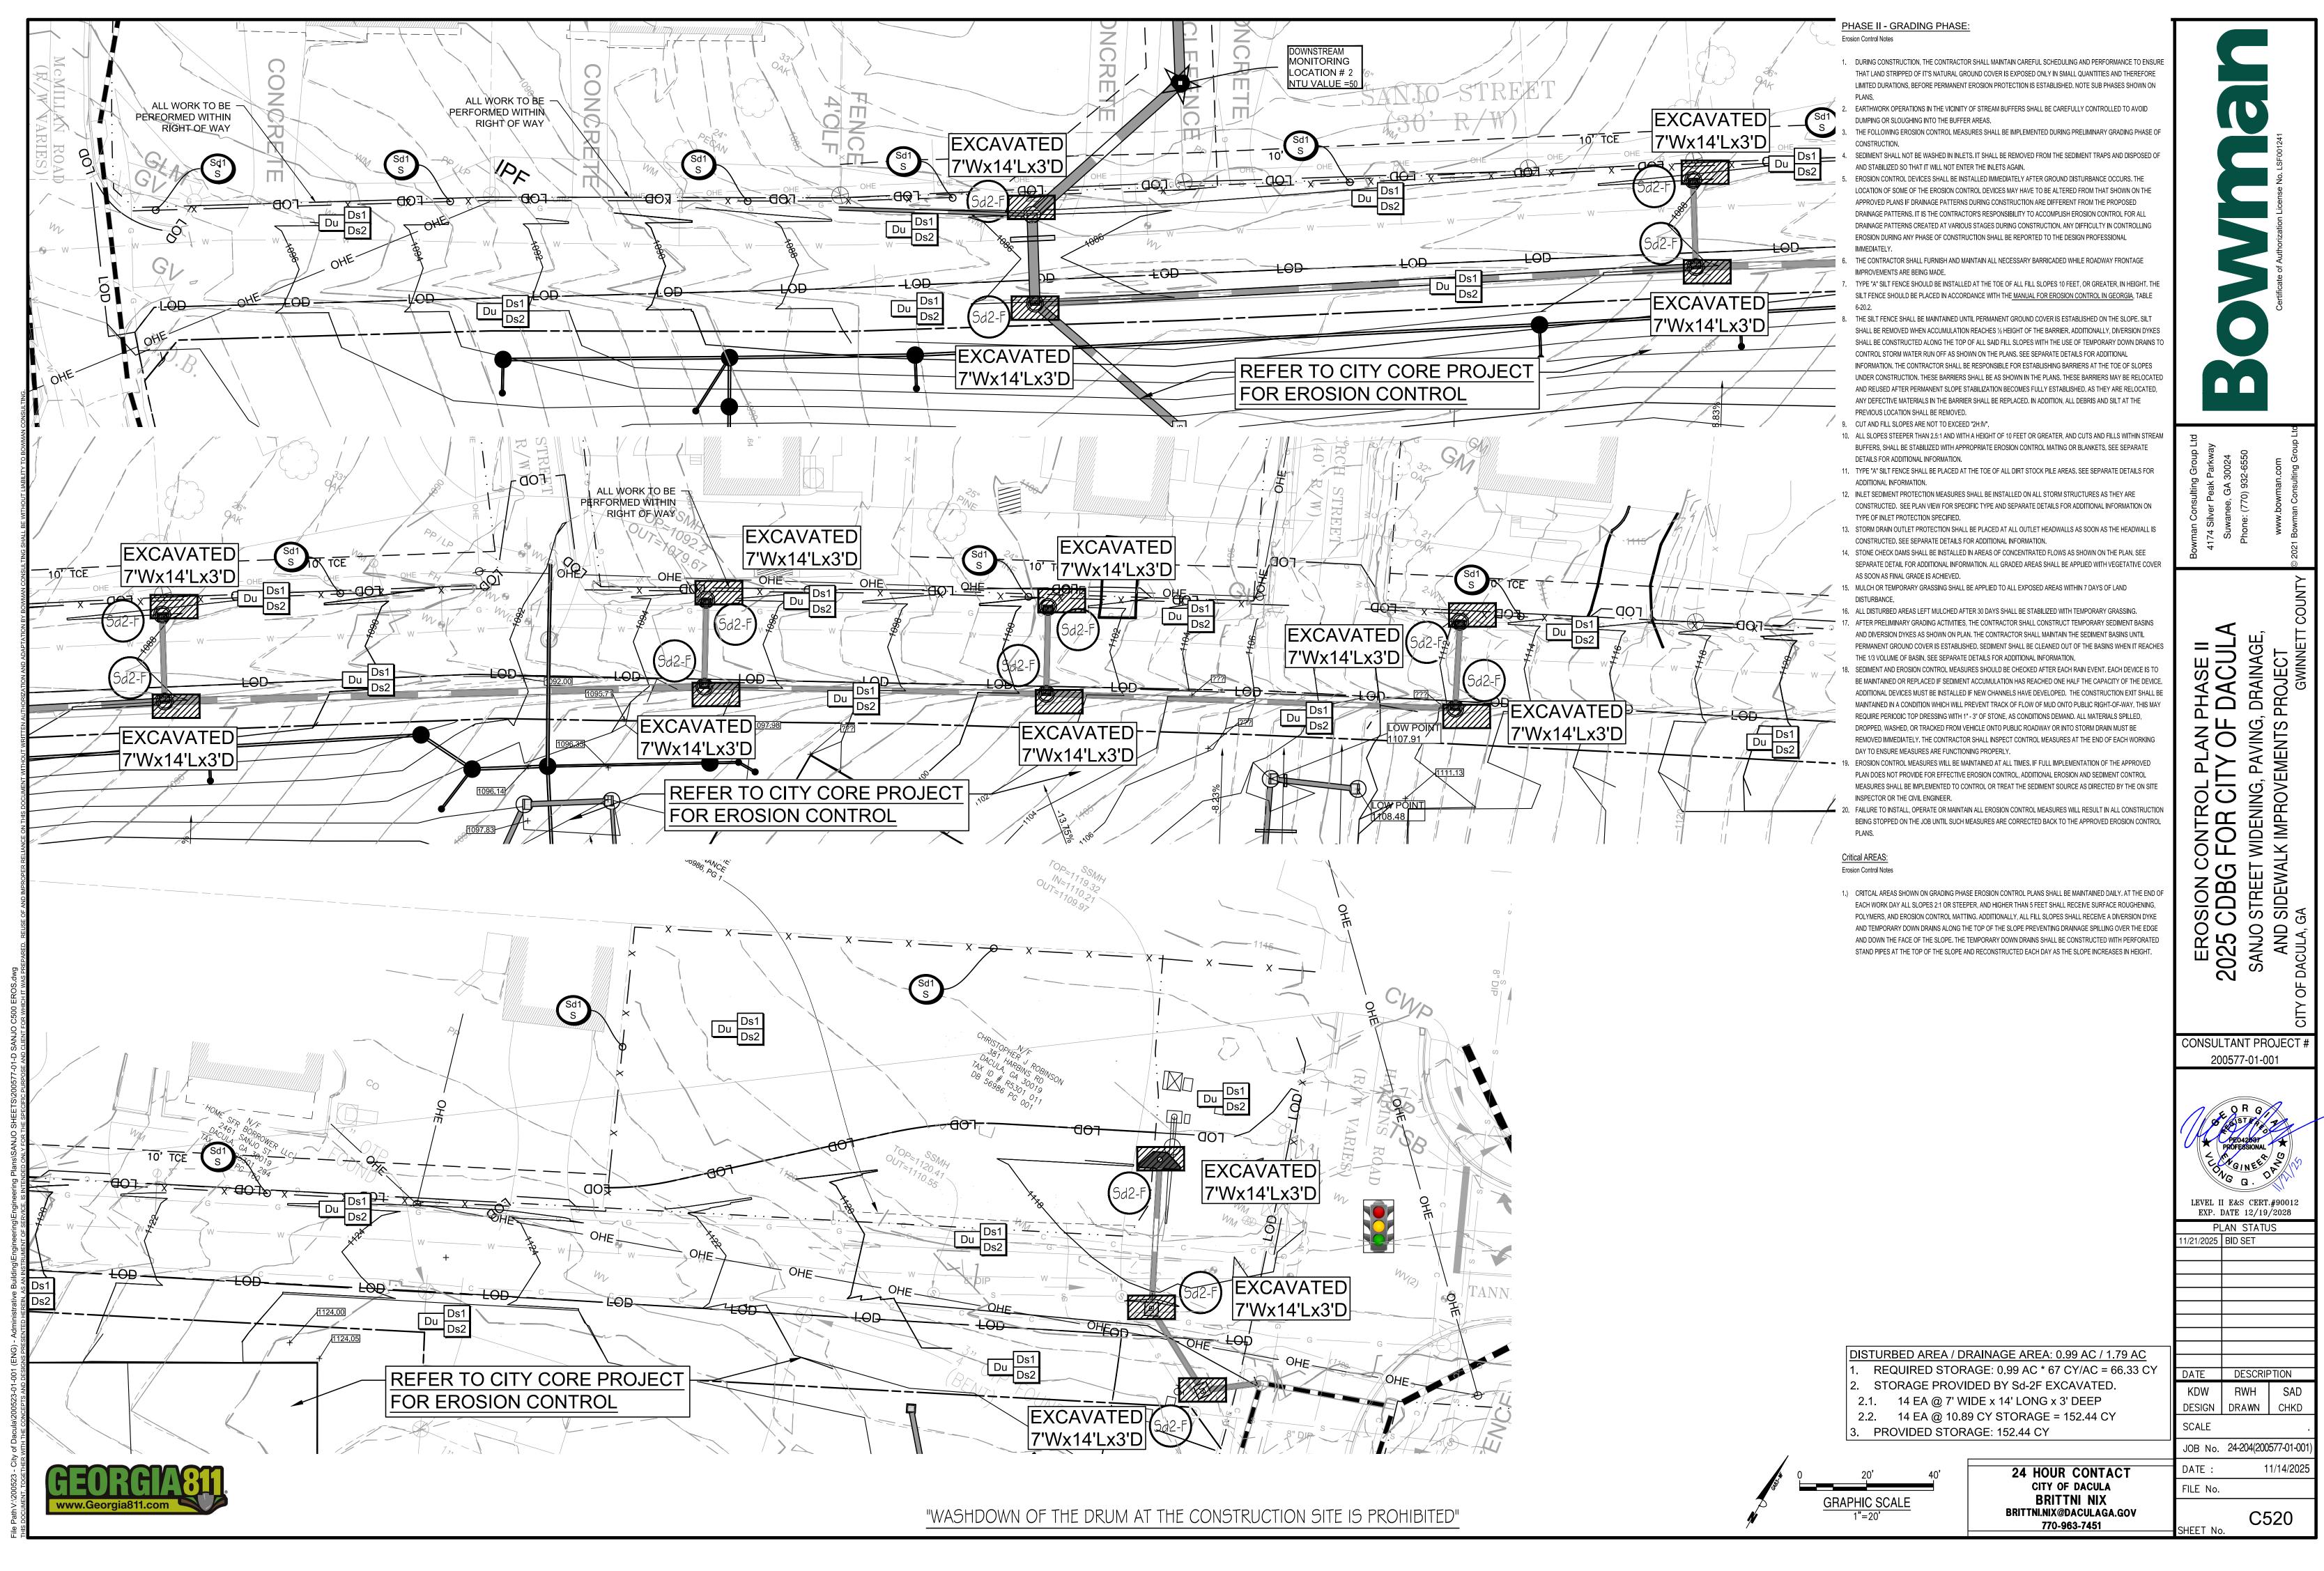

November 21, 2025

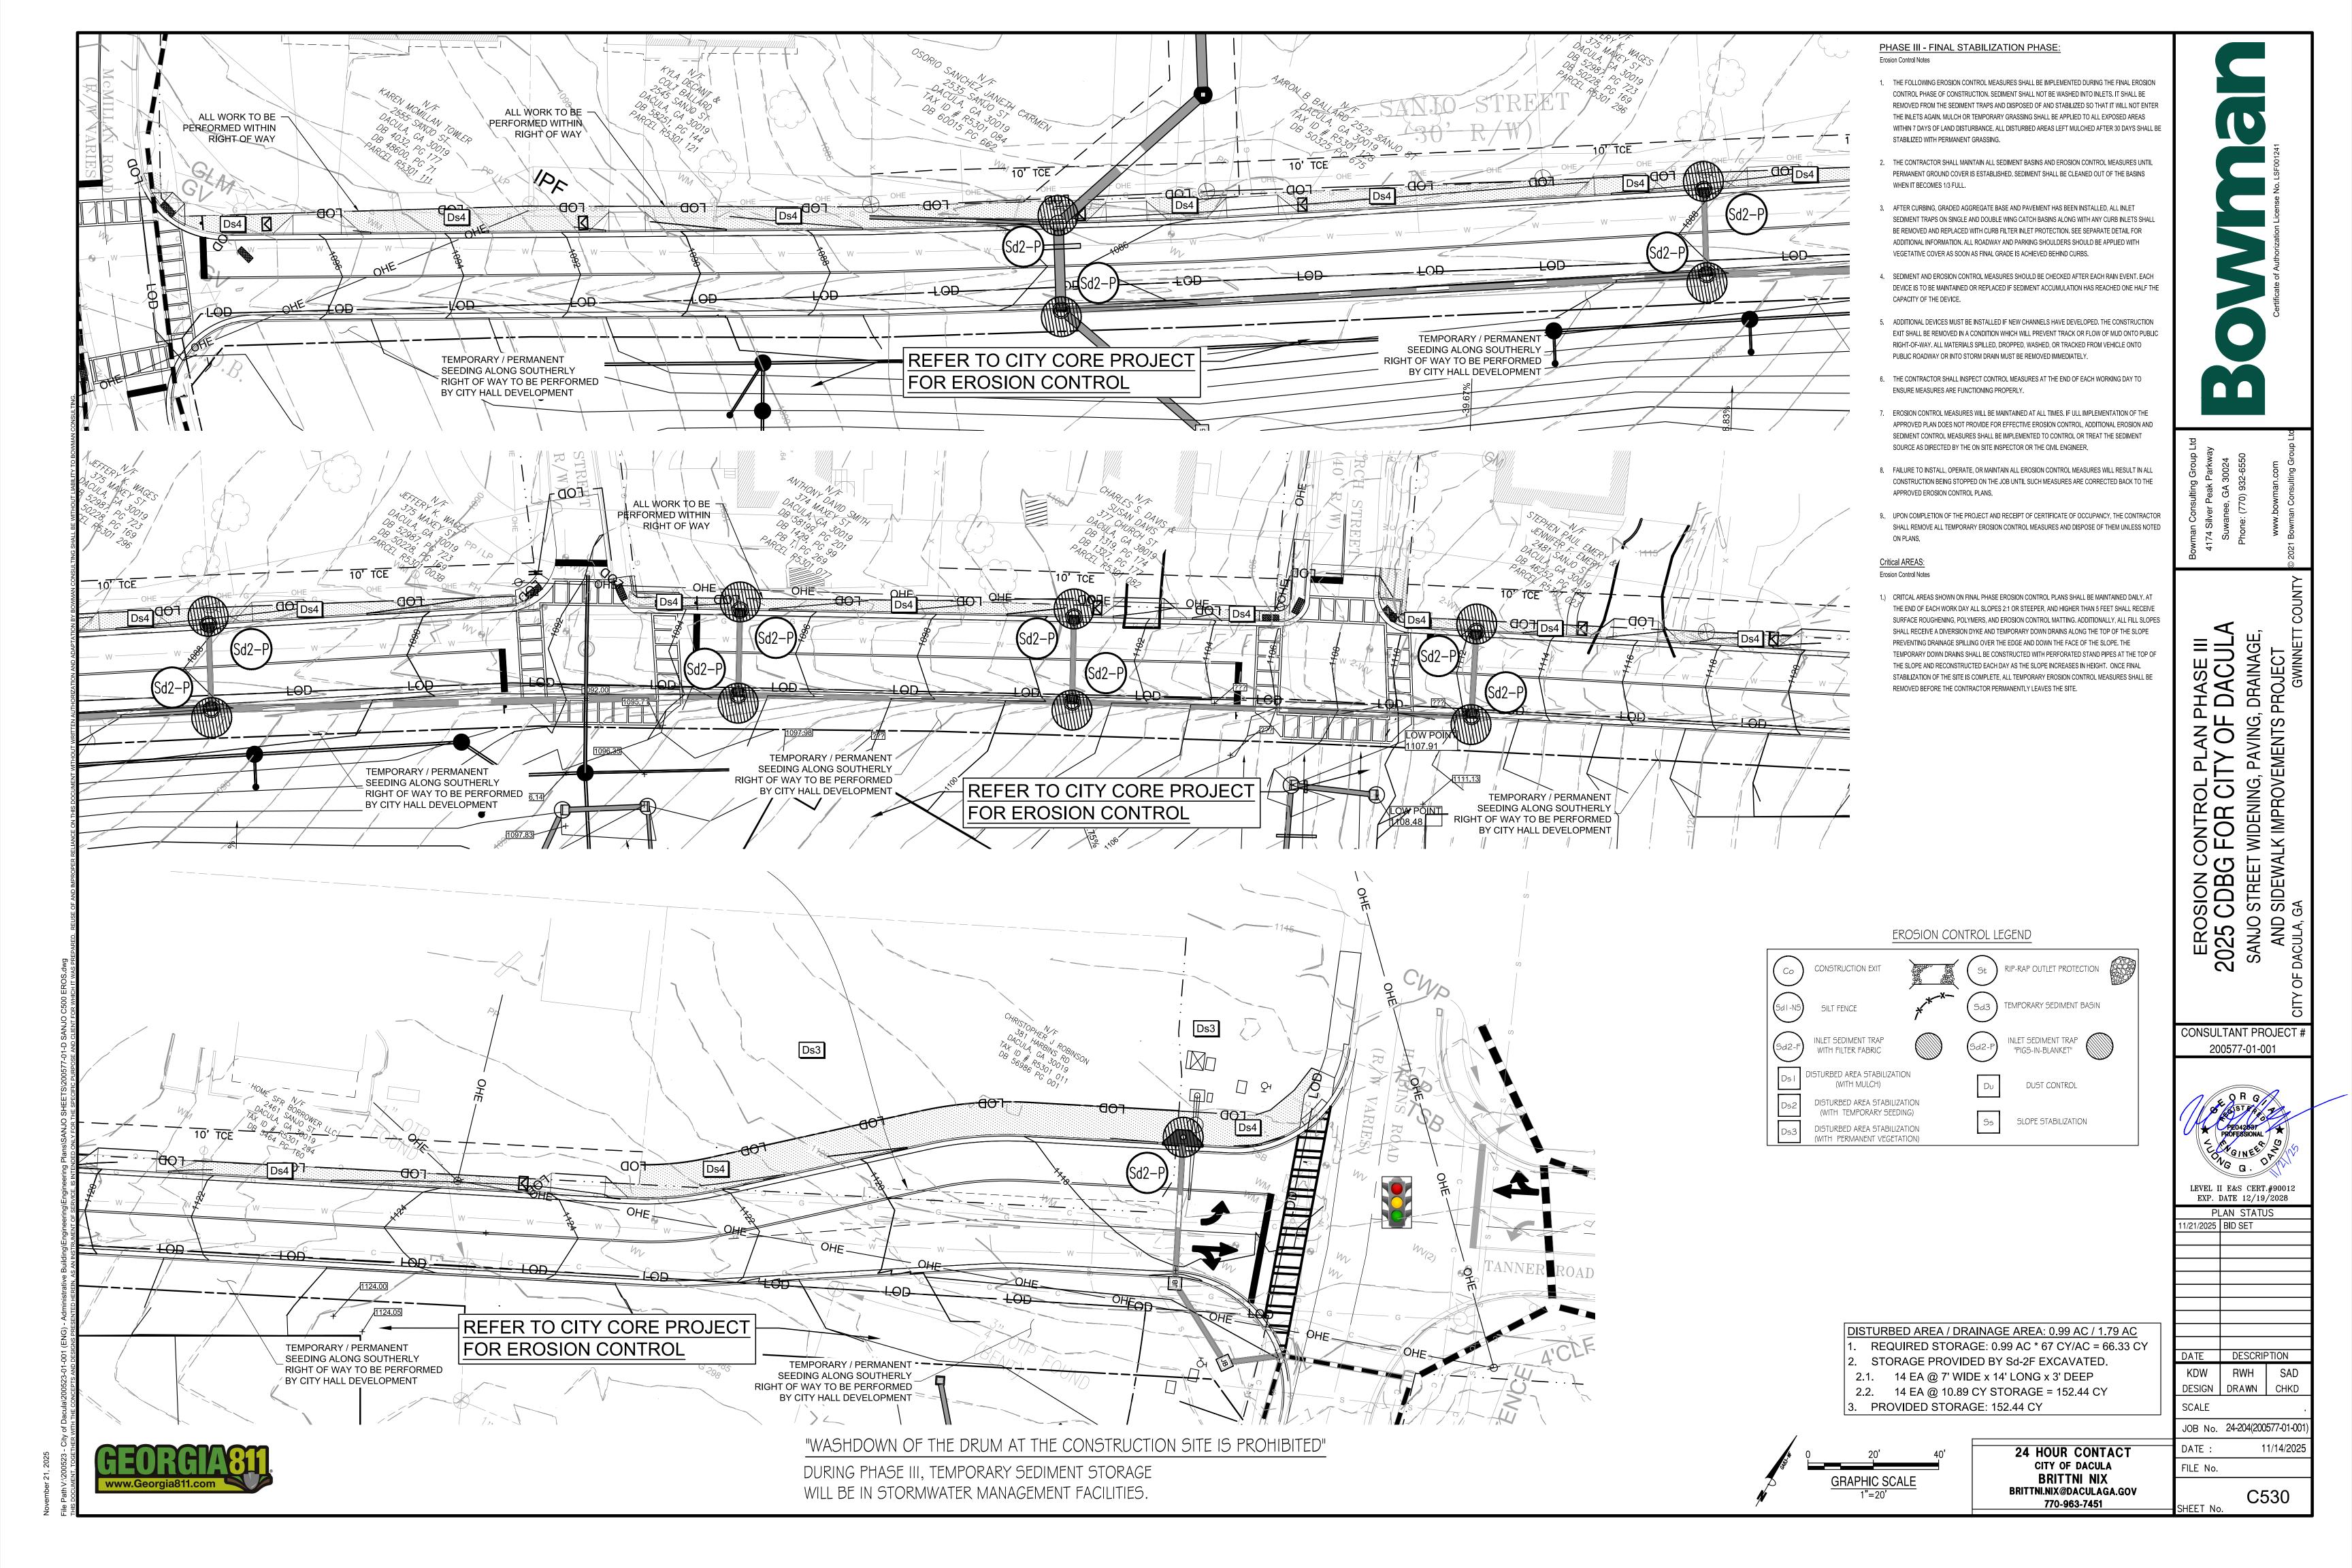

REQUIREMENT FOR REGULATORY COMPLIANCE

MULCH OR TEMPORARY GRASSING SHALL BE APPLIED TO ALL EXPOSED AREAS WITHIN 14 DAYS OF DISTURBANCE. MULCH CAN BE USED AS A SINGULAR EROSION CONTROL DEVICE FOR UP TO SIX MONTHS. BUT IT SHALL BE APPLIED ST THE APPROPRIATE DEPTH. DEPENDING ON THE MATERIAL USED, ANCHORED AND HAVE A CONTINUOUS 90% COVER OR GREATER OF THE SOIL. MAINTENANCE SHALL BE REQUIRED TO MAINTAIN APPROPRIATE DEPTH AND 90% COVE. TEMPORARY VEGETATION MAY BE EMPLOYED INSTEAD OF MUCH IF THE AREA WILL REMAIN UNDISTURBED FOR LESS THAN SIX MONTHS. IF ANY AREA WILL REMAIN UNDISTURBED FOR GREATER THAN SIX MONTHS, PERMANENT VEGETATIVE TECHNIQUES SHALL BE EMPLOYED. REFER TO D52 - DISTURBED AREA STABILIZATION (WITH TEMPORARY SEEDING), D53 - DISTURBED AREA STABILIZATION (WITH PERMANENT SEEDING). D54 - DISTURBED AREA STABILIZATION (WITH PERMANENT SODDING).

WULCHING WITHOUT SEEDING; THIS STANDARD APPLIES TO GRADED OR CLEARED AREAS WHERE SEEDINGS MAY NOT HAVE A SUITABLE GROWING SEASON TO PRODUCE AN EROSION RETARDANT COVER, BUT CAN BE STABILIZED WITH A MULCH COVER.

- GRADE TO PERMIT THE USE OF EQUIPMENT FOR APPLYING AND ANCHORING MULCH. . INSTALL NEEDED EROSION CONTROL MEASURES AS REQUIRED SUCH AS DIKES,
- DIVERSIONS, BERMS, TERRACES AND SEDIMENT BARRIERS. 3. LOOSEN COMPACT SOIL TO A MINIMUM DEPTH OF 3 INCHES.

SELEC ONE OF THE FOLLOWING MATERIALS AND APPLY AT THE DEPTH INDICATED: DRY STRAW OR HAY SHALL BE APPLIED AT A DEPTH OF 2 TO 4 INCHES PROVIDING

MULCHING CAN GREATLY REDUCE EROSION CONTROL COSTS.

APPLYING MULCH

ANCHORING MULCH

COVERAGE OF THE EXPOSED AREA.

OF THE ORGANIC MULCHES.

HAND OR BY MECHANICAL EQUIPMENT.

3. APPLY POLYETHYLENE FILM ON EXPOSED AREAS.

3. POLYETHYLENE FILM SHALL BE SECURED OVER BANKS OR STOCKPILED SOIL

WHEN MULCH IS USED WITHOUT SEEDING, MULCH SHALL BE APPLIED TO PROVIDE FULL

I. DRY STRAW OR MAY MULCH AND WOOD CHIPS SHALL BE APPLIED UNIFORMLY BY

2. IF THE AREA WILL EVENTIALLY BE COVERED WITH PERENNIAL VEGETATION, 20-30

I. STRAW OR HAY MULCH CAN BE PRESSED INTO THE SOIL WITH A DISK HARROW

POUNDS OF NITROGEN PER ACER IN ADDITION TO THE NORMAL AMOUNT SHALL BE

APPLIED TO OFFSET THE UPTAKE OF NITROGEN CAUSED BY THE DECOMPOSITION

WITH THE DISK SET STRAIGHT OR WITH A SPECIAL "PACKER DISK". DISKS MAY BE SMOOTH OR SERRATED AND SHOULD BE 20 INCHES OR MORE IN DIAMETER AND 8

COMPLETE SOIL COVER-AGE. ONE ADVANTAGE OF THIS MATERIAL IS EASY

2. WOOD WASTE (CHIPS, SAWDUST OR BARK) SHALL BE APPLIED AT A DEPTH OF 2 TO

3 INCHES. ORGANIC MATERIAL FROM THE CLEARING STAGE OF DEVELOPMENT

SHOULD REMAIN ON SITE, BE CHIPPED, AND APPLIED AS MULCH. THIS METHOD OF

MATERIAL FOR TEMPORARY PROTECTION. THIS MATERIAL CAN BE SALVAGED AND

1.1. STRAW OF HAY MULCH SPREAD WITH SPECIAL BLOWER-TYPE OF EQUIPMENT MAY BE ANCHORED. TACKIFIERS, BINERS AND HYDRAULIC MULCH WITH TACKIFIER SPECIFICALLY DESIGNED FOR TACKING STRAW CAN BE SUBSTITUTED FOR EMULSIFIED ASPHALT, PLEASE REFER TO SPECIFICATION TAC-RACKIFIERS. PLASTIC MESH OR NETTING WITH MESH NO LARGER THAN ONE INCH BY ONE INCH SHALL BE INSTALLED ACCORDING TO THE MANUFACTURER'S SPECIFICATIONS.

APPLICATION.

NETTING OF THE APPROPRIATE SIZE SHALL BE USED TO ANCHOR WOOD WASTE. OPENINGS OF THE NETTING SHALL NOT BE LARGER THAN THE AVERAGE SIZE OF THE

CUT THE MULCH BUT TO PRESS IT INTO THE SOIL LEAVING MUCH OF IT IN AN ERECT


POSITION. STRAW OR HAY MULCH SHALL BE ANCHORED IMMEDIATELY AFTER

WOOD WASTE CHIPS. 3. POLYETHYLENE FILM SHALL BE ANCHOR TRENCHED AT THE TOP AS WELL AS INCREMENTALLY AS NECESSARY

NALLICHINIC APPLICATION PEOLIDENAENTS

MULCHING APPLICATION REQUIREMENTS							
MATERIAL	RATE	DEPTH					
DRY STRAW OR HAY	2 1/2 TON/ACRE	2" TO 4"					
WOOD WASTE, CHIPS, SAWDUST, BARK	6 TO 9 TON/ACRE	2" TO 3"					
POLYETHYLENE FILM	SECURE WITH SOIL, ANCHORS, WEIGHTS						
GEOTEXTILES, JUTE MATTING, NETTING, ETC.	SEE MANUFACTURER'S RECOMMENDATIONS						

TO 12 INCHES APART. THE EDGES OF THE DISK SHALL BE DULL ENOUGH NOT TO DISTURBED AREA STABILIZATION (WITH MULCHING ONLY)

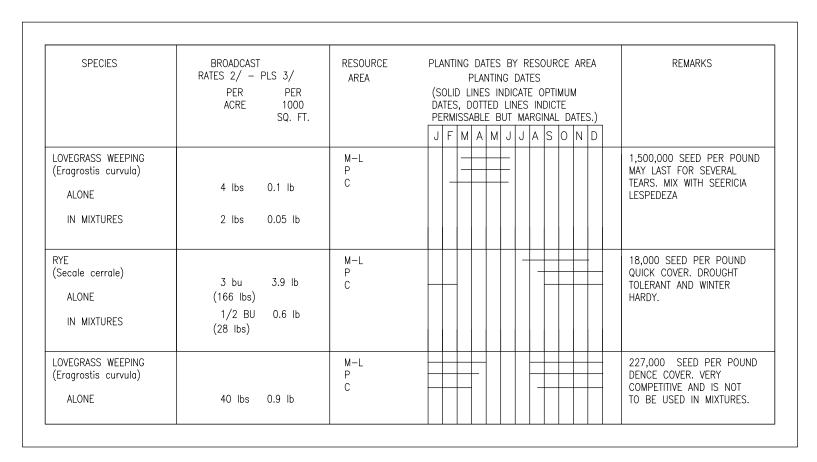

BROADCAST RESOURCE PLANTING DATES BY RESOURCE AREA RATES 2/ - PLS 3/ PLANTING DATES PER ACRE PER 1000 SQ. FT. (SOLID LINES INDICATE OPTIMUM DATES, DOTTED LINES INDICTE PERMISSABLE BUT MARGINAL DATES.) J|F|M|A|M|J|J|A|S|O|N|D (Cynodon dactylon) HULLED SEÉD 4 lbs 0.1 lb WITH TEMPORARY PLANT WITH WINTER ANUALS PLANT WITH TALL FESCUE WITH OTHER 2 lbs 0.05 lb PERENNIALS BERMUDA SPRIGS (Cynodon dactylon) APPROX. 650 SPRIGS.A 40 CU.FT. 0.9 CU.FT. COASTAL COMMON BUSHEL CONTAINS 1.25 CU. OR APPROX. 800 SPRIGS SOD PLUGS 3' x 3' COASTAL COMMON TIFT 78 SOUTHERN COASTAL PLAIN ONLY FESCUE, TALL JSE ALONE ONLY ON BETTER SITE (Festuca arundinaccea) NOT FOR DROUGHTY SOILS. MIX W/ ALONE 50 lbs 1.1 lb CROWNVETCH.APPLY TOPDRESSING SPRING FOLLOWING FALL PLANTINGS WITH OTHER 30 lbs 0.7 lb NOT FOR HEAVY USE AREAS OR

DISTURBED AREA STABILIZATION

STORAGE

FUEL STORAGE AREA —

LINED WITH GEOTEXTILE

FABRIC AND #57 STONE

SPILL CLEANUP AND CONTROL PRACTICES LOCAL, STATE, AND MANUFACTURER'S RECOMMENDED METHODS FOR SPILL

CLEANUP WILL BE CLEARLY POSTED AND PROCEDURES WILL BE MADE AVAILABLE TO SITE PERSONNEL. MATERIAL AND EQUIPMENT NECESSARY FOR SPILL CLEANUP WILL BE KEPT IN THE MATERIAL STORAGE AREAS. TYPICAL MATERIALS AND EQUIPMENT INCLUDES, BUT IS NOT LIMITED TO, BROOMS, DUSTPANS, MOPS, RAGS, GLOVES, GOGGLES, CAT LITER, SAND, SAWDUST AND PROPERLY LABELED PLASTIC AND METAL WASTE CONTAINERS. -SPILL PREVENTION PRACTICES AND PROCEDURES WILL BE REVIEWED AFTER A


SPILL AND ADJUSTED AS NECESSARY TO PREVENT FUTURE SPILLS. -All SPILLS WILL BE CLEANED UP IMMEDIATELY UPON DISCOVERY. ALL SPILLS WILL BE REPORTED AS REQUIRED BY LOCAL, STATE AND FEDERAL REGULATIONS.

-FOR SPILLS THAT IMPACT SURFACE WATER (LEAVE A SHEEN ON SURFACE WATER). THE NATIONAL RESPONSE CENTER (NRC) WILL BE CONTACTED WITHIN 24 HOURS AT 1-800-426-2675. -FOR SPILLS OF AN UNKNOWN AMOUNT, THE NATIONAL CENTER (NRC) WILL BE CONTACTED WITHIN 24 HOURS AT 1-800-426-2675. -FOR SPILLS GREATER THAN 25 GALLONS AND NO SURFACE WATER IMPACTS, THE GEORGIA EPD WILL BE CONTACTED WITHIN 24 HOURS.

-FOR SPILLS LESS THAN 25 GALLONS AND NO SURFACE WATER IMPACTS. THE

SPILL WILL BE CLEANED UP AND LOCAL AGENCIES WILL BE CONTACTED AS THE CONTRACTOR SHALL NOTIFY THE LICENSED PROFESSIONAL WHO PREPARED THIS PLAN IF MORE THAN 1320 GALLONS OF PETROLEUM IS STORED ONSITE

(THIS INCLUDES CAPACITIES OF EQUIPMENT) OR IF ANY ONE PIECE OF EQUIPMENT HAS A CAPACITY GREATER THAN 660 GALLONS. THE CONTRACTOR WILL NEED A SPILL PREVENTION CONTAINMENT AND

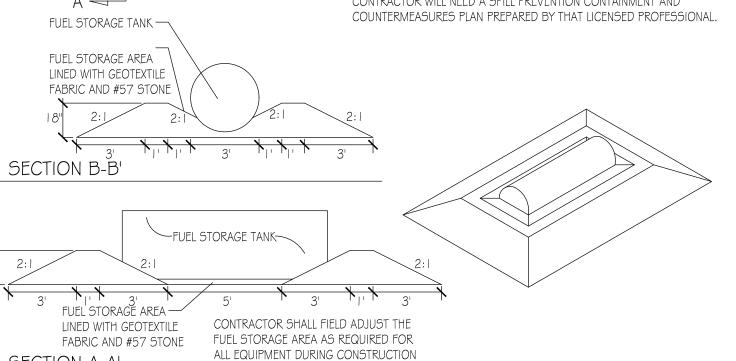

SPILL CLEANUP AND CONTROL PRACTICES

-LOCAL, STATE, AND MANUFACTURER'S RECOMMENDED METHODS FOR SPILL CLEANUP WILL BE CLEARLY POSTED AND PROCEDURES WILL BE MADE AVAILABLE TO SITE PERSONNEL

DISTURBED AREA STABILIZATION

(WITH PERMANENT VEGETATION)

-MATERIAL AND EQUIPMENT NECESSARY FOR SPILL CLEANUP WILL BE KEPT IN THE MATERIAL STORAGE AREAS. TYPICAL MATERIALS AND EQUIPMENT INCLUDES, BUT IS NOT LIMITED TO, BROOMS, DUSTPANS, MOPS, RAGS, GLOVES. GOGGLES, CAT LITER, SAND, SAWDUST AND PROPERLY LABELED PLASTIC AND METAL WASTE CONTAINERS. -SPILL PREVENTION PRACTICES AND PROCEDURES WILL BE REVIEWED AFTER A SPILL AND ADJUSTED AS NECESSARY TO PREVENT FUTURE SPILLS.

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-FOR SPILLS LESS THAN 25 GALLONS AND NO SURFACE WATER IMPACTS, THE SPILL WILL BE CLEANED UP AND LOCAL AGENCIES WILL BE CONTACTED AS REQUIRED.

THE CONTRACTOR SHALL NOTIFY THE LICENSED PROFESSIONAL WHO PREPARED THIS PLAN IF MORE THAN 1320 GALLONS OF PETROLEUM IS STORED ONSITE (THIS INCLUDES CAPACITIES OF EQUIPMENT) OR IF ANY ONE PIECE OF EQUIPMENT HAS A CAPACITY GREATER THAN 660 GALLONS. THE CONTRACTOR WILL NEED A SPILL PREVENTION CONTAINMENT AND COUNTERMEASURES PLAN PREPARED BY THAT LICENSED PROFESSIONAL.

EMERGENCY PROCEDURES FOR SPILL OF REPORTABLE QUANTITY OF PETROLEUM PRODUCTS

-ALL PETROLEUM PRODUCTS SHALL BE STORED AND USED IN AN AREA THAT PROVIDES A SECONDARY CONTAINMENT FEATURE, SECONDARY CONTAINMENT STRUCTURE SHALL CONSIST OF FLOOR, WALLS, AND JOINTS AND BE CONSTRUCTED ON A MATERIAL CAPABLE OF ADEQUATELY CONTAINING THOSE FUELS STORED WITHIN. CAPACITY OF THE SECONDARY CONTAINMENT SHALL BE SHALL HAVE A STORAGE VOLUME THAT IS A MINIMUM OF 110% OF THE TOTAL VOLUME CAPACITY OF THE LARGEST PRIMARY CONTAINER STORED WITHIN. RAIN WATER SHALL NOT BE ALLOWED TO COLLECT WITHIN THE SECONDARY CONTAINER AND ADEQUATE COVER SHALL BE PROVIDED TO PREVENT THE INGRESS OF RAIN WATER.

-EMERGENCY PROCEDURES FOR SPILLS SHALL BE KEPT IN THE CONSTRUCTION TRAILER INCLUDING EMERGENCY CONTACT NUMBERS. ANY LEAKS OR SPILLS SHALL BE THE RESPONSIBILITY OF THE CONTRACTOR TO CONTAIN, CONTROL, AND REMEDIATE WITH ALL LOCAL, STATE, AND FEDERAL GUIDELINES, ORDINANCES, AND LAWS.


- THE CONTRACTOR SHALL LOCATE STORAGE FACILITIES IN AREAS WITH THE LEAST FORESEEABLE IMPACT IF A CATASTROPHIC EVENT SHOULD OCCUR.

PAINT/CHEMICAL STORAGE, CLEANUP AND DISPOSAL:


- PAINT AND/OR OTHER CHEMICALS SHALL BE STORED IN SECURED FACILITIES WITH RESTRICTED ACCESS TO EMPLOYEES ONLY. CLEANUP AND DISPOSAL OF THIS MATERIAL SHALL BE ACCORDANCE WITH ALL RECOGNIZED LOCAL AND FEDERAL REQUIREMENTS. ALL DISPOSAL SHALL BE APPROVED OFF-SITE WASTE FACILITIES THAT ACCEPT

TYPICAL INSTALLATION GUIDELINES FOR ROLLED **EROSION CONTROL PRODUCTS (RECP)**

BLANKET AND MATTING CROSS-SECTIONS

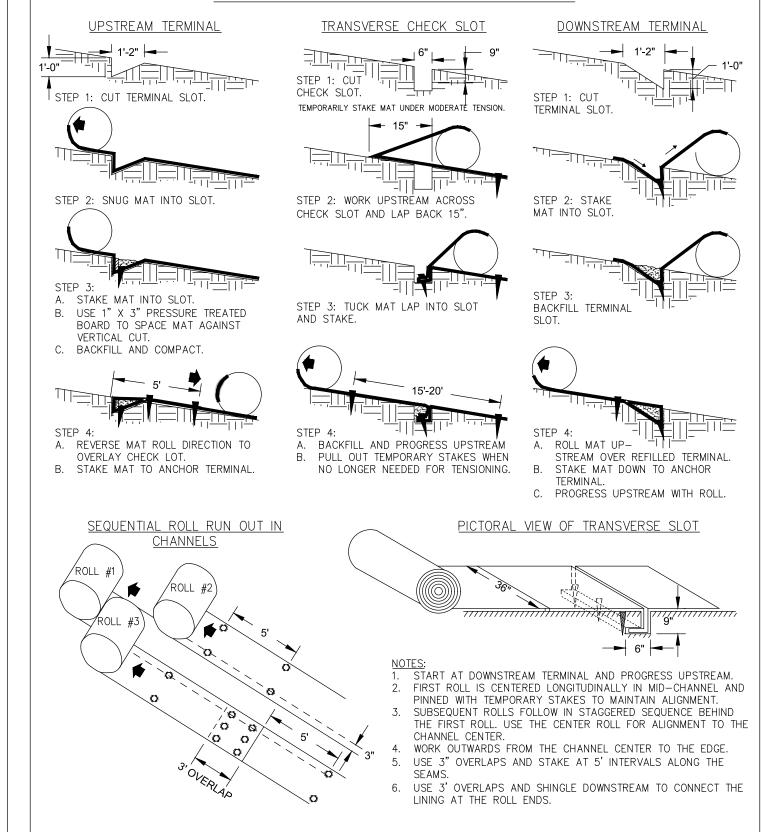

SLOPE STABILIZATION

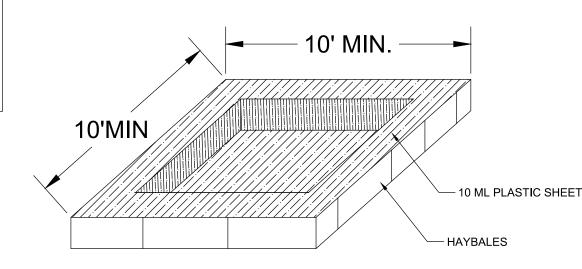

OPERATION


INSPECTION: CHECK ALL CONCRETE WASHDOWN FACILITIES DAILY TO DETERMINE IF THEY HAVE BEEN FILLED TO 75% CAPACITY. THE FACILITY NEEDS TO BE CLEANED OR CHANGED WHEN 75% FULL. INSPECT WASHOUTS DAILY TO ENSURE THAT PLASTIC LININGS ARE INTACT AND SIDEWALLS HAVE NOT BEEN DAMAGED BY CONSTRUCTION ACTIVITIES.

MATERIAL REMOVAL: IF THE WASHDOWN IS NEARING CAPACITY, VACUUM AND DISPOSE OF THE WASTE MATERIAL IN AN APPROVED MANNER. DO NOT DISCHARGE LIQUIDS TO WATERWAYS, STORM DRAINS OR DIRECTLY ONTO GROUND. DO NOT USE SANITARY SEWER WITHOUT LOCAL APPROVAL. REMOVE LIQUIDS OR COVER THE STRUCTURES BEFORE PREDICTED STORMS TO PREVENT OVERFLOWS. YOU CAN REMOVE HARDENED CONCRETE WHOLE OR YOU CAN BREAK IT UP FIRST, DEPENDING ON THE TYPE OF EQUIPMENT AVAILABLE AT YOUR SITE. HAUL IT AWAY FOR DISPOSAL OR RECYCLING. WHEN YOU REMOVE MATERIALS FROM THE CONCRETE WASHDOWN, INSPECT FOR SIGNS OF WEAKENING OR DAMAGE, AND REBUILD STRUCTURE OR MAKE NECESSARY REPAIRS. INSTALL A NEW PLASTIC LINER AFTER EVERY CLEANING.

CONCRETE WASHDOWN AREA DETAIL

N.T.S.

CONTRACTOR TO PROVIDE BMP'S FOR CONCRETE WASHDOWN OF TOOLS, CONCRETE MIXER CHUTES, HOPPERS AND THE REAR OF THE VEHICLES. WASHOUT OF THE DRUM AT THE CONSTRUCTION SITE IS PROHIBITED.

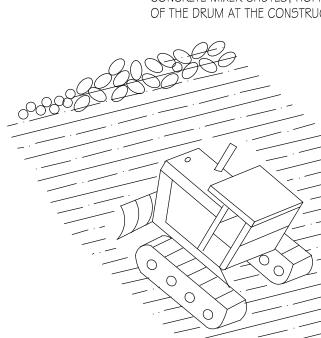

SURFACE ROUGHENING

A ROUGH SOIL SURFACE WITH HORIZONTAL DEPRESSIONS ON A CONTOUR OR SLOPES LEFT IN A ROUGHENED CONDITION AFTER GRADING.

PLAN STATUS /21/2025 BID SET

LEVEL II E&S CERT.#90012

EXP. DATE 12/19/2028

SSION CONT CDBG FOF STREET WIDE SIDEWALK IMF

CONSULTANT PROJECT #

200577-01-001

ER(2025

SANJO AND DACULA, C

DATE | DESCRIPTION RWH DESIGN | DRAWN | CHKD SCALE JOB No. 24-204(200577-01-001

11/14/2025


24 HOUR CONTACT CITY OF DACULA BRITTNI NIX BRITTNI.NIX@DACULAGA.GOV

770-963-7451


SECTION A-A'


FUEL STORAGE AREA

DISTURBED AREA STABILIZATION

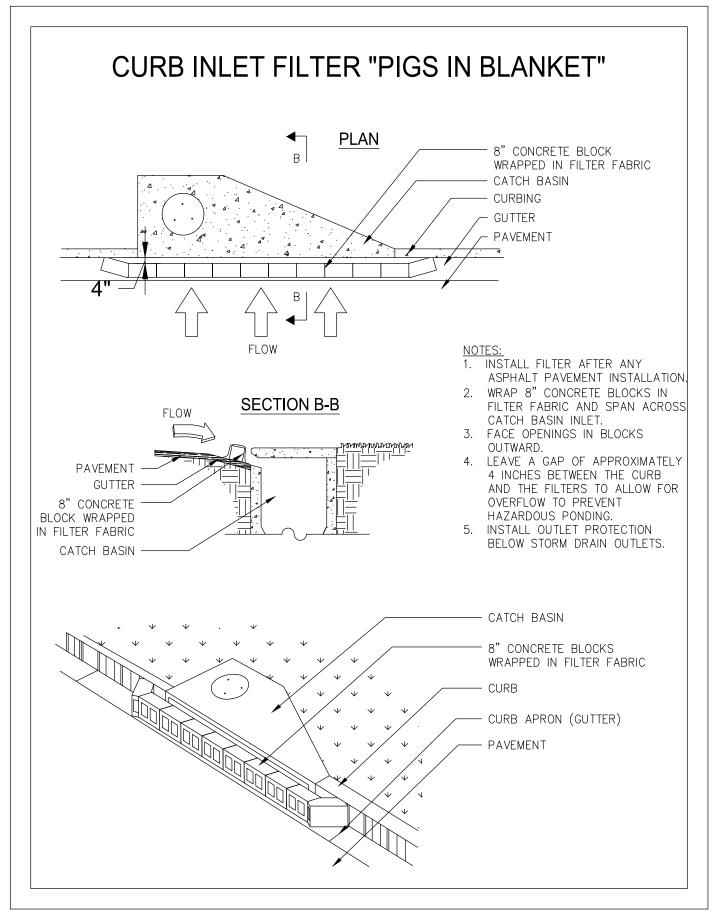

INLET SEDIMENT TRAP CURB INLET PROTECTION

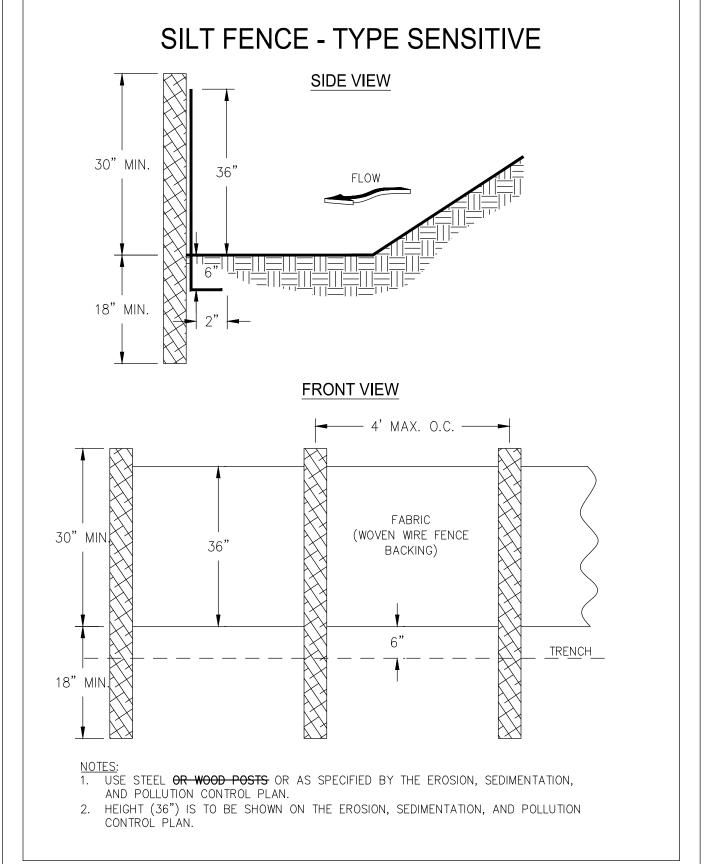

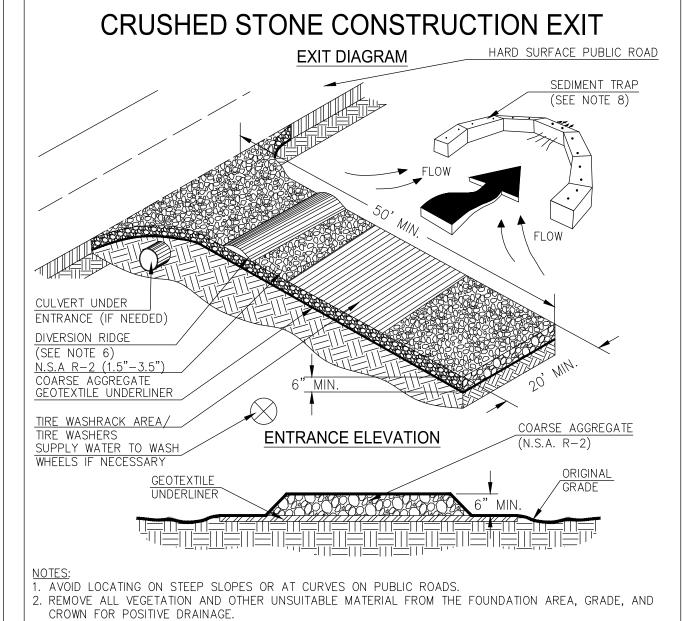

AGGREGATE SIZE SHALL BE IN ACCORDANCE WITH NATIONAL STONE ASSOCIATION R-2 (1.5"-3.5" STONE) 4. GRAVEL PAD SHALL HAVE A MINIMUM THICKNESS OF 6".


. PAD WIDTH SHALL BE EQUAL FULL WIDTH AT ALL POINTS OF VEHICULAR EGRESS, BUT NO LESS THAN 20' . A DIVERSION RIDGE SHOULD BE CONSTRUCTED WHEN GRADE TOWARD PAVED AREA IS GREATER THAN 2%. INSTALL PIPE UNDER THE ENTRANCE IF NEEDED TO MAINTAIN DRAINAGE DITCHES WHEN WASHING IS REQUIRED, IT SHOULD BE DONE ON AN AREA STABILIZED WITH CRUSHED STONE THAT DRAINS INTO AN APPROVED SEDIMENT TRAP OR SEDIMENT BASIN (DIVERT ALL SURFACE RUNOFF AND DRAINAGE FROM THE ENTRANCE TO A SEDIMENT CONTROL DEVICE

WASHRACKS AND/OR TIRE WASHERS MAY BE REQUIRED DEPENDING ON SCALE AND CIRCUMSTANCE. IF

- NECESSARY, WASHRACK DESIGN MAY CONSIST OF ANY MATERIAL SUITABLE FOR TRUCK TRAFFIC THAT
- O.MAINTAIN AREA IN A WAY THAT PREVENTS TRACKING AND/OR FLOW OF MUD ONTO PUBLIC

RIGHTS-OF-WAYS. THIS MAY REQUIRE TOP DRESSING, REPAIR AND/OR CLEANOUT OF ANY MEASURES USED TO TRAP SEDIMENT.

CONSTRUCTION EXIT

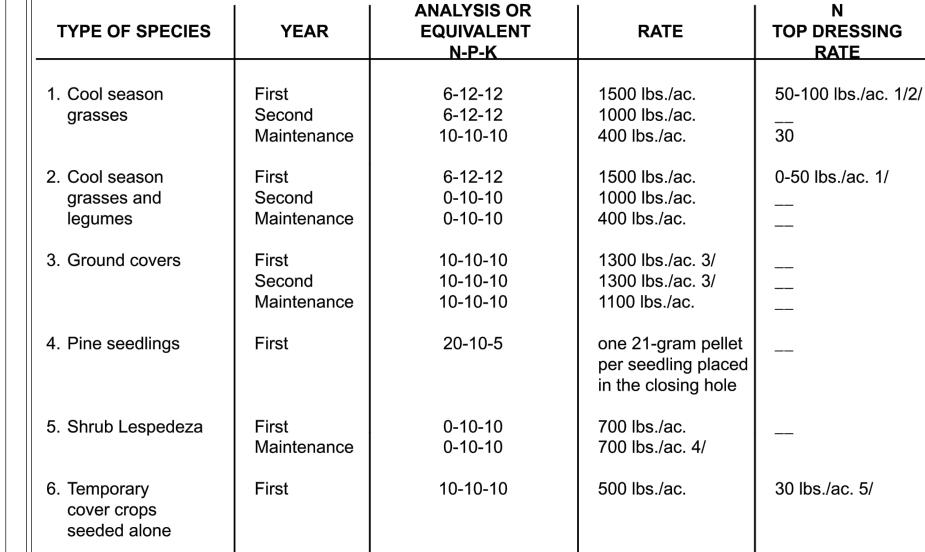

6-12-12

6-12-12

10-10-10

6-12-12

0-10-10

0-10-10

1500 lbs./ac.

800 lbs./ac.

400 lbs./ac.

1500 lbs./ac.

1000 lbs./ac.

400 lbs./ac.

50-100 lbs./ac. 2/6/

50-100 lbs./ac. 2/

30 lbs./ac.

50 lbs./ac./6/

Table 6-5.1. Fertilizer Requirements

1/ Apply in spring following seeding.

- 2/ Apply in split applications when high rates are used. 3/ Apply in 3 split applications.
- 4/ Apply when plants are pruned.

7. Warm season

8. Warm season

legumes

grasses and

grasses

- 5/ Apply to grass species only.
- 6/ Apply when plants grow to a height of 2 to 4 inches.

DRAINAGE AREA = 0.50 AC

EXCAVATED INLET SEDIMENT TRAP: "TYPICAL"

. DETERMINE REQUIRED SURFACE AREA

SAmin = $907.69 \, \text{CF} / 3 \, \text{FT}$

SAmin = 302.56 SF

SHAPE: RECTANGULAR

REQUIRED SEDIMENT STORAGE = 67 CY/AC * DRAINAGE AREAREQUIRED SEDIMENT STORAGE = 67 CY/AC * 0.50 AC

. ASSUME SLOPE OF SIDES (SHALL NOT BE STEEPER THAN 2:1) = 2:1

(A RECTANGULAR SHAPE WITH 2:1 LENGTH TO WIDTH RATIO IS RECOMMENDED.

AVAILABLE SEDIMENT STORAGE: 13 X 26 X 3 = 1,014 CF / 27 = 37.56 CY

DIMENSIONS: L=13 FT W=26 FT DIAMETER (if applicable) = N/A FT

SAmin = REQUIRED SEDIMENT STORAGE / EXCAVATION DEPTH

ASSUME SHAPE OF EXCAVATION AND DETERMINE DIMENSIONS

REQUIRED SEDIMENT STORAGE = 3.62 CY = 907.69 CF

3. ASSUME EXCAVATION DEPTH (MINIMUM OF 1.5 FT) = 3 FT

First

First


Second

Second


Maintenance

Maintenance


FABRIC AND SUPPORTING FRAME FOR **INLET PROTECTION** STEEL FRAME AND SILT FENCE INSTALLATION 1. DESIGN IS FOR SLOPES NO GREATER THAN 5% → 3' MAX. — → (NOT DESIGNED FOR CONCENTRATED FLOWS). 2. THE STEEL POSTS SUPPORTING THE SILT FÉNCE MATERIAL SHOULD BE SPACED EVENLY AROUND THE PERIMETER OF THE INLET (MAXIMUM OF 3' 1.5' MAX. 3. THE STEEL POSTS SHOULD BE SECURELY DRIVEN AT LEAST 18" DEEP. 4. THE FABRIC SHOULD BE ENTRENCHED AT LEAST 12" AND THEN BACKFILLED WITH CRUSHED STONE OR COMPACTED SOIL. 18" MIN *FABRIC ENTRENCHED AT ---- BURIED FABRIC LEAST 12" AND BACKFILLED WITH CRUSHED STONE OR / DROP INLET WITH GRATE COMPACTED SOIL. 12" MIN. - CRUSHED STONE OR COMPACTED SOIL - WIRE-BACKING - GATHER EXCESS AT CORNERS - FABRIC WITH WIRE-BACKING SUPPORT

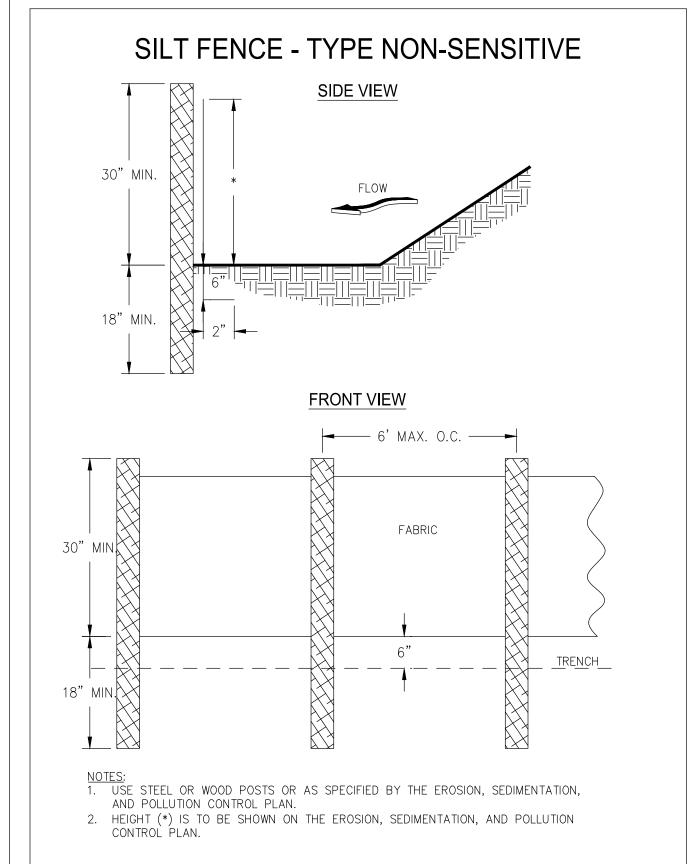


SILT FENCE TYPE SENSITIVE

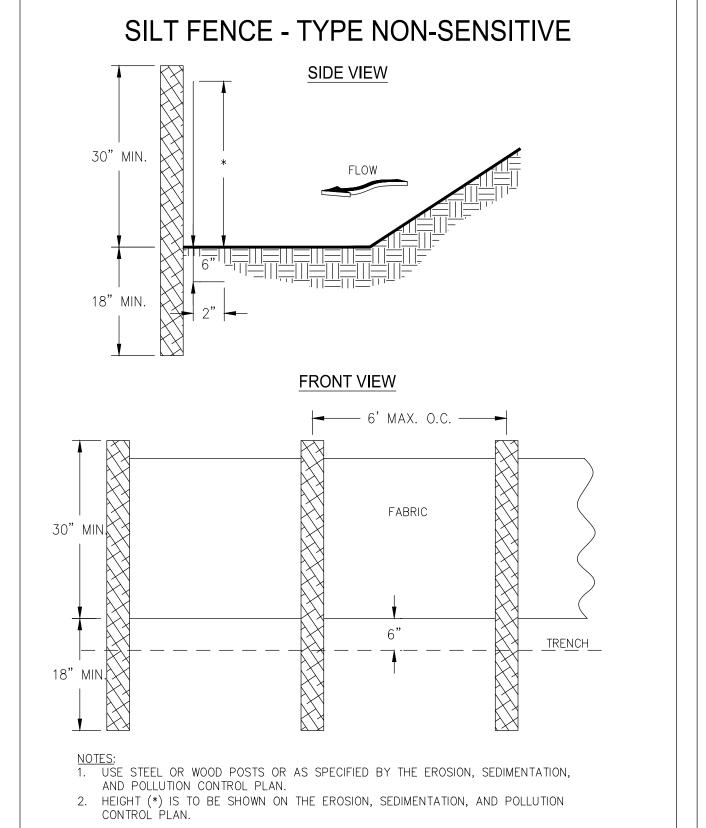




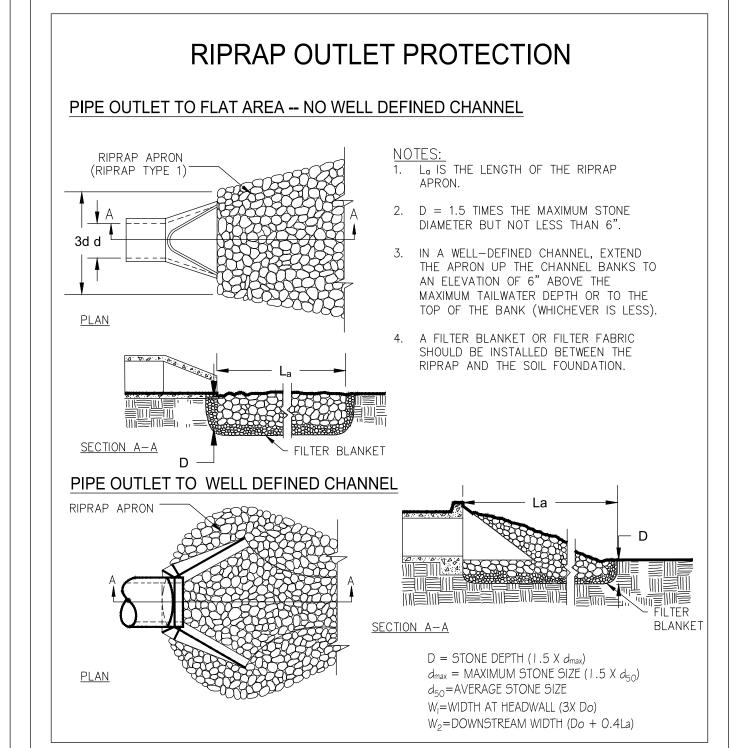

STORM DRAIN OUTLET PROTECTION

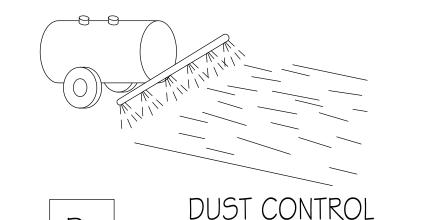

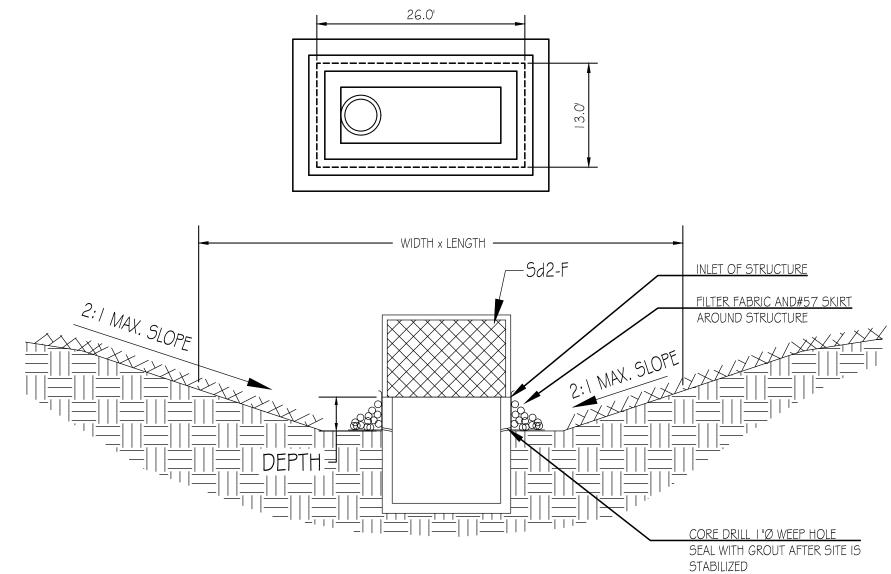

INLET SEDIMENT TRAP FILTER FABRIC EXCAVATED

24 HOUR CONTACT CITY OF DACULA **BRITTNI NIX** BRITTNI.NIX@DACULAGA.GOV 770-963-7451

DETAILS - DACUL

2025 CDBG FOR SANJO STREET WIDEN AND SIDEWALK IMPI

CONSULTANT PROJECT #

200577-01-001

LEVEL II E&S CERT.#90012

EXP. DATE 12/19/2028 PLAN STATUS

21/2025 BID SET


DATE DESCRIPTION RWH DESIGN | DRAWN | CHKD SCALE

JOB No. 24-204(200577-01-001 11/14/2025


FILE No.

C541 SHEET No.

 $^{\prime}$ SUPPORTING FRAME

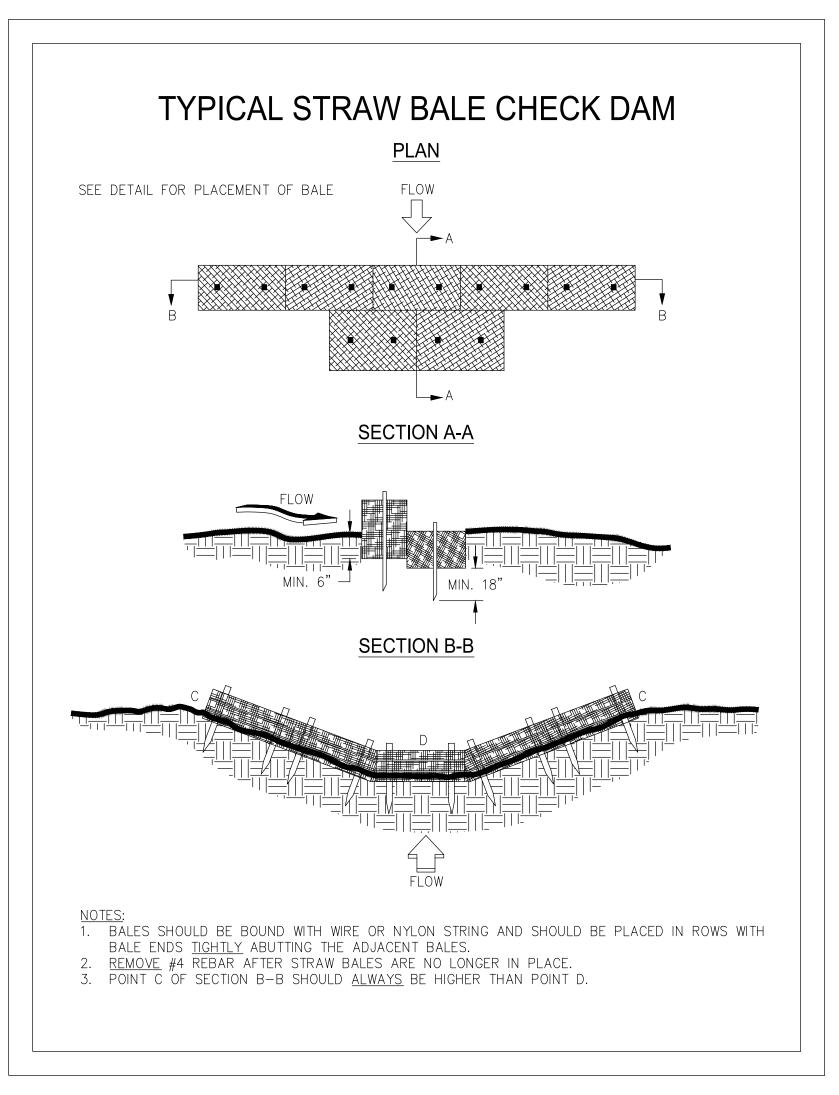

Cd-Hb CHECK DAM - STRAW BALES

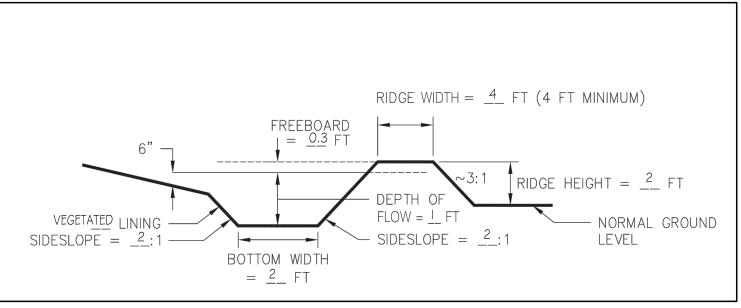

DIVERSION

GEORGIA811
www.Georgia811.com

Group Ltd
arkway
3024
-6550
com
Certificate of Authorization License No. LSF001241

4174 Silver Peak Parkway Suwanee, GA 30024 Phone: (770) 932-6550

EROSION CONTROL PLAN DETAILS
2025 CDBG FOR CITY OF DACULA
SANJO STREET WIDENING, PAVING, DRAINAGE,
AND SIDEWALK IMPROVEMENTS PROJECT
GWINNETT CO

CONSULTANT PROJECT #
200577-01-001



PLAN STATUS

1/21/2025 BID SET

DATE DESCRIPTION

KDW RWH SAD


DESIGN DRAWN CHKD

DATE: 11/14/2025

FILE No.

24 HOUR CONTACT
CITY OF DACULA
BRITTNI NIX
BRITTNI.NIX@DACULAGA.GOV
770-963-7451

C542

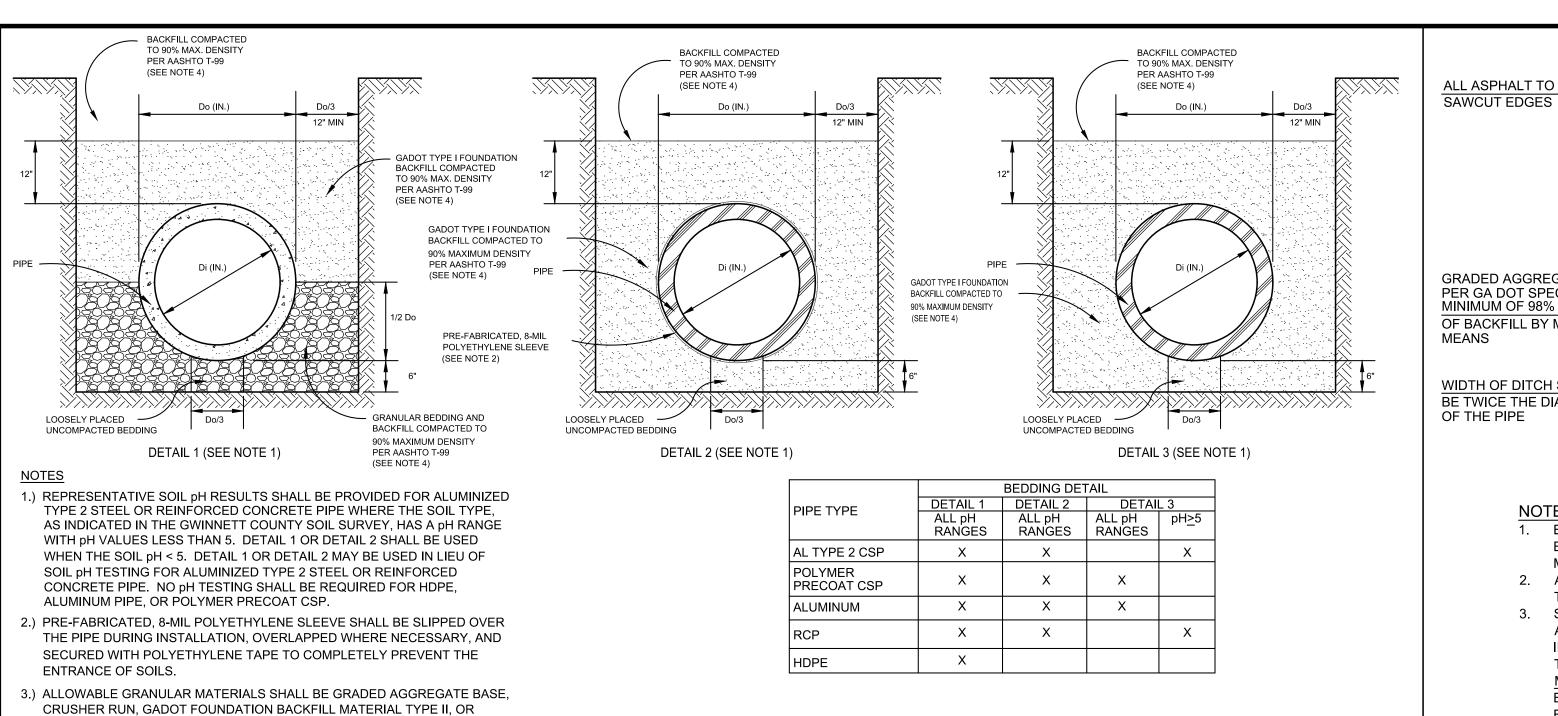

GRADED AGGREGATE BASE NOTCH EACH SIDE OF TRENCH 9" PER GA DOT SPECIFICATIONS TO RECEIVE 6-1/2" OF 4000 PSI CONCRETE BASE MINIMUM OF 98% COMPACTION OF BACKFILL BY MECHNICAL BACKFILL - TAMP IN 6 INCH MEANS LIFTS TO 95% DENSITY AT OPTIMUM MOISTURE WIDTH OF DITCH SHAL BE TWICE THE DIAMETER OF THE PIPE FILL DEPTH TO BE CRUSHER RUN OR GAB NO DIRT BACKFILL BEFORE ANY CONTRACTOR OR AGENCY CAN CUT A ROAD FOR ANY PURPOSE, AN ESCROW AGREEMENT BETWEEN THE COUNTY AND THAT CONTRACTOR OR AGENCY MUST BE SIGNED.

2. AN OPEN CUT PERMIT MUST BE OBTAINED BY THE CONTRACTOR OR AGENCY PRIOR TO THE START OF ANY DEMOLITION OR CONSTRUCTION.

GWINNETT COUNTY DEPARTMENT OF TRANSPORTATION

1-1/2" HOT MIX ASPHALT WEARING

POUR 6-1/2" THICK 4000 PSI

CONCRETE BASE COURSE

IMMEDIATELY AFTER BACKFILL

COURSE APPLIED 7 DAYS AFTER

BASE CONCRETE COURSE

UTILITY STREET CUT DETAIL


3. STREET CUTS MUST BE REPAIRED IN ACCORDANCE WITH THE SPECIFICATIONS ABOVE. THE BOND WILL BE RELEASED 30 DAYS AFTER COMPLETION AND INSPECTION OF THE CONSTRUCTION. THE CONSTRUCTION MUST OCCUR UNDER THE PROTECTION OF TRAFFIC CONTROL SIGNING REQUIREMENTS OUTLINED IN THE MANUAL ON TRAFFIC CONTROL DEVICES. THE TRANSPORTATION DEPARTMENT WILL BE NOTIFIED 48 HOURS PRIOR TO CONSTRUCTION. ANY CUT LEFT OVERNIGHT WILL

BE COVERED WITH STEEL PLATES SECURED TO THE PAVEMENT. 4. PERMIT HOLDER MUST CONTACT GWINNETT COUNTY ROAD MAINTENANCE AT 770-822-7414 FOR AN INSPECTION OF THE TRENCH PRIOR TO POURING THE CONCRETE BASE OR WILL FORFEIT YOUR BOND.

PAVEMENT PATCH FOR OPEN CUT

NTS

ALL ASPHALT TO HAVE

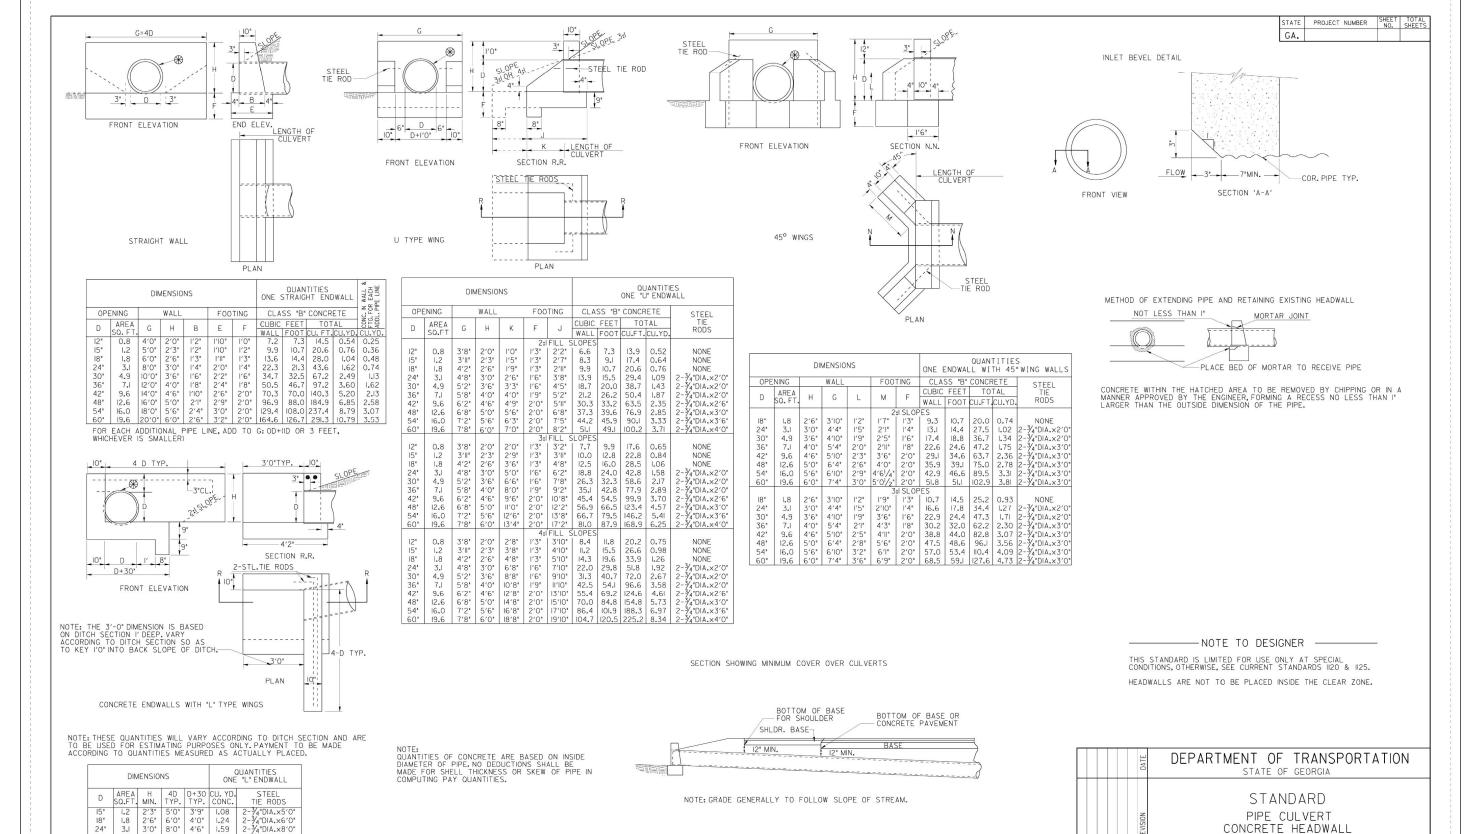

F PIPE HAS NEITHER A GROOVE NOR A SPIGOT AT ITS INLET, AN INLET BEVEL WILL BE REQ'D.



CONRETE HEADWALL

60" | 19.6 | 6'0" | 20'0" | 7'6" | 4.85 | 2-¾4"DIA.×20'0"


GADOT MECHANICALLY STABILIZED EMBANKMENT BACKFILL.


PIPE BEDDING

WITHIN STREET RIGHT-OF-WAY.

4.) BACKFILL SHALL BE COMPACTED TO 95% MAX DENSITY PER AASHTO T-99



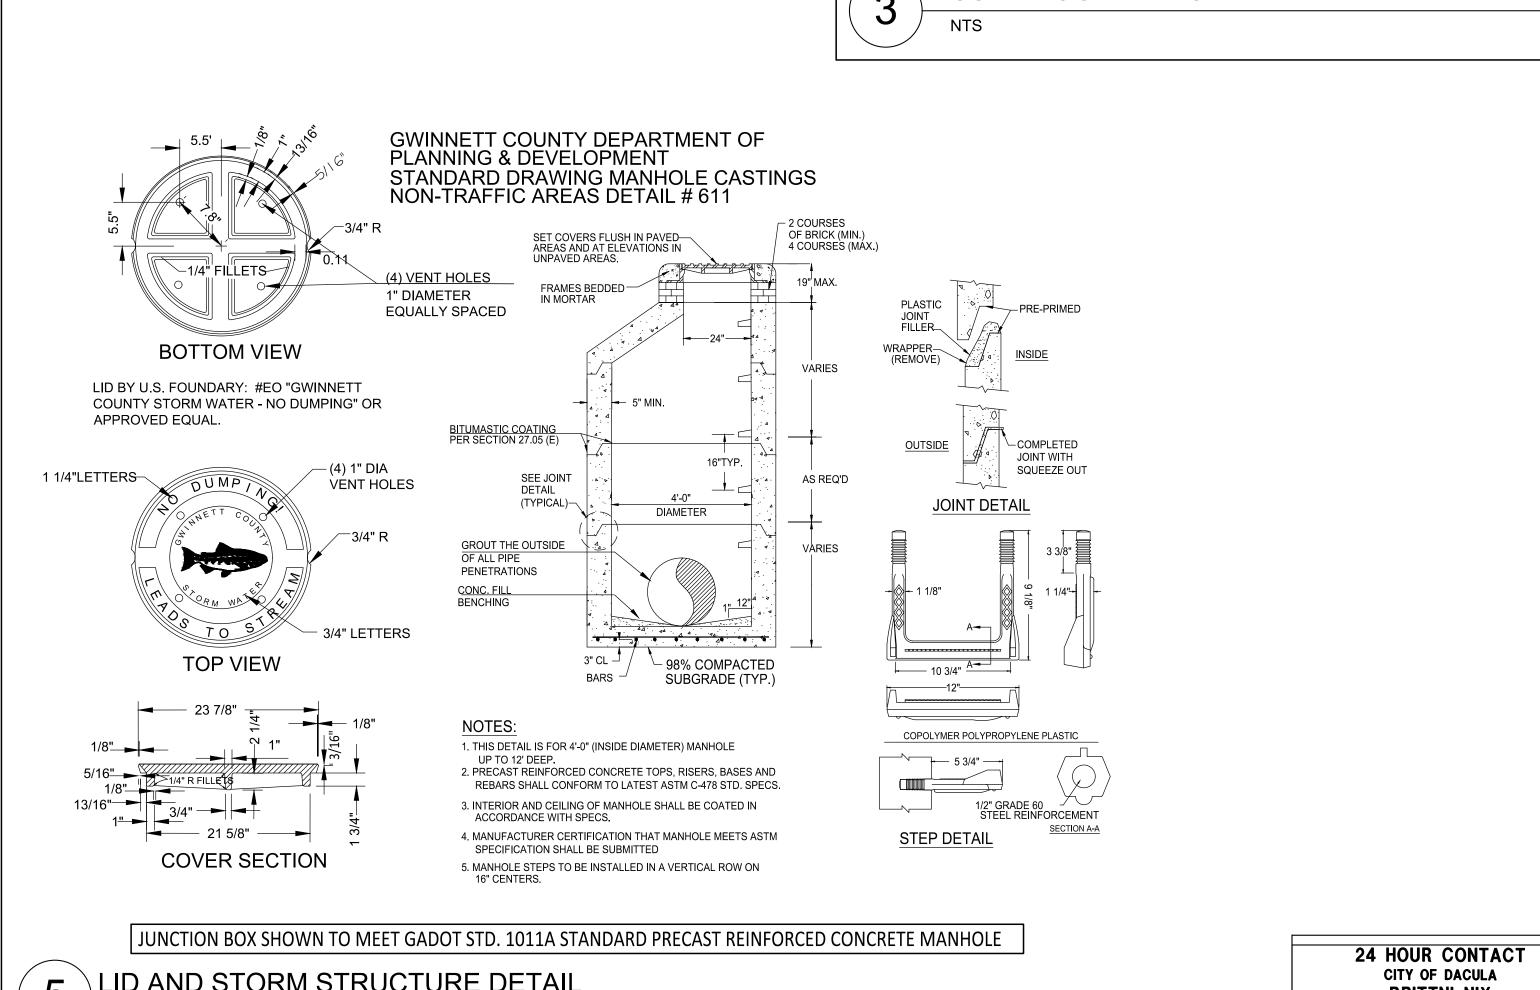

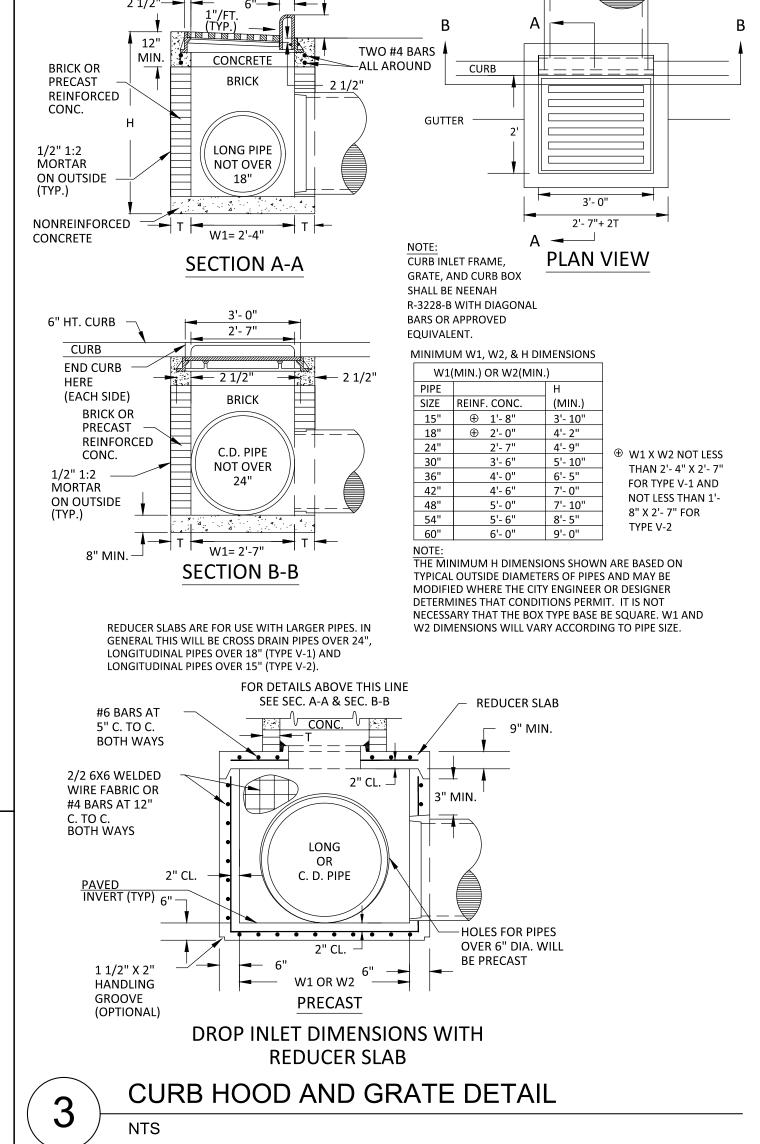

LID AND STORM STRUCTURE DETAIL

BRITTNI NIX BRITTNI.NIX@DACULAGA.GOV 770-963-7451

JOB No. 24-204(200577-01-001

SCALE

JAZ O

CONST

2025

CONSULTANT PROJECT #

200577-01-001

LEVEL II E&S CERT.#90012

EXP. DATE 12/19/2028

PLAN STATUS

DATE DESCRIPTION

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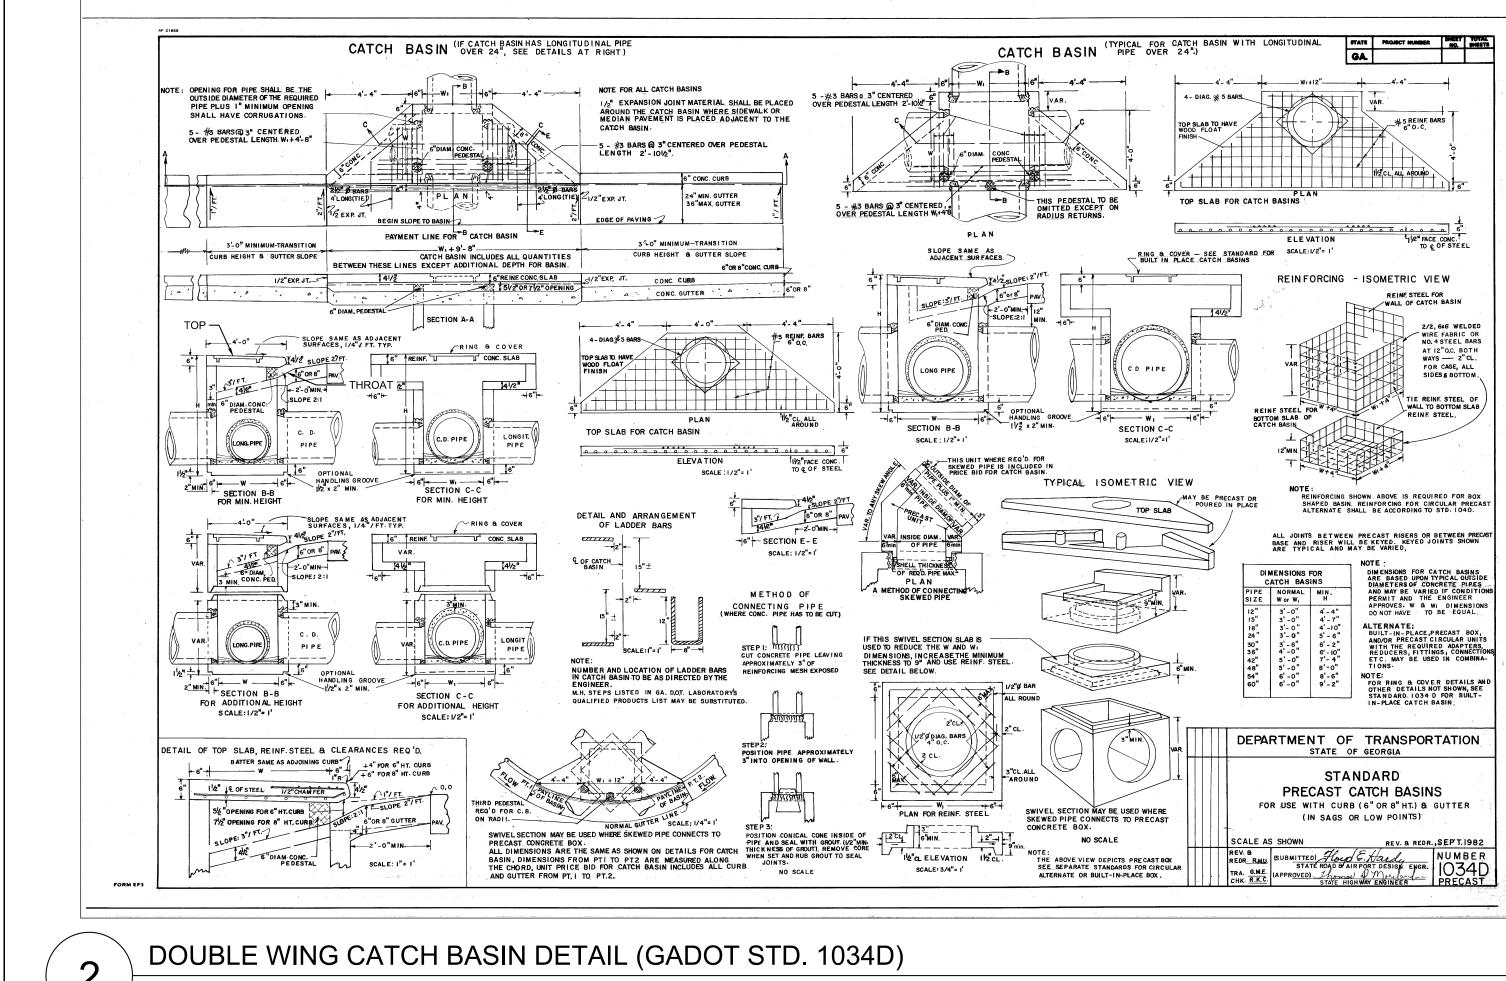
DESIGN | DRAWN | CHKD

11/14/202

/21/2025 | BID SET

STREET WIDE SIDEWALK IMF GA

SANJO AND



SEE STANDARD 1019-A- BRICK DROP INLETS- FOR DETAIL OF GRATING FRAME,HOOD,ETC., WHERE NEEDED.

SCALE: 3/4" =1

FOR OTHER DETAILS, SEE TYPE "B"

TYPE "C" (WITH OR WITHOUT WEIR)

21/2" --

→ 2¹/₂"

6" 2'-0" 6"

PLAN

SCALE: I" =I'

2" - 6" - 2'-0" - 6" -

6" 2'-0" 6"

PLAN

DIMENTIONS FOR DROP INLETS

DROP INLET (DI) GADOT STD. 1019A N.T.S.

24 HOUR CONTACT CITY OF DACULA **BRITTNI NIX BRITTNI.NIX@DACULAGA.GOV**

SHEET No.

770-963-7451

POSITION PIPE APPROXIMATELY 3"INTO OPENING OF WALL.

ALTERNATE METHOD OF CONNECTION SKEWED PIPE

SHELL THICKNESS OF REOD PIPE MAX.

ALTERNATE METHODS OF CONNECTING SKEWED PIPES MAY INCLUDE PIPE ELBOWS OR CIRCULAR PRECAST BASE UNITS. SEE SEPARATE STANDARDS.

DEPARTMENT OF TRANSPORTATION

PRECAST DROP INLETS

NOTE: REINFORCING STEEL SHALL BE NO. 4 STEEL BARS AT 12° O.C. BOTH WAYS OR EQUIVALENT WIRE FABRIC REINFORCING.

STEPS ARE REQUIRED IN ALL MANESLES OVER 4 F BELOW OR AS SHOWN GN ON STD. ICII-A (BRICK) PLASTIC MIN. VERTICAL LOAD RESISTANCE = 400 LBS.
MIN. PULLOUT RESISTANCE = 700 LBS. STEP DETAIL SEE GEN. NOTE NO. 2(A) NOTE: 10 FT. MAXIMUM ALLOWANCE COVER ABOVE TOP OF REDUCER SLABS. REDUCER CONES TO BE USED WHERE REDUCER SLABS NOT PERMITTED REINFORCEMENT REQ'D. OF NOT LESS THAN ONE LINE OF STEEL 0.17 SQ.IN. PER LINEAL FOOT. AND BASE UNIT IF NEEDED NOTE:
25 FT. MAXIMA ALLOWABLE
COVER ABOVE REDUCER CONE.

D X (MIN.) Z (MIN.)
60" 1'-6" 5"
72" (3'-0" 6" SECTIONAL DETAIL REDUCER SLAB *CONCENTRIC CONE SHOWN ... PRECAST HOLE FOR PIPE CONES MAY BE USED AS AN ALTERNATE, MIN.HT.=3'0" DESIGNED ACCORDING TO A.S.T.M. C-478 BASE UNIT SHALL CONTAIN IN ADDITION TO A.S.T.M. C-478 REINFORCEMENT, TWO NO. 5 VERTICAL BARS AT EACH OPENING EXTENDING FROM WITHIN 2" OF JOINT DOWN WALL INTO BOTTOM SLAB AS SHOWN MINIMEM 2" CLEARANCE ALL AROUND. SECTIONAL DETAIL (MANHOLE WITH BASE WHIT OF D=48") SECTIONAL DETAIL GENERAL NOTES: (MANHOLE WITH BASE UNIT OF D=OVER 48") INSIDE DIAMETER OF BASE UNIT DEPENDS UPON SIZE AND ALINEMENT OF PIPES. SEE GENERAL NOTES. RINGS AND JOINTS SHALL BE IN COMPLIANCE WITH A.S.T.M. C-478 UNLESS OTHERNISE NOTED.

(B) BASE UNITS, REDUCER SLABS AND FLAT TOP SLABS SHALL HAVE STEEL REINFORCEMENT AS SHOWN IN DETAILS AT LEFT...

(OPENINGS FOR PIPES LARGER THAN 6 INCHES IN DIAMETER ARE TO BE PRECAST. A MINIMUM OF 6° ALONG THE INTERCIRCUMPERENCE IS TO REMAIN BETWEEN THE EXTREMITIES OF HOLE FOR ADJACENT PIPE IN ANY SINGLE WITH. A MINIMUM OF THO REINF, BARS SHALL REMAIN IN WALL BETWEEN AN BASE UNIT OR RISER NO PART EXTENDS BEYOND INTERIOR SECTIONAL DETAIL 6" PIPES TO ENTER MANHOLE AND THE HEIGHT OF STRUCTURE. 5. BASE UNITS SHALL HAVE SUPFICIENT HEIGHT TO ALLOW FOR MINIMUM OF 6" OF WALL BETWEEN TOP HIGHEST OPENING FOR PIPES AND BOTTOM OF JOINT.

6. INVERT CHANNELS: SECTIONAL DETAIL (A) FOR SANITARY SCHER MANHOLES SEE GEORGIA STANDARD SPECIFICATIONS FOR CHANNEL REQUIRE PIPE PLACEMENT DETAIL PRECAST REINFORCED CONCRETE PLAN OF REINFORCING STEEL MANHOLE

FLAT TOP SLAB IS FOR USE IN AREA OF MINIMUM COVER ONLY. MAXIMUM HEIGHT OF MANHOLE WITH FLAT TOP SLAB SHALL BE 4.FT. ABOVE TOP OF HIGHEST ENTERING


FLAT TOP SLAB

JUNCTION BOX (JB) GADOT STD. 1011A




RLAN OF STEEL REINFORCEMENT IN BOTTOM SLAB

CONSTRUC CDBG FOF O STREET WIDEN D SIDEWALK IMP SANJO S AND S 2025 CONSULTANT PROJECT # 200577-01-001 LEVEL II E&S CERT.#90012 EXP. DATE 12/19/2028 PLAN STATUS /21/2025 BID SET DATE DESCRIPTION KDW DESIGN | DRAWN | CHKD SCALE JOB No. 24-204(200577-01-001 11/14/202

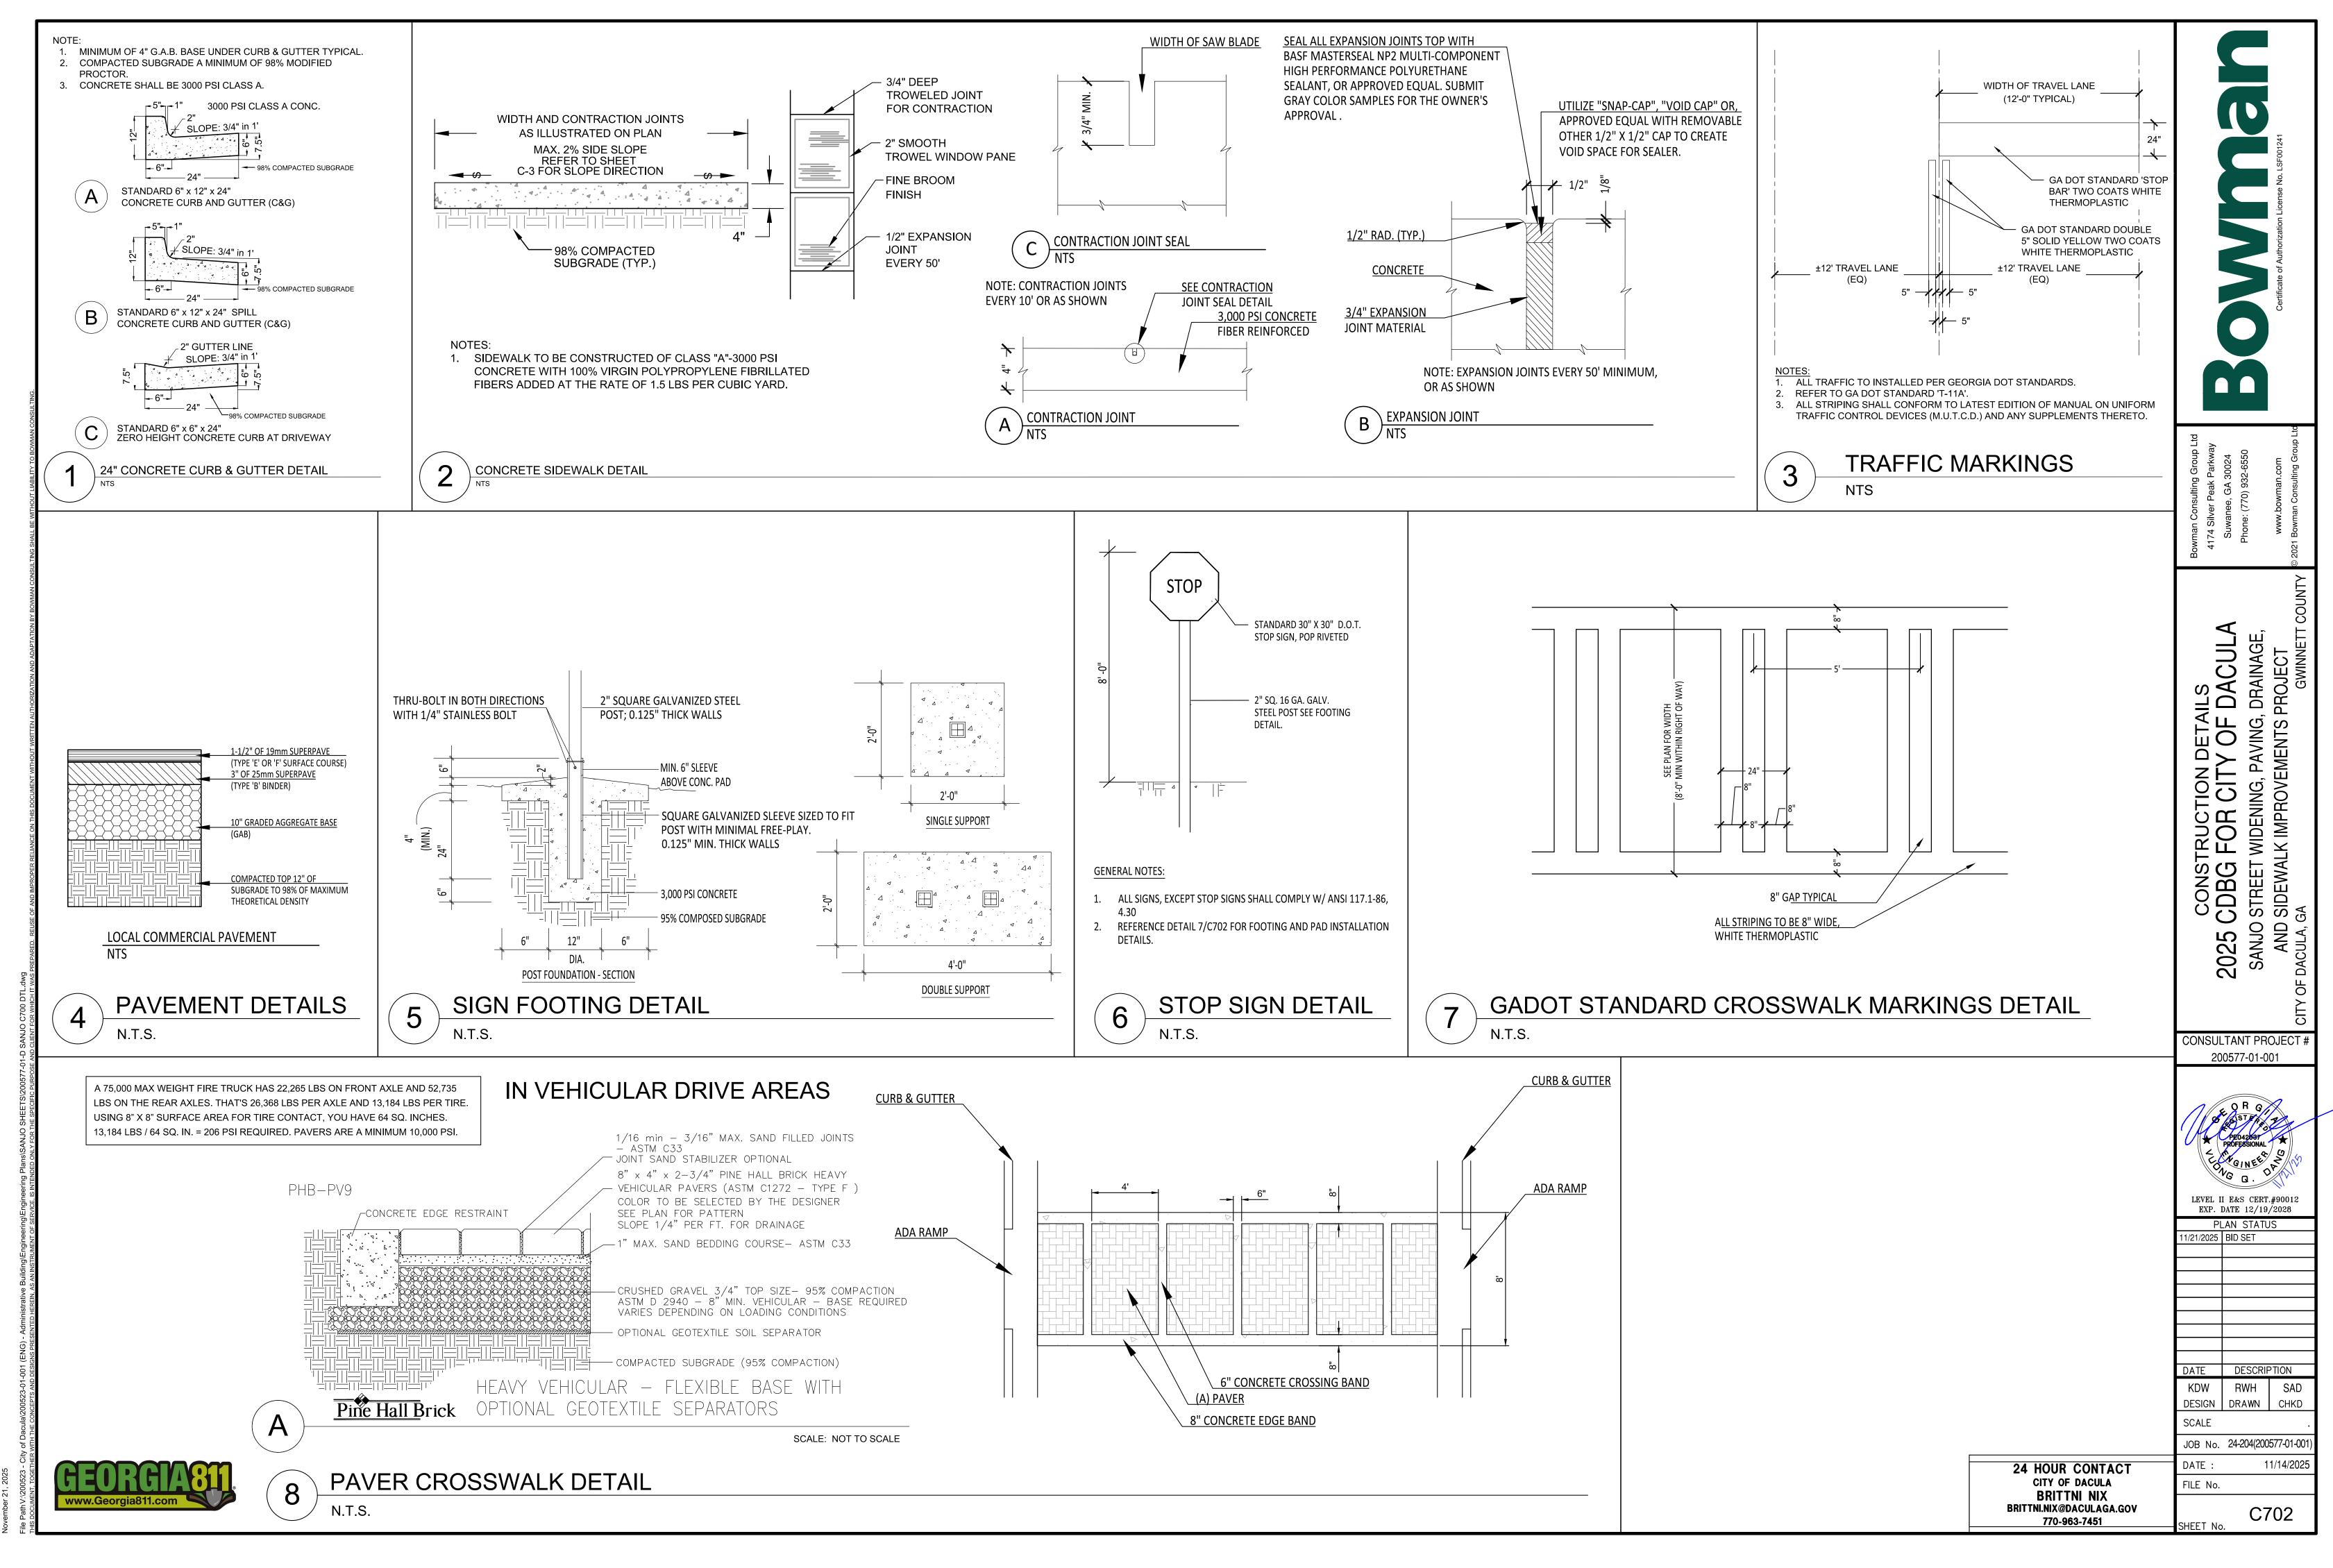

November 21, 2025

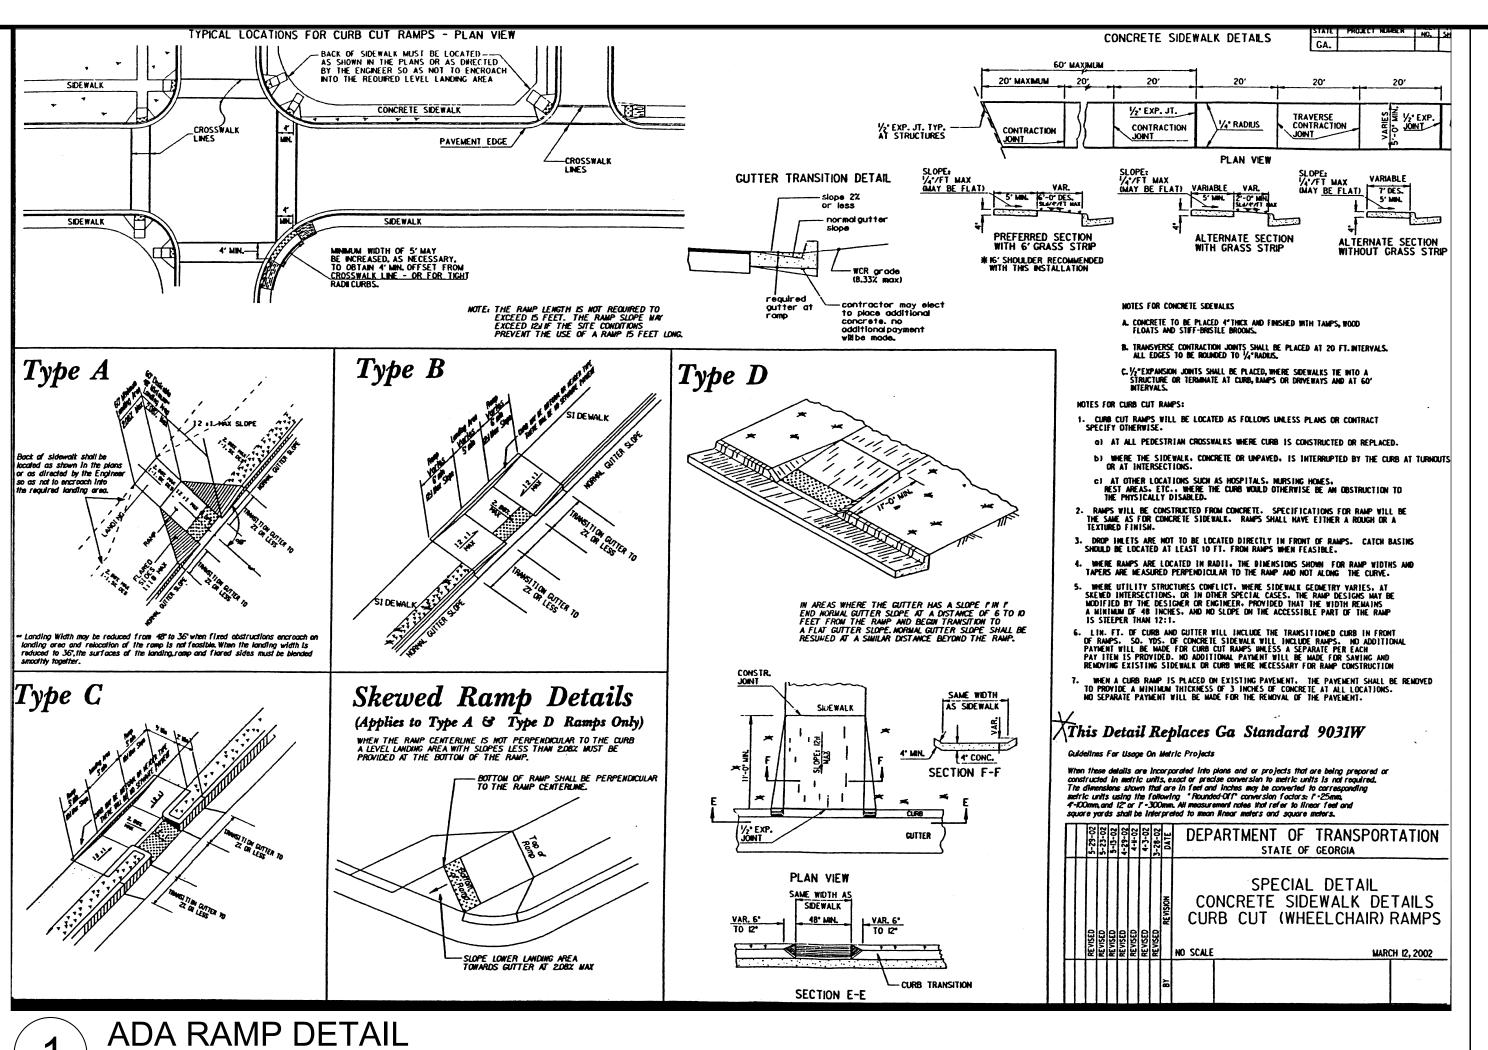



TOP VIEW SIDE VIEW **BOTTOM VIEW** AIR VENTS LOCATED ON THE ENDS OF THE TWS UNIT

- 1. PRODUCT TO BE: CAST IN PLACE REPLACEABLE TACTILE WARNING SURFACE TILES AS
- MANUFACTURED BY ADA SOLUTIONS, INC., OR APPROVED EQUAL
- TACTILE WARNING PRODUCTS SHALL BE INSTALLED AS PER MANUFACTURER'S INSTRUCTIONS. COLOR TO BE BRICK RED.
- 4. UNITS SHALL BE 24" WIDE. LENGTHS MAY VARY DEPENDING ON INSTALLATION LOCATION.
- CONTRACTOR TO SUBMIT LAYOUT PLAN FOR UNITS FOR APPROVAL.

ADA DETECTIBLE STRIP DETAIL

N.T.S.

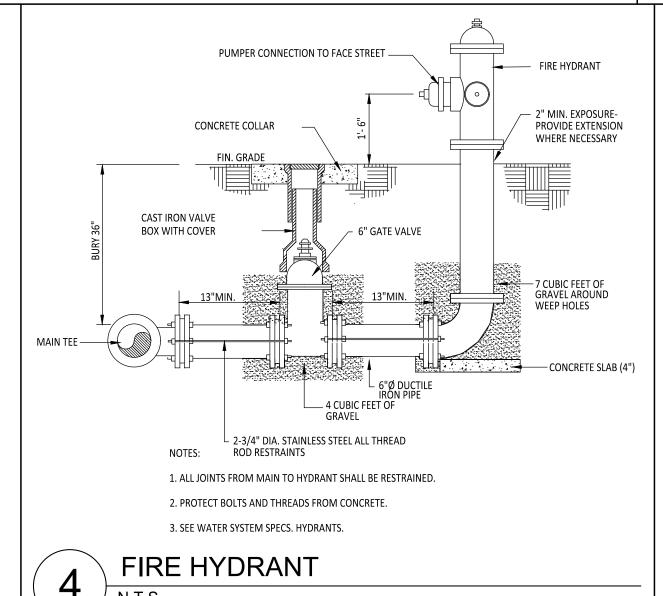


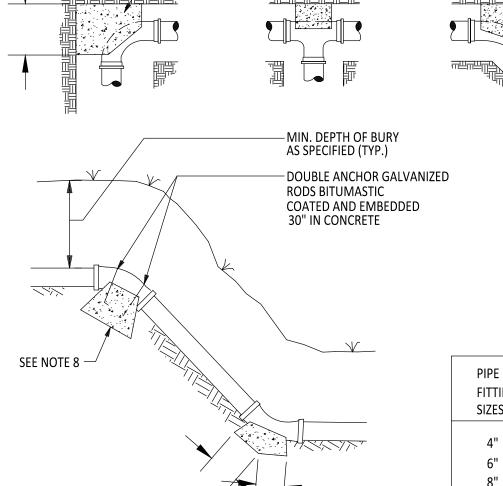

BEARING AREA (TYP.)

POURED CONCRETE BLOCKS (TYP.

- UNDISTURBED EARTH (TYP.)

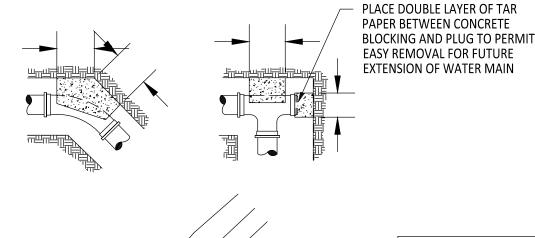

ANCHOR ROD SIZE PIPE SIZE ROD SIZE 4" THRU 6" 8" THRU 10" 12" THRU 18" #8 20" THRU 24" #10


PIPE	BEARING AREA OF BLOCK IN SQ.FT.										
FITTING SIZES	TEE & END	90 BEND	45 BENDS & WYES	22 1/2 BEND	11 1/4 BEND						
4"	0.8	1.2	0.6								
6"	1.9	2.6	1.4	0.7	0.4						
8"	3.3	4.6	2.5	1.3	0.7						
10"	5.0	7.1	3.9	2.0	1.0						
12"	7.2	10.1	5.5	2.9	1.5						
14"	9.7	13.7	7.5	3.9	2.0						
16"	12.7	17.8	9.7	5.0	2.6						
20"	19.6	27.5	15.1	7.8	4.0						
	1	1	l .	1	1						

THRUST BLOCK NOTES:

1. KEEP CONCRETE CLEAR OF JOINT AND JOINT ACCESSORIES

VERTICAL BEND

- 2. CONCRETE THRUST BLOCKING SHALL BE POURED AGAINST UNDISTURBED EARTH.
- 3. THRUST BLOCKS FOR VERTICAL BENDS HAVING DOWNWARD RESULTANT THRUSTS SHALL BE THE SAME AS FOR HORIZONTAL BENDS.
- 4. BEARING AREAS, VOLUMES, AND SPECIAL BLOCKING DETAILS SHOWN ON PLANS TAKE PRECEDENCE OVER THIS STANDARD.
- 5. TAPPING VALVES SHALL HAVE THRUST BLOCKING AS SPECIFIED FOR TEES.
- 6. CONTRACTOR SHALL PROVIDE RESTRAINT AT ALL PRESSURE LINE FITTINGS USING EITHER CONCRETE BLOCKING OR TIE ROD ASSEMBLIES.
- 7. CONCRETE FOR THRUST BLOCKS SHALL BE 3000 PSI MINIMUM STRENGH.
- 8. ANCHOR BLOCKS FOR VERTICAL BENDS SHALL BE SIZED AS 90 BENDS REGARDLESS OF ANGLE.

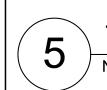

THRUST BLOCKING DETAIL

24 HOUR CONTACT CITY OF DACULA **BRITTNI NIX** BRITTNI.NIX@DACULAGA.GOV 770-963-7451

DESIGN | DRAWN | CHKD SCALE JOB No. 24-204(200577-01-001 11/14/2025

DETAILS Y OF D,

2025

CONSULTANT PROJECT # 200577-01-001

LEVEL II E&S CERT.#90012

EXP. DATE 12/19/2028 PLAN STATUS

DATE DESCRIPTION

RWH

/21/2025 BID SET

SHEET No.

N.T.S.