ZONING SYNOPSIS Petition Number(s): Z24-02

REQUEST SUMMARY:

Smith Douglas Homes, applicant, requests a change in zoning conditions of the Jackson Farm Planned Development, P-D (Planned Development), to reduce the commercial area in order to construct (103) townhomes. The area affected is approximately 12.58 acres of the 103.56 acres.

APPLICANT INFORMATION AND PROPERTY DESCRIPTION

Applicant: <u>Smith Douglas Homes (SDH)</u>

Representative: <u>Karl Lutjens, PE, Southland Engineering</u>

Property Owner: <u>Clyde Wilson Jackson Trust</u>

Property Location: 496 Mission Rd (C024-0001-001)

Access to the Property: Mission Rd & Silo Drive

Site Characteristics:

Tract Size: Acres: 12.58 ac District: 4th Section: 3rd LL(S): 448-449

Ward: **5** Council Member: **Gary Fox**

LAND USE INFORMATION

Current Zoning: P-D (Planned Development, Jackson Farm Subdiv.)

Proposed Zoning: Modify zoning conditions to allow townhomes on 12.58 acres originally

identified for commercial development.

Proposed Use: Townhouse Development

Current Zoning of Adjacent Property:

North: P-D (Jackson Farm)
South: A-G (Agriculture)
East: P-D (Jackson Farm)
West: P-D (Jackson Farm)

The Future Development Plan designates the subject property as: **Neighborhood Living**

The Future Land Use Map designates the subject property as: **Low & Medium Density Residential**

ZONING ANALYSIS

Zoning History

In 2006, the property was rezoned from R-20 and L-I with conditions to P-D (Planned Development) for the construction of single family housing in combination with commercial. Zoning was approved on 12/7/06. The commercial development was generally limited to Office-Commercial (O-C) allowed uses. The approved commercial area was 19.47 acres. Conditions were also applicable to the residential development, 80.61 acres.

The zoning conditions attached to the zoning approval in 2006 are as follows and per Ordinance 80-06:

- 1) Permitted uses shall be limited to the O-C district uses as well as hardware store, dry cleaners, and retail package stores (liquor), as well as O-C district development standards.
- 2) Proposed development will consist of a maximum of 191 residential lots.
- 3) Proposed development shall have a neighborhood swimming pool and clubhouse.
- *All residential homes shall be a minimum of 1,800 heated square feet.*
- 5) Proposed development shall consist of a maximum residential and commercial acreage as shown on the proposed site plan.
- 6) All residential lots shall be a minimum of 10,000 square feet.
- 7) All proposed commercial buildings shall be a minimum of 30% brick, stone, and/or stucco.
- 8) Developer agrees to provide 10 feet of additional right-of-way beyond that which is necessary for project related improvements.

In 2022, Smith Douglas Homes (SDH) began construction of Phase 1 which included (105) single family residential lots, (1) amenity lot, and (1) lot for a stormwater pond. All but one (1) Phase 1 lot has been developed as of the end of 2023.

In 2023, SDH began construction of the infrastructure for Phase 2 and a portion of the residential lots. Total approved lots in Phase 2 is eighty-six (86). Total approved residential lots for both phases is one hundred ninety-one (191).

Proposed Zoning

The current zoning application is to amend the zoning conditions of the commercial area of the P-D. The applicant requests to convert 12.58 acres of the commercial area to residential to construct 103 townhomes. The 12.58 acres is located along Mission Rd. between Silo Drive (Jackson Farm entrance) and the railroad tracks west of Silo Drive. The remaining commercial area, approx. 7 acres east of Silo Dr. along Mission Rd, will remain commercial.

See concept plan and elevations included with the application.

The proposed townhome development is shown with 109 total lots with 103 lots being developed for townhomes. The remaining lots will be common area lots. A pool is proposed on the lot at the Silo Dr and Mission Rd intersection.

Residential Lot summary:

Phase 1 Lots- 105
Phase 2 Lots- 86
Proposed Townhomes- 103
Proposed Total Lots for Jackson Farm – 294

Two entrances are proposed- one on Mission Rd and one on Silo Dr. This solution may address department comments regarding development regulations requiring more than one entrance for developments over 199 lots.

The internal streets are designed to accommodate front entry townhomes (front facades and garages along streets) except for townhomes adjacent to Silo Dr. and Mission Rd. Townhomes facing these existing streets will have a covered front patio.

Unit densities (units per acre or un/ac) are a consideration for any residential development. The table below includes the approximate unit densities along Mission Rd. from the DBD to Burnt Hickory Rd. Densities near the DBD range from 6.22 in the R-7 zoning district to the 2.16 un/ ac in Jackson Farm. The townhome proposal is 8.66 un/ ac. A significant increase over any other development density along this section of the Mission Rd corridor.

Location or	Zoning Category	Density-Theoretical	Density-Actual
Subdivision			
DBD Area	R-7 (min. 7,000sf/ lot)	6.22	
DBD Area	R-20 (min. 20,000sf/ lot)	2.18	
Estate Lots- AG	AG (Agriculture)	0.12 (min. lot = 5	
		acres).	
		Total. ac = 42+/-	
Estate Lot- R-20	R-20	2.18	0.05
Reserve at Pettit	R-10 (min. 10,000 sf/lot)		1.25
Creek	,		
Jackson Farm	P-D (Designed as R-10)		2.16
Jakson Farm	P-D	12 (Per RA-12 zoning	8.66
Townhomes-		district standard)	
Proposed		,	

No details about bedroom counts have been provided. Staffs' assumption is that the townhomes will be a mix of (2) and (3) bedroom configurations. This is sometimes a consideration by the school district to estimate student enrollment. No hardship is expected on the school district given that approx. 2,000 homes in Carter Grove will not be developed do the recent Technology District rezoning.

City Department Comments (from original zoning application, Z23-05, October'23)

A plan review of the concept was held with city departments and Southland Engineering on 10/10/23 to discuss the department comments below. A revised concept was submitted with this application and is under review by the city departments.

<u>Electric:</u> CES takes no exceptions to the zoning. However, the concept only shows one entrance/exit. I thought there was a limitation for lots per entrance/exit. Is this correct?

Fibercom: No Comment received.

<u>Fire:</u> Please refer to the snippet below from our development regs for subdivisions that shows more than one entrance is required for subdivisions with more than 200 lots. It does not state emergency access or fire department access.

Per 7.5-63, Subdivisions.

- ...(5) Entrances:
- (a) Maximum lots served. A subdivision shall serve no more than two hundred (200) lots with a single entrance.

Gas: Takes No Exception

<u>Public Works</u>: Below are initial Public Works comments:

- 1. Per Section 7.5-63 of the City of Cartersville Code of Ordinances "A subdivision shall serve no more than two hundred (200) lots with a single entrance. This proposes to add 112 lots to the 191 lots in the single-family section of the subdivision resulting in 303 lots using one entrance to the subdivision from a non-subdivision road. Therefore, a separate entrance from the non-subdivision road would be required.
- 2. The new entrance will require a separate right turn and left turn lane associated with it due to Mission Road being classified as a major collector route on the official GDOT functional classification map and the number of lots proposed.
- 3. Roads cannot dead end without an approved turn around feature that meets City of Cartersville standards per Standard No. 3.8.02 as referred to in the City of Cartersville Code of Ordinances Section 7.5-63.
- 4. Development area appears to be in FEMA floodplain a flood study will be required and all requirements of local ordinance Article VI. FLOODPLAIN MANAGEMENT/FLOOD DAMAGE PREVENTION ORDINANCE must be met.
- 5. Pond levels below the water table will not count towards meeting stormwater management requirements or towards compensatory cut volumes as part of required flood plain calculations. A study should be done by a registered professional to establish the water table elevation which should be documented and included in the plan package submittal.

<u>Water and Sewer:</u> The current site conditions include a sewer main placed as such to allow for the commercial development of this tract. It appears the current layout places townhomes over the existing sewer line; the sewer main will need to be relocated to a more appropriate location, preferably within road right-of-way.

Cartersville School District: Inquiry about townhouse details (bedroom counts).

Public Comments:

1/25: Joy Peterson. 42 Jackson Farm Rd. Questions about public notice process and general inquiry.

1/29: 48 Jackson Farm. General Inquiry.

STANDARDS FOR EXERCISE OF ZONING POWERS.

1. The existing land uses and zoning of nearby property.

The specific 12.58 ac. parcel is part of the 19.47ac. commercial area. The 12.58ac. area is generally surrounded by the remaining P-D area to the east, west and north. Outside the P-D area, the adjacent areas to the east are single family detached properties that are part of the Reserve at Pettit Creek subdivision. Areas to the west are undeveloped and zoned commercial. The area to the south is zoned agricultural containing an estate lot and Mission Road Kennels.

- 2. The suitability of the subject property for the zoned purposes.

 The subject property is suitable for the commercial area of the P-D zoning.
- 3. The relative gain to the public, as compared to the hardship imposed upon the individual property owner.

The proposed gain to the public would be minimal. No true hardship has been identified.

4. Whether the subject property has a reasonable economic use as currently zoned.

The property may have a reasonable economic use as currently zoned (P-D, Commercial); however, introducing office commercial uses in the middle of a residential area and within close proximity to the Burnt Hickory intersection and DBD may not be practical.

5. Whether the zoning proposal will permit a use that is suitable in view of the use and development of adjacent and nearby property.

The zoning proposal may permit a use that is suitable in view of the use of the adjacent residential properties with low to medium unit density. Jackson Farm and Reserve at Pettit Creek have an approximate density of 2.6 un/acre and 1.25 un/ac within the developed areas. The townhomes would have an approx. density of 8.66 un/acre. The densities may not be compatible.

- 6. Whether the proposed zoning will adversely affect the existing use or usability of adjacent or nearby property.
 - The zoning proposal should not have an adverse effect on adjacent property owners. Concerns regarding traffic increases and development in a floodplain will likely be raised.
- 7. Whether the zoning proposal is in conformity with the current future development plan and community agenda of the comprehensive land use plan as currently adopted or amended in the future.

The zoning proposal generally conforms with the Future Development Plan and Comprehensive Land Use Plan for Neighborhood Living and Low to Medium density requirements. At 12 units per acre, mathematically, 150 units could be constructed which would be a high density development for the City; however, the proposed 109 units at 8.66 un/ acre may be considered in the upper limits of medium density. Low and medium densities are not specifically defined in the ordinance. These densities are referenced with examples in the Comprehensive Plan.

8. Whether the zoning proposal will result in a use which will or could adversely affect the environment, including but not limited to drainage, wetlands, groundwater recharge areas, endangered wildlife habitats, soil erosion and sedimentation, floodplain, air quality, and water quality and quantity.

Development resulting from an approved zoning proposal would be required to meet all local, state, and federal environmental regulations. The engineer and developer would be required to meet all floodplain development regulations and access regulations.

9. Whether the zoning proposal will result in a use which will or could cause an excessive or burdensome use of existing streets, transportation facilities, utilities, or schools.

The proposed use could be burdensome on local streets during peak travel times. A traffic study may be required if the zoning condition change is approved.

No burden is expected on city utilities or schools.

10. Whether there are other existing or changing conditions affecting the use and development of the property which give supporting grounds for either approval or disapproval of the zoning proposal.

There are no known conditions.


STAFF RECOMMENDATION:

Staff does not oppose the zoning condition change.

If approved, staff recommends that all department comments be addressed and the following zoning conditions for Townhomes be included. These are in addition to the original 2006 conditions:

Townhomes

- 1. For the northern most units abutting the stormwater easement, limit the front yard property line to the southern boundary of the stormwater easement to avoid conflicts with easement encroachments.
- 2. In addition to required setbacks, install a fifteen-foot wide buffer along all property lines which abut a single-family district or use to provide a visual screen in accordance with section 4.17 of the zoning ordinance.

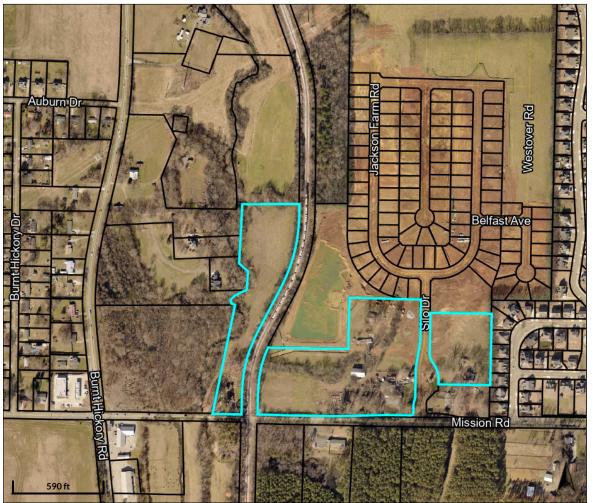

Overview

Legend

Parcels
Roads

Parcel ID C024-0001-001 Sec/Twp/Rng n/a Property Address 496 MISSION RD

District Cartersville

Brief Tax Description LL 448-449-416-377

(Note: Not to be used on legal documents)

Class

Acreage

Alternate ID 34911

Agricultural

26.01

Owner Address CLYDE WILSON JACKSON TRUST 478 MISSION RD


CARTERSVILLE, GA 30120

Date created: 1/31/2024

Last Data Uploaded: 1/30/2024 8:44:05 PM



QPublic.net Bartow County, GA ZONING

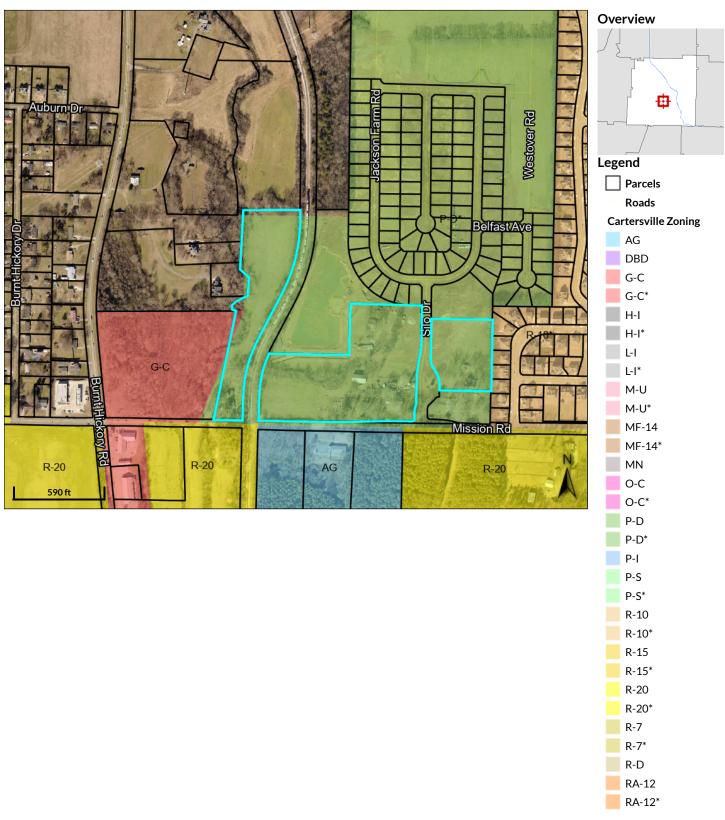

District Brief Tax Description Cartersville LL 448-449-416-377


(Note: Not to be used on legal documents)

Date created: 1/31/2024

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QPublic.net Bartow County, GA FLOOD HAZARD AREA



Parcel ID C024-0001-001 Sec/Twp/Rng n/a Property Address 496 MISSION RD Alternate ID 34911
Class Agricultural
Acreage 26.01

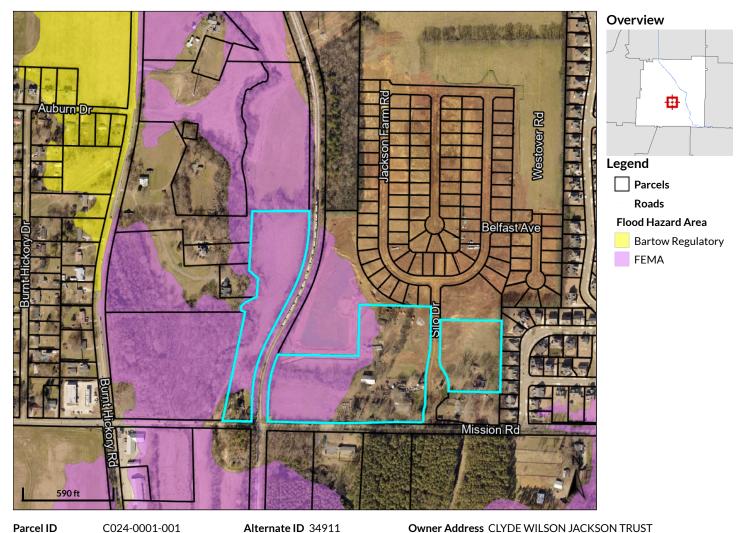478 MISSION RD CARTERSVILLE, GA 30120

District Cartersville

Brief Tax Description LL 448-449-416-377

(Note: Not to be used on legal documents)

Date created: 1/31/2024

Last Data Uploaded: 1/30/2024 8:44:05 PM



Application for Rezoning	Case Number: $274-07$					
City of Cartersville	Date Received: 12/27/23					
Public Hearing Dates: Planning Commission 7/6 1st City Council 2/15 5:30pm 7:00pm						
city zip zmax	N/A horpe@smithdouglas.com					
Southland Engineering, INC. Phone (Rep) 770-387-0440						
Representative's printed name (if other than applicant) Email (Rep)	karl@southlandengineers.com					
Representative Signature Applicant Signature	TEN 80-00					
Signed, sealed and delivered in presence of: My commission Bracke futer Schmaker Notary Public	n expires:					
	COUNTY GOVE					
* TitleholderClyde Wilson Jackson Trust Phone 454 569 //						
Address 478 Mission Road Cartersville, GA 301250 Email denjack Sentara @ Project Con						
Signed, sealed, delivered in presence of: My commission expires: 0 1 2025						
W. COONI Shirt						
Present Zoning District P-D Requested Zoning	P-D with modifications					
Acreage 12.58 Land Lot(s) 448 & 449 District(s) 4th	Section(s)3rd					
Location of Property: 496 Mission Road Cartersville, GA 301.20 (street address, nearest intersections, etc.)	Parcel ID No					
Reason for Rezoning Request:To modify the zoning conditions by reducing the amount of commercial area by 12.58 acres in order						
to construct townhomes on the west side of Silo Drive.						


(attach additional statement as necessary)

^{*} Attach additional notarized signatures as needed on separate application pages.

CAMPAIGN DISCLOSURE REPORT FOR ZONING ACTIONS

Pursuant to O.C.G.A. 36-67A-3 any and all applicants to a rezoning action must make the following disclosures:

	Date of Application:	12/27/2023			
	Date Two Years Prior to App	olication:	12/27/2021		
	Date Five Years Prior to App	lication:	12/27/2018		
1.	Has the applicant within the made campaign contributio				
	Mayor: Matt Santini		YES	NO V	
	Council Member: Ward 1- Kari Hodge				
	Ward 2- Jayce Stepp Ward 3- Cary Roth Ward 4- Calvin Cooley				
	Ward 5- Gary Fox Ward 6- Taff Wren				
	Planning Commission Lamar Pendley, Chair Anissa Cooley Fritz Dent Greg Culverhouse Jeffery Ross Stephen Smith Travis Popham			\\ \\ \\ \\ \\ \\ \\ \\ \\ \\ \\ \\ \\	
2.	If the answer to any of the above is Yes , please indicate below to whom, the d amount, date, and description of each campaign contribution, during the past years.				
		Ca	onnor Thorps	12/27/2023	
			ature	Date	
			nnor Thorpe t Name		

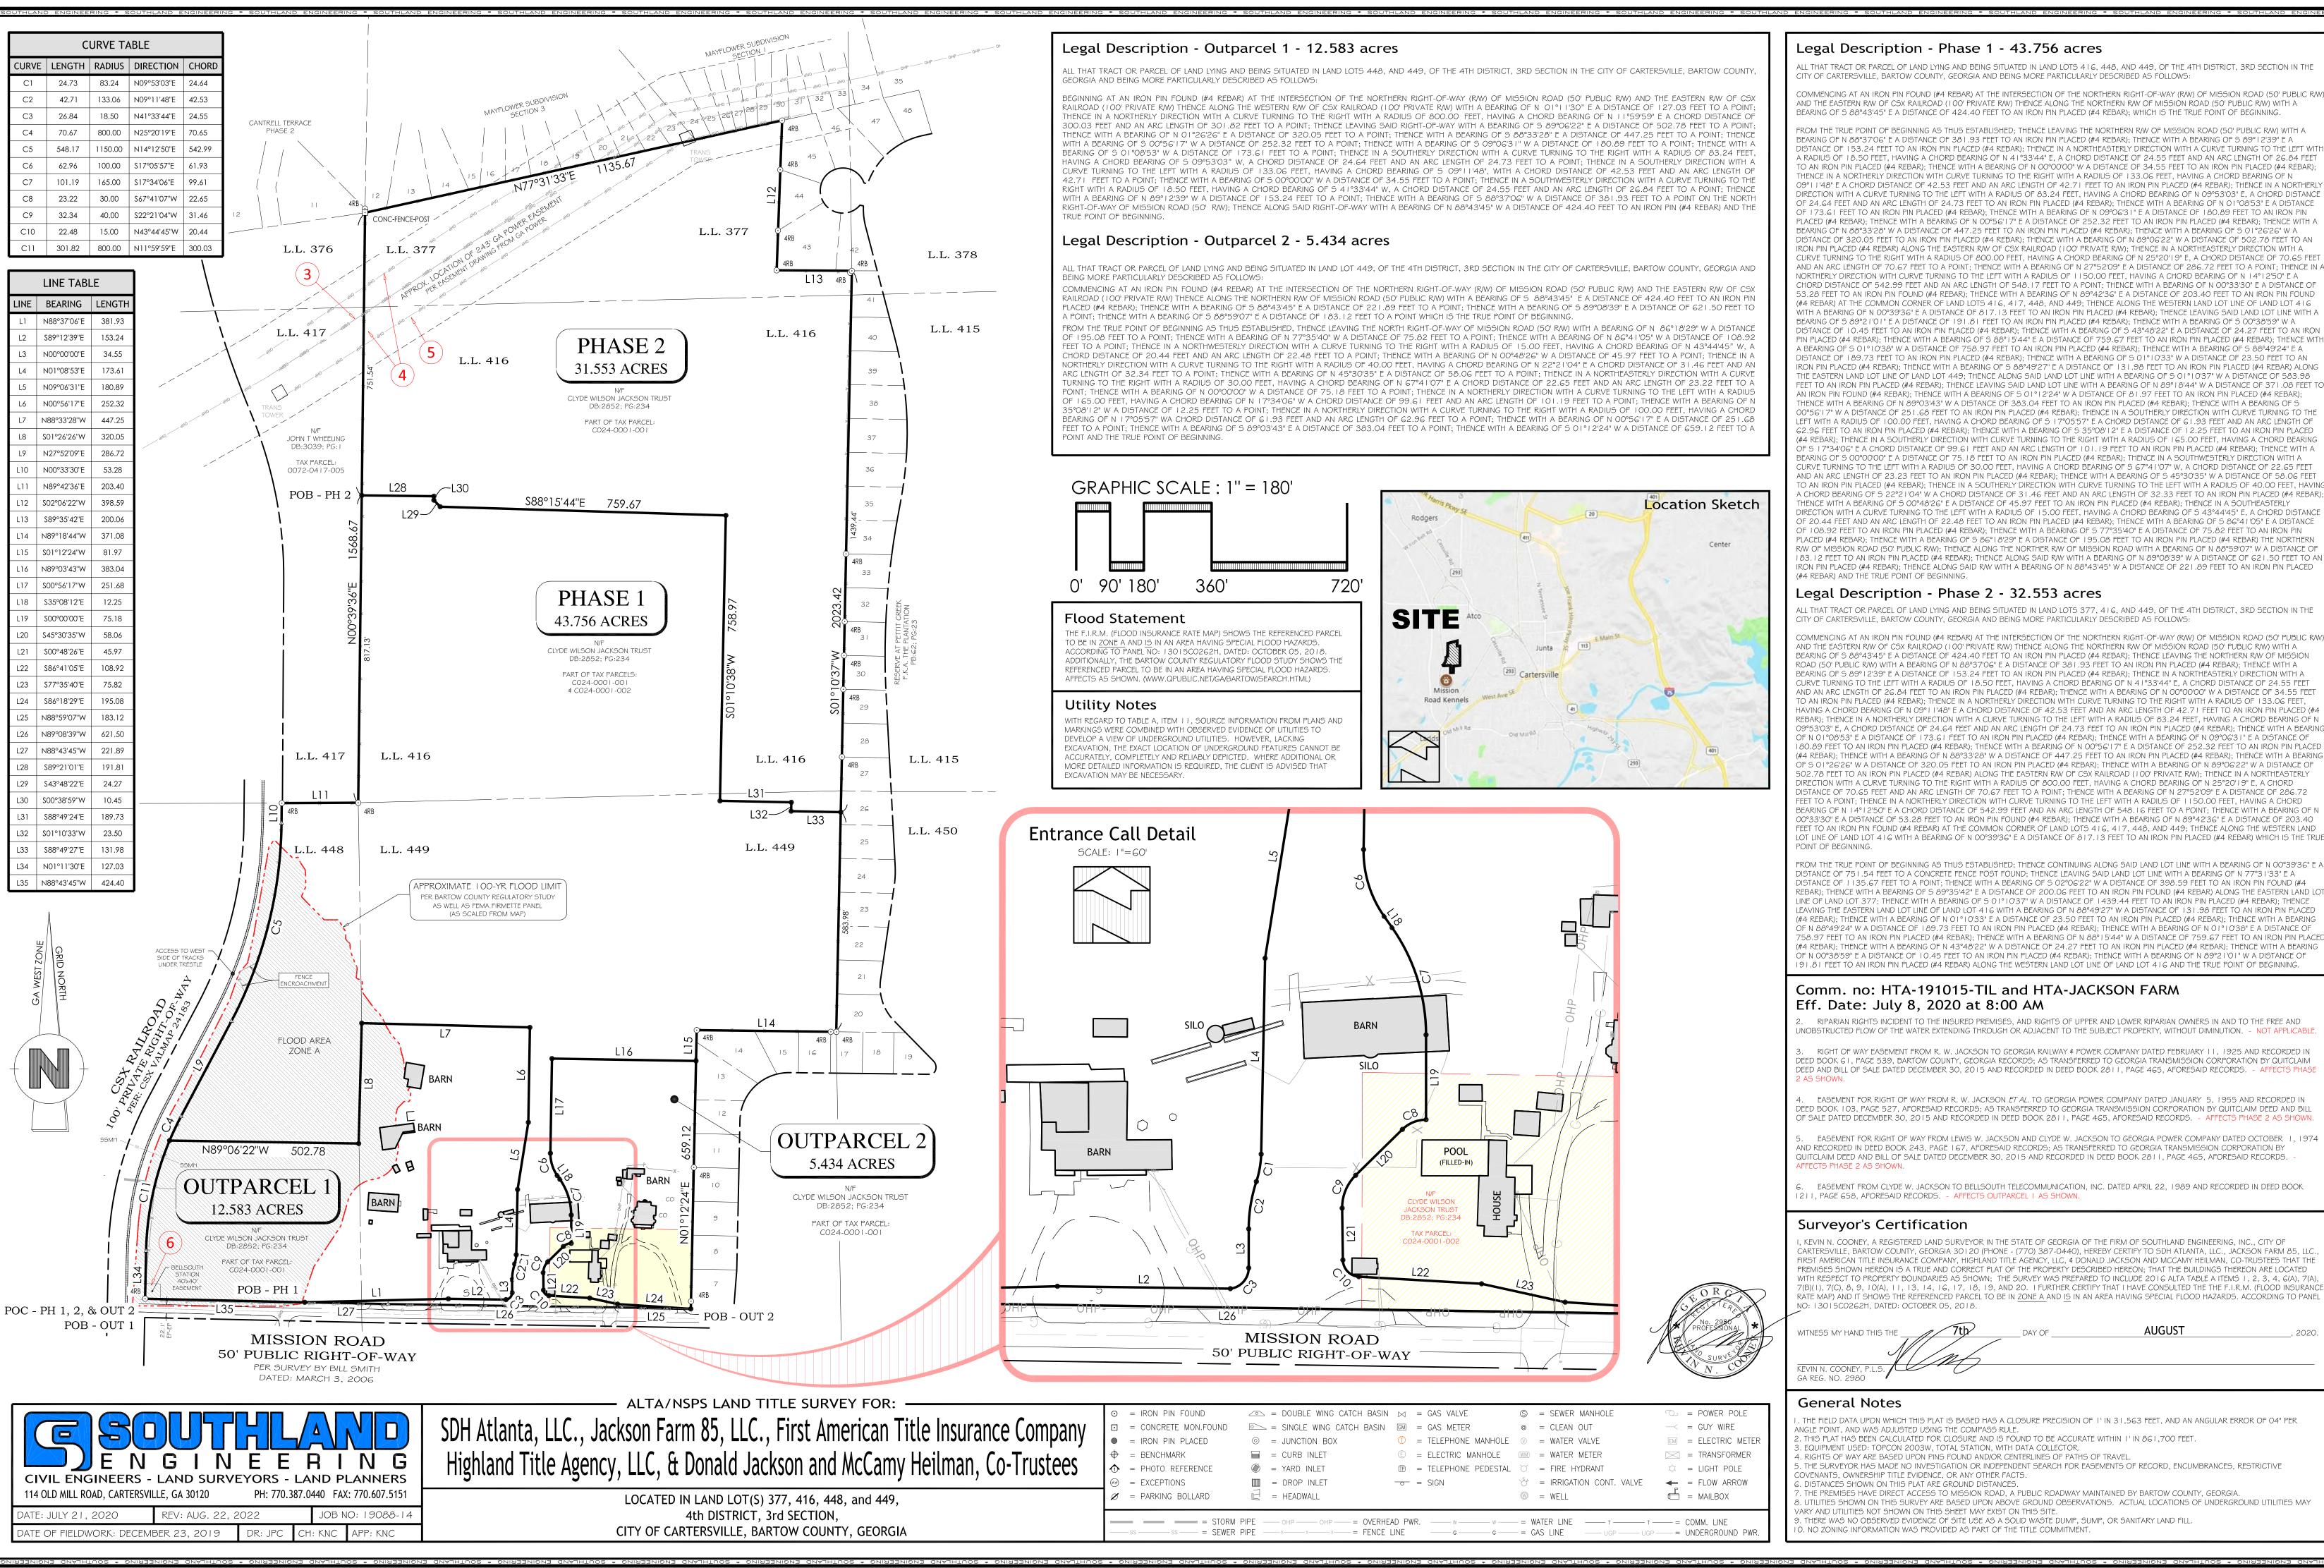

Legal Description - Phase 1 - 43.756 acres

ALL THAT TRACT OR PARCEL OF LAND LYING AND BEING SITUATED IN LAND LOTS 416, 448, AND 449, OF THE 4TH DISTRICT, 3RD SECTION IN THE ITY OF CARTERSVILLE, BARTOW COUNTY, GEORGIA AND BEING MORE PARTICULARLY DESCRIBED AS FOLLOWS:

COMMENCING AT AN IRON PIN FOUND (#4 REBAR) AT THE INTERSECTION OF THE NORTHERN RIGHT-OF-WAY (RW) OF MISSION ROAD (50' PUBLIC RW) AND THE EASTERN RW OF CSX RAILROAD (100' PRIVATE RW) THENCE ALONG THE NORTHERN RW OF MISSION ROAD (50' PUBLIC RW) WITH A BEARING OF S 88°43'45" E A DISTANCE OF 424.40 FEET TO AN IRON PIN PLACED (#4 REBAR); WHICH IS THE TRUE POINT OF BEGINNING.

FROM THE TRUE POINT OF BEGINNING AS THUS ESTABLISHED; THENCE LEAVING THE NORTHERN RW OF MISSION ROAD (50' PUBLIC RW) WITH A BEARING OF N 88°37'OG" E A DISTANCE OF 38 I .93 FEET TO AN IRON PIN PLACED (#4 REBAR): THENCE WITH A BEARING OF S 89° I 2'39" E A DISTANCE OF 153.24 FEET TO AN IRON PIN PLACED (#4 REBAR): THENCE IN A NORTHEASTERLY DIRECTION WITH A CURVE TURNING TO THE LEFT WITH A RADIUS OF 18.50 FEET, HAVING A CHORD BEARING OF N 41°33'44" E, A CHORD DISTANCE OF 24.55 FEET AND AN ARC LENGTH OF 26.84 FEET O AN IRON PIN PLACED (#4 REBAR); THENCE WITH A BEARING OF N 00°00'00" W A DISTANCE OF 34.55 FEET TO AN IRON PIN PLACED (#4 REBAR); THENCE IN A NORTHERLY DIRECTION WITH CURVE TURNING TO THE RIGHT WITH A RADIUS OF 133.0G FEET, HAVING A CHORD BEARING OF N 09°II'48" E A CHORD DISTANCE OF 42.53 FEET AND AN ARC LENGTH OF 42.71 FEET TO AN IRON PIN PLACED (#4 REBAR); THENCE IN A NORTHERLY DIRECTION WITH A CURVE TURNING TO THE LEFT WITH A RADIUS OF 83.24 FEET, HAVING A CHORD BEARING OF N 09°53'03" E, A CHORD DISTANCE OF 24.64 FEET AND AN ARC LENGTH OF 24.73 FEET TO AN IRON PIN PLACED (#4 REBAR); THENCE WITH A BEARING OF N 01°08'53" E A DISTANCE OF 173.61 FEET TO AN IRON PIN PLACED (#4 REBAR): THENCE WITH A BEARING OF N 09°06'31" E A DISTANCE OF 180.89 FEET TO AN IRON PIN PLACED (#4 REBAR): THENCE WITH A BEARING OF N 00°56′17″ F A DISTANCE OF 252.32 FEET TO AN IRON PIN PLACED (#4 REBAR): THENCE WITH / BEARING OF N 88°33'28" W A DISTANCE OF 447.25 FEET TO AN IRON PIN PLACED (#4 REBAR); THENCE WITH A BEARING OF S 01°26'26" W A DISTANCE OF 320.05 FEET TO AN IRON PIN PLACED (#4 REBAR): THENCE WITH A BEARING OF N 89°06'22" W A DISTANCE OF 502.78 FEET TO AN IRON PIN PLACED (#4 REBAR) ALONG THE EASTERN RW OF CSX RAILROAD (100' PRIVATE RW); THENCE IN A NORTHEASTERLY DIRECTION WITH A CURVE TURNING TO THE RIGHT WITH A RADIUS OF 800.00 FEET, HAVING A CHORD BEARING OF N 25°20'I 9" E, A CHORD DISTANCE OF 70.65 FEE AND AN ARC LENGTH OF 70.67 FEET TO A POINT: THENCE WITH A BEARING OF N 27°52′09″ E A DISTANCE OF 286.72 FEET TO A POINT; THENCE IN . NORTHERLY DIRECTION WITH CURVE TURNING TO THE LEFT WITH A RADIUS OF 1150.00 FEET. HAVING A CHORD BEARING OF N $14^{\circ}12^{\circ}50''$ E A CHORD DISTANCE OF 542.99 FEET AND AN ARC LENGTH OF 548.17 FEET TO A POINT; THENCE WITH A BEARING OF N 00°33'30" E A DISTANCE OF 53.28 FEET TO AN IRON PIN FOUND (#4 REBAR); THENCE WITH A BEARING OF N 89°42'36" E A DISTANCE OF 203.40 FEET TO AN IRON PIN FOUND (#4 REBAR) AT THE COMMON CORNER OF LAND LOTS 416, 417, 448, AND 449; THENCE ALONG THE WESTERN LAND LOT LINE OF LAND LOT 416 WITH A BEARING OF N 00°39'36" E A DISTANCE OF 817.13 FEET TO AN IRON PIN PLACED (#4 REBAR): THENCE LEAVING SAID LAND LOT LINE WITH . BEARING OF 5 89°21'01" E A DISTANCE OF 191.81 FEET TO AN IRON PIN PLACED (#4 REBAR); THENCE WITH A BEARING OF S 00°38'59" W A ISTANCE OF 10.45 FEET TO AN IRON PIN PLACED (#4 REBAR); THENCE WITH A BEARING OF S 43°48'22" E A DISTANCE OF 24.27 FEET TO AN IRON 'IN PLACED (#4 REBAR); THENCE WITH A BEARING OF S 88° I 5'44" E A DISTANCE OF 759.67 FEET TO AN IRON PIN PLACED (#4 REBAR); THENCE WITH A BEARING OF S.O.1.9.1.0138" W. A DISTANCE OF 758.97 FEET TO AN IRON PIN PLACED (#4 REBAR). THENCE WITH A BEARING OF S. 8.8°4.9124" F. A. DISTANCE OF 189.73 FEET TO AN IRON PIN PLACED (#4 REBAR); THENCE WITH A BEARING OF S 01°10'33" W A DISTANCE OF 23.50 FEET TO AN IRON PIN PLACED (#4 REBAR): THENCE WITH A BEARING OF S 88°49'27" E A DISTANCE OF 131.98 FEET TO AN IRON PIN PLACED (#4 REBAR) ALONG HE EASTERN LAND LOT LINE OF LAND LOT 449; THENCE ALONG SAID LAND LOT LINE WITH A BEARING OF S 01°10'37" W A DISTANCE OF 583.98 FET TO AN IRON PIN PLACED (#4 REBAR): THENCE LEAVING SAID LAND LOT LINE WITH A BEARING OF N 89° L8'44" W.A. DISTANCE OF 37 L.08 FEFT AN IRON PIN FOUND (#4 REBAR): THENCE WITH A BEARING OF S 01°12'24" W A DISTANCE OF 81.97 FEET TO AN IRON PIN PLACED (#4 REBAR): IHENCE WITH A BEARING OF N 89°03'43" W A DISTANCE OF 383.04 FEET TO AN IRON PIN PLACED (#4 REBAR); THENCE WITH A BEARING OF S 00°56'17" W A DISTANCE OF 251.68 FEET TO AN IRON PIN PLACED (#4 REBAR); THENCE IN A SOUTHERLY DIRECTION WITH CURVE TURNING TO THI EFT WITH A RADIUS OF 100.00 FEET, HAVING A CHORD BEARING OF S 1 7° 05'57" E A CHORD DISTANCE OF 61.93 FEET AND AN ARC LENGTH OF 62.96 FEET TO AN IRON PIN PLACED (#4 REBAR): THENCE WITH A BEARING OF S 35°08' I 2" E A DISTANCE OF 12.25 FEET TO AN IRON PIN PLACEI (#4 RFBAR): THENCE IN A SOUTHERLY DIRECTION WITH CURVE TURNING TO THE RIGHT WITH A RADIUS OF 1.65 OO FEET. HAVING A CHORD BEARING DF S | 7°34'06" E A CHORD DISTANCE OF 99.6 | FEET AND AN ARC LENGTH OF | 0 | . | 9 FEET TO AN IRON PIN PLACED (#4 REBAR); THENCE WITH A BEARING OF S 00°00'00" E A DISTANCE OF 75.18 FEET TO AN IRON PIN PLACED (#4 REBAR); THENCE IN A SOUTHWESTERLY DIRECTION WITH A CURVE TURNING TO THE LEFT WITH A RADIUS OF 30.00 FEFT. HAVING A CHORD BEARING OF S 67°4 L'07" W. A CHORD DISTANCE OF 22.65 FEF AND AN ARC LENGTH OF 23.23 FEET TO AN IRON PIN PLACED (#4 REBAR): THENCE WITH A BEARING OF S 45°30'35" W A DISTANCE OF 58.06 FEET TO AN IRON PIN PLACED (#4 REBAR); THENCE IN A SOUTHERLY DIRECTION WITH CURVE TURNING TO THE LEFT WITH A RADIUS OF 40.00 FEET, HAVING CHORD BEARING OF 5 22°21'04" W A CHORD DISTANCE OF 31.46 FEET AND AN ARC LENGTH OF 32.33 FEET TO AN IRON PIN PLACED (#4 REBAR); IHENCE WITH A BEARING OF S 00°48'26" E A DISTANCE OF 45.97 FEET TO AN IRON PIN PLACED (#4 REBAR); THENCE IN A SOUTHEASTERLY DIRECTION WITH A CURVE TURNING TO THE LEFT WITH A RADIUS OF 15 OO FFET. HAVING A CHORD BEARING OF S 43°44'45" F. A CHORD DISTANCE

Legal Description - Phase 2 - 32.553 acres

ALL THAT TRACT OR PARCEL OF LAND LYING AND BEING SITUATED IN LAND LOTS 377, 416, AND 449, OF THE 4TH DISTRICT, 3RD SECTION IN THE CITY OF CARTERSVILLE, BARTOW COUNTY, GEORGIA AND BEING MORE PARTICULARLY DESCRIBED AS FOLLOWS:

COMMENCING AT AN IRON PIN FOUND (#4 REBAR) AT THE INTERSECTION OF THE NORTHERN RIGHT-OF-WAY (R/W) OF MISSION ROAD (50' PUBLIC R/W) ND THE EASTERN R/W OF CSX RAILROAD (100' PRIVATE R/W) THENCE ALONG THE NORTHERN R/W OF MISSION ROAD (50' PUBLIC R/W) WITH A BEARING OF S 88°43'45" E A DISTANCE OF 424.40 FEET TO AN IRON PIN PLACED (#4 REBAR); THENCE LEAVING THE NORTHERN R/W OF MISSION ROAD (50' PUBLIC RW) WITH A BEARING OF N 88°37'0G" E A DISTANCE OF 38 I .93 FEET TO AN IRON PIN PLACED (#4 REBAR): THENCE WITH A BEARING OF S 89° I 2'39" E A DISTANCE OF 153.24 FEET TO AN IRON PIN PLACED (#4 REBAR); THENCE IN A NORTHEASTERLY DIRECTION WITH A CURVE TURNING TO THE LEFT WITH A RADIUS OF 18.50 FEET, HAVING A CHORD BEARING OF N 41°33'44" E, A CHORD DISTANCE OF 24.55 FEET AND AN ARC LENGTH OF 26.84 FEET TO AN IRON PIN PLACED (#4 REBAR); THENCE WITH A BEARING OF N 00°00'00" W A DISTANCE OF 34.55 FEET TO AN IRON PIN PLACED (#4 REBAR): THENCE IN A NORTHERLY DIRECTION WITH CURVE TURNING TO THE RIGHT WITH A RADIUS OF 1.33.0G FEFT 1AVING A CHORD BEARING OF N 09°1 I '48" E A CHORD DISTANCE OF 42.53 FEET AND AN ARC LENGTH OF 42.71 FEET TO AN IRON PIN PLACED (#4 REBAR); THENCE IN A NORTHERLY DIRECTION WITH A CURVE TURNING TO THE LEFT WITH A RADIUS OF 83.24 FEET, HAVING A CHORD BEARING OF N)9°53'03" E, A CHORD DISTANCE OF 24.64 FEET AND AN ARC LENGTH OF 24.73 FEET TO AN IRON PIN PLACED (#4 REBAR); THENCE WITH A BEARING OF N O 1°08'53" E A DISTANCE OF 173.61 FEET TO AN IRON PIN PLACED (#4 REBAR); THENCE WITH A BEARING OF N 09°06'31" E A DISTANCE OF 180.89 FFFT TO AN IRON PIN PLACED (#4 REBAR): THENCE WITH A BEARING OF N 00°56'17" F A DISTANCE OF 252.32 FFFT TO AN IRON PIN PLACEI (#4 REBAR); THENCE WITH A BEARING OF N 88°33'28" W A DISTANCE OF 447.25 FEET TO AN IRON PIN PLACED (#4 REBAR); THENCE WITH A BEARING OF S O 1°26'26" W A DISTANCE OF 320.05 FEET TO AN IRON PIN PLACED (#4 REBAR); THENCE WITH A BEARING OF N 89°06'22" W A DISTANCE OF 2.78 FEET TO AN IRON PIN PLACED (#4 REBAR) ALONG THE EASTERN RW OF CSX RAILROAD (| 00' PRIVATE RW): THENCE IN A NORTHEASTERLY IRECTION WITH A CURVE TURNING TO THE RIGHT WITH A RADIUS OF 800,00 FEET. HAVING A CHORD BEARING OF N 25°20'I 9" E. A CHORD DISTANCE OF 70.65 FEET AND AN ARC LENGTH OF 70.67 FEET TO A POINT; THENCE WITH A BEARING OF N 27°52'09" E A DISTANCE OF 286.72 EET TO A POINT; THENCE IN A NORTHERLY DIRECTION WITH CURVE TURNING TO THE LEFT WITH A RADIUS OF 1 150.00 FEET, HAVING A CHORD BEARING OF N 14°12'50" E A CHORD DISTANCE OF 542.99 FEET AND AN ARC LENGTH OF 548.16 FEET TO A POINT; THENCE WITH A BEARING OF N 0°33'30" F A DISTANCE OF 53 28 FEFT TO AN IRON PIN FOLIND (#4 REBAR): THENCE WITH A BEARING OF N 89°42'3C" F A DISTANCE OF 203 4 EET TO AN IRON PIN FOUND (#4 REBAR) AT THE COMMON CORNER OF LAND LOTS 416. 417. 448. AND 449: THENCE ALONG THE WESTERN LAND OT LINE OF LAND LOT 416 WITH A BEARING OF N 00°39'36" E A DISTANCE OF 817.13 FEET TO AN IRON PIN PLACED (#4 REBAR) WHICH IS THE TRUE

LINE OF LAND LOT 377: THENCE WITH A BEARING OF S 0 I ° I 0'37" W A DISTANCE OF 1439,44 FEET TO AN IRON PIN PLACED (#4 REBAR): THENCE FAVING THE FASTERN LAND LOT LINE OF LAND LOT 4 LG WITH A BEARING OF N. 88°49'27" W. A. DISTANCE OF 131, 98 FFFT TO AN IRON PIN PLACE (#4 RFBAR): THENCE WITH A BEARING OF N 43°48'22" W A DISTANCE OF 24.27 FFFT TO AN IRON PIN PLACED (#4 REBAR): THENCE WITH A BEARING OF N 00°38'59" E A DISTANCE OF 10.45 FEET TO AN IRON PIN PLACED (#4 REBAR): THENCE WITH A BEARING OF N 89°21'01" W A DISTANCE OF 91.81 FEET TO AN IRON PIN PLACED (#4 REBAR) ALONG THE WESTERN LAND LOT LINE OF LAND LOT 416 AND THE TRUE POINT OF BEGINNING

Comm. no: HTA-191015-TIL and HTA-JACKSON FARM

Eff. Date: July 8, 2020 at 8:00 AM

RIPARIAN RIGHTS INCIDENT TO THE INSURED PREMISES, AND RIGHTS OF UPPER AND LOWER RIPARIAN OWNERS IN AND TO THE FREE AND JNOBSTRUCTED FLOW OF THE WATER EXTENDING THROUGH OR ADJACENT TO THE SUBJECT PROPERTY, WITHOUT DIMINUTION. - NOT APPLICABLE

RIGHT OF WAY EASEMENT FROM R. W. JACKSON TO GEORGIA RAILWAY & POWER COMPANY DATED FEBRUARY 11, 1925 AND RECORDED IN DEED BOOK 61, PAGE 539, BARTOW COUNTY, GEORGIA RECORDS; AS TRANSFERRED TO GEORGIA TRANSMISSION CORPORATION BY QUITCLAIM

- DEED BOOK 103, PAGE 527, AFORESAID RECORDS; AS TRANSFERRED TO GEORGIA TRANSMISSION CORPORATION BY QUITCLAIM DEED AND BILL DF SALE DATED DECEMBER 30, 2015 AND RECORDED IN DEED BOOK 2811, PAGE 465, AFORESAID RECORDS. - AFFECTS PHASE 2 AS SHOWN
- EASEMENT FOR RIGHT OF WAY FROM LEWIS W. JACKSON AND CLYDE W. JACKSON TO GEORGIA POWER COMPANY DATED OCTOBER 1. 1974 AND RECORDED IN DEED BOOK 243, PAGE 167, AFORESAID RECORDS; AS TRANSFERRED TO GEORGIA TRANSMISSION CORPORATION BY QUITCLAIM DEED AND BILL OF SALE DATED DECEMBER 30, 2015 AND RECORDED IN DEED BOOK 2811, PAGE 465, AFORESAID RECORDS.
- EASEMENT FROM CLYDE W. JACKSON TO BELLSOUTH TELECOMMUNICATION, INC. DATED APRIL 22, 1989 AND RECORDED IN DEED BOOK 211, PAGE 658, AFORESAID RECORDS. - AFFECTS OUTPARCEL I AS SHOWN

Surveyor's Certification

CARTERSVILLE, BARTOW COUNTY, GEORGIA 30120 (PHONE - (770) 387-0440), HEREBY CERTIFY TO SDH ATLANTA, LLC., JACKSON FARM 85, LL FIRST AMERICAN TITLE INSURANCE COMPANY. HIGHLAND TITLE AGENCY. LLC. 🛊 DONALD JACKSON AND MCCAMY HEILMAN. CO-TRUSTEES THAT TH PREMISES SHOWN HEREON IS A TRUE AND CORRECT PLAT OF THE PROPERTY DESCRIBED HEREON: THAT THE BUILDINGS THEREON ARE LOCATED WITH RESPECT TO PROPERTY BOUNDARIES AS SHOWN; THE SURVEY WAS PREPARED TO INCLUDE 2016 ALTA TABLE A ITEMS 1, 2, 3, 4, 6(A), 7(A 7(B)(1), 7(C), 8, 9, 10(A), 11, 13, 14, 16, 17, 18, 19, AND 20. I FURTHER CERTIFY THAT I HAVE CONSULTED THE THE F.I.R.M. (FLOOD INSURANCI RATE MAP) AND IT SHOWS THE REFERENCED PARCEL TO BE IN ZONE A AND IS IN AN AREA HAVING SPECIAL FLOOD HAZARDS. ACCORDING TO PANEI

ITNESS MY HAND THIS TH

General Notes

THE FIELD DATA UPON WHICH THIS PLAT IS BASED HAS A CLOSURE PRECISION OF 1' IN 31,563 FEET, AND AN ANGULAR ERROR OF 04" PER NGLE POINT, AND WAS ADJUSTED USING THE COMPASS RULE.

THIS PLAT HAS BEEN CALCULATED FOR CLOSURE AND IS FOUND TO BE ACCURATE WITHIN I'IN 861,700 FEET


EQUIPMENT USED: TOPCON 2003W, TOTAL STATION, WITH DATA COLLECTOR. . RIGHTS OF WAY ARE BASED UPON PINS FOUND AND/OR CENTERLINES OF PATHS OF TRAVEL

THE SURVEYOR HAS MADE NO INVESTIGATION OR INDEPENDENT SEARCH FOR EASEMENTS OF RECORD. ENCUMBRANCES. RESTRICTIVE

DVENANTS, OWNERSHIP TITLE EVIDENCE, OR ANY OTHER FACTS. DISTANCES SHOWN ON THIS PLAT ARE GROUND DISTANCES.

UTILITIES SHOWN ON THIS SURVEY ARE BASED UPON ABOVE GROUND OBSERVATIONS. ACTUAL LOCATIONS OF UNDERGROUND UTILITIES MAY 'ARY AND UTILITIES NOT SHOWN ON THIS SHEET MAY EXIST ON THIS SITE

). THERE WAS NO OBSERVED EVIDENCE OF SITE USE AS A SOLID WASTE DUMP, SUMP, OR SANITARY LAND FILI

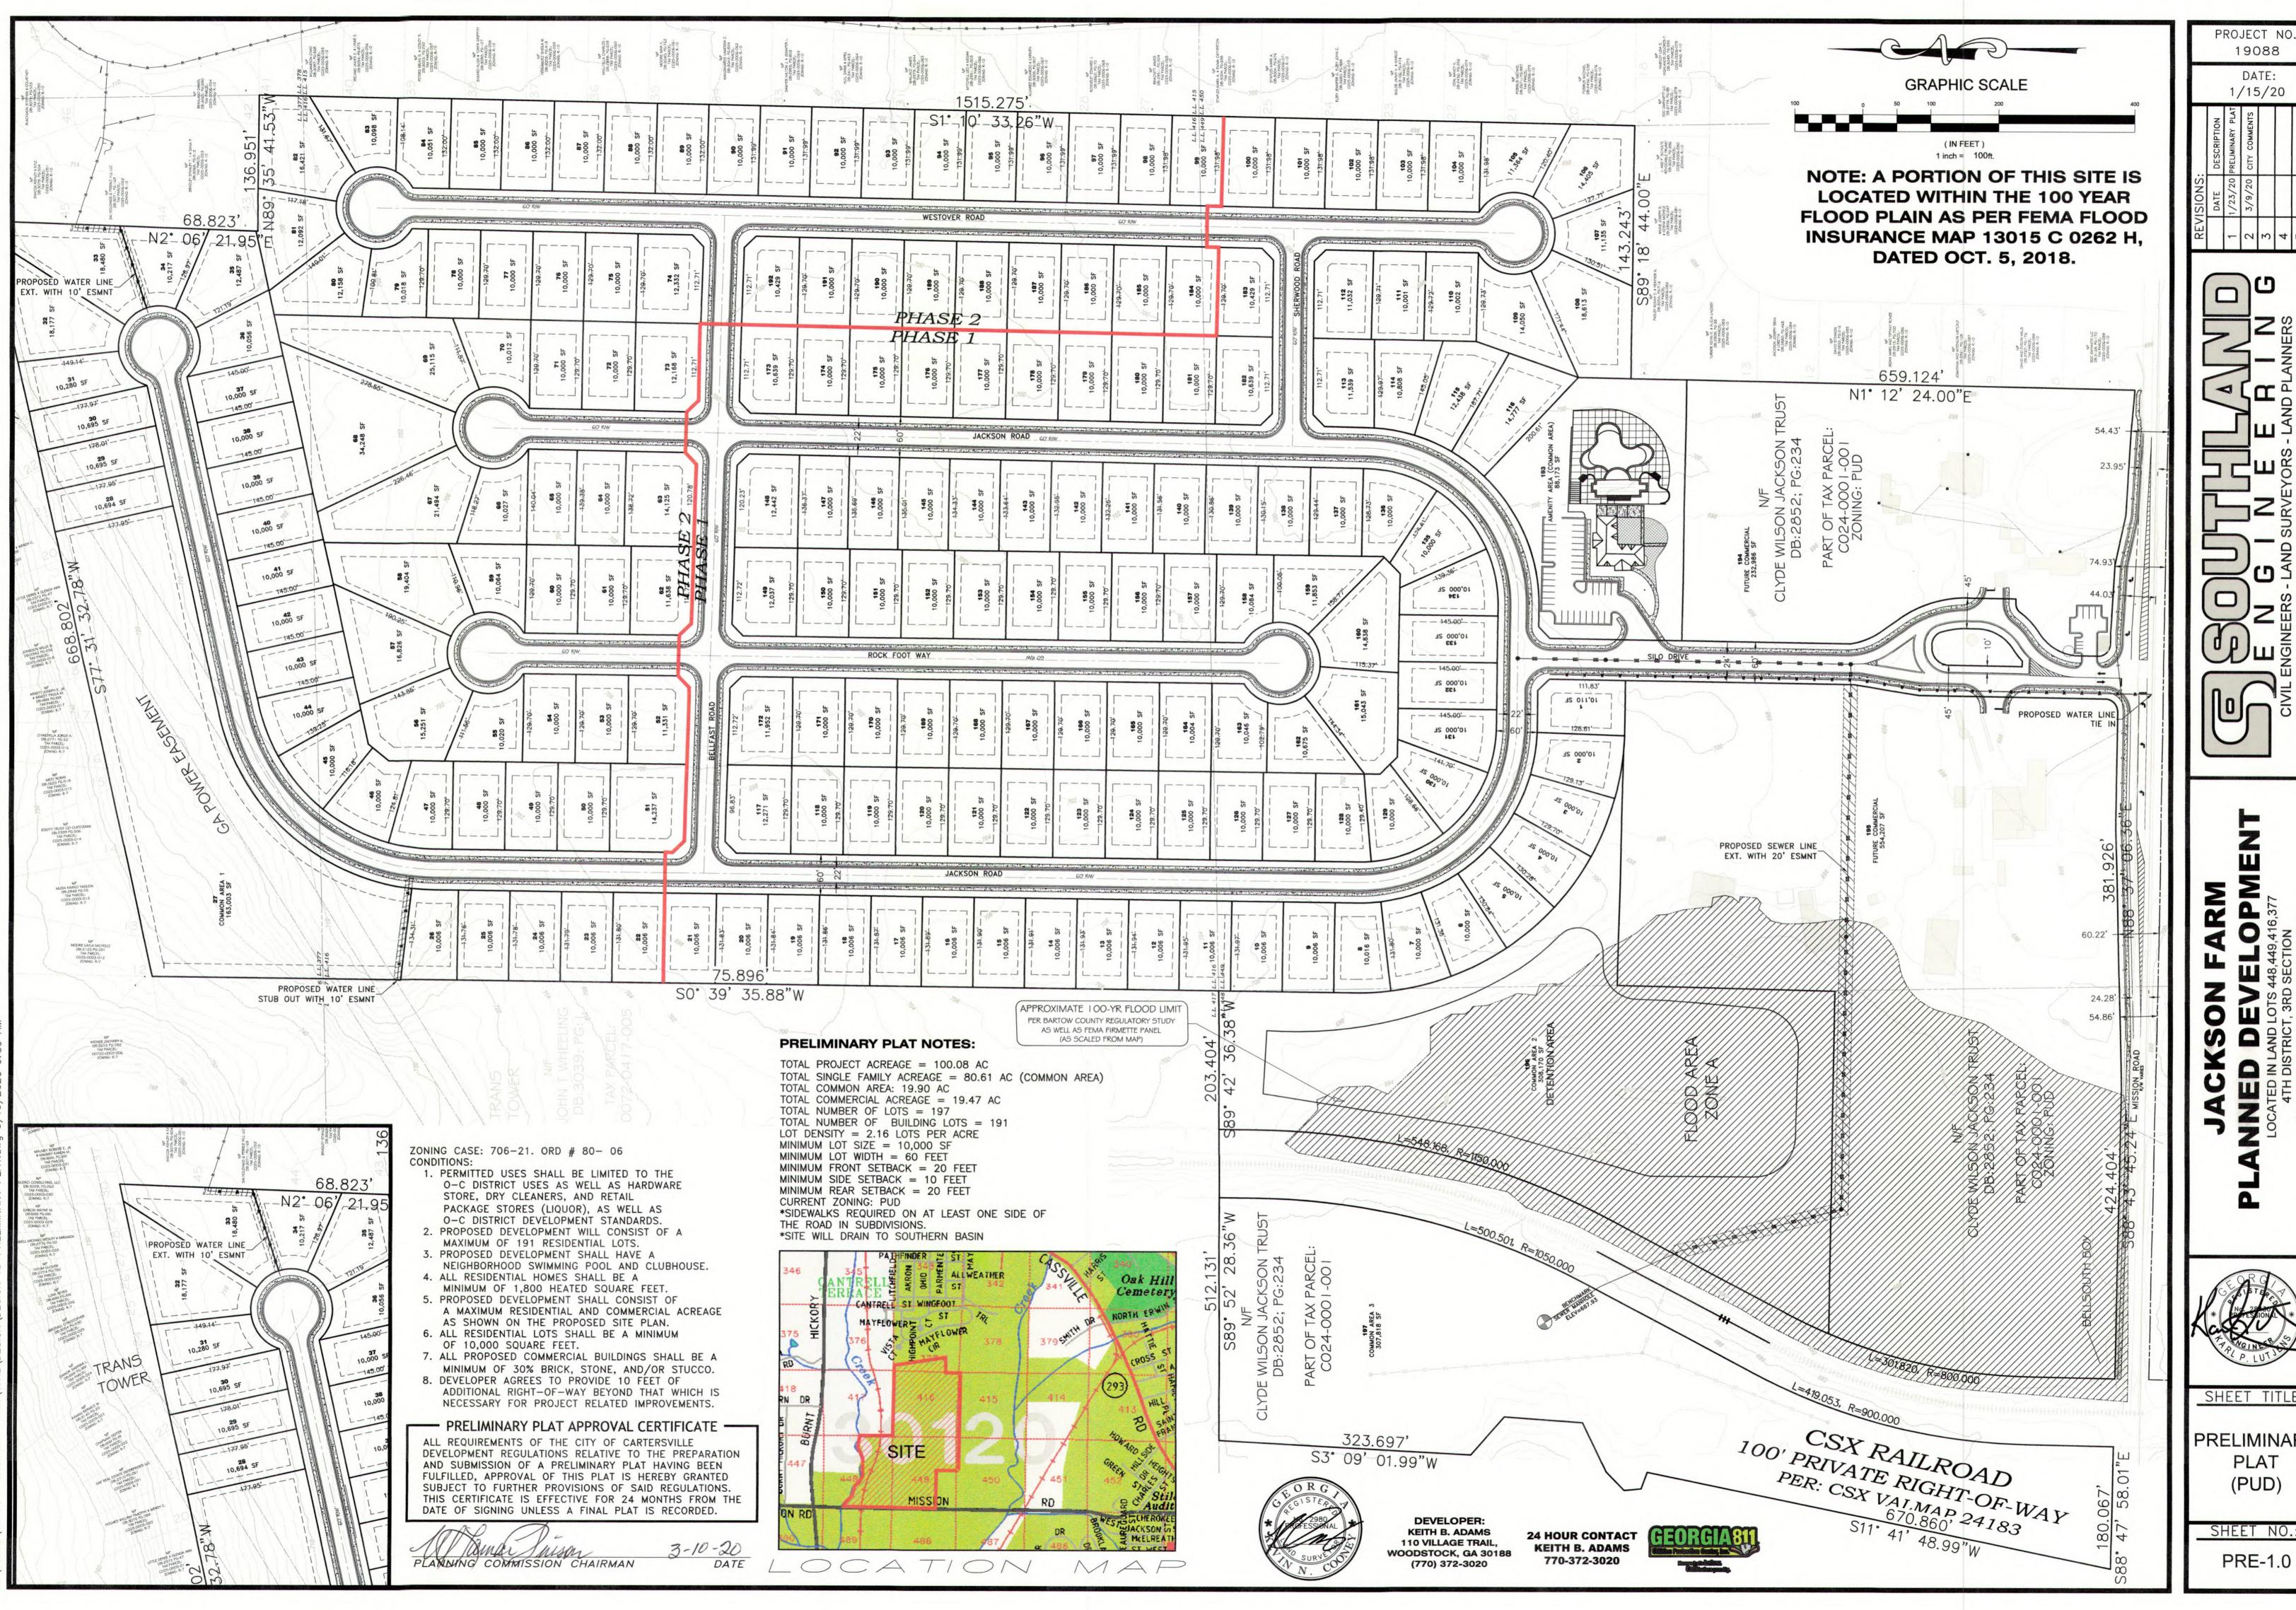


19088 DATE:

1/15/20

SHEET TITLE:


PRELIMINARY PLAT (PUD)

SHEET NO .:

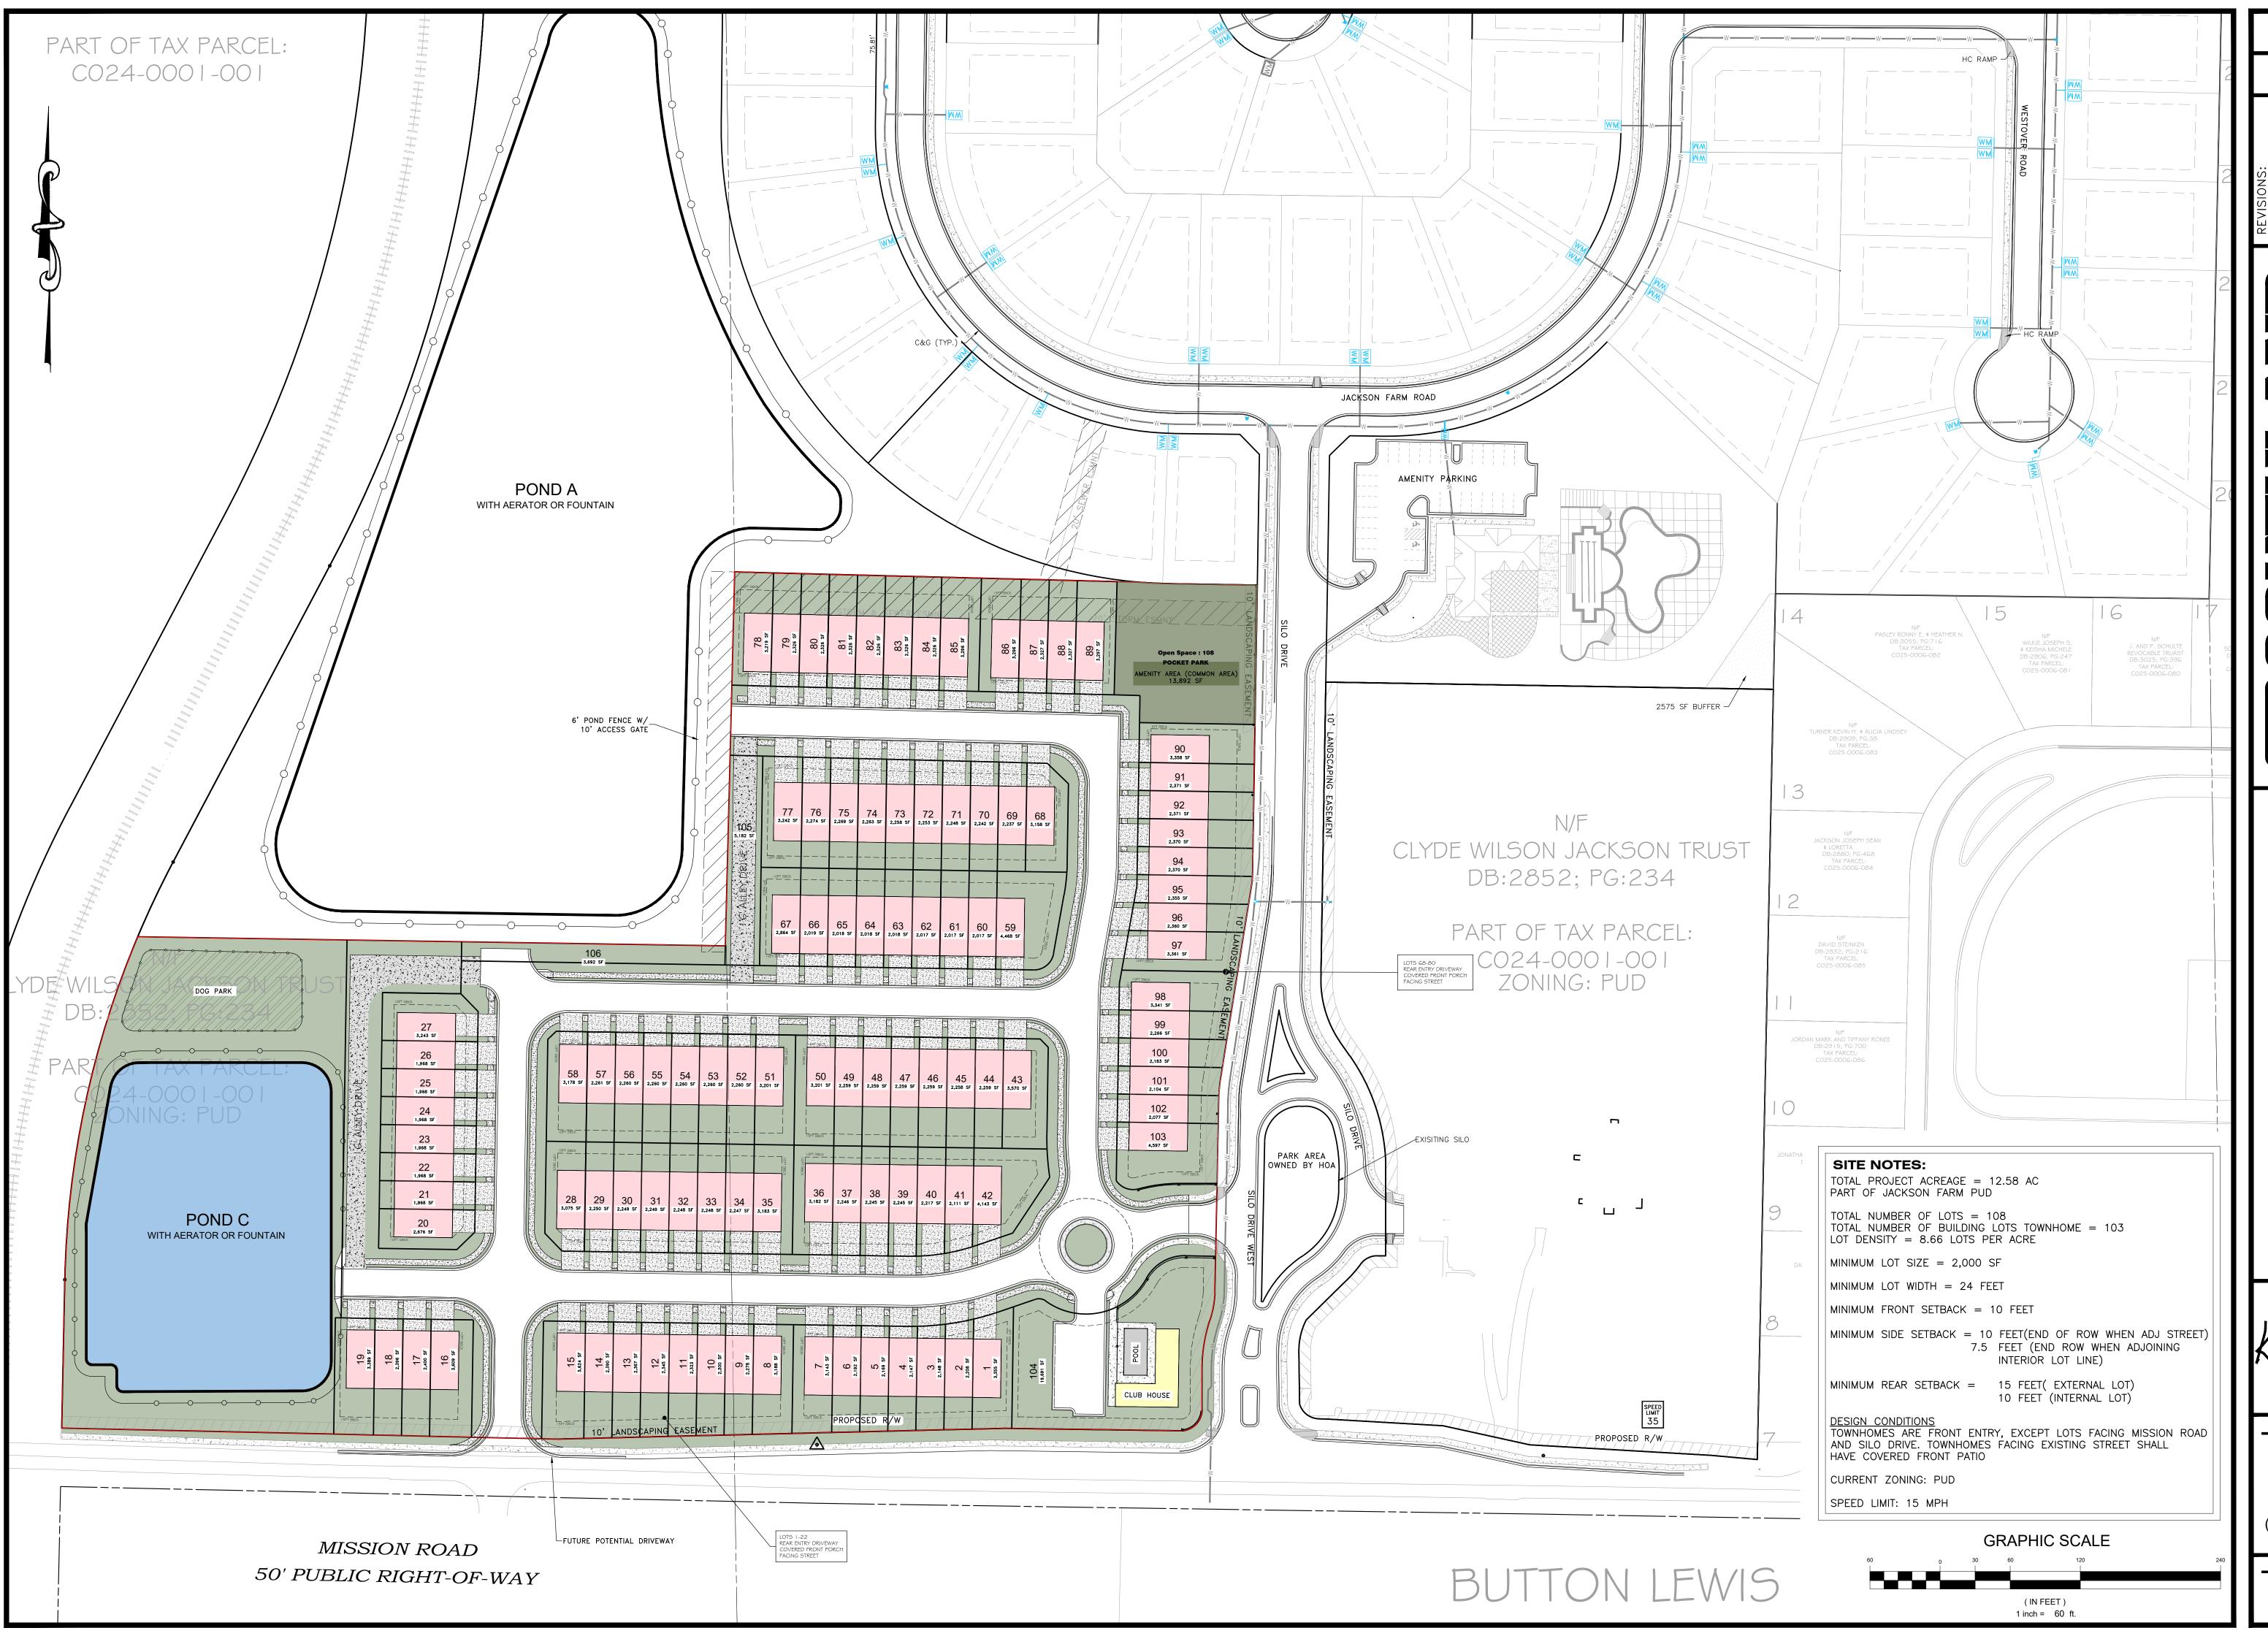

20367 12/28/23

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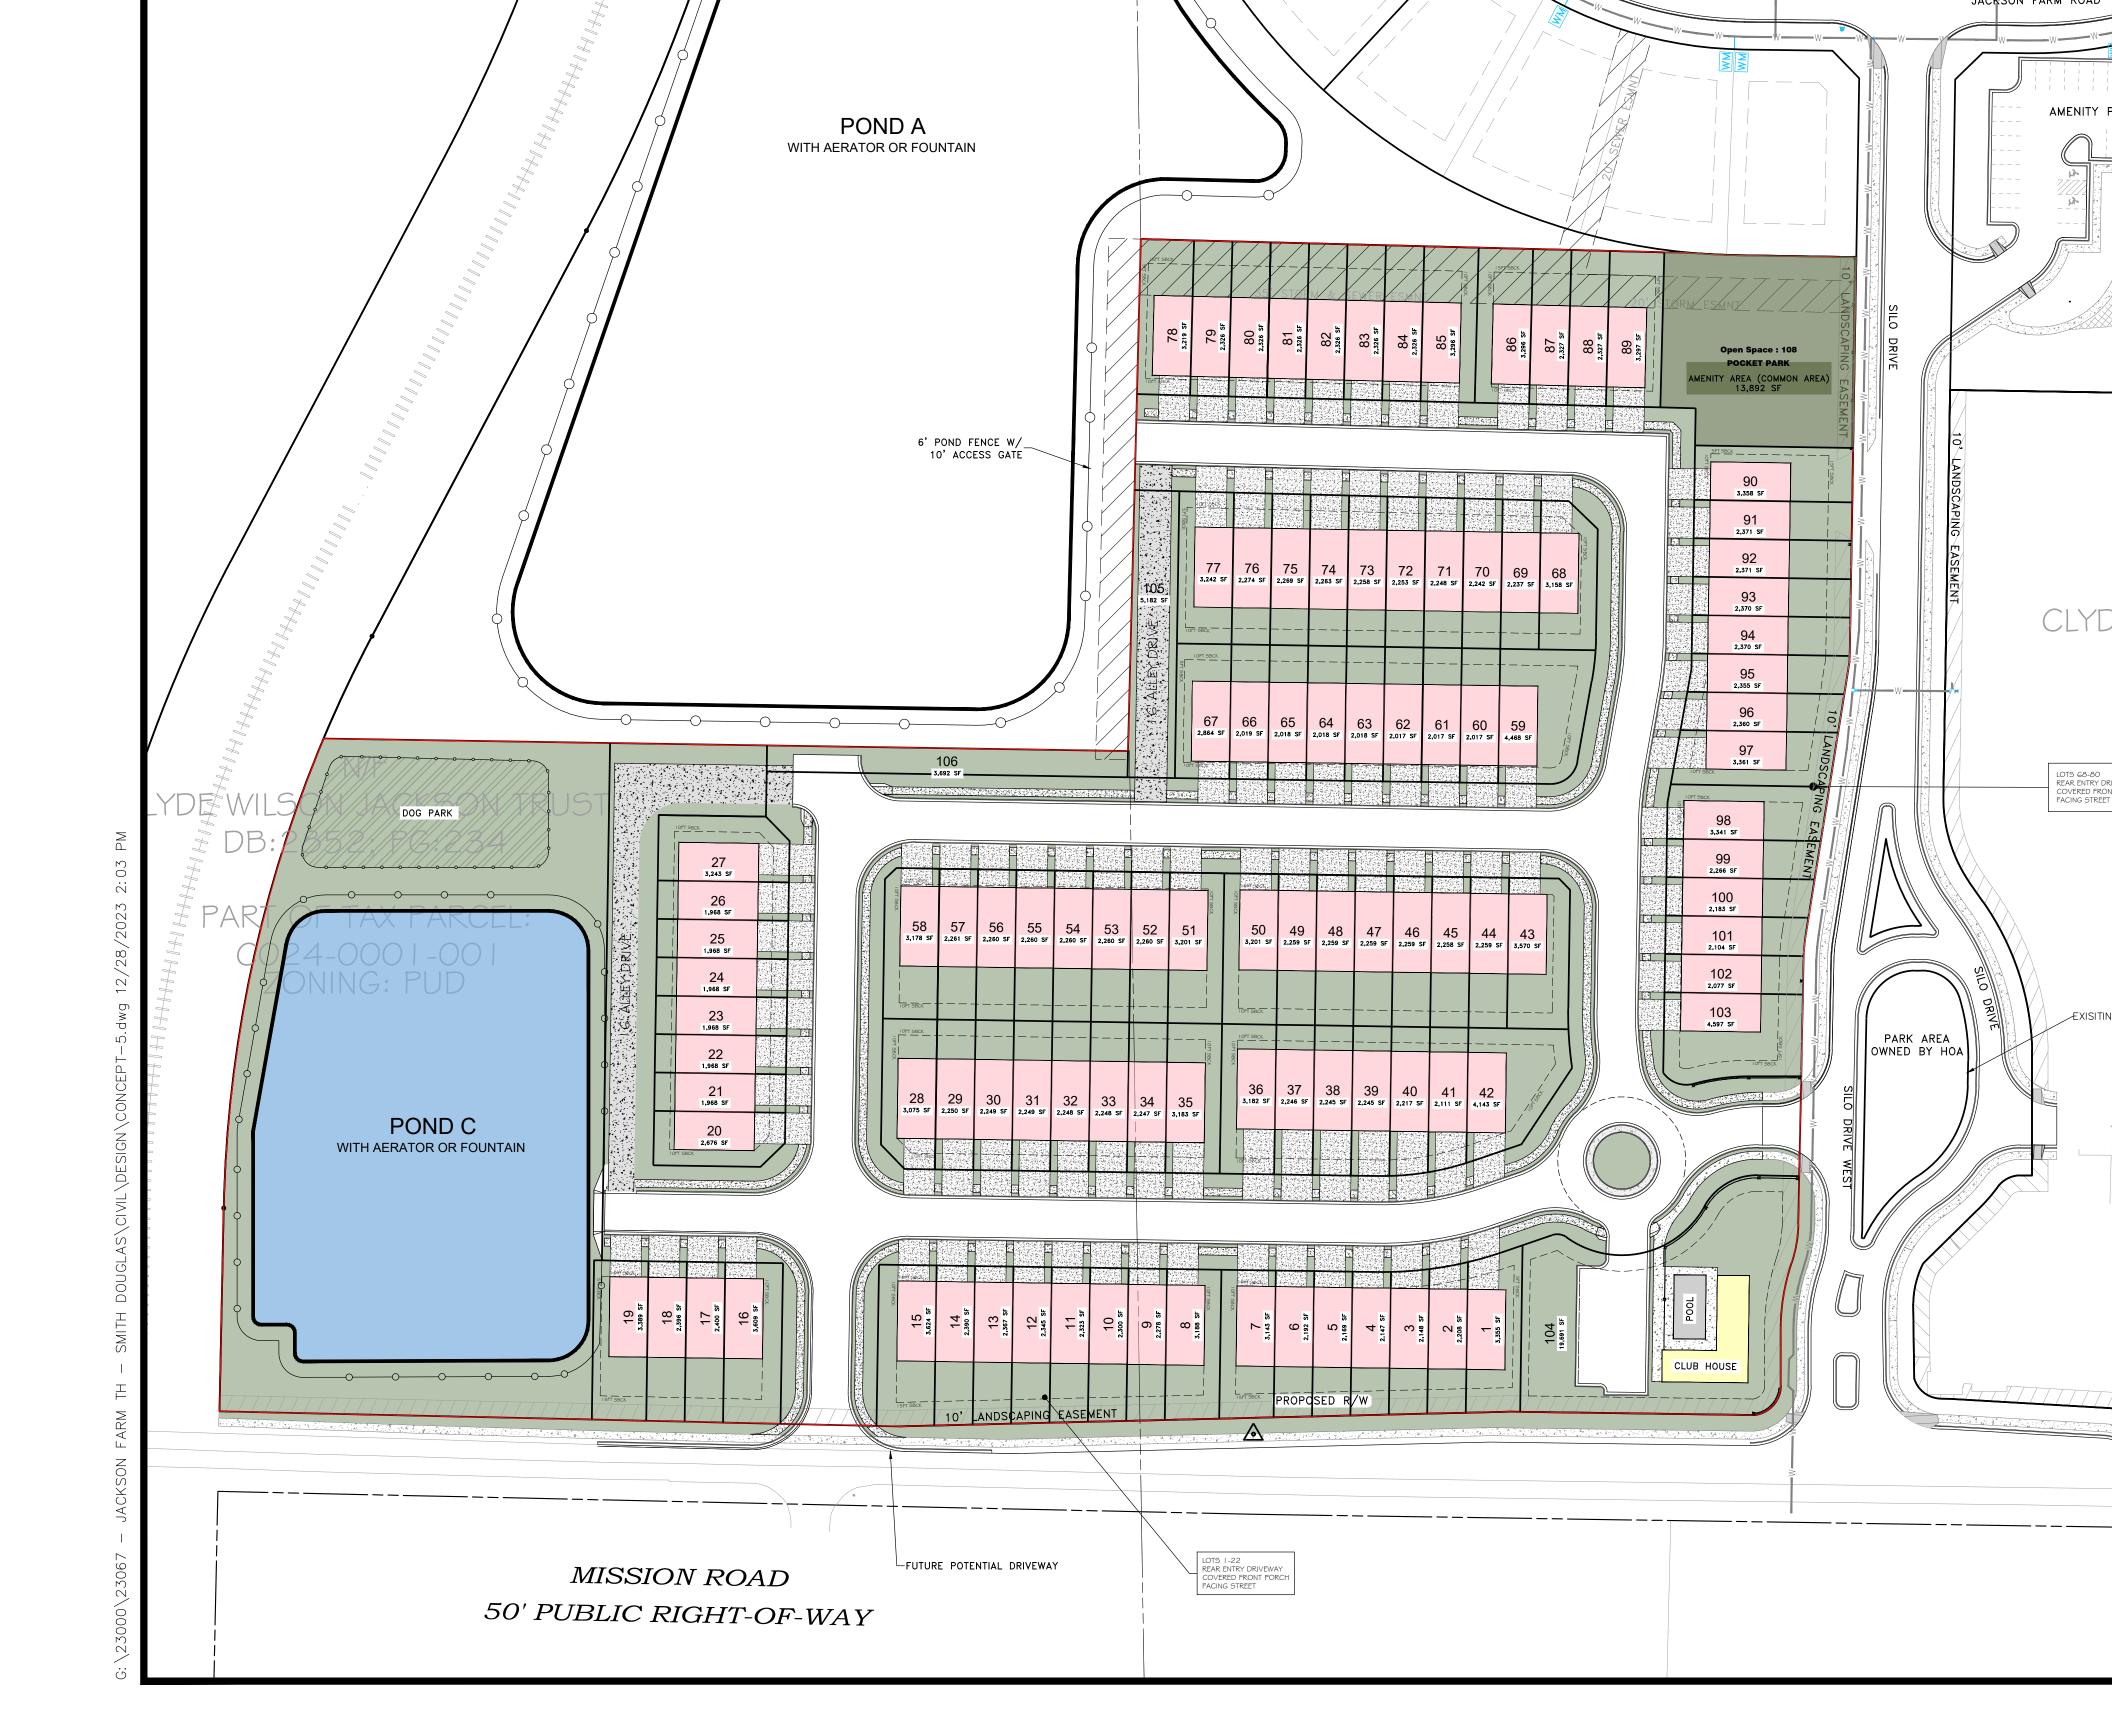


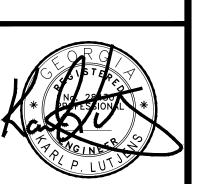
SHEET TITLE:

PLAN (TOWN HOMES)


SHEET NO.:

C201



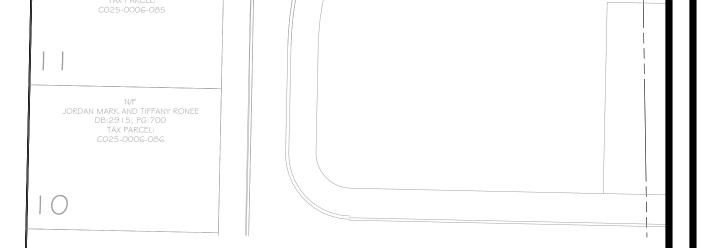

JACKSON FA LANNED DEVEL LOCATED IN LAND LOTS 377,448 4TH DISTRICT, 3RD SECTION OF CARTERSVILLE, GEO

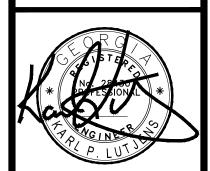

SHEET TITLE:

SITE PLAN (TOWN HOMES)

SHEET NO .:

C201

SITE NOTES:

TOTAL PROJECT ACREAGE = 12.58 AC PART OF JACKSON FARM PUD

TOTAL NUMBER OF LOTS = 108
TOTAL NUMBER OF BUILDING LOTS TOWNHOME = 103
LOT DENSITY = 8.66 LOTS PER ACRE

MINIMUM LOT SIZE = 2,000 SF

MINIMUM LOT WIDTH = 24 FEET

MINIMUM FRONT SETBACK = 10 FEET

MINIMUM SIDE SETBACK = 10 FEET(END OF ROW WHEN ADJ STREET) 7.5 FEET (END ROW WHEN ADJOINING

INTERIOR LOT LINE)

MINIMUM REAR SETBACK = 15 FEET(EXTERNAL LOT)

10 FEET (INTERNAL LOT)


DESIGN CONDITIONS

TOWNHOMES ARE FRONT ENTRY, EXCEPT LOTS FACING MISSION ROAD AND SILO DRIVE. TOWNHOMES FACING EXISTING STREET SHALL HAVE COVERED FRONT PATIO

CURRENT ZONING: PUD

SPEED LIMIT: 15 MPH

GRAPHIC SCALE

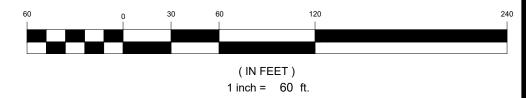

REAR ENTRY TOWNHOME BUILDING



LEFT ELEVATION "B"

RIGHT ELEVATION "D"











FRONT ELEVATION "A"



FRONT ELEVATION "B"

SCALE: 3/16 =1 -0"




SD SMITH DOUGLAS HOMES







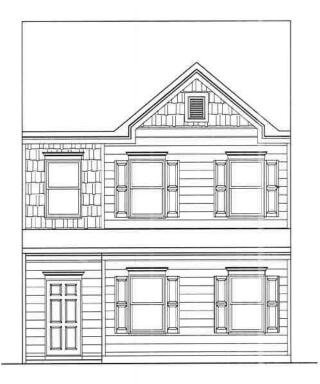

FRONT ELEVATION "A"



FRONT ELEVATION "B"

SCALE: 3/16"=1'-0"



SMITH DOUGLAS HOMES



SMITH DOUGLAS HOMES 110 VILLAGE TRAIL SUITE 215 WOODSTOCK, GA 20188 www.smithdouglas.com





GATE REVISION 6N

SMITH DOUGLAS HOMES

ELEVATIONS
4-PACK
BUILDING

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10/2/23 FLOOR ST



















