

EXHIBIT L

PRELIMINARY ENGINEERING PLANS EXTRA SPACE STORAGE

1812 N LARKIN AVE
CREST HILL, IL 60403



1-800-892-0123

UTILITY AND GOVERNING AGENCY CONTACTS

ENGINEERING DEPARTMENT
CITY OF CREST HILL PUBLIC WORKS
2090 OAKLAND AVENUE
CREST HILL, IL 60403
TEL: (815) 741-5108
CONTACT: RON WIEDEMAN

SANITARY SEWER SERVICE
CITY OF CREST HILL PUBLIC WORKS
2090 OAKLAND AVENUE
CREST HILL, IL 60403
TEL: (815) 741-5108

STORM SEWER SERVICE
CITY OF CREST HILL PUBLIC WORKS
2090 OAKLAND AVENUE
CREST HILL, IL 60403
TEL: (815) 741-5108

WATER SERVICE
CITY OF CREST HILL PUBLIC WORKS
2090 OAKLAND AVENUE
CREST HILL, IL 60403
TEL: (815) 741-5108

ROADWAY AUTHORITY
WILL COUNTY DIVISION OF TRANSPORTATION
16841 W. LARAWAY ROAD
JOLIET, IL 60433
TEL: (815) 727-8476
CONTACT: JEFF RONALDSON, P.E.

POWER COMPANY
COMED
1910 S BRIGGS ST
JOLIET, IL 60433
TEL: (800) 334-7661

NATURAL GAS COMPANY
NICOR
1844 FERRY RD
NAPERVILLE, ILLINOIS 60563
TEL: (888) 642-6748

TELEPHONE
AT&T
225 W RANDOLPH ST SUITE 2950
CHICAGO, IL 60606
TEL: (800) 288-2020

PROJECT TEAM

DEVELOPER
EXTRA SPACE STORAGE
2795 E COTTONWOOD PKWY STE #300
SALT LAKE CITY, UT 84121
TEL: (480) 256-5263
CONTACT: CLINT KLEPPE


GEOTECH
ECS MIDWEST, LLC
216 W JACKSON BLVD #1050
CHICAGO, IL 60606
TEL: (847) 279-0366
CONTACT: PENG WANG, PHD, P.E.

ARCHITECT
SGW ARCHITECTURE & DESIGN
444 N MICHIGAN AVE #1850
CHICAGO, IL 60611
TEL: (312) 237-1536
CONTACT: MIKE AUFDERHEIDE

CIVIL ENGINEER
KIMLEY-HORN AND ASSOCIATES, INC.
111 W JACKSON BLVD, SUITE 1320
CHICAGO, IL 60604
TEL: (312) 726-9445
EMAIL: ALEXA.FALBO@KIMLEY-HORN.COM
CONTACT: ALEXA FALBO, P.E.

LANDSCAPE ARCHITECT
KIMLEY-HORN AND ASSOCIATES, INC.
111 W JACKSON BLVD, SUITE 1320
CHICAGO, IL 60604
TEL: (630) 487-5550
CONTACT: JOE COGSWELL, P.L.A.

SURVEYOR
WEAVER CONSULTANTS GROUP
1316 BOND STREET, STE #108
NAPERVILLE, IL 60563
TEL: (630) 717-4848
CONTACT: JAMES BERGER

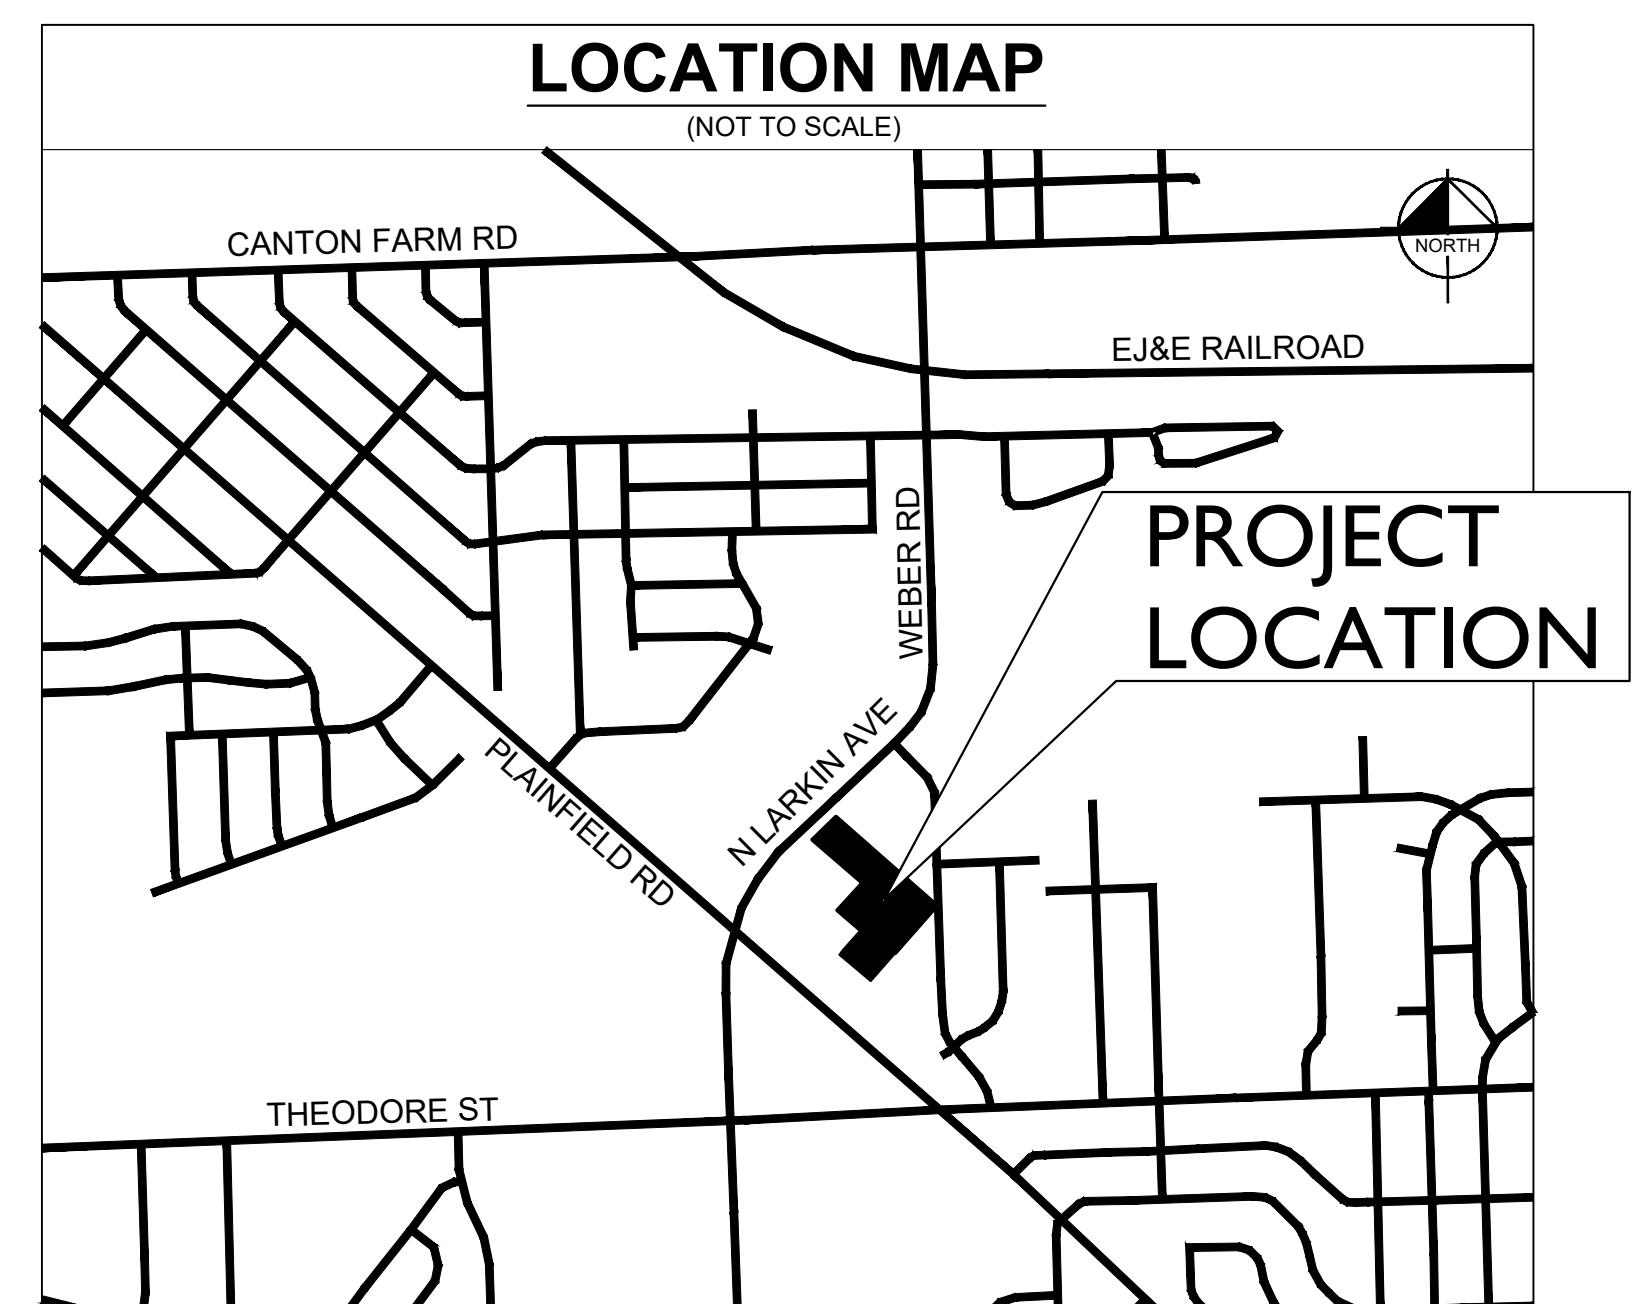

BENCHMARKS
REFER TO V0.4 FOR BENCHMARKS LISTED BY LICENSED LAND SURVEYOR

LEGAL DESCRIPTION
REFER TO V0.4 FOR ALTA LAND TITLE AND TOPOGRAPHIC SURVEY LEGAL DESCRIPTION.

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**EXTRA SPACE
STORAGE**

COVER SHEET

**EXTRA SPACE
STORAGE**

COVER SHEET

ORIGINAL ISSUE:
10/30/2025

KHA PROJECT NO.
268783002

SHEET NUMBER

C0.0

Kimley»Horn

SCALE: AS NOTED
DESIGNED BY: JTW
DRAWN BY: JEA
CHECKED BY: ANF

**NOT FOR
CONSTRUCTION**

**ExtraSpace
Storage**

PROFESSIONAL ENGINEER'S CERTIFICATION

I, ALEXANDRA FALBO, A LICENSED PROFESSIONAL ENGINEER OF ILLINOIS, HEREBY CERTIFY THAT THIS SUBMISSION, PERTAINING ONLY TO THE "C" SERIES CIVIL SHEETS LISTED ABOVE BUT EXCLUDING DETAILS PREPARED BY OTHERS, WAS PREPARED ON BEHALF OF EXTRA SPACE STORAGE BY KIMLEY-HORN AND ASSOCIATES, INC. UNDER MY PERSONAL DIRECTION. THIS TECHNICAL SUBMISSION IS INTENDED TO BE USED AS AN INTEGRAL PART OF AND IN CONJUNCTION WITH THE PROJECT SPECIFICATIONS AND CONTRACT DOCUMENTS.

DATED THIS 30TH DAY OF DECEMBER, A.D., 2025.

Alexandra Falbo

ILLINOIS LICENSED PROFESSIONAL ENGINEER 062-073907
MY LICENSE EXPIRES ON NOVEMBER 30, 2027
DESIGN FIRM REGISTRATION NUMBER: 184002012-0006



ALEXANDRA FALBO
062-073907

EXTRA SPACE STORAGE PLAT OF SUBDIVISION

THAT PART OF THE SOUTHEAST QUARTER OF SECTION 31, TOWNSHIP 36
NORTH, RANGE 10 EAST OF THE THIRD PRINCIPAL MERIDIAN, IN WILL
COUNTY, ILLINOIS

VICINITY MAP
(NOT TO SCALE)

PLAINFIELD RD. (IL 30)

N. LARKIN AVE.

KNAPP DRIVE

WILLOW CIR DR

SITE

BARTHELONE AVE

HEIDEN AVE

PLAINFIELD RD. (IL 30)

THEODORE ST. (COUNTY HWY 7)

SCALE: 1" = 50'

0 25' 50' 100'

HORIZONTAL DATUM

MEASURED BEARINGS SHOWN HEREON ARE ILLINOIS STATE PLANE EAST ZONE, BASED ON GLOBAL NAVIGATION SATELLITE SYSTEM OBSERVATIONS.

LINE LEGEND	
	BOUNDARY
	EXISTING LOTS
	RIGHT-OF-WAY
	EASEMENT

ABBREVIATIONS

LOT 1 AREA = 330,265 SQ.FT.± / 7.58 ACRES±

EXTRA SPACE STORAGE PLAT OF SUBDIVISION

Weaver Consultants Group

WEAVER CONSULTANTS GROUP
1316 BOND STREET SUITE 100
NAPERVILLE, ILLINOIS 60563
(630)-717-4848

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FILE: 8077-385
2025 10 21 - SUB PLAT.dwg
SHEET 1

VO.0


ALTA/NSPS LAND TITLE & TOPOGRAPHIC SURVEY

THAT PART OF THE SOUTHEAST QUARTER OF SECTION 31, TOWNSHIP 36
NORTH, RANGE 10 EAST OF THE THIRD PRINCIPAL MERIDIAN, IN WILL
COUNTY, ILLINOIS

PARCEL 1 PIN: 11-04-31-405-045-0000
PARCEL 2 PIN: 11-04-31-407-007-0000
PARCEL 3 PIN: 11-04-31-407-009-0000
PARCEL 4 PIN: 11-04-31-407-009-0000
PARCEL 5 PIN: 11-04-31-407-010-0000


PREPARED FOR:
Kimley Horn

ALTA/NSPS LAND TITLE & TOPOGRAPHIC SURVEY
EXTRA SPACE STORAGE
CREST HILL, IL

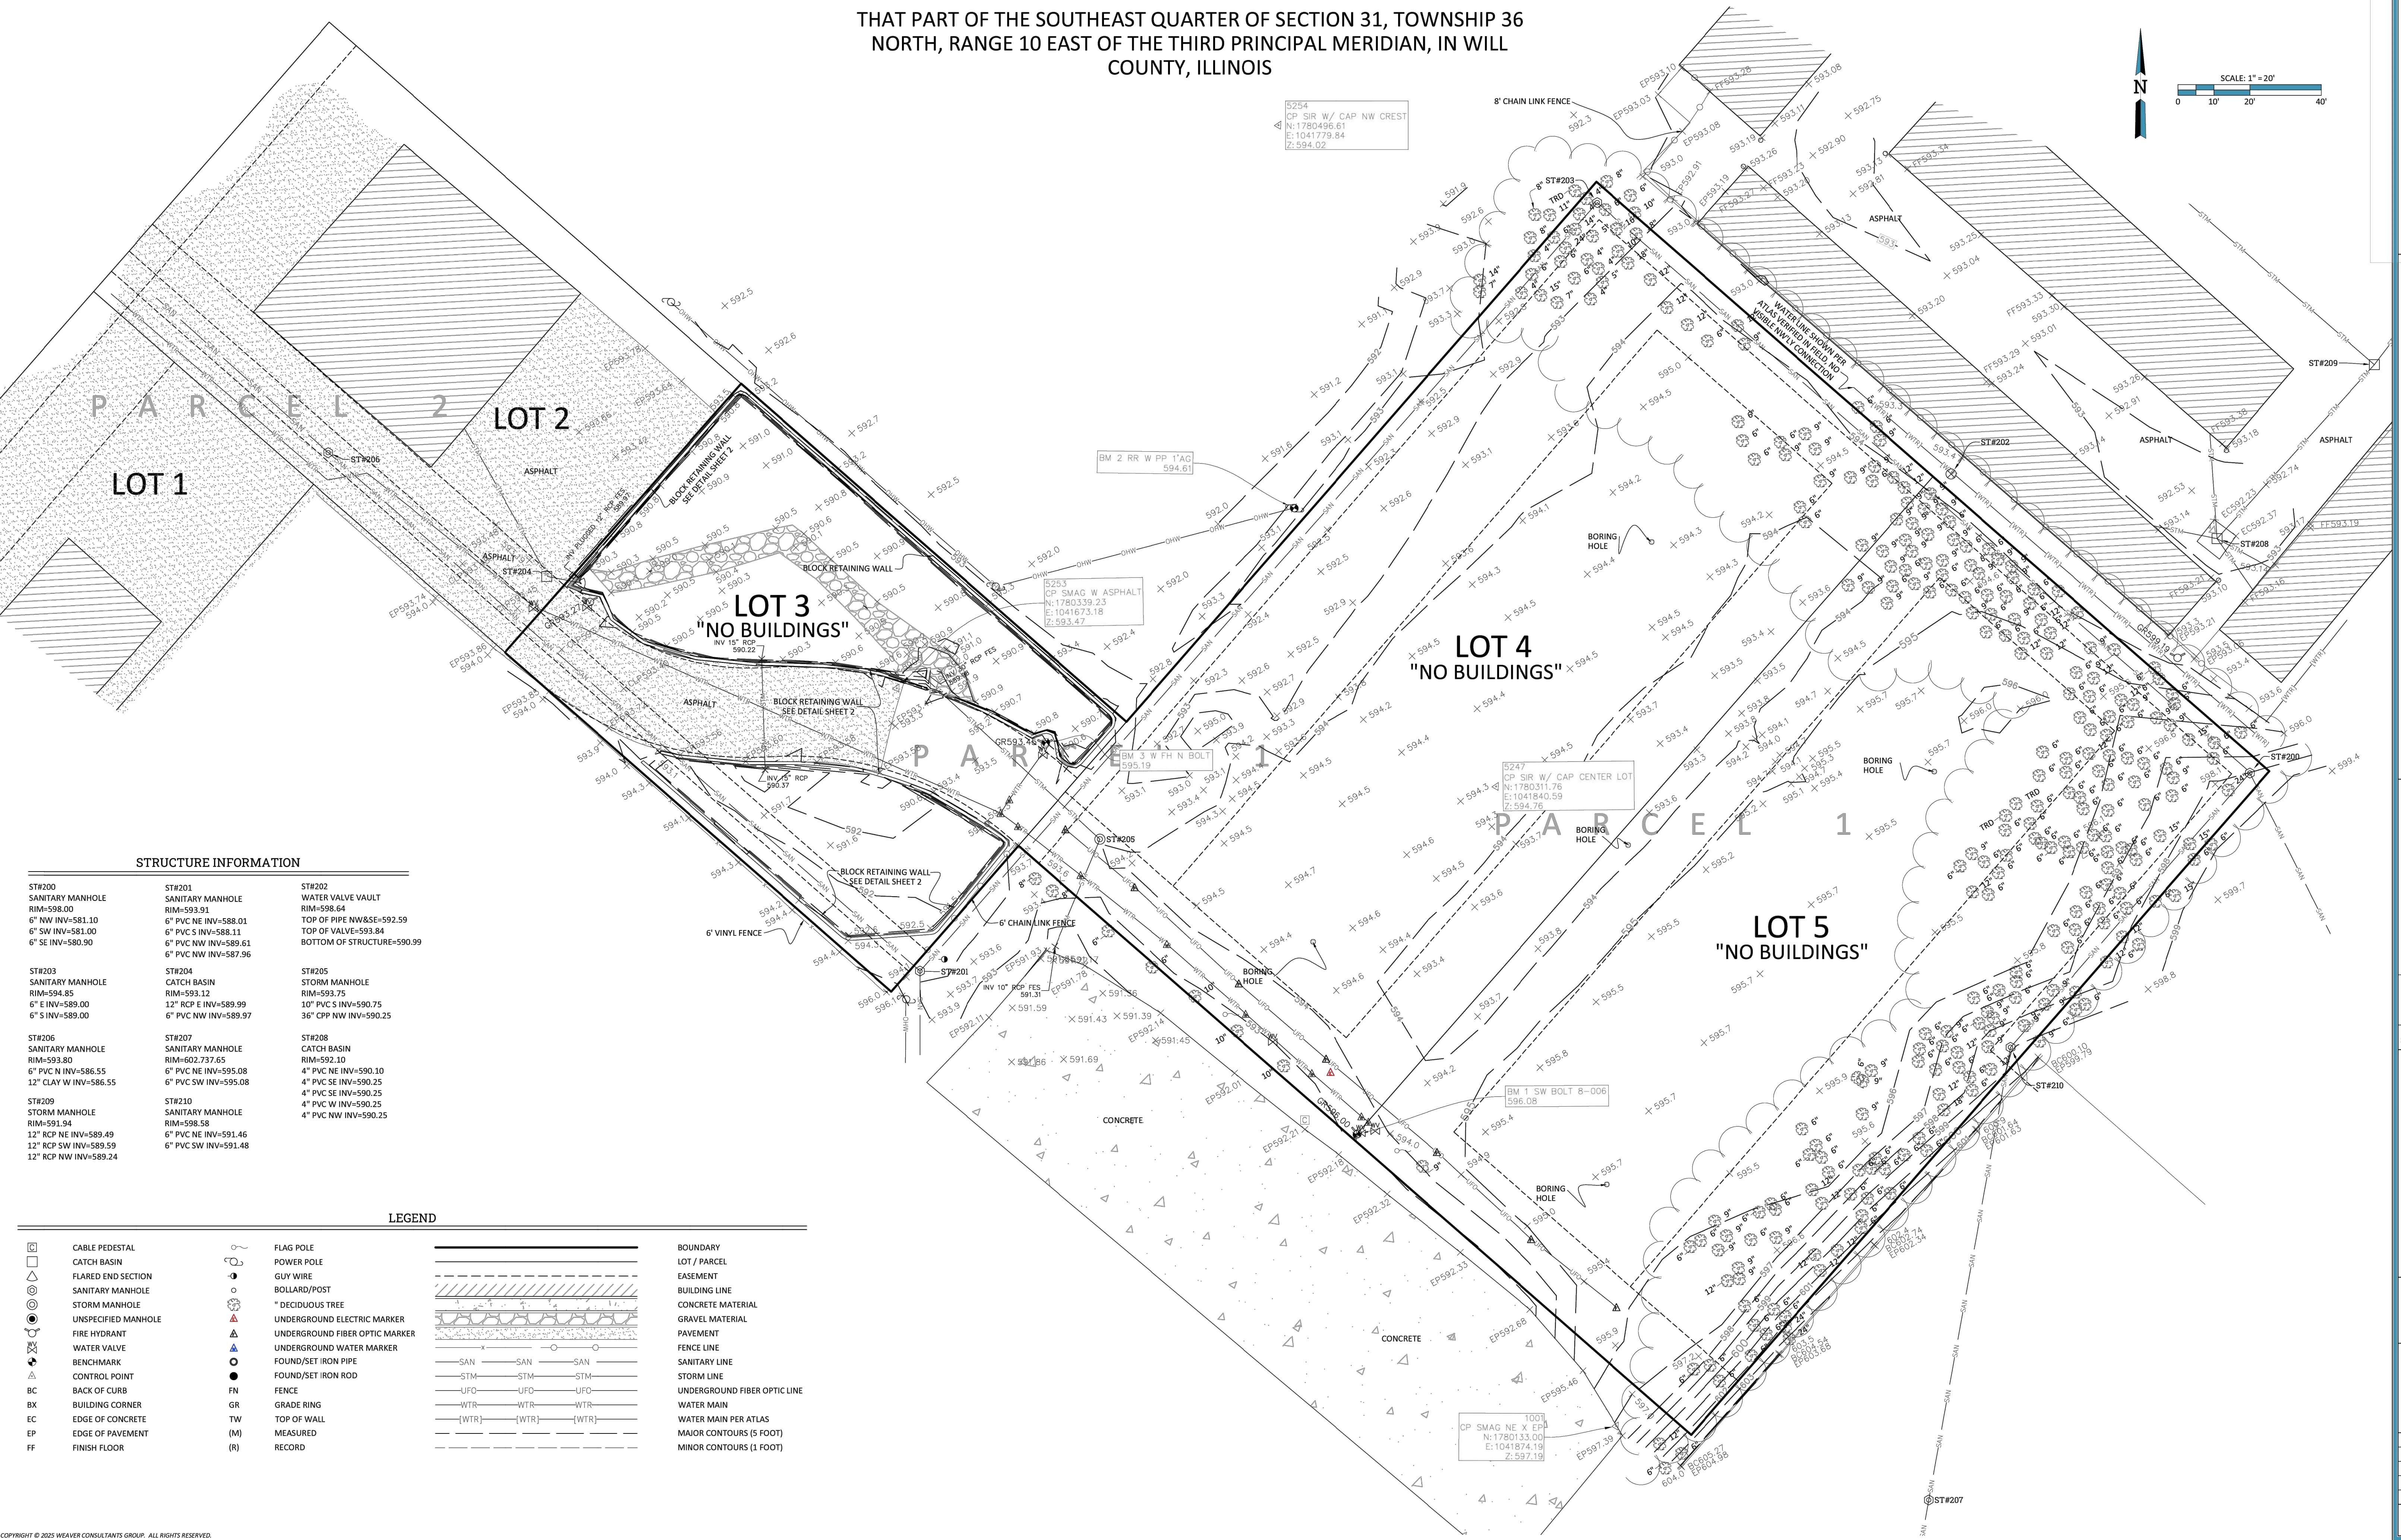

ALTA/NSPS LAND TITLE & TOPOGRAPHIC SURVEY

THAT PART OF THE SOUTHEAST QUARTER OF SECTION 31, TOWNSHIP 36
NORTH, RANGE 10 EAST OF THE THIRD PRINCIPAL MERIDIAN, IN WILL
COUNTY, ILLINOIS

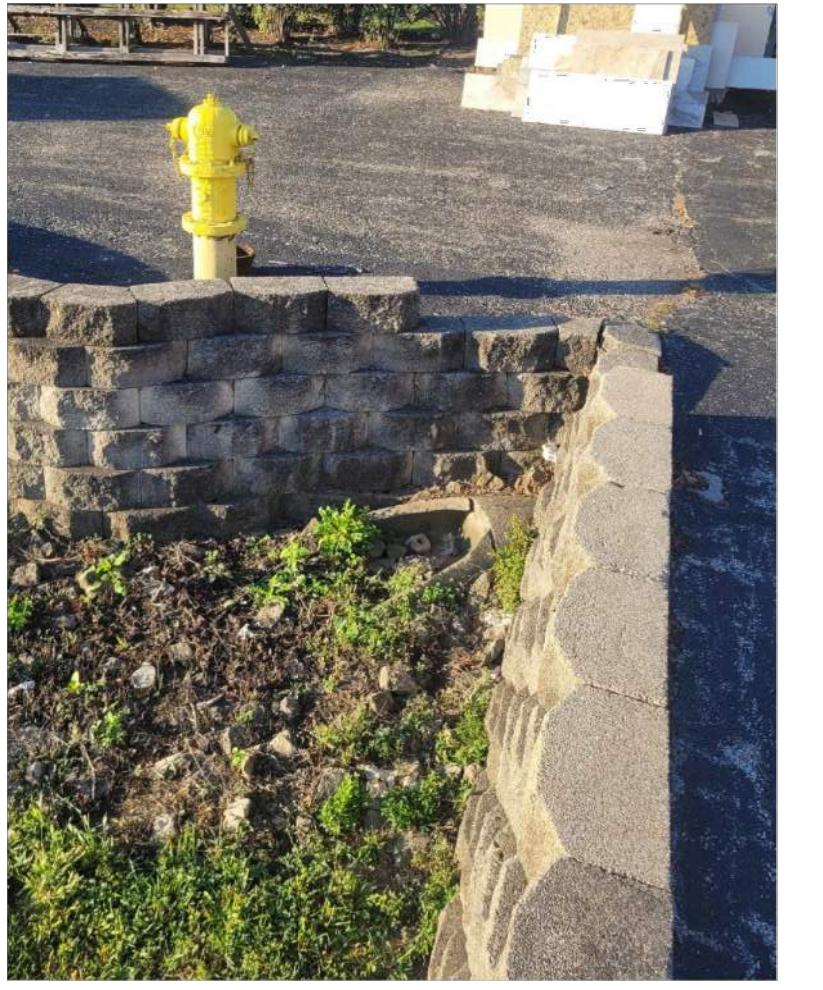

FES FROM STRUCTURE #204


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PARCEL 3 PIN: 11-04-31-407-008-0000
PARCEL 4 PIN: 11-04-31-407-009-0000
PARCEL 5 PIN: 11-04-31-407-010-0000

SCALE: 1" = 10'
0 5' 10' 20'

PREPARED FOR:

Horn

ALTA/NSPS LAND TITLE & TOPOGRAPHIC SURVEY
EXTRA SPACE STORAGE
CREST HILL, IL

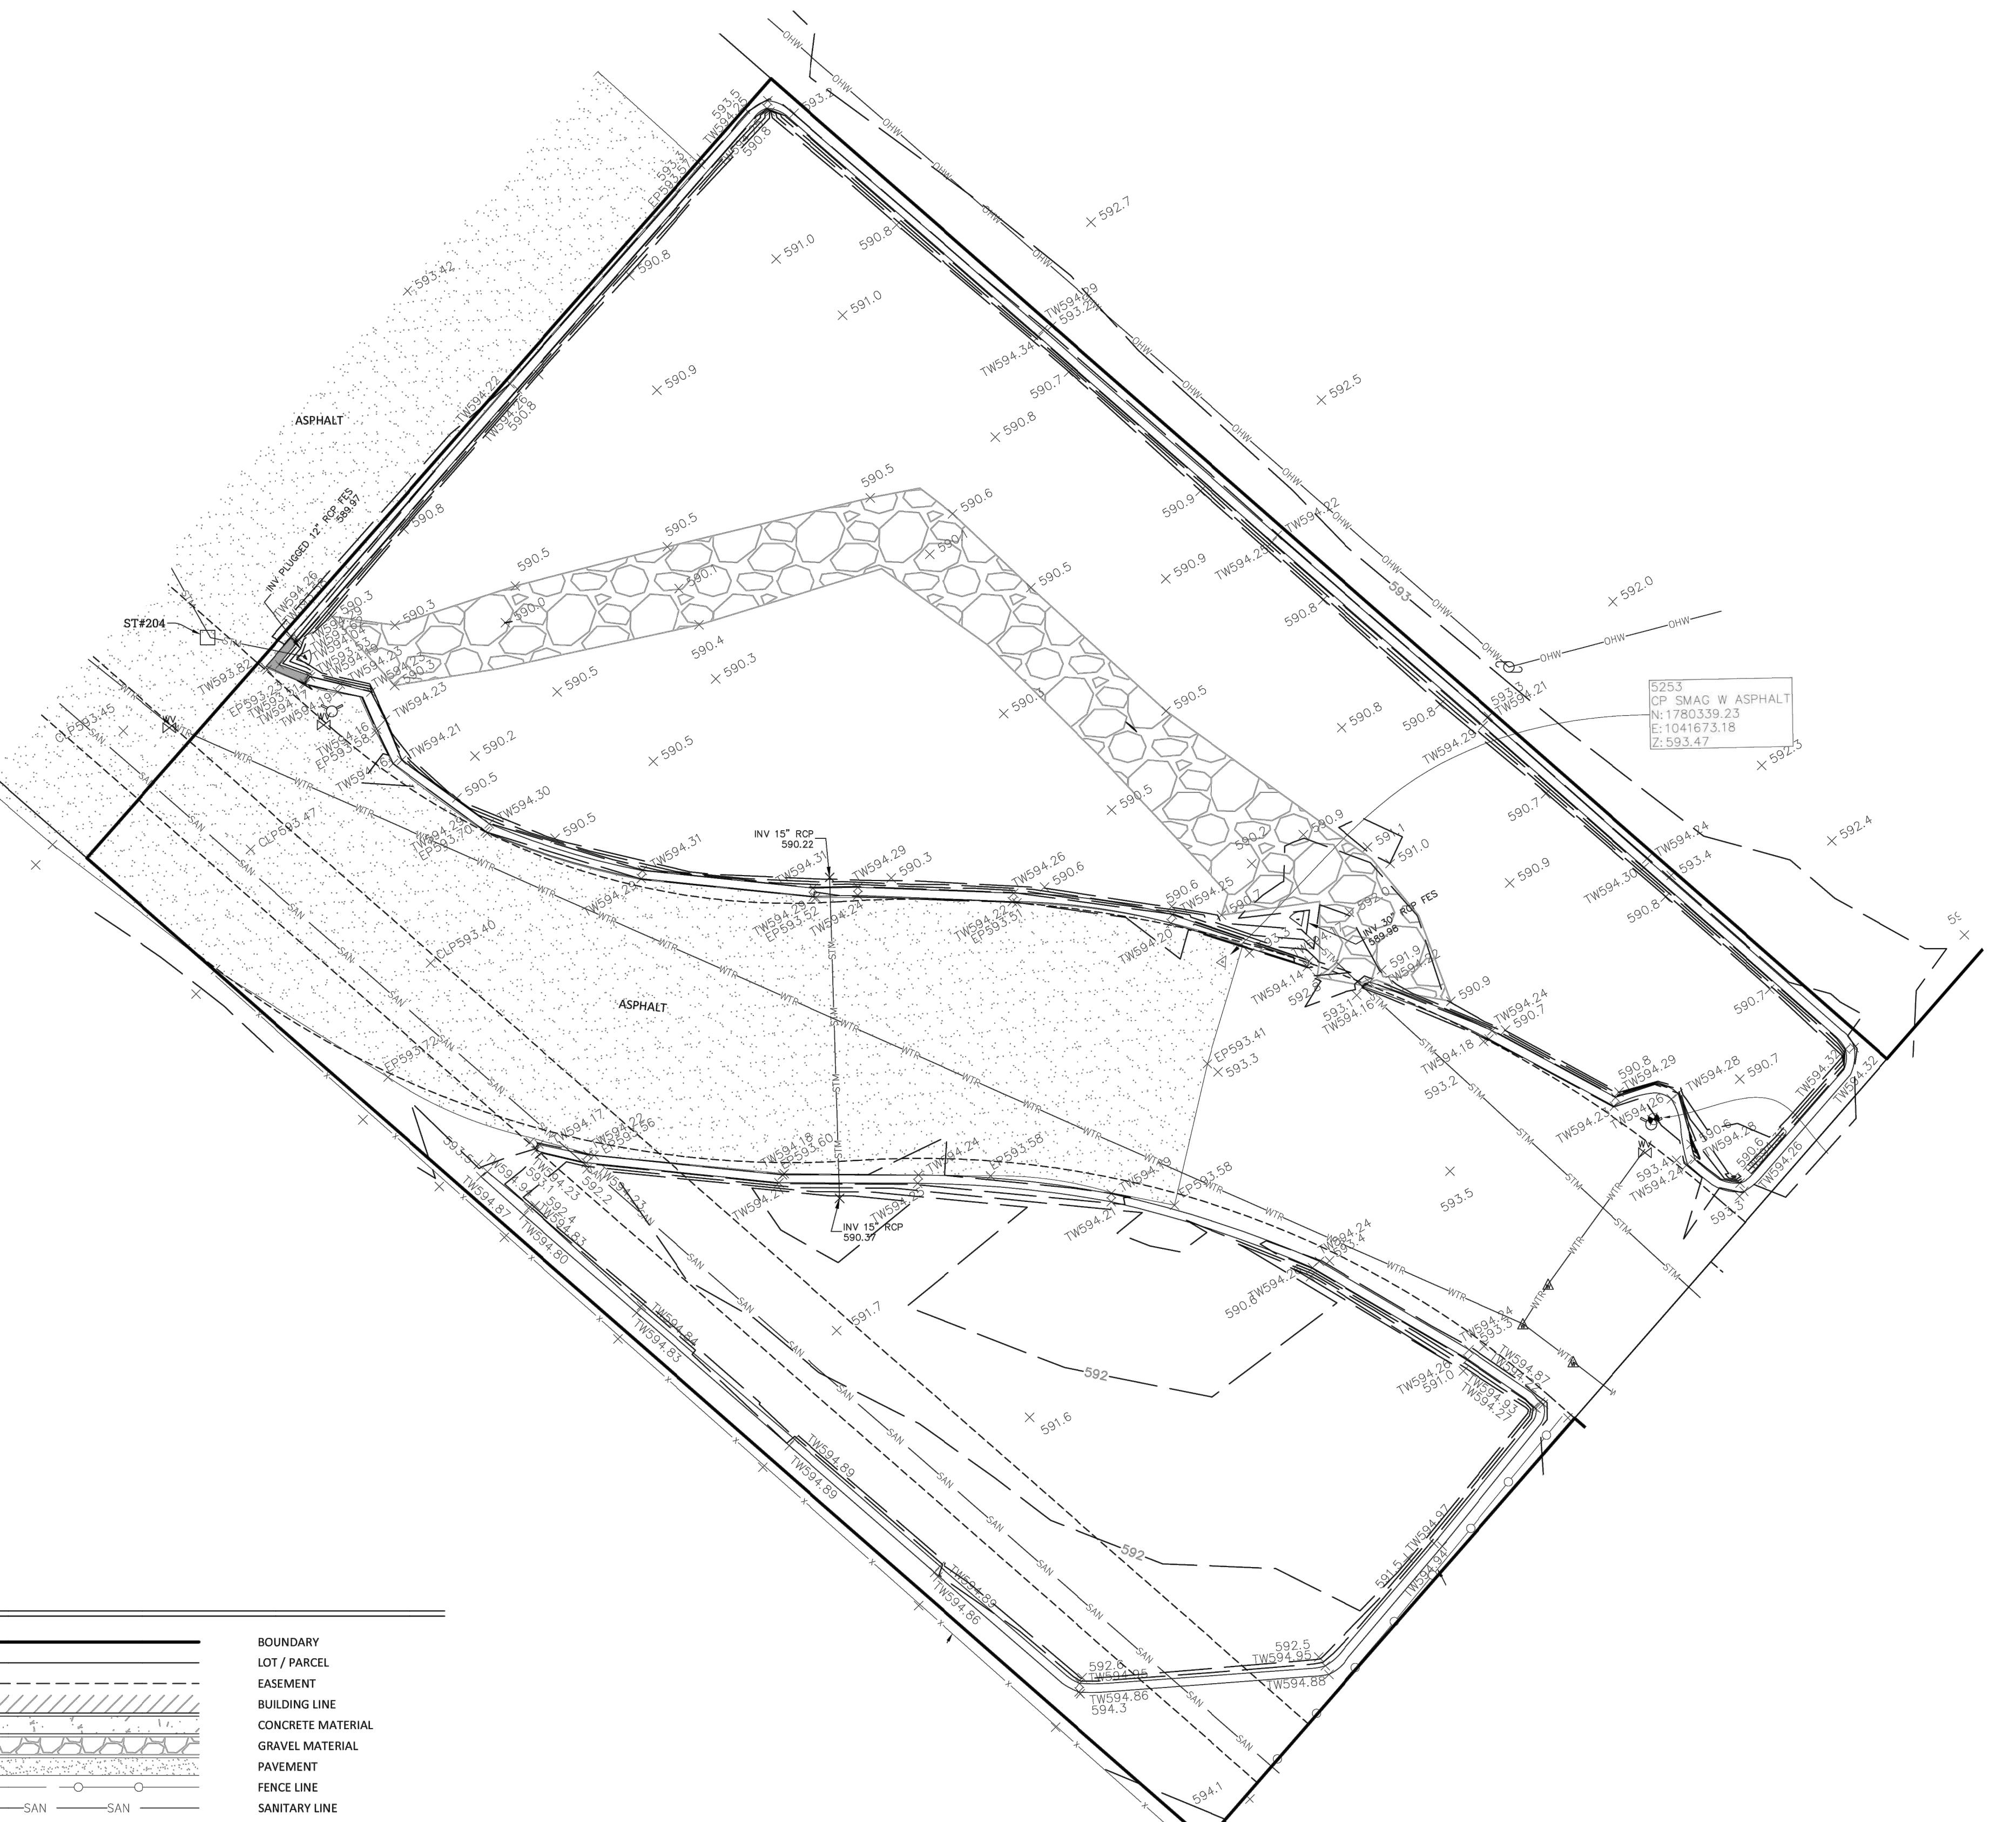

Weaver
Consultants
Group



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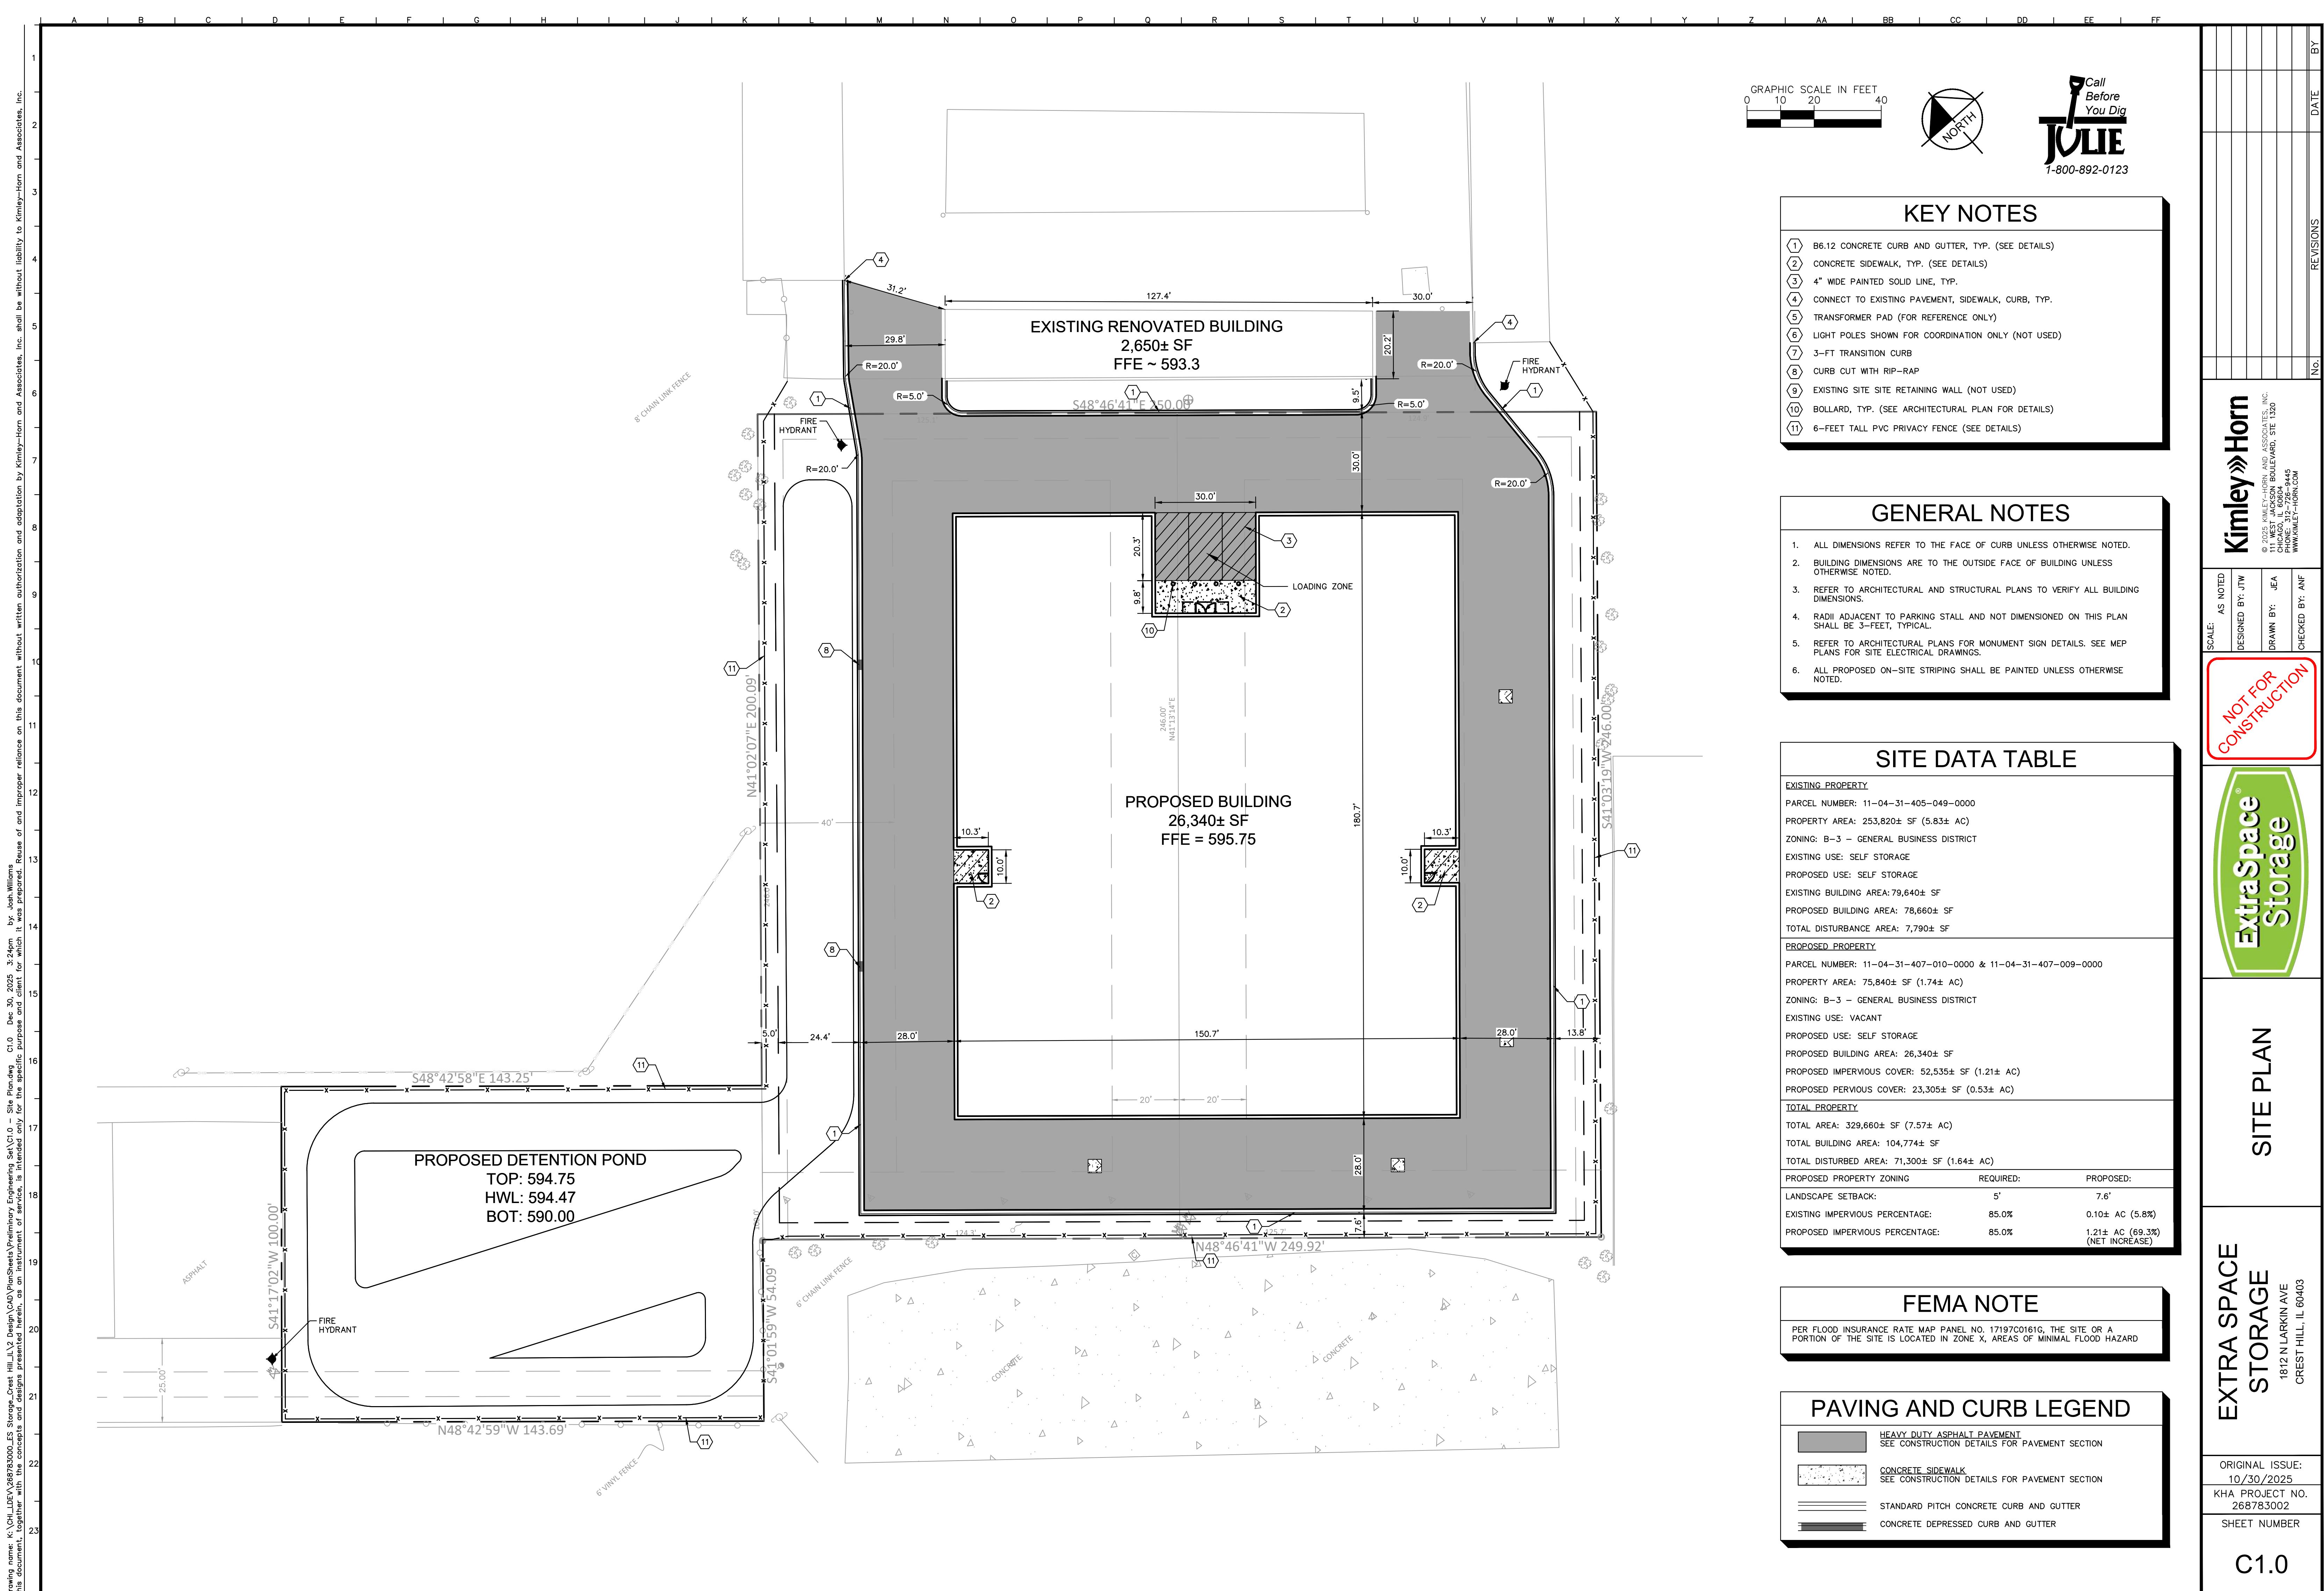
REVIEWED BY: JTB




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FILE: 8077-363 2025 09 29.dwg

SHEET 2 OF 2

V0.3



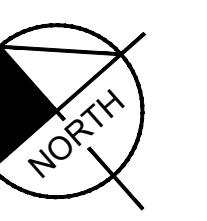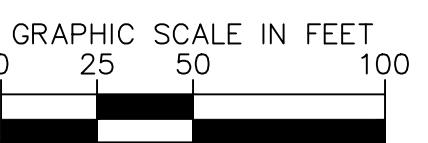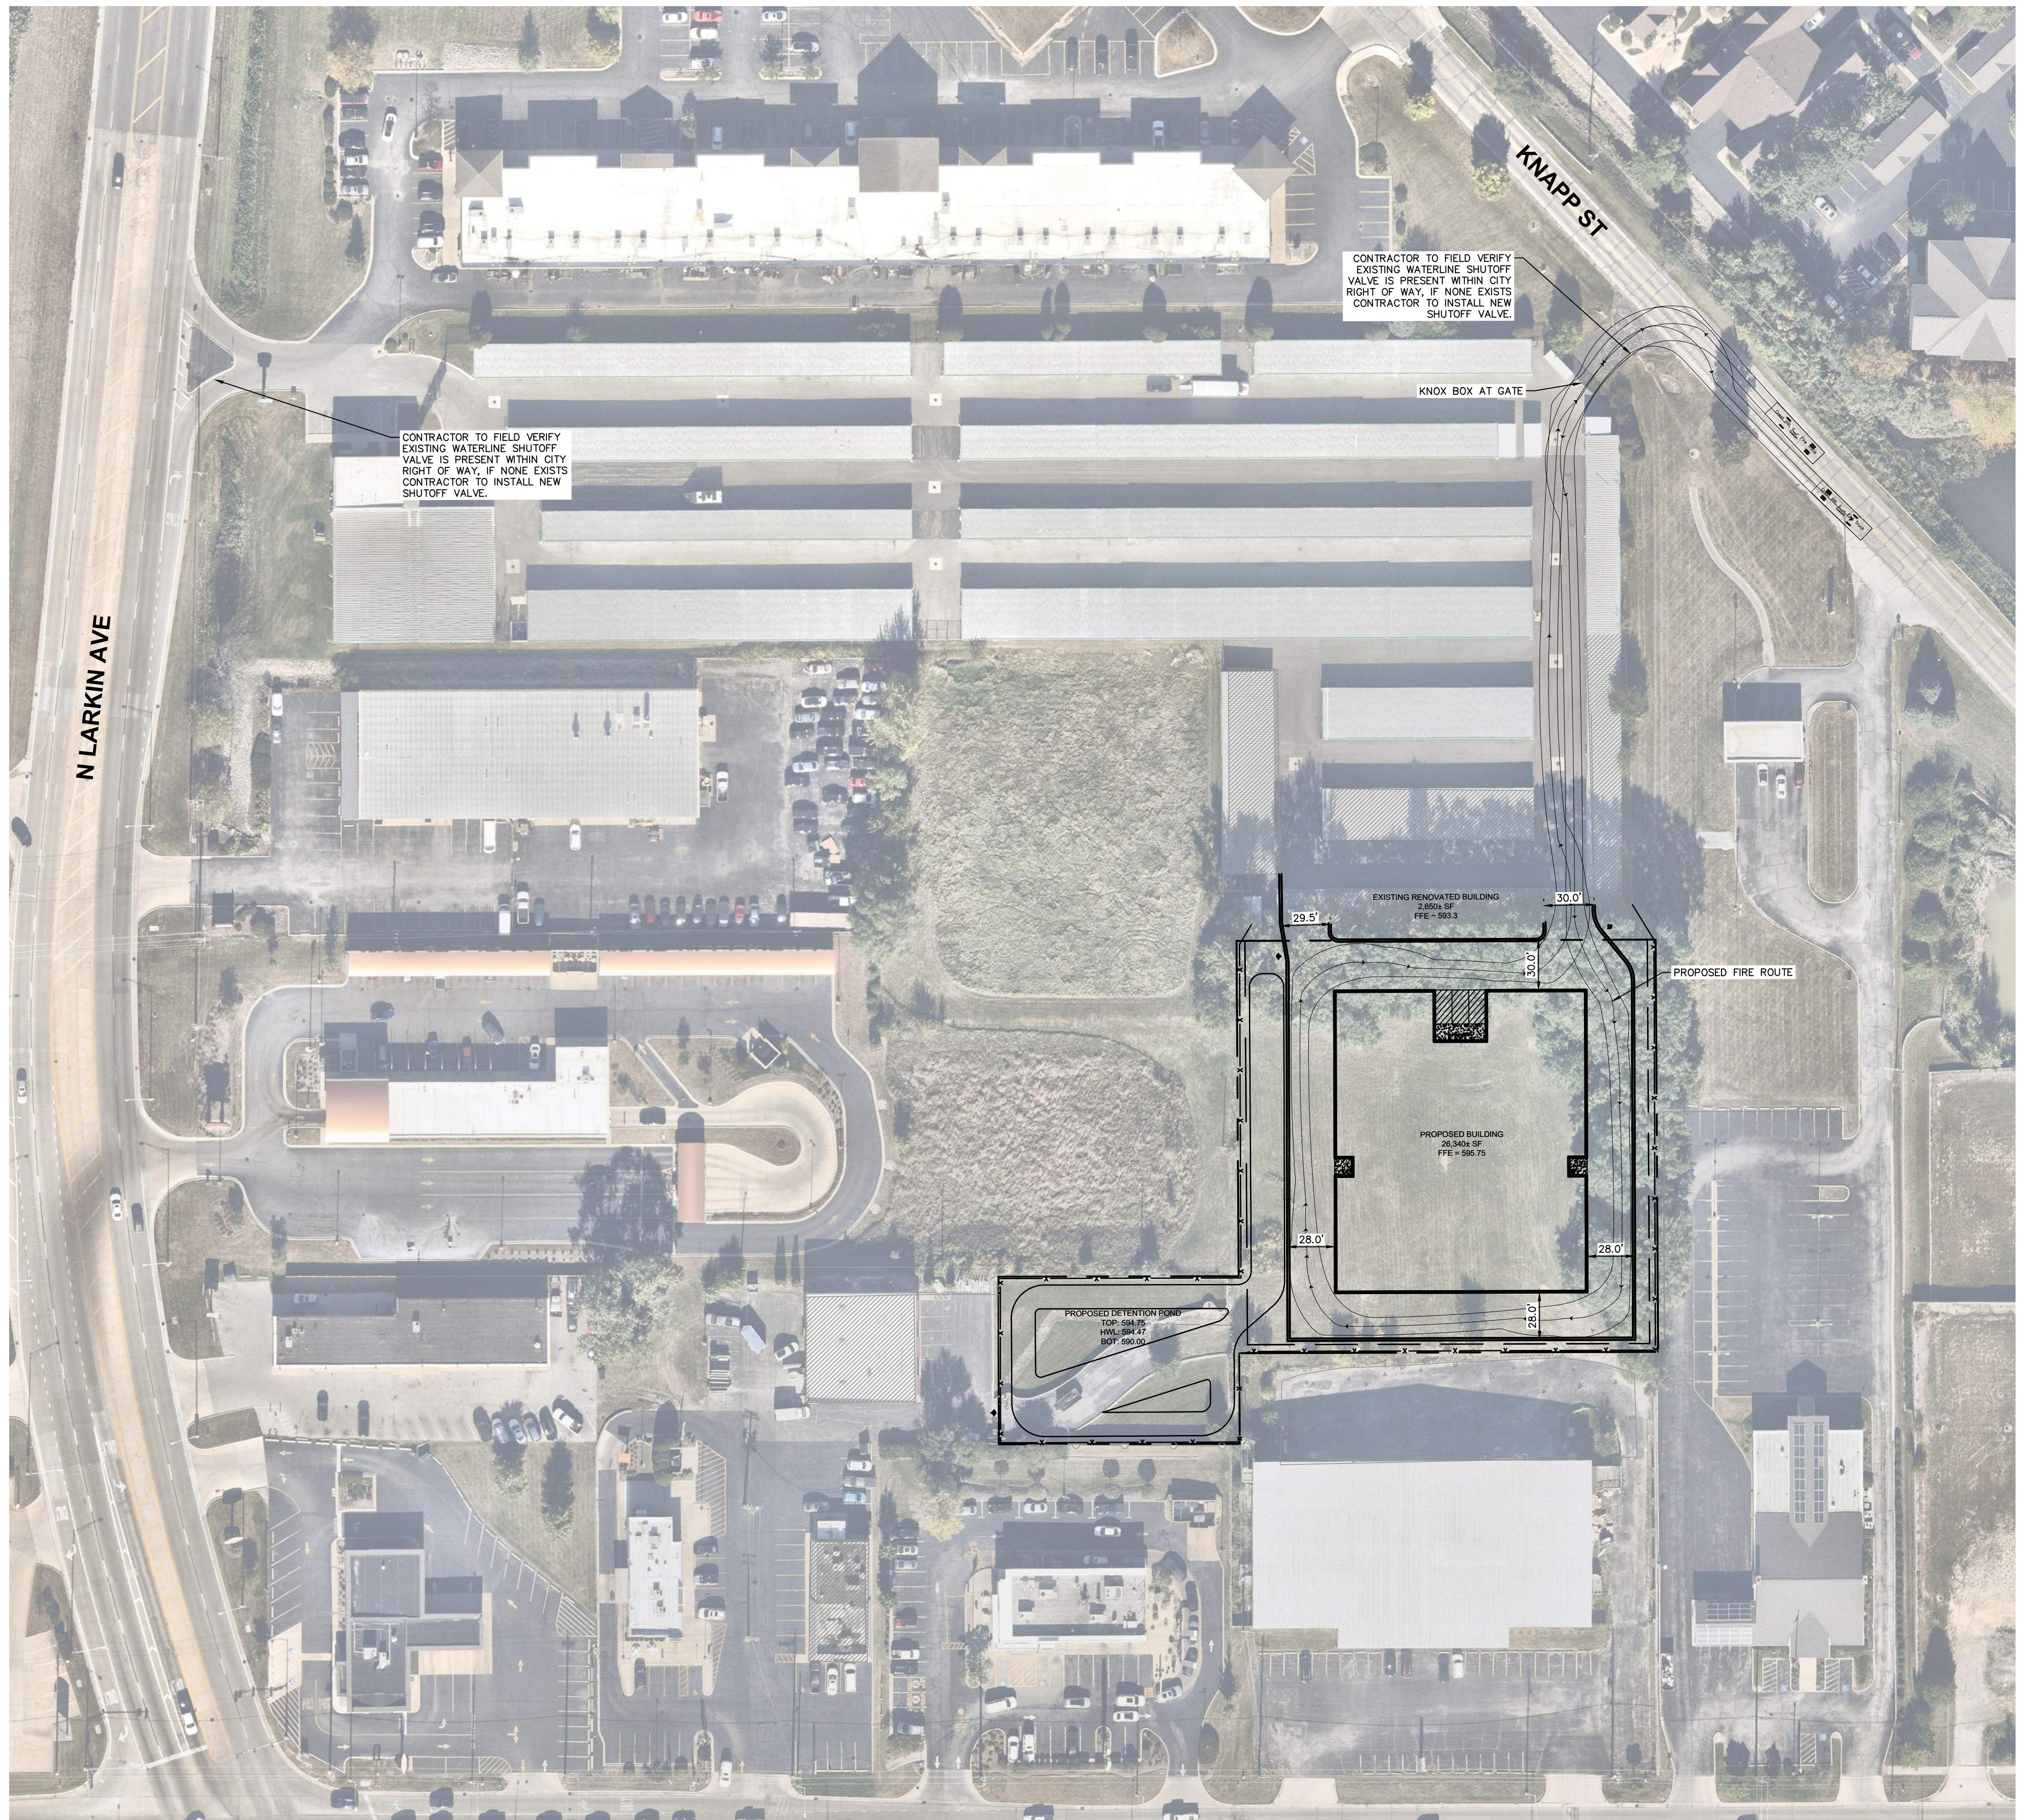

Call
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GENERAL NOTES


1. ALL DIMENSIONS REFER TO THE FACE OF CURB UNLESS OTHERWISE NOTED.
2. BUILDING DIMENSIONS ARE TO THE OUTSIDE FACE OF BUILDING UNLESS OTHERWISE NOTED.
3. REFER TO ARCHITECTURAL AND STRUCTURAL PLANS TO VERIFY ALL BUILDING DIMENSIONS.
4. RADII ADJACENT TO PARKING STALL AND NOT DIMENSIONED ON THIS PLAN SHALL BE 3-FEET, TYPICAL.
5. REFER TO ARCHITECTURAL PLANS FOR MONUMENT SIGN DETAILS. SEE MEP PLANS FOR SITE ELECTRICAL DRAWINGS.
6. ALL PROPOSED ON-SITE STRIPING SHALL BE PAINTED UNLESS OTHERWISE NOTED.

SITE DATA TABLE

EXISTING PROPERTY		
PARCEL NUMBER:	11-04-31-405-049-0000	
PROPERTY AREA:	253,820± SF (5.83± AC)	
ZONING:	B-3 – GENERAL BUSINESS DISTRICT	
EXISTING USE:	SELF STORAGE	
PROPOSED USE:	SELF STORAGE	
EXISTING BUILDING AREA:	79,640± SF	
PROPOSED BUILDING AREA:	78,660± SF	
TOTAL DISTURBANCE AREA:	7,790± SF	
PROPOSED PROPERTY		
PARCEL NUMBER:	11-04-31-407-010-0000 & 11-04-31-407-009-0000	
PROPERTY AREA:	75,840± SF (1.74± AC)	
ZONING:	B-3 – GENERAL BUSINESS DISTRICT	
EXISTING USE:	VACANT	
PROPOSED USE:	SELF STORAGE	
PROPOSED BUILDING AREA:	26,340± SF	
PROPOSED IMPERVIOUS COVER:	52,535± SF (1.21± AC)	
PROPOSED PERVIOUS COVER:	23,305± SF (0.53± AC)	
TOTAL PROPERTY		
TOTAL AREA:	329,660± SF (7.57± AC)	
TOTAL BUILDING AREA:	104,774± SF	
TOTAL DISTURBED AREA:	71,300± SF (1.64± AC)	
PROPOSED PROPERTY ZONING		
REQUIRED:		PROPOSED:
LANDSCAPE SETBACK:	5'	7.6'
EXISTING IMPERVIOUS PERCENTAGE:	85.0%	0.10± AC (5.8%)
PROPOSED IMPERVIOUS PERCENTAGE:	85.0%	1.21± AC (69.3%) (NET INCREASE)

FEMA NOTE

PER FLOOD INSURANCE RATE MAP PANEL NO. 17197C00161G, THE SITE OR A PORTION OF THE SITE IS LOCATED IN ZONE X, AREAS OF 100-YEAR FLOODING WITH A BASE FLOOD ELEVATION OF XXX.

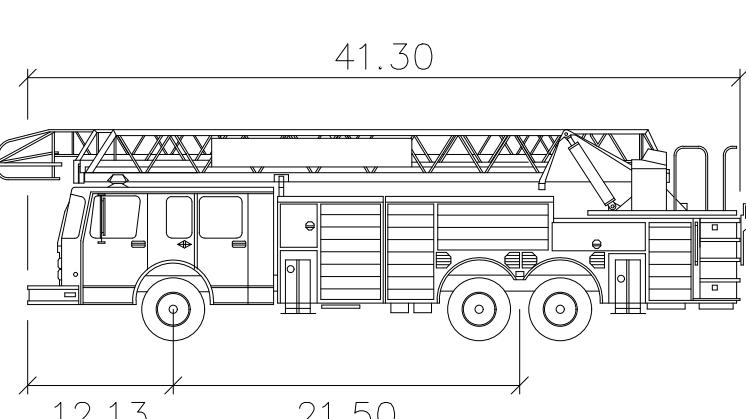

Crest Hill, IL – Fire Truck
feet

Width : 9.88
Track : 6.91
Lock to Lock Time : 6.0
Steering Angle : 40.0

CREST HILL TRUCK PROFILE
N.T.S.

EXTRA SPACE
STORAGE
1812 N LARKIN AVE
CREST HILL, IL 60403

ORIGINAL ISSUE:
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KHA PROJECT NO.
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SHEET NUMBER

C1.1

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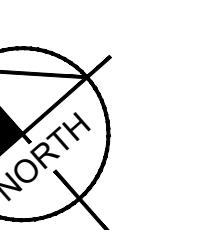
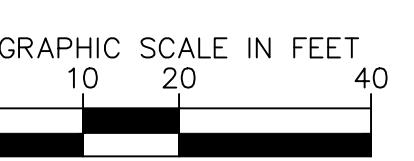
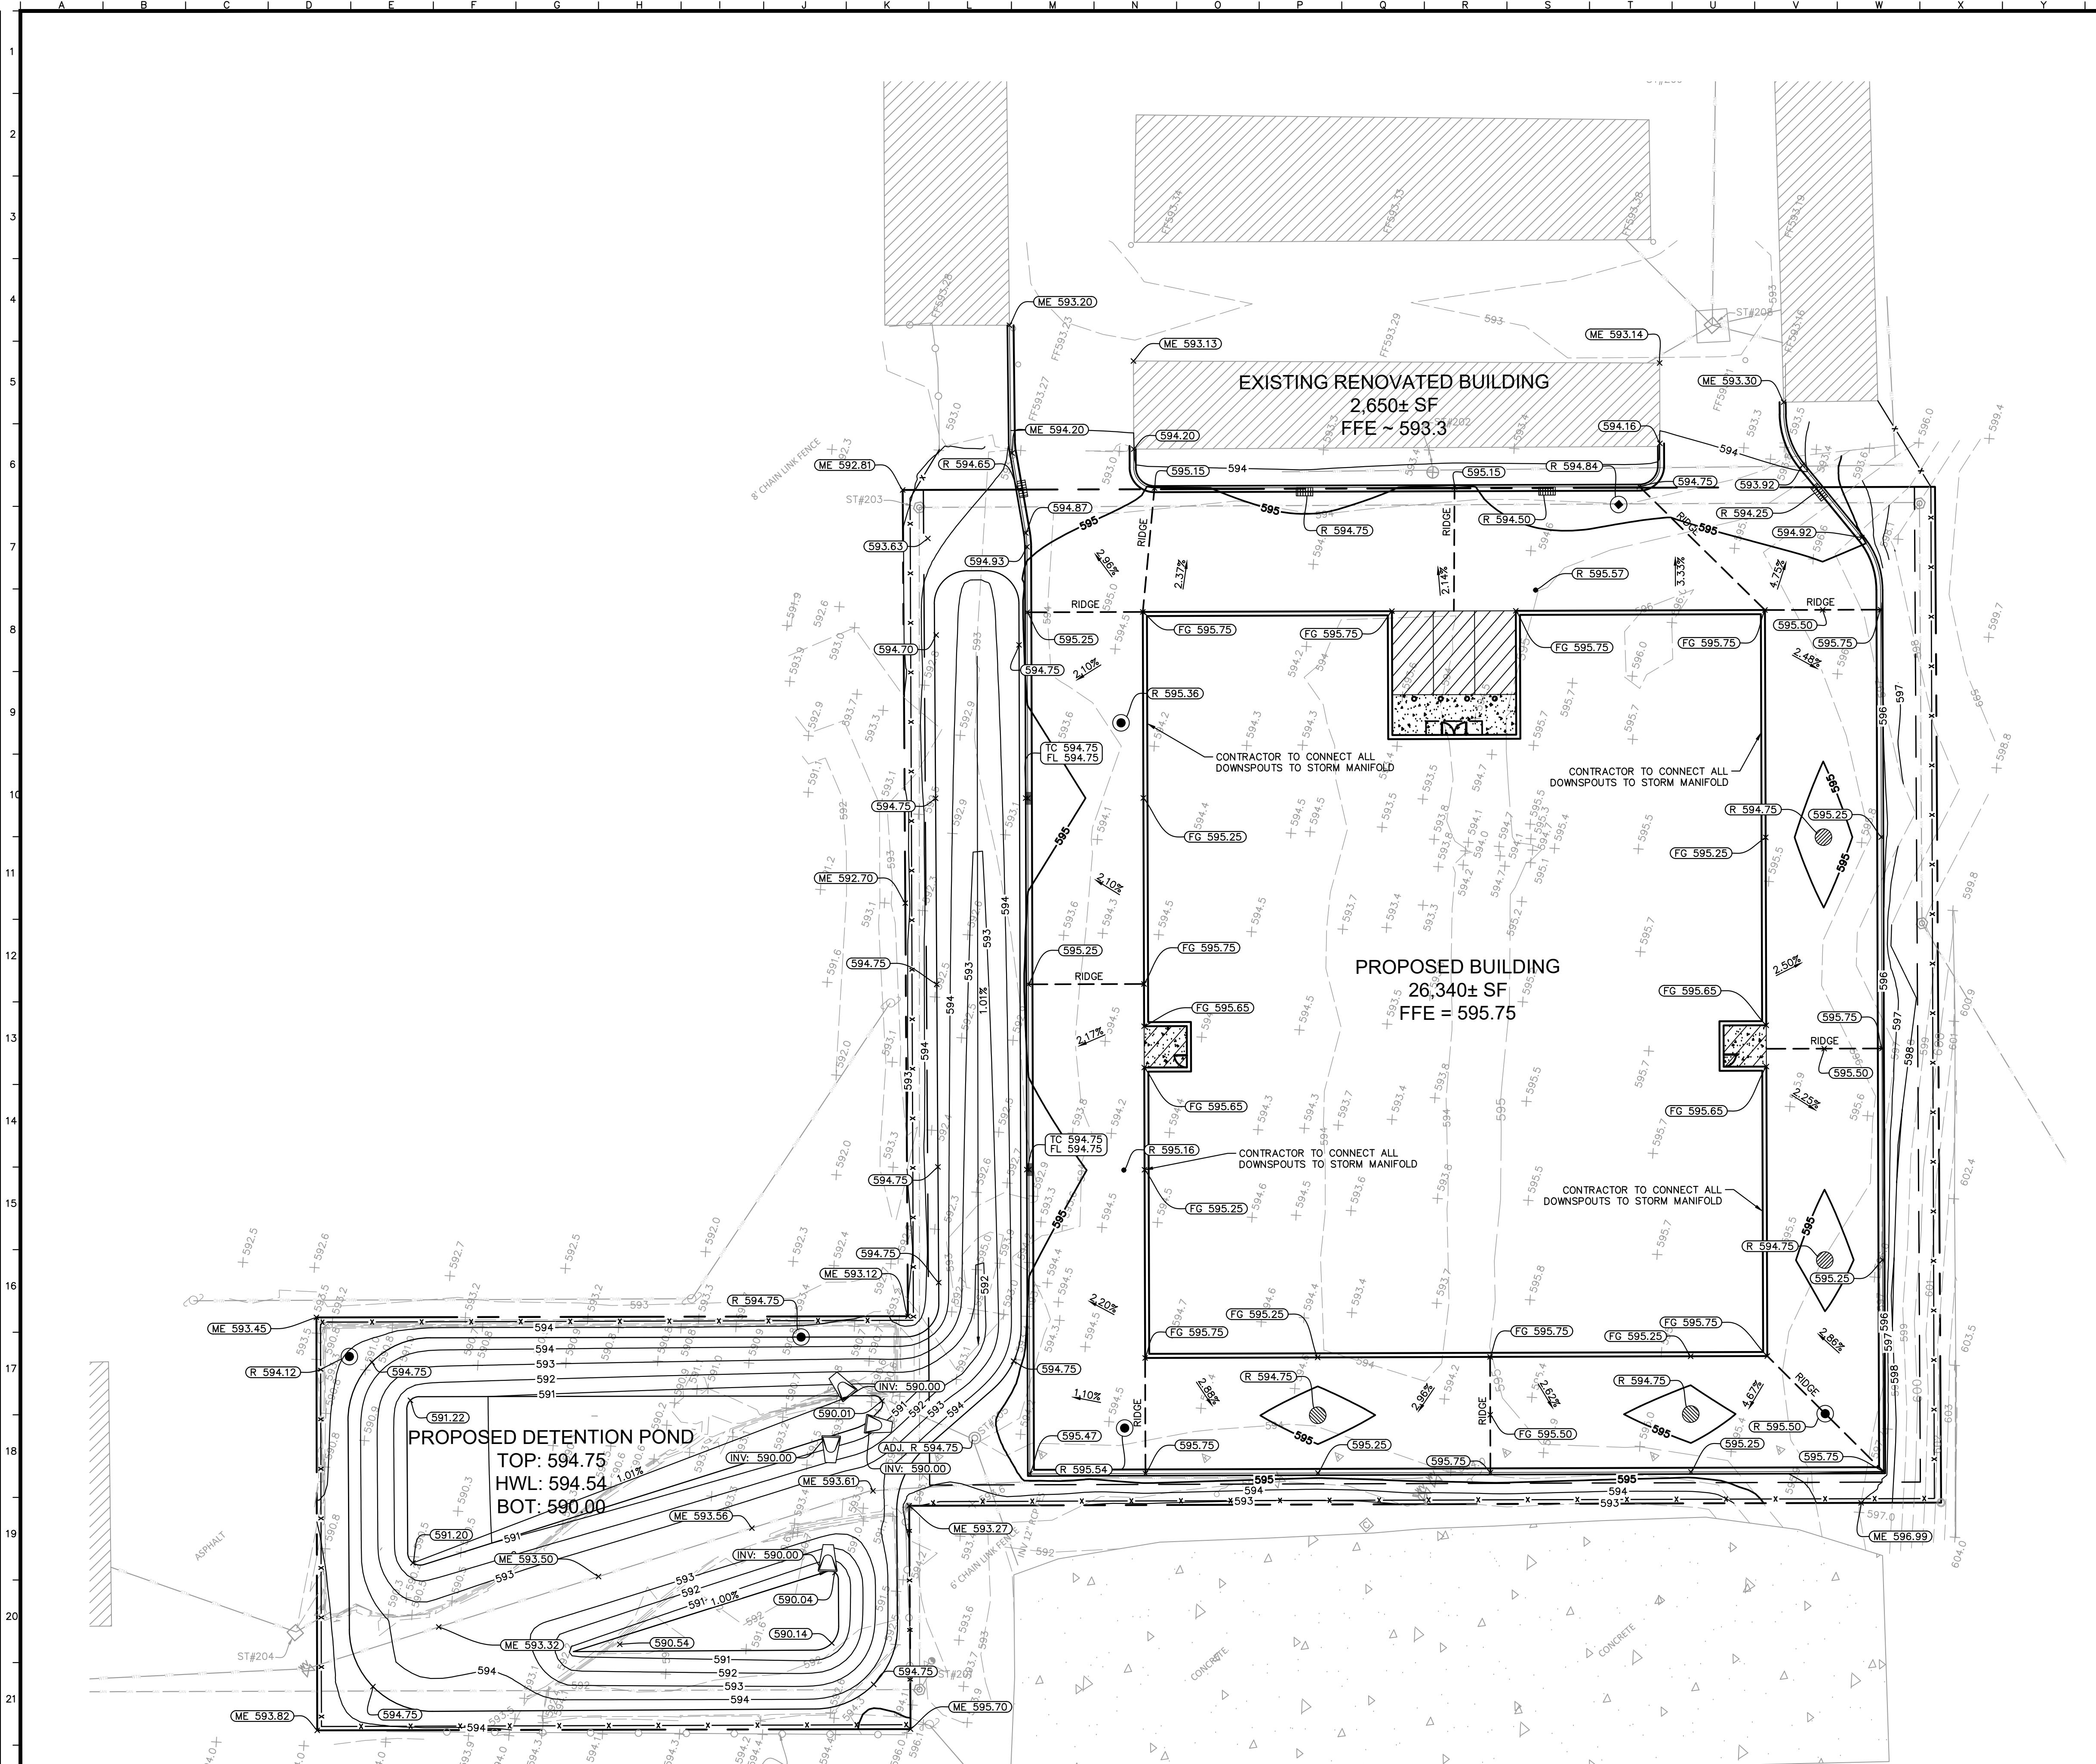
ExtraSpace
Storage

FIRE TRUCK
TURN PLAN

Kimley»Horn
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111 WEST JACKSON BOULEVARD, STE 1320
CHICAGO, IL 60606-3445
WWW.KIMLEY-HORN.COM

BY

REVISIONS
No.



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1-800-892-0123

GRADING NOTES

1. CONTRACTOR TO VERIFY ALL EXISTING TOPOGRAPHY AND STRUCTURES ON THE SITE AND IMMEDIATELY NOTIFY THE ENGINEER OF ANY DISCREPANCIES PRIOR TO STARTING WORK.
2. ALL PAVEMENT SPOT GRADE ELEVATIONS AND RIM ELEVATIONS WITHIN OR ALONG CURB AND GUTTER REFER TO FLOW LINE ELEVATIONS UNLESS OTHERWISE NOTED.
3. ALL ELEVATIONS SHOWN DEPICT FINISHED GRADE UNLESS OTHERWISE NOTED. GENERAL CONTRACTOR TO COORDINATE WITH EXCAVATION, LANDSCAPE AND PAVING SUBCONTRACTORS REGARDING TOPSOIL THICKNESS FOR LANDSCAPE AREAS AND PAVEMENT SETBACK THICKNESS FOR PAVED AREAS TO PROPERLY ENSURE ADEQUATE CUT TO ESTABLISH SUBGRADE ELEVATIONS.
4. NO EARTHEN SLOPE SHALL BE GREATER THAN 3:1, UNLESS OTHERWISE NOTED.
5. MAXIMUM SLOPE IN ACCESSIBLE PARKING SPACES AND LOADING ZONES SHALL NOT EXCEED 2.0% IN ALL DIRECTIONS.
6. MAXIMUM RUNNING SLOPE SHALL NOT EXCEED 5% AND CROSS SLOPE SHALL NOT EXCEED 2% ON ALL SIDEWALKS AND ACCESSIBLE ROUTES.
7. WHEN NATURAL FLOW OF DRAINAGE IS AWAY FROM CURB, CONTRACTOR TO INSTALL REVERSE GUTTER PITCH.
8. MATCH EXISTING ELEVATIONS AT THE PROPERTY LIMITS.

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 111 WEST JACKSON BOULEVARD, STE 1320
 CHICAGO, IL 60606-3445
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EXTRA SPACE STORAGE

1812 N LARKIN AVE
 CREST HILL, IL 60403

ORIGINAL ISSUE:
 10/30/2025
 KHA PROJECT NO.
 268783002
 SHEET NUMBER

C2.0

GRADING LEGEND


TP = TOP OF PAVEMENT
EP = EDGE OF PAVEMENT
FL = FLOW LINE
TC = TOP OF CURB
TF = TOP OF FOUNDATION
R = RIM ELEVATION
TW = TOP OF WALL
FG = FINISHED GRADE
TS = TOP OF STAIRS
BS = BOTTOM OF STAIRS
ME = MATCH ELEVATION
(CONTRACTOR TO VERIFY ALL MATCH EXISTING SPOT GRADE ELEVATIONS AND IMMEDIATELY NOTIFY THE ENGINEER OF ANY DISCREPANCIES.)
— XXX — PROPOSED CONTOUR
— XXX — EXISTING CONTOUR
— RIDGE — RIDGE LINE
X XXX SLOPE AND FLOW DIRECTION
— 100% — 100-YEAR OVERLAND OVERFLOW ROUTE
— — — DETENTION BASIN 100-YEAR EMERGENCY OVERLAND OVERFLOW ROUTE
— — — PROPOSED SWALE
— — — REVERSED PITCH CURB AND GUTTER
— — — ACCESSIBLE ROUTE
— — — RIP RAP (SEE DETAILS)

REVISIONS
 No. DATE BY

STORM STRUCTURE TABLE

STRUCTURE NAME:	DETAILS:
D1	CONNECT TO EXISTING STORM STRUCTURE RIM: 591.17 INV OUT: 590.00 (NE, 12") INV OUT: 589.97 (NW, 6")
D2	4' DIA. STORM MH WITH CLOSED LID RIM: 594.12 INV IN: 590.00 (SW, 12") INV OUT: 590.00 (SE, 12")
D3	OUTLET CONTROL STRUCTURE RIM: 594.75 INV IN: 590.00 (NW, 12") INV OUT: 590.00 (S, 12")
D6	EX. STORM STRUCTURE #205 CONTRACTOR TO RAISE RIM TO PROPOSED GRADE, SEE SHEET C2.0 FOR DETAILS. RIM: 594.75 INV IN: 590.25 (SE, 18") INV IN: 590.75 (SW, 12") INV OUT: 590.25 (NW, 24")
D7	4' DIA. STORM MH WITH OPEN LID RIM: 594.75 INV IN: 590.42 (SE, 15") INV OUT: 590.42 (NW, 18")
D8	4' DIA. STORM MH WITH OPEN LID RIM: 594.75 INV IN: 590.66 (SE, 12") INV OUT: 590.63 (NW, 15")
D9	4' DIA. STORM MH WITH CLOSED LID RIM: 595.50 INV IN: 590.77 (NE, 12") INV OUT: 590.77 (NW, 12")
D10	4' DIA. STORM MH WITH OPEN LID RIM: 594.75 INV IN: 590.89 (NE, 12") INV OUT: 590.89 (SW, 12")

STORM STRUCTURE TABLE	
STRUCTURE NAME:	DETAILS:
D11	4' DIA. STORM MH WITH OPEN LID RIM: 594.75 INV IN: 591.21 (NE, 12") INV OUT: 591.21 (SW, 12")
D12	4' DIA. STORM MH WITH CURB INLET RIM: 594.25 INV IN: 591.48 (NW, 12") INV OUT: 591.48 (SW, 12")
D13	2' DIA. STORM INLET WITH CURB GRATE RIM: 594.50 INV OUT: 591.70 (SE, 12")
D16	4' DIA. STORM MH WITH CLOSED LID RIM: 595.54 INV IN: 590.32 (SE, 18") INV IN: 590.32 (NE, 12") INV OUT: 590.32 (NW, 18")
D17	6" CLEANOUT RIM: 595.16 INV IN: 590.52 (SE, 12") INV IN: 590.52 (NE, 12") INV OUT: 590.52 (SW, 12")
D18	4' DIA. STORM MH WITH CLOSED LID RIM: 595.36 INV IN: 590.87 (SE, 12") INV IN: 590.87 (N, 12") INV OUT: 590.87 (SW, 12")
D19	4' DIA. STORM MH WITH CURB INLET RIM: 594.65 INV IN: 591.07 (SE, 8") INV OUT: 591.07 (S, 12")
D20	2' DIA. STORM INLET WITH CURB GRATE RIM: 594.75 INV OUT: 591.44 (NW, 8")

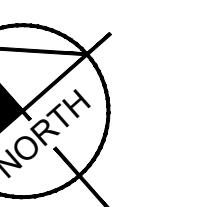

Kimley Horn

UTILITY PLAN

EXTRA SPACE STORAGE

C3.0

UTILITY NOTES

TER LINES \geq 3" SHALL BE DUCTILE IRON PIPE, CLASS 52.

ITARY SEWER LINES SHALL BE PVC MEETING, ASTM D-3034 SDR 26 FOR SANITARY SEWER THAT CROSSES ABOVE WATER MAIN, THIS PIPE E AWWA C900 (UNLESS WATER MAIN CASING IS UTILIZED). PROVIDE MUM COVER.

CTOR SHALL COORDINATE ANY DISRUPTIONS TO EXISTING UTILITY S WITH ADJACENT PROPERTY OWNERS.

CTRIC AND TELEPHONE EXTENSIONS INCLUDING SERVICE LINES SHALL TRUCTED TO THE APPROPRIATE UTILITY COMPANY SPECIFICATIONS. UTILITY DISCONNECTIONS SHALL BE COORDINATED WITH THE DESIGNATED COMPANIES.

CTION SHALL NOT START ON ANY PUBLIC UTILITY SYSTEM UNTIL APPROVAL HAS BEEN RECEIVED BY THE ENGINEER FROM THE RRIATE GOVERNING AUTHORITY AND CONTRACTOR HAS BEEN NOTIFIED ENGINEER.

CTOR TO CALL "JULIE" (1-800-892-0123) TO COORDINATE FIELD NS OF EXISTING UNDERGROUND UTILITIES BEFORE ORDERING MATERIALS MENCING CONSTRUCTION. NOTIFY ENGINEER OF ANY DISCREPANCIES ELY.

TO THE CONSTRUCTION OF OR CONNECTION TO ANY STORM DRAIN, Y SEWER, WATER MAIN OR ANY OTHER UTILITIES, THE CONTRACTOR XCAVATE, VERIFY AND CALCULATE ALL POINTS OF CONNECTION AND ITY CROSSINGS AND INFORM THE ENGINEER AND THE OWNER/ ER OF ANY CONFLICT OR REQUIRED DEVIATIONS FROM THE PLAN. TION SHALL BE MADE A MINIMUM OF 72 HOURS PRIOR TO UCTION. THE ENGINEER AND ITS CLIENTS SHALL BE HELD HARMLESS IN NT THAT THE CONTRACTOR FAILS TO MAKE SUCH NOTIFICATION. THE ALITY SHALL BE NOTIFIED OF ANY AND ALL CHANGES TO THE DESIGN

CTOR SHALL COMPLY COMPLETELY WITH THE LATEST STANDARDS OF RECTIVES OR ANY OTHER AGENCY HAVING JURISDICTION FOR TION AND TRENCHING PROCEDURES. THE CONTRACTOR SHALL USE T SYSTEMS, SLOPING, BENCHING AND OTHER MEANS OF PROTECTION. TO INCLUDE, BUT NOT LIMITED FOR ACCESS AND EGRESS FROM ALL TION AND TRENCHING. CONTRACTOR IS RESPONSIBLE FOR COMPLYING RFORMANCE CRITERIA AS REQUIRED BY OSHA.

CTOR TO AVOID DISRUPTION OF ANY ADJACENT TENANT'S TRAFFIC NS DURING INSTALLATION OF UTILITIES.

ENSIONS ARE TO CENTERLINE OF PIPE OR CENTER OF MANHOLE NOTED OTHERWISE.

HITECTURAL AND MEP PLANS FOR EXACT UTILITY CONNECTION NS AT BUILDING.

ODES SHOWN FOR COORDINATION PURPOSES ONLY AND DO NOT NT ACTUAL SIZE. SEE SITE LIGHTING PLANS BY OTHERS FOR MORE TION.

AILS FOR LOCATING STORM STRUCTURES WITHIN THE CURB LINE.

ATER FACILITIES MUST BE FUNCTIONAL BEFORE BUILDING CONSTRUCTION F REQUIRED BY AUTHORITY HAVING JURISDICTION.

SCALE:	AS NOTED
DESIGNED BY:	JTW
DRAWN BY:	JEA

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The logo for Extra Space Storage, featuring the brand name in a bold, white, sans-serif font. The word "Extra" is on the first line, "Space" is on the second line, and "Storage" is on the third line. A registered trademark symbol (®) is positioned above the "E" in "Extra". The entire logo is set against a light green background with a white decorative border.

PROPERTY LEGEND

—WTR—WTR—WTR—WTR—WTR—	EX. WATER LINE
	EX. HYDRANT
—SAN—SAN—CAN—SAN—CAN—SAN—	EX. WATER VALVE
	EX. SANITARY SEWER LINE
—STM—STM—STM—STM—STM—	EX. SANITARY SEWER MANHOLE
	EX. STORM DRAIN LINE
	EX. STORM MANHOLE
	EX. STORM STRUCTURE/INLET
—OHW—DHW—OHW—OHW—OHW—	EX. OVERHEAD ELECTRIC LINE
—JFO—JFO—JFO—JFO—JFO—	EX. UNDERGROUND TELEPHONE LINE
—ELEC—	PROPOSED UNDERGROUND ELECTRIC LINE
—GAS—	GAS LINE (BY GAS COMPANY)
—TEL—	PROPOSED PHONE LINE
—	PROPOSED STORM SEWER LINE
	PROPOSED OPEN LID STORM STRUCTURE (PAVEMENT USE NEENAH R-2540) (GRASS USE NEENAH R-4340-B BEEHIVE)
	PROPOSED CLOSED LID STORM STRUCTURE (PAVEMENT USE NEENAH R-1713) (GRASS USE NEENAH R-1786)
	PROPOSED COMBINATION CURB INLET (B6.12 C&G USE NEENAH R-3281-A)
	PROPOSED FLARED END SECTION
—►—	PROPOSED SANITARY SEWER LINE
	PROPOSED SANITARY MANHOLE
•	PROPOSED STORM/SANITARY CLEANOUT
—W—W—	PROPOSED WATER LINE
	PROPOSED VALVE VAULT
	PROPOSED VALVE BOX
	PROPOSED FIRE HYDRANT
	PROPOSED LIGHT POLE
	PROPOSED TRANSFORMER PAD (FOR REFERENCE ONLY)
	RIP RAP (SEE DETAILS)

ORIGINAL ISSUE 10/30/2025
KHA PROJECT N 268783002
CLUE NUMBER

C3.0

