#### DRAWING INDEX Sheet Name Sheet # SP-1 SITE PLAN - LOCATION SKETCH SP-3 DETAILED SITE PLAN (1"=30') SP-4 DETAILED SITE PLAN (1"=30') SP-4 DETAILED SITE PLAN (1"=30') SP-6 ENTRANCE DETAILS (1"=10') SP-7 FENCE TYPE PLAN (1"=50') KEY MAP, PLANT LEGEND AND ENTRY LANDSCAPE L-102 ENHANCED LANDSCAPE PLAN (A) L-103 ENHANCED LANDSCAPE PLAN (B) L-104 ENHANCED LANDSCAPE NOTES AND DETAILS EXISTING TREE DISPOSITION CHART L-105 TYPICAL LOT LANDSCAPE PLAN - COASTAL L-201 TYPICAL LOT LANDSCAPE PLAN - SOUTHERN L-203 TYPICAL LOT LANDSCAPE PLAN - FARM E-200 OVERALL PHOTOMETRIC PLAN E-201 PHOTMETRIC PARTIAL SITE E-202 PHOTMETRIC PARTIAL SITE C-01 PAVING, GRADING & DRAINAGE LOCATION MAP PAVING, GRADING & DRAINAGE PLAN C-03 PAVING, GRADING & DRAINAGE PLAN C-04 PAVING, GRADING & DRAINAGE PLAN C-05 PAVEMENT MARKING & SIGNAGE PLAN C-06 PAVEMENT MARKING & SIGNAGE PLAN C-07 PAVEMENT MARKING & SIGNAGE PLAN PAVING SECTION PLAN C-09 PAVING, GRADING & DRAINAGE DETAILS C-10 PAVING, GRADING & DRAINAGE NOTES C-11 EROSION CONTROL PLAN C-12 **CROSS SECTIONS CROSS SECTIONS** CROSS SECTIONS C-15 **CROSS SECTIONS** C-16 WATER DISTRIBUTION SYSTEM NOTES C-17 OVERALL WATER PLAN (1"=80') C-18 WATER DISTRIBUTION SYSTEM PLAN C-19 WATER DISTRIBUTION SYSTEM PLAN WATER DISTRIBUTION SYSTEM PLAN WATER DISTRIBUTION SYSTEM PROFILES C-22 C-23 C-24 SEWAGE COLLECTION SYSTEM PLAN SEWAGE COLLECTION SYSTEM PLAN SEWAGE COLLECTION SYSTEM PLAN SEWAGE COLLECTION SYSTEM PROFILES COOPER CITY STANDARD DETAILS COOPER CITY STANDARD DETAILS COOPER CITY STANDARD DETAILS COOPER CITY STANDARD DETAILS

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DEMOLITION PLAN
PHASING PLAN

#### Folio: 504130010040

## LEGAL DESCRIPTION:

TRACT TWENTY-NINE (29) OF SECTION 30, TOWNSHIP 50 SOUTH, RANGE 41 EAST, ACCORDING TO NEWMAN'S SURVEY, AS SHOWN ON PLAT RECORDED IN PLAT BOOK 2, PAGE 26, OF THE PUBLIC RECORDS OF DADE COUNTY, FLORIDA; SAID LANDS SITUATE, LYING AND BEING IN BROWARD COUNTY, FLORIDA.

#### LESS THE FOLLOWING DESCRIBED PROPERTIES:

A PORTION OF TRACT 29, "NEWMAN'S SURVEY", ACCORDING TO THE PLAT THEREOF, AS RECORDED IN PLAT BOOK 2, PAGE 26 OF THE PUBLIC RECORDS OF DADE COUNTY, FLORIDA, LYING IN SOUTHEAST QUARTER OF SECTION 30, TOWNSHIP 50 SOUTH, RANGE 41 EAST, BROWARD COUNTY, FLORIDA, AND BEING MORE PARTICULARLY DESCRIBED AS FOLLOWS:

COMMENCE AT THE SOUTH ONE QUARTER CORNER OF SAID SECTION 30; THENCE NORTH 01°55'26" WEST ALONG THE WEST LINE OF THE SOUTHEAST QUARTER OF SAID SECTION 30, A DISTANCE OF 1,333.57 FEET TO A POINT ON THE BASELINE OF SURVEY FOR STATE ROAD 818 ACCORDING TO THE FLORIDA DEPARTMENT OF TRANSPORTATION RIGHT-OF-WAY MAP FOR SECTION NO. 86015-2503; THENCE NORTH 88°26'16" EAST ALONG SAID BASELINE OF SURVEY, A DISTANCE OF 660.59 FEET; THENCE SOUTH 01°33'44" EAST ALONG A LINE AT A RIGHT ANGLE FROM THE PREVIOUSLY DESCRIBED COURSE, A DISTANCE OF 50.00 FEET TO A POINT ON THE SOUTHERLY EXISTING RIGHT-OF-WAY LINE, A DISTANCE OF 645.27 FEET TO A POINT ON THE EASTERLY EXISTING RIGHT-OF-WAY LINE FOR S.W. 106TH TERRACE; THENCE SOUTH 01°55'26" EAST ALONG SAID EASTERLY EXISTING RIGHT-OF-WAY LINE, A DISTANCE OF 345.20 FEET; THENCE NORTH 88°04'34" EAST, A DISTANCE OF 62.34 FEET; THENCE NORTH 01°55'26" WEST, A DISTANCE OF 236.22 FEET; THENCE NORTH 42°45'43" EAST, A DISTANCE OF 63.29 FEET; THENCE NORTH 87°26'52" EAST, A DISTANCE OF 538.51 FEET; THENCE NORTH 01°58'58" WEST, A DISTANCE OF 54.00 FEET TO THE POINT OF BEGINNING.

#### AND

A PORTION OF TRACT 29, "NEWMAN'S SURVEY", ACCORDING TO THE PLAT THEREOF, AS RECORDED IN PLAT BOOK 2, PAGE 26 OF THE PUBLIC RECORDS OF DADE COUNTY, FLORIDA, LYING IN SOUTHEAST QUARTER OF SECTION 30, TOWNSHIP 50 SOUTH, RANGE 41 EAST, BROWARD COUNTY, FLORIDA, AND BEING MORE PARTICULARLY DESCRIBED AS FOLLOWS:


COMMENCE AT THE SOUTH ONE QUARTER CORNER OF SAID SECTION 30; THENCE NORTH 01°55′26″ WEST ALONG THE WEST LINE OF THE SOUTHEAST QUARTER OF SAID SECTION 30, A DISTANCE OF 1,333.57 FEET TO A POINT ON THE BASELINE OF SURVEY FOR STATE ROAD 818 ACCORDING TO THE FLORIDA DEPARTMENT OF TRANSPORTATION RIGHT-OF-WAY MAP FOR SECTION NO. 86015-2503; THENCE NORTH 88°26′16″ EAST ALONG SAID BASELINE OF SURVEY, A DISTANCE OF 663.97 FEET; THENCE SOUTH 01°33′44″ EAST ALONG A LINE AT A RIGHT ANGLE FROM THE PREVIOUSLY DESCRIBED COURSE, A DISTANCE OF 510.84 FEET TO A POINT ON THE EASTERLY BOUNDARY LINE OF SAID TRACT 29 AND THE POINT OF BEGINNING; THENCE SOUTH 01°58′58″ EAST ALONG SAID EASTERLY BOUNDARY LINE, A DISTANCE OF 487.00 FEET; THENCE SOUTH 88°01′02″ WEST, A DISTANCE OF 190.00 FEET; THENCE NORTH 01°58′58″ WEST, A DISTANCE OF 487.00 FEET; THENCE NORTH 88°01′02″ EAST, A DISTANCE OF 190.00 FEET TO THE POINT OF BEGINNING.

### SUBJECT TO THE RIGHT-OF-WAY OF SW 106TH AVENUE.

SAID LANDS LYING AND BEING IN THE CITY OF COOPER CITY, BROWARD COUNTY, FLORIDA AND CONTAINING 604,250 SQUARE FEET (13.8717 ACRES), MORE OR LESS.

# SITE PLAN FOR PROPOSED

# GRIFFIN 106 SUBDIVISION

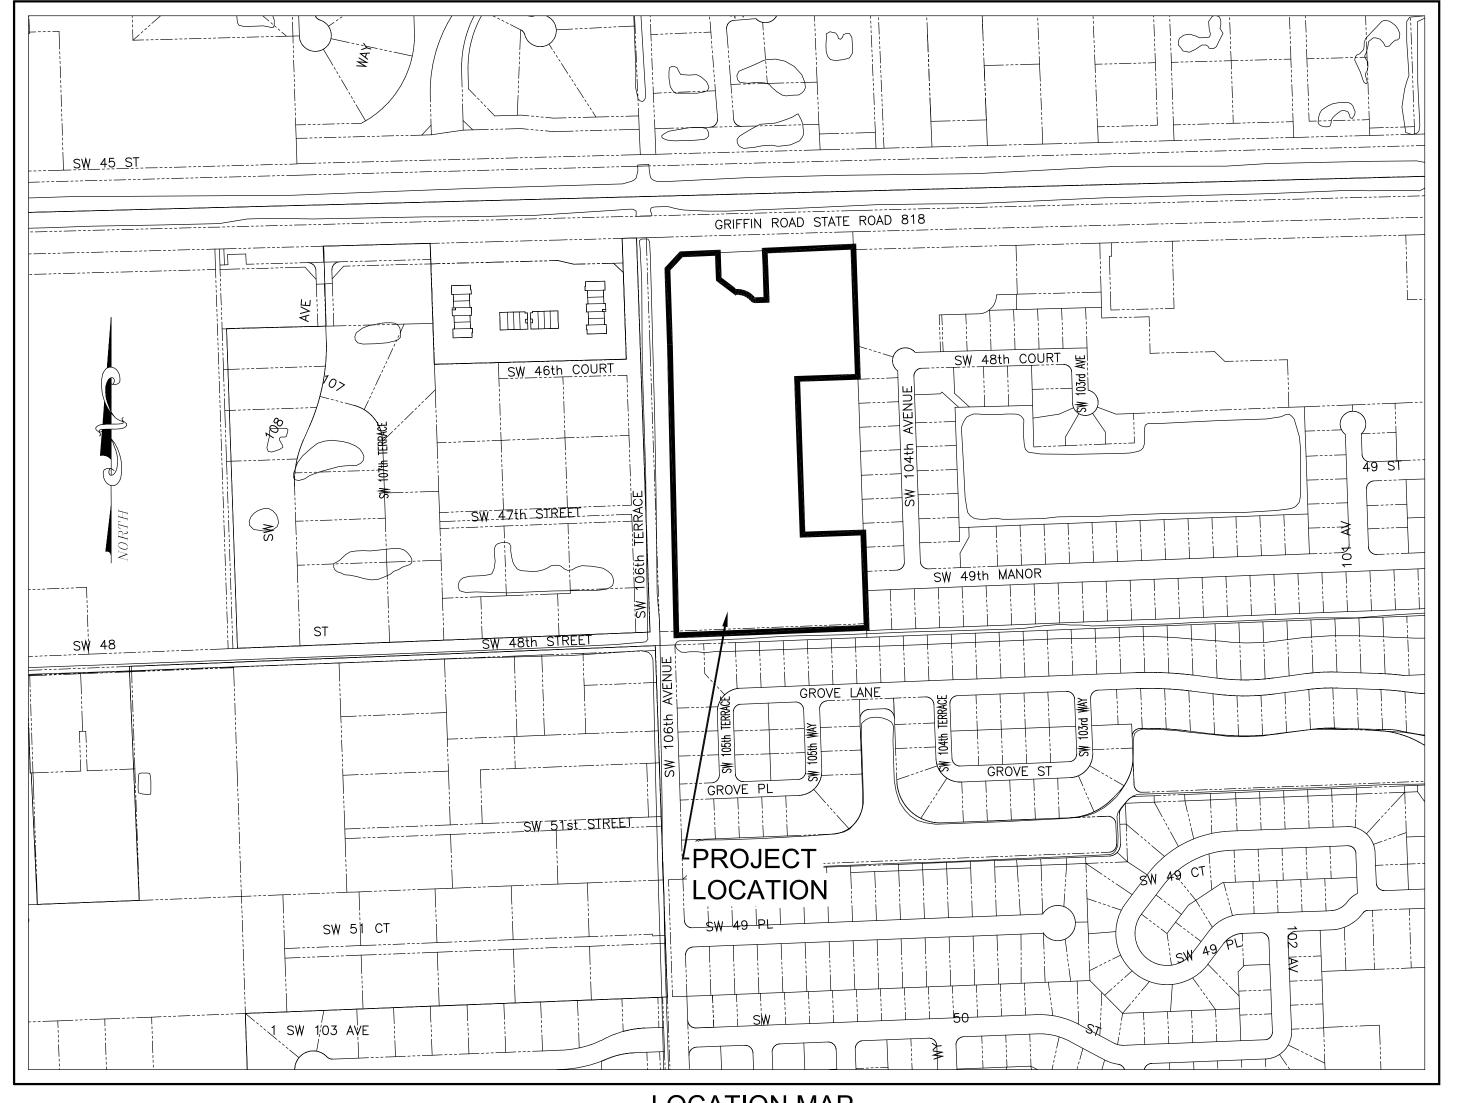


LOCATION MAP

SCALE: 1" = 300'

BROWARD COUNTY - COOPER CITY, FLORIDA
SECTION 30 - TOWNSHIP 50 - RANGE 41

THIS ITEM HAS BEEN DIGITALLY
SIGNED AND SEALED BY ANDREW
W. ADAMS, P.E. ON THE DATE ADJACENT
TO THE SEAL.
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AND THE SIGNATURE MUST BE VERIFIED

ON ANY ELECTRONIC COPIES.

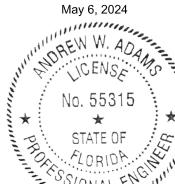

ANDREW W. ADAMS
REGISTERED ENGINEER #55315
STATE OF FLORIDA

DESIGNED: AWA

DRAWN: AWA


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DATE: 8/30/23
PROJ. NO.
2306A

SP-1
OF 7 SHEETS

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SITE DATA TABLE GRIFFIN 106 SUBDIVISION				
FUTURE LAND USE DESIGNATION (COOPER CITY)	ESTATE (1DU/ACRE)			
FUTURE LAND USE DESIGNATION (BROWARD COUNTY)	ESTATE (1) RESIDENTIAL			
GROSS SITE AREA (PER B.C.P.C. DETERMINATION)	19.23 ACRES			
NUMBER OF UNITS ALLOWED BY LAND USE DESIGNATION	19 UNITS			
PROPOSED FLEX UNIT ALLOCATION	19 UNITS			
PROPOSED NUMBER OF DWELLING UNITS	38 UNITS			
GROSS DENSITY	1.98 UNITS/ACRE			

SITE DATA GRIFFIN	106 SUBDIVISION	
CURRENT ZONING DESIGNATION	A-1* AGRICU	LTURAL ESTATE
PROPOSED ZONING DESIGNATION	R-1-D SI	NGLE FAMILY
GROSS SITE AREA	19.23	3 ACRES
NET SITE AREA	14.03	3 ACRES
ZONING CRITERIA (SEC. 23-34)	REQUIRED	PROVIDED
MINIMUM LOT AREA (SQUARE FEET)	6000	8700
MINIMUM LOT WIDTH (FEET)	60	60
MINIMUM LOT DEPTH (FEET)	100	123.89
MINIMUM YARDS (FEET)	-	-
FRONT	25	25
STREET SIDE	15	15
INTERIOR SIDE	7.5	7.5 / 10
REAR	15	15
MINIMUM FLOOR AREA (SF/UNIT)	1,200	2312
MAXIMUM BUILDING COVERAGE (%)	33	33
MAXIMUM HEIGHT	-	-
FEET	30	29'-10"
STORIES	2	2
ANDSCAPE CRITERIA (SEC. 25-47)	-	-
MAXIMUM IMPERVIOUS COVER (%)	55	49
OFF-STREET PARKING CRITERIA (SEC. 25-4)	-	-
MINIMUM NUMBER OF PARKING SPACES	114 (3/UNIT)	155 (4/UNIT + 3 GUEST)

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TO THE SEAL.
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May 6, 2024

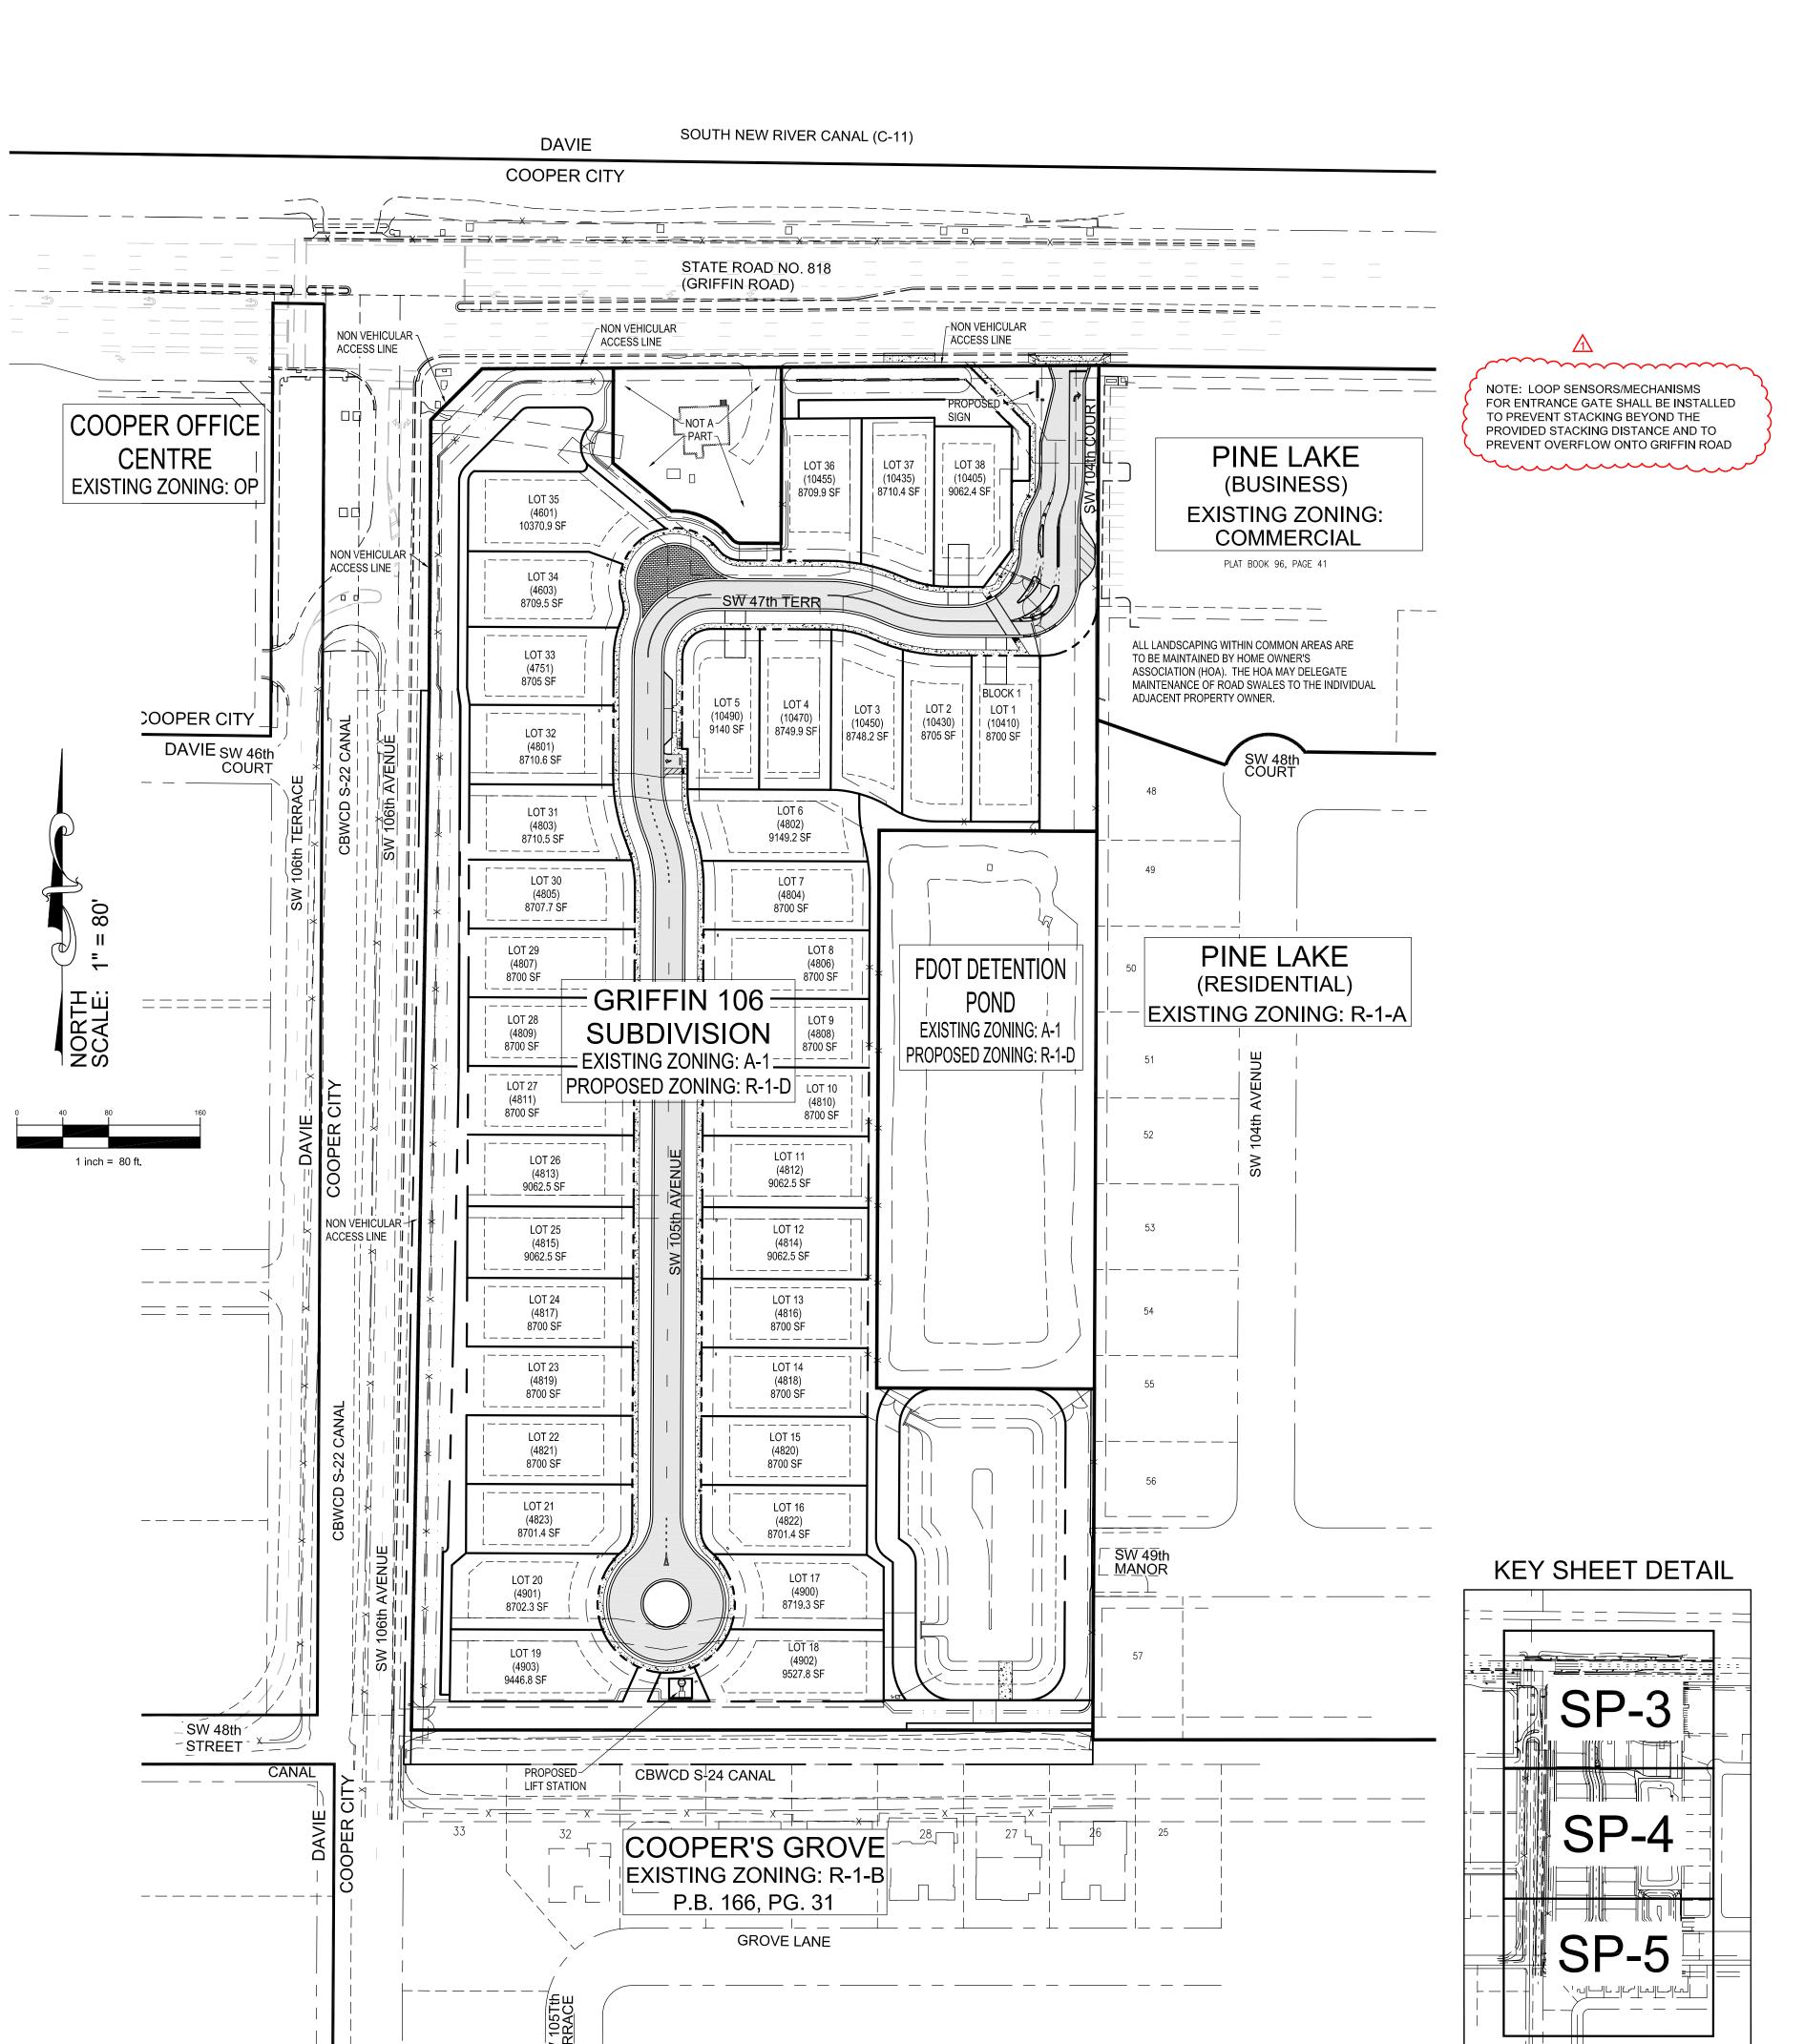
ΙΤ	
ARE D :D	ANDREW W. ADAMS REGISTERED ENGINEER #55318 STATE OF FLORIDA
	DESIGNED: AWA
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	CHECKED: AWA
	SCALE: AS NOTED
	DATE: 8/30/23
	PROJ. NO. 2306A


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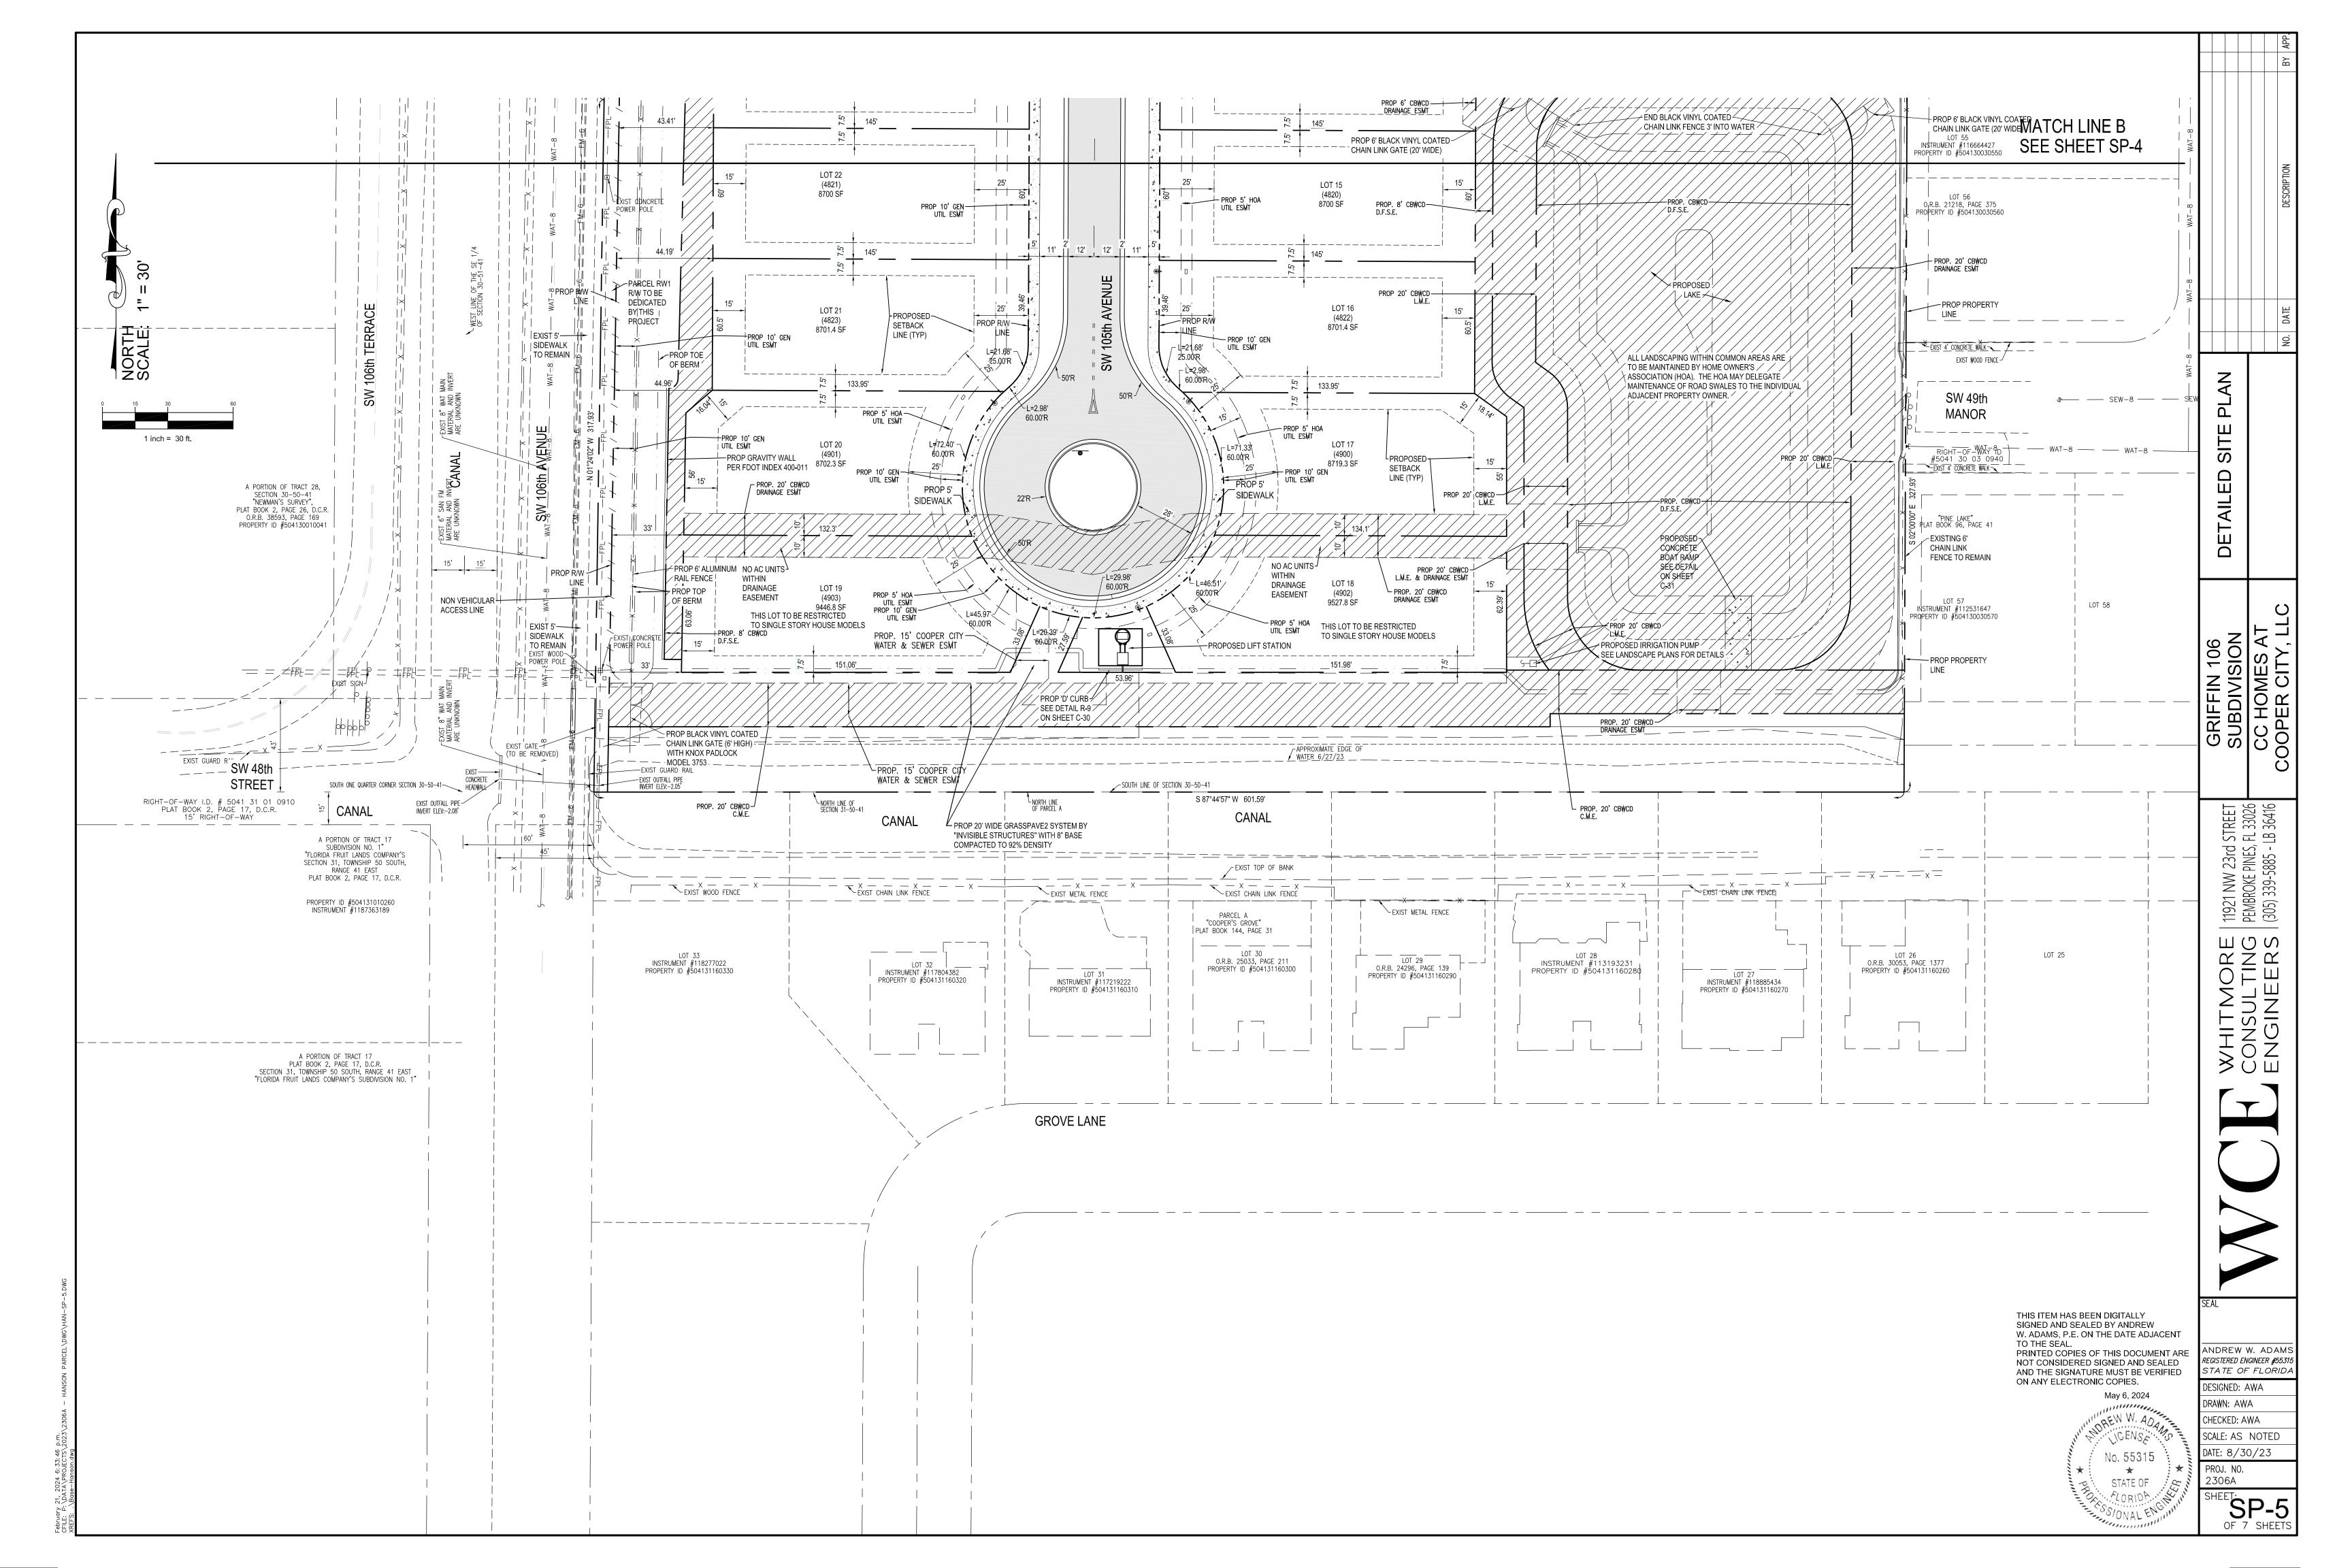
STREE 7, FL 330 LB 364


ПOS


SHEET. SP-2 OF 7 SHEETS




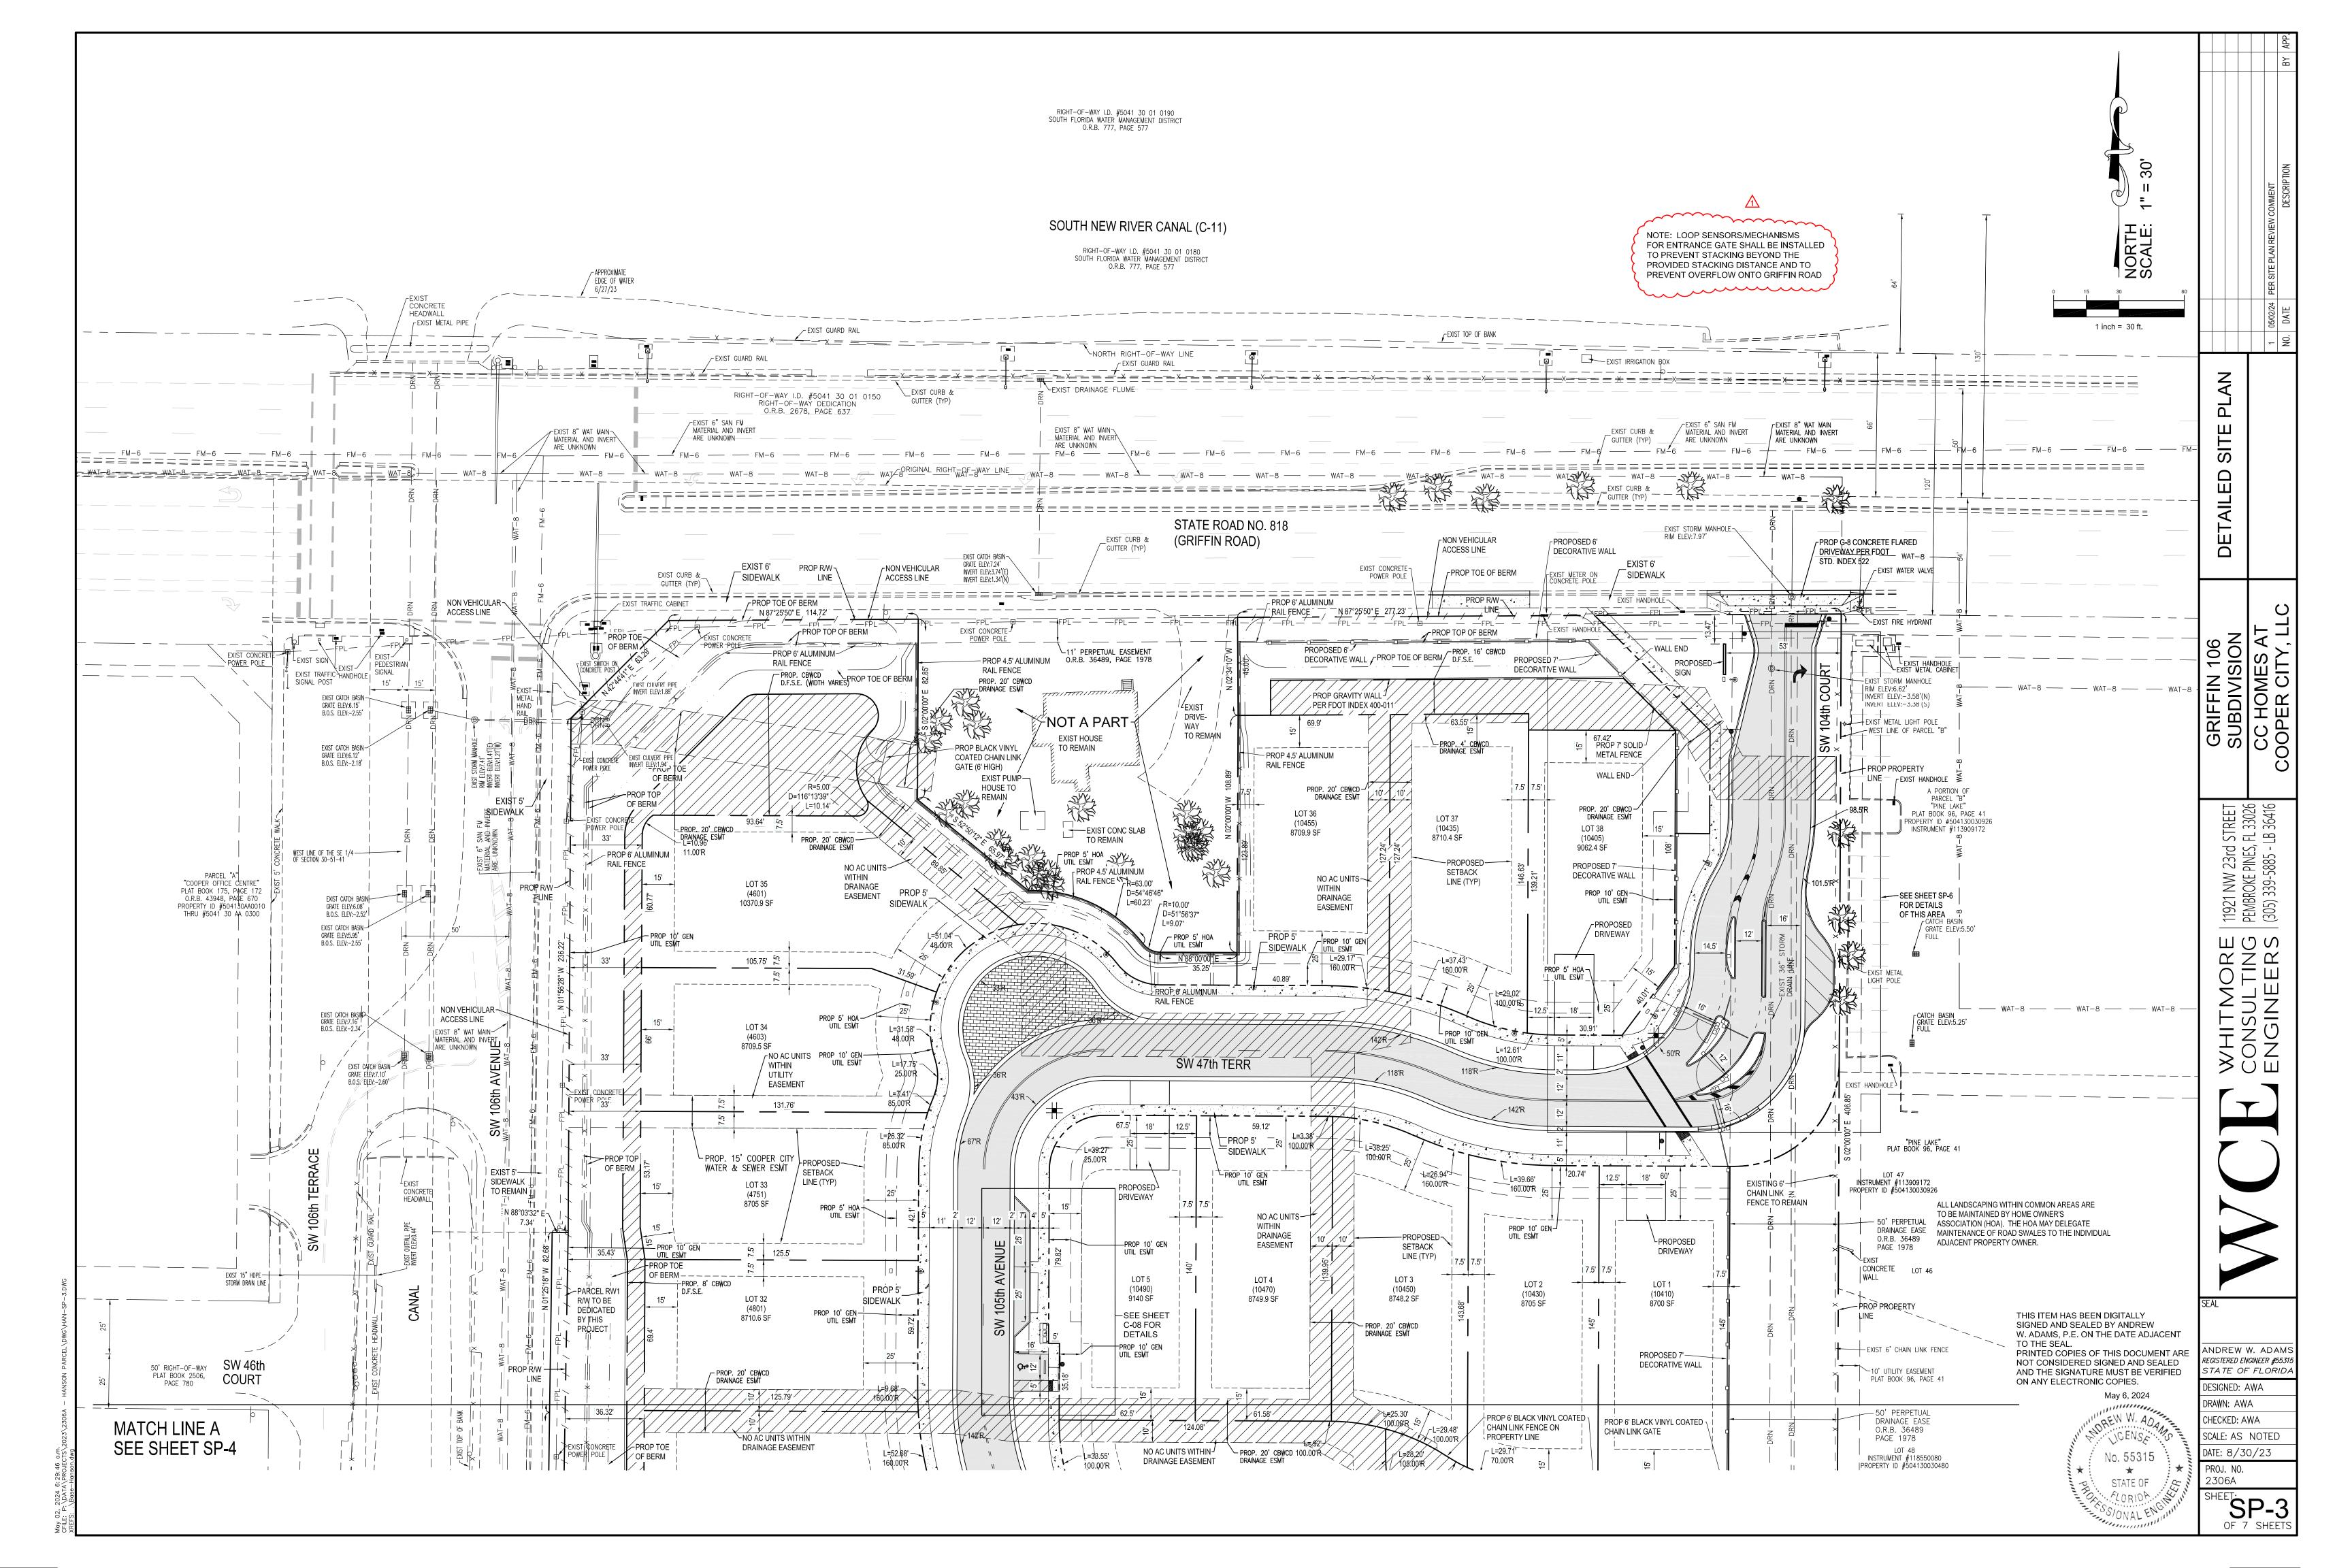

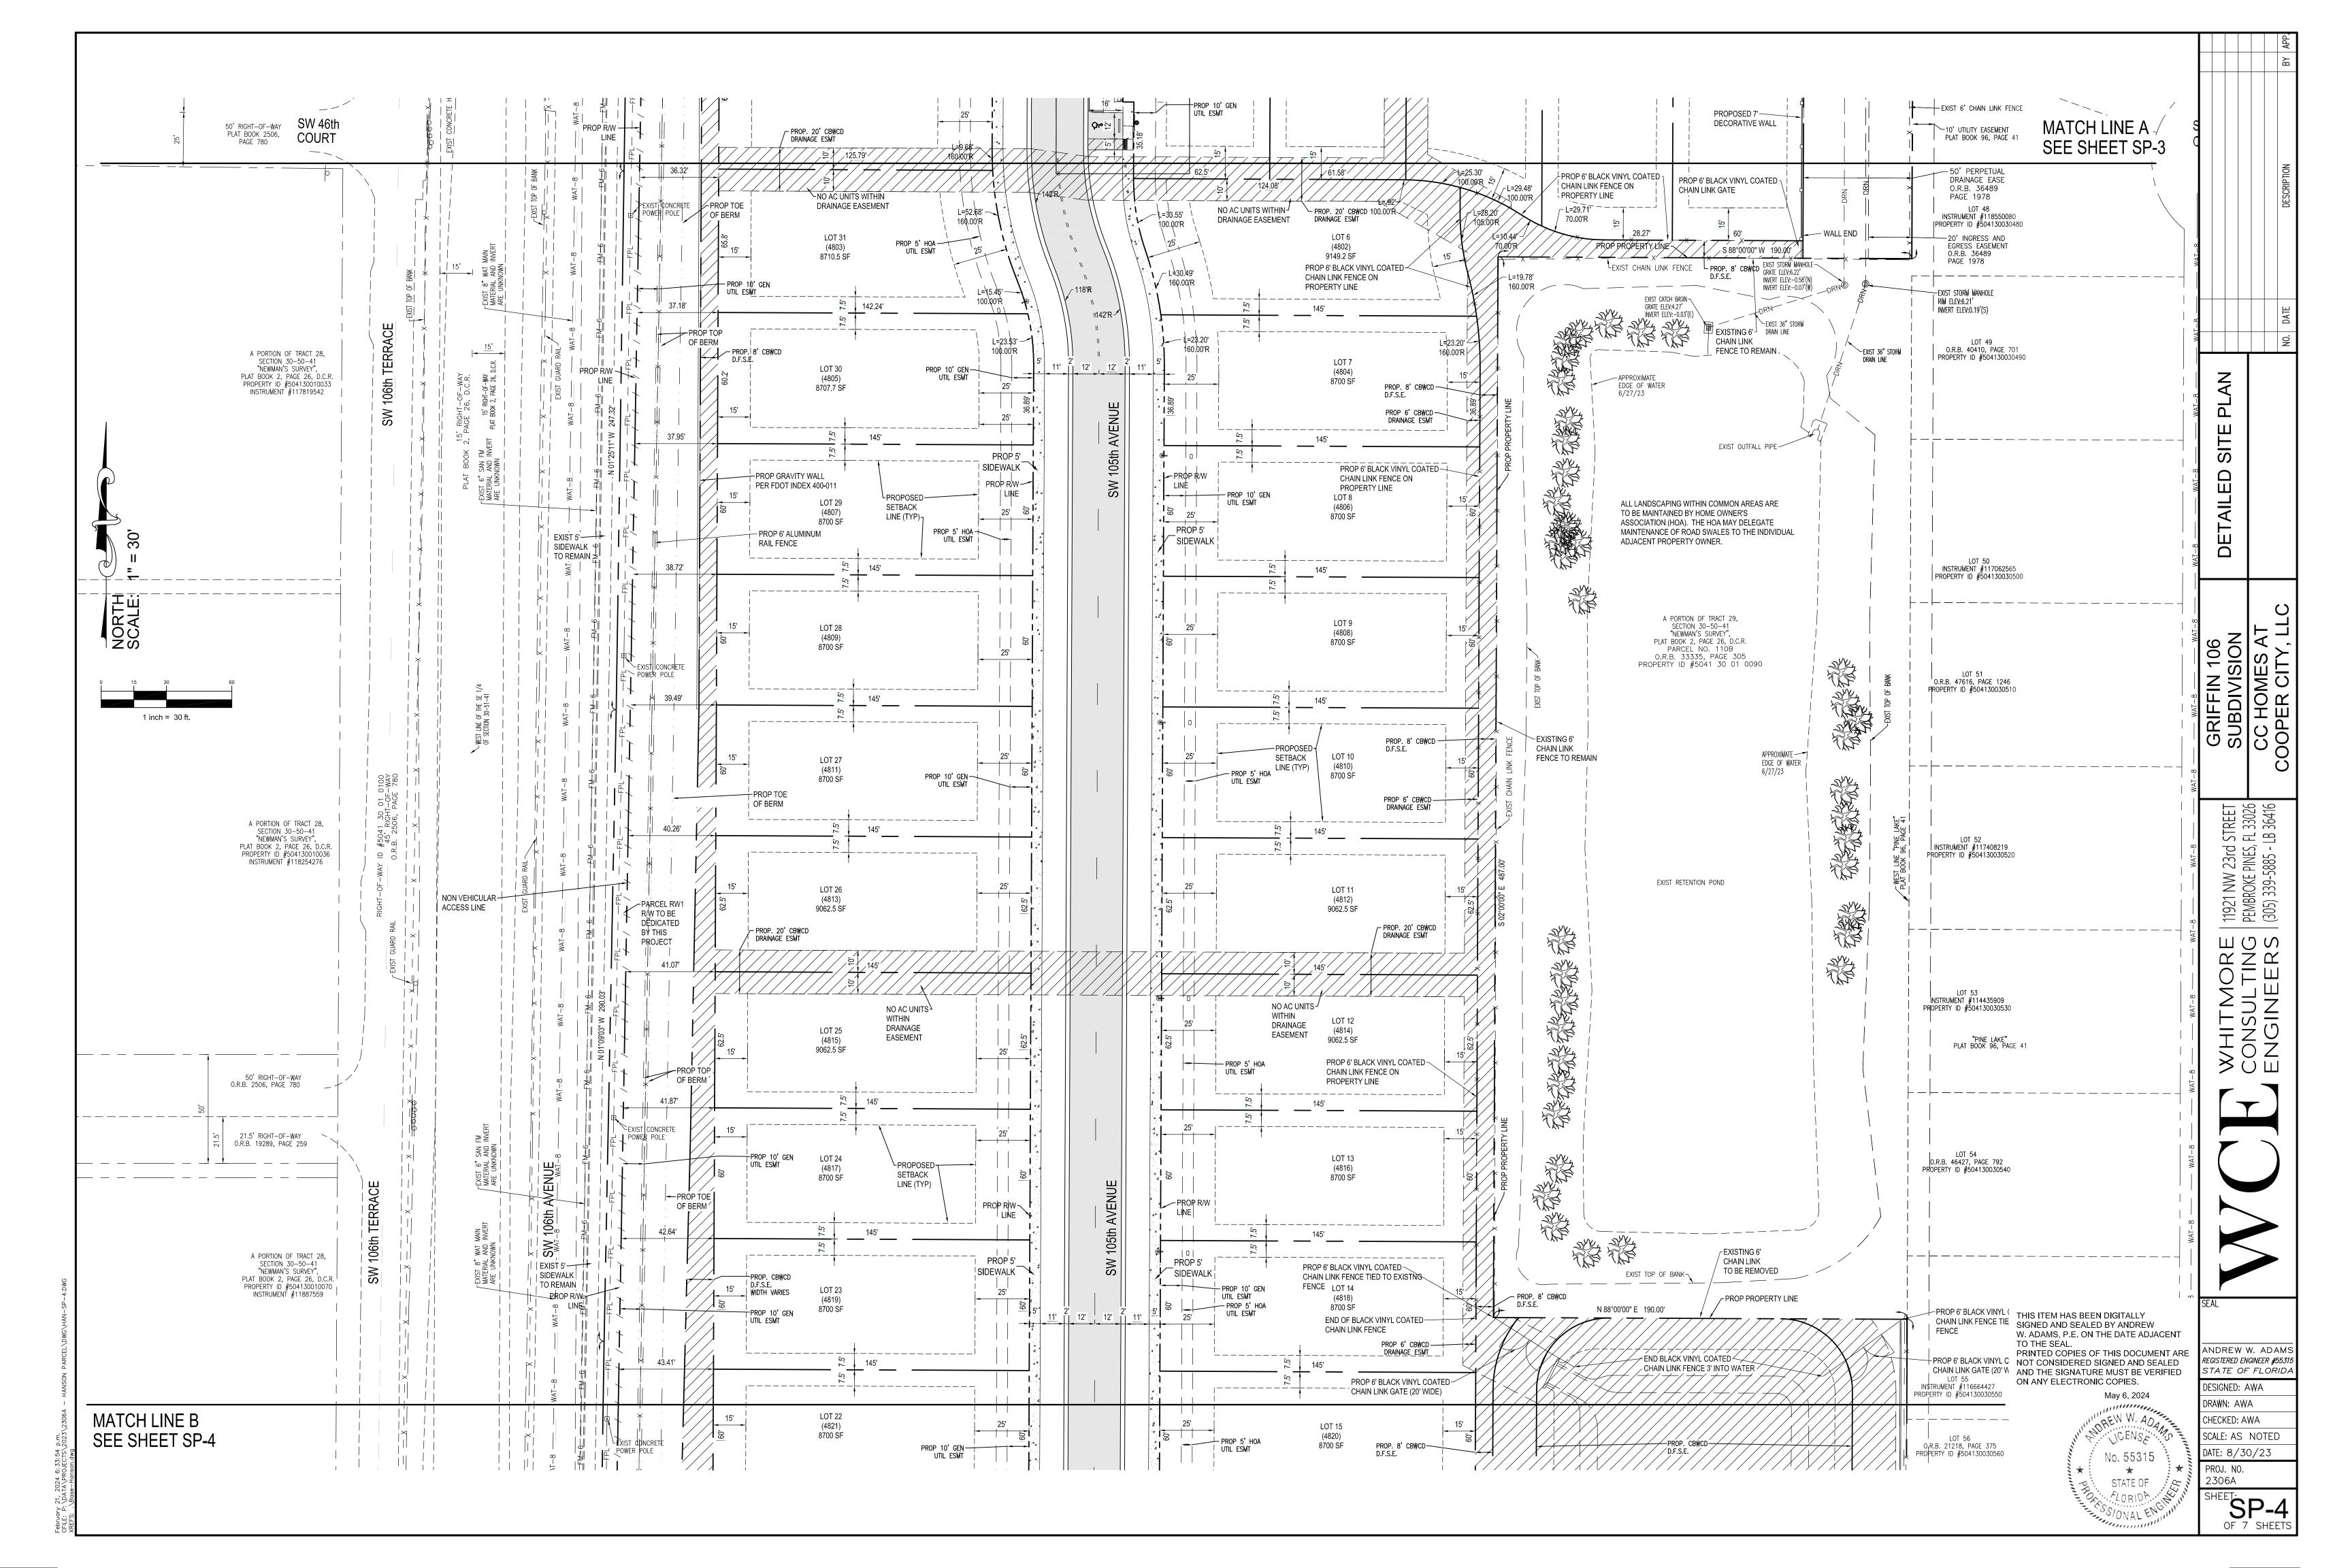

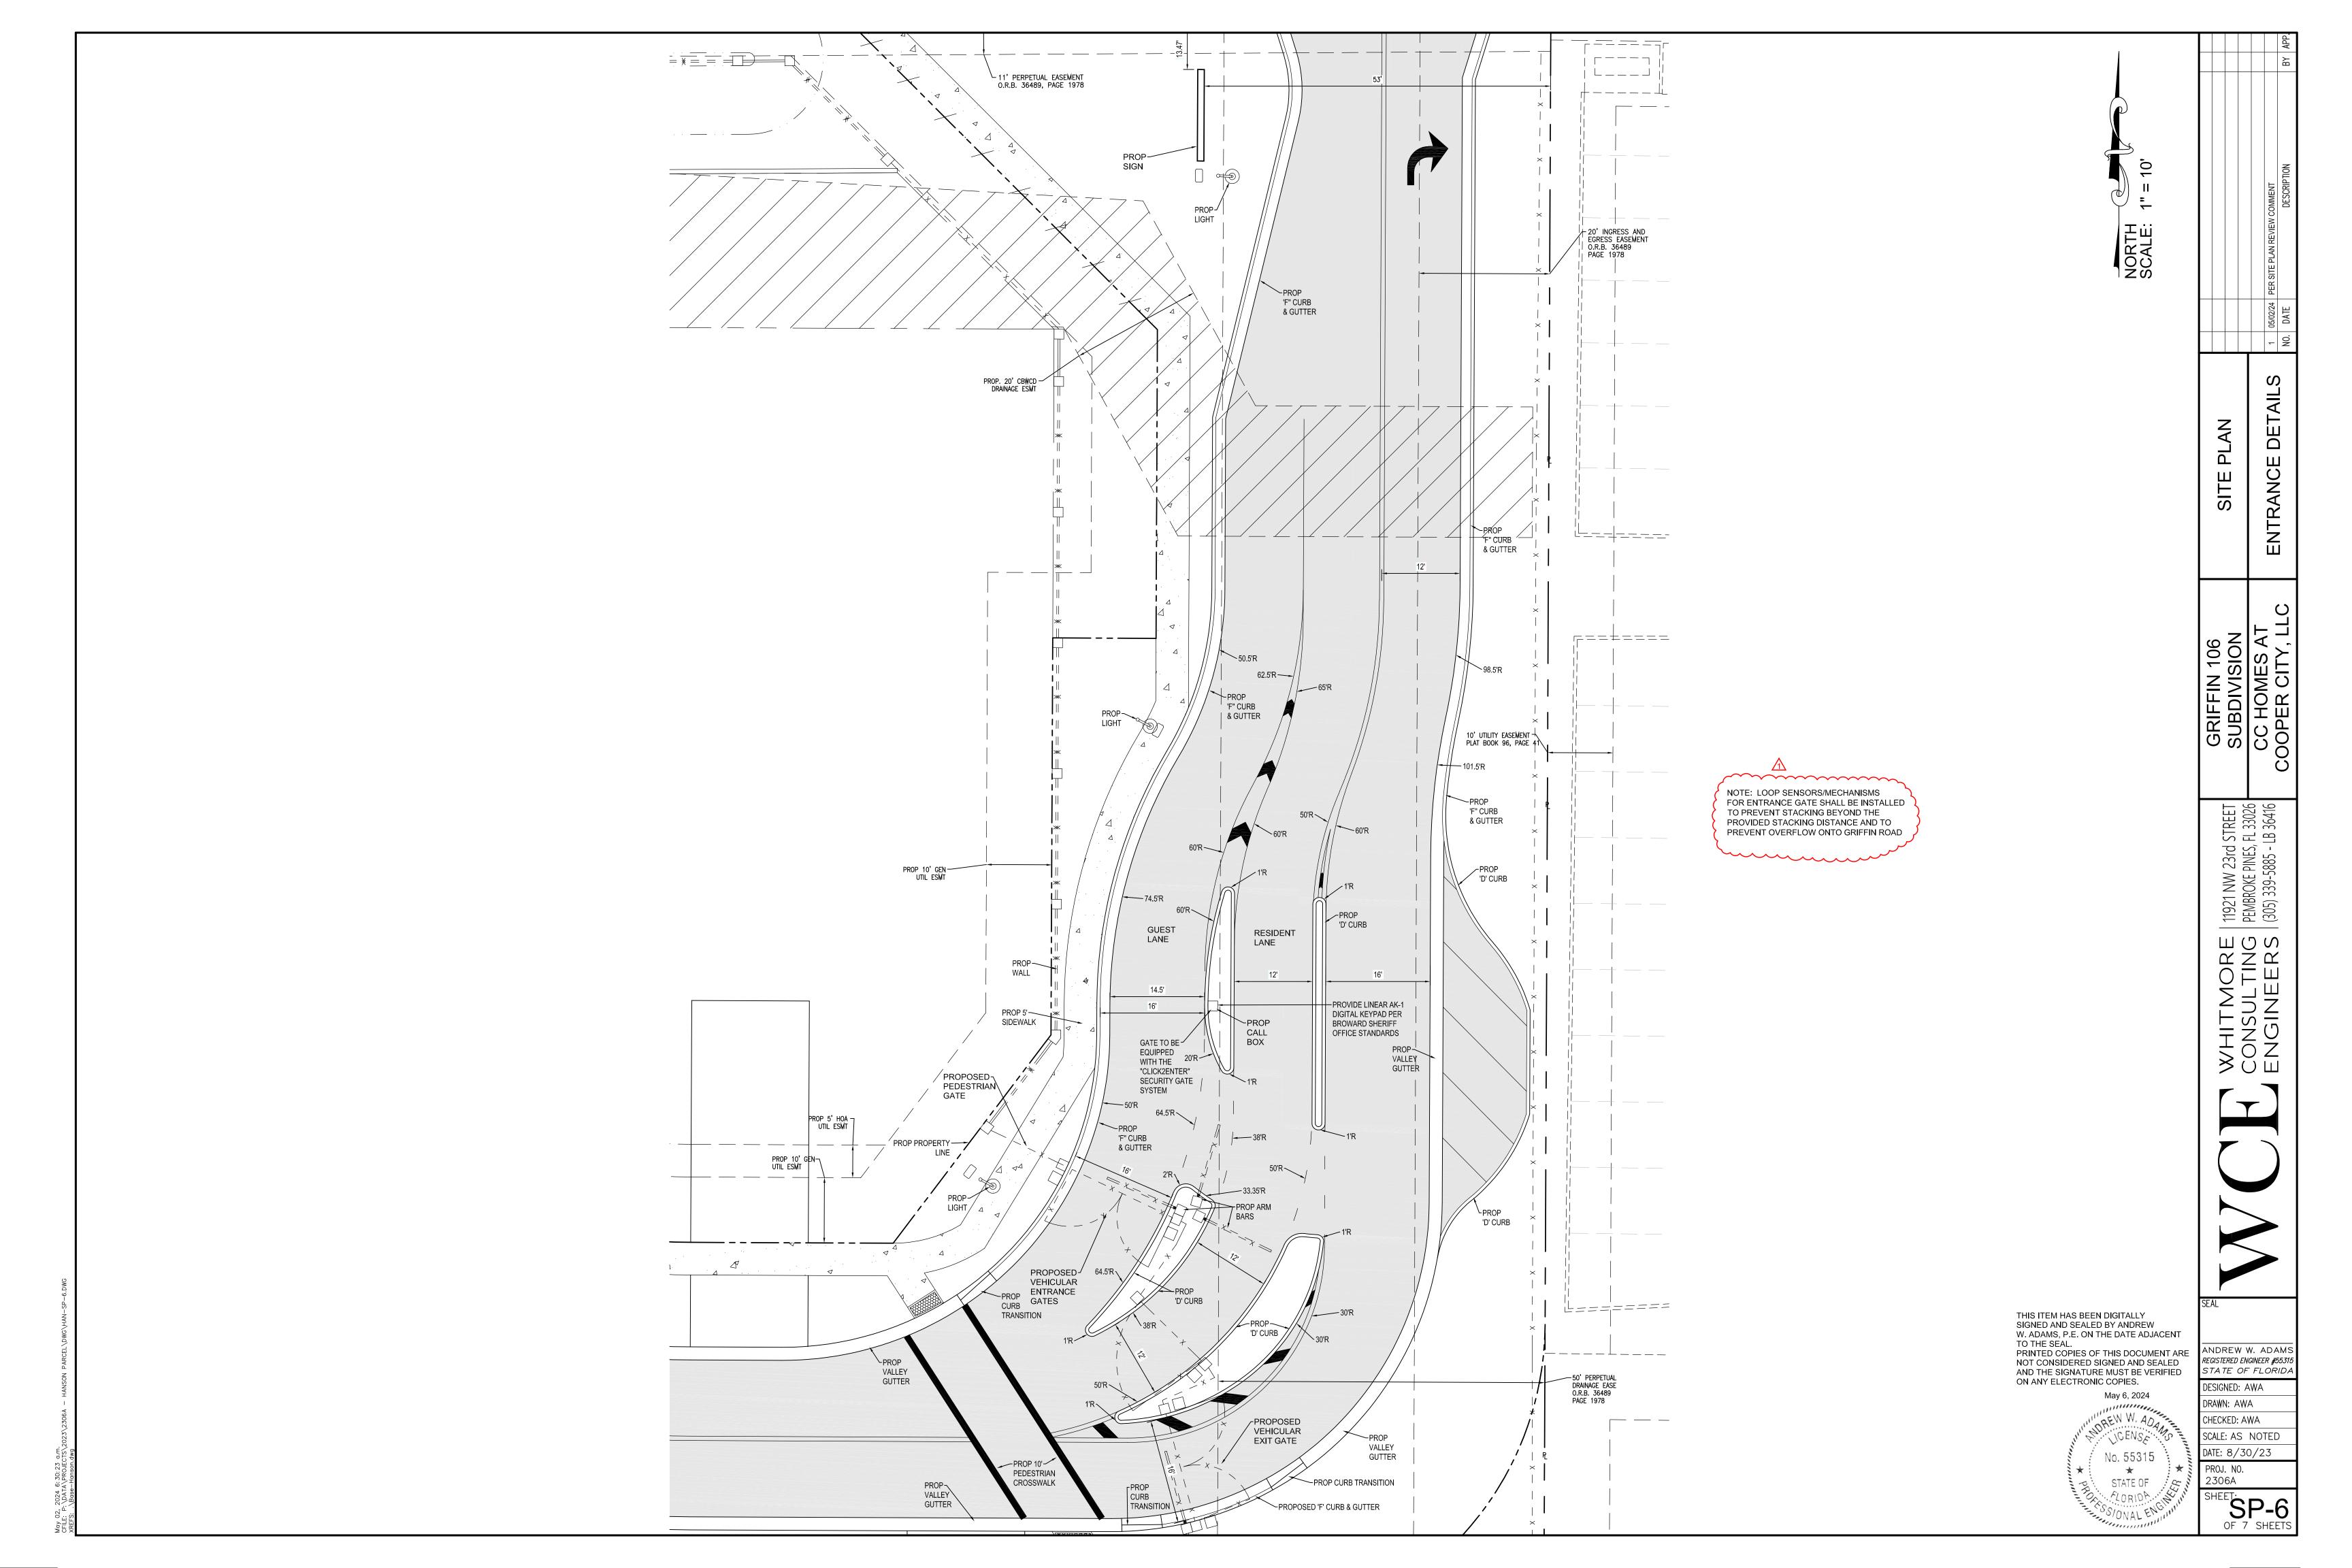

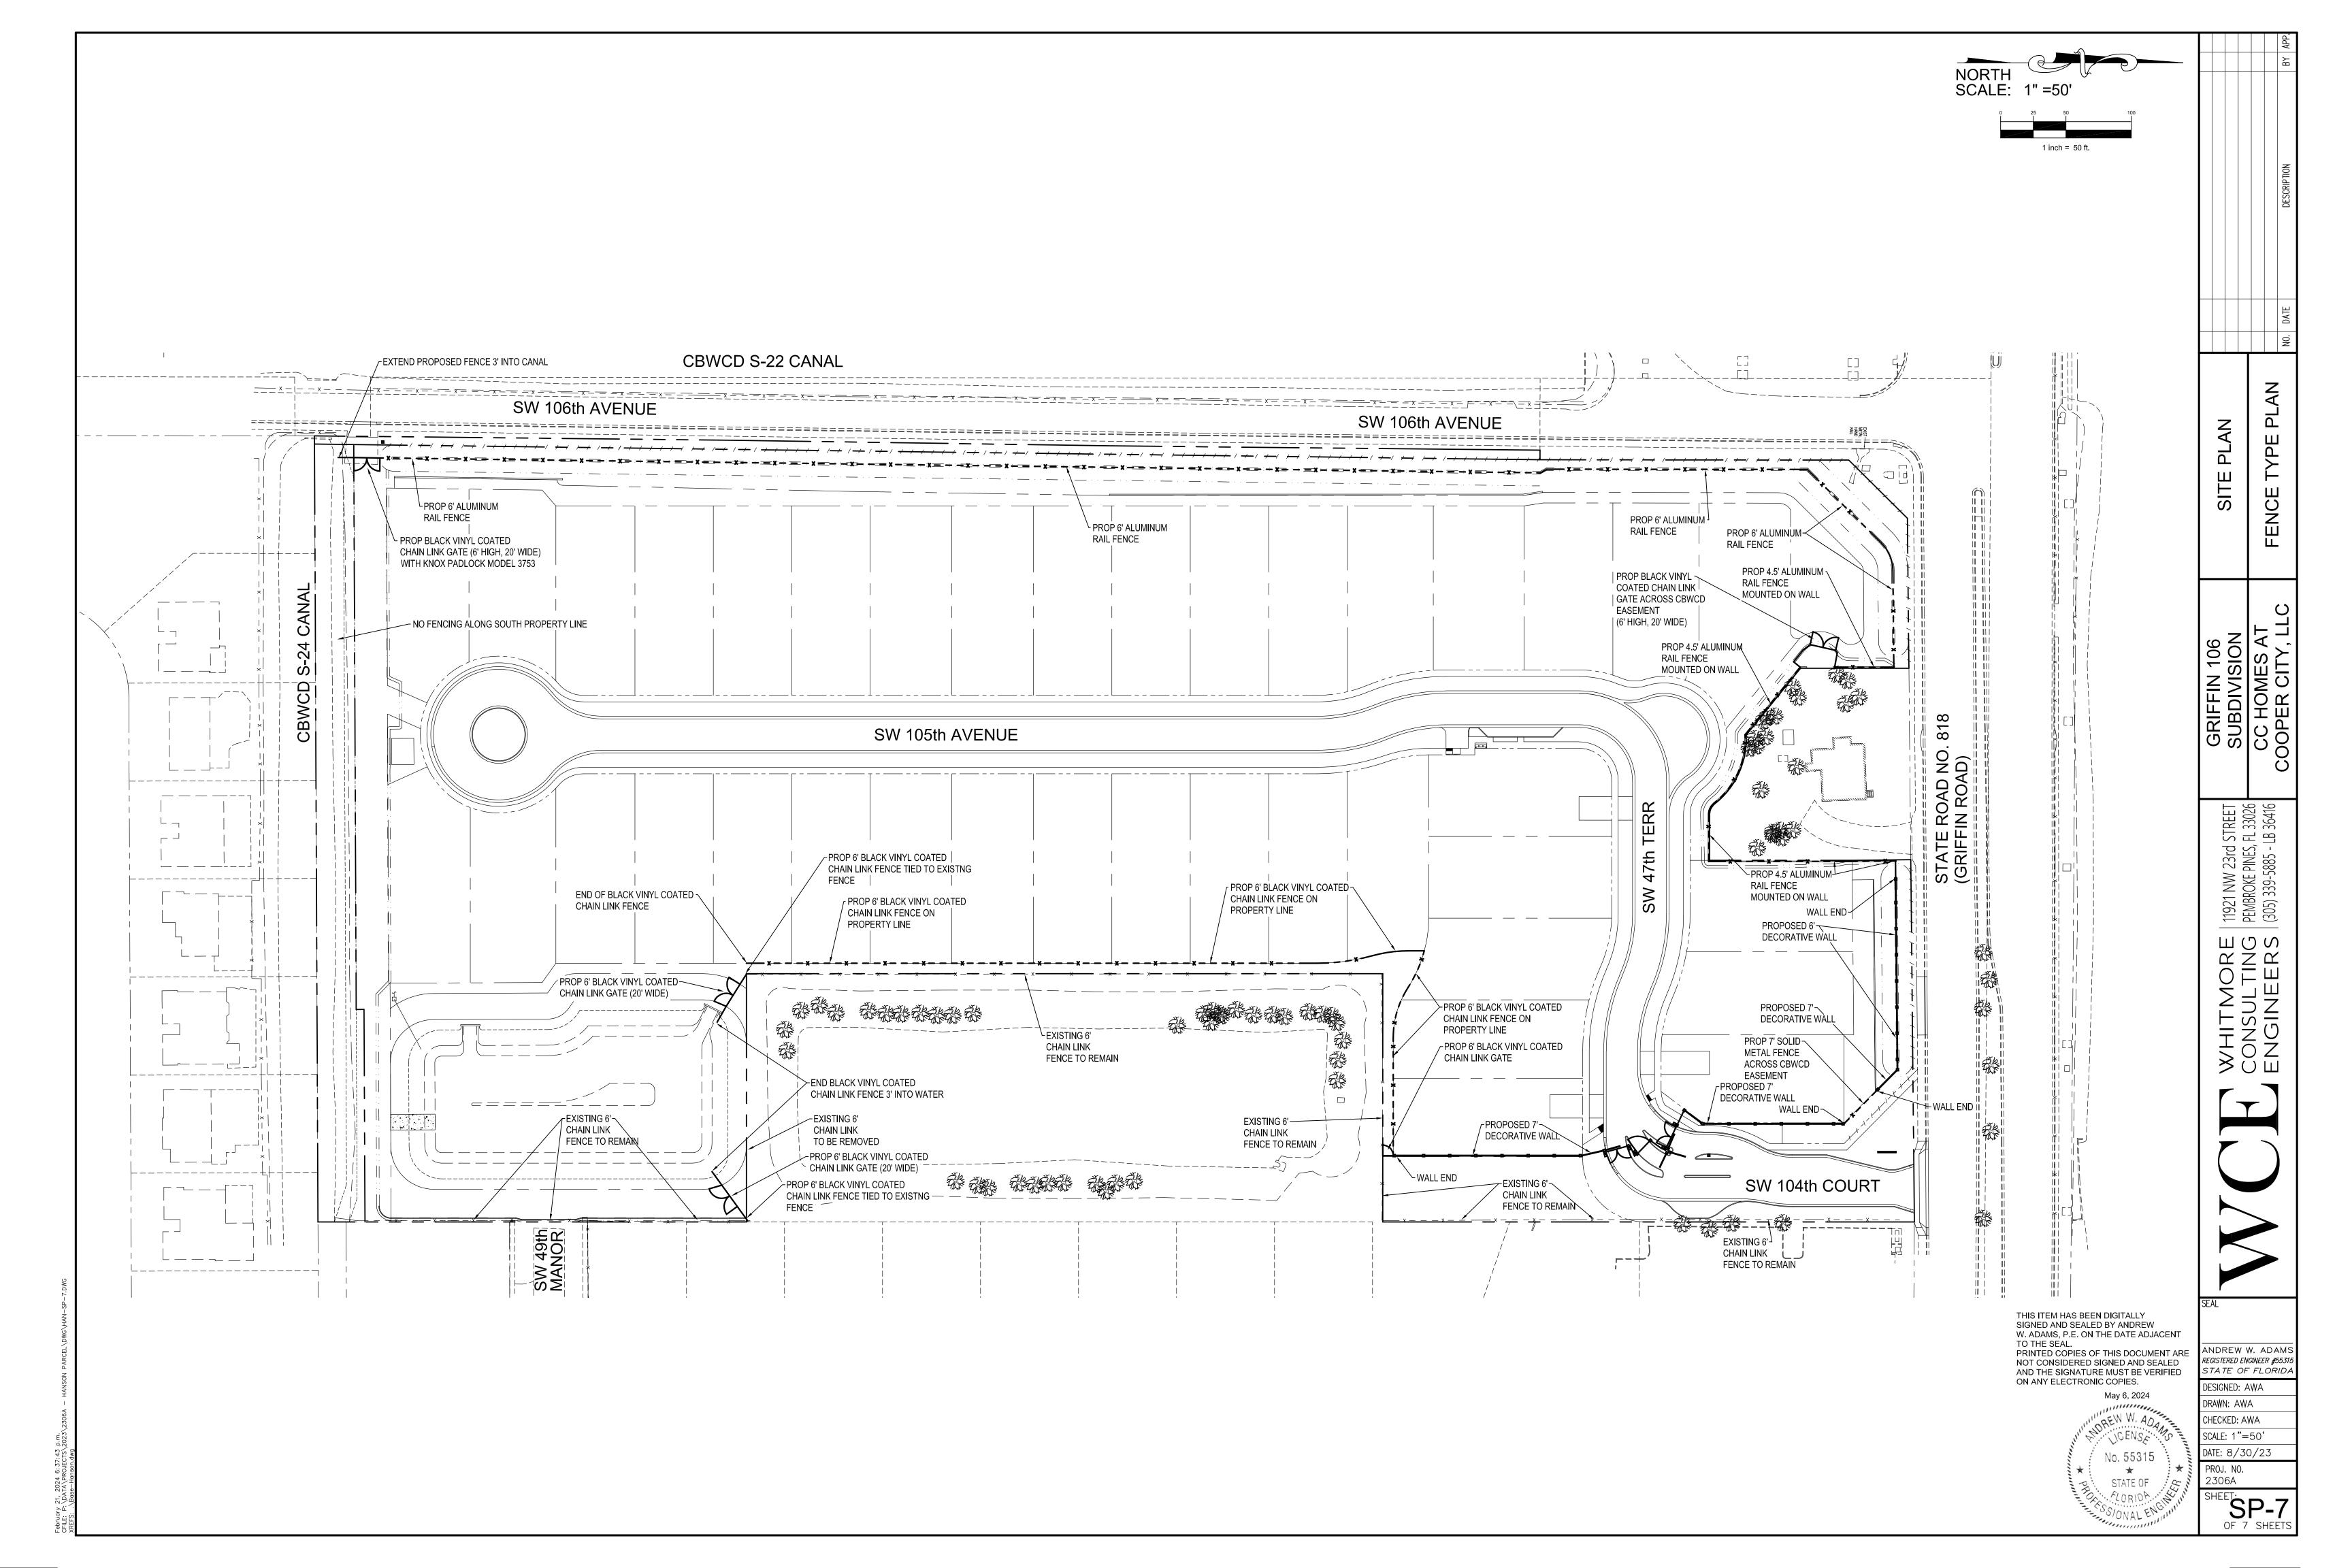

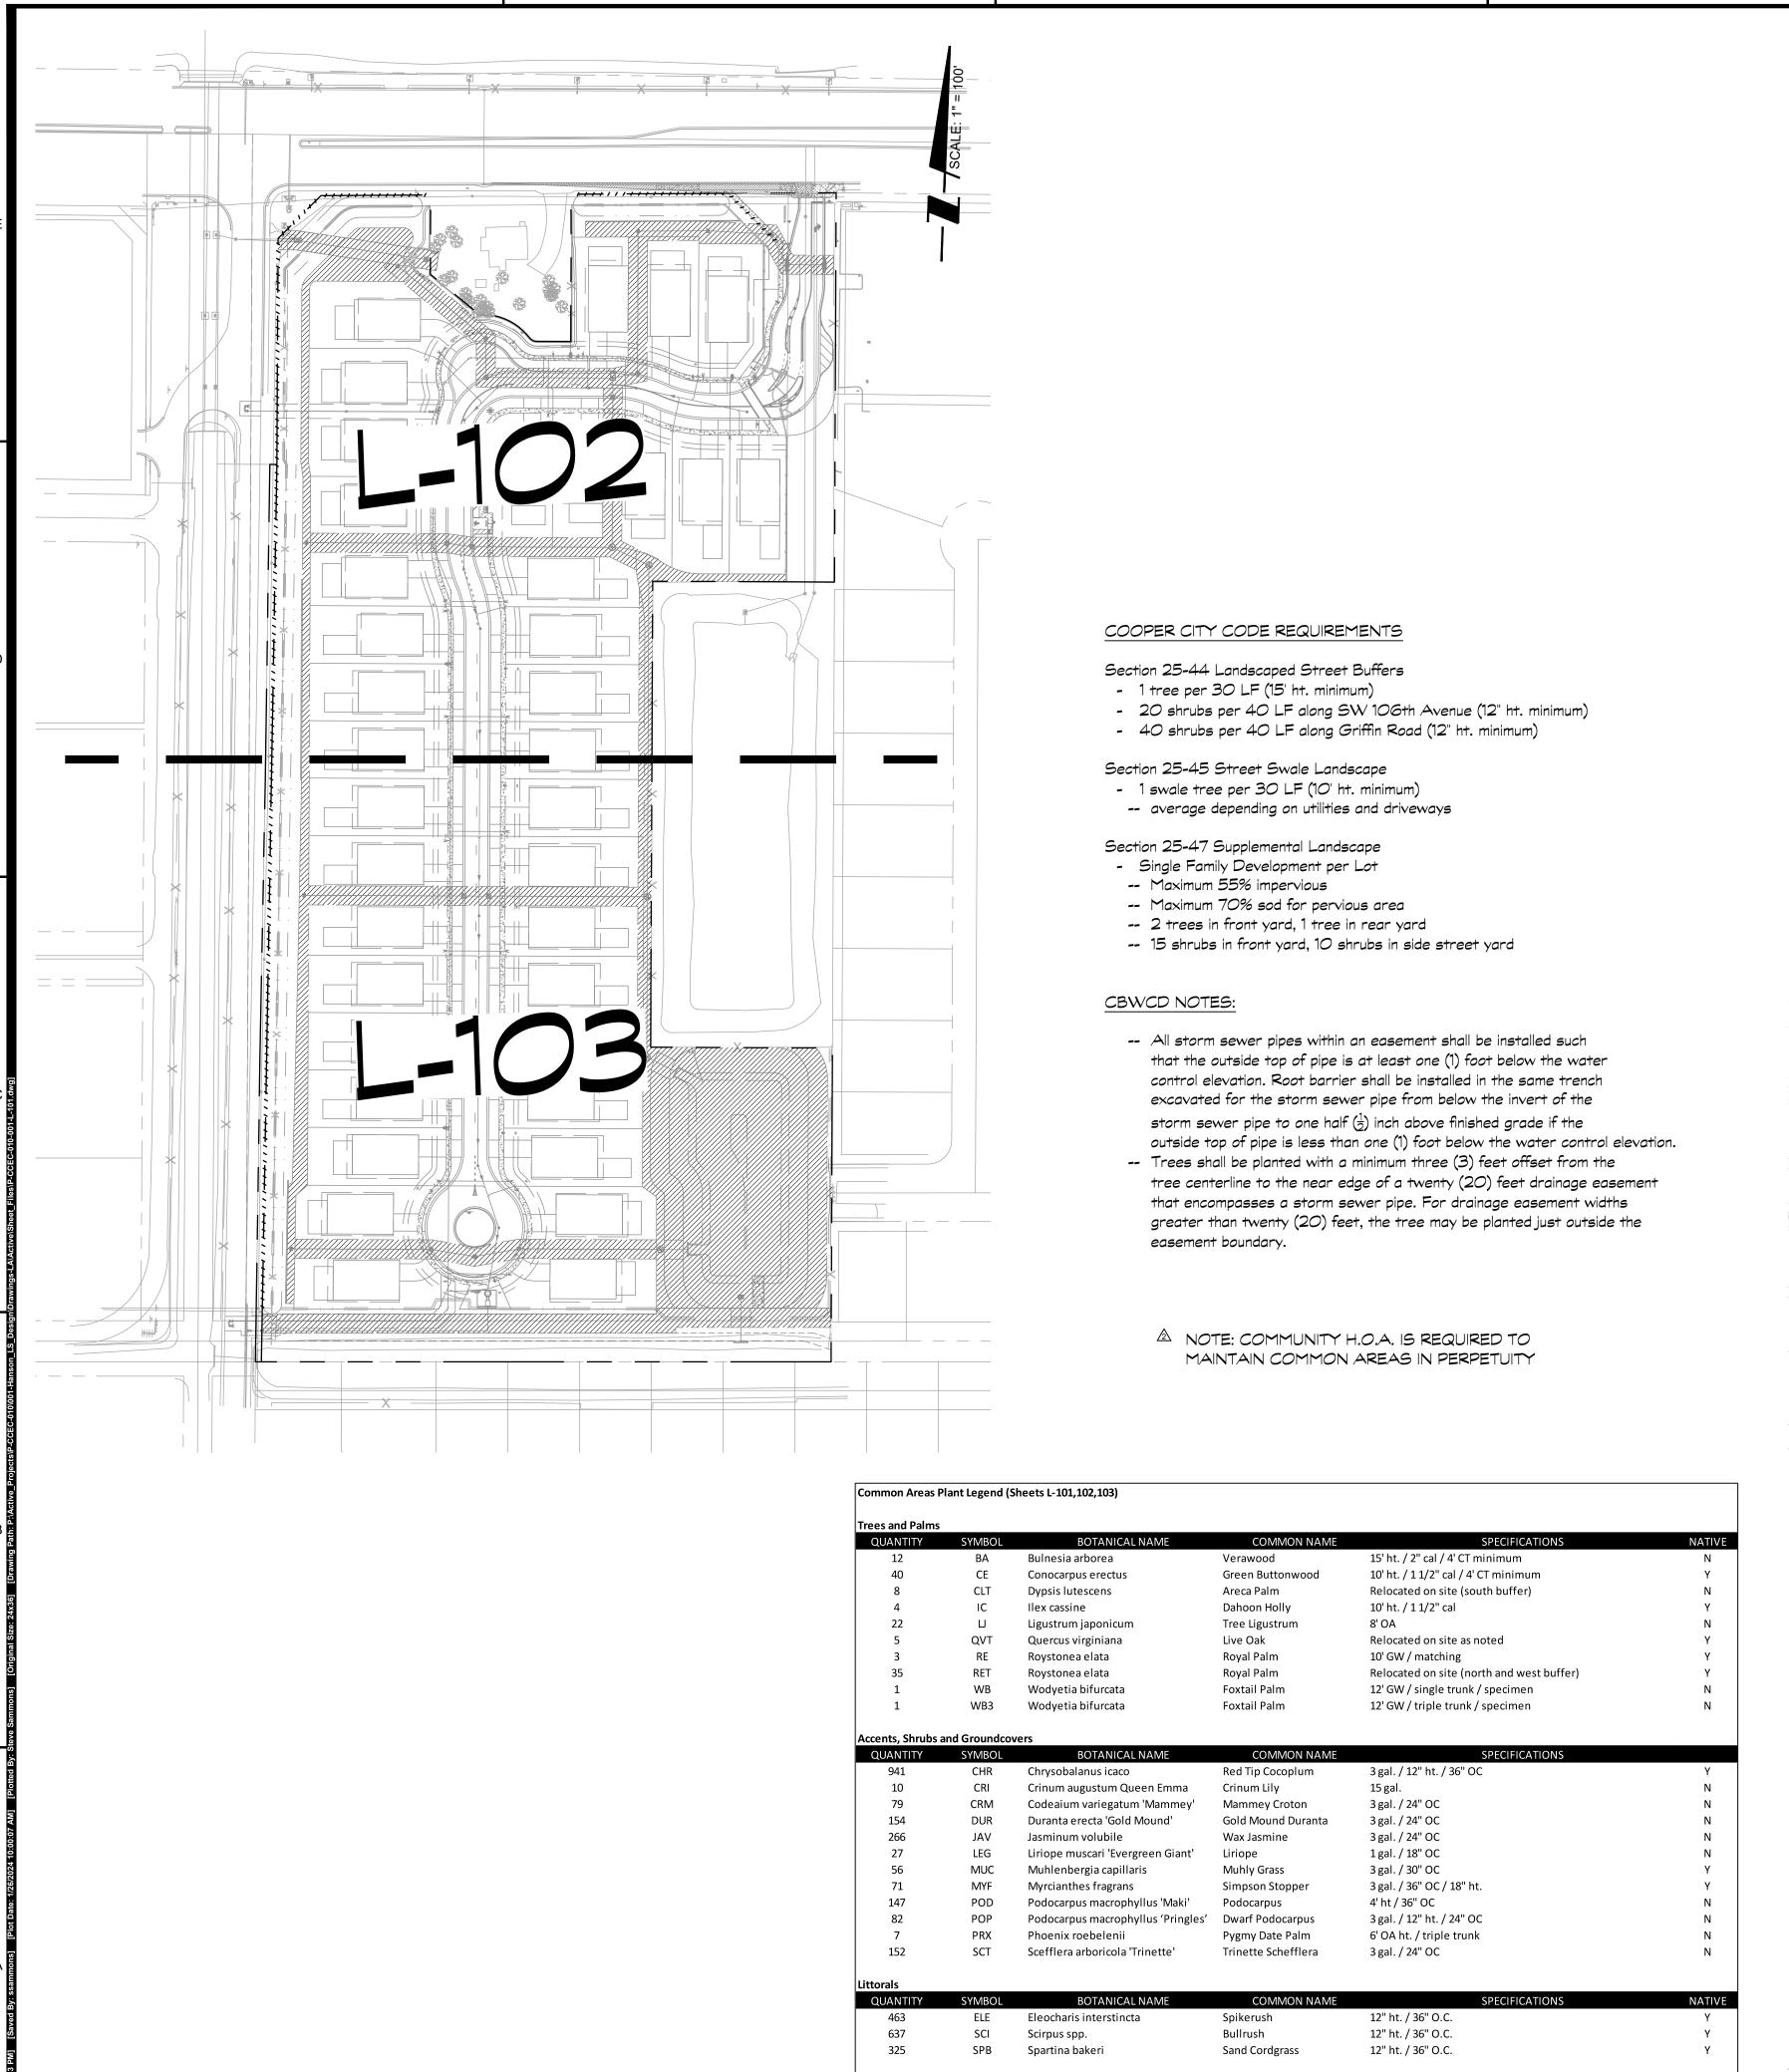


Coco Brown Mulch


Bahia Grass sod


SOD SOD 2 St. Augustine Floratam Sod As shown on plan


All shrub beds and tree rings

As shown on plan

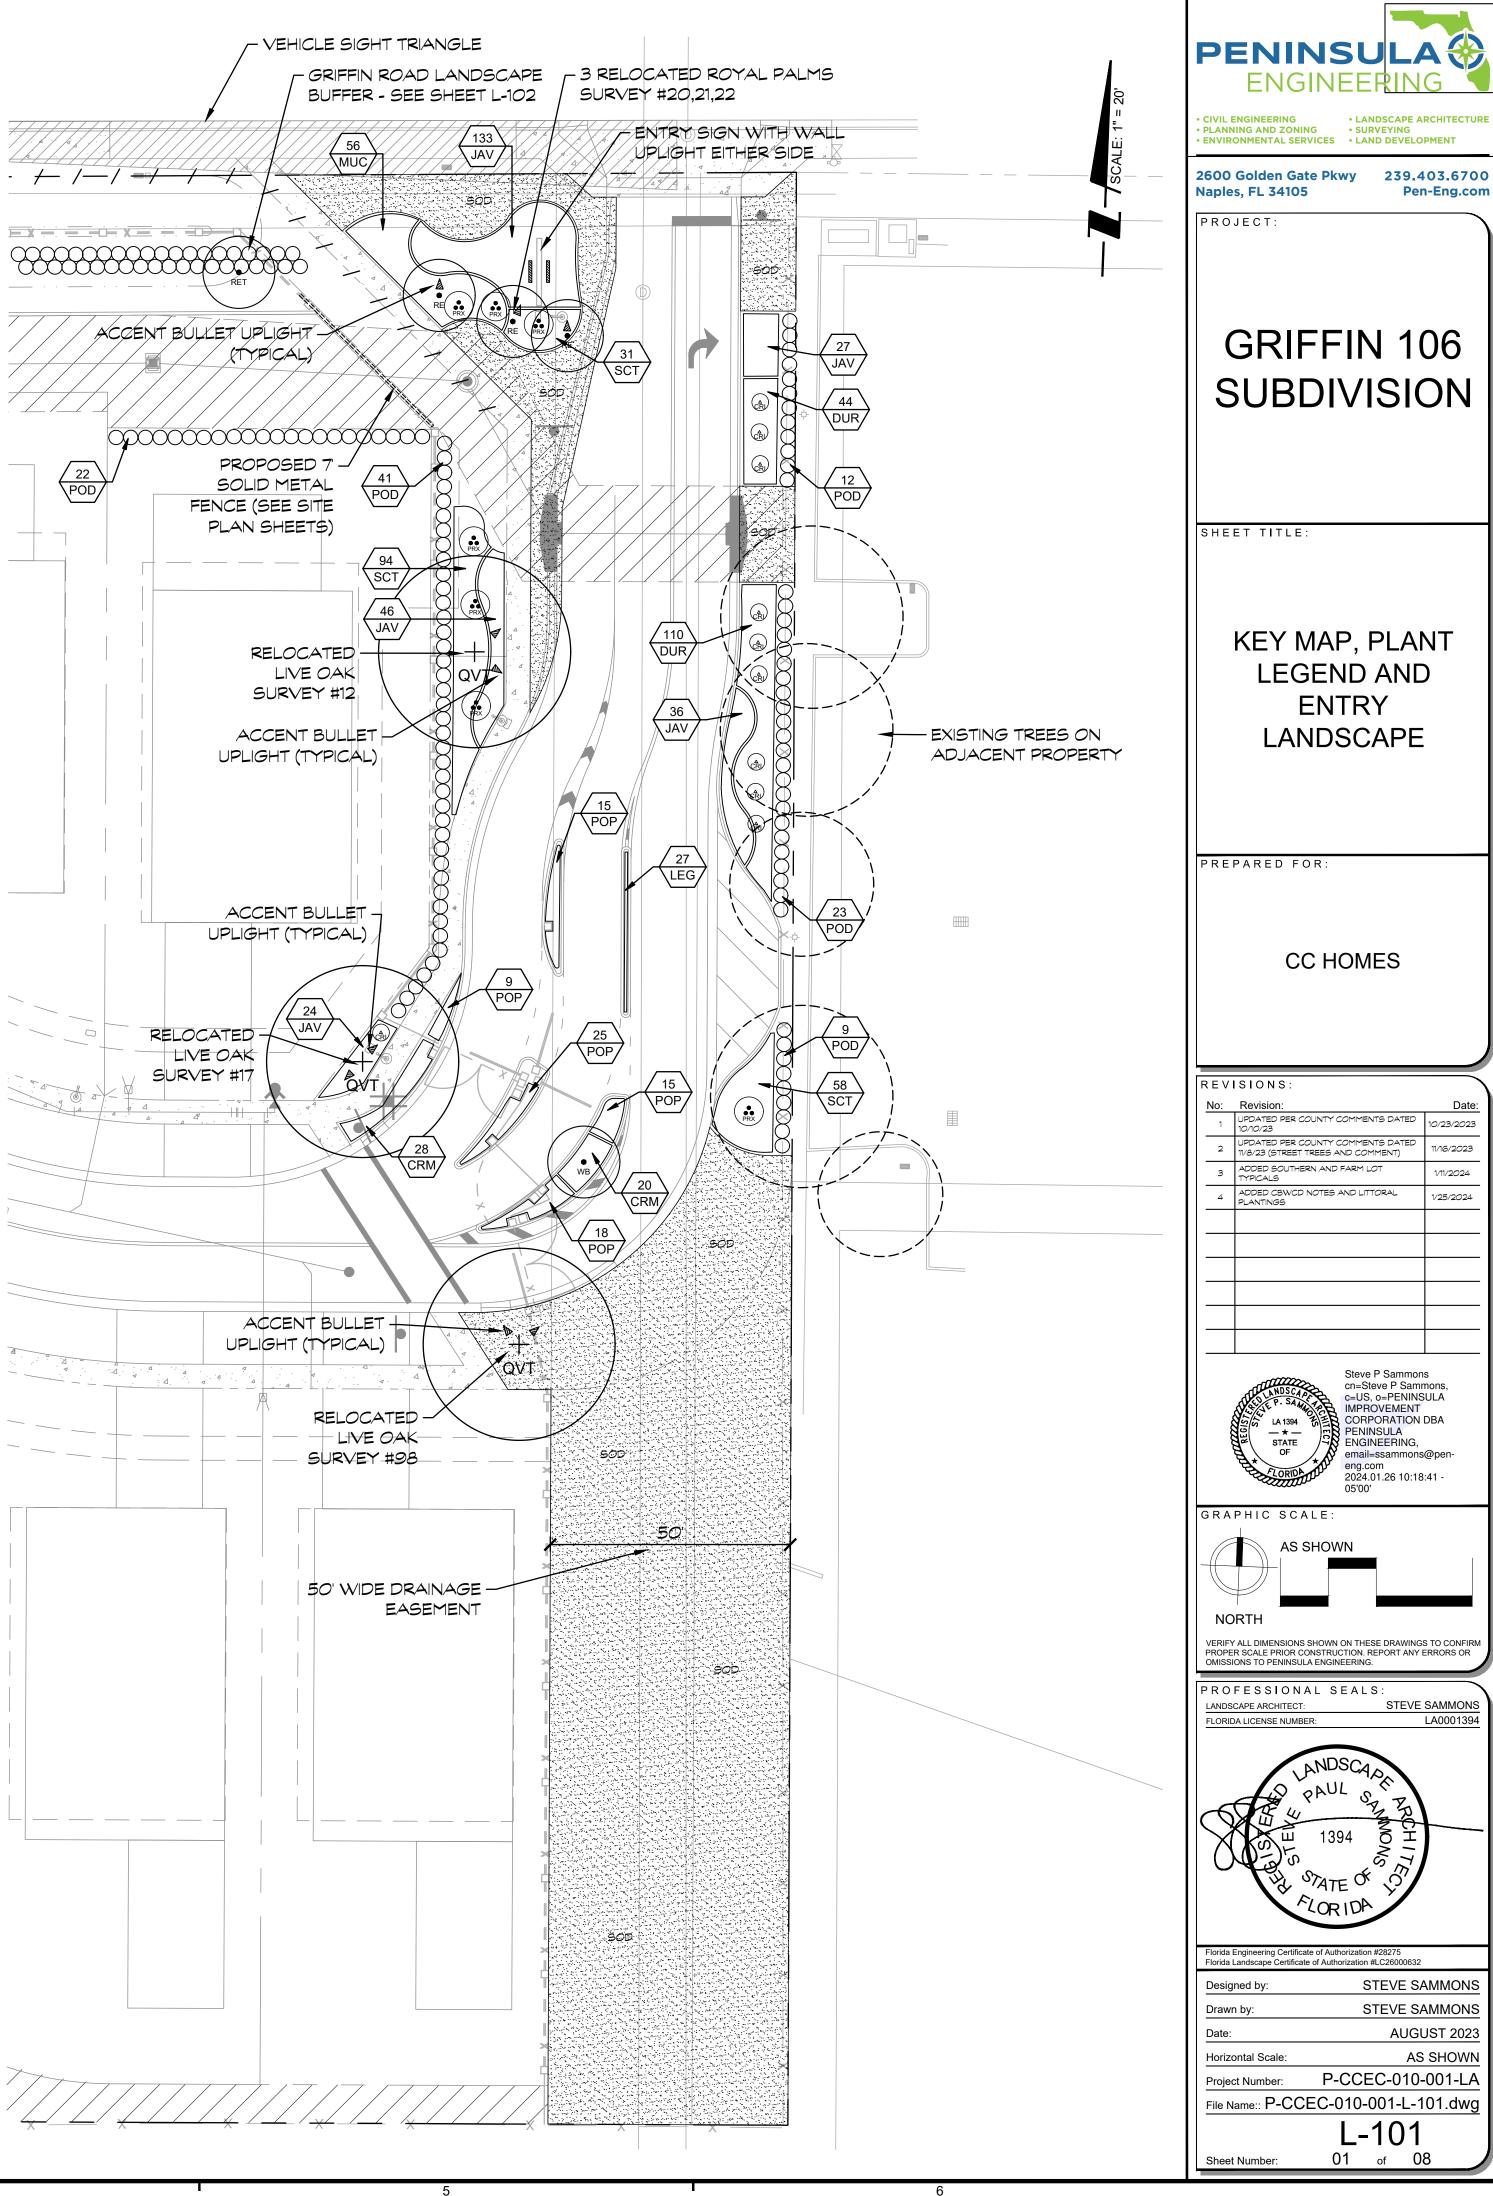


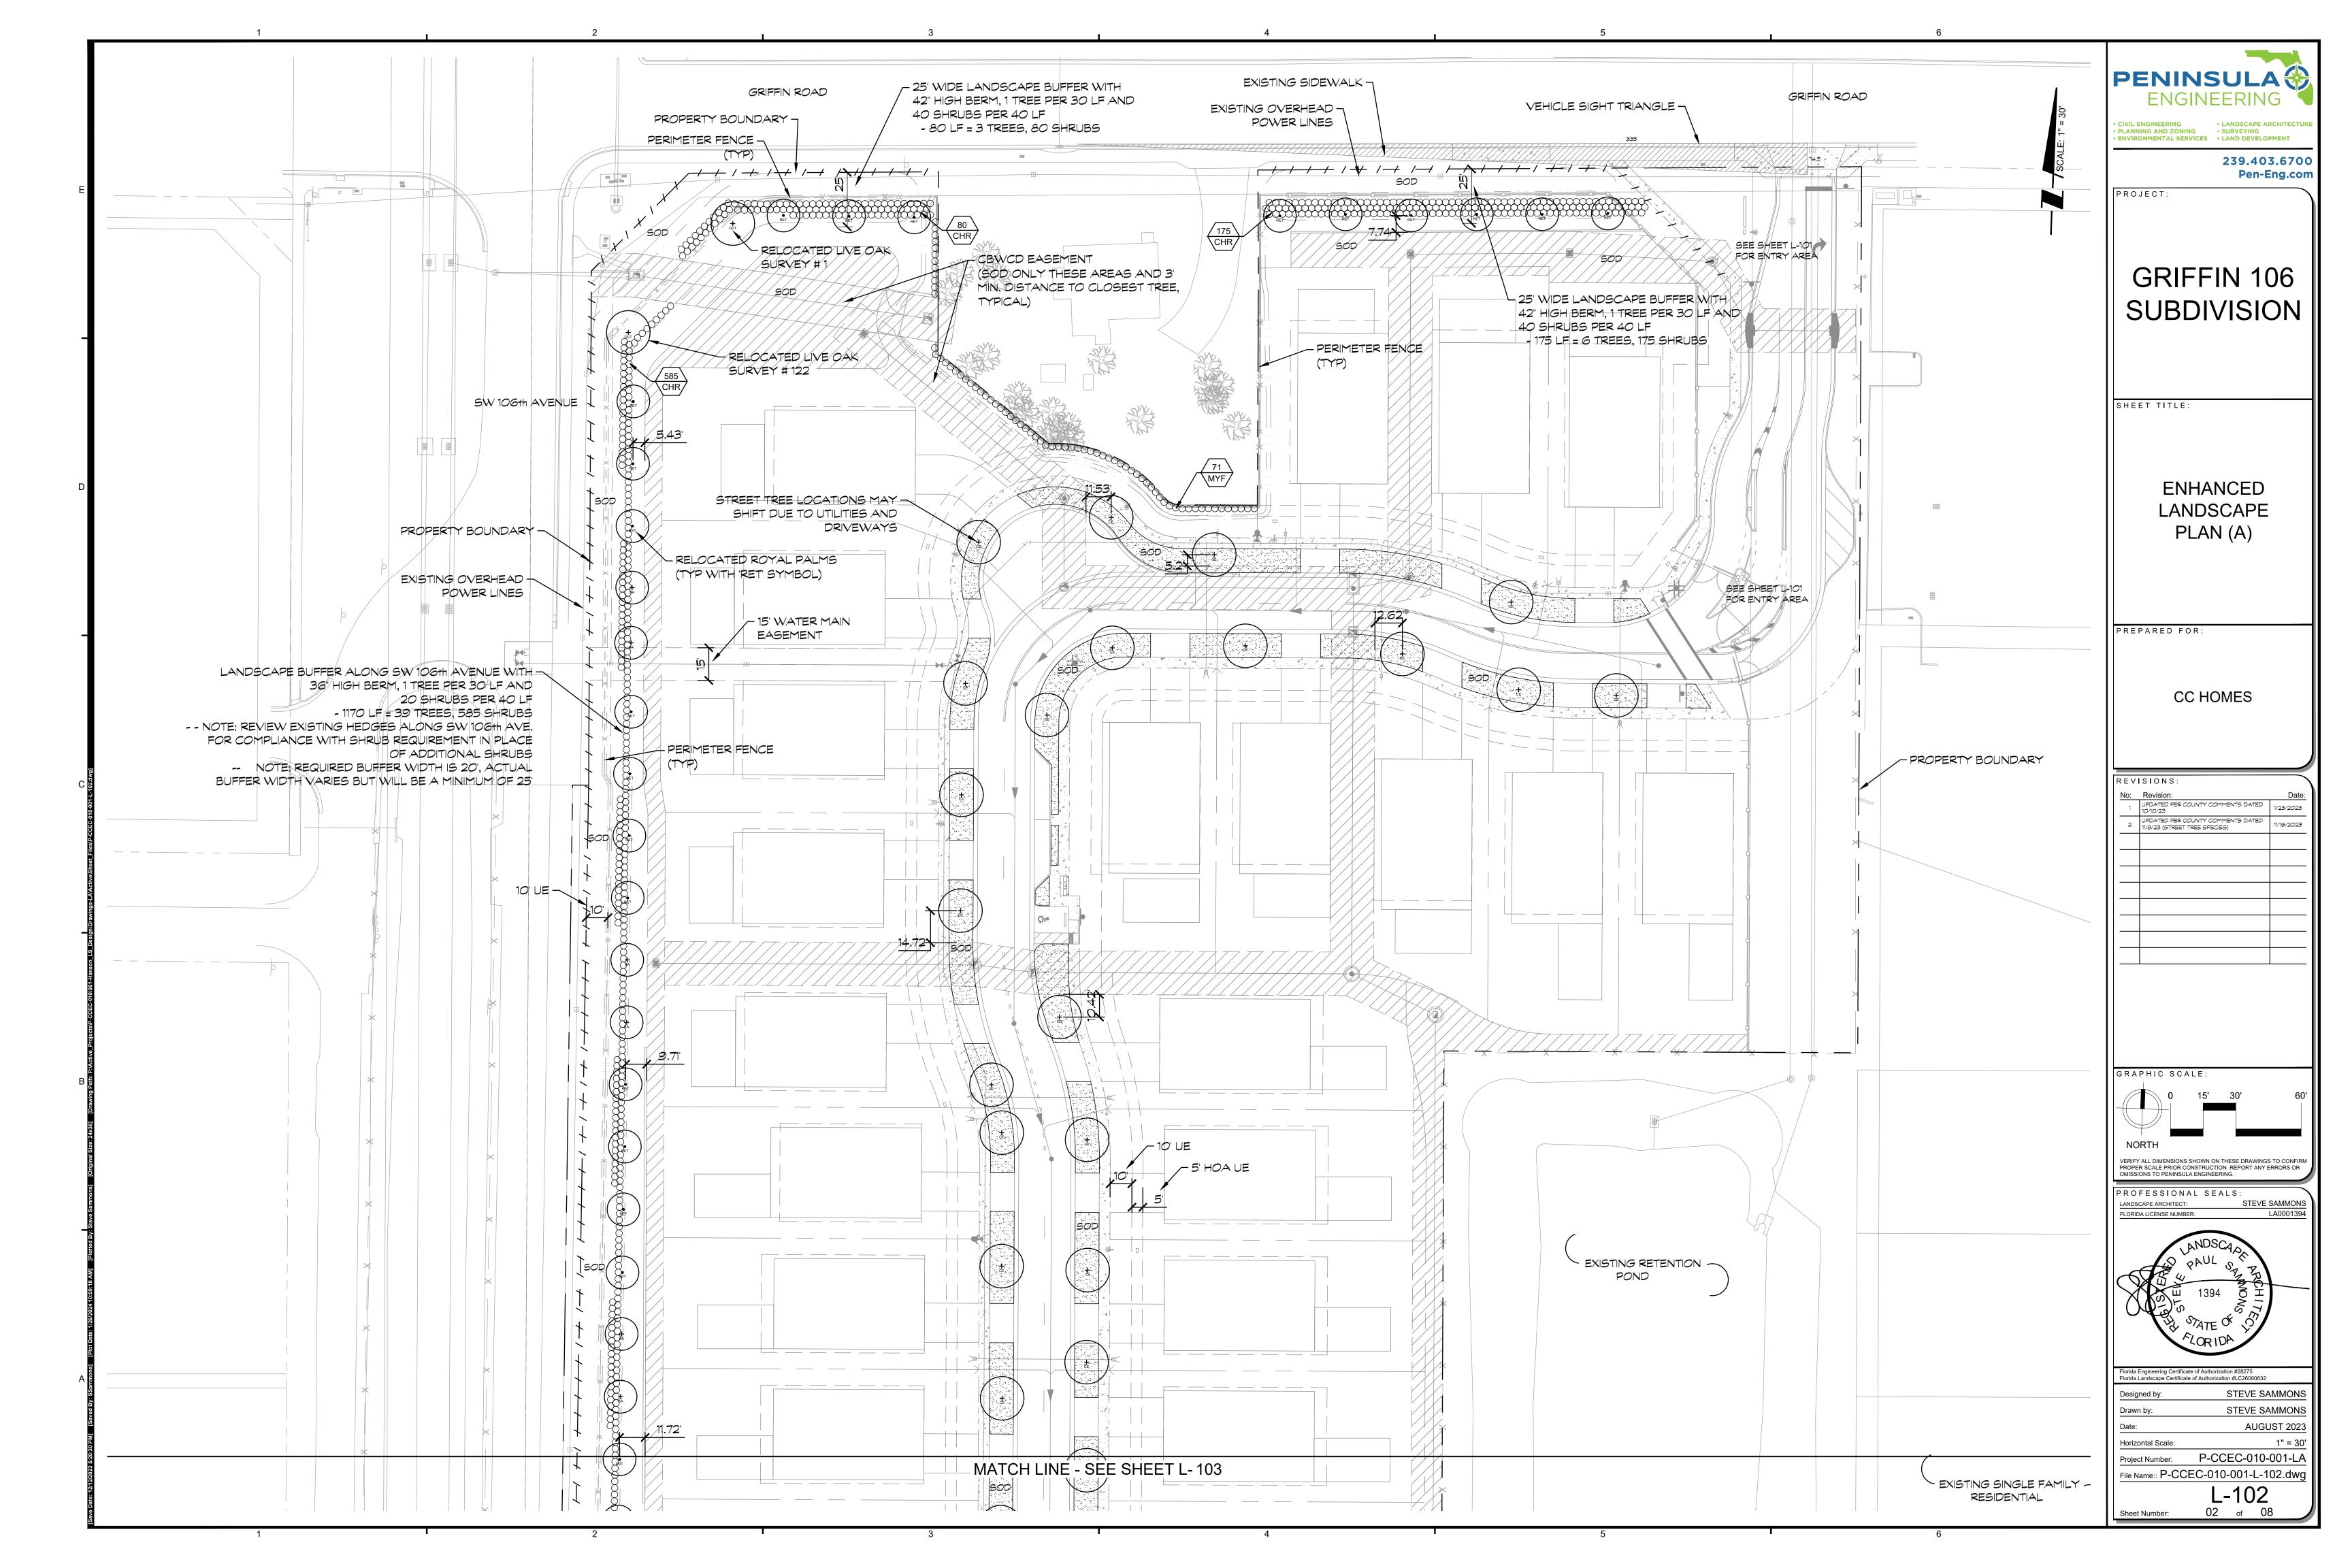

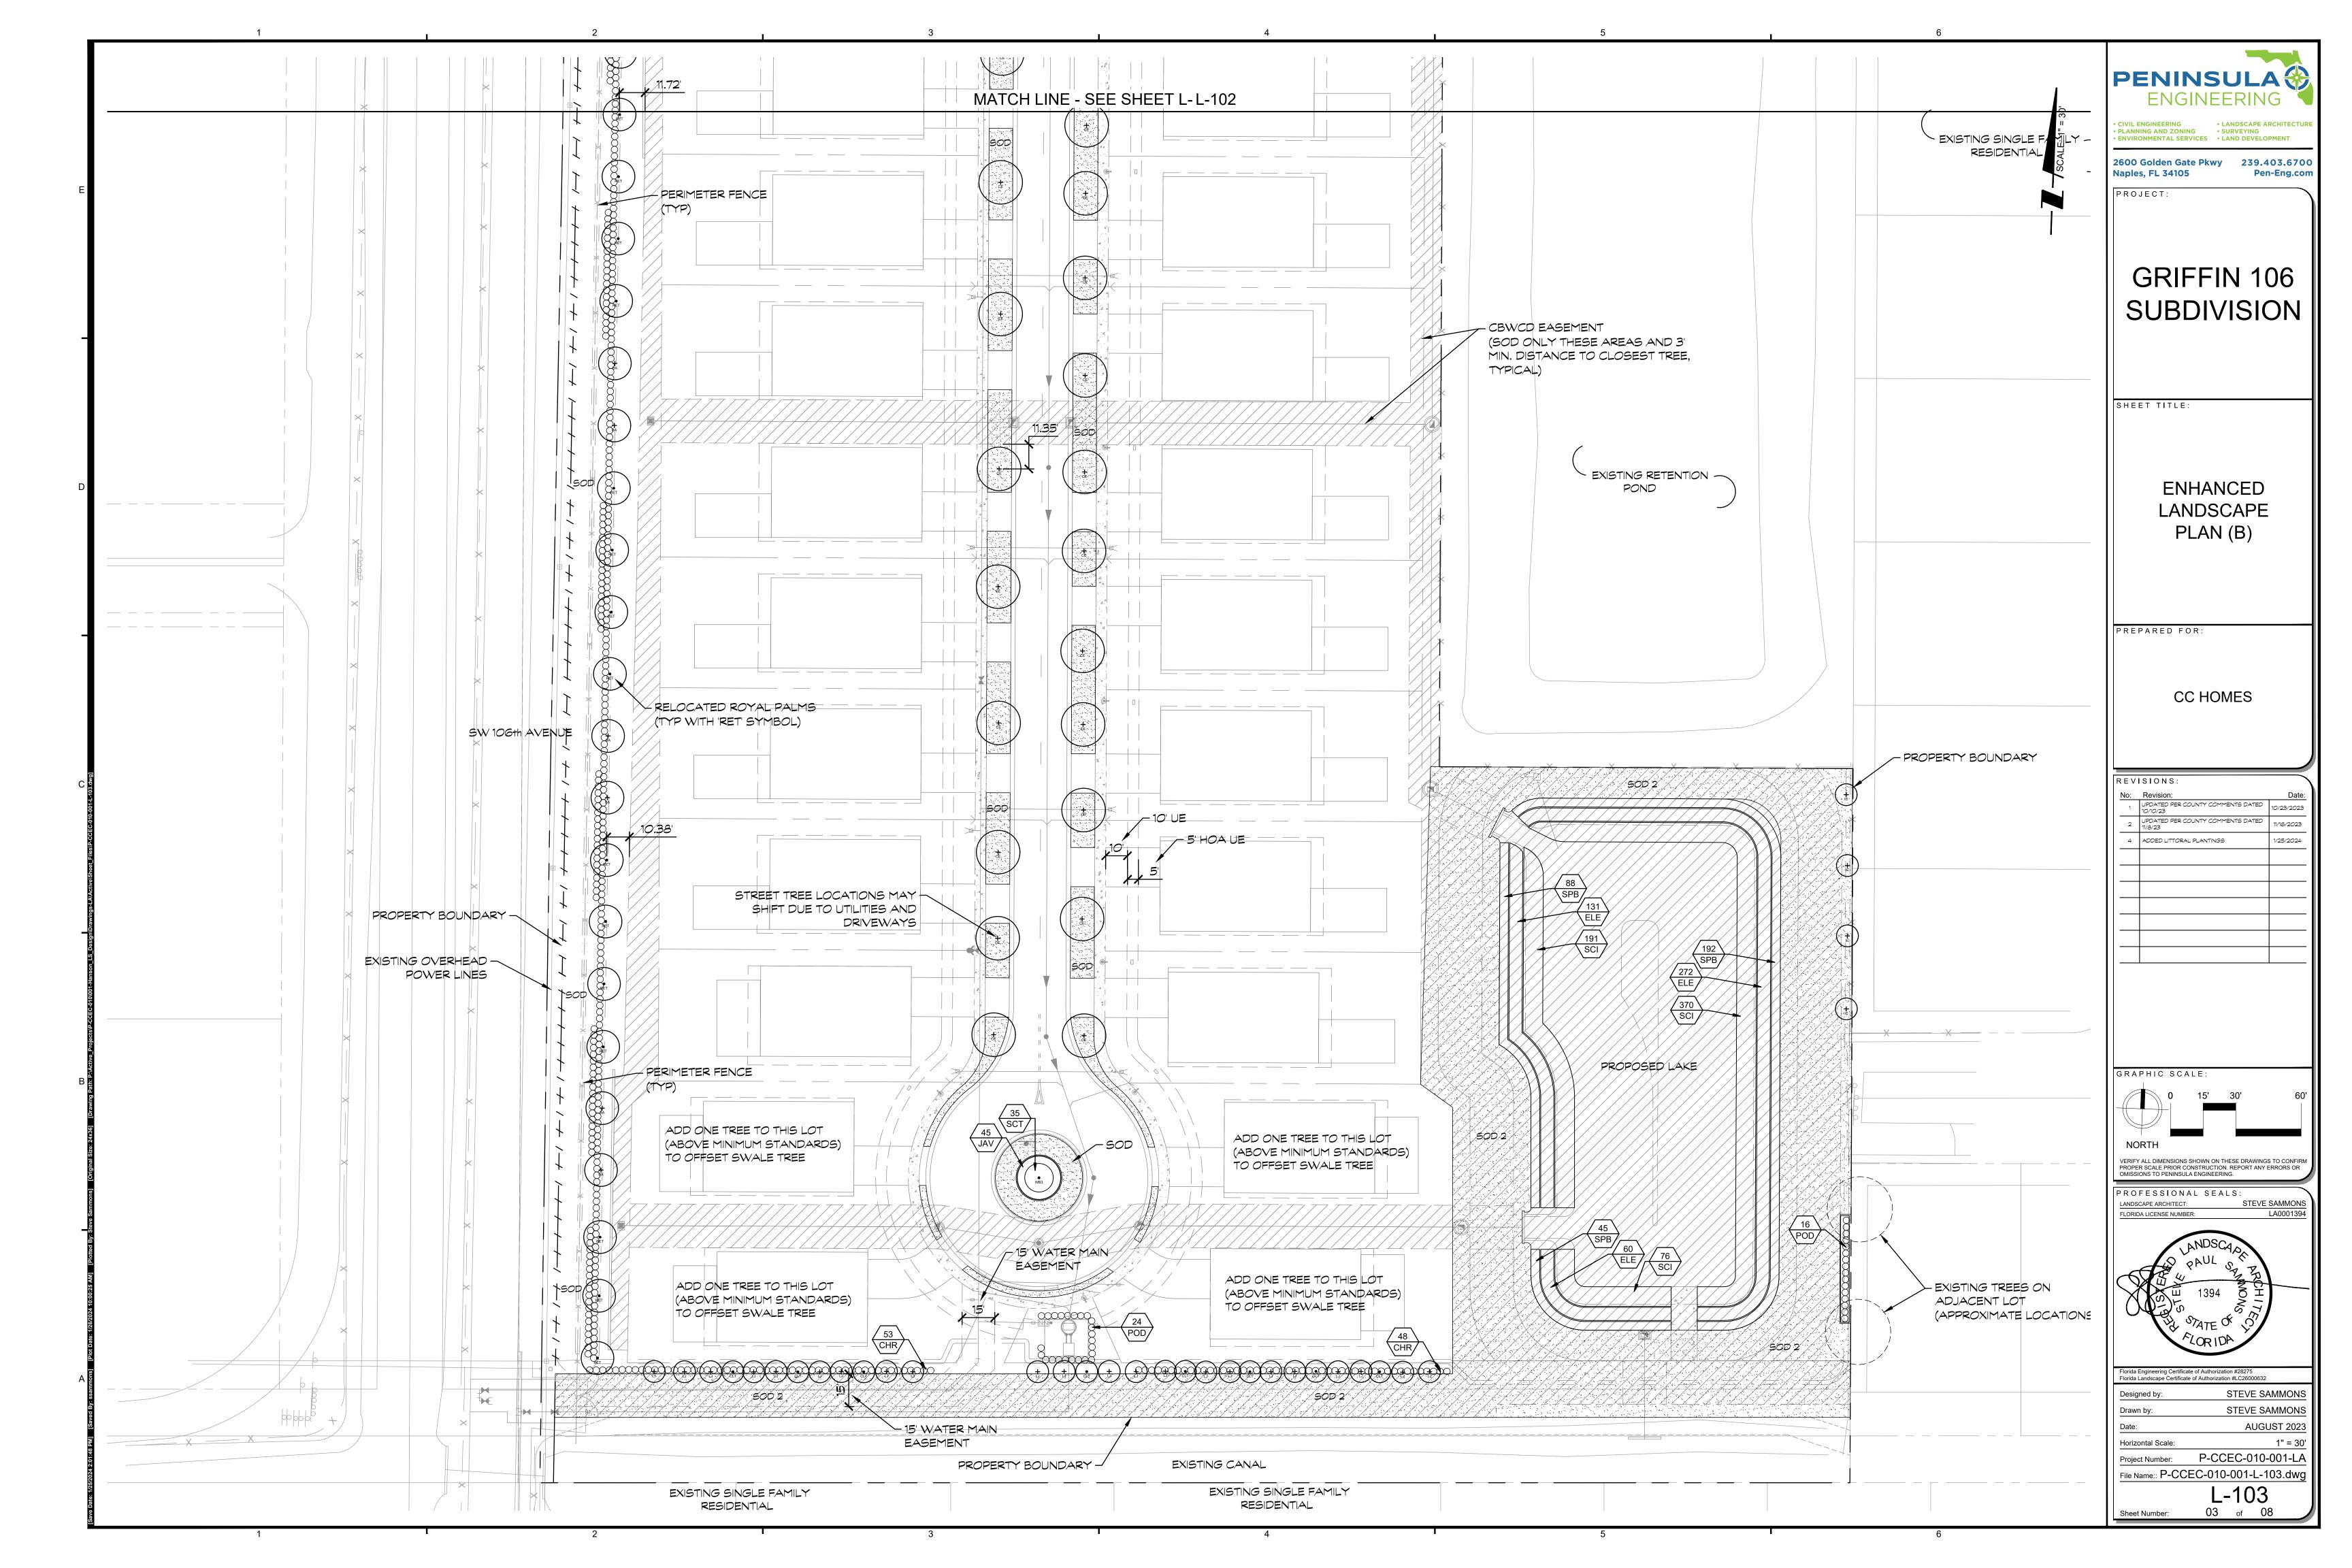

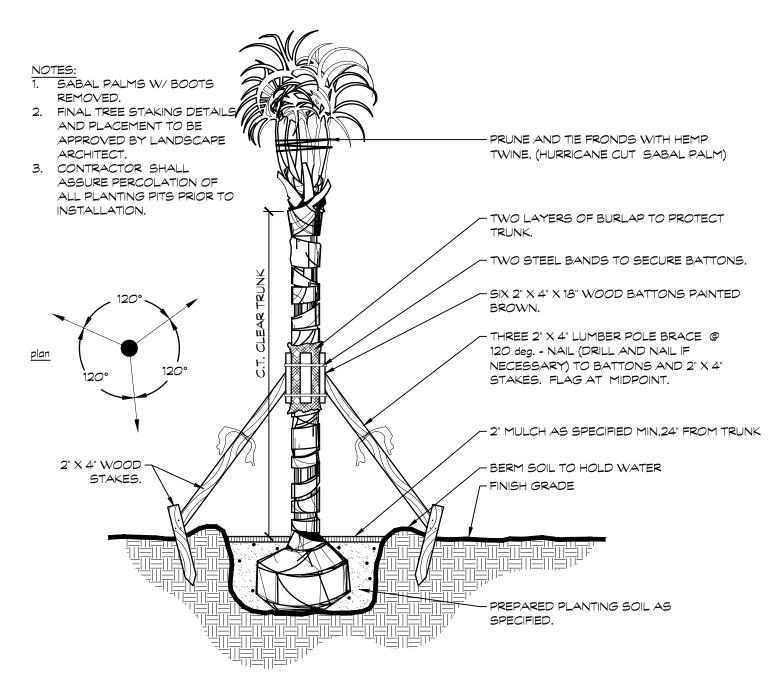


## PALM TREE DETAIL NOT TO SCALE

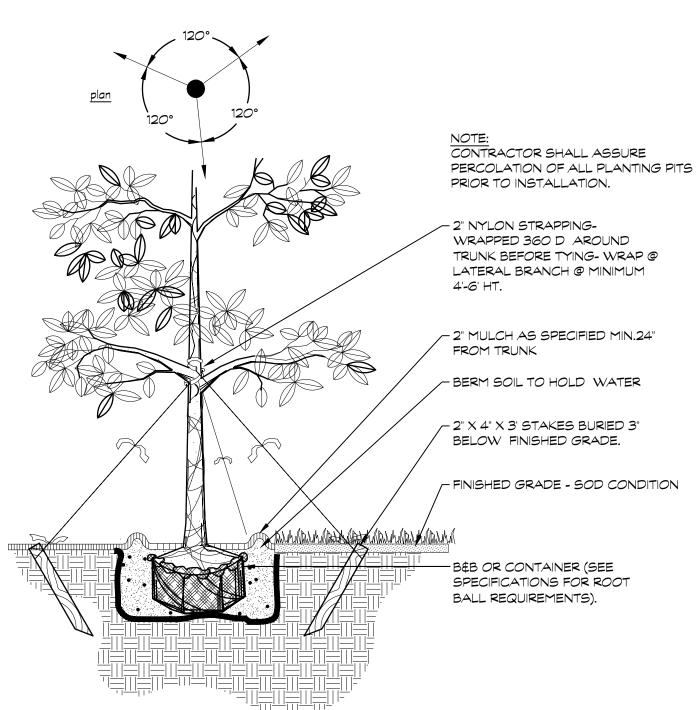

# TREE DETAIL

NOT TO SCALE

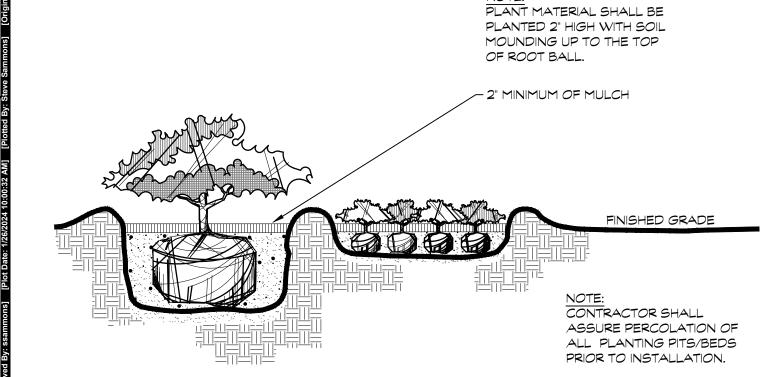

## SHRUB DETAIL

NOT TO SCALE

## LANDSCAPE INSTALLATION/MAINTENANCE GENERAL NOTES

- 1. ALL PLANTS MUST BE HEALTHY, VIGOROUS MATERIAL, FREE OF PESTS AND DISEASES. ALL PLANT MATERIAL SHALL BE IN FULL AND STRICT ACCORDANCE TO FLORIDA NO. 1 GRADE, ACCORDING TO THE "GRADES AND STANDARDS FOR NURSERY PLANTS". PUBLISHED BY FLORIDA DEPARTMENT OF AGRICULTURE AND CONSUMER SERVICES. PLANT MATERIALS IN SOME INSTANCES EXCEED NO. 1 GRADE IN ORDER TO MEET THE MINIMUM REQUIREMENTS OF THIS PROJECT
- 2. CONTRACTOR SHALL BE RESPONSIBLE FOR PLANTS MEETING SPECIFICATION AS NOTED PRIOR TO INSTALLATION. CONTRACTOR SHALL IMMEDIATELY REMOVE ALL PLANT MATERIAL THAT DOES NOT CONFORM TO SPECIFICATIONS AT THE CONTRACTOR'S EXPENSE
- 3. ALL ROOT BALLS SHALL CONFORM TO THE SIZE STANDARDS SET FORTH IN "AMERICAN STANDARDS FOR NURSERY STOCK".
- 4. ALL PLANT MATERIAL SHALL BE PROTECTED DURING TRANSPORT AND DELIVERY TO JOB SITE WITH SHADE CLOTH OR OTHER ACCEPTABLE MEANS OF WINDBURN PREVENTION. CONTRACTOR SHALL FIELD VERIFY ALL INFORMATION PRIOR TO INITIATING PLANTING INSTALLATION.
- 5. ALL EXISTING PLANTING SHALL REMAIN INTACT AND UNDISTURBED UNLESS OTHERWISE NOTED ON THE PLANS. CONTRACTOR SHALL INSTALL A 4.0' HEIGHT ORANGE NYLON OR POLYPROPYLENE TYPE FENCE AFFIXED WITH NAILS OR STAPLES TO STURDY POSTS (METAL FENCE STAKES OR 2X4 WOOD, SET TO A DEPTH OF 2.0' MINIMUM) SURROUNDING ALL EXISTING VEGETATION AND/OR VEGETATION TO BE PROTECTED AND RELOCATED. FENCE TO BE INSTALLED IN THE CRITICAL PROTECTION ZONE - THE AREA SURROUNDING A TREE WITHIN A CIRCLE DESCRIBED BY A RADIUS OF ONE (1) FOOT FOR EACH INCH OF TREE TRUNK DIAMETER MEASURED AT 54" ABOVE FINISHED GRADE (FOR GROUPS OF TREES, LOCATE FENCE BETWEEN TREES AND CONSTRUCTION ACTIVITY). THE FENCE SHALL BE LOCATED TO PROTECT A MINIMUM OF 75% OF THE CRITICAL PROTECTION ZONE. SHRUBS AND GROUNDCOVER VEGETATION SHALL HAVE A MINIMUM 5.0' BUFFER BETWEEN FENCE AND CONSTRUCTION ZONE. NO CONSTRUCTION DEBRIS, VEHICLES, CHEMICALS, OR OTHER CONSTRUCTION ACTIVITY SHALL BE ALLOWED WITHIN THE ROOT ZONE AND/OR CRITICAL PROTECTION ZONE.
- 6. ANY SUBSTITUTIONS IN SIZE AND/OR PLANT MATERIAL MUST BE APPROVED BY THE LANDSCAPE ARCHITECT IN WRITING PRIOR TO PROCUREMENT AND/OR DELIVERY TO THE WORK SITE. ALL PLANTS WILL BE SUBJECT TO APPROVAL BY LANDSCAPE ARCHITECT BEFORE PLANTING CAN BEGIN.
- 7. LANDSCAPE CONTRACTOR SHALL FIELD STAKE THE LOCATION OF ALL PLANT MATERIAL PRIOR TO INITIATING INSTALLATION FOR THE REVIEW AND APPROVAL OF THE LANDSCAPE ARCHITECT.
- 8. PRIOR TO CONSTRUCTION, THE CONTRACTOR IS RESPONSIBLE FOR LOCATING ALL UNDERGROUND UTILITIES AND SHALL AVOID DAMAGE TO ALL UTILITIES DURING CONSTRUCTION. SHOULD THE CONTRACTOR CAUSE DAMAGE TO ANY UTILITIES, NECESSARY REPAIRS SHALL BE MADE AS QUICKLY AS PRACTICABLE, AT CONTRACTOR'S EXPENSE, UNDER SUPERVISION OF THE LANDSCAPE ARCHITECT AND/OR OWNER.
- 9. INSTALLATION ALL PLANT MATERIAL SHALL BE INSTALLED IN A SOUND, WORKMANLIKE MANNER AND ACCORDING TO ACCEPTED GOOD PLANTING PROCEDURES WITH THE QUALITY OF PLANT MATERIALS AS HEREINAFTER DESCRIBED. ALL ELEMENTS OF LANDSCAPING SHALL BE INSTALLED SO AS TO MEET ALL APPLICABLE ORDINANCES AND CODE REQUIREMENTS.
- SHALL BE PLACED ON A TRIANGULAR SPACING CONFIGURATION (STAGGERED SPACING) AS SHOWN IN THE PLANTING DETAILS. PLANT CENTER TO CENTER DIMENSIONS (O.C.) ARE LISTED IN THE PLANT LIST/SCHEDULE.
- 11. CONTRACTOR SHALL ASSURE DRAINAGE AND PERCOLATION OF ALL PLANTING PITS PRIOR TO INSTALLATION OF PLANT MATERIAL. CONTRACTOR SHALL FILL ALL TREE PITS WITH WATER BEFORE PLANTING TO ASSURE THAT PROPER DRAINAGE AND PERCOLATION IS AVAILABLE. CORRECT IF REQUIRED TO ASSURE PERCOLATION. CONTRACTOR IS RESPONSIBLE FOR REPLACEMENT OF ALL PLANTS LOST DUE TO INADEQUATE DRAINAGE CONDITIONS AS DETERMINED BY THE LANDSCAPE ARCHITECT.
- 12. TREES GROWN IN GROW BAGS OR GROW BAG TYPE MATERIAL MUST HAVE THE GROW BAG REMOVED ENTIRELY PRIOR TO PLANTING .
- 13. BALLED AND BURLAPPED MATERIAL SHALL HAVE THE TOP ONE HALF (1/2) OF THE BURLAP AROUND THE BASE OF THE TRUNK CUT AND PULLED BACK. DO NOT REMOVE BURLAP. WIRE CAGES, STRAPS, ETC. MUST BE CUT AND REMOVED PRIOR TO INSTALLATION.
- 14. CONTRACTOR TO REPLACE REJECTED PLANT MATERIAL WITHIN FIVE (5) BUSINESS DAYS OF NOTICE.
- 15. CONTRACTOR SHALL REFER TO THE LANDSCAPE PLANTING DETAILS, PLANTS LIST, GENERAL NOTES AND THE PLANTING SPECIFICATIONS FOR COMPLETE LANDSCAPE PLANTING INSTRUCTIONS.
- 16. FERTILIZATION:

#### PALMS: 13-3-13 PLUS MINOR ELEMENTS - SLOW RELEASE 1/2 LB FERTILIZER PER 1/2 INCH CALIPER SHRUBS AND GROUNDCOVERS:

8-10-10 PLUS MINOR ELEMENTS - SLOW RELEASE 1/2 LB FERTILIZER PER 100 FT2

## 1/2 LB FERTILIZER PER 1/2 INCH CALIPER

16-4-8 PLUS MINOR ELEMENTS - SLOW RELEASE

8-6-6 PLUS MINOR ELEMENTS - SLOW RELEASE

## 1 LB FERTILIZER PER 1000 FT2

THE COST FOR LANDSCAPE FERTILIZER AS DESCRIBED ABOVE SHALL BE INCLUDED IN THE PER PLANT PRICE.

- 17. SOIL PREPARATION AND SOIL MIX:
- a. APPLY ROUNDUP (MANUFACTURED BY MONSANTO CORP.) OR APPROVED HERBICIDE EQUAL ACCORDING TO MANUFACTURER'S RATE AND SPECIFICATION WITHIN LIMITS OF ALL AREAS TO BE PLANTED AS NEEDED.

PROTECT EXISTING PLANTS TO REMAIN FROM OVER-SPRAY OR SPRAY WITHIN ROOT ZONE. CONTRACTOR TO ENSURE TOTAL WEED ERADICATION.

- RAKE SUBSOIL SURFACE CLEAR OF STONES (1 INCH DIAMETER AND LARGER), DEBRIS, RUBBISH, AND REMAINING FROM REMOVED PLANT MATERIAL.
- c. SCARIFY SUBSOIL TO A DEPTH OF 3 INCHES THEN APPLY "RONSTAR" OR APPROVED PRE-EMERGENT HERBICIDE IN ACCORDANCE WITH MANUFACTURER'S RATE AND SPECIFICATIONS. FOLLOW MANUFACTURER'S RECOMMENDED WAITING PERIOD PRIOR TO NEW LANDSCAPE INSTALLATION.
- d. SOIL SHALL BE NATURAL, FERTILE, AGRICULTURAL SOIL CAPABLE OF SUSTAINING VIGOROUS PLANT GROWTH. IT SHALL BE OF UNIFORM COMPOSITION THROUGHOUT, WITH ADMIXTURE OF SUBSOIL. IT SHALL BE FREE OF STONES, LUMPS, LIVE PLANTS AND THEIR ROOTS, STICKS, AND OTHER EXTRANEOUS MATTER. REMOVE ALL ROCKS AND OTHER OBJECTS OVER ONE (1) INCH IN DIAMETER.
- e. SMOOTH ALL PREPARED SOIL TO FOUR (4) INCHES BELOW TOP OF SURROUNDING PAVEMENT EDGES FINISH GRADE ALL PREPARED TOPSOIL AREAS TO A SMOOTH. EVEN SURFACE ASSURING POSITIVE DRAINAGE AWAY FROM THE STRUCTURES AND AND ELIMINATE ANY LOW AREAS WHICH MAY COLLECT WATER.
- f. SOIL SHALL NOT BE EXTREMELY ACIDIC OR ALKALINE. NOR CONTAIN TOXIC SUBSTANCES WHICH MAY BE HARMFUL TO PLANT GROWTH. THE PH SHALL BE IN THE RANGE OF 5.5 TO 6.5. IF NECESSARY, THE CONTRACTOR SHALL APPLY THE APPROPRIATE SOIL AMENDMENTS ADJUSTING SOIL PH TO ASSURE A PH RANGE OF 5.5 TO
- 20. GUYING / STAKING PRACTICES SHALL NOT PERMIT NAILS. SCREWS. WIRES ETC., TO PENETRATE OUTER SURFACE OF TREE OR PALM. TREES OR PALMS REJECTED DUE TO THIS PRACTICE SHALL BE REPLACED AT THE CONTRACTOR'S EXPENSE WITH THE LANDSCAPE ARCHITECT AND/OR OWNER ON SITE.
- 21. CONTRACTOR SHALL MULCH ALL PLANT MATERIAL THROUGHOUT AND COMPLETELY TO A TWO (2) INCH DEPTH WITH CLEAN, WEED AND STICK FREE MULCH AS SPECIFIED. COVER SHALL BE FULL WITH NO DIRT SHOWING.
- 22. INSTALLATION PERIOD: THE CONTRACTOR IS RESPONSIBLE FOR MAINTAINING IN FULL, ALL PLANTING AREAS (INCLUDING WATERING, SPRAYING, MULCHING, MOWING, FERTILIZING, ETC.) UNTIL THE JOB IS ACCEPTED IN FULL, AT THE END OF THE INSTALLATION PHASE BY THE OWNER AND LANDSCAPE ARCHITECT. CONTRACTOR TO REQUEST INSPECTION OF PROJECT IN WRITING AT END OF INSTALLATION PERIOD. LANDSCAPE ARCHITECT AND OWNER ACCEPTANCE SHALL BEGIN THE ESTABLISHMENT PERIOD.
- 23. ESTABLISHMENT PERIOD: CONTRACTOR TO GUARANTEE, MAINTAIN, AND WATER PLANT MATERIAL FOR A NINETY (90) DAY ESTABLISHMENT PERIOD FOLLOWING DATE OF INSTALLATION PERIOD COMPLETION. CONTRACTOR TO REQUEST INSPECTION OF PROJECT IN WRITING AFTER NINETY (90) DAY ESTABLISHMENT PERIOD. LANDSCAPE ARCHITECT AND OWNER ACCEPTANCE SHALL BEGIN THE GUARANTEE PERIOD.
- 24. GUARANTEE PERIOD: IF ALL WORK IS SATISFACTORY AND COMPLETE IN ACCORDANCE WITH THE CONDITIONS OF THE CONTRACT DOCUMENTS, THEN THE OWNER AND LANDSCAPE ARCHITECT SHALL DECLARE SUBSTANTIAL COMPLETION IN WRITING UPON WRITTEN REQUEST OF THE CONTRACTOR. ACKNOWLEDGMENT OF SUBSTANTIAL COMPLETION CONSTITUTES THE BEGINNING OF THE ONE (1) YEAR GUARANTEE PERIOD.
- 25. ALL PLANT MATERIAL SHALL BE OF FLORIDA NO. 1 OR BETTER QUALITY AT TIME OF INSTALLATION AND SHALL BE MAINTAINED IN THIS SAME CONDITION UNTIL COMPLETION OF THE GUARANTEE PERIOD. DECLINE IN CONDITION OF PLANT MATERIAL DURING ANY PERIOD (INSTALLATION, ESTABLISHMENT, GUARANTEE) SHALL BE GROUNDS FOR REJECTION AND REPLACEMENT AS DETERMINED BY THE LANDSCAPE ARCHITECT AT THE CONTRACTOR'S EXPENSE.
- 26. REMOVAL OF ALL STAKING AND GUYING OF TREES AND PALMS AFTER GUARANTEE PERIOD SHALL BE THE RESPONSIBILITY OF THE OWNER UNLESS OTHERWISE AGREED UPON WITH THE CONTRACTOR IN WRITING.
- 27. LANDSCAPE WILL BE IRRIGATED THROUGH A FULLY AUTOMATIC SYSTEM WITH A CONTROLLER AND APPLICABLE RAIN SENSOR AND SHALL HAVE 100% FULL HEAD TO HEAD COVERAGE. THE IRRIGATION SYSTEM WILL BE DESIGNED TO MINIMIZE THE APPLICATION OF WATER TO IMPERVIOUS AREAS AND ADJACENT PROPERTIES.
- 28. NATURAL GRADE SHALL BE MAINTAINED WITHIN THE CRITICAL ROOT ZONE OF ALL TREES TO BE PRESERVED (SEE NOTES BELOW).
- 29. ROOT BARRIERS ARE REQUIRED WHEN LARGE CANOPY TREES (FOR EXAMPLE LIVE OAKS) ARE WITHIN 15' OF A BUILDING OR 10' OF A SIDEWALK, PAVED AREA OR UNDERGROUND UTILITY AND SHALL RUN PARALLEL WITH BUILDING, PAVEMENT OR UTILITY TO A DISTANCE 20' OUT EITHER DIRECTION FROM THE TRUNK. ROOT BARRIERS SHALL BE A MINIMUM OF 18" DEEP AND SHALL EXTEND UP TO FINISH GRADE. ROOT BARRIER PRODUCTS SHALL BE APPROVED BY OWNER AND LANDSCAPE ARCHITECT AND INSTALLED IN ACCORDANCE WITH MANUFACTURER SPECIFICATIONS.

**PENINSULA ENGINEERING** 

NVIRONMENTAL SERVICES • LAND DEVELOPMENT

239.403.670 Pen-Eng.co

GRIFFIN 106 SUBDIVISION

**ENHANCED LANDSCAPE NOTES AND DETAILS** 


**CC HOMES** 

REV	ISIONS:	
No:	Revision:	Date
4	ADDED ROOT BARRIER NOTE	1/25/2024
-		

GRAPHIC SCALE

VERIFY ALL DIMENSIONS SHOWN ON THESE DRAWINGS TO CONFI

PROPER SCALE PRIOR CONSTRUCTION. REPORT ANY ERRORS OF OMISSIONS TO PENINSULA ENGINEERING. PROFESSIONAL SEALS

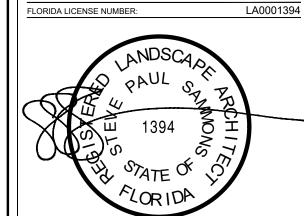

Florida Engineering Certificate of Authorization #28275 Florida Landscape Certificate of Authorization #LC2600063 STEVE SAMMON STEVE SAMMON **AUGUST 202** 

P-CCEC-010-001-L/ File Name:: P-CCEC-010-001-L-104.dw

Horizontal Scale:

L-104 Sheet Number: 04 of 08

<b>-</b>	6.21-6.22.23	10550 Griffin Rd. Coope			ry trees)	CLEAR	
TREE #	COMMON NAME	BOTANICAL NAME	HEIGHT (ft)	WIDTH (ft)	DBH (in)	TRUNK (ft)	DISPOSITION
1	Live Oak	Quercus virginiana	24	30	20		Relocate on site
2	Sabal Palm	Sabal palmetto	8	8	17	4	Remove
3	Sabal Palm	Sabal palmetto	16	8	17	12	Remove
4	Stranger Fig	Ficus aurea	48	50	80		Remove
5	Stranger Fig	Ficus aurea	49	33	44		Remove
6	Stranger Fig	Ficus aurea	40	52	80		Remove
7	Date Palm	Phoenix dactylifera	20	16	15	10	Remove
8	Date Palm	Phoenix dactylifera	19	18	15	8	Remove
9	Royal Palm	Roystonea elata	43	16	20	38	Relocate on site
10	Royal Palm	Roystonea elata	43,1	16	16	38	Relocate on site
11	Royal Palm	Roystonea elata	20	13	10	13	Remove
12	Live Oak	Quercus virginiana	36	48	37		Relocate on site
13	Stranger Fig	Ficus aurea	24	40	27		Remove
14	Royal Palm	Roystonea elata	22	14	11	13	Relocate on site
15	Chinese Banyon	Ficus microcarpa	41	50	61		Remove
16	Stranger Fig	Ficus aurea	32	40	34		Remove
17	Live Oak	Quercus virginiana	43	54	36		Relocate on site
18	Stranger Fig	Ficus aurea	34	56	36		Remove
19	Fishtail Palm	Caryota mitis	25	14	9" multi	18	Remove
20	Royal Palm	Roystonea elata	64	16	22	51	Relocate on site
21	Royal Palm	Roystonea elata	55	16	11	45	Relocate on site
22	Royal Palm	Roystonea elata	55	16	13	45	Relocate on site
23	Chinese Banyon	Ficus microcarpa	35	27	45		Remove
24	Stranger Fig	Ficus aurea	20	23	16		Remove
25	Chinese Banyon	Ficus microcarpa	35	45	65		Remove
26	Stranger Fig	Ficus aurea	34	29	55		Remove
27	Royal Palm	Roystonea elata	61	16	24	51	Relocate on site
28	Royal Palm	Roystonea elata	61	16	18	51	Relocate on site
29	Royal Palm	Roystonea elata	61	16	24	51	Relocate on site
30	Stranger Fig	Ficus aurea	29	25	37		Remove
31	Stranger Fig	Ficus aurea	29	25	18		Remove
32	Stranger Fig	Ficus aurea	26?6	20	13		Remove
33	Royal Palm	Roystonea elata	22	10	7	12	Remove
34	Royal Palm	Roystonea elata	26	16	18	16	Remove
35	Stranger Fig	Ficus aurea	32	30	18		Remove
36	Stranger Fig	Ficus aurea	32	30	37		Remove
37	Stranger Fig	Ficus aurea	34	23	16		Remove
38	Coconut Palm	Cocos nucifera	17	16	13	7	Remove
39	Stranger Fig	Ficus aurea	30	40	26		Remove
40	Royal Palm	Roystonea elata	61	16	24	51	Off site
41	Coconut Palm	Cocos nucifera	25	16	12	14	Off site
42	Coconut Palm	Cocos nucifera	29	16	12	19	Off site
43	Coconut Palm	Cocos nucifera	29	16	12	19	Off site
44	Coconut Palm	Cocos nucifera	29	16	12	19	Off site
44 45	Coconut Palm	Cocos nucifera	29	16	12	19	Off site
45 46	Coconut Palm	Cocos nucifera	286	16	12	18	Off site
	Coconut Palm Coconut Palm		43	16	12	33	Oπ site Off site
47		Cocos nucifera				 	
48 	Live Oak	Quercus virginiana	35	24	19 18" cluster	10	Off site
49 	Areca Palm	Dypsis lutescens	22	13			Relocate on site
50 	Coconut Palm	Cocos nucifera	19	16	15	9	Remove
51	Stranger Fig	Ficus aurea	35	27	43	47	Remove
52	Royal Palm	Roystonea elata	57	16	22	47	Remove
53	Stranger Fig	Ficus aurea	49	45	60		Remove
54	Stranger Fig	Ficus aurea	37	35	50		Remove
55	Royal Palm	Roystonea elata	35	16	18	25	Relocate on site
56	Willow Oak	Quercus phellos	30	25	18		Remove
57	Areca Palm	Dypsis lutescens	18	14	18" cluster	14	Remove
58	Areca Palm	Dypsis lutescens	13	9	14" cluster	9	Relocate on site
59	Areca Palm	Dypsis lutescens	23	12	18" cluster	17	Relocate on site
60	Stranger Fig	Ficus aurea	28	32	35		Remove

61	Stranger Fig	Ficus aurea	17	13	13		Remove
62	Areca Palm	Dypsis lutescens	19	13	18" cluster	13	Relocate on site
63	Live Oak	Quercus virginiana	30	22	20		Remove
64	Stranger Fig	Ficus aurea	32	30	16		Remove
65	Stranger Fig	Ficus aurea	32	30	16		Remove
66	Stranger Fig	Ficus aurea	32	30	16		Remove
67	Areca Palm	Dypsis lutescens	27	14	18" cluster	23	Off site
68	Areca Palm	Dypsis lutescens	27	14	18" cluster	23	Off site
69	Queen Palm	Syagrus romanzoffiana	33	12	6, 3	27	Off site
70	Queen Palm	Syagrus romanzoffiana	30	14	8, 6	24	Off site
71	Queen Palm	Syagrus romanzoffiana	20	12	6, 2	14	Off site
73	Royal Palm	Roystonea elata	53	16	13	43	Off site
74	Queen Palm	Syagrus romanzoffiana	30	10	9	22	Off site
75	Queen Palm	Syagrus romanzoffiana	30	10	8, 4	22	Off site
76	Queen Palm	Syagrus romanzoffiana	30	10	9	22	Off site
77	Queen Palm	Syagrus romanzoffiana	30	10	9	22	Off site
78	Queen Palm	Syagrus romanzoffiana	30	10	6	22	Off site
79	Queen Palm	Syagrus romanzoffiana	16	10	6	8	Off site
80	Gumbo Limbo	Bursera simaruba	25	7	4		Off site
81	Queen Palm	Syagrus romanzoffiana	30	12	8	20	Off site
82	Queen Palm	Syagrus romanzoffiana	30	13	8	20	Off site
83	Queen Palm	Syagrus romanzoffiana	30	12	8	20	Off site
84	Areca Palm	Dypsis lutescens	26	13	18" cluster		Off site
85	Areca Palm	Dypsis lutescens	26	13	18" cluster		Off site
86	Areca Palm	Dypsis lutescens	26	13	18" cluster		Off site
87		Veitchia arecina	50	12	7	44	Off site
	Montgomery Palm				18" cluster		
88	Areca Palm	Dypsis lutescens	26	13			Off site
89	Areca Palm	Dypsis lutescens	26	13	18" cluster	23	Off site
90	Live Oak	Quercus virginiana	24	17	11		Off site
91	Areca Palm	Dypsis lutescens	26	13	18" cluster	23	Off site
92	Black Olive	Bucida buceras	47	34	30		Off site
93	Weeping Fig	Ficus benjamina	42	30	47		Off site
94	Queen Palm	Syagrus romanzoffiana	21	12	4	14	Off site
95	Stranger Fig	Ficus aurea	27	25	8		Remove
96	Stranger Fig	Ficus aurea	27	20	7		Remove
97	Royal Palm	Roystonea elata	45	16	24	35	Remove
98	Live Oak	Quercus virginiana	38	46	31		Relocate on site
99	Sabal Palm	Sabal palmetto	12	8	12	6	Remove
100	Stranger Fig	Ficus aurea	37	34	20		Remove
101	Live Oak	Quercus virginiana	36	25	15		Remove
102	Live Oak	Quercus virginiana	47	18	18		Remove
103	Areca Palm	Dypsis lutescens	25	13	18" cluster		Remove
104	Areca Palm	Dypsis lutescens	25	13	18" cluster	18	Remove
105	Live Oak	Quercus virginiana	14	6	4		Remove
106	Live Oak	Quercus virginiana	28	12	10		Remove
107	Areca Palm	Dypsis lutescens	22	13	18" cluster	17	Relocate on site
108	Royal Palm	Roystonea elata	26	14	11	19	Remove
109	Royal Palm	Roystonea elata	66	16	23	56	Relocate on site
110	Royal Palm	Roystonea elata	66	16	23	56	Relocate on site
111	Royal Palm	Roystonea elata	66	16	23	56	Relocate on site
112	Royal Palm	Roystonea elata	66	16	23	56	Relocate on site
113	Sabal Palm	Sabal palmetto	26	8	15	22	Remove
114	Royal Palm	Roystonea elata	66	16	23	56	Relocate on site
115	Royal Palm	Roystonea elata	66	16	23	56	Relocate on site
116	Royal Palm	Roystonea elata	18	12	7	10	Remove
117	Queen Palm	Syagrus romanzoffiana	46	12	10	36	Remove
118	Chinese Banyon	Ficus microcarpa	36	33	60		Remove
119	Areca Palm	Dypsis lutescens	25	14	18" cluster	22	Relocate on site
120	Royal Palm	Roystonea elata	31	16	14	21	Relocate on site
	<b> </b>	-		-	11	21	

122	Live Oak	Quercus virginiana	32	22	14		Relocate on site
123	Royal Palm	Roystonea elata	40	16	13	30	Relocate on site
124	Stranger Fig	Ficus aurea	26	27	16		Remove
125	Royal Palm	Roystonea elata	30	12	8	20	Remove
126	Royal Palm	Roystonea elata	47	16	24	37	Relocate on site
127	Royal Palm	Roystonea elata	25	12	9	19	Relocate on site
128	Royal Palm	Roystonea elata	35	16	24	25	Relocate on site
129	Royal Palm	Roystonea elata	35	16	18	25	Relocate on site
130	Areca Palm	Dypsis lutescens	32	13	14" cluster	27	Relocate on site
131	Royal Palm	Roystonea elata	25	14	11	17	Relocate on site
132	Royal Palm	Roystonea elata	42	16	24	32	Relocate on site
133	Royal Palm	Roystonea elata	50	16	18	40	Relocate on site
134	Royal Palm	Roystonea elata	50	16	18	40,3	Relocate on site
135	Royal Palm	Roystonea elata	33	16	12	23	Relocate on site
136	Royal Palm	Roystonea elata	52	16	24	42	Relocate on site
137	Royal Palm	Roystonea elata	52	16	24	42	Relocate on site
138	Royal Palm	Roystonea elata	52	16	18	42	Relocate on site
139	Royal Palm	Roystonea elata	52	16	24	42	Relocate on site
140	Royal Palm	Roystonea elata	52	16	16	42	Relocate on site
141	Royal Palm	Roystonea elata	55	16	27	45	Relocate on site
142	Royal Palm	Roystonea elata	55	16	27	45	Relocate on site
143	Royal Palm	Roystonea elata	59	16	15	49	Relocate on site
144	Areca Palm	Dypsis lutescens	16	13	15" cluster	12	Relocate on site
145	Coconut Palm	Cocos nucifera	18	8	13	3	Remove



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PROJECT:

GRIFFIN 106 SUBDIVISION

SHEET TITLE:


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PREPARED FOR:


CC HOMES

REV	ISIONS:	
No:	Revision:	Date
1	UPDATE DISPOSITION TABLE (50, 113, 145)	1/23/2023
		•

GRAPHIC SCALE:

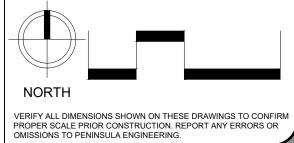

PROFESSIONAL SEALS:

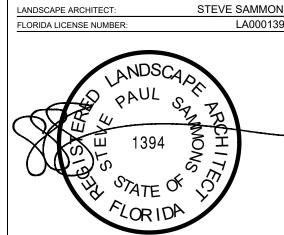

	Florida Engineering Certificate of Authorization #28275 Florida Landscape Certificate of Authorization #LC26000632					
Designed by:	STEVE SAMMO					
Drawn by:	STEVE SAMMO					
Date:	AUGUST 20					

Project Number: P-CCEC-010-001-LA File Name:: P-CCEC-010-001-L-105.dwg

L-105
Sheet Number: 05 of 08

16


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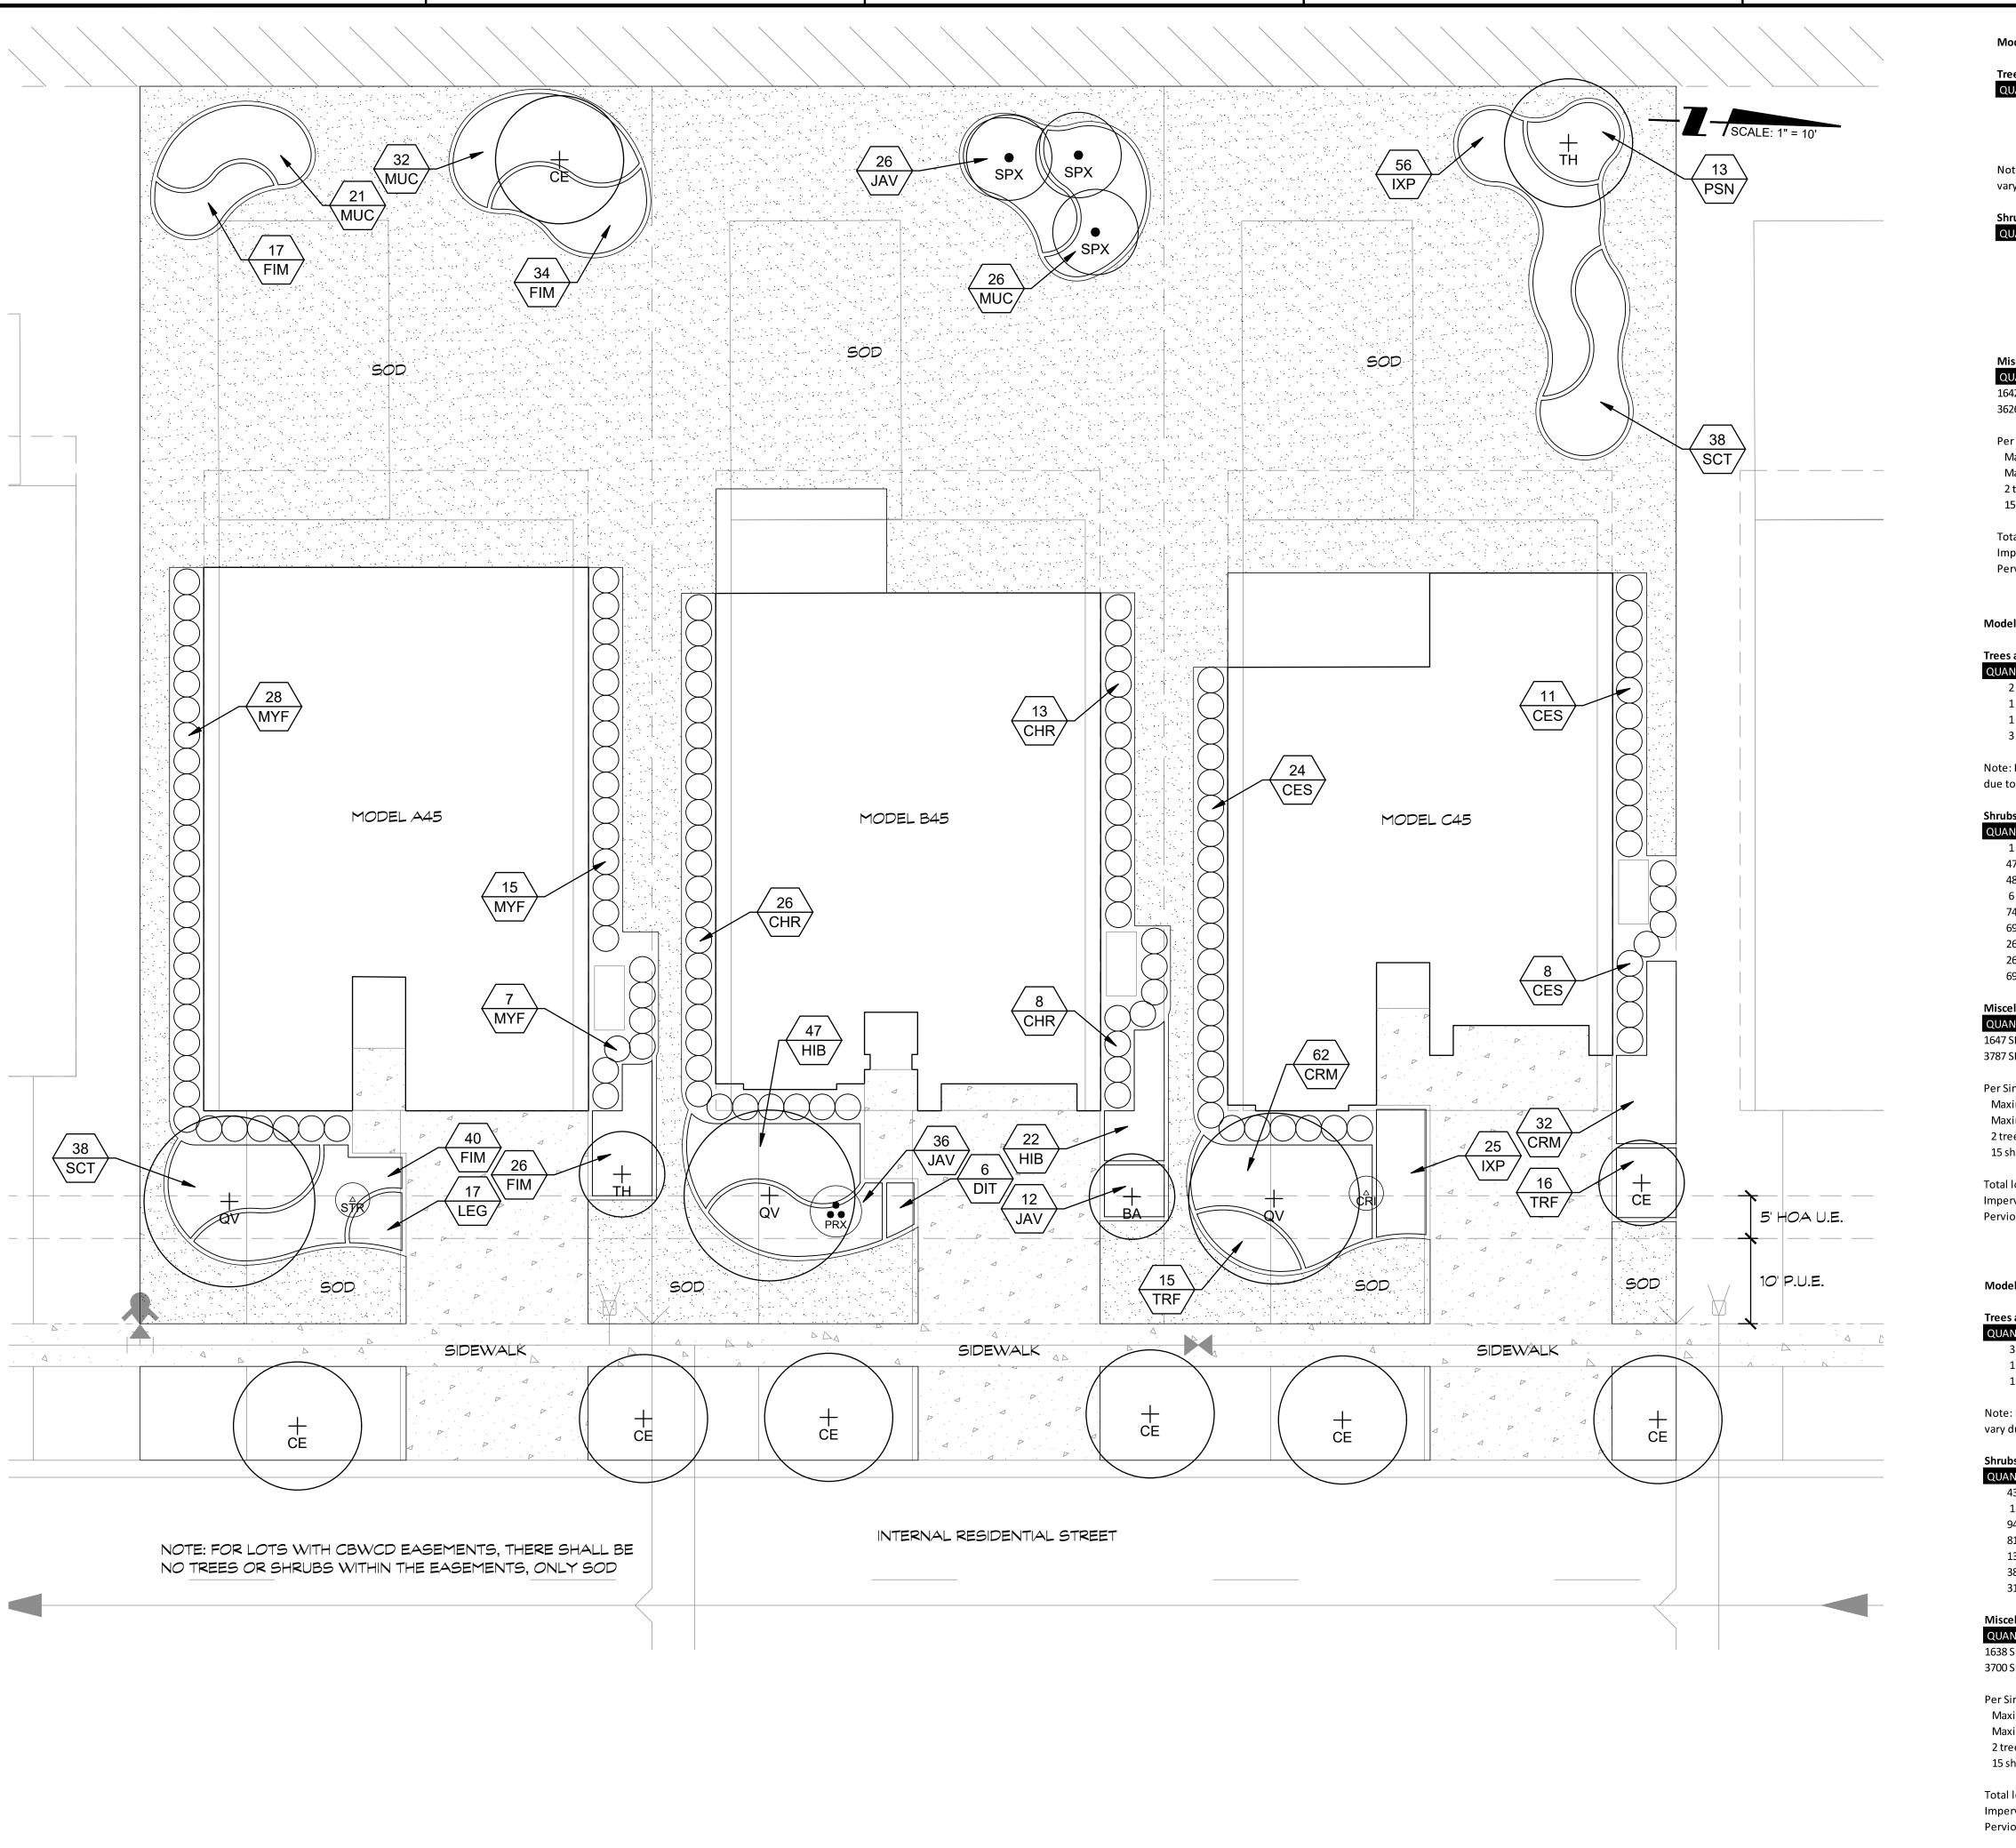
31

Roystonea elata

121 Royal Palm

Relocate on site



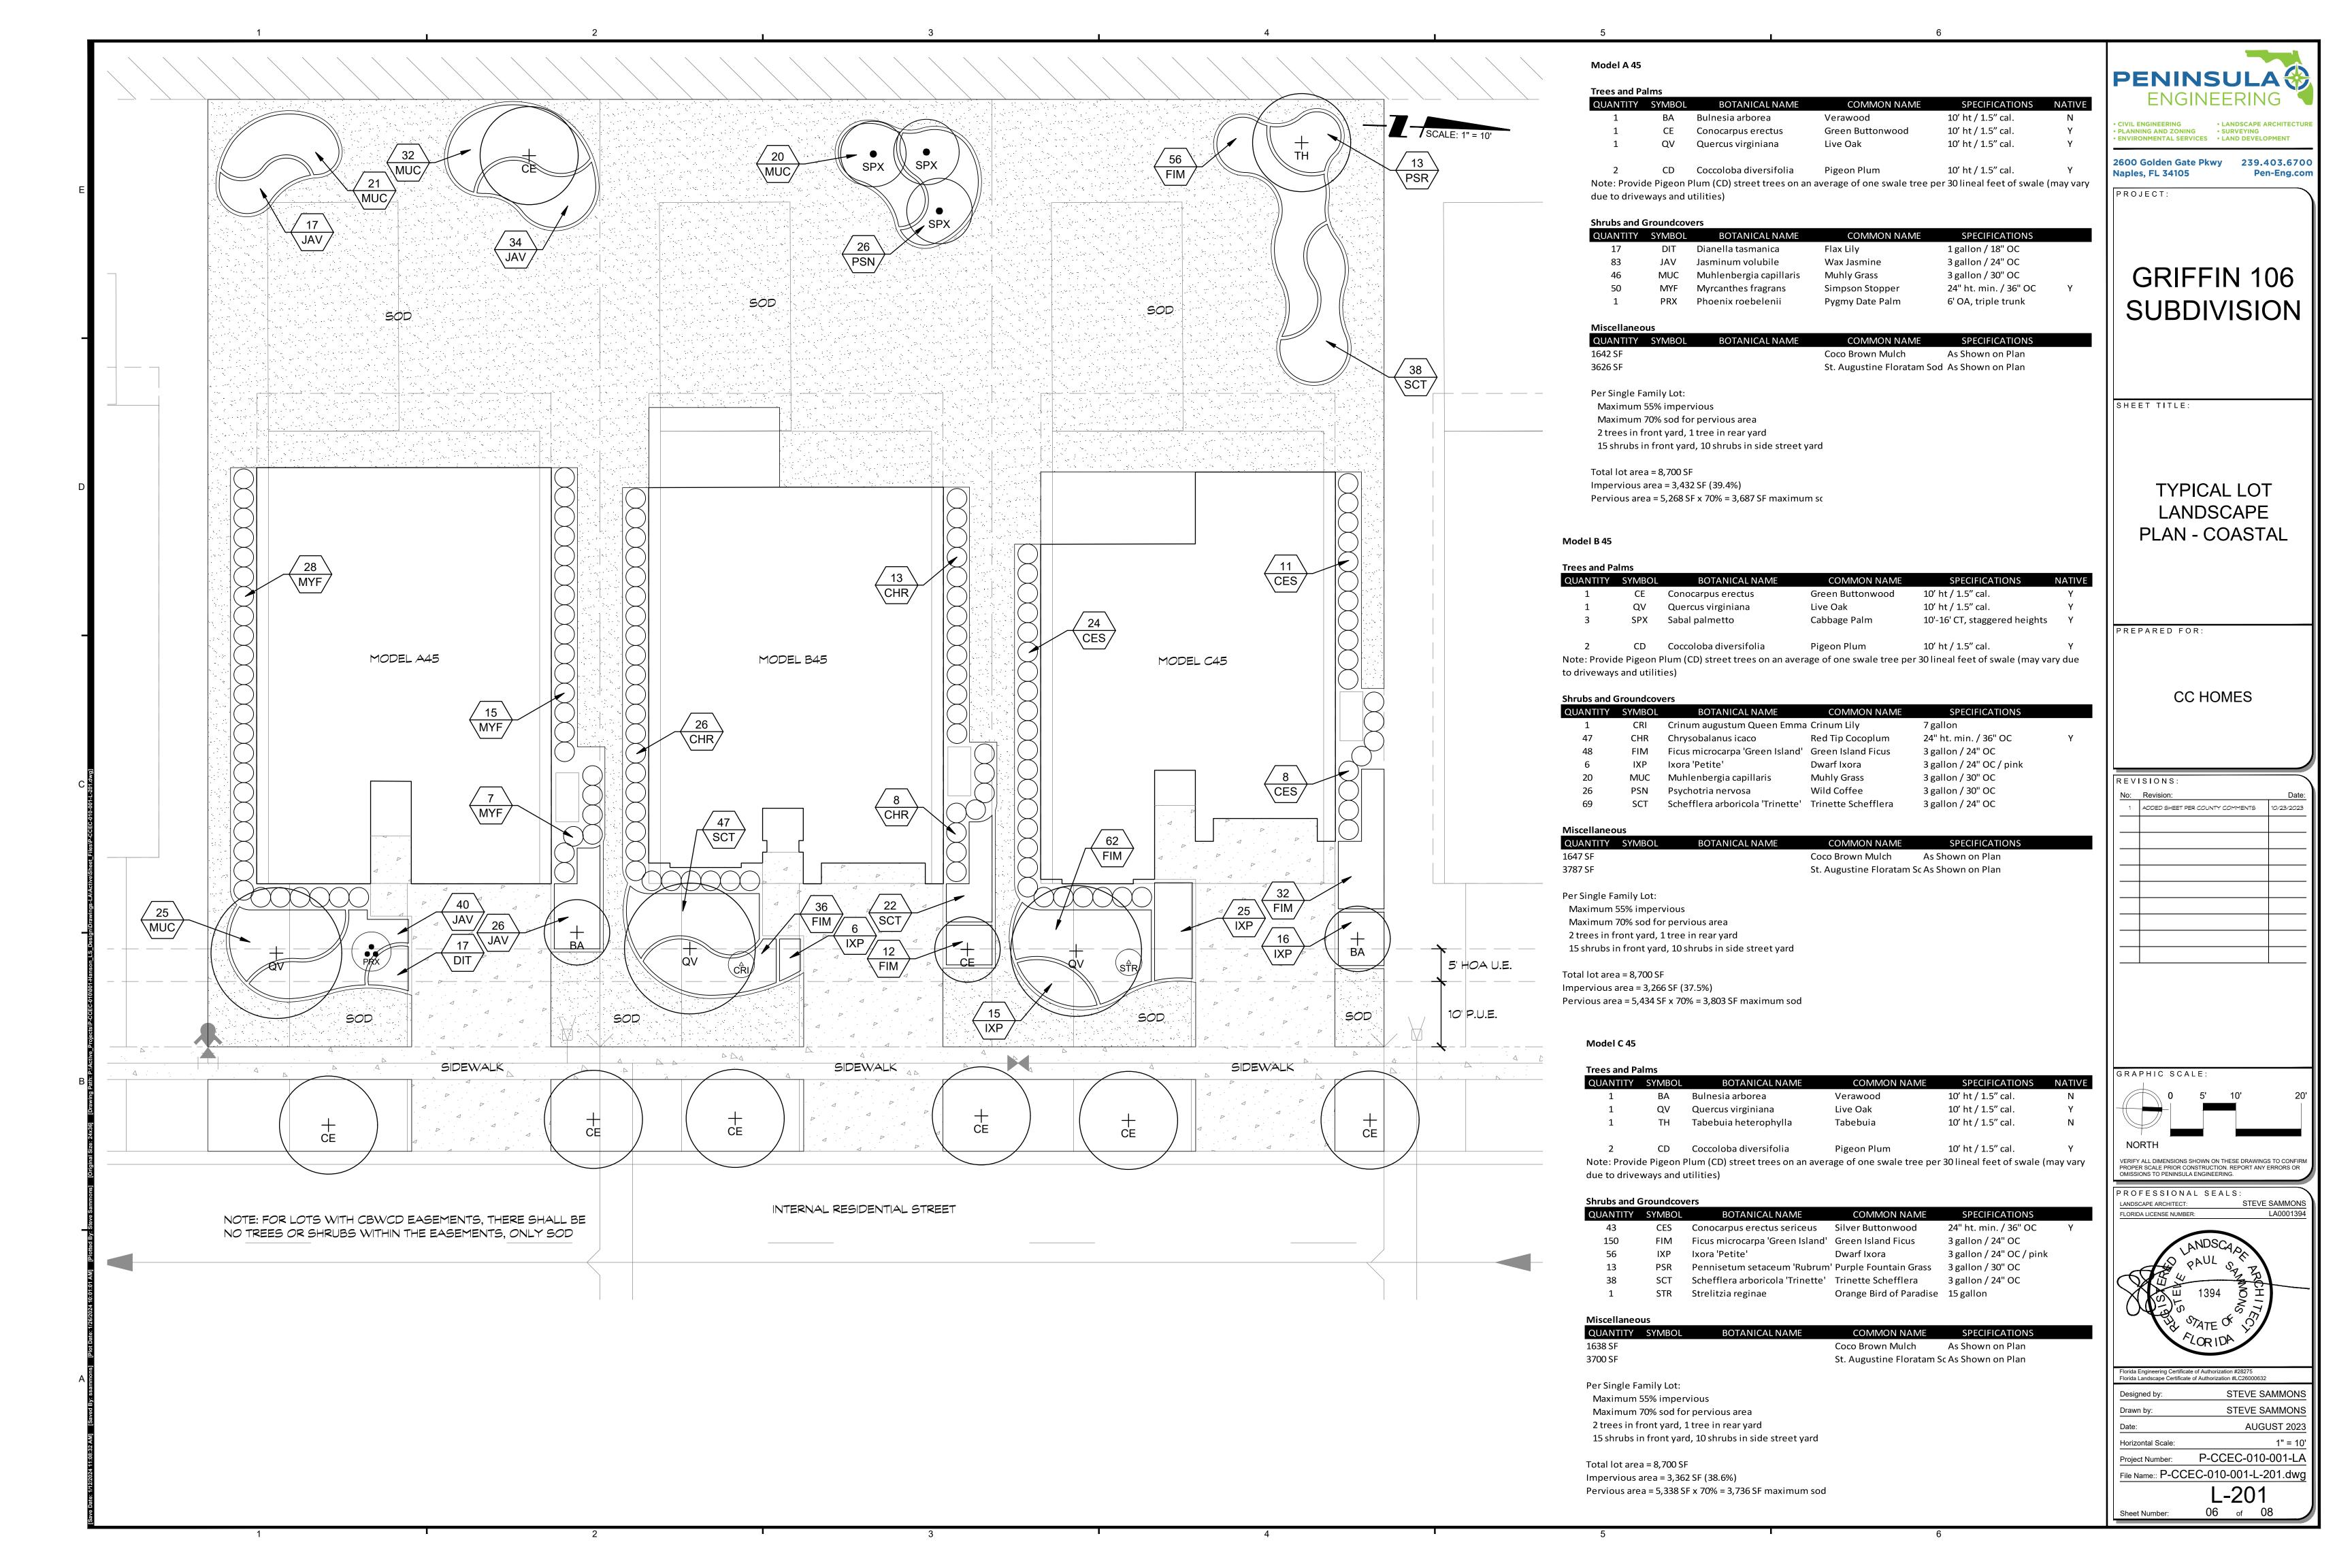

#### Model A 45

Trees and Palms					
SYMBOL	<b>BOTANICAL NAME</b>	COMMON NAME	<b>SPECIFICATIONS</b>	NATIVE	
TH	Tabebuia heterophylla	Pink Tab	10' ht / 1.5" cal.	N	
CE	Conocarpus erectus	Green Buttonwood	10' ht / 1.5" cal.	Υ	
QV	Quercus virginiana	Live Oak	10' ht / 1.5" cal.	Υ	
	SYMBOL TH CE	SYMBOL BOTANICAL NAME  TH Tabebuia heterophylla  CE Conocarpus erectus	SYMBOL BOTANICAL NAME COMMON NAME  TH Tabebuia heterophylla Pink Tab  CE Conocarpus erectus Green Buttonwood	SYMBOLBOTANICAL NAMECOMMON NAMESPECIFICATIONSTHTabebuia heterophyllaPink Tab10' ht / 1.5" cal.CEConocarpus erectusGreen Buttonwood10' ht / 1.5" cal.	

Note: Provide Green Buttonwood (CE) street trees on an average of one swale tree per 30 lineal feet of swale (may vary due to driveways and utilities)

#### **Shrubs and Groundcovers**

QUANTITY	SYMBOL	<b>BOTANICAL NAME</b>	COMMON NAME	SPECIFICATIONS	
17	LEG	Liriope muscari	Liriope Evergreen Giant	1 gallon / 18" OC	
117	FIM	Ficus microcarpa	Green Island Ficus	3 gallon / 24" OC	
53	MUC	Muhlenbergia capillaris	Muhly Grass	3 gallon / 30" OC	
50	MYF	Myrcanthes fragrans	Simpson Stopper	24" ht. min. / 36" OC	Υ
1	STR	Strelitzia reginae	Orange Bird of Paradise	15 gallon	
38	SCT	Schefflera arboricola	Trinette Schefflera	3 gallon / 24" OC	

QUANTITY	STIMBOL	BOTANICAL NAIVIE	COMMON NAME	SPECIFICATIONS	
1642 SF			Coco Brown Mulch	As Shown on Plan	
3626 SF			St. Augustine Floratam So	d As Shown on Plan	

Per Single Family Lot: Maximum 55% impervious Maximum 70% sod for pervious area 2 trees in front yard, 1 tree in rear yard 15 shrubs in front yard, 10 shrubs in side street yard

Total lot area = 8,700 SF Impervious area = 3,432 SF (39.4%) Pervious area = 5,268 SF x 70% = 3,687 SF maximum sod

#### Model B 45

#### **Trees and Palms**

QUANTITY	SYMBOL	BOTANICAL NAME	COMMON NAME	SPECIFICATIONS	NATIVE
2	CE	Conocarpus erectus	Green Buttonwood	10′ ht / 1.5″ cal.	Υ
1	BA	Bulnesia arborea	Verawood	10′ ht / 1.5″ cal.	N
1	QV	Quercus virginiana	Live Oak	10′ ht / 1.5″ cal.	Υ
3	SPX	Sabal palmetto	Cabbage Palm	10'-16' CT, staggered heights	Υ

Note: Provide Green Buttonwood (CE) street trees on an average of one swale tree per 30 lineal feet of swale (may vary due to driveways and utilities)

#### **Shrubs and Groundcovers**

QUANTITY	SYMBOL	BOTANICAL NAME	COMMON NAME	SPECIFICATIONS	
1	PRX	Phoenix roebellenii	Pygmy Date Palm	6' OA / triple trunk	
47	CHR	Chrysobalanus icaco	Red Tip Cocoplum	24" ht. min. / 36" OC	Υ
48	FIM	Ficus microcarpa 'Green Island'	Green Island Ficus	3 gallon / 24" OC	
6	DIT	Dianella tasmanica	Flax Lily	1 gallon / 18" OC	
74	JAV	Jasminum volubile	Wax Jasmine	3 gallon / 24" OC	
69	HIB	Hibiscus rosa-sinensis	Hibiscus	3 gallon / 24" OC	
26	MUC	Muhlenbergia capillaris	Muhly Grass	3 gallon / 30" OC	
26	PSN	Psychotria nervosa	Wild Coffee	3 gallon / 30" OC	
69	SCT	Schefflera arboricola 'Trinette'	Trinette Schefflera	3 gallon / 24" OC	

QUANTITY	SYMBOL	BOTANICAL NAME	COMMON NAME	SPECIFICATIONS
1647 SF			Coco Brown Mulch	As Shown on Plan
3787 SF			St. Augustine Floratam	Sc As Shown on Plan

#### Per Single Family Lot: Maximum 55% impervious

Maximum 70% sod for pervious area 2 trees in front yard, 1 tree in rear yard

15 shrubs in front yard, 10 shrubs in side street yard

Total lot area = 8,700 SF Impervious area = 3,266 SF (37.5%) Pervious area = 5,434 SF x 70% = 3,803 SF maximum sod

#### Model C 45

#### **Trees and Palms**

QUANTITY	SYMBOL	<b>BOTANICAL NAME</b>	COMMON NAME	SPECIFICATIONS	NATI
3	CE	Conocarpus erectus	Green Buttonwood	10' ht / 1.5" cal.	Υ
1	QV	Quercus virginiana	Live Oak	10' ht / 1.5" cal.	Υ
1	TH	Tabebuia heterophylla	Tabebuia	10' ht / 1.5" cal.	N

Note: Provide Green Buttonwood (CE) street trees on an average of one swale tree per 30 lineal feet of swale (may vary due to driveways and utilities)

#### Shrubs and Groundcovers

QUANTITY	SYMBOL	BOTANICAL NAME	COMMON NAME	SPECIFICATIONS	
43	CES	Conocarpus erectus sericeus	Silver Buttonwood	24" ht. min. / 36" OC	Υ
1	CRI	Crinum augustum 'Queen Emma'	Purple Crinum Lily	15 gallon	
94	CRM	Codiaeum variegatum	Mammey Croton	3 gallon / 24" OC	
81	IXP	Ixora 'Petite'	Dwarf Ixora	3 gallon / 24" OC / pink	
13	PSN	Psychotria nervosa	Wild Coffee	3 gallon / 30" OC	
38	SCT	Schefflera arboricola 'Trinette'	Trinette Schefflera	3 gallon / 24" OC	
31	TRF	Tripsacum floridanum	Gama Grass	1 gallon / 24 " OC	

#### Miscellaneous

QUANTITY	SYMBOL	<b>BOTANICAL NAME</b>	COMMON NAME	<b>SPECIFICATIONS</b>
1638 SF			Coco Brown Mulch	As Shown on Plan
3700 SF			St. Augustine Floratam	Sc As Shown on Plan

Per Single Family Lot: Maximum 55% impervious Maximum 70% sod for pervious area 2 trees in front yard, 1 tree in rear yard 15 shrubs in front yard, 10 shrubs in side street yard

Total lot area = 8,700 SF

Impervious area = 3,362 SF (38.6%) Pervious area = 5,338 SF x 70% = 3,736 SF maximum sod **PENINSULA ENGINEERING** 

CIVIL ENGINEERING
PLANNING AND ZONING
PENVIRONMENTAL SERVICES
• LAND DEVELOPMENT

2600 Golden Gate Pkwy 239.403.6700 Pen-Eng.com

**GRIFFIN 106** SUBDIVISION

SHEET TITLE:

Naples, FL 34105

PROJECT:

TYPICAL LOT LANDSCAPE PLAN -SOUTHERN

PREPARED FOR:

CC HOMES


REVISIONS: 1 ADDED SHEET

GRAPHIC SCALE:

VERIFY ALL DIMENSIONS SHOWN ON THESE DRAWINGS TO CONFIRM

PROPER SCALE PRIOR CONSTRUCTION. REPORT ANY ERRORS OR OMISSIONS TO PENINSULA ENGINEERING.

PROFESSIONAL SEALS: LANDSCAPE ARCHITECT:

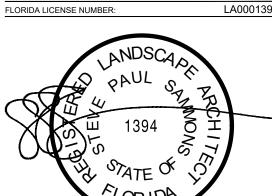


Florida Engineering Certificate of Authorization #28275 Florida Landscape Certificate of Authorization #LC26000632 STEVE SAMMONS

STEVE SAMMONS AUGUST 2023 Horizontal Scale:

P-CCEC-010-001-LA File Name:: P-CCEC-010-001-L-202.dwg

Sheet Number: 07 of 08

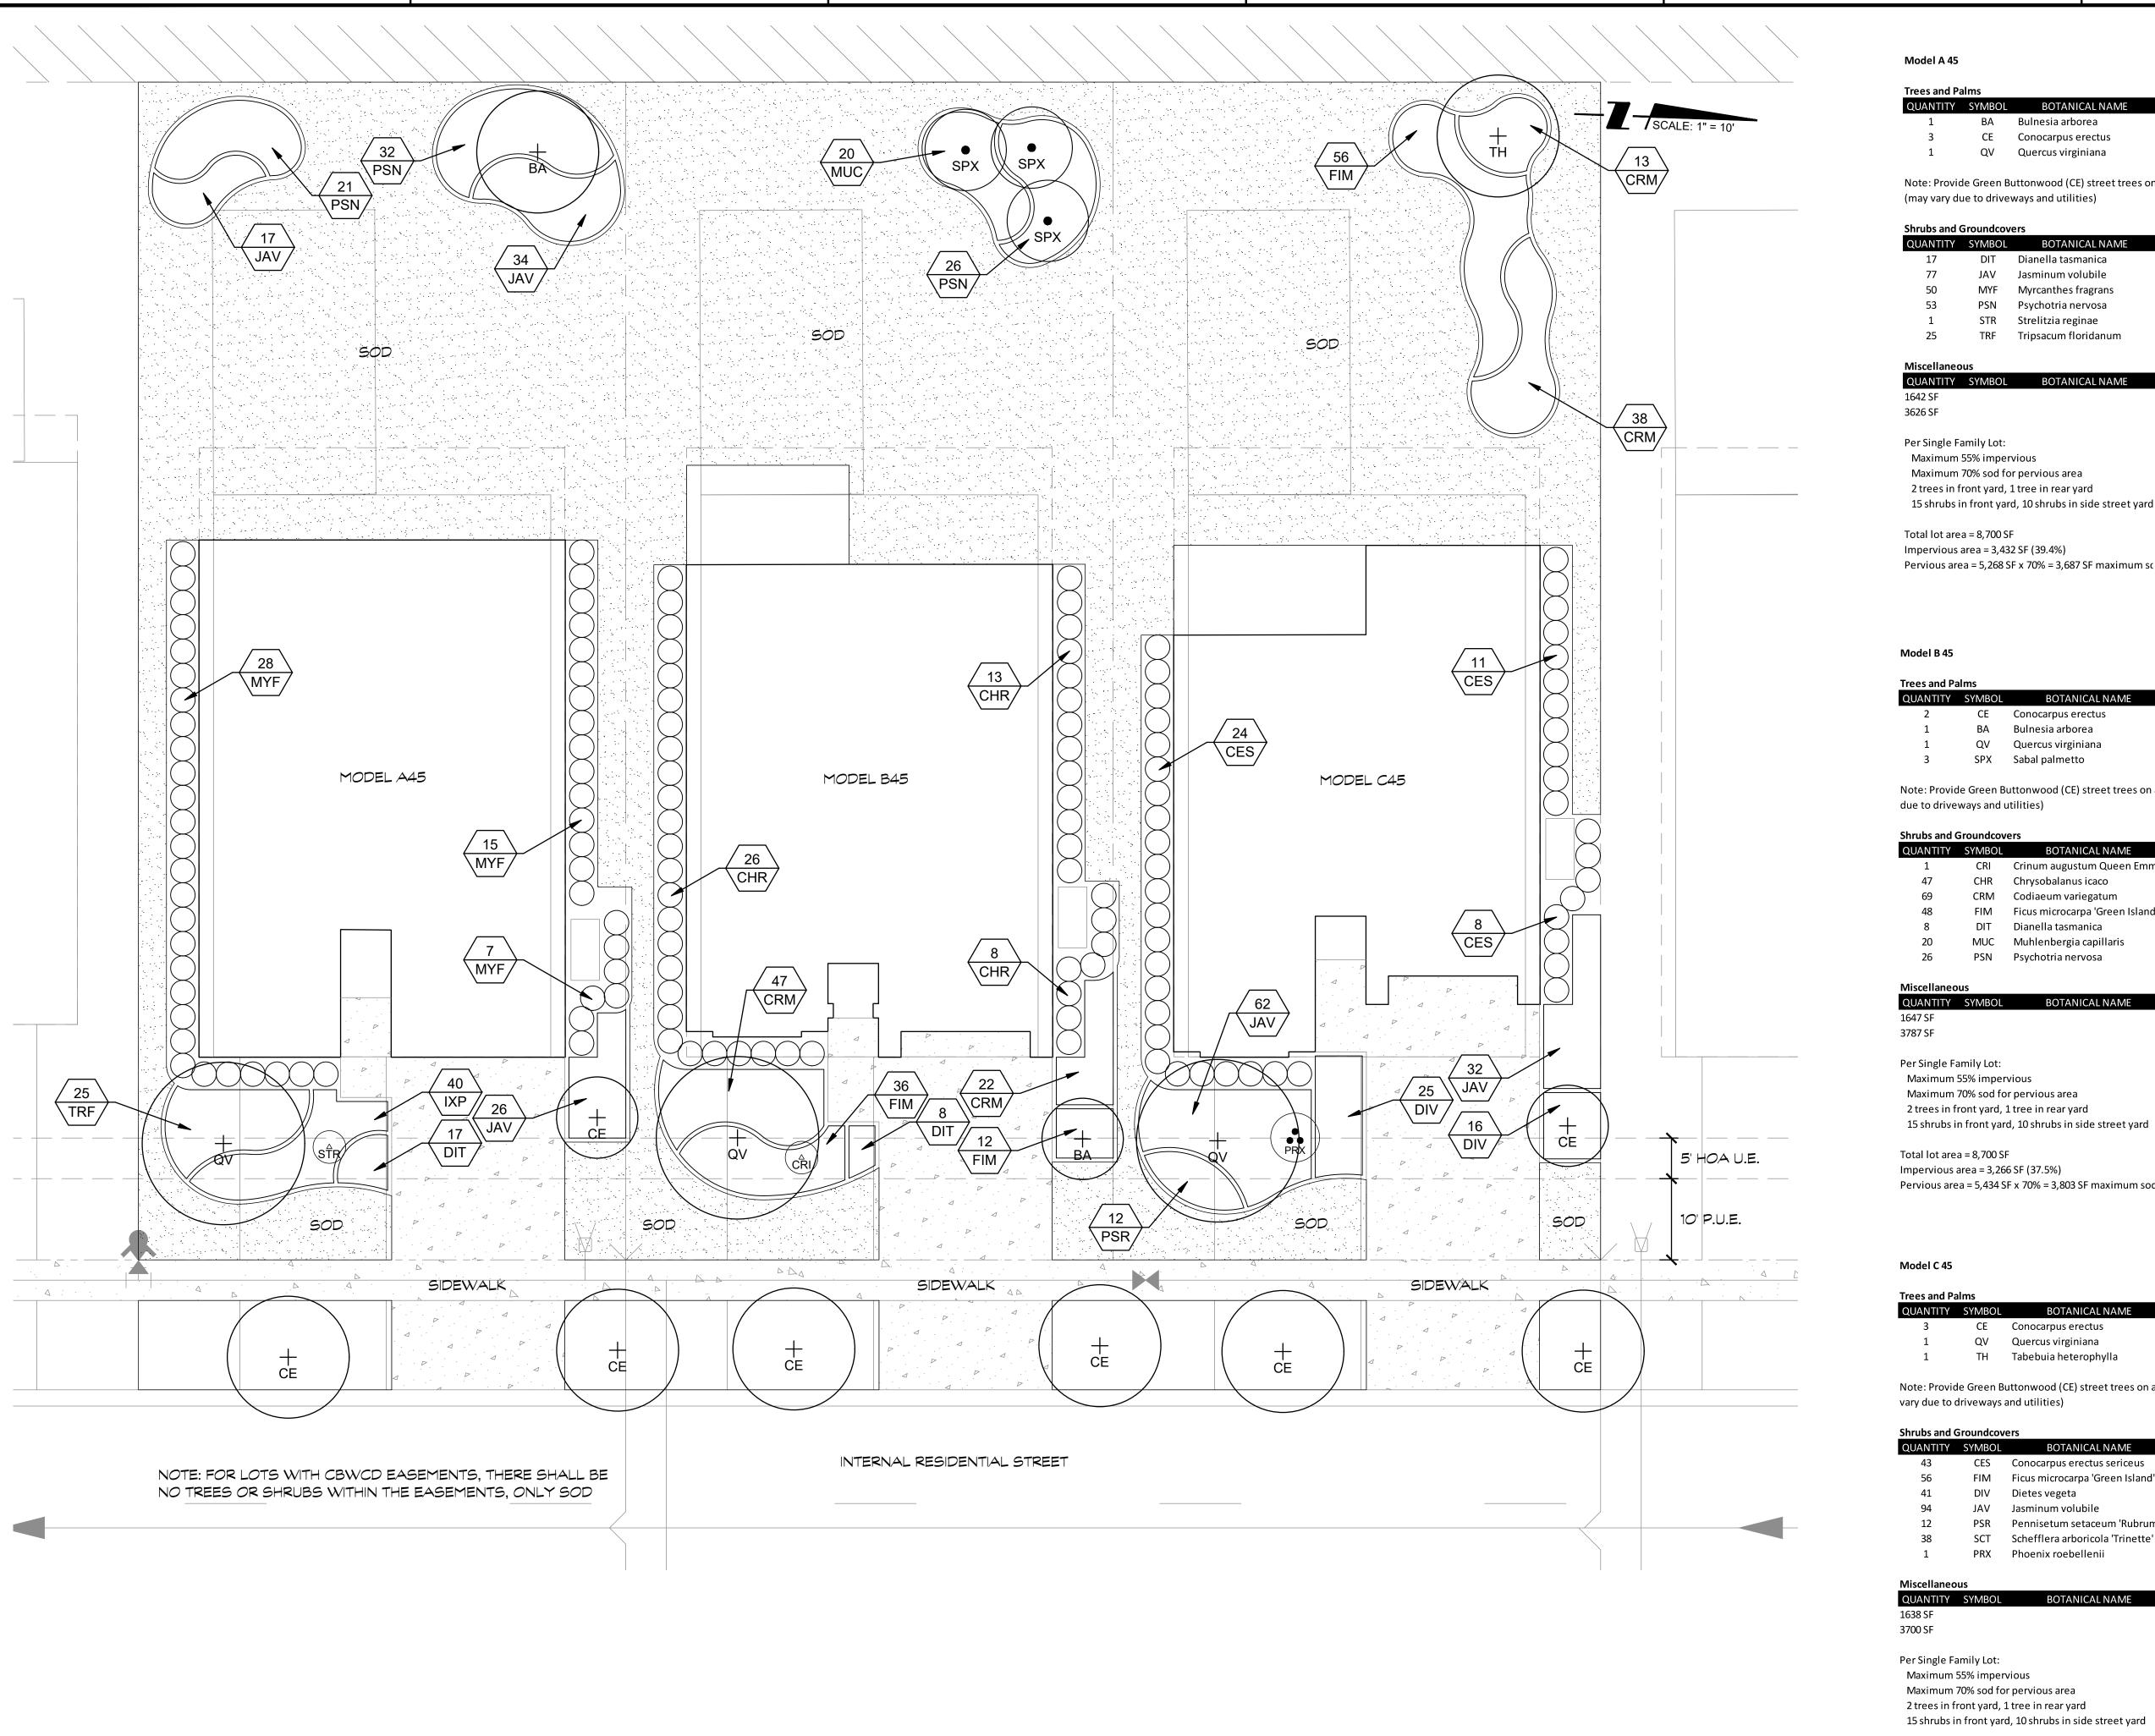

#### Model A 45

#### Trees and Palms

rees and Pa	aims				
QUANTITY	SYMBOL	<b>BOTANICAL NAME</b>	<b>COMMON NAME</b>	<b>SPECIFICATIONS</b>	
1	ВА	Bulnesia arborea	Verawood	10' ht / 1.5" cal.	
3	CE	Conocarpus erectus	Green Buttonwood	10' ht / 1.5" cal.	
1	QV	Quercus virginiana	Live Oak	10' ht / 1.5" cal.	

Note: Provide Green Buttonwood (CE) street trees on an average of one swale tree per 30 lineal feet of swale (may vary due to driveways and utilities)

#### **Shrubs and Groundcovers**

on and are drawned vers					
QUANTITY	SYMBOL	BOTANICAL NAME	COMMON NAME	SPECIFICATIONS	
17	DIT	Dianella tasmanica	Flax Lily	1 gallon / 18" OC	
77	JAV	Jasminum volubile	Wax Jasmine	3 gallon / 24" OC	
50	MYF	Myrcanthes fragrans	Simpson Stopper	24" ht. min. / 36" OC	Υ
53	PSN	Psychotria nervosa	Wild Coffee	3 gallon / 30" OC	
1	STR	Strelitzia reginae	Orange Bird of Paradise	15 gallon	
25	TRF	Tripsacum floridanum	Gama Grass	1 gallon / 24" OC	

#### Miscellaneous

QUANTITY	SYMBOL	<b>BOTANICAL NAME</b>	COMMON NAME	<b>SPECIFICATIONS</b>
1642 SF			Coco Brown Mulch	As Shown on Plan
3626 SF			St. Augustine Floratam Sc	d As Shown on Plan

#### Per Single Family Lot: Maximum 55% impervious

Maximum 70% sod for pervious area 2 trees in front yard, 1 tree in rear yard

## 15 shrubs in front yard, 10 shrubs in side street yard

Impervious area = 3,432 SF (39.4%) Pervious area = 5,268 SF x 70% = 3,687 SF maximum sc

#### Model B 45

#### **Trees and Palms**

QUANTITY	SYMBOL	BOTANICAL NAME	COMMON NAME	SPECIFICATIONS	NATIVE
2	CE	Conocarpus erectus	Green Buttonwood	10' ht / 1.5" cal.	Υ
1	BA	Bulnesia arborea	Verawood	10' ht / 1.5" cal.	N
1	QV	Quercus virginiana	Live Oak	10' ht / 1.5" cal.	Υ
3	SPX	Sabal palmetto	Cabbage Palm	10'-16' CT, staggered heights	Υ

Note: Provide Green Buttonwood (CE) street trees on an average of one swale tree per 30 lineal feet of swale (may vary due to driveways and utilities)

#### **Shrubs and Groundcovers**

QUANTITY	SYMBOL	BOTANICAL NAME	COMMON NAME	SPECIFICATIONS	
1	CRI	Crinum augustum Queen Emma	Crinum Lily	7 gallon	
47	CHR	Chrysobalanus icaco	Red Tip Cocoplum	24" ht. min. / 36" OC	Υ
69	CRM	Codiaeum variegatum	Mammey Croton	3 gallon / 24" OC	
48	FIM	Ficus microcarpa 'Green Island'	Green Island Ficus	3 gallon / 24" OC	
8	DIT	Dianella tasmanica	Flax Lily	1 gallon / 18" OC	
20	MUC	Muhlenbergia capillaris	Muhly Grass	3 gallon / 30" OC	
26	PSN	Psychotria nervosa	Wild Coffee	3 gallon / 30" OC	

QUANTITY	SAMBOL	BOTANICAL NAME	COMMON NAME	SPECIFICATIONS
1647 SF			Coco Brown Mulch	As Shown on Plan
3787 SF			St. Augustine Floratam S	c As Shown on Plan

## Maximum 55% impervious

Maximum 70% sod for pervious area 2 trees in front yard, 1 tree in rear yard

#### Total lot area = 8,700 SF

Impervious area = 3,266 SF (37.5%)

Pervious area = 5,434 SF x 70% = 3,803 SF maximum sod

#### Model C 45

es and Palms			
JANTITY	SYMBOL		
3	CF		

QUANTITY	SYMBOL	BOTANICAL NAME	COMMON NAME	SPECIFICATIONS	NATIVE
3	CE	Conocarpus erectus	Green Buttonwood	10' ht / 1.5" cal.	Υ
1	QV	Quercus virginiana	Live Oak	10' ht / 1.5" cal.	Υ
1	TH	Tabebuia heterophylla	Tabebuia	10' ht / 1.5" cal.	N

Note: Provide Green Buttonwood (CE) street trees on an average of one swale tree per 30 lineal feet of swale (may vary due to driveways and utilities)

#### **Shrubs and Groundcovers**

QUANTITY	SYMBOL	BOTANICAL NAME	COMMON NAME	SPECIFICATIONS	
43	CES	Conocarpus erectus sericeus	Silver Buttonwood	24" ht. min. / 36" OC	Υ
56	FIM	Ficus microcarpa 'Green Island'	Green Island Ficus	3 gallon / 24" OC	
41	DIV	Dietes vegeta	Walking Iris	3 gallon / 24" OC	
94	JAV	Jasminum volubile	Wax Jasmine	3 gallon / 24" OC	
12	PSR	Pennisetum setaceum 'Rubrum'	Purple Fountain Grass	3 gallon / 30" OC	
38	SCT	Schefflera arboricola 'Trinette'	Trinette Schefflera	3 gallon / 24" OC	
1	PRX	Phoenix roebellenii	Pygmy Date Palm	6' OA / triple trunk	

## Miscellaneous

QUANTITY	SYMBOL	BOTANICAL NAME	COMMON NAME	SPECIFICATION:
1638 SF			Coco Brown Mulch	As Shown on Plan
3700 SF			St. Augustine Floratam	Sc As Shown on Plan

Per Single Family Lot: Maximum 55% impervious Maximum 70% sod for pervious area 2 trees in front yard, 1 tree in rear yard 15 shrubs in front yard, 10 shrubs in side street yard

Total lot area = 8,700 SF

Impervious area = 3,362 SF (38.6%)

Pervious area = 5,338 SF x 70% = 3,736 SF maximum sod



CIVIL ENGINEERING
PLANNING AND ZONING
PENVIRONMENTAL SERVICES

LAND DEVELOPMENT

LAND DEVELOPMENT

2600 Golden Gate Pkwy 239.403.6700 Naples, FL 34105 Pen-Eng.com

PROJECT:

GRIFFIN 106 SUBDIVISION

SHEET TITLE:


TYPICAL LOT LANDSCAPE PLAN - FARM

PREPARED FOR:

CC HOMES

REVISIONS: 1 ADDED SHEET

GRAPHIC SCALE:

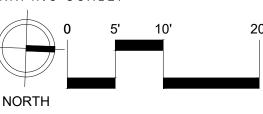

VERIFY ALL DIMENSIONS SHOWN ON THESE DRAWINGS TO CONFIRM PROPER SCALE PRIOR CONSTRUCTION. REPORT ANY ERRORS OR OMISSIONS TO PENINSULA ENGINEERING.

PROFESSIONAL SEALS: LANDSCAPE ARCHITECT: FLORIDA LICENSE NUMBER:





Florida Engineering Certificate of Authorization #28275 Florida Landscape Certificate of Authorization #LC26000632 STEVE SAMMONS


STEVE SAMMONS AUGUST 2023 Horizontal Scale:

P-CCEC-010-001-LA File Name:: P-CCEC-010-001-L-203.dwg

Sheet Number: 08 of 08

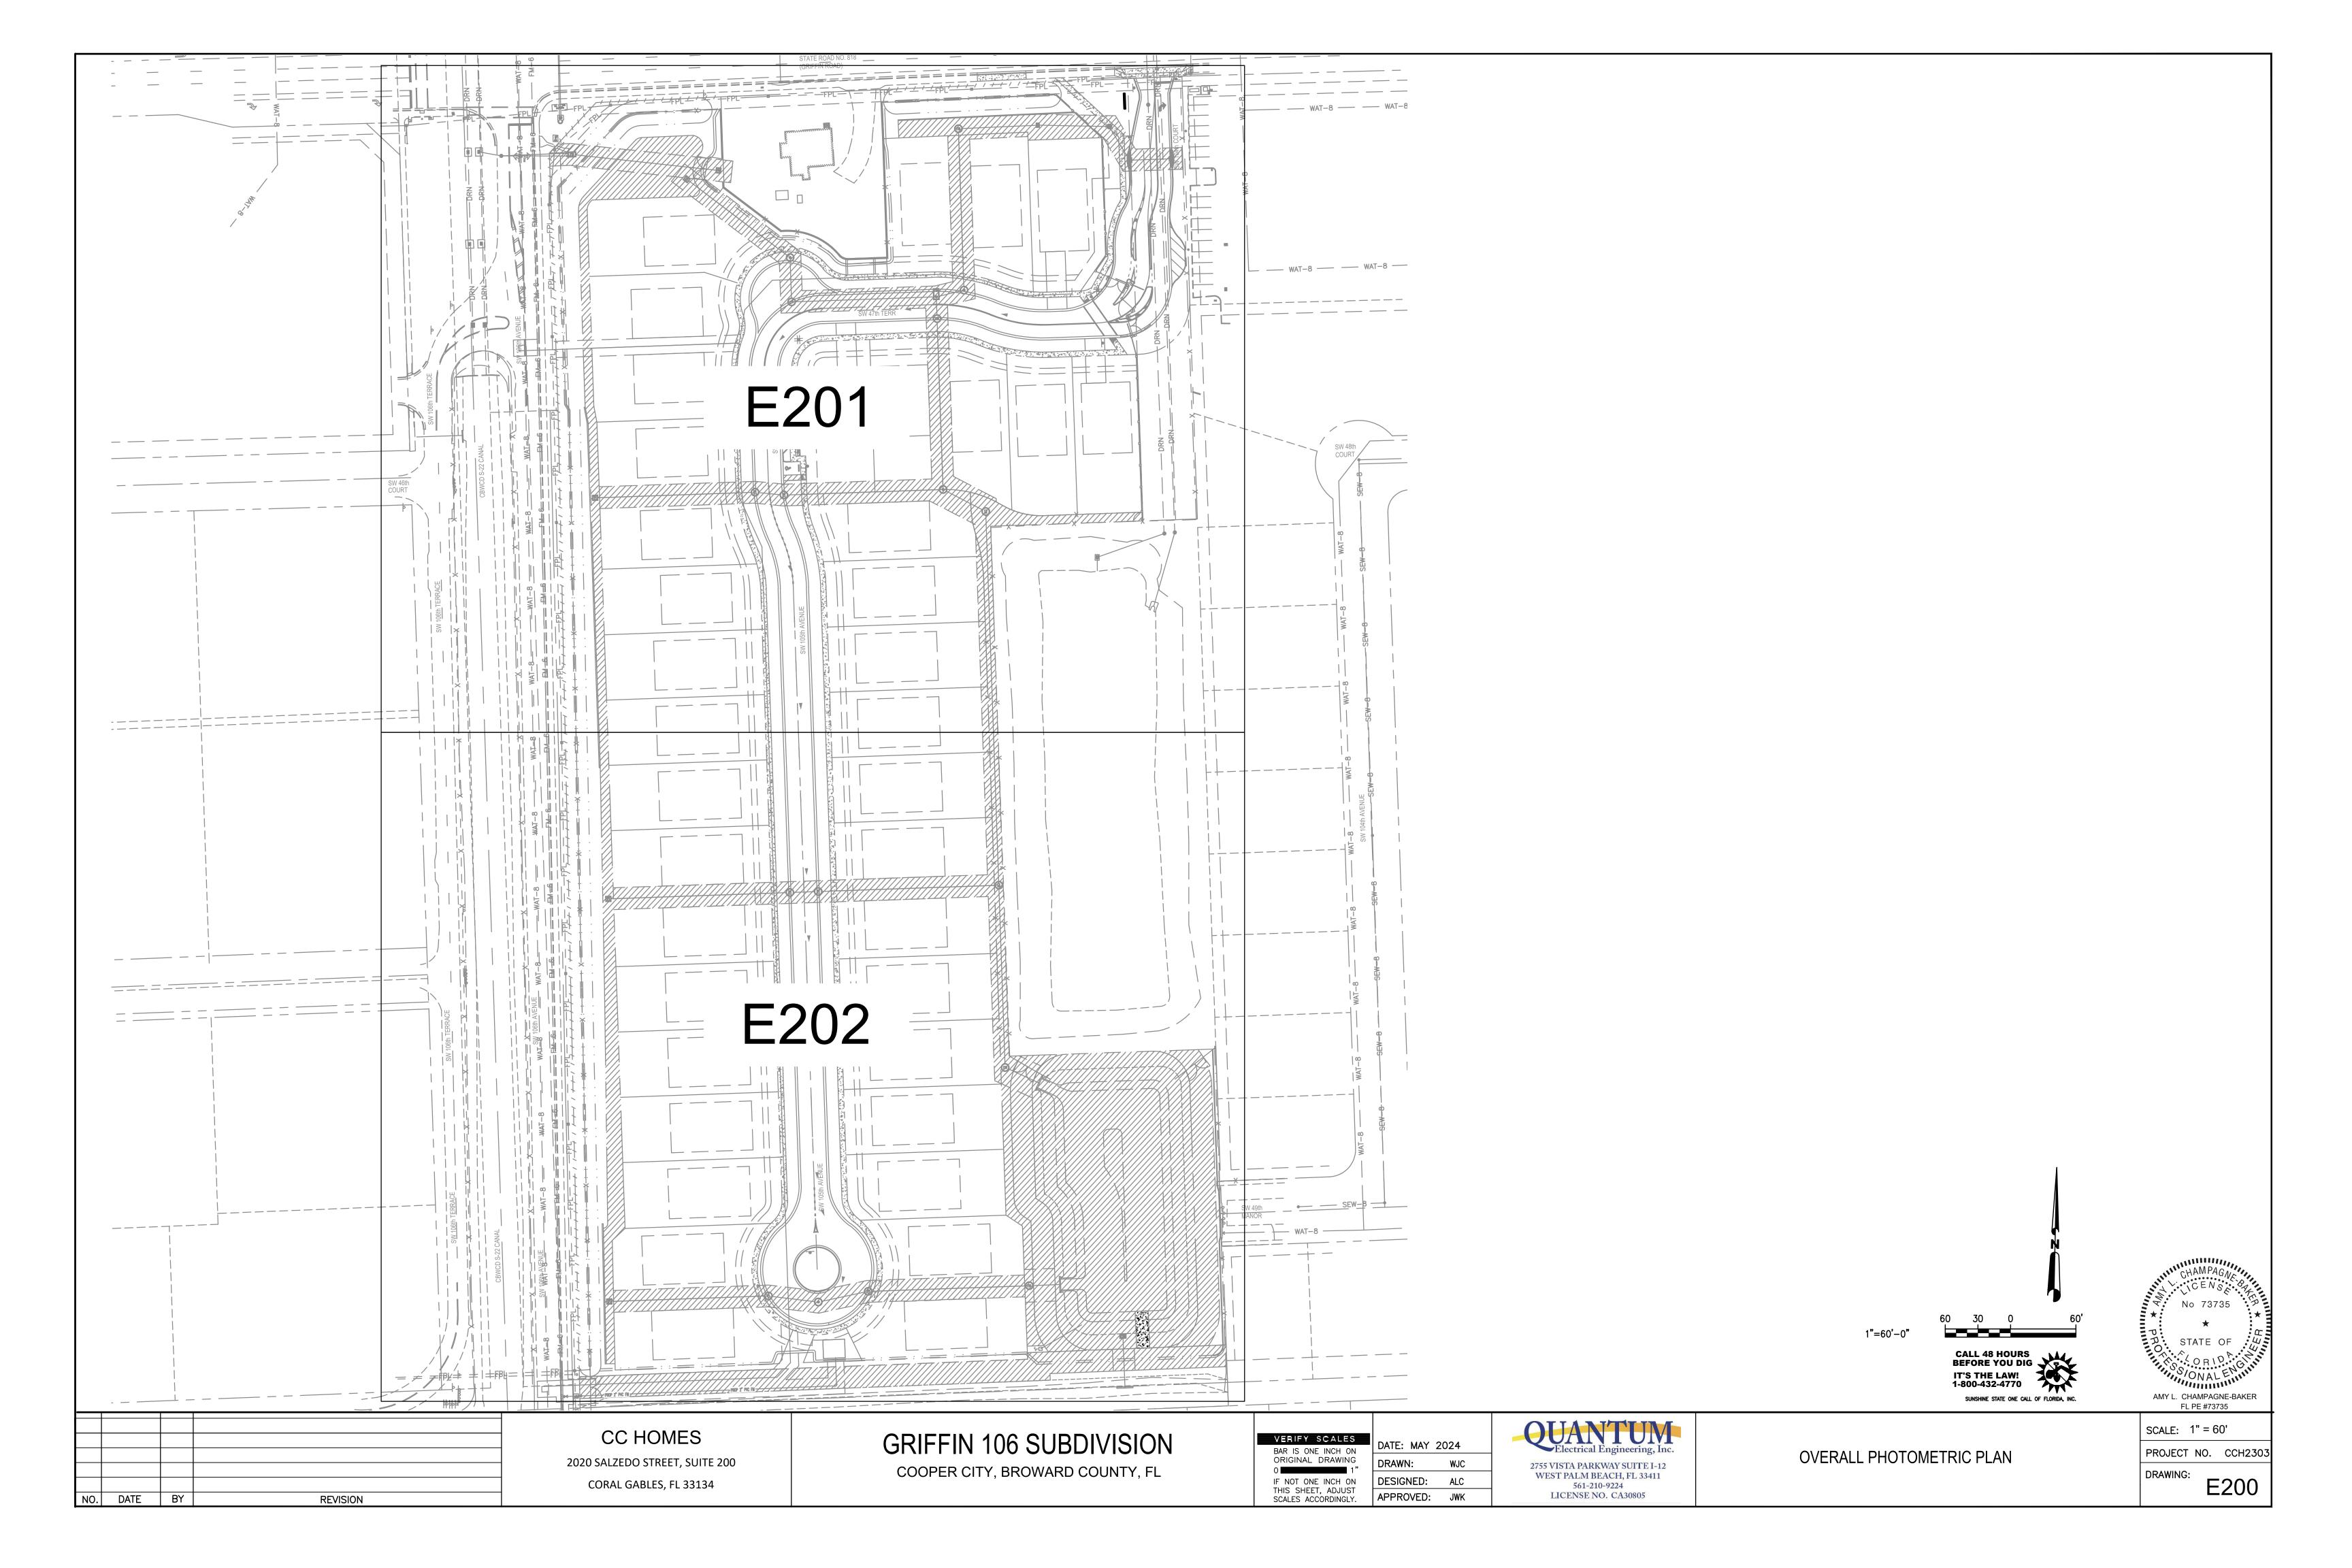

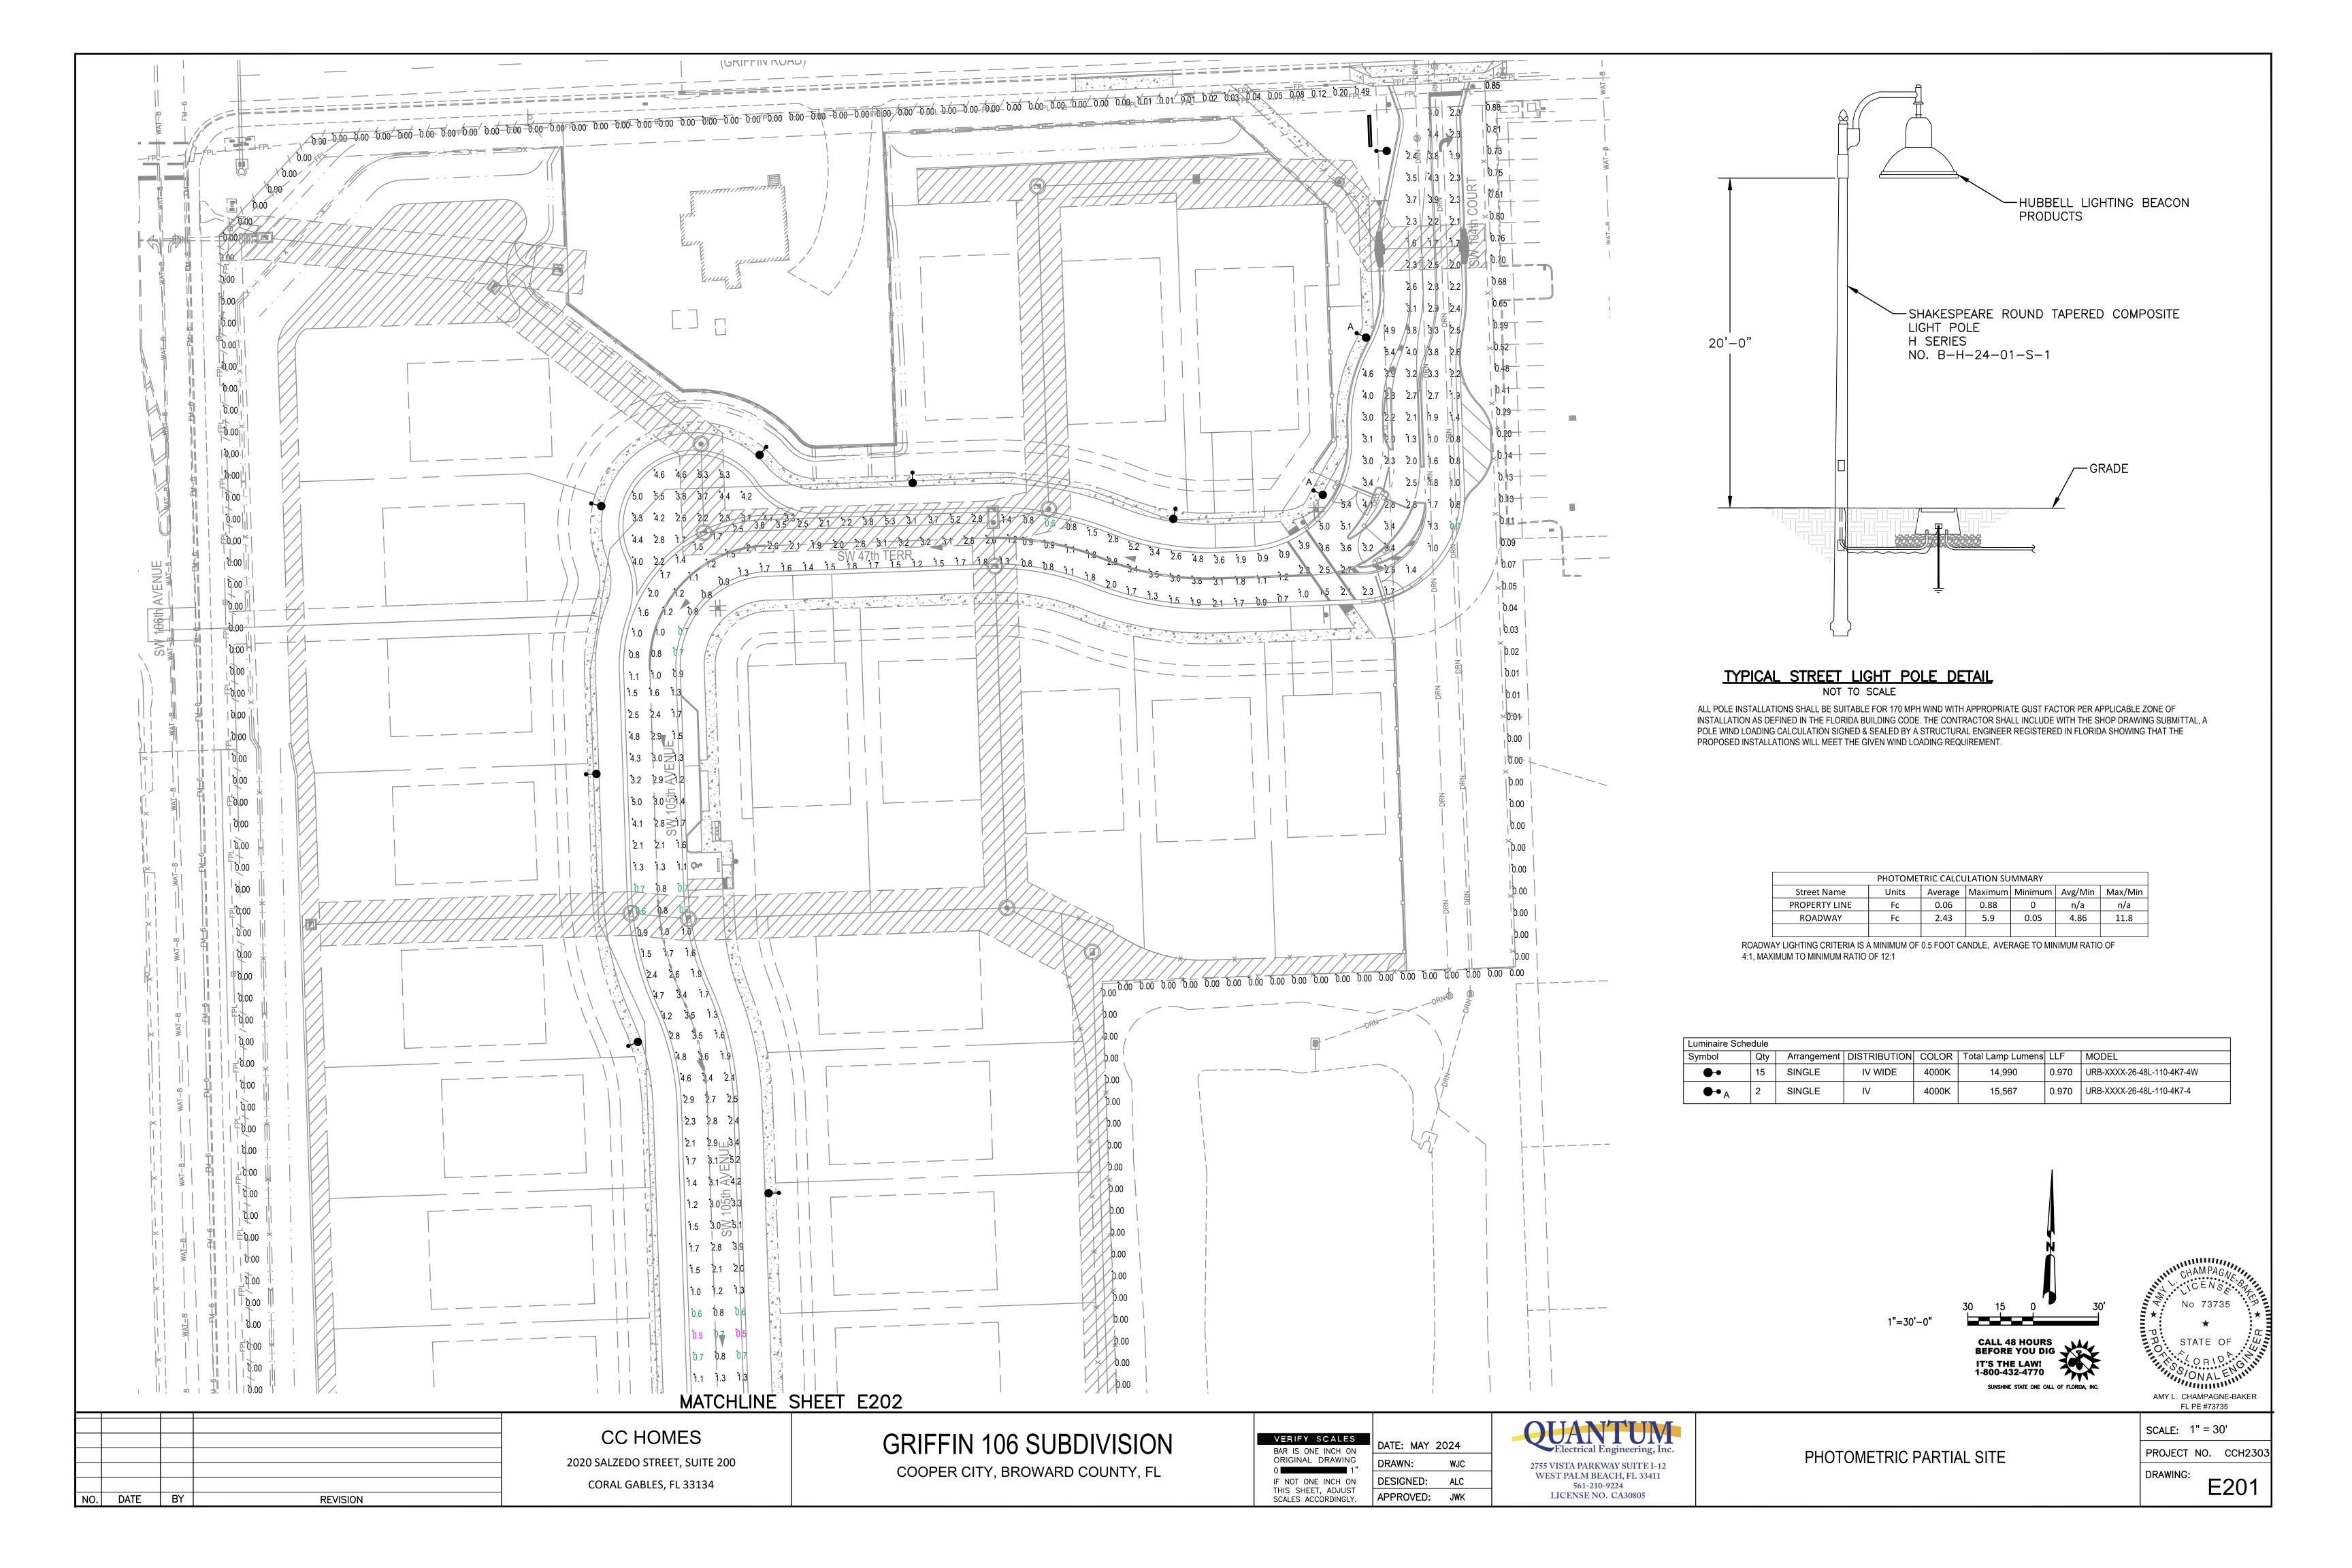

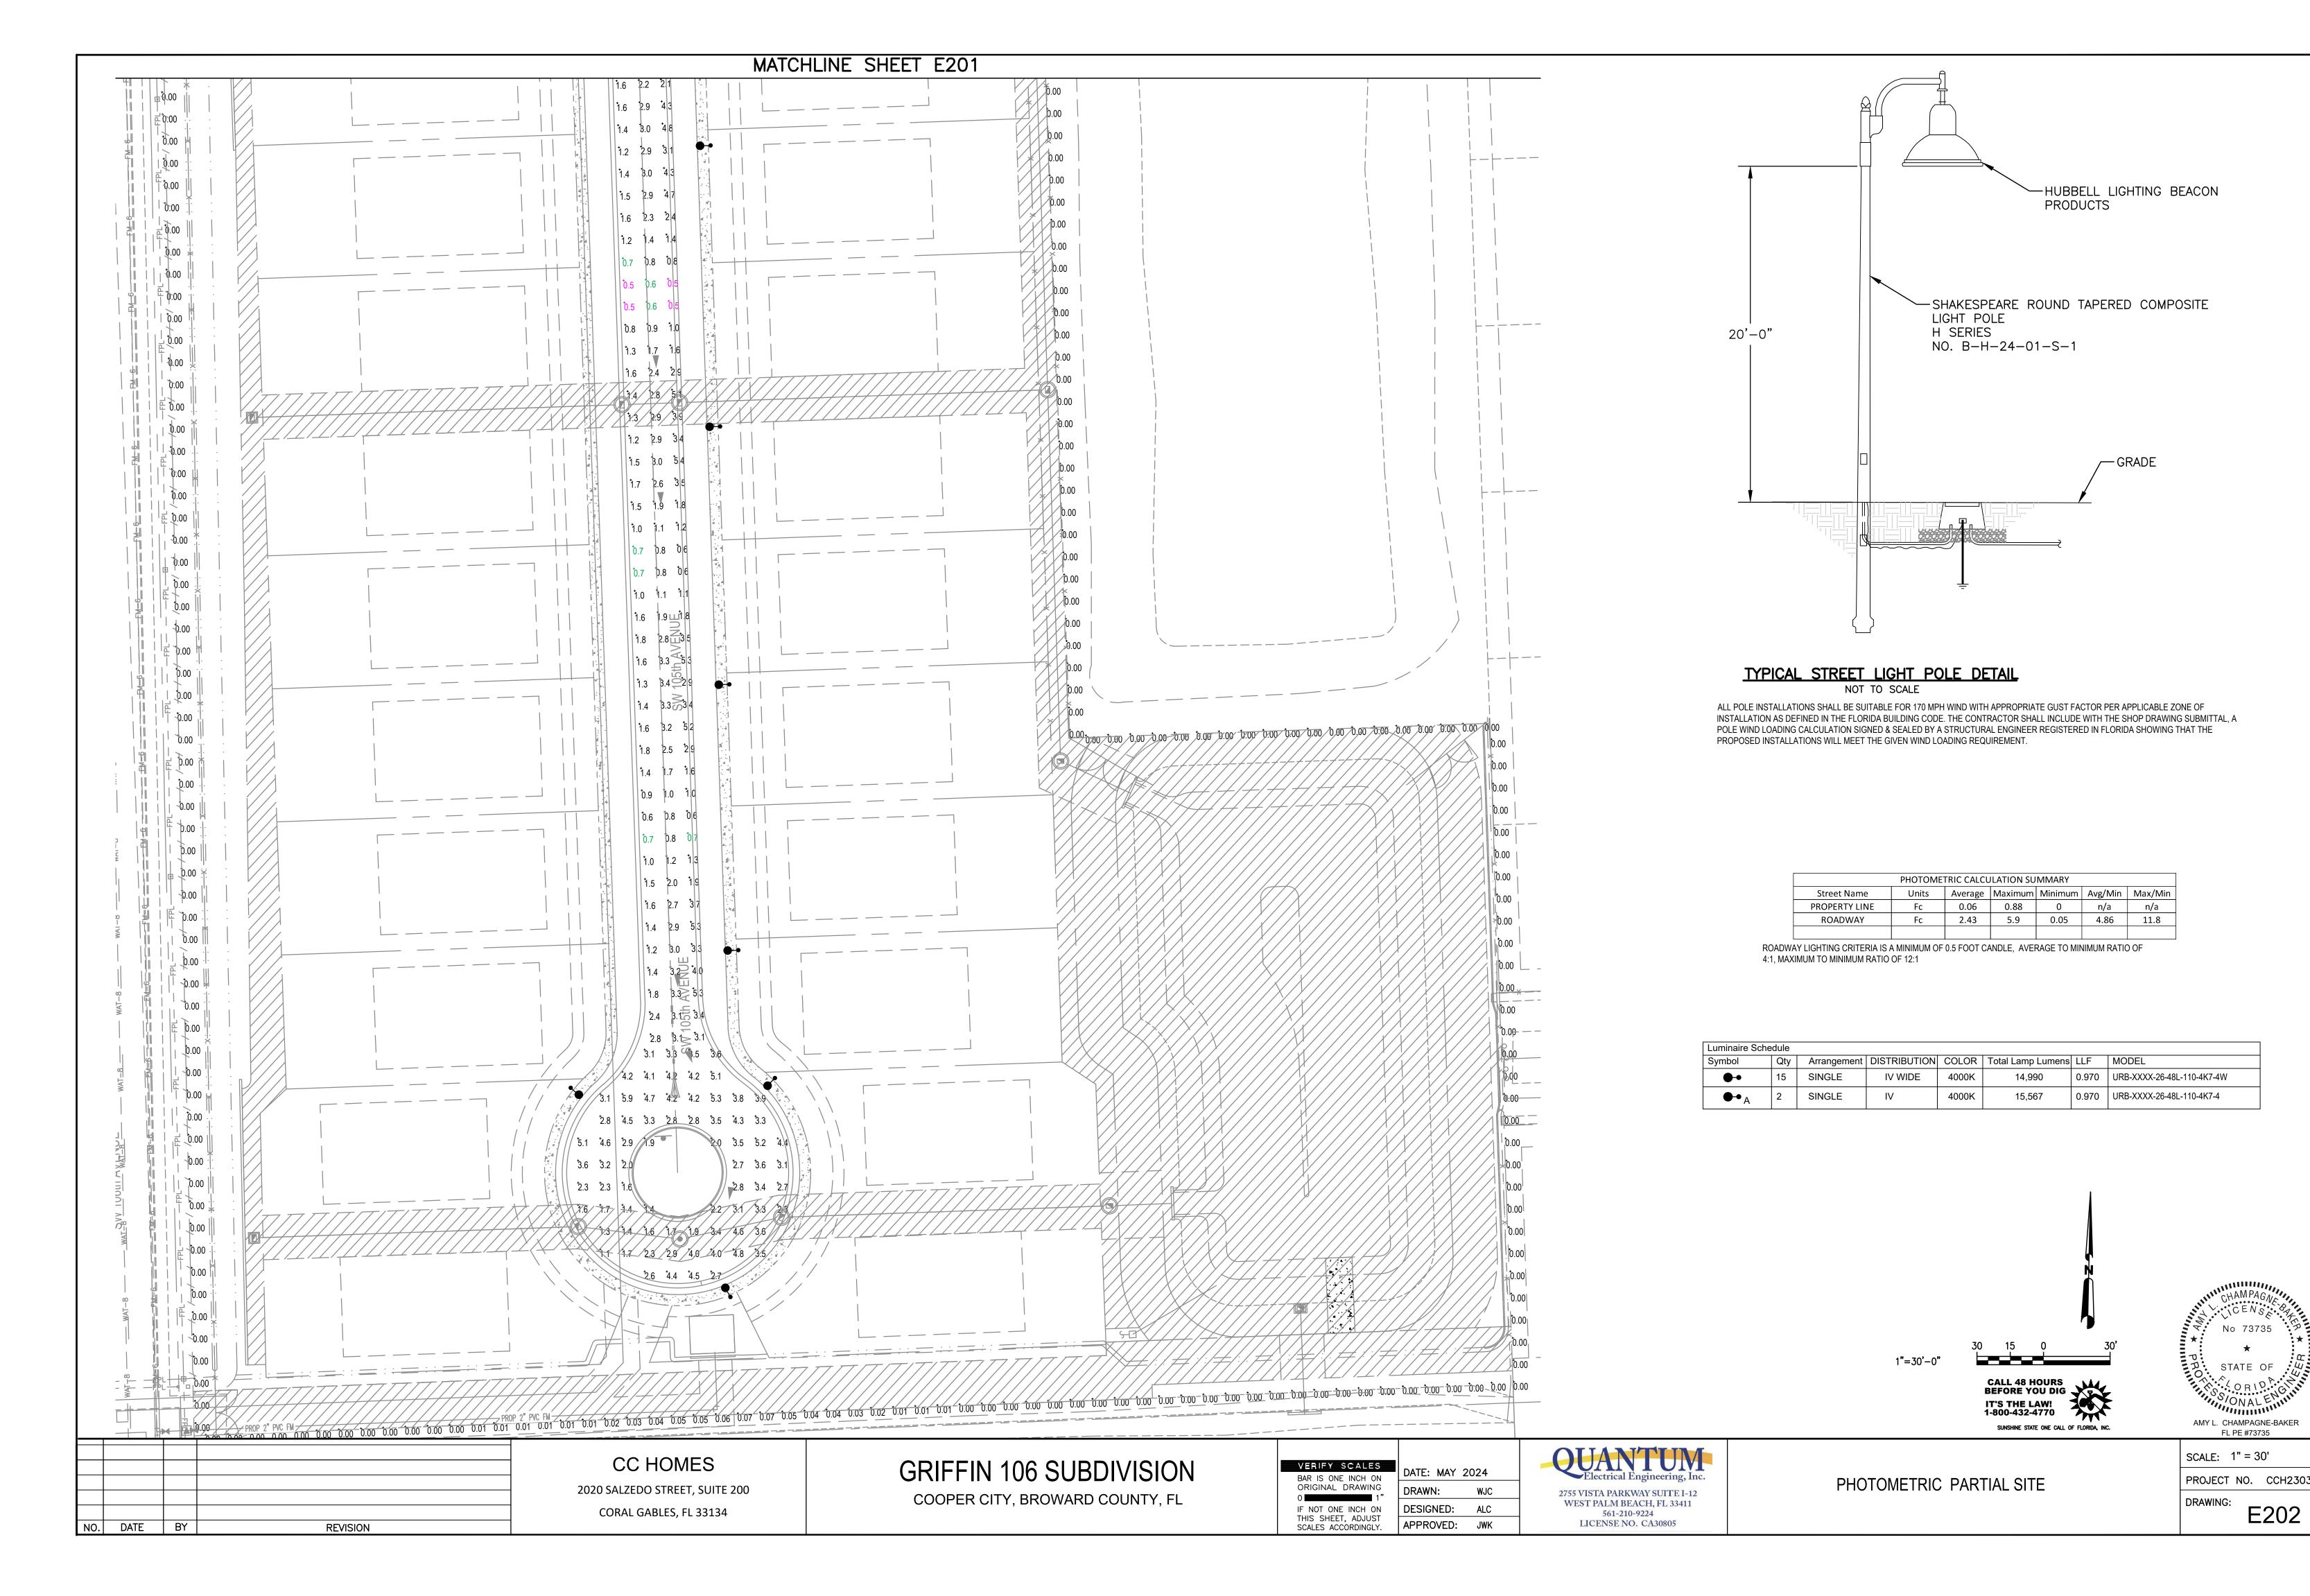

2) ANY REVISIONS TO THESE PLANS MUST BE APPROVED BY THE CENTRAL BROWARD WATER CONTROL DISTRICT PRIOR TO CONSTRUCTION.

DETERMINED BY THE DISTRICT BOARD OF COMMISSIONERS AND BY RECOMMENDATION OF THE DISTRICT SECRETARY/MANAGER

PROPERTY. IN THIS CASE, NUISANCE VEGETATION SHALL BE REMOVED FROM THE CANAL BANK NEAREST THE PROPERTY LINE.

N THE CENTRAL BROWARD WATER CONTROL DISTRICT'S STORMWATER MANAGEMENT REGULATIONS, STANDARDS, PROCEDURES, AND DESIGN C

(1) NGVD29 BENCHMARK. CULVERTS CONNECTING DISTRICT CANALS ONLY REQUIRE ONE (1) BENCHMARK PER EACH PAIR OF HEADWALLS.

**LEGEND** 

DISTRICT UNTIL SUCCESSFUL COMPLETION. THE AMOUNT OF THIS SEPARATE BOND WILL BE

MINIMUM PERCENTAGE OF CARBONATES OF CALCIUM AND MAGNESIUM SHALL BE SIXTY PERCENT (60 %).

DISTRICT EASEMENT NOT EXPRESSLY APPROVED BY THE DISTRICT BOARD OF COMMISSIONERS.

EXISTING DRAINAGE INLET

) THE FOLLOWING GENERAL NOTES ARE REQUIRED BY CENTRAL BROWARD WATER CONTROL DISTRICT. THEY ARE NOT MEANT TO BE ALL INCLUSIVE, AND IT IS THE ENGINEER OF

3) BONDS: UPON DISTRICT BOARD OF COMMISSIONERS APPROVAL OF PLANS, BUT BEFORE CONSTRUCTION CAN COMMENCE, THE FOLLOWING ITEMS MUST BE COMPLIED WITH

A) BOND (CASH OR SURETY), IN THE DISTRICT'S FAVOR, MUST BE POSTED IN THE AMOUNT OF 110 PERCENT OF THE DEVELOPER'S ENGINEER OF RECORD'S ESTIMATE OF COST OF

B) SWALES, LAKE/POND BANKS, SLOPES, CANALS, AND OTHER EXCAVATIONS SHALL BE BONDED SEPARATELY FROM OTHER DRAINAGE IMPROVEMENTS AND WILL BE HELD BY THE

C) THE DISTRICT'S BOND FORM IS THE ONLY FORM APPROVED FOR USE, AND IT SHALL BE A RECORDED INSTRUMENT. RELEASE OR REDUCTION FROM THE RECORDED INSTRUMENT

PERFORMANCE BOND AS DETERMINED BY THE DISTRICT MAY BE RELEASED. THE BALANCE OF BOND SHALL REMAIN IN FULL FORCE AND EFFECT FOR AN ADDITIONAL TWELVE (12)

EXFILTRATION TRENCHES, WORK IN DISTRICT CANALS, AND BEFORE PLACEMENT OF ASPHALT OR CONCRETE PAVEMENT. CALL (954) 432-5110 FOR AN INSPECTION APPOINTMENT A

i) LIMEROCK BASE COURSE SHALL CONFORM TO THE REQUIREMENTS OF SECTION 911 OF FLORIDA DEPARTMENT OF TRANSPORTATION STANDARD SPECIFICATIONS, EXCEPT THE

6) ALL MUCK AND DELETERIOUS SOILS SHALL BE REMOVED FROM THE TOP OF BANK TO TOP OF BANK LIMITS OF DRY DETENTION/RETENTION AREAS, AND EXFILTRATION TRENCHES

UPSTREAM AND DOWNSTREAM OF THE POINT OF CONNECTION. TELEVISION INSPECTION OF THE PIPES SHALL BE REVIEWED AND CERTIFIED THAT THEY ARE CLEAN BY THE ENGINEER OF

7) ALL NUISANCE VEGETATION SHALL BE REMOVED FROM WITHIN THE PROJECT LIMITS AND WITHIN THE PORTION OF THE CBWCD CANAL THAT FALLS WITHIN THE PROPERTY BOUNDARY. THIS ALSO APPLIES WHEN THE PROPERTY ABUTS A ROADWAY AND THE DISTRICT CANAL IS LOCATED ON THE OPPOSITE SIDE OF THE ROAD WITH RESPECT TO THE


CBWCD GENERAL NOTES

SHALL BE THE RESPONSIBILITY OF THE APPLICANT

NORTH AMERICAN DATUM OF 1983/1990 (NAD83/90).

# PAVING, GRADING & DRAINAGE PLANS

# GRIFFIN 106 SUBDIVISION

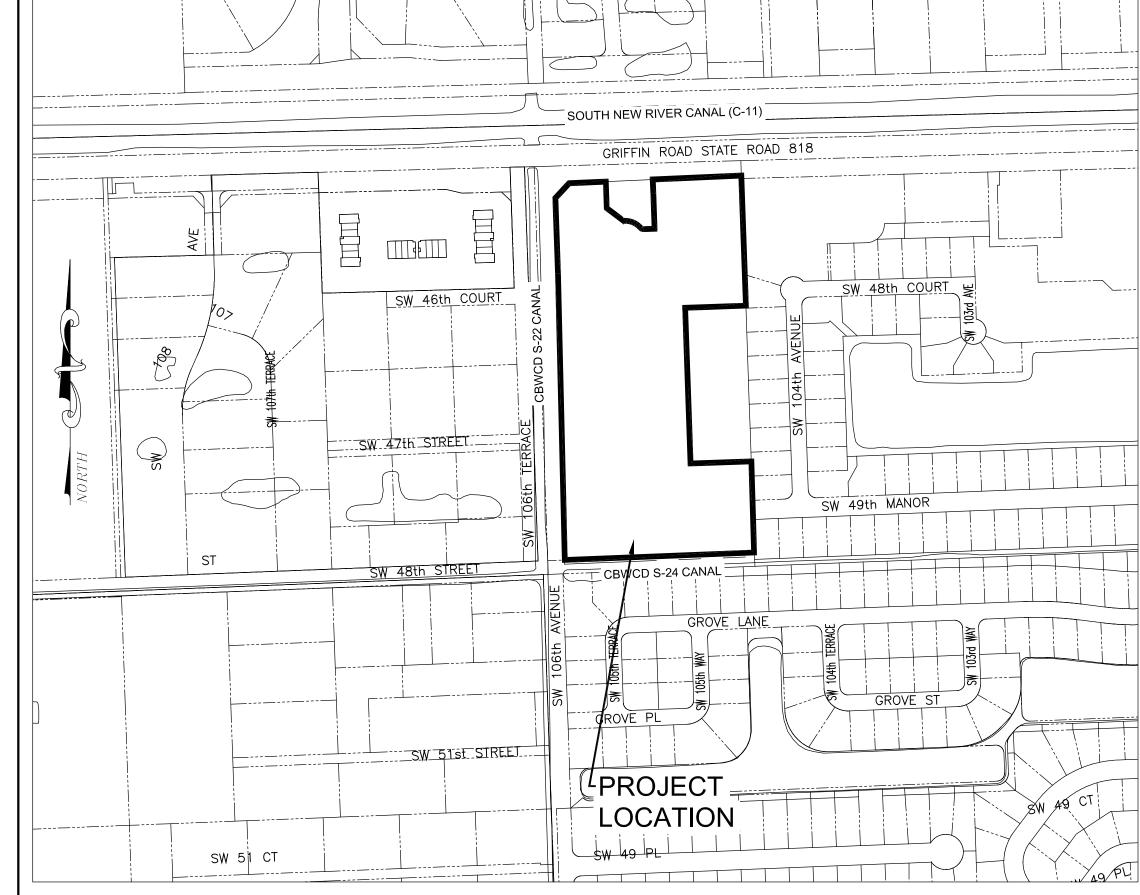

# **LOCATION MAP**

### BROWARD COUNTY - COOPER CITY, FLORIDA SECTION 30 - TOWNSHIP 50 - RANGE 41

#### Folio: 504130010040

#### LEGAL DESCRIPTION:

TRACT TWENTY-NINE (29) OF SECTION 30, TOWNSHIP 50 SOUTH, RANGE 41 EAST, ACCORDING TO NEWMAN'S SURVEY, AS SHOWN ON PLAT RECORDED IN PLAT BOOK 2, PAGE 26, OF THE PUBLIC RECORDS OF DADE COUNTY, FLORIDA; SAID LANDS SITUATE, LYING AND BEING IN BROWARD

#### LESS THE FOLLOWING DESCRIBED PROPERTIES:

A PORTION OF TRACT 29, "NEWMAN'S SURVEY", ACCORDING TO THE PLAT THEREOF, AS RECORDED IN PLAT BOOK 2, PAGE 26 OF THE PUBLIC RECORDS OF DADE COUNTY, FLORIDA, LYING IN SOUTHEAST QUARTER OF SECTION 30, TOWNSHIP 50 SOUTH, RANGE 41 EAST, BROWARD COUNTY, FLORIDA, AND BEING MORE PARTICULARLY DESCRIBED AS FOLLOWS:

COMMENCE AT THE SOUTH ONE QUARTER CORNER OF SAID SECTION 30; THENCE NORTH 01°55'26" WEST ALONG THE WEST LINE OF THE SOUTHEAST QUARTER OF SAID SECTION 30, A DISTANCE OF 1,333.57 FEET TO A POINT ON THE BASELINE OF SURVEY FOR STATE ROAD 818 ACCORDING TO THE FLORIDA DEPARTMENT OF TRANSPORTATION RIGHT-OF-WAY MAP FOR SECTION NO. 86015-2503; THENCE NORTH 88°26'16" EAST ALONG SAID BASELINE OF SURVEY, A DISTANCE OF 660.59 FEET; THENCE SOUTH 01°33'44" EAST ALONG A LINE AT A RIGHT ANGLE FROM THE PREVIOUSLY DESCRIBED COURSE, A DISTANCE OF 50.00 FEET TO A POINT ON THE SOUTHERLY EXISTING RIGHT-OF-WAY LINE FOR SAID STATE ROAD 818 AND THE POINT OF BEGINNING; THENCE SOUTH 88°26'16" WEST ALONG SAID SOUTHERLY EXISTING RIGHT-OF-WAY LINE, A DISTANCE OF 645.27 FEET TO A POINT ON THE EASTERLY EXISTING RIGHT-OF-WAY LINE FOR S.W. 106TH TERRACE; THENCE SOUTH 01°55'26" EAST ALONG SAID EASTERLY EXISTING RIGHT-OF-WAY LINE, A DISTANCE OF 345.20 FEET; THENCE NORTH 88°04'34" EAST, A DISTANCE OF 62.34 FEET; THENCE NORTH 01°55'26" WEST, A DISTANCE OF 236.22 FEET; THENCE NORTH 42°45'43" EAST, A DISTANCE OF 63.29 FEET; THENCE NORTH 87°26'52" EAST, A DISTANCE OF 538.51 FEET; THENCE NORTH 01°58'58" WEST, A DISTANCE OF 54.00 FEET TO THE POINT OF BEGINNING.

A PORTION OF TRACT 29, "NEWMAN'S SURVEY", ACCORDING TO THE PLAT THEREOF, AS RECORDED IN PLAT BOOK 2, PAGE 26 OF THE PUBLIC RECORDS OF DADE COUNTY, FLORIDA, LYING IN SOUTHEAST QUARTER OF SECTION 30, TOWNSHIP 50 SOUTH, RANGE 41 EAST, BROWARD COUNTY, FLORIDA, AND BEING MORE PARTICULARLY DESCRIBED AS FOLLOWS:

COMMENCE AT THE SOUTH ONE QUARTER CORNER OF SAID SECTION 30; THENCE NORTH 01°55'26" WEST ALONG THE WEST LINE OF THE SOUTHEAST QUARTER OF SAID SECTION 30, A DISTANCE OF 1,333.57 FEET TO A POINT ON THE BASELINE OF SURVEY FOR STATE ROAD 818 ACCORDING TO THE FLORIDA DEPARTMENT OF TRANSPORTATION RIGHT-OF-WAY MAP FOR SECTION NO. 86015-2503; THENCE NORTH 88°26'16" EAST ALONG SAID BASELINE OF SURVEY, A DISTANCE OF 663.97 FEET; THENCE SOUTH 01°33'44" EAST ALONG A LINE AT A RIGHT ANGLE FROM THE PREVIOUSLY DESCRIBED COURSE, A DISTANCE OF 510.84 FEET TO A POINT ON THE EASTERLY BOUNDARY LINE OF SAID TRACT 29 AND THE POINT OF BEGINNING; THENCE SOUTH 01°58'58" EAST ALONG SAID EASTERLY BOUNDARY LINE, A DISTANCE OF 487.00 FEET; THENCE SOUTH 88°01'02" WEST, A DISTANCE OF 190.00 FEET; THENCE NORTH 01°58'58" WEST, A DISTANCE OF 487.00 FEET; THENCE NORTH 88°01'02" EAST, A DISTANCE OF 190.00 FEET TO THE POINT OF BEGINNING.

#### SUBJECT TO THE RIGHT-OF-WAY OF SW 106TH AVENUE.

SAID LANDS LYING AND BEING IN THE CITY OF COOPER CITY, BROWARD COUNTY, FLORIDA AND CONTAINING 604,250 SQUARE FEET (13.8717 ACRES),



Call 811 or visit sunshine811.com two full business days before digging to have buried facilities located and marked.

Check positive response codes before you dig!

NAVD88 = NGVD1929 - 1.601'

**ELEVATIONS SHOWN ON THESE** 

NORTH AMERICAL DATUM (NAVD88)

PLANS ARE RELATIVE TO THE

PROJECT ACREAGE: 13.477 PAVEMENT ACREAGE: 1.634

### **ENGINEER CERTIFICATION NOTE**

THE PUBLIC ROADWAY(S) INDICATED IN THESE PLANS HAVE BEEN DESIGNED IN ACCORDANCE WITH THE "MANUAL OF UNIFORM MINIMUM STANDARDS FOR DESIGN, CONSTRUCTION AND MAINTENANCE FOR STREETS & HIGHWAYS - STATE OF FLORIDA."

ELEVATION IN FEET REQUIRED PROVIDED ELEVATIONS IN THESE DRAWINGS ARE BASED ON 0.00 NGVD29 = (-) 1.604<u> MINIMUM FINISHED FLOOR ELEVATION CRITERIA</u> 5.0 + 1.0 = 6.07.5 NAVD 6.5 NAVD 7.5 NAVD BROWARD COUNTY 100-YEAR FLOOD ELEVATION 7.5 NAVD 18" ABOVE NEAREST ROAD CROWN ELEVATION -6.0 NAVD 7.5 NAVD 6" ABOVE NEAREST ROAD CROWN ELEVATION -N/A N/A MINIMUM CROWN OF ROAD ELEVATION CRITERIA 5.5 NAVD | 5.60 NAVD **BROWARD COUNTY 10-YEAR FLOOD ELEVATION** 5.56 NAVD

**CONTACT PERSON INFORMATION** 

EMAIL ADDRESS: ADAMS@WHITMORECE.COM

NAME: ANDREW W. ADAMS, P.E.

TELEPHONE NUMBER: 305-339-5885

#### SUMMARY OF PROPOSED WATER USAGE

### SERVICE

RESIDENTIAL STRUCTURES

10-YEAR 1-DAY PEAK STAGE

25-YEAR 3-DAY PEAK STAGE

**NON-RESIDENTIAL STRUCTURES** 

MINIMUM PERIMETER BERM ELEVATION

**GALLONS PER DAY** 

OCATION

S F B

6.35 NAVD | 6.35 NAVD

#### Thirty-nine Single Family Residences @ 300 GPD/Residence


#### **Total Gallons Per Day**

- ENSURE APPROPRIATE EROSION CONTROL DEVICES ARE IN PLACE
- THROUGHOUT THE DURATION OF CONSTRUCTION
- DONE BY THE PERMITTEE TO UNDERGROUND FACILITIES AND ABOVE GROUND FACILITIES.
- 522-003 AND FDOT STANDARD SPECIFICATION 522 REFER TO THE FDOT DESIGN STANDARDS IN THE GENERAL NOTES. MAKE SURE TO FURNISHING APPROPRIATE EXPANSION JOINTS AS PER DS INDEX
- ALL PORTIONS OF THE STATE RIGHT OF WAY SHALL BE RESTORED WITHIN (30) DAYS UPON COMPLETION OF THE PERMITTED INSTALLATION
- 6. EXISTING FDOT DRAINAGE SHALL BE PROTECTED ALWAYS BY THE PERMITTEE, ANY DAMAGE TO THE FDOT DRAINAGE SYSTEM SHALL BE REPAIRED / REPLACED BY THE PERMITTEE AT NO COST TO THE
- PERMITTEE MUST TAKE PICTURES OF THE EXISTING STREET LIGHTNING SYSTEM WORKING-DURING NIGHT-TIME-WITHIN THE LIMITS OF THIS PROPOSED JOB PRIOR TO BEGIN SAID WORK, TO AVOID FUTURE DISPUTE ABOUT UNFORESEEN DAMAGES TO THE
- LIGHTNING SYSTEM. B. WORKING HOURS WITHIN THE F.D.O.T. RIGHT OF WAY SHALL BE
- BETWEEN THE HOURS OF 9:30 A.M. AND 3:30 P.M. AND OPTIONALLY FROM 9:00 P.M. TO 5:00 A.M. OR AS DIRECTED BY THE DEPARTMENT REPRESENTATIVE PRIOR TO COMMENCEMENT OF WORK 9. DAMAGED PAVEMENT WILL BE RESTORED AT THE PERMITTEES
- 10. COMPACT FILL AREAS, INCLUDING CUT ARE AS UNDER THE SIDEWALK THAT HAVE BEEN EXCAVATED MORE THAN 6" BELOW THE BOTTOM OF SIDEWALK, TO A MINIMUM OF 95% OF AASHTO

EXPENSE AND WILL BE IN FULL LANE WIDTHS WITH THE SAME TYPE

- T99 DENSITY. THE AREA TO BE COMPACTED IS DEFINED AS THAT AREA DIRECTLY UNDER THE SIDEWALK AND 1 FOOT BEYOND EACH SIDE OF THE SIDEWALK WHEN RIGHT-OF-WAY ALLOWS. (SPEC.
- 11. THE ASPHALT AT THIS LOCATION IS LESS THAN 5 YEARS OLD, ANY DAMAGE TO PAVEMENT THAT IS LESS THAN 5 YEARS OLD WILL HAVE TO BE MILLED AND RESURFACED IN FULL LANE WIDTHS. BY 50' IN EITHER DIRECTION FROM THE DAMAGED AREA. ASPHALT WILL BE MATCHED TO THE EXISTING ASPHALT TYPE USED IN THE PREVIOUS FDOT PROJECT PAVEMENT STRUCTURE: MINIMUM ASPHALT MIX ARE SP-12.5 (4.0" THICK) & FC-12.5 (1.5" THICK) W/ PG 76-22. MAINTAIN THE PERMANENT PATCHES FOR A PERIOD OF TWO (2) YEARS FROM THE DATE OF INSTALLATION.

THIS ITEM HAS BEEN DIGITALLY SIGNED AND SEALED BY ANDREW W. ADAMS, P.E. ON THE DATE ADJACENT TO THE SEAL. PRINTED COPIES OF THIS DOCUMENT ARE NOT CONSIDERED SIGNED AND SEALED AND THE SIGNATURE MUST BE VERIFIED ON ANY ELECTRONIC COPIES.

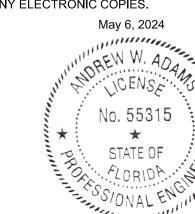



REGISTERED ENGINEER #55318 STATE OF FLORIDA DESIGNED: AWA DRAWN: AWA CHECKED: AWA SCALE: AS NOTED DATE: 08/30/2023 PROJ. NO. 2306A


C-01


#### —— WAT-6 —— WAT-6 —— EXISTING 6" WATER LINE EXISTING DRAINAGE INLET SEWER LATERAL CONNECTIONS —— WAT-12— WAT-12— EXISTING 12" WATER LINE TO MAIN IS PER SS 1.0 & EXFILTRATION TRENCH —— SEW-8 —— SEW-8 —— EXISTING 8" GRAVITY SEWER MAIN EXISTING PIV AND FDC — PROP 6" C-900 SEW SERV @ — FM-8 — FM-8 — EXISTING 8" SEWER FORCE MAIN 1/8"/FT SLOPE MIN (TYP) FPL EXISTING FPL BOX — — — IRR— — — IRR— EXISTING IRRIGATION LINE - PROP 6" C-900 PUB C.O. PER SS 1.0 (TYP) EXISTING LIGHT POLE IF LOCATED IN TRAFFIC AREA USE No. 53 — — — — GAS— — — — GAS **EXISTING GAS LINE** VALVE BOX PER SS 13.0 EXISTING AIR RELEASE VALVE - - - FPL- - - FPL- - - FPL- EXISTING ELECTRIC LINE (HOMESTEAD ELECTRIC) - PROP 6" C-900 PRIVATE C.O. - - - $\times$ - - $\times$ - $\times$ - EXISTING FENCE EXISTING LIGHT POLE - --- DRN--- --- DRN- EXISTING DRAINAGE LINE 1" HDPE WATER SERVICE WITH A SINGLE EXISTING LIGHT POLE METER BOXES PER WS 2.10 AND WS 2.16 SHT 3 TEL TEL EXISTING TELEPHONE/CABLE LINE OF 4 FOR (1) 5/8" WATER METERS. NO METERS **EXISTING AIR CONDITIONING PAD** ON TRAFFIC AREAS EXISTING ELECTRIC BOX EXISTING GAS VALVE EXISTING TELEPHONE BOX EXISTING ELECTRIC BOX **PROPOSED** CATCH BASIN EXISTING ELECTRIC BOX EXISTING SEWER MANHOLE **SECTION NUMBER** EXISTING TREE CATCH BASIN $\triangleright \triangleleft$ EXISTING VALVE PER WS 1.60 **EXISTING TREE** (2) PROP 8" - 45° PAGE SECTION -EXISTING TREE WAS CUT ON WAS DRAWN ON **EXISTING IRRIGATION CONTROL VALVE** -PROP F.H. AS PER WS 4.50 WITH GUARD POSTS EXISTING IRRIGATION CONTROL VALVE PROP 8"x6" TEE EXISTING DRAINAGE MANHOLE W/6" G.V. TIED EXISTING GAS VALVE 1801 **EXISTING SANITARY SEWER SERVICE** ~ PROPOSED CBWCD CENTRAL BROWARD WATER CONTROL DISTRICT CURB & GUTTER DRAINAGE FLOWAGE STORAGE EASEMENT **EXISTING SANITARY SEWER SERVICE** - PROPOSED LANDSCAPE PLANTER NO TREE OR PLANTER WITHIN **EXISTING SANITARY SEWER CLEANOUT** 6' OF PROPOSED WATER OR SEWER MAIN → PROPOSED SIDEWALK PROPOSED DRAINAGE STRUCTURE EXISTING WATER METER BOX PROPOSED DRAINAGE STRUCTURE AND EXFILTRATION TRENCH EXISTING POWER POLE PROPOSED DRAINAGE STRUCTURE, **EXFILTRATION TRENCH & YARD DRAIN** EXISTING POWER POLE


# 10) THE DISTRICT SECRETARY/MANAGER AND DISTRICT ENGINEER SHALL BE NOTIFIED PRIOR TO THE SUBMITTAL OF AS-BUILT/RECORD DRAWINGS OF ANY ENCROACHMENT WITHIN A 11) AS-BUILT SURVEY AND RECORD DRAWING: "AS-BUILT" PLANS FROM THE SURVEYOR OF RECORD MUST BE CERTIFIED AS "RECORD DRAWINGS" BY THE ENGINEER OF RECORD. THE SÚRVEYOR'S CERTIFICATION SHALL INCLUDE THE LAST DATE OF FIELD DATA ACQUISITION. THE ENGINEER'S CERTIFICATION SHALL INCLUDE THE CBWCD PERMIT COMPLIANCE STATEMENT. AS-BUILTS SHALL BE PROVIDED AS AN OVERLAY ON THE APPROVED CONSTRUCTION DRAWINGS AT THE SAME SCALE FOR COMPARISON PURPOSES. ALL REFERENCES TO "PROPOSED" SHALL BE STRUCK THROUGH AND REPLACED WITH THE AS-BUILT CONDITION. AS-BUILT SUBMITTALS SHALL FOLLOW THE SAME FORMAT OF GENERAL REVIEW AS DESCRIBED 12) LAKE/POND, CANAL, AND DRY DETENTION/RETENTION AREA AS-BUILTS WILL BE CROSS-SECTIONED SHOWING THE DESIGNED SECTION AS DASHED, AS-BUILT SECTION AS SOLID, AND HAVE THE TOP OF BANK REFERENCE TO THE LAKE/CANAL MAINTENANCE EASEMENT. SPACING BETWEEN EACH CROSS-SECTION SHALL BE SUCH AS TO PROVIDE ENOUGH DATA TO DETERMINE IF THE LAKE/POND/CANAL/DRY DETENTION/RETENTION AREA WAS CONSTRUCTED AS DESIGNED. THE MAXIMUM SPACING BETWEEN CROSS SECTIONS SHALL BE 100' 13) THE CONTRACTOR SHALL PROVIDE STABLE AND PERMANENT ELEVATION BENCHMARKS ON THE TOP OF EACH HEADWALL CAP FOR PIPES DISCHARGING INTO DISTRICT CANALS AND DRIVEWAY CULVERTS ALONG DISTRICT CANALS. THE BENCHMARK ELEVATION SHALL BE BASED ON NORTH AMERICAN VERTICAL DATUM OF 1988 (NAVD88) AND INCLUDE THE DATUM REFERENCE USING NATIONAL GEODETIC SURVEY BENCHMARKS OR FLORIDA DEPARTMENT OF TRANSPORTATION BENCHMARKS IN NAVD88 AND ONLY CONVERTED BACK TO NATIONAL GEODETIC VERTICAL DATUM OF 1929 (NGVD29). THE OTHER SHALL BE BASED ON NGVD29 AND INCLUDE THE DATUM REFERENCE. EACH HEADWALL SHALL HAVE ONE (1) NAVD88 AND ONE 14) THE SURVEYOR OF RECORD SHALL ANNOTATE THE BENCHMARK ELEVATIONS ON THE AS-BUILT DRAWING IN THE FORMAT PROVIDED BY THE DISTRICT ENGINEER. THE BENCHMARK DATA SHALL ALSO INCLUDE A NORTHING/EASTING COORDINATE AT THE CENTER OF EACH HEADWALL. THE HORIZONTAL DATUM SHALL BE BASED ON STATE PLANE, FLORIDA EAST ZONE, \_\_\_\_ WAT-8 \_\_\_ WAT-8 \_\_\_ EXISTING 8" WATER LINE COUNTY, FLORIDA.

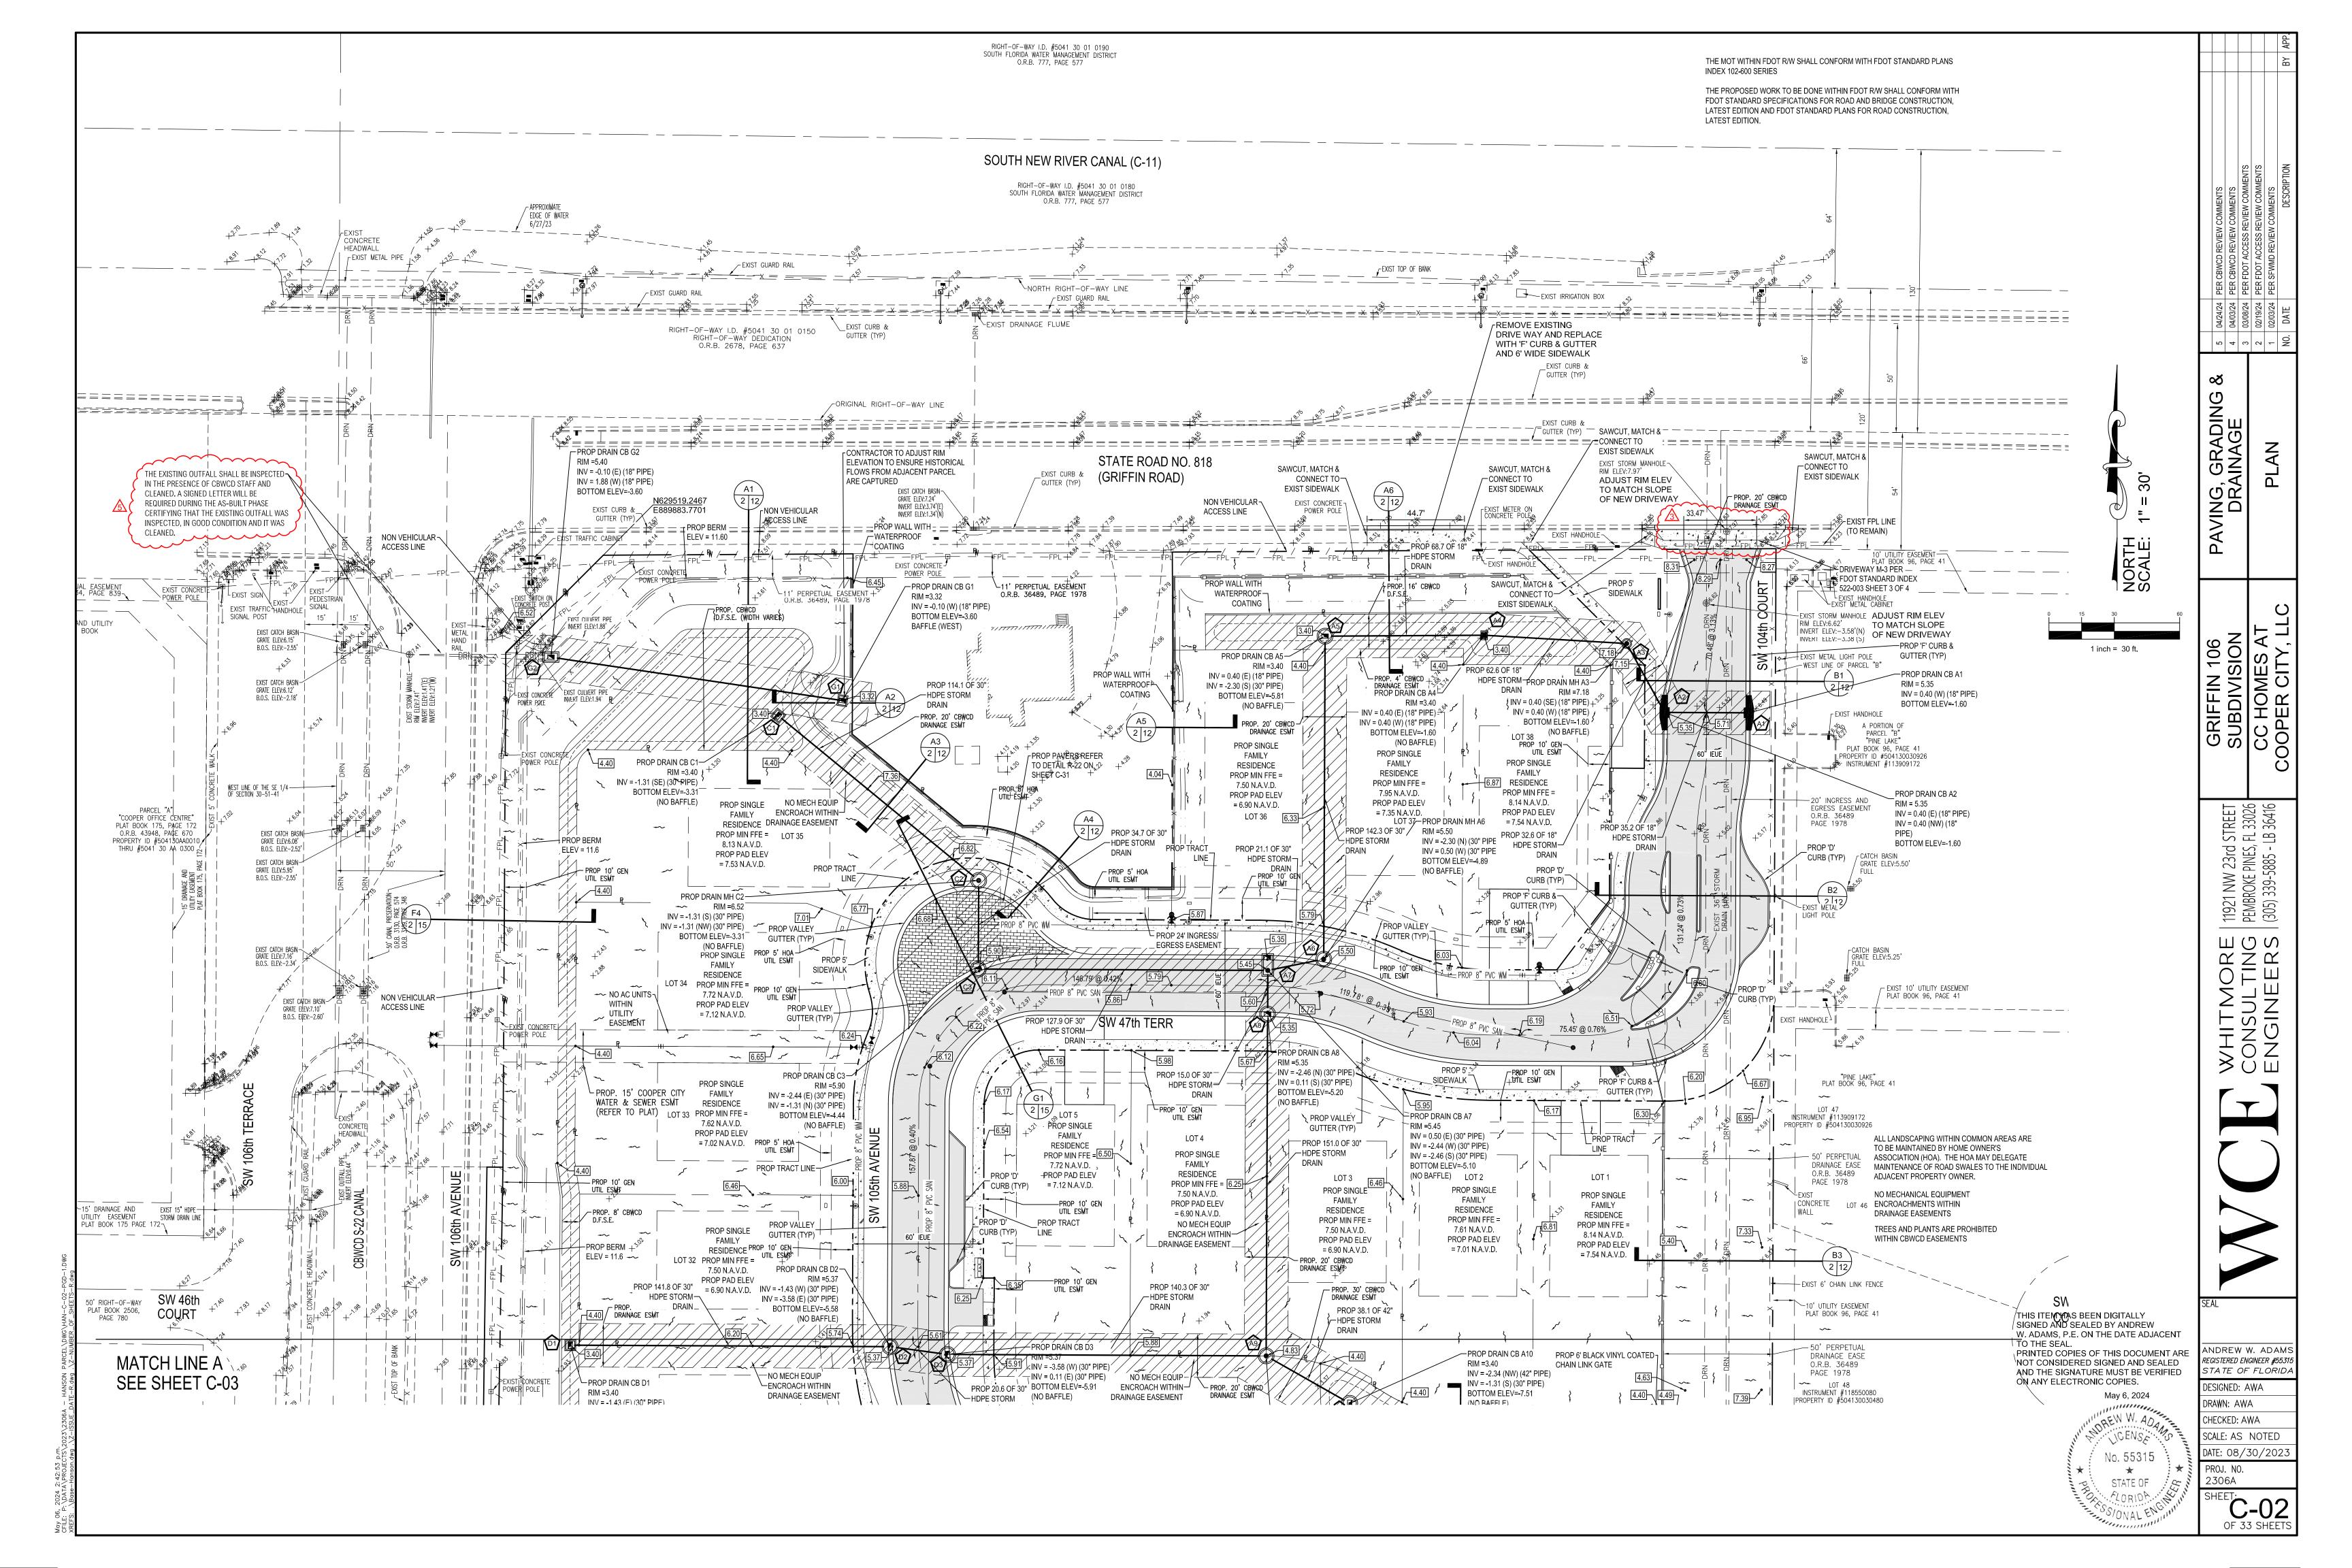


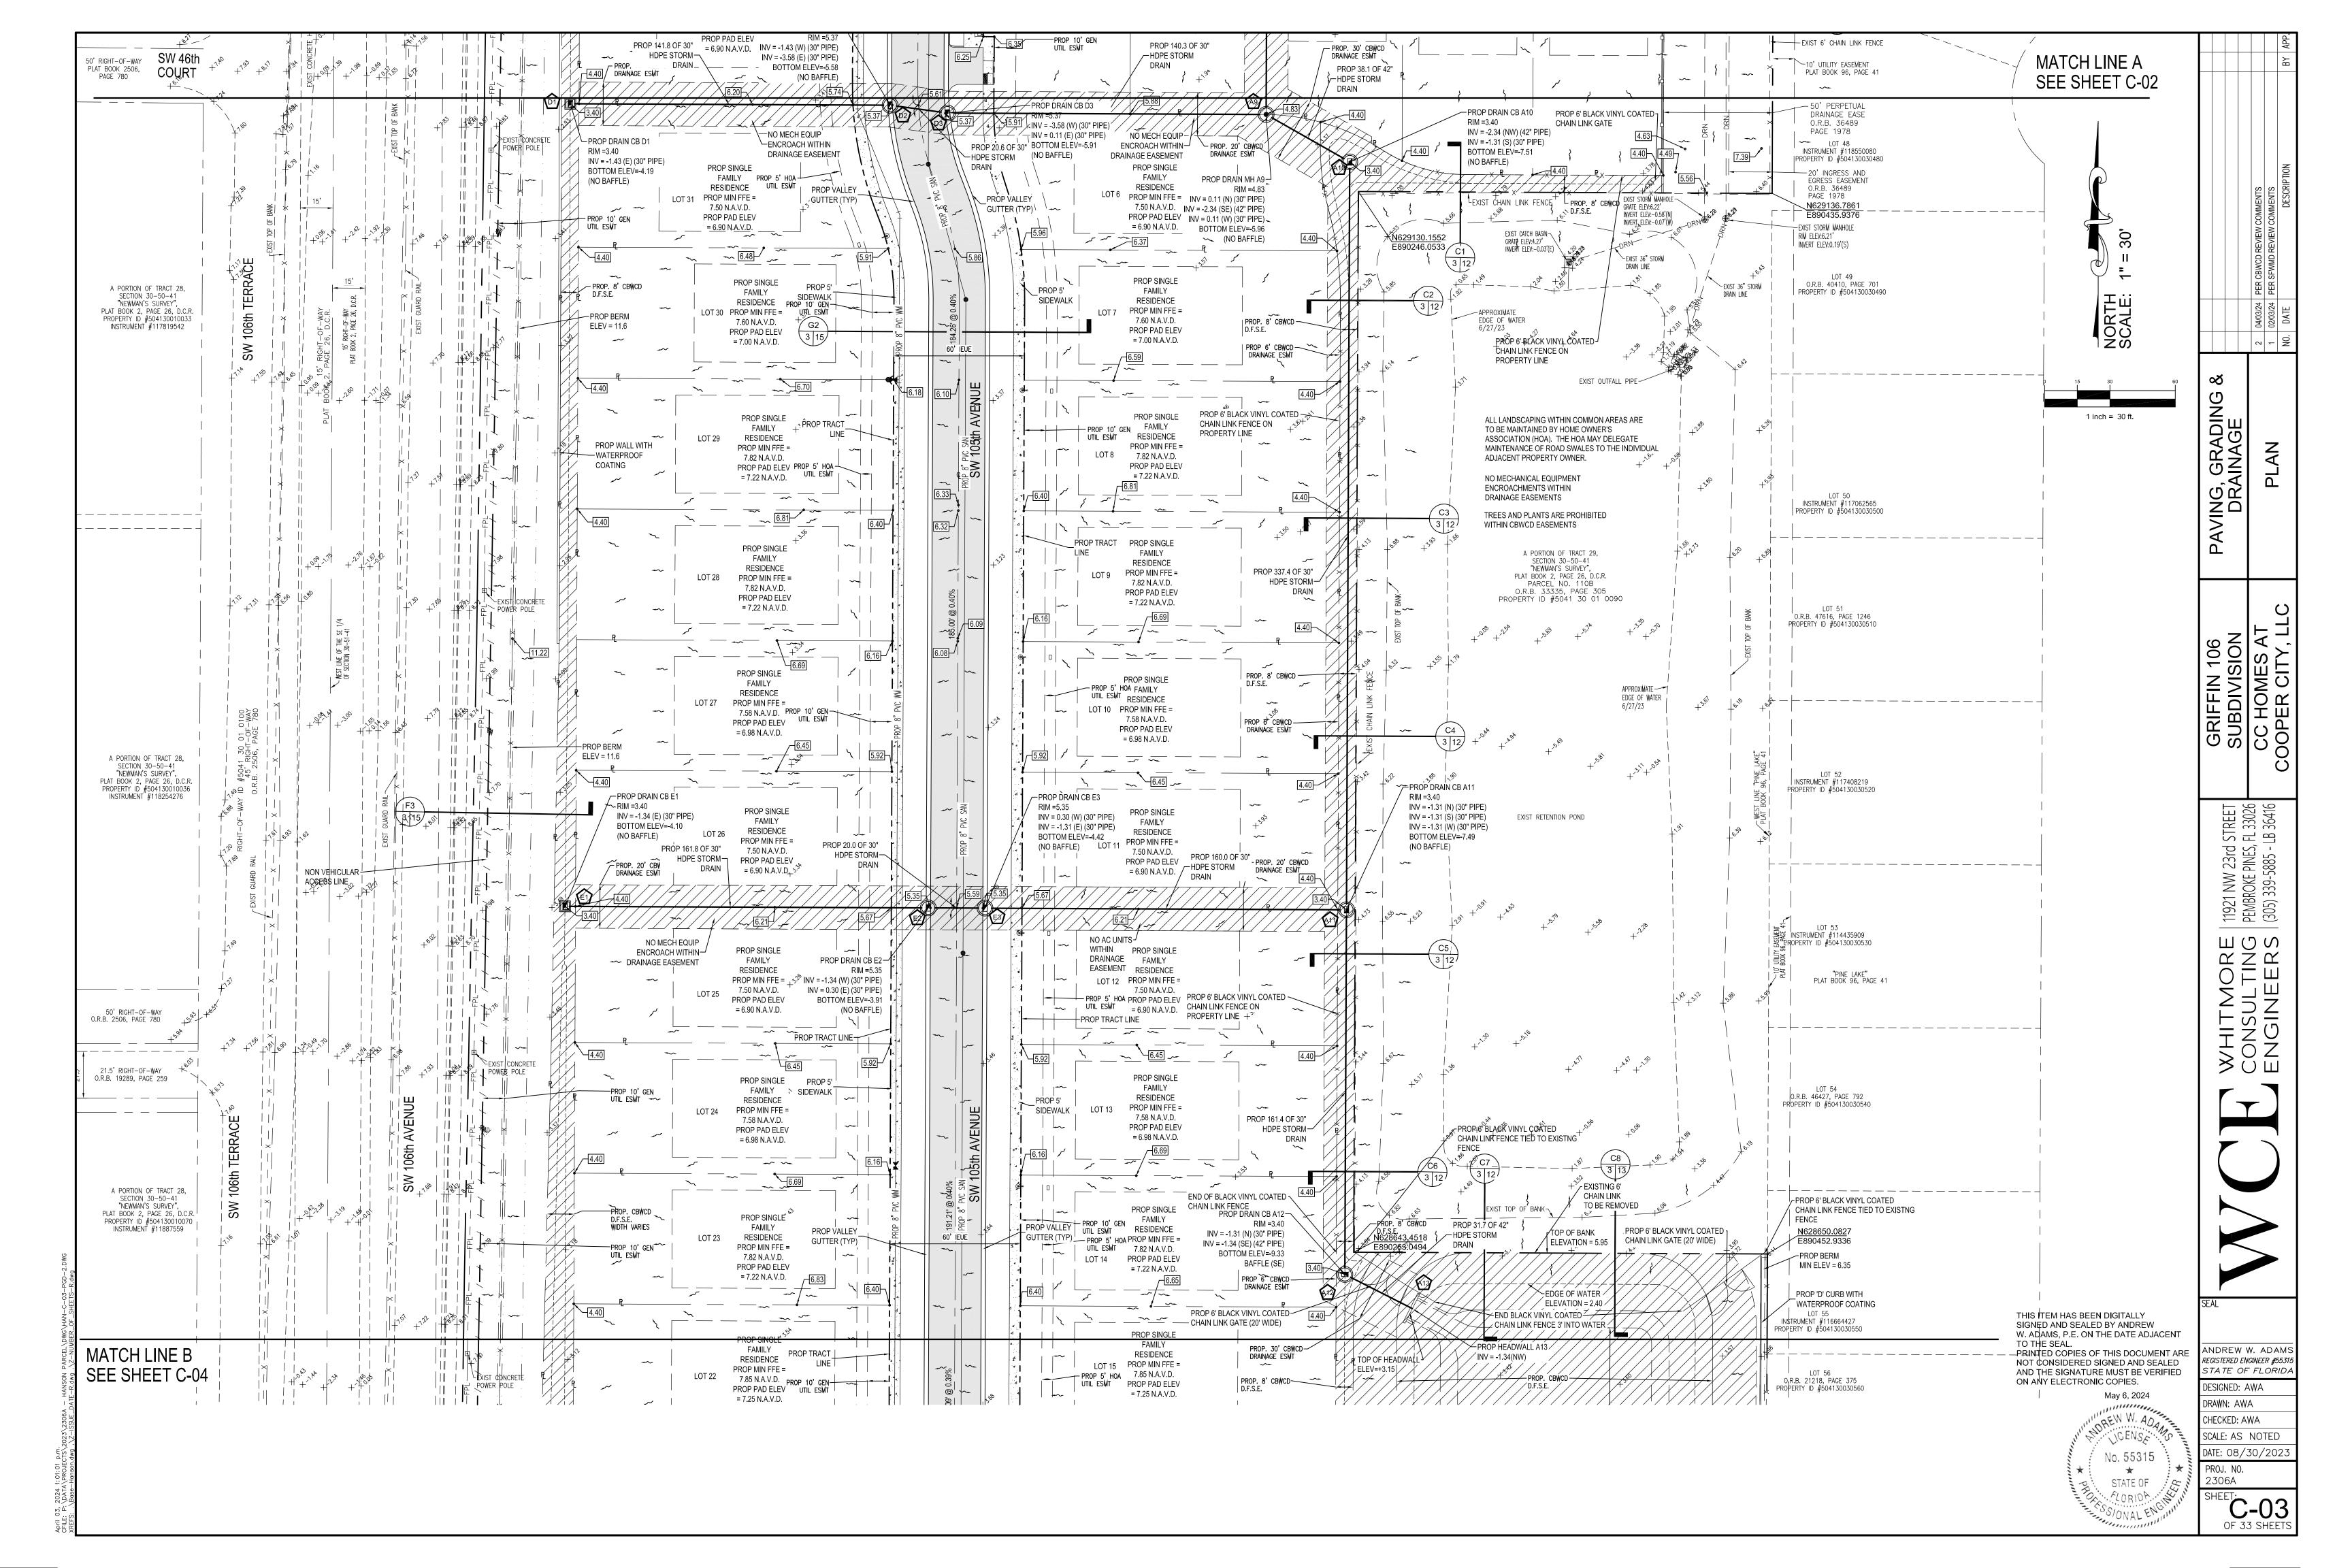


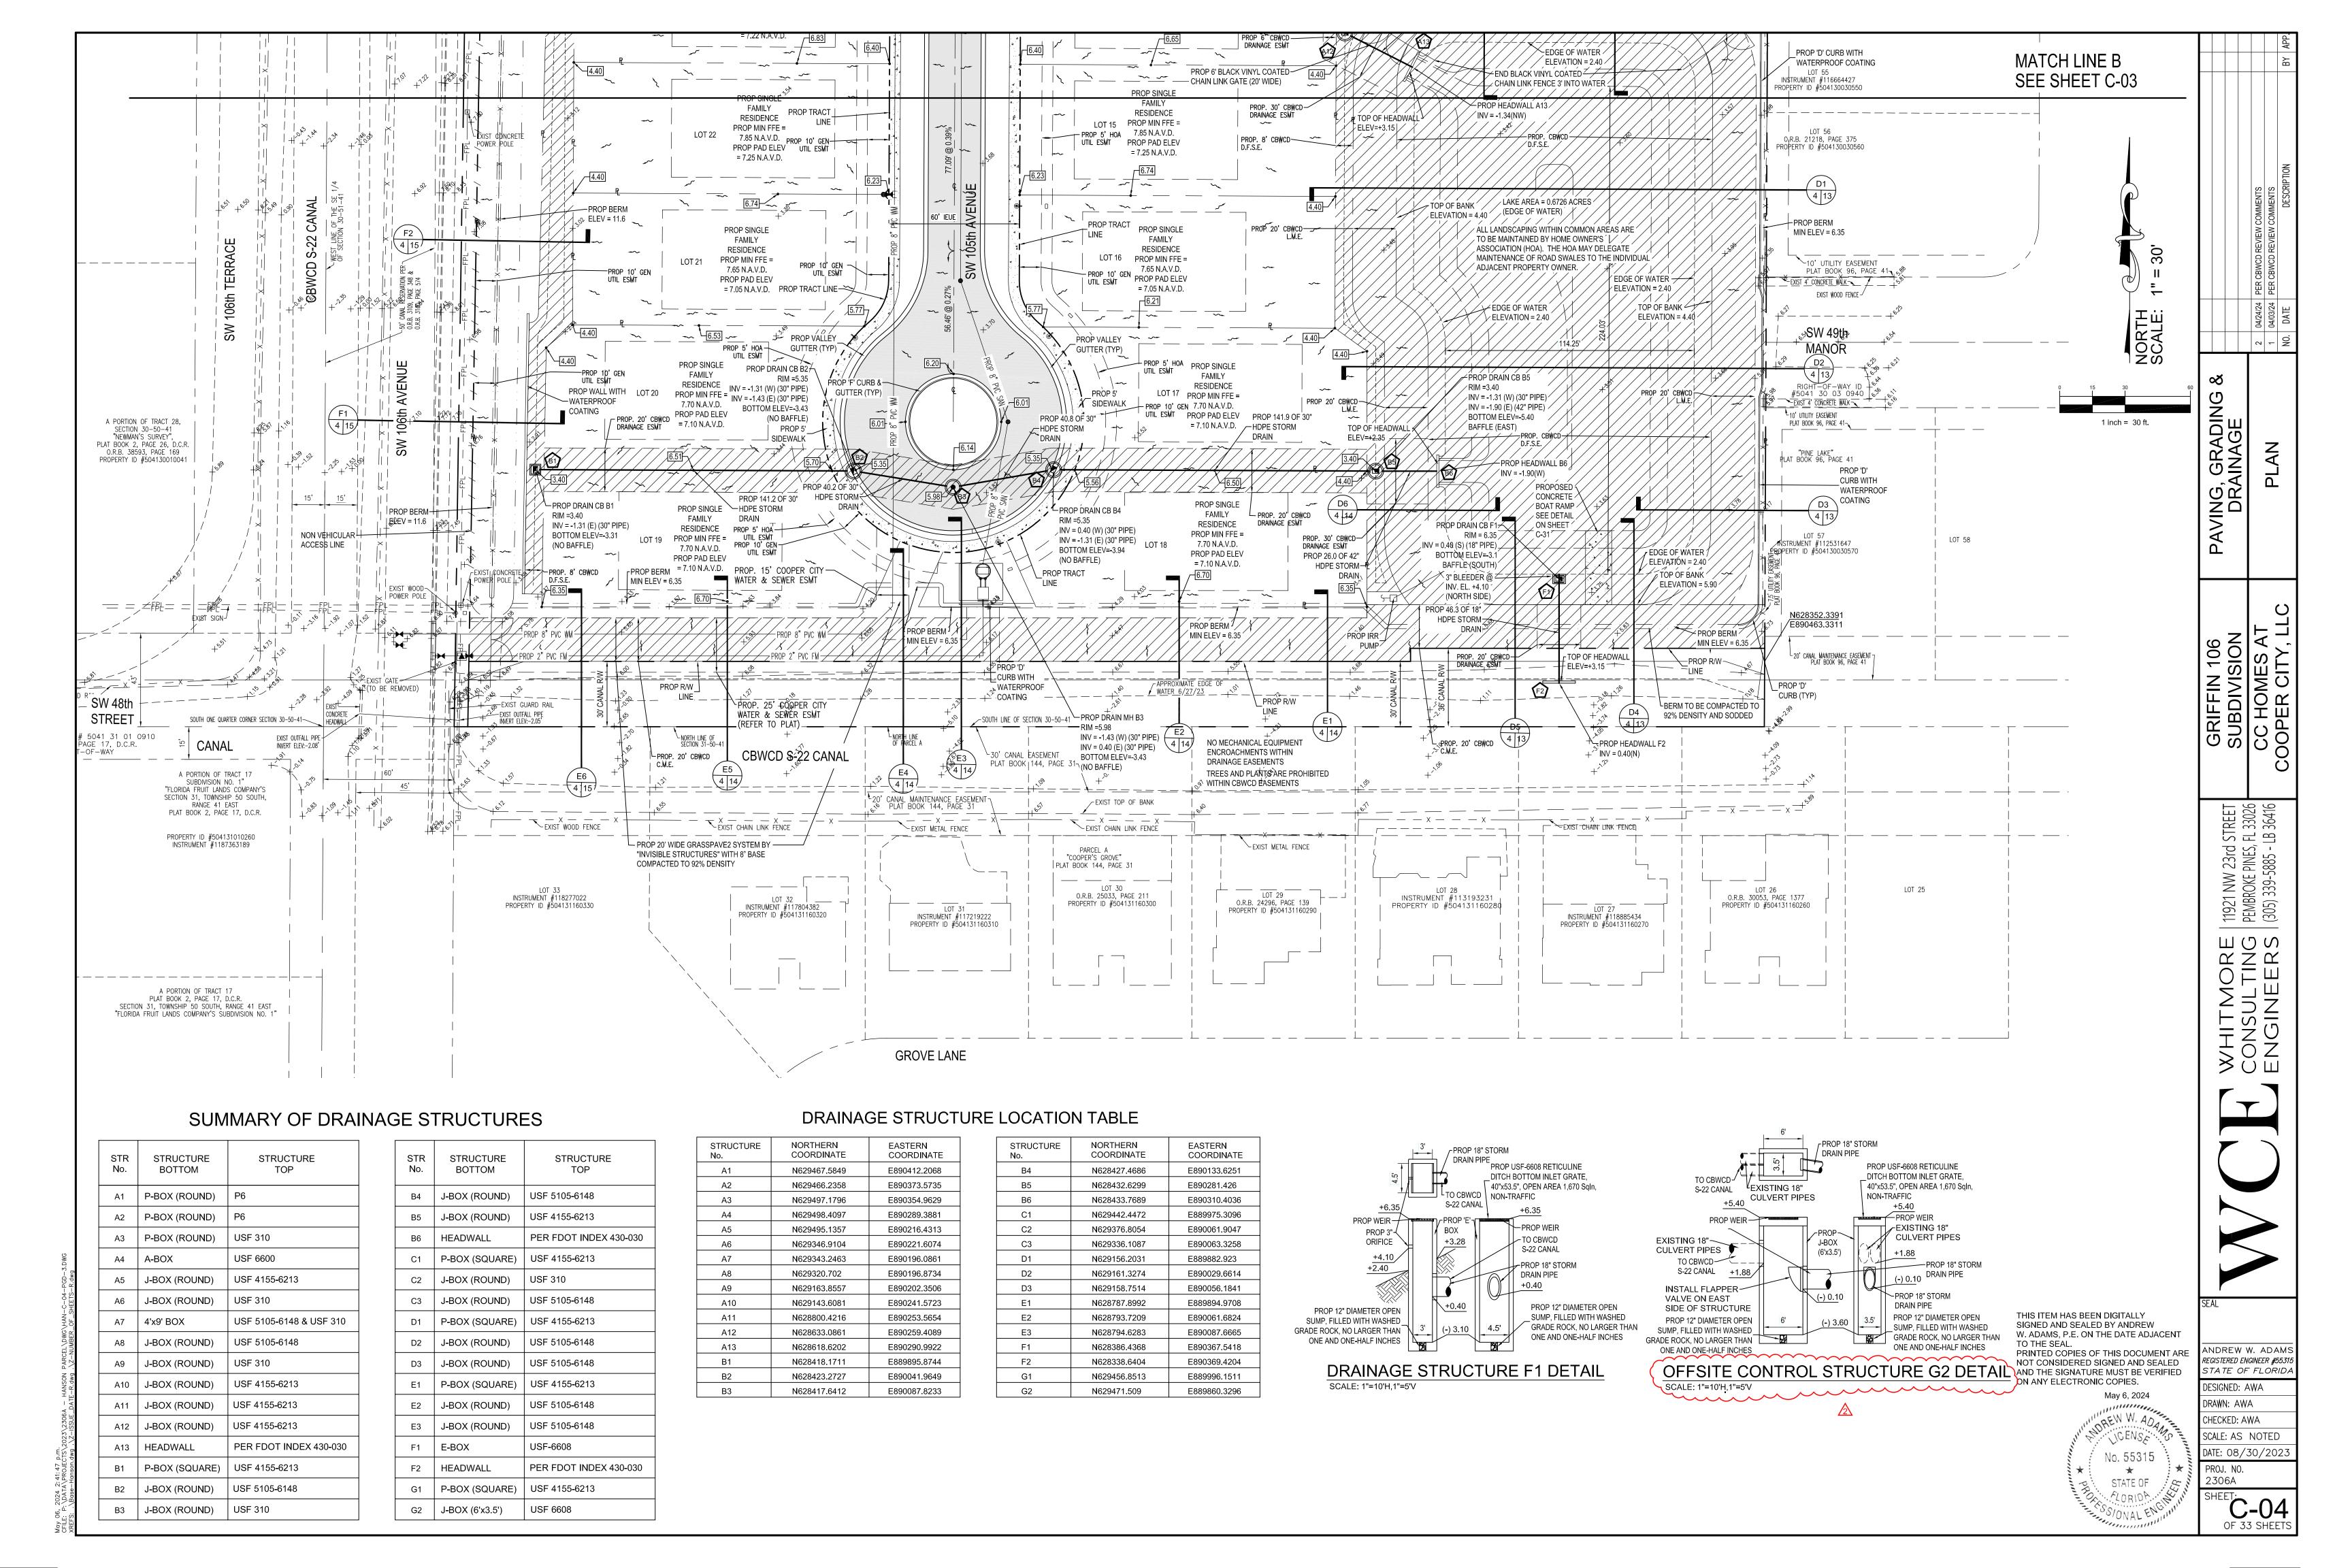


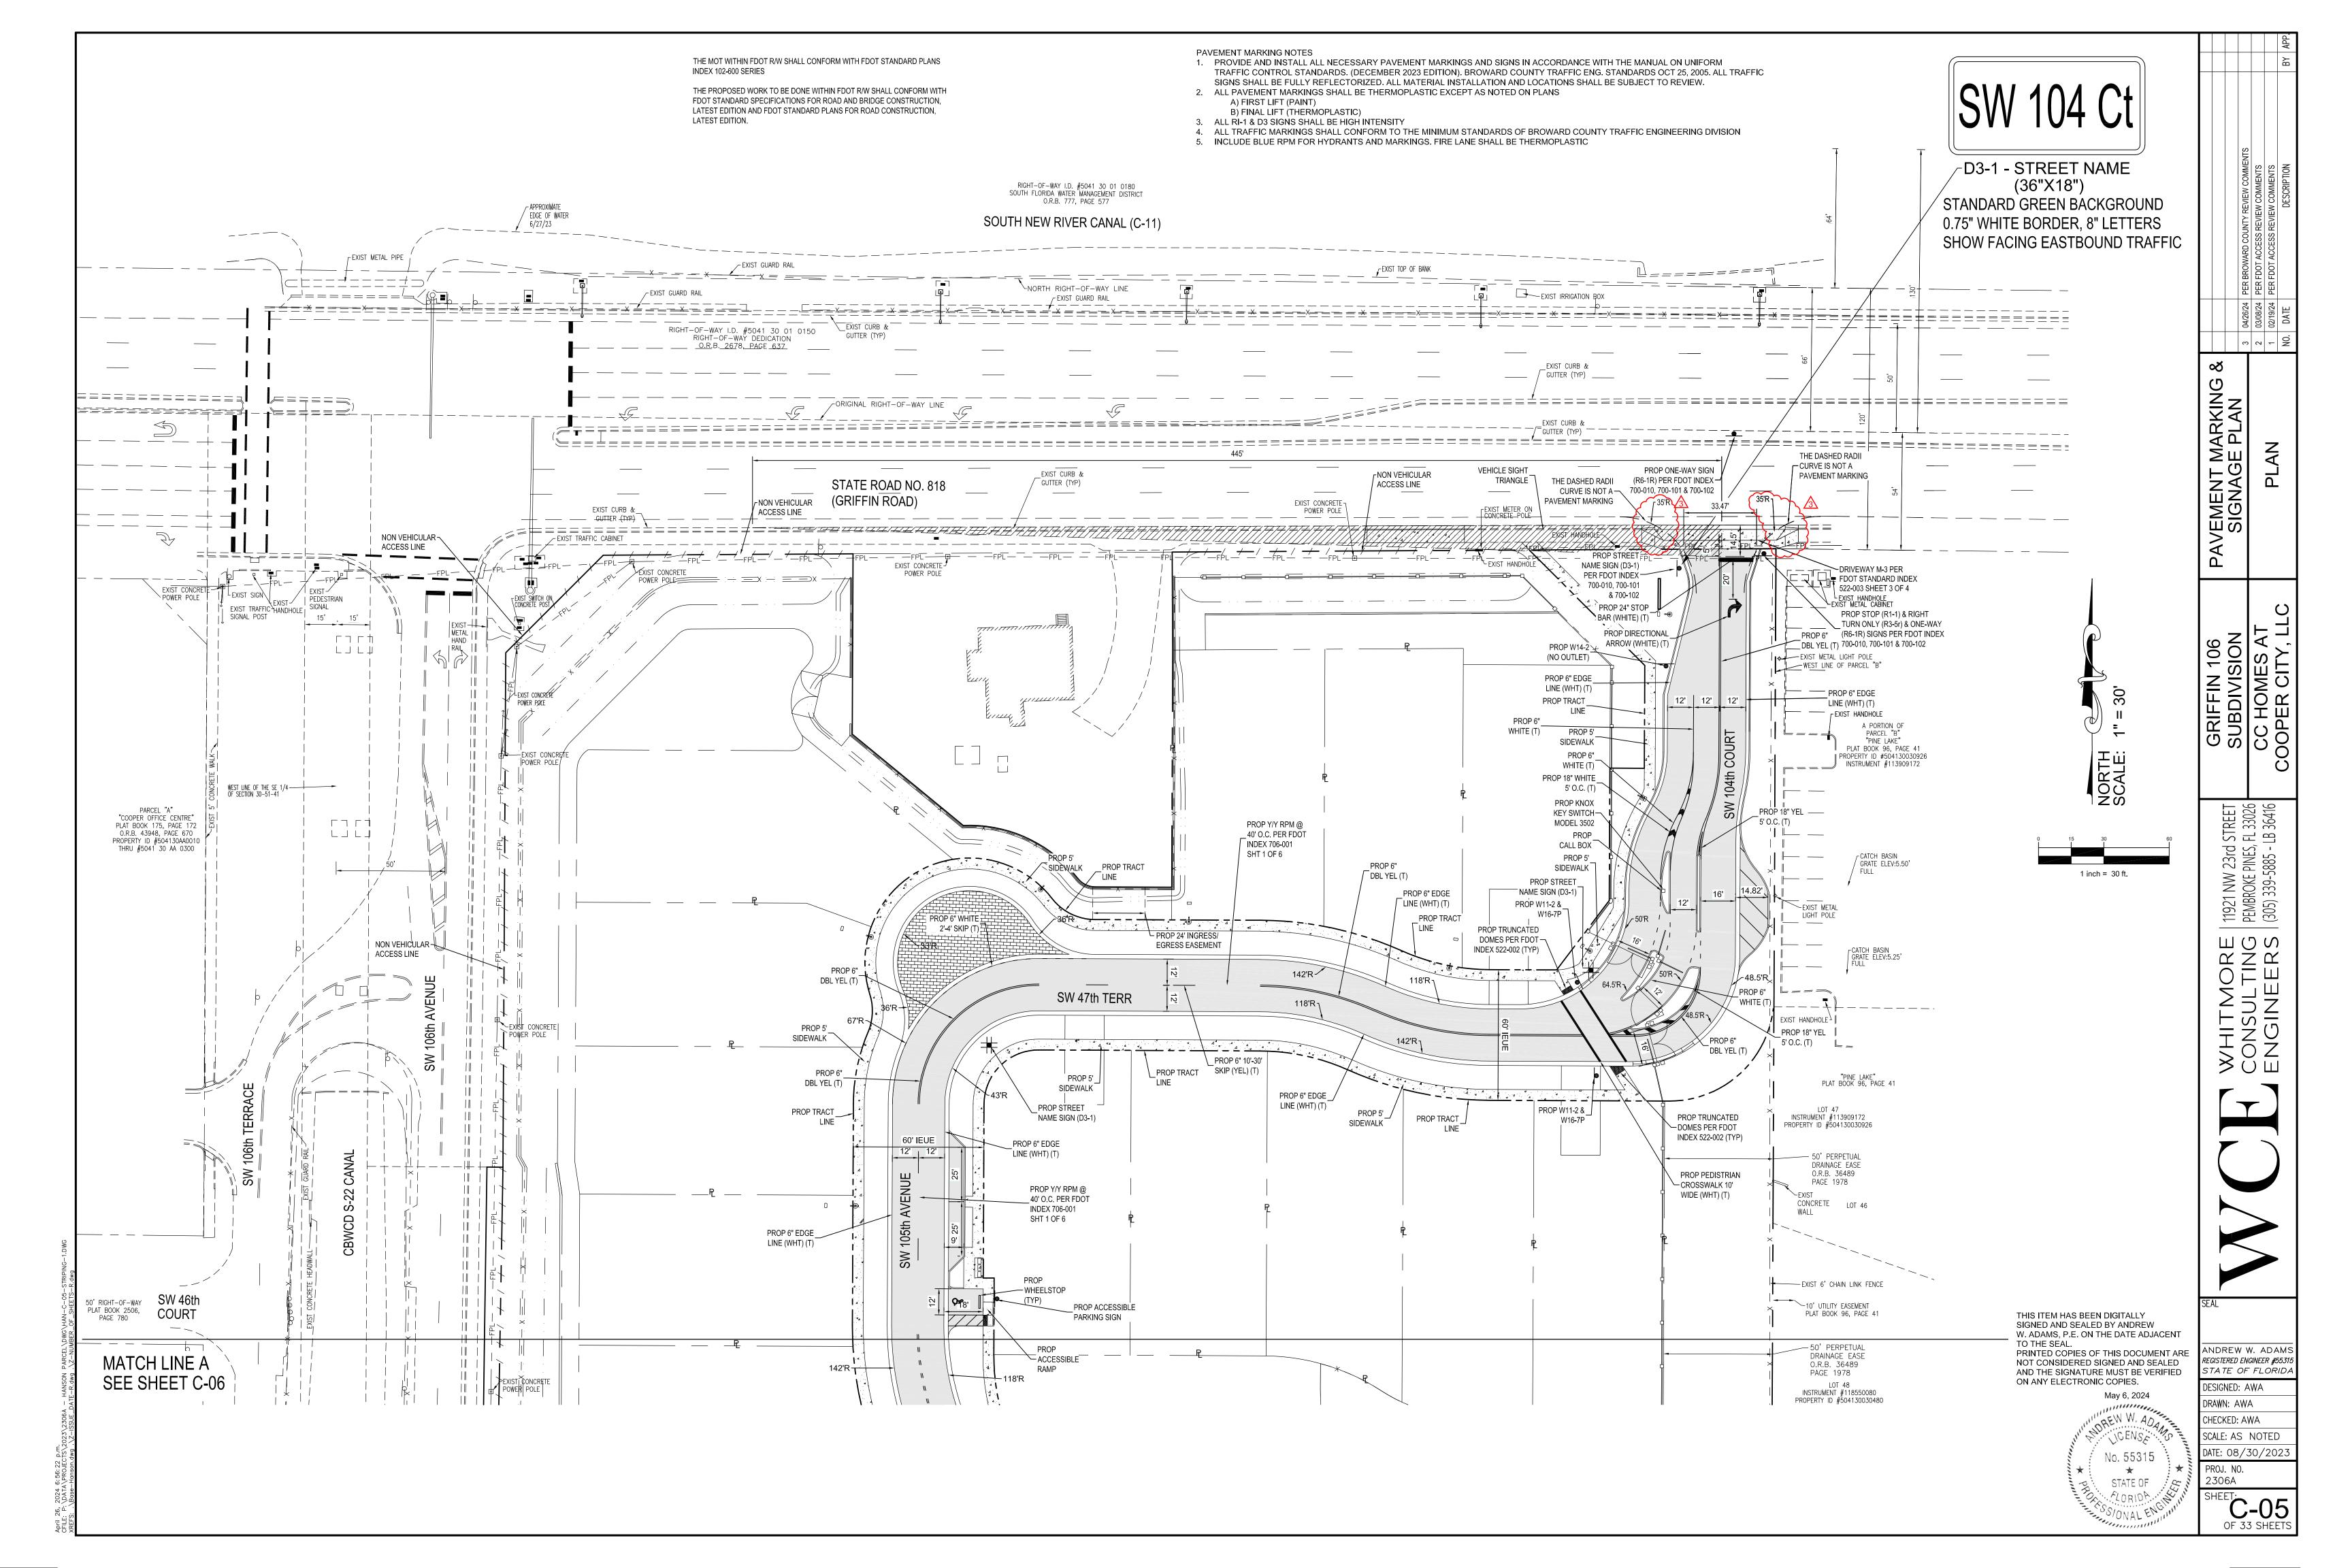

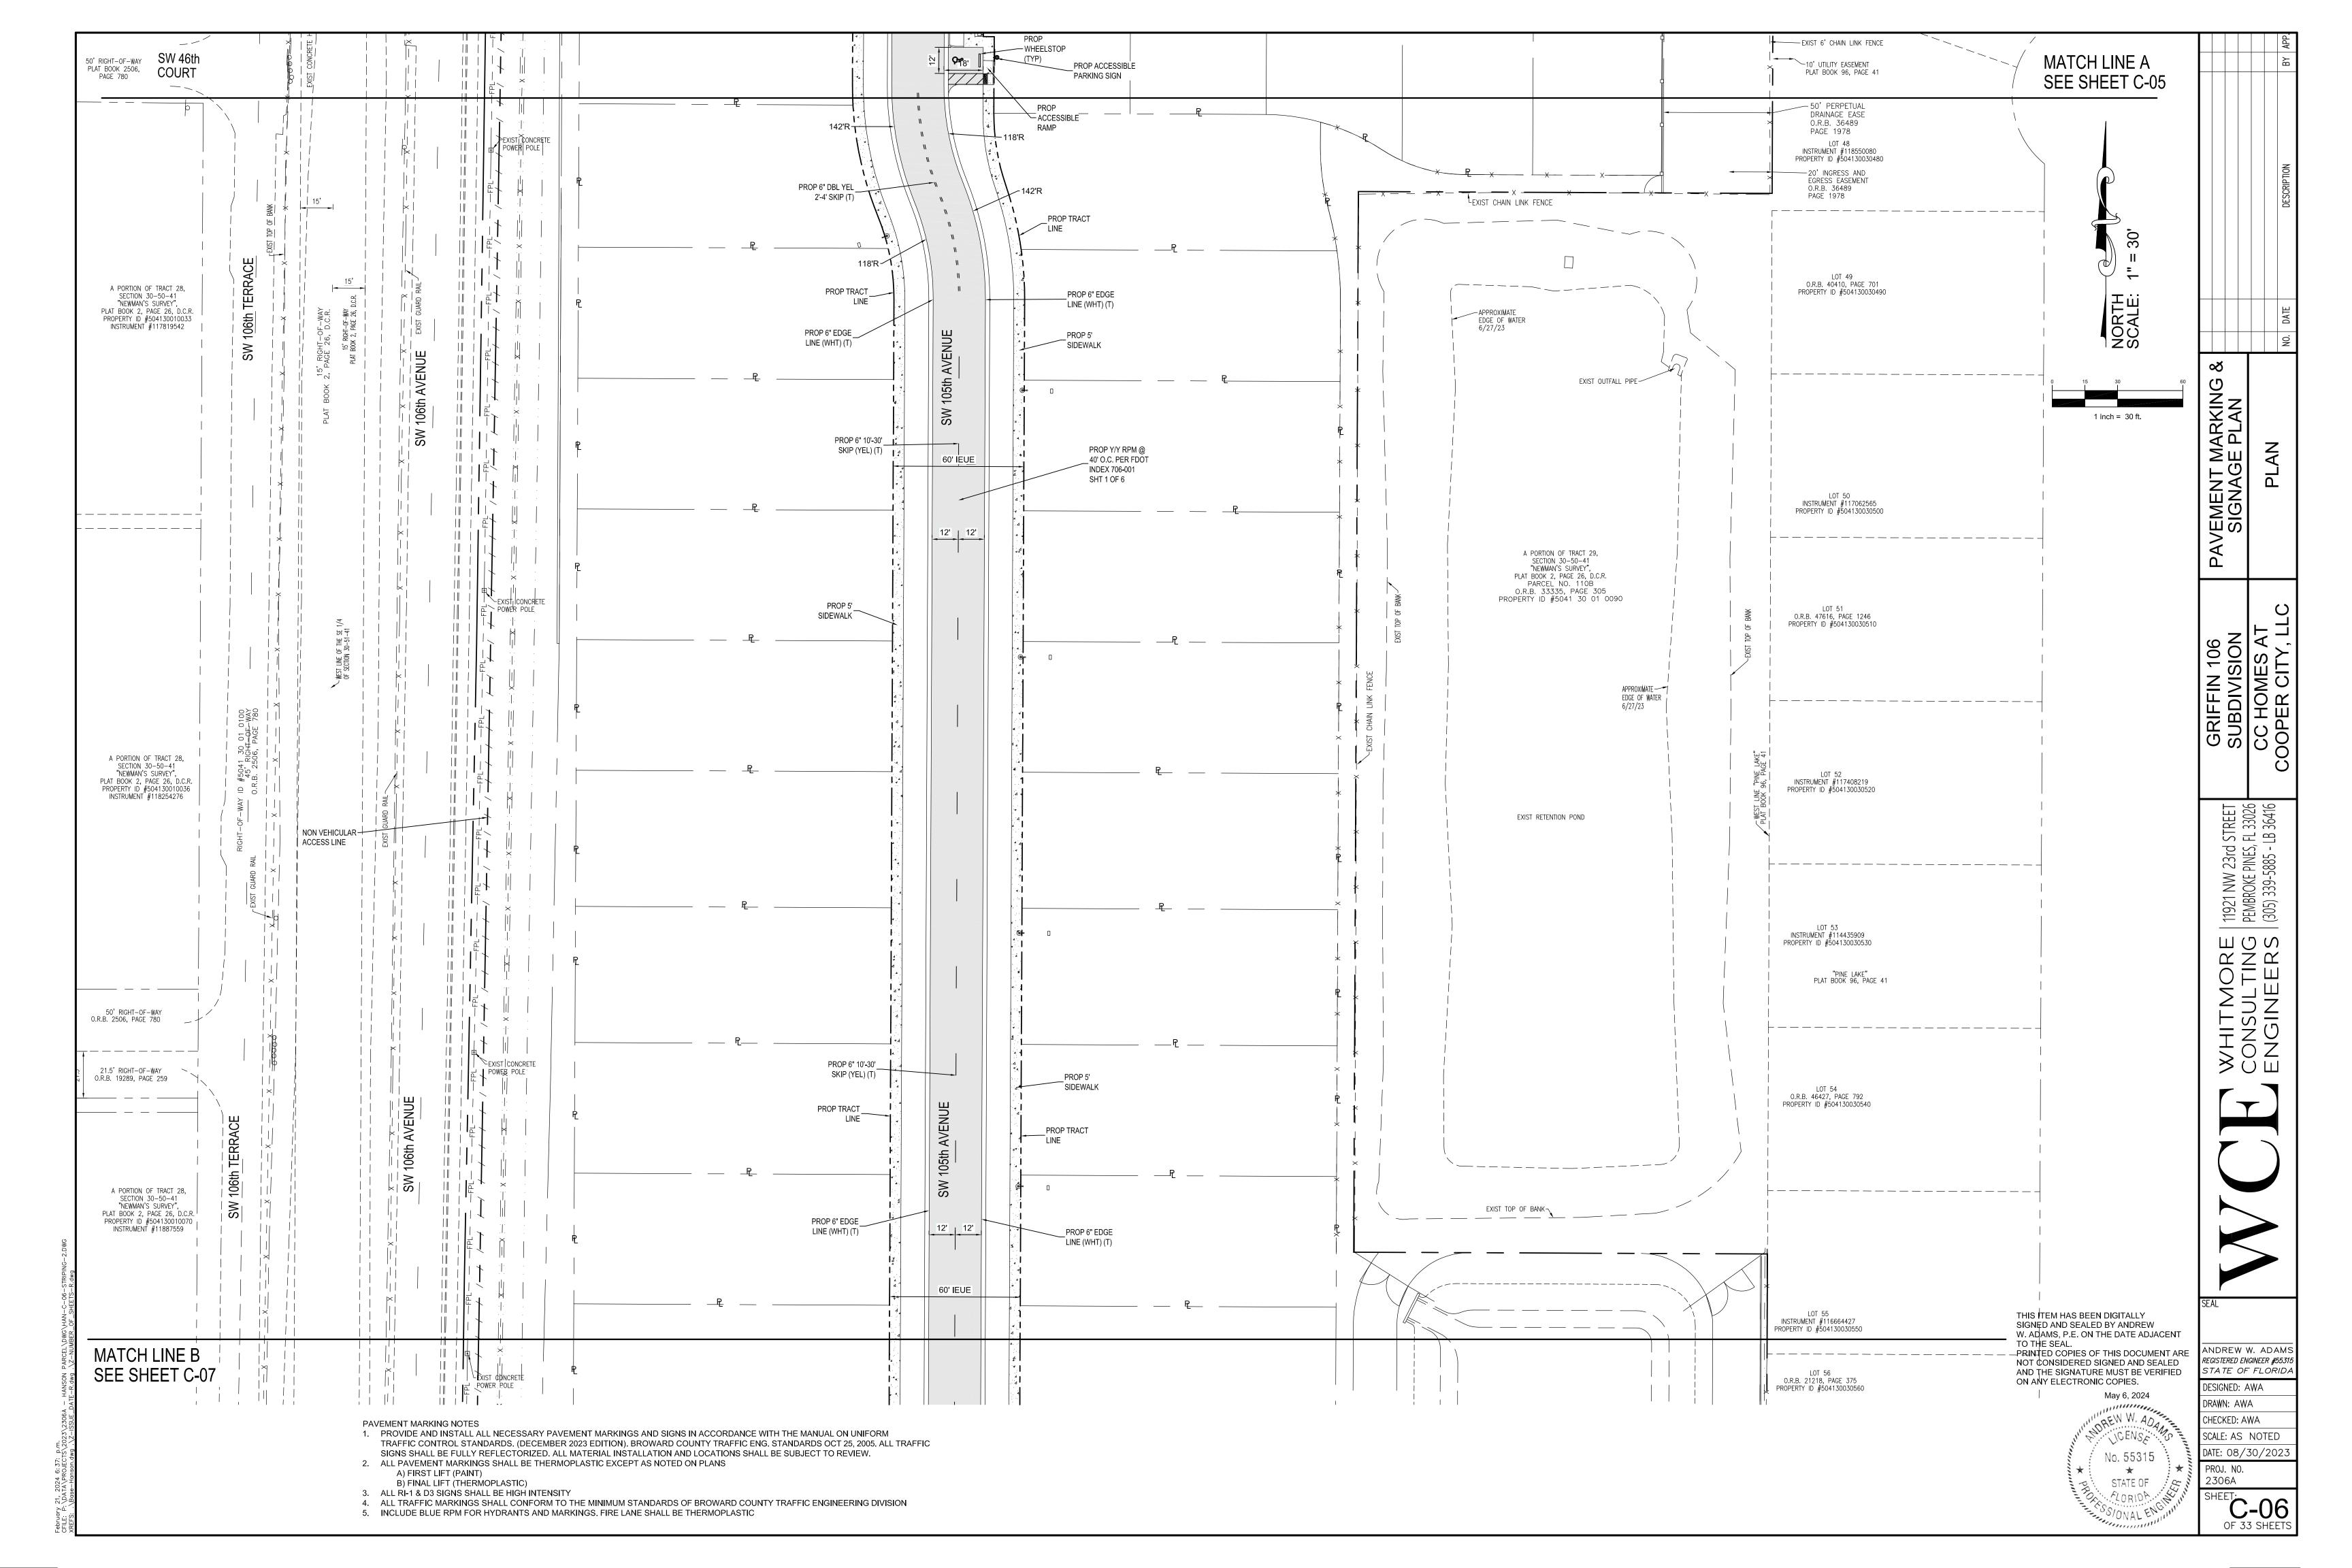

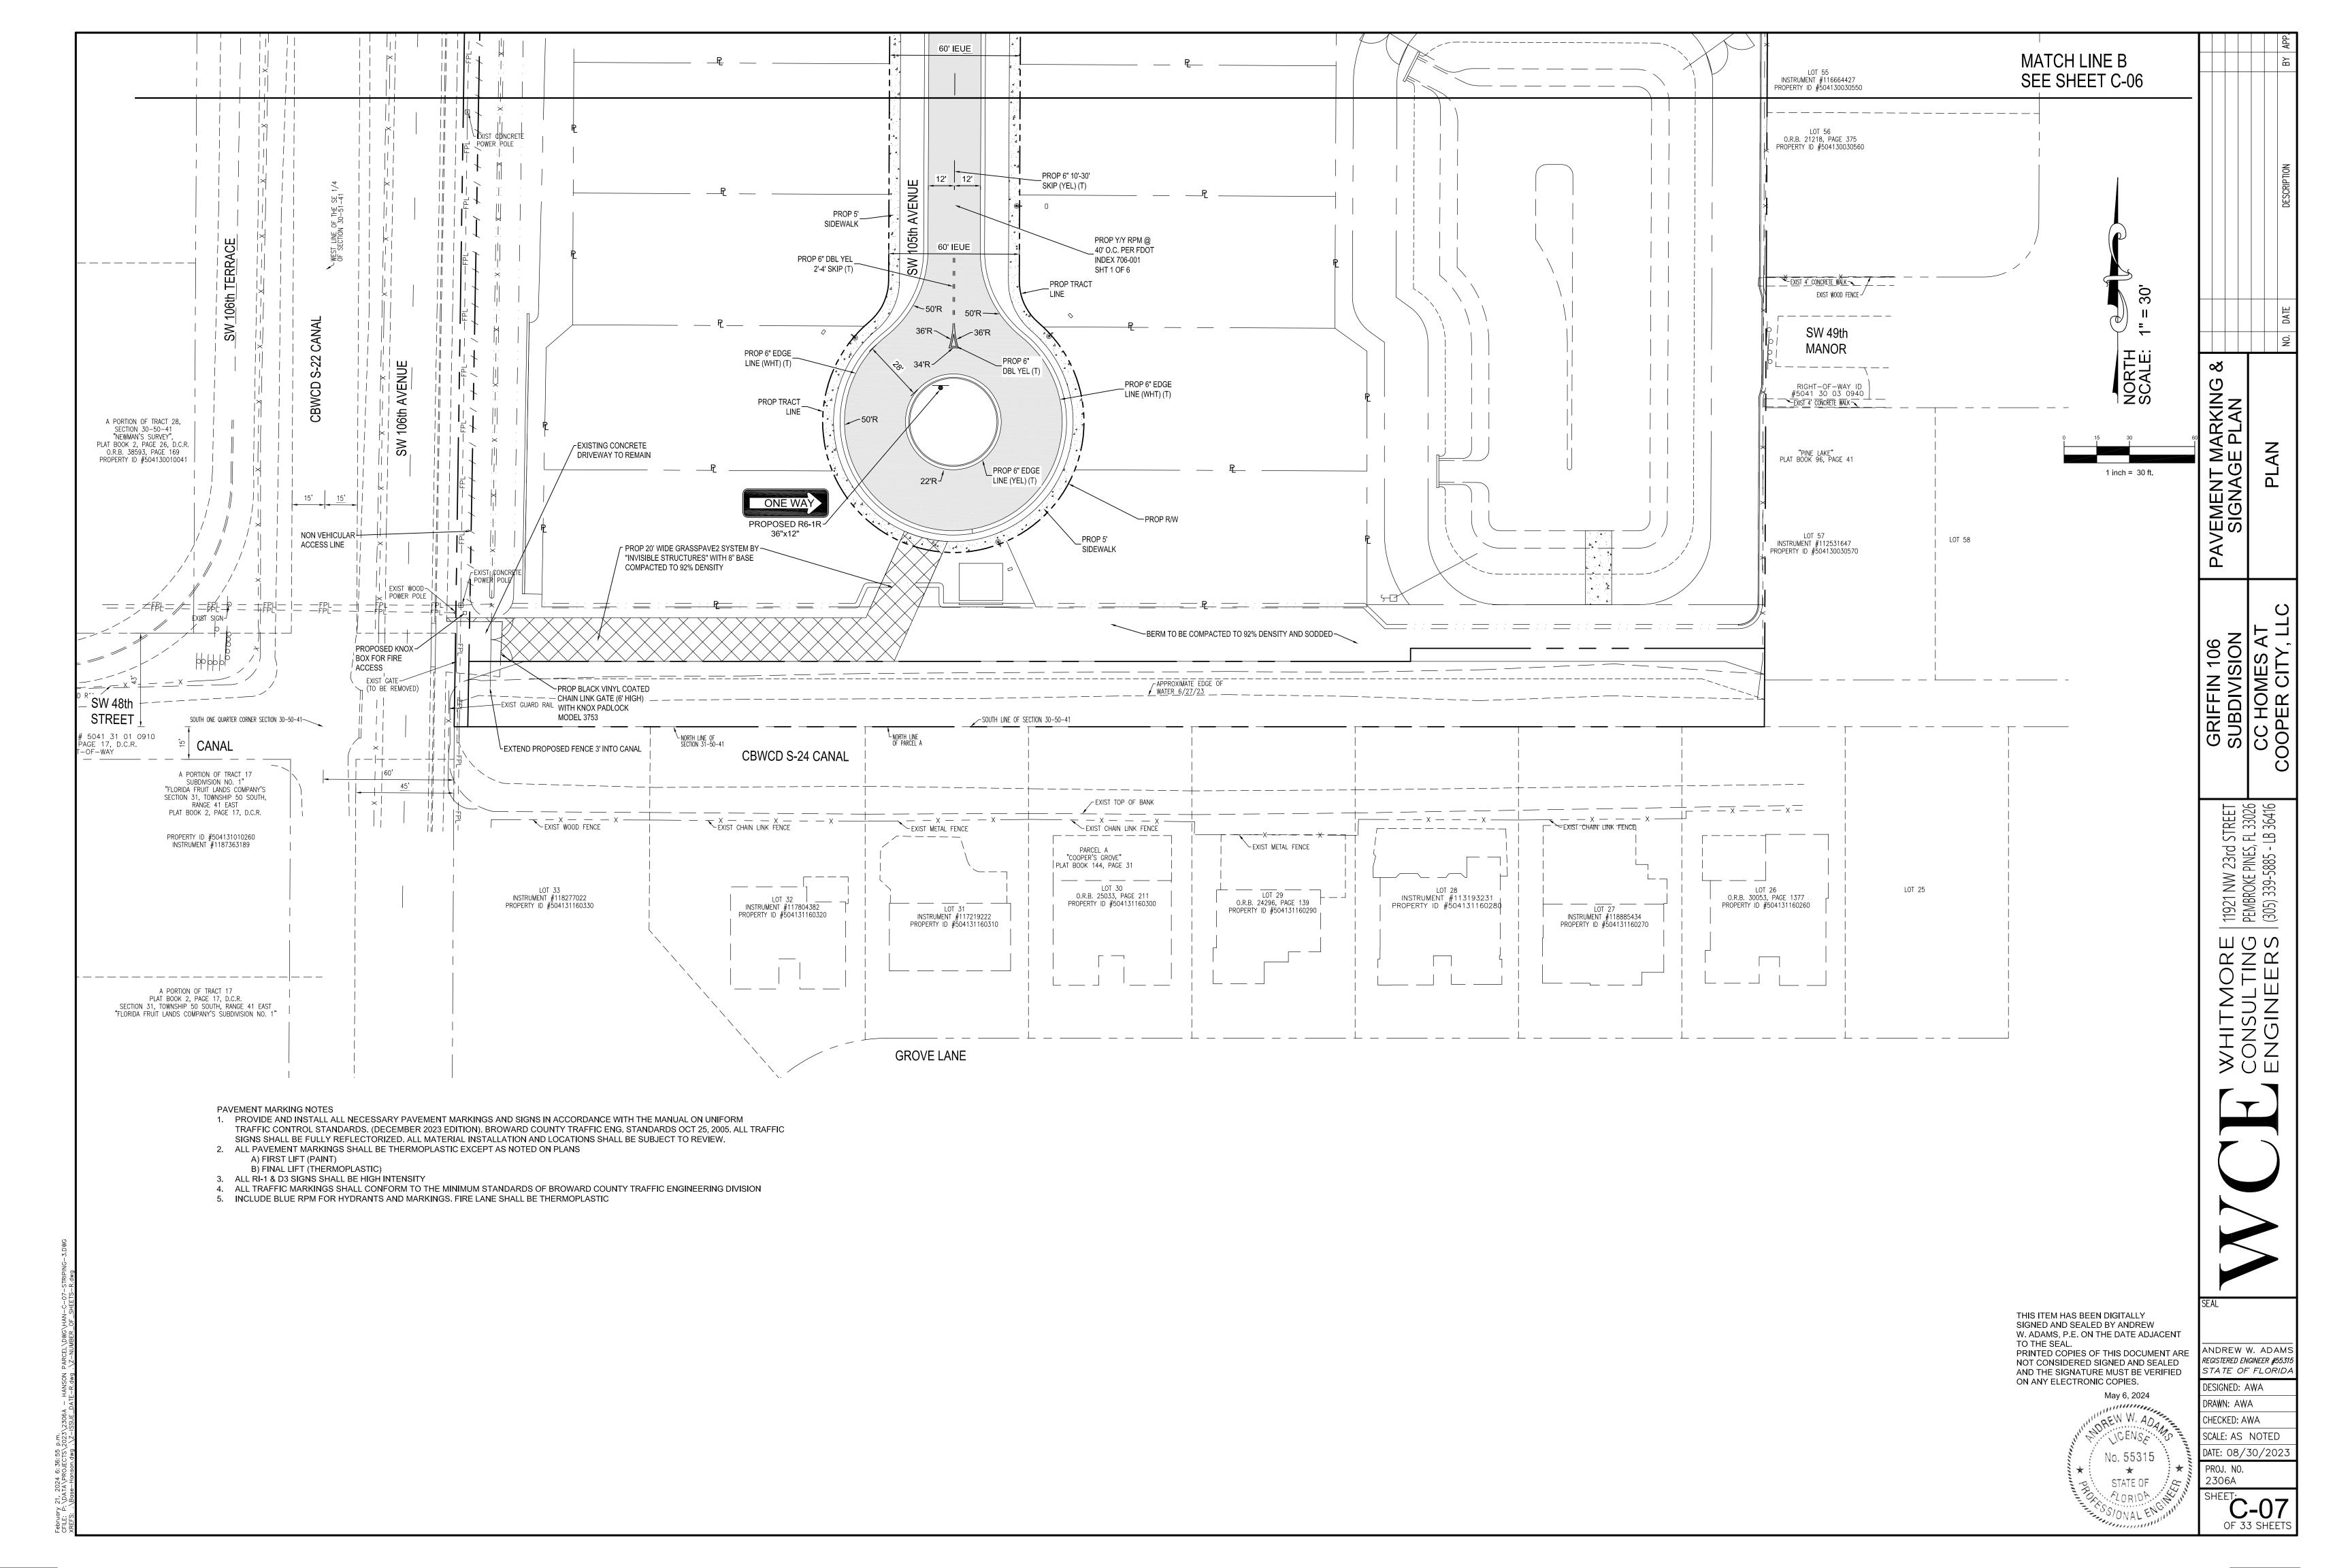

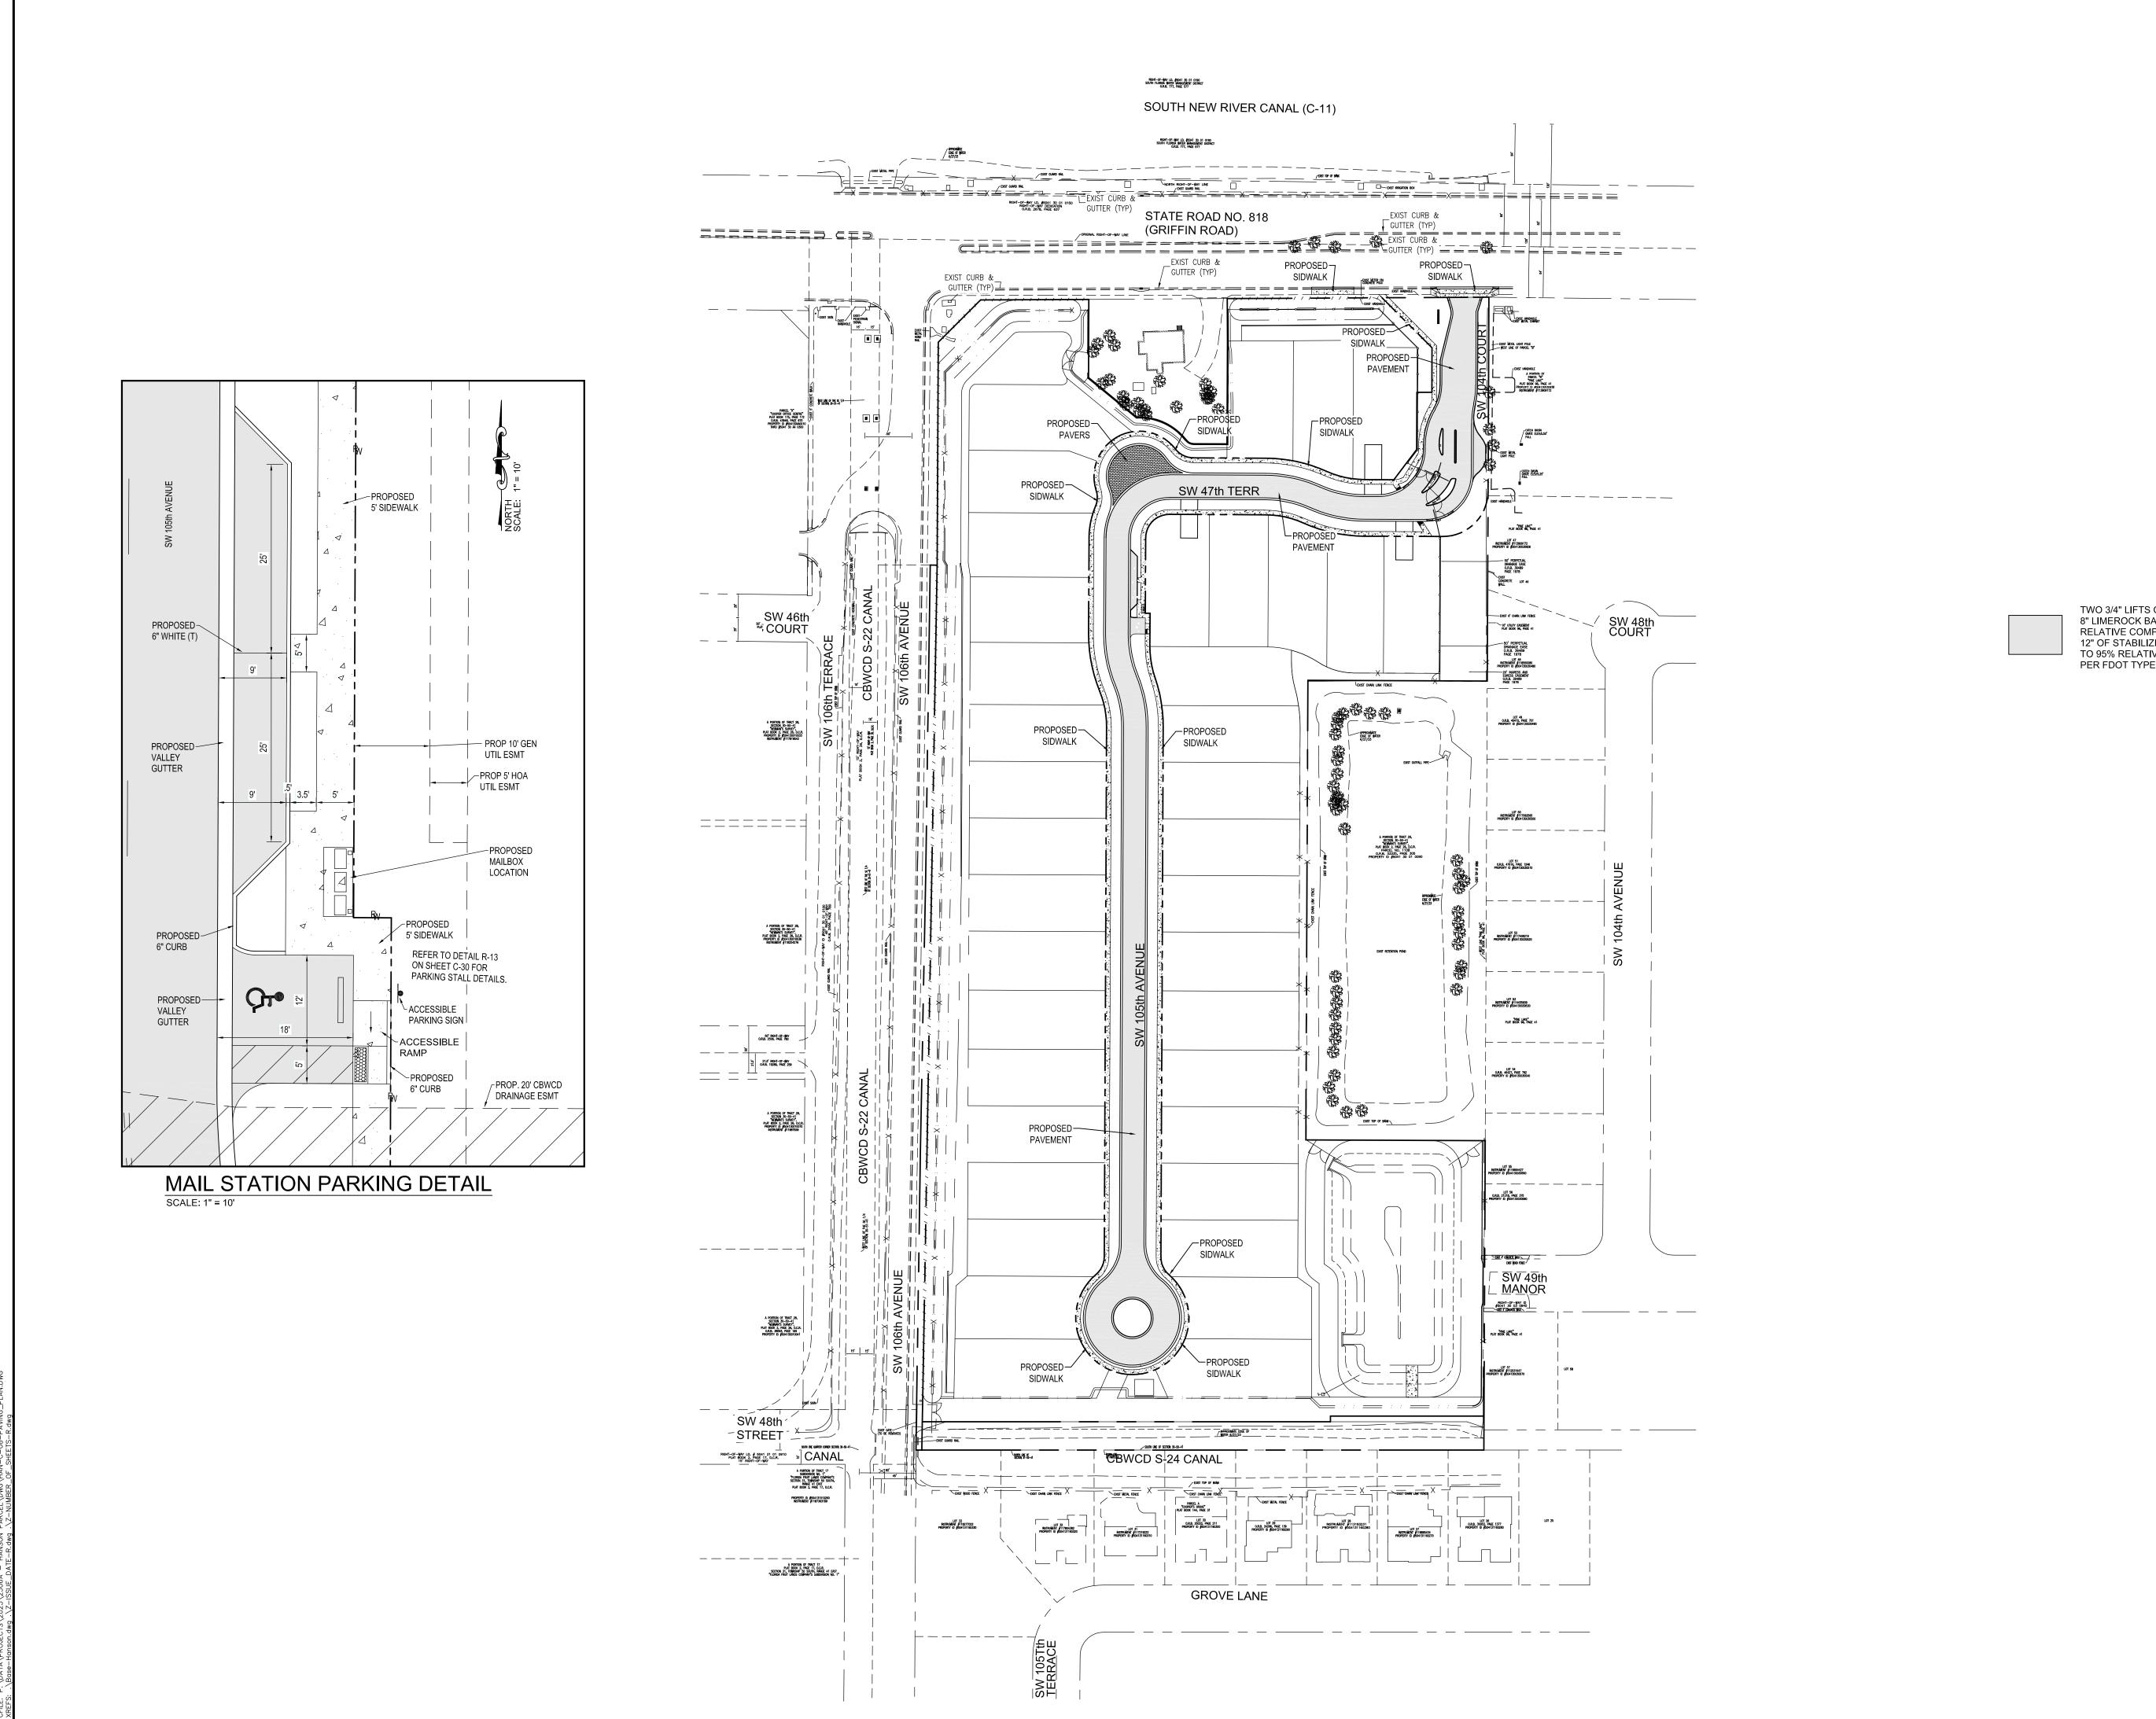

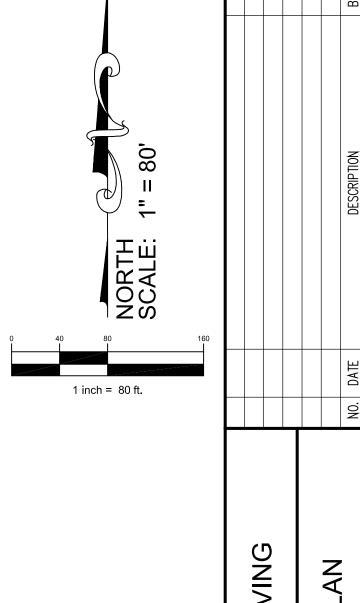

TWO 3/4" LIFTS OF TYPE S-III ASPHALT
8" LIMEROCK BASE COMPACTED TO 98%
RELATIVE COMPACTION WITH A LBR OF 100%
12" OF STABILIZED SUBGRADE COMPACTED
TO 95% RELATIVE COMPACTION WITH A LBR OF 40%
PER FDOT TYPE B OR TYPE C STABILIZED SUBGRADE

THIS ITEM HAS BEEN DIGITALLY SIGNED AND SEALED BY ANDREW

SIGNED AND SEALED BY ANDREW
W. ADAMS, P.E. ON THE DATE ADJACENT
TO THE SEAL.
PRINTED COPIES OF THIS DOCUMENT ARE
NOT CONSIDERED SIGNED AND SEALED
AND THE SIGNATURE MUST BE VERIFIED
ON ANY ELECTRONIC COPIES.

May 6, 2024

May 6, 2024

CENSE

No. 55315

STATE OF

ANDREW W. ADAMS
REGISTERED ENGINEER #55315
STATE OF FLORIDA

DESIGNED: AWA

DRAWN: AWA

CHECKED: AWA

SCALE: AS NOTED

DATE: 08/30/2023


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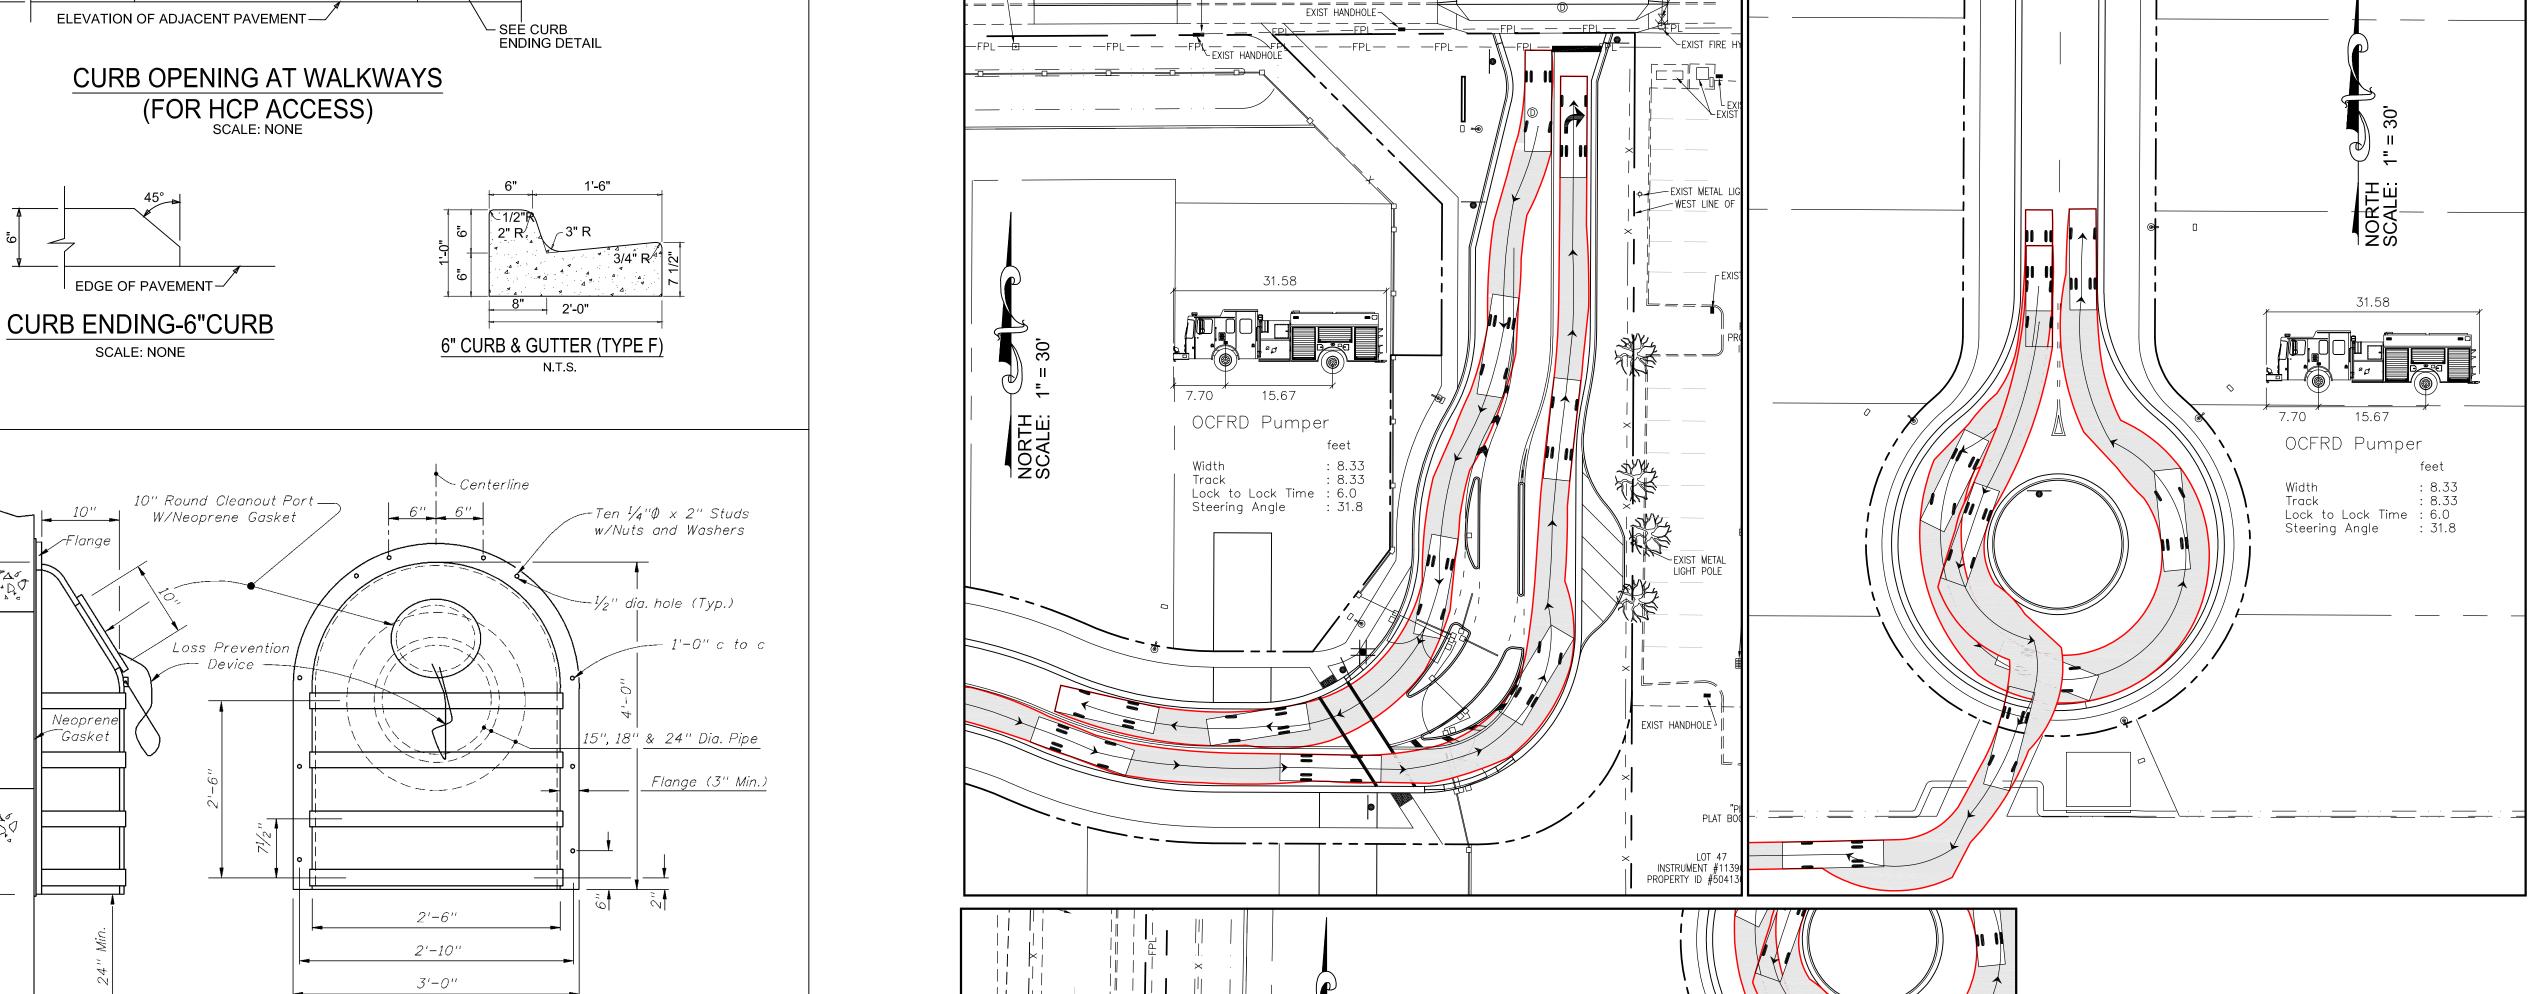
2306A

11921 NW 23rd STREET PEMBROKE PINES, FL 33026 (305) 339-5885 - LB 36416

ПOS

SHEET:
C-08
OF 33 SHEETS



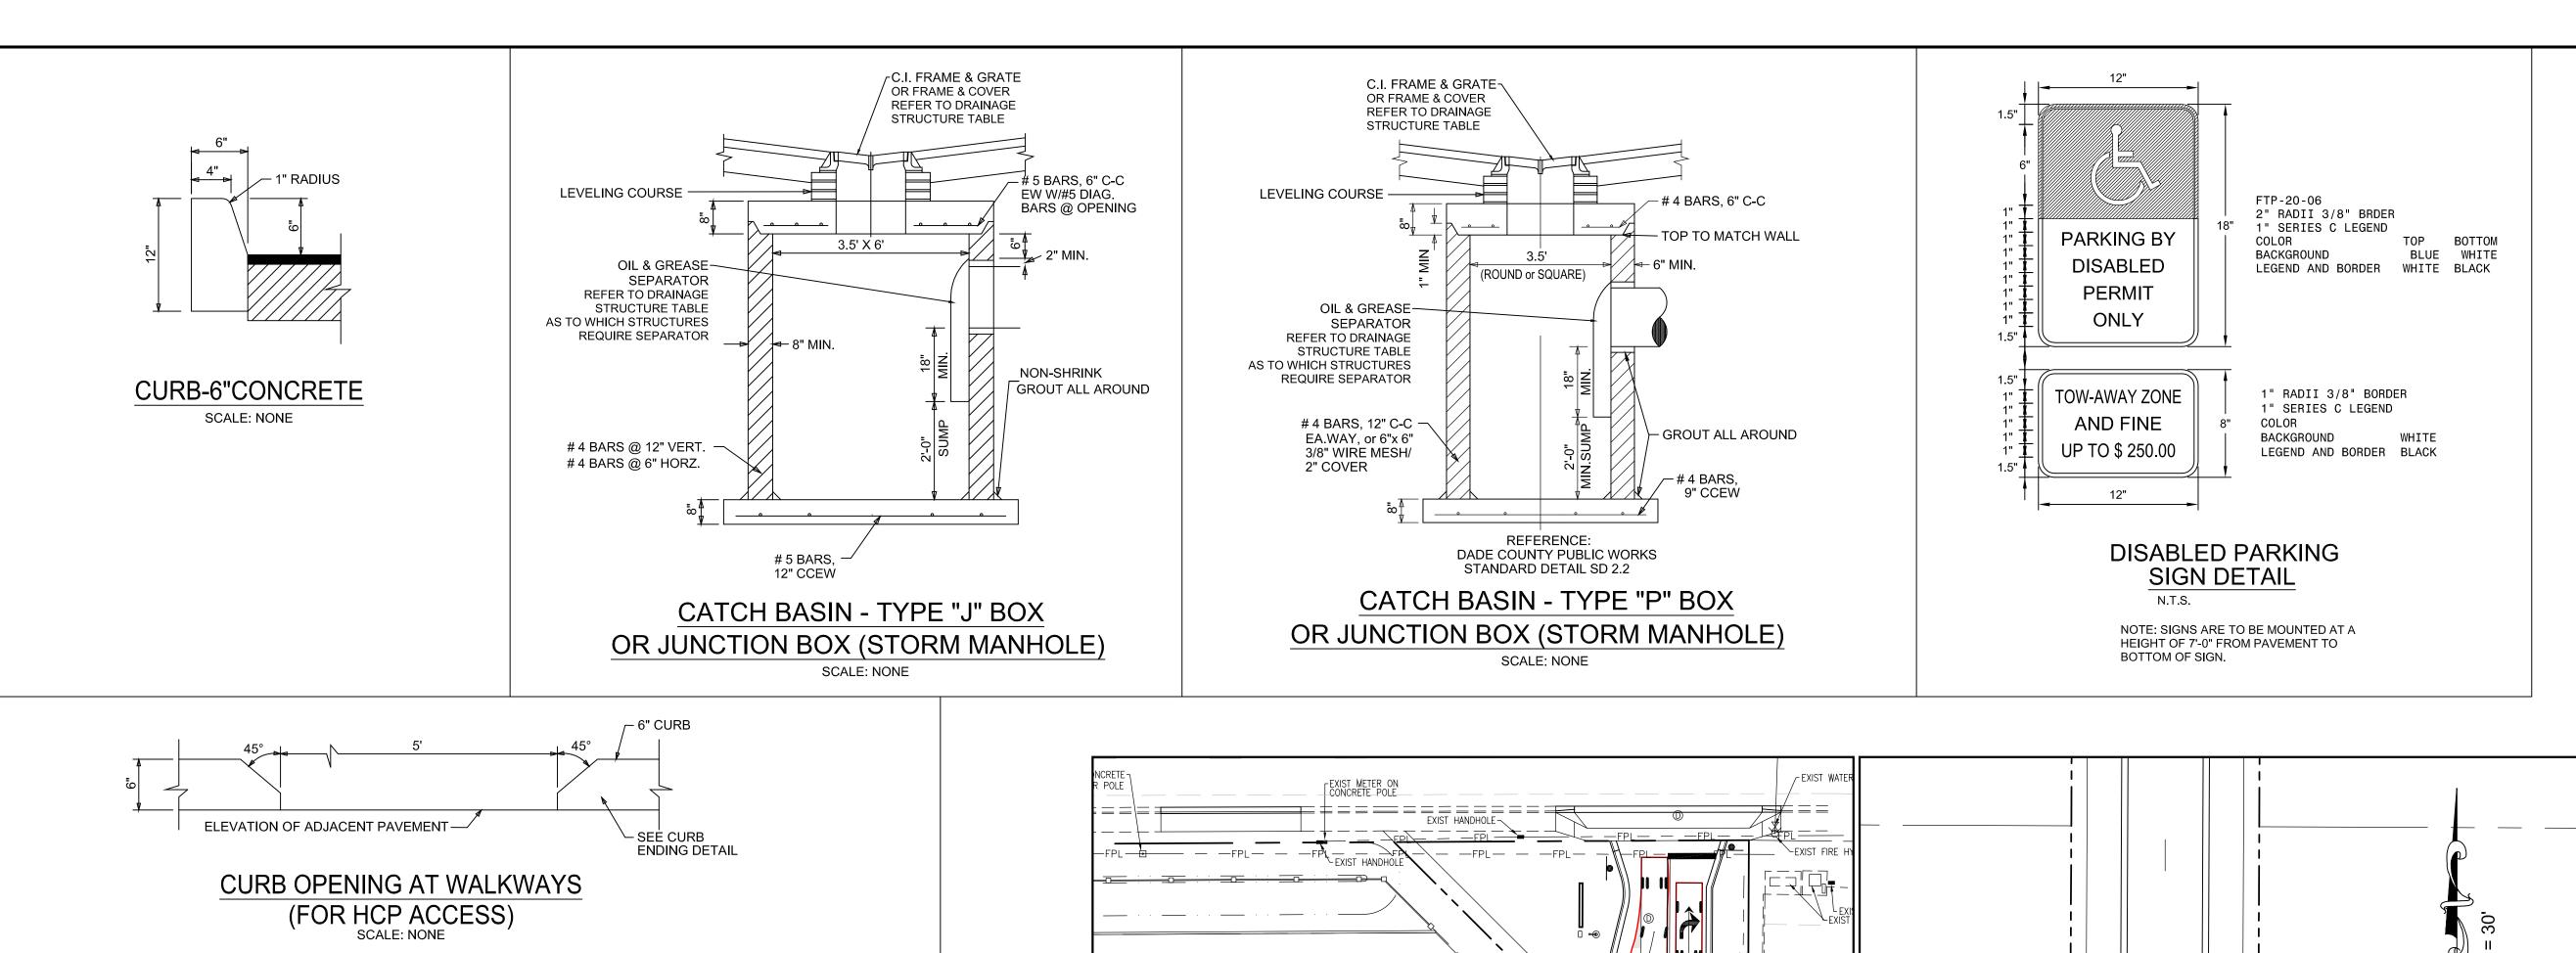

Dutlet . Pipe

SIDE ELEVATION

FRONT ELEVATION

gasketed, with either a threaded screw-in lid or


PER FDOT INDEX 241

**OIL & GREASE SEPARATOR** 

TYPE II SKIMMER

Note: The cleanout port for the Type II skimmer shall be

a lid secured by four stainless steel quick-release latches.

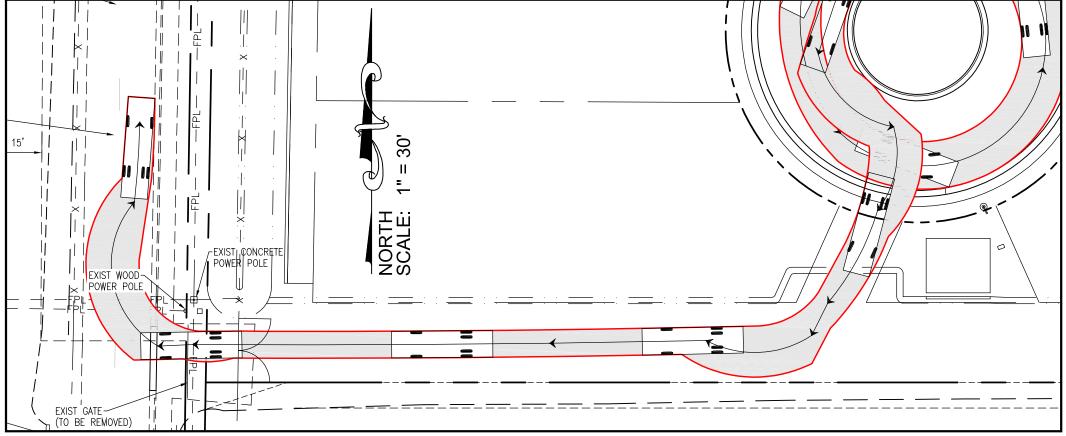

FIRE TRUCK AUTOTURN EXHIBIT

THIS ITEM HAS BEEN DIGITALLY
SIGNED AND SEALED BY ANDREW
W. ADAMS, P.E. ON THE DATE ADJACENT
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May 6, 2024

May 6, 2024

No. 55315

STATE OF

STATE OF

CORIDA

ANDREW W. ADAMS
REGISTERED ENGINEER #55316
STATE OF FLORIDA

DESIGNED: AWA

DRAWN: AWA

CHECKED: AWA

PAVING, GRADING DRAINAGE

DETAILS

STREET FL 33026 LB 36416

DRAWN: AWA
CHECKED: AWA
SCALE: AS NOTED
DATE: 08/30/2023
PROJ. NO.
2306A

C-09

MAINTENANCE FACILITY. D. FIELD OBSERVATION MILESTONES: SUBGRADE e. SITE GRADING SPECIFICATIONS. 2 HANDICAP RAMPS: SEE FDOT INDEX NO. 304

B. TRAFFIC GENERAL NOTES & CONDITIONS (THESE NOTES ARE REQUIRED BY THE MDPWD) 1. ENGINEER SHALL PREPARE SIGNING & PAVEMENT MARKING PLANS IN A SEPARATE SHEET (1" = 50' SCALE MINIMUM). 2. ENGINEER SHALL VISIT SITE & VERIFY FIELD CONDITIONS BEFORE PREPARING PROPOSED SIGNING & PAVEMENT MARKING PLANS. 3. CONTRACTOR SHALL BE RESPONSIBLE FOR THE REMOVAL OF ALL PAVEMENT MARKINGS AND SIGNS CONFLICTING WITH THE PROPOSED ROADWAY CONSTRUCTION. 4. CONTRACTOR SHALL BE RESPONSIBLE FOR THE INSTALLATION OF ALL PAVEMENT MARKINGS AND SIGNS AS SHOWN IN THE PLANS AND APPLICABLE TRAFFIC DESIGN 5. CONTRACTOR SHALL BE RESPONSIBLE FOR MATCHING EXISTING PAVEMENT MARKINGS AT THE BEGINNING AND AT THE END OF THE PROJECT, AND AT ALL INTERSECTING SIDE 6. CONTRACTOR SHALL BE RESPONSIBLE FOR THE INSTALLATION OF REFLECTIVE PAVEMENT MARKERS ALONG THE ENTIRE LENGTH OF THE PROJECT. 7. ANY SIGNING MATERIAL, INCLUDING SUPPORTS TO BE REMOVED, SHALL BE DELIVERED BY THE CONTRACTOR TO BROWARD COUNTY TRAFFIC SIGNALS AND SIGNS 8. SIGN ASSEMBLY LOCATIONS SHOWN IN THE PLANS WHICH ARE IN CONFLICT WITH THE STREET LIGHTING UTILITIES, DRIVEWAYS, PEDESTRIAN RAMPS, ETC., MAY BE ADJUSTED AS DIRECTED BY THE ENGINEER OR ENGINEER'S FIELD REPRESENTATIVE 9. CONTRACTOR SHALL BE RESPONSIBLE FOR PROVIDING PED RAMPS/X-WALK WHERE SIDEWALK IS EXISTING OR PROPOSED (ADA-PWM). C. SIGNAGE/PAVEMENT MARKINGS/MAINTENANCE OF TRAFFIC: THE CONTRACTOR SHALL CONTACT THE COOPER CITY PUBLIC WORKS DEPARTMENT TO OBTAIN A GENERAL PLAN FOR MAINTENANCE OF TRAFFIC. THE CONTRACTOR SHALL BE RESPONSIBLE FOR MAINTAINING THE SPECIFIED TRAFFIC PLANS. 2. COORDINATE MAINTENANCE OF TRAFFIC WITH AFFECTED PARTIES. 3. DO NOT CLOSE OR OBSTRUCT ROADS, STREETS, WALKS, OR OTHER ADJACENT OCCUPIED OR USED FACILITIES WITHOUT PERMISSION FROM OWNERS AND AUTHORITIES HAVING JURISDICTION. PROVIDE ALTERNATE ROUTES AROUND CLOSED OR OBSTRUCTED 4. ALL EXISTING PAVEMENT MARKINGS THAT IN CONFLICT WITH THE PROPOSED MARKINGS SHALL BE REMOVED. 5. PAVEMENT MARKINGS WITHIN EXISTING OR PROPOSED PUBLIC RIGHTS-OF-WAY: a. ALL PAVEMENT MARKINGS SHALL BE THERMOPLASTIC. FOLLOW FDOT SPECIFICATIONS SECTION 711--THERMOPLASTIC TRAFFIC STRIPES AND MARKINGS 6. PAVEMENT MARKINGS WITHIN PRIVATE PROPERTY SHALL BE THE FOLLOWING: a. PARKING STALL STRIPES. STOP BARS AND DOUBLE YELLOW STRIPES: (1) FOLLOW FDOT SPECIFICATIONS SECTION 710-- PAINTING TRAFFIC STRIPES. (2) PARKING STALL STRIPES ARE TO BE 4", SOLID WHITE a. MATERIALS: FOLLOW FDOT SPECIFICATION SECTION 700-HIGHWAY SIGNING; AND MANUAL ON UNIFORM TRAFFIC CONTROL DEVICES, U.S. DEPARTMENT OF TRANSPORTATION (M.U.T.C.D.) LATEST EDITION. b. PLACEMENT: IN ACCORDANCE WITH THE M.U.T.C.D., PART II, SIGNS, IN LOCATIONS SHOWN ON THE PLANS. c. FIBERGLASS BLANKS FOR TRAFFIC SIGNS ARE ALLOWED IN LIEU OF ALUMINUM. 1. FIELD OBSERVATION SCHEDULE a. EACH FIELD OBSERVATION MUST BE COMPLETED BY ENGINEER'S FIELD REPRESENTATIVE PRIOR TO CONTRACTOR'S PROCEEDING TO NEXT STEP. b. DRAINAGE OBSERVATION FOR EACH STRUCTURE AND TRENCH. d. BASE ROCK: BEFORE PRIMING; AND BEFORE PLACING ASPHALTIC CONCRETE. E. REFERENCE SPECIFICATIONS: THE FOLLOWING COOPER CITY PUBLIC WORKS DEPARTMENT STANDARDS ARE HEREBY INCORPORATED BY REFERENCE. THESE STANDARDS ARE TAKEN FROM THE PUBLIC WORKS MANUAL. 1. PAVEMENT AND SUBGRADE- FOLLOW COOPER CITY'S PUBLIC WORKS DEPARTMENT

III. STORM WATER POLLUTION PREVENTION PLAN (SWPPP) NOTES: A. GENERAL NOTES ALL EROSION CONTROLS MUST BE IMPLEMENTED PRIOR TO COMMENCEMENT OF CONSTRUCTION ACTIVITIES. 2. ALL ENVIRONMENTAL CONTROL FEATURES ARE TO BE MAINTAINED THROUGHOUT THE LIFE OF THE PROJECT IN ACCORDANCE WITH FDEP NPDES REQUIREMENTS. 3. ALL EROSION AND MATERIAL DEPOSITS MUST BE CONTAINED WITHIN THE 4. ANY DAMAGED OR INEFFECTIVE GEOHAY (OR EQUIVALENT) ARE TO BE REPLACED WITH NEW ONES. THE LOCATION OF GEOHAY INSTALLATION IS AS MENTIONED IN EROSION CONTROL PLANS. THE PROJECT ENGINEER MAY SPECIFY OTHER AREAS AS NECESSARY. 5. INLETS SHALL BE PROTECTED FROM SEDIMENT INTAKE UNTIL PROJECT IS COMPLETE. ELEVATION OF GROUND OUTSIDE INLET TOP SHALL NOT BE HIGHER THAN INLET TOP. 6. COMPLETED INLETS SHALL BE PROTECTED TO PREVENT SEDIMENT INTAKE FROM OTHER AREAS UNTIL THE PROJECT IS COMPLETE. 7. ALL FILL EMBANKMENT AND GRADED AREAS SHALL BE PROTECTED AGAINST 8. ANY OFFSITE SEDIMENT DISCHARGE TO A MUNICIPALLY SEPARATE STORM SEWER SYSTEM ARISING FROM THE CONTRACTOR'S ACTIVITIES SHALL HAVE EROSION CONTROLS PROVIDED FOR THOSE INLETS. 9. THE AGGREGATE LAYER OF ALL CONSTRUCTION ENTRANCE GRAVEL BEDS MUST BE AT LEAST 3"-6" THICK WITH FILTER FABRIC UNDERNEATH. IT MUST EXTEND THE FULL WIDTH OF THE VEHICULAR INGRESS AND EGRESS AREA. THE LENGTH OF THE ENTRANCE MUST BE AT LEAST 50 FEET. THE ENTRANCE MUST WIDEN AT ITS CONNECTION TO THE ROADWAY IN ORDER TO ACCOMMODATE THE TURNING RADIUS OF LARGE TRUCKS. 10. CONTRACTOR SHALL COMPLY WITH ALL TERMS AND CONDITIONS OF THE U.S. ENVIRONMENTAL PROTECTION AGENCY (EPA) NATIONAL POLLUTANT SEDIMENT AND EROSION CONTROLS AND STORM WATER MANAGEMENT DISCHARGE ELIMINATION SYSTEM (NPDES) PERMIT. IN PARTICULAR, MEASURES SHALL BE STRICTLY FOLLOWED 11. THE CONTRACTOR SHALL BE RESPONSIBLE FOR THE INSTALLATION AND MAINTENANCE OF ALL EROSION, SEDIMENTATION AND STORM WATER MANAGEMENT MEASURES FOR THE DURATION OF THE PROJECT. ONCE THE PROJECT HAS BEEN COMPLETED, THE CONTRACTOR SHALL REMOVE ALL TEMPORARY STORM WATER MANAGEMENT MEASURES AND SHALL DISPOSE OF THEM ACCORDING TO THE CODE. 12. THE CONTRACTOR SHALL TAKE DATE STAMPED PICTURES OF THE EROSION CONTROL MEASURES ON A BI-WEEKLY BASIS THROUGH-OUT THE DURATION OF THE PROJECT. THESE PICTURES ARE REQUIREMENTS OF THE LEED RATING SYSTEM. THE PICTURES ARE TO BE PROVIDED TO THE ENGINEER AT THE END OF THE PROJECT. B. SITE DESCRIPTION 1 CONSTRUCTION ACTIVITY: DRAINAGE AND UTILITY INSTALLATION, BUILDING AND PARKING LOT CONSTRUCTION, LAND DEVELOPMENT. PROJECT LIMITS: REFER TO PROJECT LOCATION SKETCH FOR LIMITS. 3 PROJECT DESCRIPTION: CONSTRUCTION OF A BUILDING AND ITS RELATED SITE WORK. THE DRAINAGE SYSTEM WILL CONSIST OF SOLID PIPES TO COLLECT THE RUNOFF FROM THE ROOF AREAS OF THE PROPOSED BUILDING AND PARKING LOT RUNOFF. 4. MAJOR SOIL DISTURBING ACTIVITIES: CLEARING AND GRUBBING, EXCAVATION FOR STORM WATER FACILITIES AND OTHER UTILITIES, PLACEMENT OF FILL FOUNDATIONS AND SITE GRADING. 5. LOCATION OF OUTFALLS: NOT APPLICABLE 6. NAME OF RECEIVING WATER: NOT APPLICABLE. C. EROSION AND SEDIMENTATION CONTROLS 1. CONTRACTOR SHALL INSTALL SILT FENCE AROUND THE LIMITS OF CONSTRUCTION PRIOR TO ANY DEMOLITION, FILLING OR GRADING OF ANY PORTIONS OF THE 2. PROPOSED INLETS, ONCE INSTALLED, SHALL BE PROTECTED WITH GEO-TEXTILE (FILTER) FABRIC. 3. A GRAVEL ACCESS BED SHALL BE CONSTRUCTED TO MINIMIZE THE EFFECTS OF TRUCK TRAFFIC AND SEDIMENTATION TRACKING BOTH ON AND OFF OF THE SITE. 4. TOP OF SOIL PILES AND DISTURBED PORTIONS OF THE SITE WHERE CONSTRUCTION ACTIVITY TEMPORARILY CEASES FOR AT LEAST 21 DAYS SHALL BE STABILIZED WITH THE APPROPRIATE EROSION CONTROL MEASURE.

D. OTHER CONTROLS 1. ALL CONSTRUCTION WASTE MATERIAL SHALL BE COLLECTED AND STORED IN A SECURED METAL DUMPSTER RENTED FROM A LOCAL WASTE MANAGEMENT COMPANY. THE DUMPSTER WILL MEET ALL LOCAL AND STATE SOLID WASTE MANAGEMENT REGULATIONS. ALL PERSONNEL SHALL BE INSTRUCTED REGARDING THE CORRECT PROCEDURES FOR WASTE DISPOSAL. NOTICES STATING THESE PRACTICES SHALL BE POSTED IN THE OFFICE TRAILER AND THE CONTRACTOR SHALL BE RESPONSIBLE FOR SEEING THAT THESE PROCEDURES ARE FOLLOWED. 2. ALL SANITARY WASTE SHALL BE COLLECTED FROM THE PORTABLE UNITS A MINIMUM OF ONCE PER WEEK BY A LICENSED SANITARY WASTE 3. ALL HAZARDOUS WASTE MATERIALS SHALL BE DISPOSED OF AS PER LOCAL AND/OR STATE REGULATIONS OR AS RECOMMENDED BY THE MANUFACTURER. SITE PERSONNEL SHALL BE INSTRUCTED IN THESE PRACTICES AND THE CONTRACTOR SHALL BE RESPONSIBLE FOR SEEING THAT THESE PROCEDURES ARE FOLLOWED. 4. A STABILIZED CONSTRUCTION ENTRANCE (GRAVEL ACCESS BED) HAS BEEN PROVIDED TO HELP REDUCE VEHICLE TRACKING OF SEDIMENTS. THE PAVED STREETS ADJACENT TO THE SITE ENTRANCE SHALL BE HAND SWEPT AS NEEDED TO REMOVE ANY EXCESS OF MUD, DIRT, OR ROCK TRACKED FROM THE SITE. E. MAINTENANCE AND INSPECTION PROCEDURES 1. THE GENERAL CONTRACTOR'S SITE SUPERINTENDENT SHALL SELECT AT LEAST ONE INDIVIDUAL WHO WILL BE RESPONSIBLE FOR INSPECTIONS MAINTENANCE AND REPAIR ACTIVITIES, AND FILLING OUT THE INSPECTION MAINTENANCE REPORT. PERSONNEL SELECTED FOR INSPECTION AND MAINTENANCE RESPONSIBILITIES SHALL RECEIVE PROPER TRAINING IN ALL THE INSPECTION AND MAINTENANCE PRACTICES NECESSARY FOR KEEPING EROSION AND SEDIMENT CONTROLS USED ONSITE IN GOOD WORKING ORDER. 2. CONSTRUCTION ENTRANCE GRAVEL BED: WHEN BEDS BECOME LOADED WITH SEDIMENTS, REMOVE BEDS TO DISPLACE SEDIMENT LOAD AND RE-ESTABLISH EFFECTIVENESS OF THE GRAVEL BEDS 3. BUILT UP SEDIMENT WILL BE REMOVED FROM THE SILT FENCE WHEN IT HAS REACHED ONE THIRD OF THE HEIGHT OF THE FENCE. 4. CONTRACTOR SHALL INSPECT THE SILT FENCE FOR DEPTH OF SEDIMENT, TEARS, IF FABRIC IS SECURELY ATTACHED TO THE FENCE POSTS, AND IF FENCE POSTS ARE FIRMLY IN THE GROUND. 5. TEMPORARY AND PERMANENT SEEDING AND PLANTING SHALL BE OBSERVED FOR BARE SPOTS, WASHOUTS, AND HEALTHY GROWTH INSPECTION OF EROSION AND SEDIMENTATION CONTROLS BY THE CONTRACTOR'S REPRESENTATIVE SHALL BE PERFORMED EVERY SEVEN CALENDAR DAYS AND WITHIN 24 HOURS OF THE END OF A STORM THAT IS 0.50 INCHES OR GREATER. AN INSPECTION REPORT DESIGNATED FOR THIS PURPOSE SUMMARIZING THE SCOPE OF THE INSPECTION SHALL BE MADE AND RETAINED, AND SHALL IDENTIFY ANY DAMAGE. THE CONTRACTOR SHALL CORRECT DAMAGE OR PROVIDE MAINTENANCE AS RECOMMENDED BY THE REPORT AS SOON AS PRACTICAL BUT IN NO CASE LATER THAN SEVEN CALENDAR DAYS FOLLOWING THE INSPECTION. ALL CONTROLS MUST BE IN GOOD OPERATING CONDITION UNTIL THE AREA THEY PROTECT HAS BEEN COMPLETELY STABILIZED AND THE CONSTRUCTION IS COMPLETED. F. SEQUENCE OF MAJOR ACTIVITIES 1. INSTALL BERM AT BOUNDARIES OF PROPOSED CONSTRUCTION. 2. CONSTRUCT GRAVEL ACCESS AREA. COMMENCE SITE CONSTRUCTION ACTIVITIES. 4. TEMPORARILY STABILIZE ALL AREAS WITH APPROPRIATE EROSION CONTROL 5. INSTALL PERMANENT SEEDING AND PLANTING IN AREAS WHERE CONSTRUCTION ACTIVITIES HAVE PERMANENTLY CEASED NO LATER THAN 15 DAYS AFTER THE LAST CONSTRUCTION ACTIVITIES. 6. REMOVE ACCUMULATED SEDIMENT. 7. REMOVE TEMPORARY POLLUTION PREVENTION MEASURES AFTER ALL CONSTRUCTION ON SITE HAS BEEN COMPLETED AND DISPOSE OF ACCORDING TO CODE. STATEMENT OF DESIGN INTENT IT IS THE INTENT OF THESE PLANS NOT ONLY TO PROVIDE FOR STORM WATER DISPOSAL, BUT ALSO FOR PROTECTION OF FRESH WATER RESOURCES THROUGH BEST MANAGEMENT PRACTICES (BMP). AMONG THESE PRACTICES ARE PRETREATMENT OF STORM WATER VIA GRASSED SWALES, AND RETENTION OF STORM WATER IN PERVIOUS AREAS. WATER IS DESIGNED TO POND, DURING HEAVY RAINSTORMS, BETWEEN DRIVEWAYS IN ROADWAY SWALES AND IN REAR YARD AREAS. PONDED WATER DISSIPATES AFTER RAINSTORMS BY INFILTRATION THROUGH THE PERVIOUS GROUND SURFACES. BUILDING FINISH FLOOR ELEVATIONS AND SITE GRADES ARE ESTABLISHED TO PROTECT PROPERTY FROM DAMAGE DUE TO EXCESSIVE FLOODING OR PONDING, BUT NOT TO ELIMINATE THE INCONVENIENCE OF PONDED WATER DURING AND AFTER HEAVY RAINSTORMS. BROWARD COUNTY NOTES THE FOLLOWING ITEMS ARE NOT REVIEWED OR ACCEPTED BY BROWARD COUNTY: 1. BROWARD COUNTY TRAFFIC ENGINEERING DIVISION'S REVIEW DOES NOT INCLUDE A REVIEW AND ACCEPTANCE OF THE PROJECT'S DESIGN OR OPERATION. THESE ITEMS ARE TO BE REVIEWED AND APPROVED BY THE CITY ENGINEER. 2. BROWARD COUNTY TRAFFIC ENGINEERING DIVISION DOES NOT REVIEW AND APPROVE. OR INSPECT AND ACCEPT THE FOLLOWING ITEMS FOR MAINTENANCE: PAVEMENT MARKINGS ON OR ADJACENT TO PAVER BRICKS, PAINTED ASPHALT, STAMPED ASPHALT OR PAVEMENT MARKINGS MADE OF PAVER BRICKS, RAISED INTERSECTIONS AND RELATED MARKINGS AND SIGNING, UN-WARRANTED MID-BLOCK CROSSWALKS AND RELATED MARKINGS AND SIGNING, UN-WARRANTED CROSSWALKS AND RELATED MARKINGS AND SIGNING, PAINTED/DECORATIVE CROSSWALKS, RAISED CROSSWALKS AND RELATED MARKINGS AND SIGNING, ADVANCED WARNING PAVEMENT MARKINGS FOR SPEED TABLES. BLINKER SIGNS. RECTANGULAR RAPID FLASHER BEACONS AND RELATED MARKINGS AND SIGNING, ONSTREET PARKING AND RELATED MARKINGS AND SIGNING, IN-ROAD LIGHTING AND RELATED MARKINGS AND SIGNING, GREEN BIKE LANES, FLEXIBLE DELINEATORS, DECORATIVE SIGNS AND DECORATIVE SIGN POSTS, PLANTERS, ON-SITE PAVEMENT MARKINGS AND SIGNING, OFF-SITE PAVEMENT MARKINGS AND SIGNING IN RIGHT-OF-WAY THAT IS NOT DEDICATED FOR PUBLIC USE, SIDEWALK WORK OR ASPHALT WORK.

3. THE CITY ENGINEER IS RESPONSIBLE FOR THE REVIEW AND APPROVAL OF THE DESIGN AND OPERATION OF THE PROJECT, AND FOR THE INSPECTION AND ACCEPTANCE OF THE FOLLOWING ITEMS THAT WILL BE MAINTAINED BY THE CITY: PAVEMENT MARKINGS ON OR ADJACENT TO PAVER BRICKS, PAINTED ASPHALT, STAMPED ASPHALT OR PAVEMENT MARKINGS MADE OF PAVER BRICKS, PAVEMENT MARKINGS ON OR ADJACENT TO PAINTED ASPHALT, RAISED INTERSECTIONS AND RELATED MARKINGS AND SIGNING, UNWARRANTED MID-BLOCK CROSSWALKS AND RELATED MARKINGS AND SIGNING, UN-WARRANTED CROSSWALKS AND RELATED MARKINGS AND SIGNING, PAINTED/DECORATIVE CROSSWALKS, RAISED CROSSWALKS AND RELATED MARKINGS AND SIGNING, ADVANCED WARNING PAVEMENT MARKINGS FOR SPEED TABLES, BLINKER SIGNS, RECTANGULAR RAPID FLASHER BEACONS AND RELATED MARKINGS AND SIGNING, ON-STREET PARKING AND RELATED MARKINGS AND SIGNING, IN-ROAD LIGHTING AND RELATED MARKINGS AND SIGNING, GREEN BIKE LANES, FLEXIBLE DELINEATORS, DECORATIVE SIGNS AND DECORATIVE SIGN POSTS, PLANTERS, ON-SITE PAVEMENT MARKINGS AND SIGNING, OFF-SITE PAVEMENT MARKINGS AND SIGNING IN RIGHT-OF-WAY THAT IS NOT DEDICATED FOR PUBLIC USE, SIDEWALK WORK AND ASPHALT

ALL TRAFFIC CONTROL DEVICES MAINTAINED BY BROWARD COUNTY, THAT ARE REMOVED OR DAMAGED BY CONSTRUCTION, SHALL BE REPLACED BY CONTRACTOR USING CURRENT BROWARD COUNTY TRAFFIC ENGINEERING DIVISION STANDARDS.

> THIS ITEM HAS BEEN DIGITALLY SIGNED AND SEALED BY ANDREW W. ADAMS, P.E. ON THE DATE ADJACENT TO THE SEAL. PRINTED COPIES OF THIS DOCUMENT ARE ANDREW W. ADAMS NOT CONSIDERED SIGNED AND SEALED AND THE SIGNATURE MUST BE VERIFIED ON ANY ELECTRONIC COPIES. May 6, 2024 REW W. ADD

CENSE" No. 55315 STATE OF FLORIDA.

REGISTERED ENGINEER #55315 STATE OF FLORIDA DESIGNED: AWA DRAWN: AWA CHECKED: AWA SCALE: AS NOTED DATE: 08/30/2023

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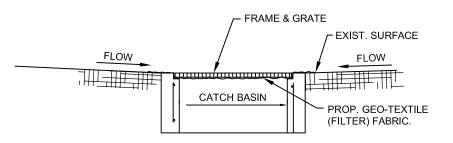
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C-10 OF 33 SHEET:

PROJ. NO. 2306A

#### SEQUENCE OF MAJOR ACTIVITIES


- 1. INSTALL BERM AT BOUNDARIES OF PROPOSED CONSTRUCTION.
- 2. CONSTRUCT GRAVEL ACCESS AREA.
- COMMENCE SITE CONSTRUCTION ACTIVITIES. 4. TEMPORARILY STABILIZE ALL AREAS WITH APPROPRIATE EROSION CONTROL MEASURES.
- 5. INSTALL PERMANENT SEEDING AND PLANTING IN AREAS WHERE CONSTRUCTION ACTIVITIES HAVE PERMANENTLY CEASED NO LATER THAN 15 DAYS AFTER THE LAST CONSTRUCTION ACTIVITIES.
- 6. REMOVE ACCUMULATED SEDIMENT. 7. REMOVE TEMPORARY POLLUTION PREVENTION MEASURES AFTER ALL CONSTRUCTION ON SITE HAS BEEN COMPLETED AND DISPOSE OF ACCORDING



#### INLET EROSION/SEDIMENT CONTROL


1. CONTRACTOR SHALL PERFORM DAILY INSPECTIONS OF GEO-TEXTILE FABRIC BARRIER AND AS NECESSARY REPLACE OR REPAIR AS REQUIRED, SPECIFICALLY AFTER STORM EVENTS AND LARGE RAINFALL EVENTS.

2. SEDIMENTATION AND DEBRIS THAT ARE REMOVED FROM BARRIERS SHALL BE LEGALLY DISPOSED OF AT AN AUTHORIZED OFF-SITE DISPOSAL FACILITY.

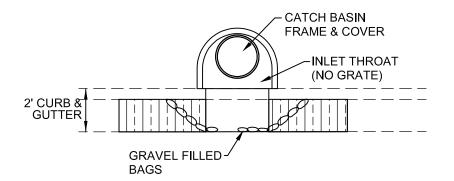



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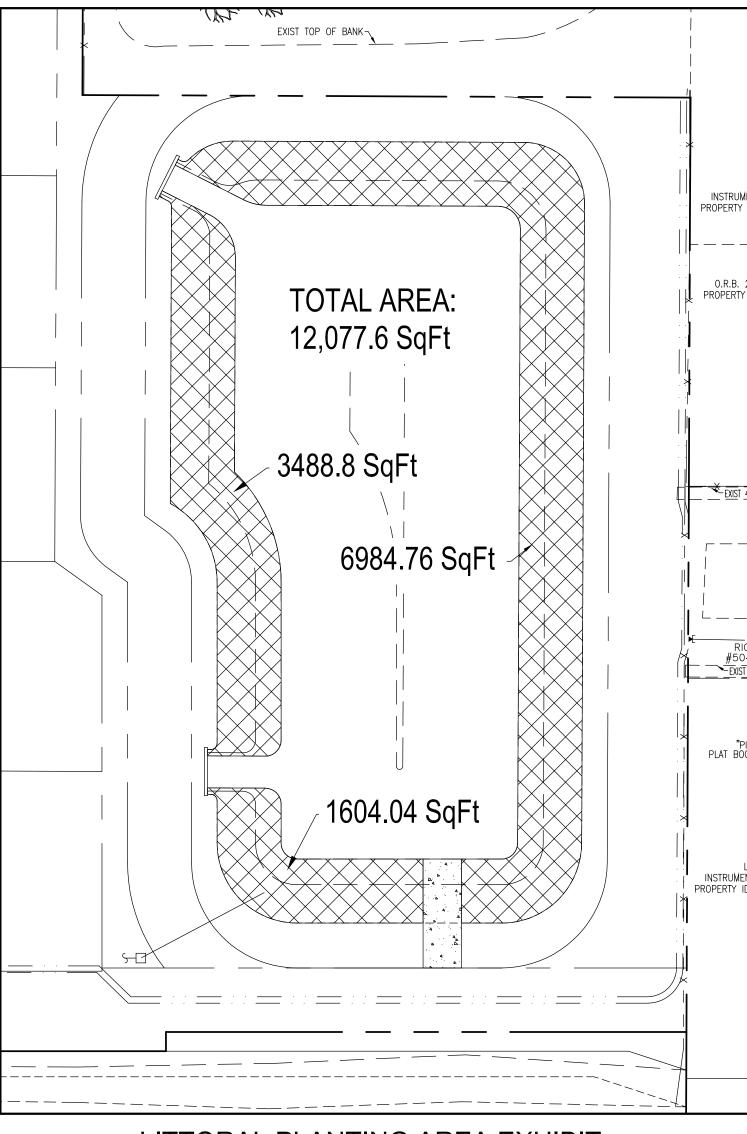
GRAVEL ACCESS BED TEMPORARY CONSTRUCTION ENTRANCE/EXIT



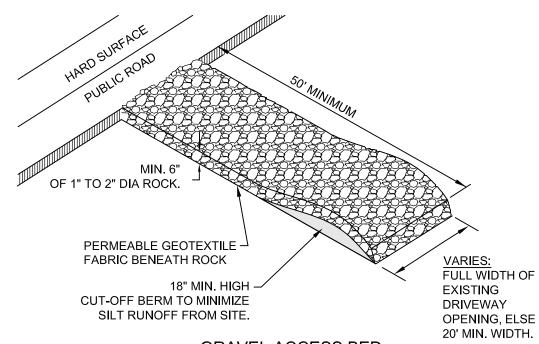

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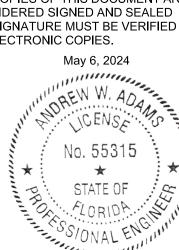
#### LITTORAL PLANTING AREA EXHIBIT SCALE: 1"=30'

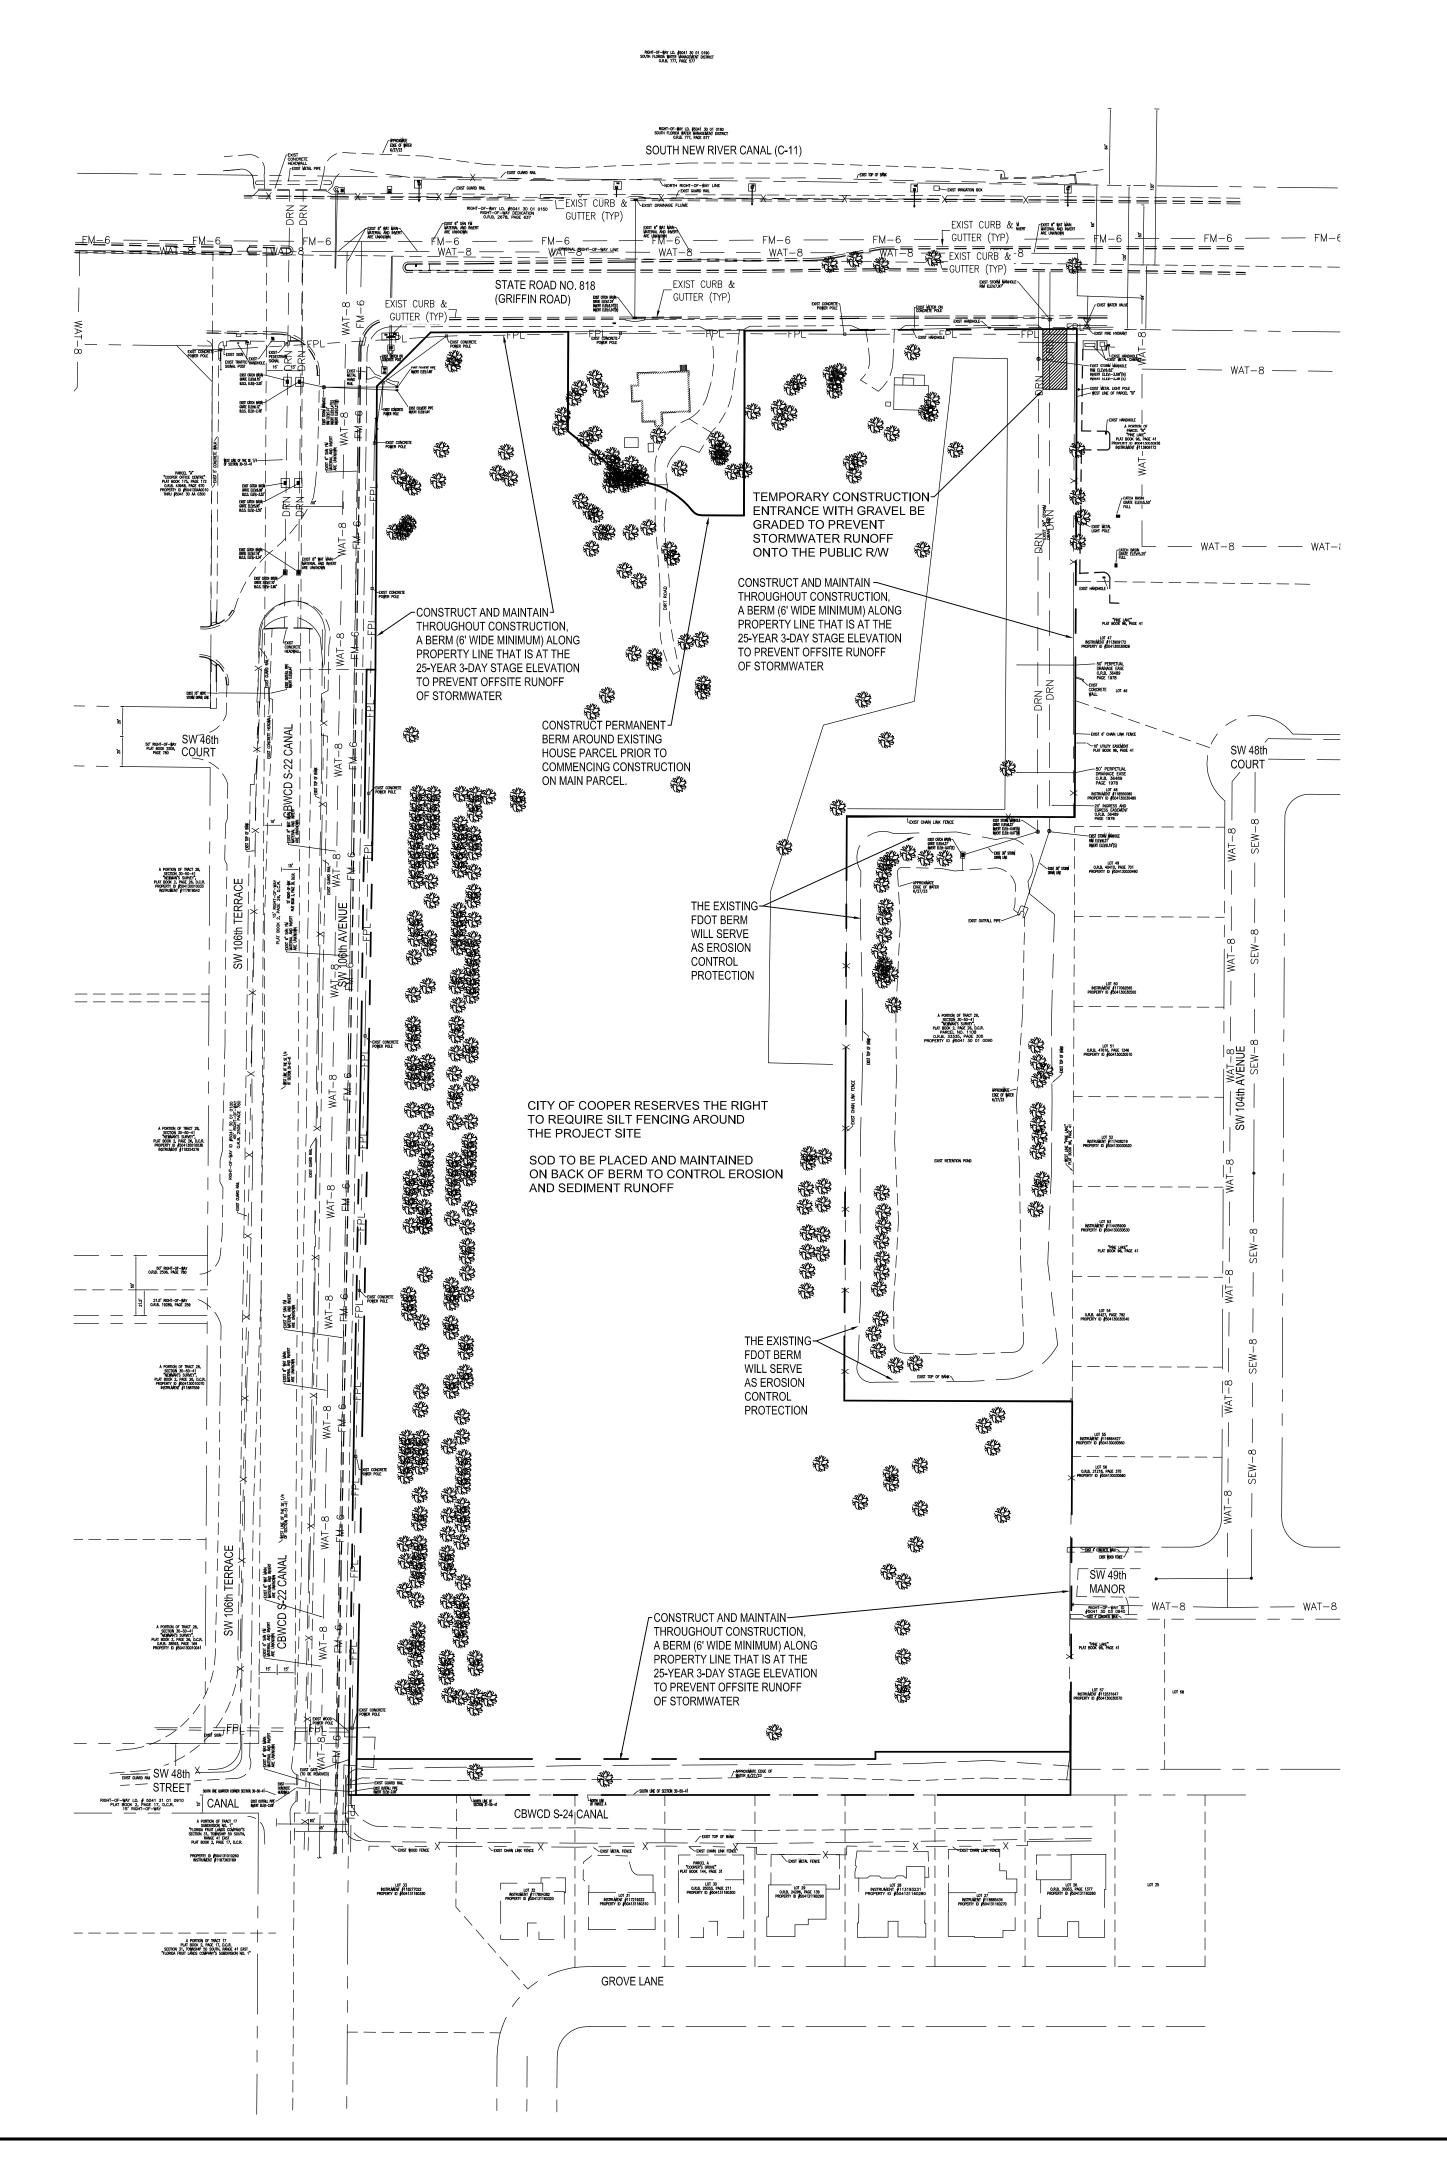Littoral Area Calculations 587,039 SqFt x 2.5% 14,676 SqFt Project Site area Lake Surface Area: 29,300 SqFt x 20% 5,860 SqFt 5,860 SqFt Required littoral area is lesser of above:

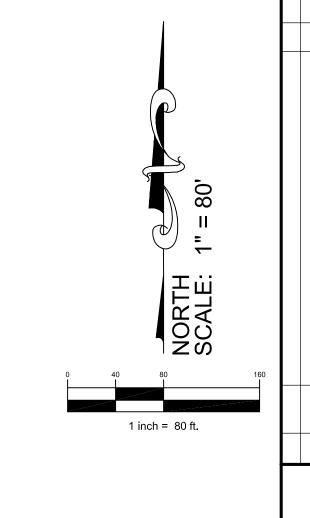Littoral Area Provided:

THIS ITEM HAS BEEN DIGITALLY SIGNED AND SEALED BY ANDREW W. ADAMS, P.E. ON THE DATE ADJACENT TO THE SEAL. PRINTED COPIES OF THIS DOCUMENT ARE NOT CONSIDERED SIGNED AND SEALED AND THE SIGNATURE MUST BE VERIFIED ON ANY ELECTRONIC COPIES.

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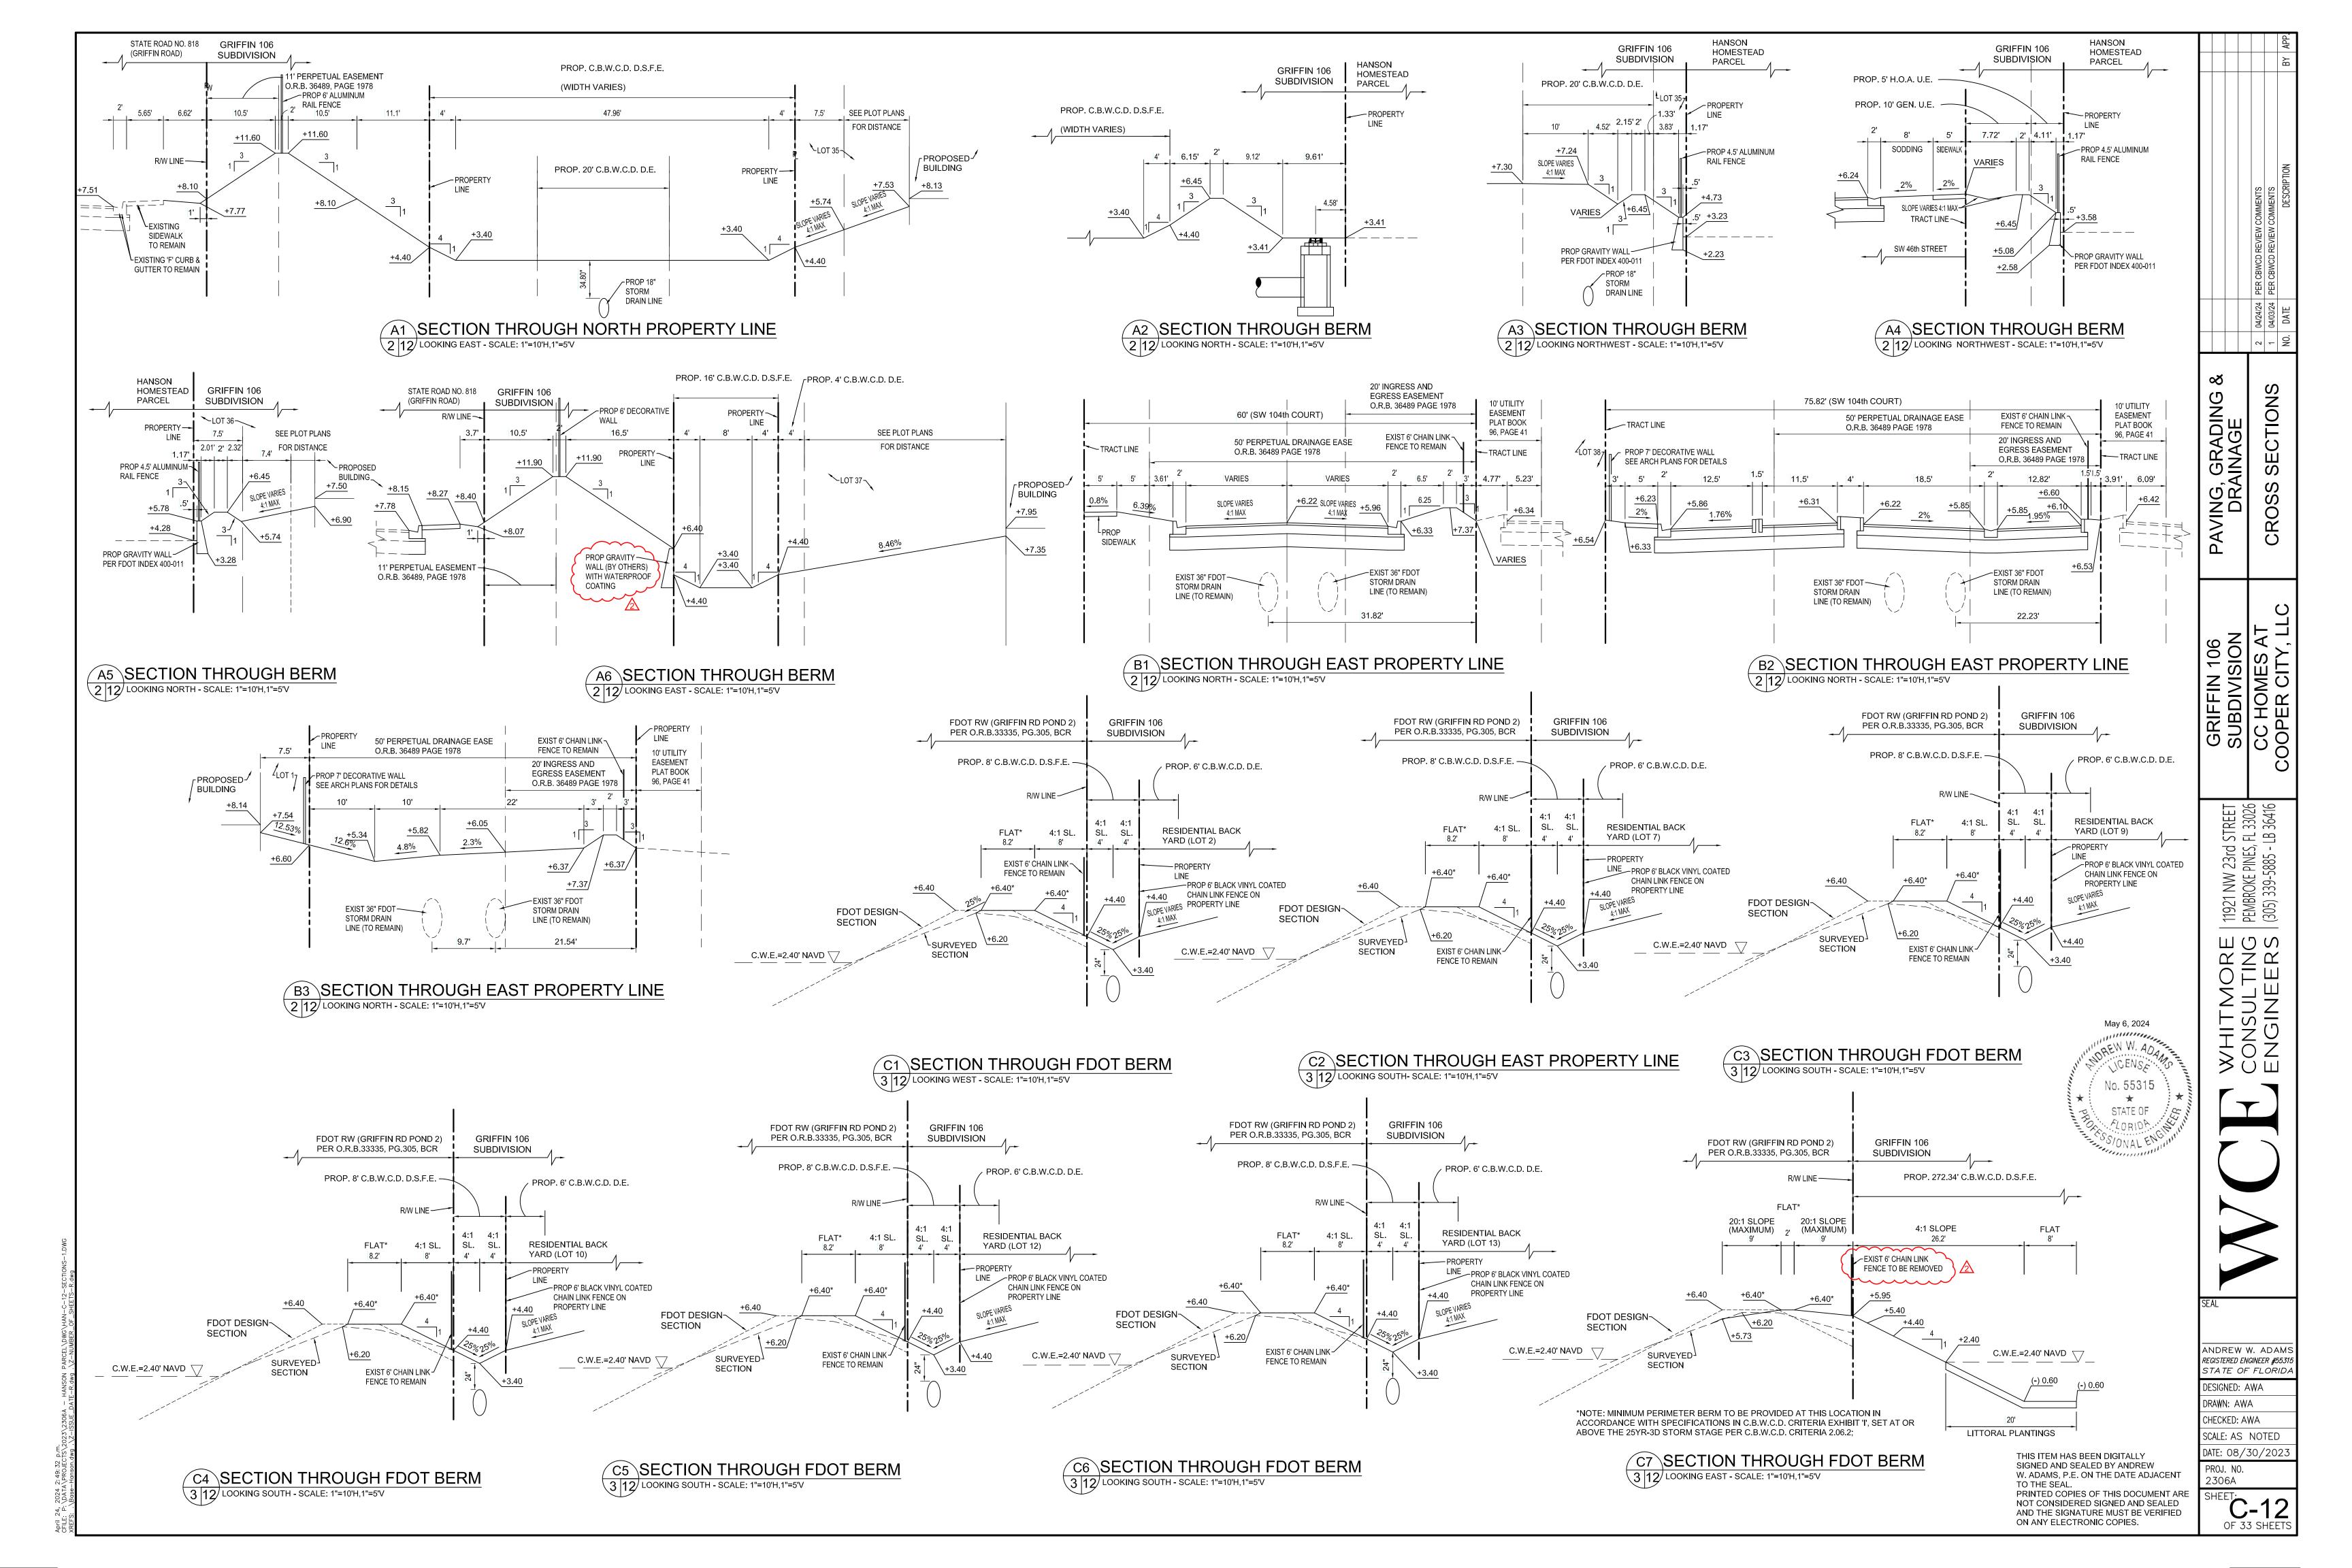



ANDREW W. ADAMS REGISTERED ENGINEER #55318 STATE OF FLORIDA DESIGNED: AWA DRAWN: AWA CHECKED: AWA SCALE: AS NOTED


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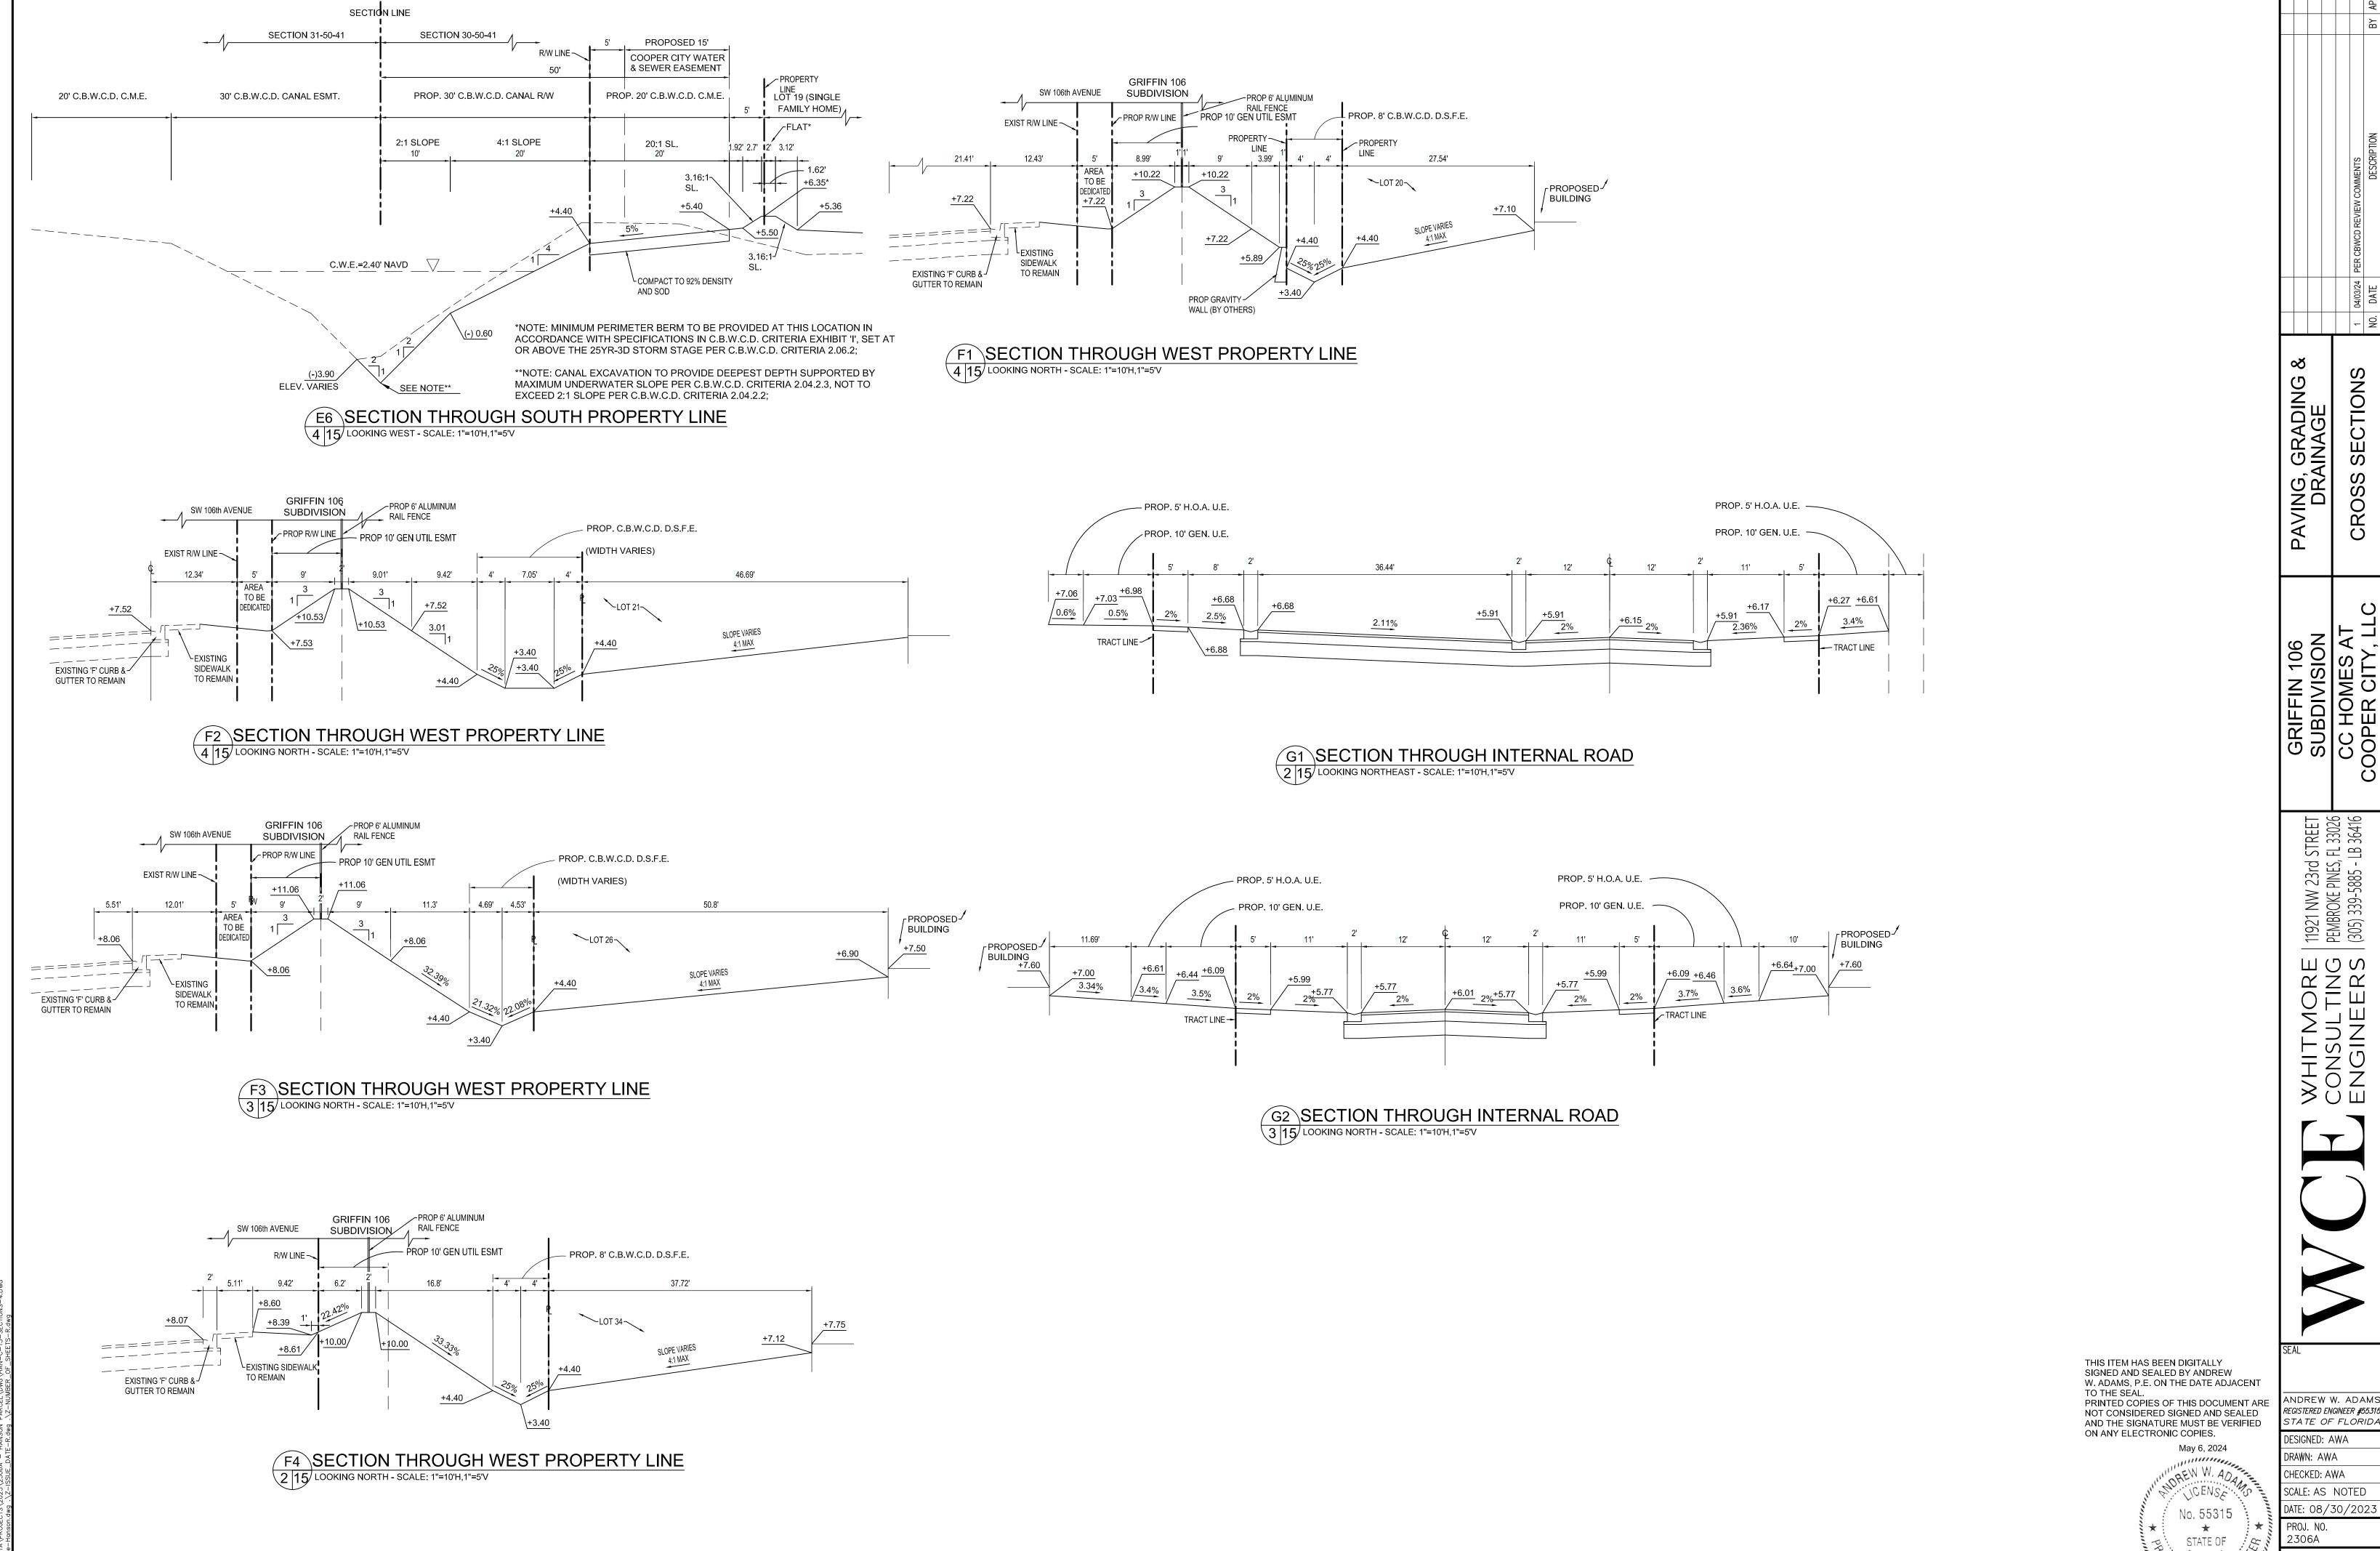
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PROJ. NO. 2306A







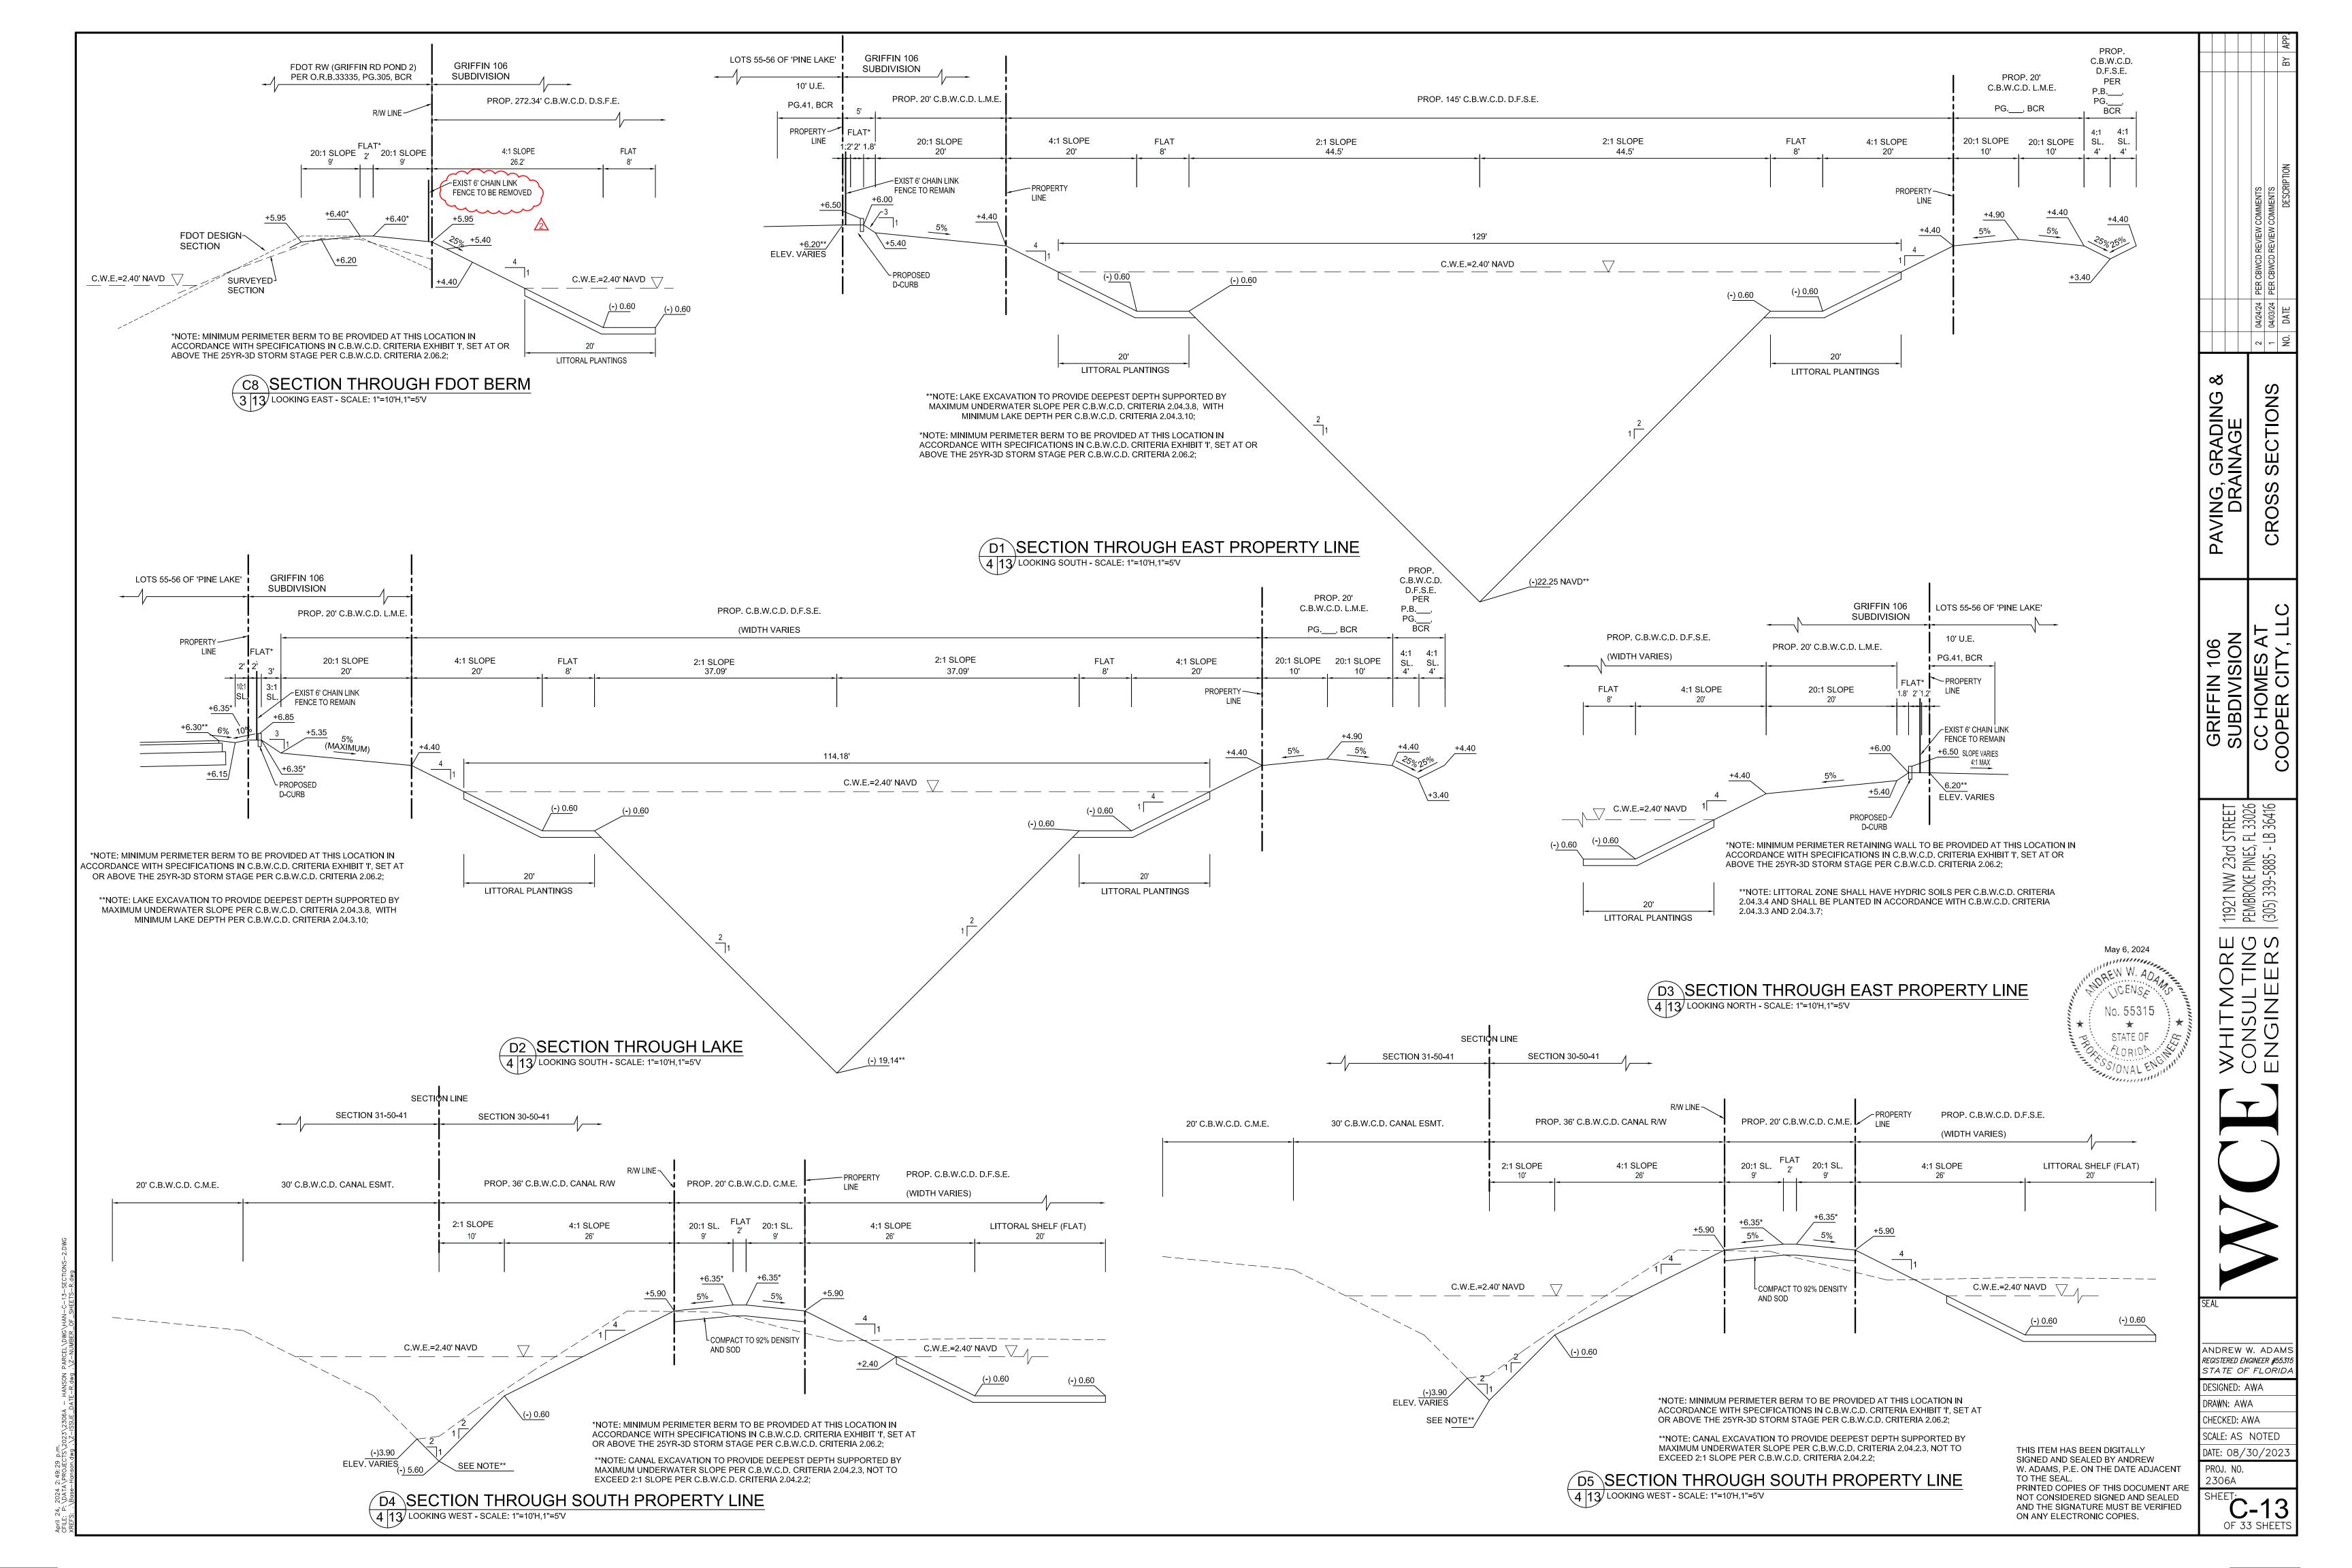
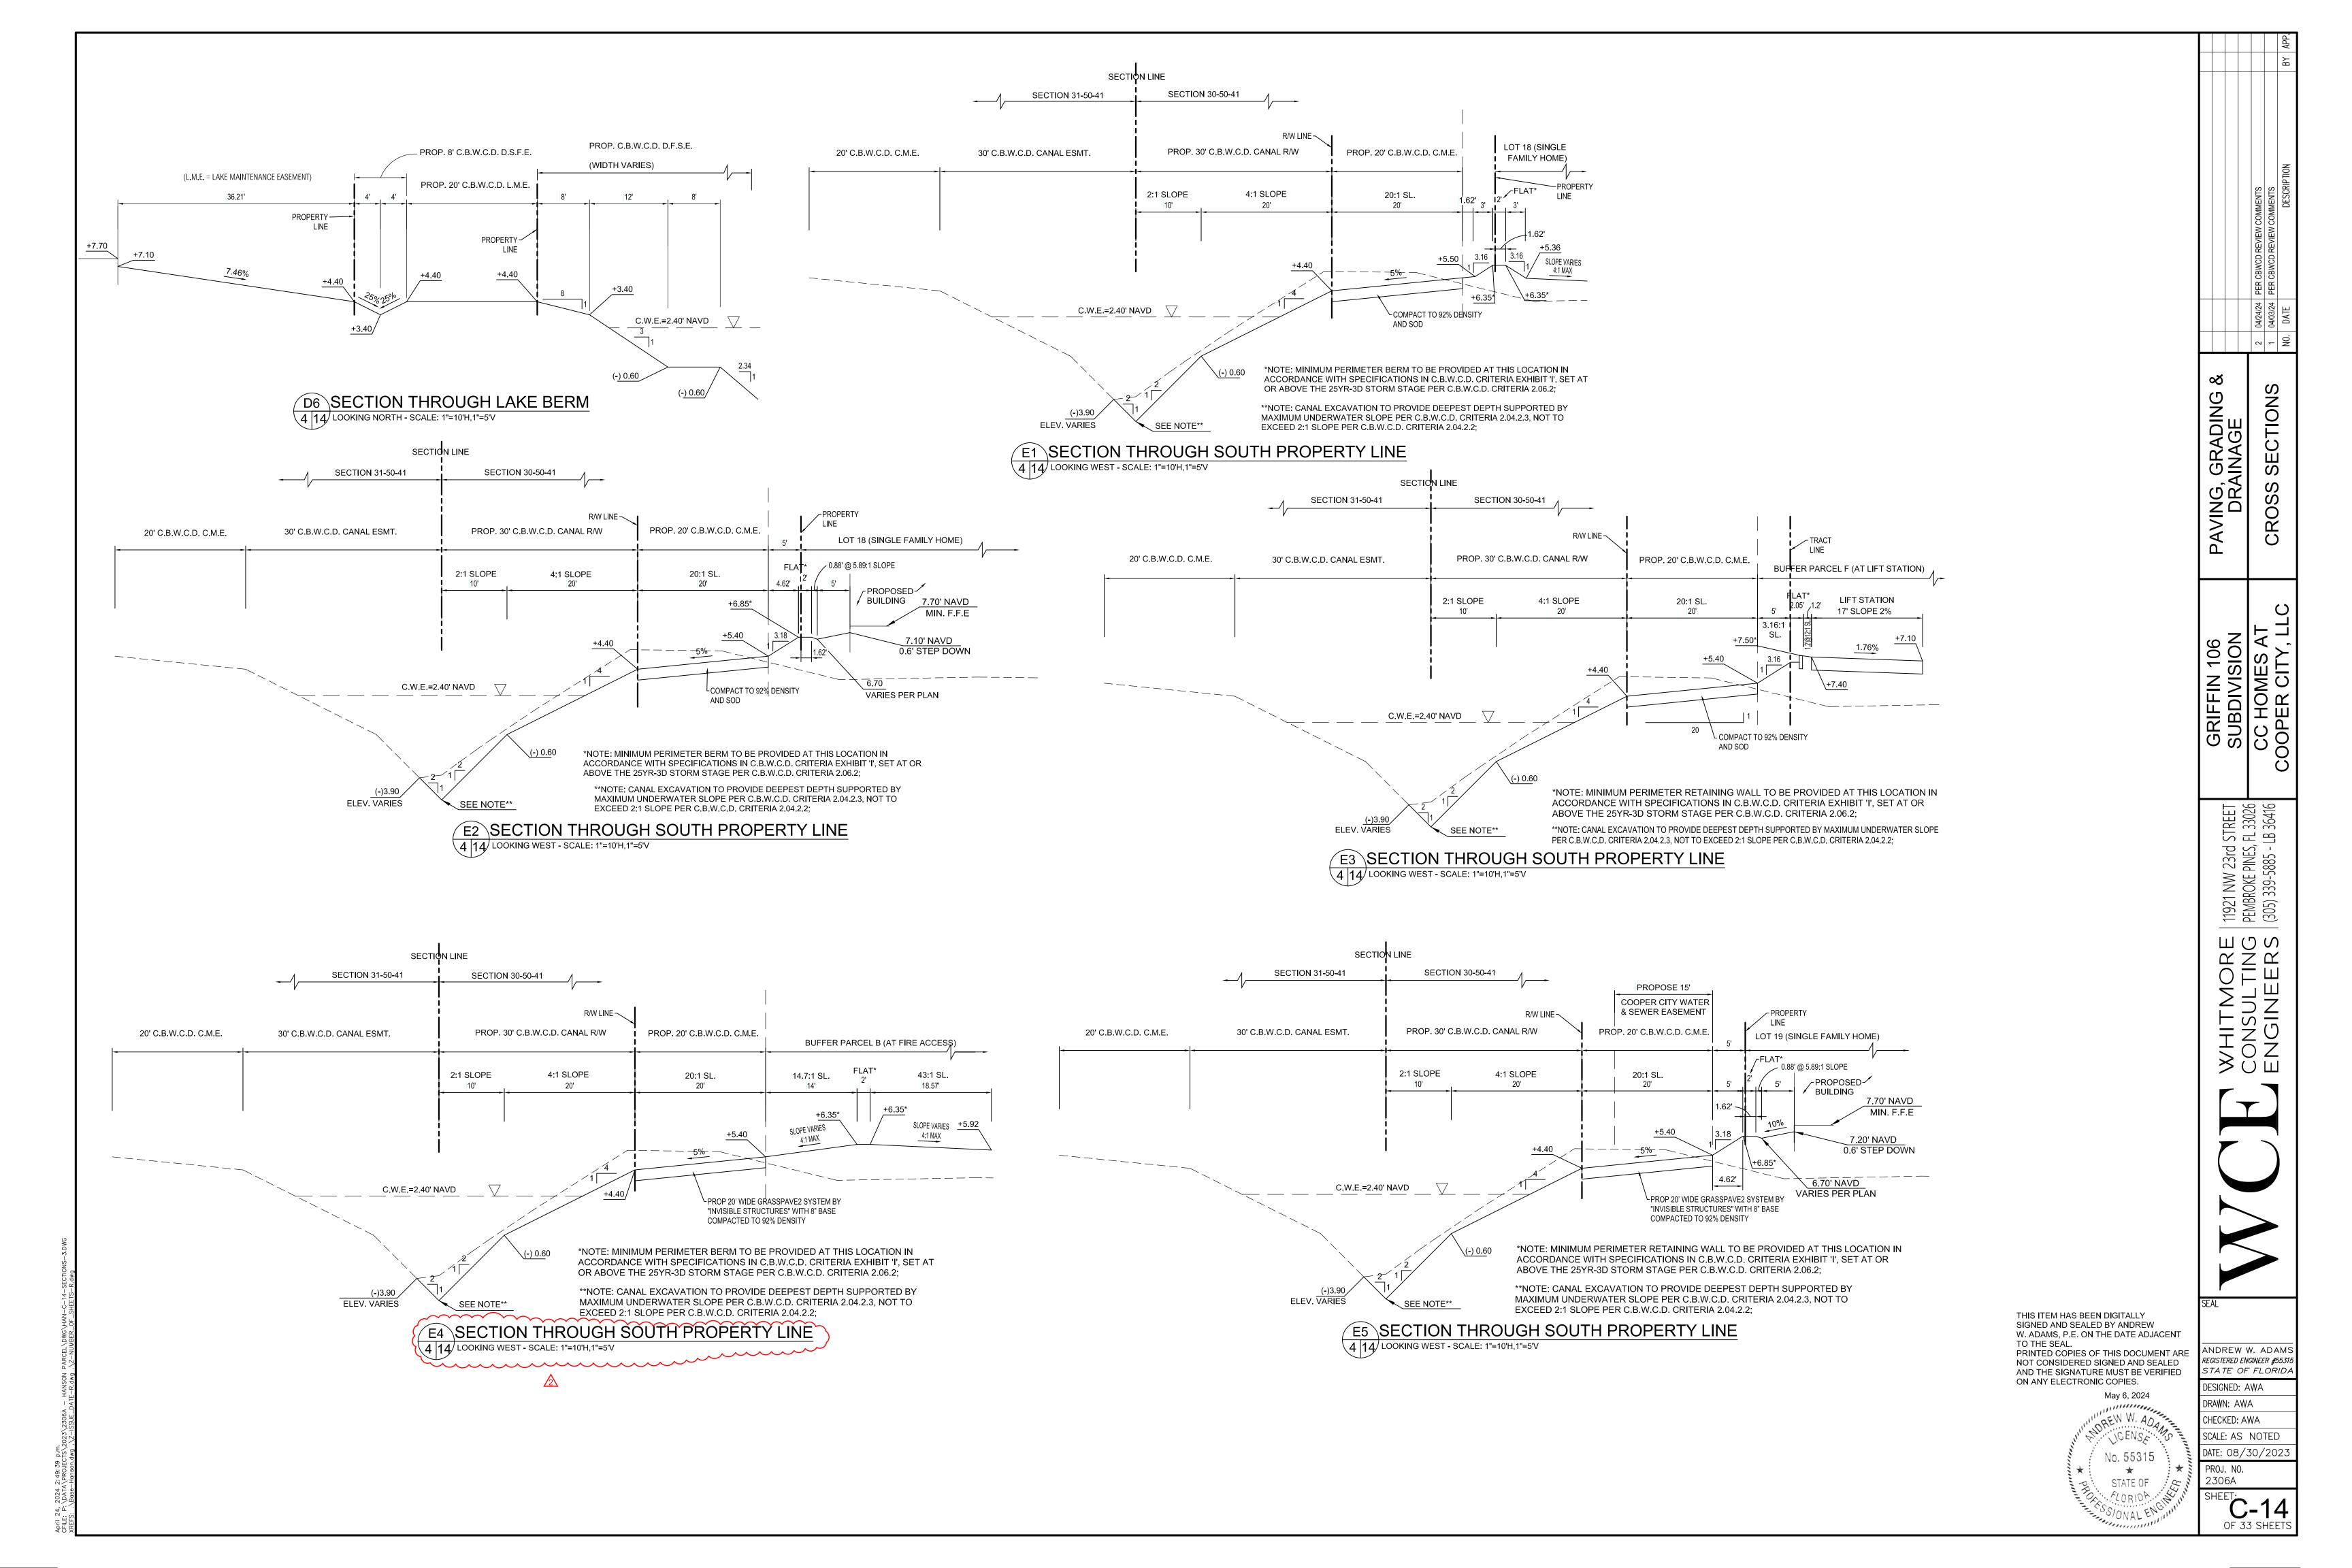
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#### ENGINEER'S NOTES

I. GENERAL NOTES A. ALL ELEVATIONS REFER TO NAVD 1988.

- B. CONTRACTOR:
- 1. THE CONTRACTOR SHALL NOTIFY ALL UTILITY COMPANIES IN THE AREA BEFORE BEGINNING 2. THE CONTRACTOR IS SOLELY RESPONSIBLE FOR COORDINATION AND GIVING NOTICE

OF REQUIRED INSPECTIONS. IN DOING THIS, HONOR THE LEAD-TIME NEEDS OF THE

- RESPECTIVE AGENCIES. 3. NOTIFY ENGINEER'S FIELD REPRESENTATIVE AHEAD OF TIME SO THAT HE CAN MAKE REQUIRED INSPECTIONS LISTED BELOW.
- 4. NOTE: THE ENGINEER'S CERTIFICATION OF CONSTRUCTION OBSERVATION IS REQUIRED FOR UTILITY CONVEYANCE. YOU ARE RESPONSIBLE FOR NOTIFYING THE ENGINEER 24 HOURS IN ADVANCE OF MANHOLE INSTALLATIONS, MAIN & SERVICE INSTALLATIONS, TESTING, BACKFILLING, FLUSHING AND DISINFECTING SO THAT ENGINEER MAY MAKE THE OBSERVATIONS NECESSARY FOR THE CERTIFICATION.
- WORK WITH UTILITY CONTRACTORS IS TO BE COORDINATED IN ORDER TO AVOID POTENTIAL CONFLICTS BETWEEN SEEPAGE TRENCHES AND UTILITY MAINS AND SERVICES. C. EXISTING FACILITIES:
- 1. PROMPTLY PATCH AND REPAIR ANY DAMAGES CAUSED TO EXISTING FACILITIES AND UTILITIES. CLOSELY MATCH TEXTURES AND FINISHES OF EXISTING ADJACENT SURFACES. PATCH WITH DURABLE SEAMS THAT ARE AS INVISIBLE AS POSSIBLE. INSPECT AND TEST PATCHED AREAS TO DEMONSTRATE INTEGRITY OF THE INSTALLATIONS, WHERE FEASIBLE.
- 2. CONTRACTOR TO VERIFY LOCATION, ELEVATION, MATERIAL AND CONDÍTION OF ALL EXISTING UTILITIES PRIOR TO THE START OF CONSTRUCTION. AFTER OBTAINING LOCATIONS FROM SUNSHINE AND OTHER UTILITY COMPANIES, AND PRIOR TO THE START OF CONSTRUCTION, CONTRACTOR SHALL UNCOVER ALL KNOWN UNDERGROUND UTILITIES IN THE PATH OF THE WORK, WHETHER OR NOT THE UTILITIES ARE SHOWN ON THE PLANS, AND TAKE VERTICAL AND HORIZONTAL MEASUREMENTS OF THE LOCATION OF THESE UTILITIES,
- AND IF ANY CONFLICTS ARE APPARENT REPORT THE MEASUREMENTS TO THE ENGINEER. 3. IT SHALL BE THE CONTRACTOR'S RESPONSIBILITY TO VERIFY ALL UNDERGROUND FACILITIES PRIOR TO THE START OF CONSTRUCTION AND COORDINATE WITH THE VARIOUS UTILITY AGENCIES TO RELOCATE, BYPASS OR OTHERWISE ENSURE THAT UTILITY SERVICES WILL NOT BE INTERRUPTED DURING CONSTRUCTION.
- 4. EXISTING FACILITIES SHALL BE RESTORED TO A CONDITION EQUIVALENT TO THAT WHICH EXISTED PRIOR TO THE COMMENCEMENT OF CONSTRUCTION. NO SEPARATE PAYMENT
- WILL BE MADE FOR THIS WORK. 5. THE LOCATIONS OF EXISTING FACILITIES HAVE BEEN PREPARED FROM THE MOST RELIABLE INFORMATION AVAILABLE TO THE ENGINEER. THE CONTRACTOR SHALL VERIFY
- THE LOCATION OF FACILITIES IN THE FIELD. 6. EXISTING GRADES WERE TAKEN FROM THE BEST AVAILABLE DATA AND MAY NOT ACCURATELY REFLECT PRESENT CONDITIONS, CONTRACTOR SHALL BE RESPONSIBLE FOR FAMILIARIZING HIMSELF WITH CURRENT SITE CONDITIONS, AND SHALL REPORT ANY
- DISCREPANCIES TO THE ENGINEER PRIOR TO STARTING WORK. 7. EXISTING LAND MARKERS AND MONUMENTS WITHIN THE LIMITS OF CONSTRUCTION SHALL BE REFERENCED BY THE CONTRACTOR'S SURVEY PARTY AND IF DISTURBED, SHALL
- BE RESET. 8. THE CONTRACTOR SHALL MAINTAIN ACCESS TO ALL ADJACENT PROPERTIES AT ALL
- 9. ALL GRASS AREAS AFFECTED BY CONSTRUCTION SHALL BE RE-SODDED WITH ST. AUGUSTINE GRASS AND IS INCIDENTAL TO THE CONTRACT. D. SURVEY/LAYOUT:
- 1. THE CONTRACTOR SHALL CONTACT THE DESIGN ENGINEER IF ANY ADDITIONAL DIMENSIONS OR SPECIFICATIONS ARE NEEDED TO LAYOUT OR CONSTRUCT THE PROJECT.
- 1. UNDERGROUND CONTRACTOR SHALL COMPLY WITH THE TRENCH SAFETY ACT, HB 3183, FLORIDA STATUTES, WHICH INCORPORATES, BUT IS NOT LIMITED TO, THE FOLLOWING: a. OSHA STANDARD 29 C.F.R. PART 1926, SUBPART P, EXCAVATION AND
- 2. ADHERE TO ANY SPECIAL SHORING REQUIREMENTS OF THE STATE OR OTHER
- POLITICAL SUBDIVISION. 3. ENGINEER IS NOT RESPONSIBLE FOR THE SAFETY OF THE EXCAVATION OR DESIGN
- AND CONSTRUCTION OF ANY SHORING. 4. THE CONTRACTOR SHALL CONDUCT ALL CONSTRUCTION OPERATIONS IN A MANNER TO PREVENT INJURY TO PEOPLE AND WORKERS, AND DAMAGE TO ADJACENT BUILDINGS AND
- FACILITIES. ENSURE SAFE PASSAGE OF PEOPLE AROUND WORKING AREAS. 1. NO MODIFICATIONS TO THESE PLANS ARE ALLOWED WITHOUT THE WRITTEN CONSENT OF THE ENGINEER. NO AGENCY INSPECTOR, CONTRACTOR, OR OWNER IS AUTHORIZED TO
- UNILATERALLY MODIFY THESE PLANS. 2. EXCEPT AS PARTICULARLY NOTED ON THE PLANS, ALL PROPOSED CONSTRUCTION SHALL COMPLY WITH THE REQUIREMENTS OF THE COOPER CITY PUBLIC WORKS MANUAL, AND THE SOUTH FLORIDA BUILDING CODE. IF ANY ITEM OF WORK IS NOT COVERED IN EITHER OF THE SPECIFICATIONS, IT SHALL BE CONSTRUCTED PER THE FLORIDA DEPARTMENT OF TRANSPORTATION STANDARD SPECIFICATIONS FOR ROAD AND BRIDGE CONSTRUCTION.
- 3. IT IS THE INTENT OF THESE PLANS TO BE IN ACCORDANCE WITH APPLICABLE CODES AND AUTHORITIES HAVING JURISDICTION ANY DISCREPANCIES BETWEEN THESE PLANS AND APPLICABLE CODES SHALL BE IMMEDIATELY BROUGHT TO THE ATTENTION OF THE ENGINEER.

METERS WILL NOT BE INSTALLED IF THE METER BOXES ARE IN A DRIVING SURFACE

- 1. USE WATER MIST, TEMPORARY ENCLOSURES, AND ANY OF THE SUITABLE METHODS TO LIMIT THE SPREAD OF DUST AND DIRT. COMPLY WITH GOVERNING ENVIRONMENTAL PROTECTION REGULATIONS.
- 1. EXISTING TREES SHALL BE REMOVED ONLY IF REQUIRED FOR CONSTRUCTION. THOSE TREES NOT INTERFERING WITH CONSTRUCTION SHALL BE PROTECTED IN PLACE. THE CONTRACTOR IS ADVISED THAT A TREE PERMIT MAY BE REQUIRED FOR TREE REMOVAL CONTRACTOR SHALL NOTIFY D.E.R.M. PRIOR TO REMOVING ANY TREES.
- 2. ALL EXISTING TREES TO REMAIN SHALL BE PROTECTED AT ALL TIMES DURING CONSTRUCTION. ROOTS AND BRANCHES SHALL BE PRUNED AS NEEDED ENSURING TO PROVOKE THE MINIMUM POSSIBLE AMOUNT OF DAMAGE TO THE TREES. NOTIFY THE ENGINEER OF ANY DISCREPANCIES IN LOCATION OF EXISTING TREES FOR ADJUSTMENTS OF PROPOSED WORK.
- 3. NO MATERIAL SHALL BE STORED OR CONSTRUCTION OPERATION CARRIED ON WITHIN 4 FEET OF ANY TREE TO BE SAVED OR WITHIN THE TREE PROTECTION FENCE.
- I PRE-CONSTRUCTION: 1. THE CONTRACTOR SHALL SUBMIT SHOP DRAWINGS FOR PRECAST STRUCTURES AND MANUFACTURER'S LITERATURE FOR ALL PIPE, FITTINGS AND OTHER HARDWARE FOR REVIEW
- 2. SUBMITTALS (SHOP DRAWINGS AND PRODUCT LITERATURE): NUMBER REQUIRED: ONE TO BE RETAINED BY ENGINEER PLUS WHATEVER ADDITIONAL MAY BE NEEDED BY CONTRACTOR. SCOPE: ALL PRODUCTS AND MATERIALS.
- 3. SHOP DRAWINGS SHALL BE CHECKED AND APPROVED BY THE CONTRACTOR AND THEN SUBMITTED TO THE ENGINEER-OF-RECORD FOR REVIEW PRIOR TO THE PURCHASE OR
- INSTALLATION OF ANY SYSTEM COMPONENTS. J. POST CONSTRUCTION/RECORD DRAWINGS/PROJECT CLOSEOUT: 1. AFTER ALL SITE WORK IS COMPLETED, INCLUDING LANDSCAPING, CONTRACTOR IS TO RETURN TO THE SITE AND JET VAC ALL DRAINAGE STRUCTURES INCLUDING SUMPS AND
- PERFORATED PIPES. 2. CLEAN ADJACENT STRUCTURES AND IMPROVEMENTS OF DUST, DIRT, AND DEBRIS CAUSED BY CONSTRUCTION OPERATIONS. RETURN ADJACENT AREAS TO CONDITIONS EXISTING BEFORE
- START OF CONSTRUCTION. 3. CONTRACTOR SHALL SUBMIT TO ENGINEER ONE PRINT OF THE RECORD DRAWINGS SIGNED AND SEALED BY A LICENSED SURVEYOR FOR ENGINEER'S REVIEW.
- 1. SUBMIT TO UTILITY DEPARTMENT: RECORD MYLAR AND TWO PRINTS SIGNED
- L. PERMITS AND APPROVALS 1. ENGINEER IS RESPONSIBLE FOR GETTING REGULATORY AGENCY APPROVALS OF
- CONSTRUCTION DRAWINGS. 2. OWNER IS RESPONSIBLE FOR GETTING CONSTRUCTION PERMITS FOR THOSE WORKS FOR

AND SEALED BY A LICENSED SURVEYOR AND ENDORSED BY THE CONTRACTOR.

- WHICH THE REGULATORY AGENCIES ISSUE PERMITS ONLY TO THE OWNER. 3. CONTRACTOR IS RESPONSIBLE FOR PULLING ALL OTHER NECESSARY CONSTRUCTION
- PERMITS. UNLESS OTHERWISE PROVIDED IN THE CONTRACT BETWEEN CONTRACTOR AND OWNER, THE CONTRACTOR SHALL PAY THE CONSTRUCTION PERMIT FEES.
- A. ALL OF THE PROPOSED WATER AND SEWER FACILITIES THAT WILL BE DEDICATED TO COOPER CITY SHALL BE FIELD LOCATED AND DESCRIBED WITH BEARINGS AND DISTANCES. THE BEARINGS AND DISTANCES SHOWN IN THE AS-BUILT DRAWINGS SHALL BE REFERENCED TO THE FLORIDA STATE PLANE COORDINATE SYSTEM AND TIED TO THE PROPERTY CORNERS. THE CONTRACTOR SHALL PROVIDE THE ENGINEER WITH AN AUTOCAD FILE AND A SIGNED AND SEALED HARD COPY OF THE AS BUILT SURVEY.

DEPARTMENT OF HEALTH WATER NOTES (REQUIRED)

- 1. SEPARATIONS SHALL BE MEASURED OUTSIDE EDGE TO OUTSIDE EDGE BETWEEN WATER MAINS AND, STORM SEWERS STORM WATER FORCE MAINS, OR RECLAIMED WATER LINES, SHALL BE 3
- 2. BETWEEN WATER MAINS AND VACUUM TYPE SEWER PREFERABLY 10
- FT. AND AT LEAST 3 FT. MINIMUM.
- A. WATER MAIN HORIZONTAL SEPARATIONS GRAVITY OR PRESSURE SANITARY SEWERS, WASTEWATER FORCE MAINS OR RECLAIMED WATER PREFERABLY 10 FT. AND AT LEAST B FL MAY BE REDUCED TO 3 FT. WHERE BOTTOM OF WATER MAINS IS AT LEAST 6 INCHES ABOVE TOP OF SEWER. 10 FT. TO ANY PART OF ON-SITE SEWER TREATMENT OR DISPOSAL SYSTEM.
- B. WATER MAIN VERTICAL-SEPARATIONS 1. SEPARATIONS BETWEEN WATER MAINS AND GRAVITY SEWER, VACUUM TYPE SEWER, OR STORM SEWERS, TO BE PREFERABLY 12 INCHES, OR AT LEAST 6 INCHES ABOVE. OR AT LEAST 12 INCHES IF BELOW.\*
  - 2. PRESSURE SANITARY SEWER, WASTEWATER OR STORM WATER FORCE MAIN, OR RECLAIMED WATER, AT LEAST 12 INCHES ABOVE OR BELOW.\* NOTE: CENTER 1-FULL LENGTH OF WATER MAIN PIPE AT CROSSINGS; ALTERNATIVELY ARRANGE PIPES SO JOINTS ARE AT LEAST 3 FEET FROM JOINTS IN VACUUM, STORM OR STORM FORCE MAINS. AT LEAST 6 FEET FROM JOINTS IN GRAVITY OR PRESSURE SEWERS WASTEWATER FORCE MAINS OR RECLAIMED WATER.

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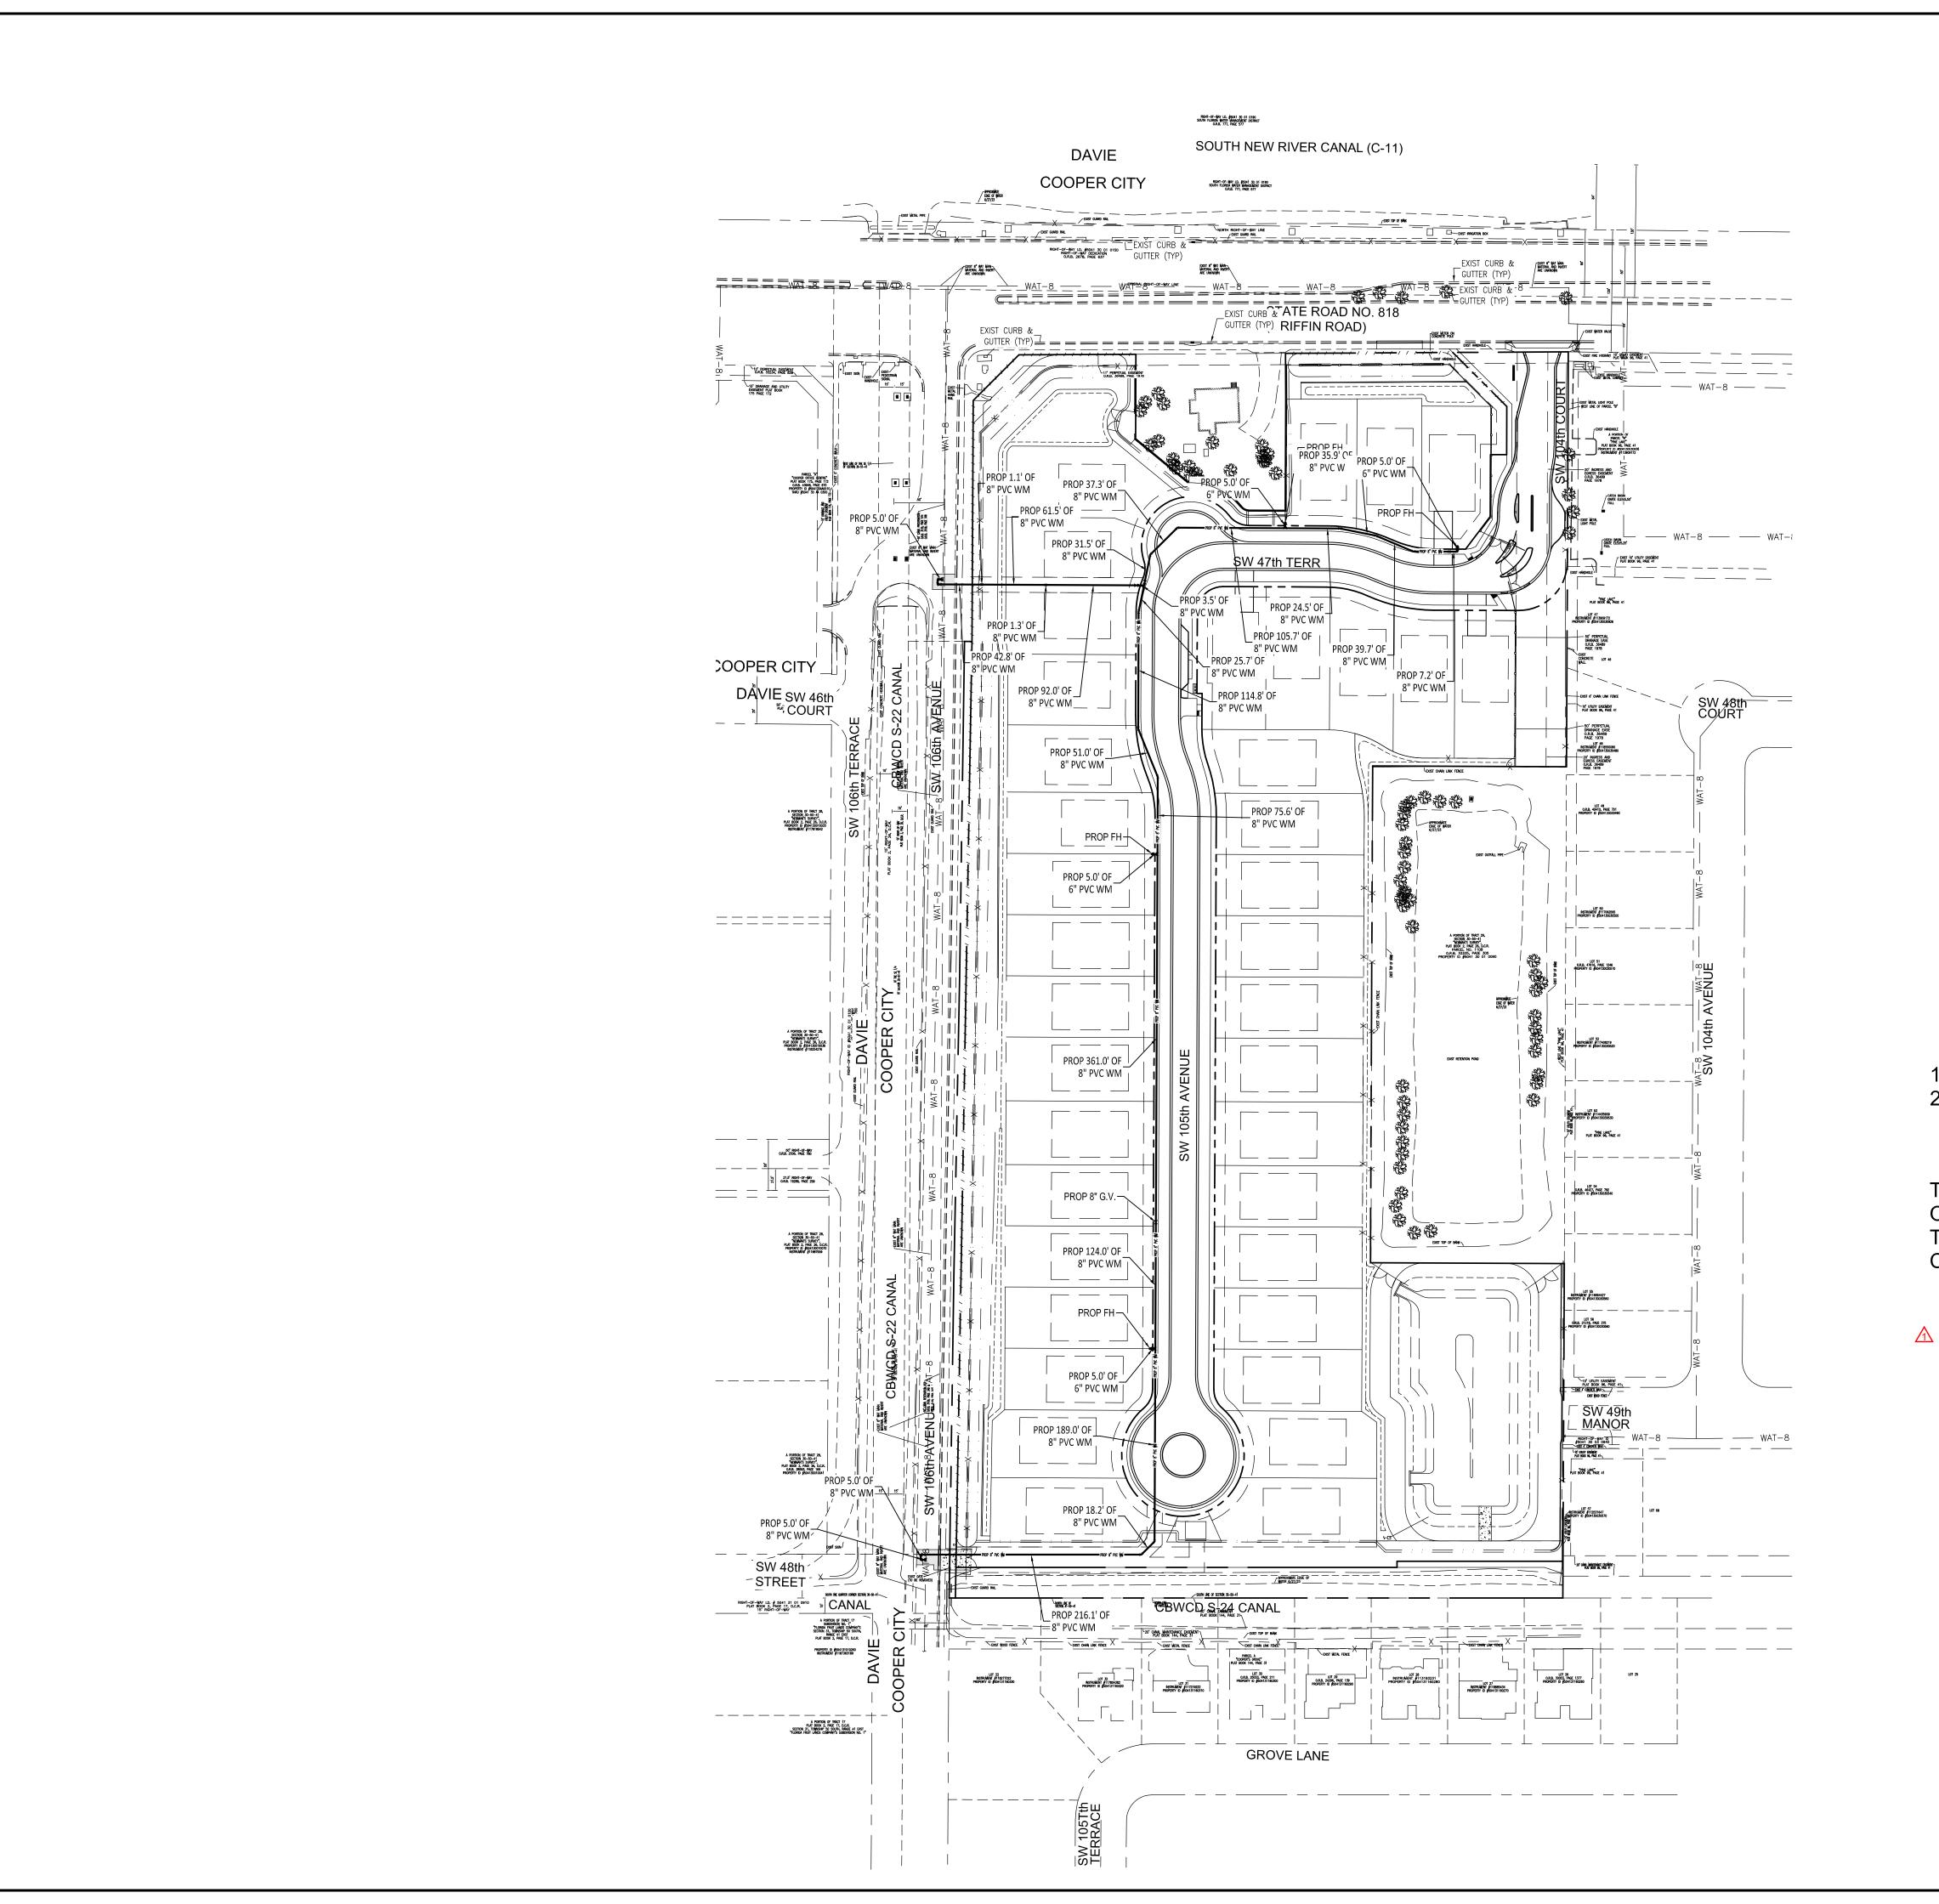
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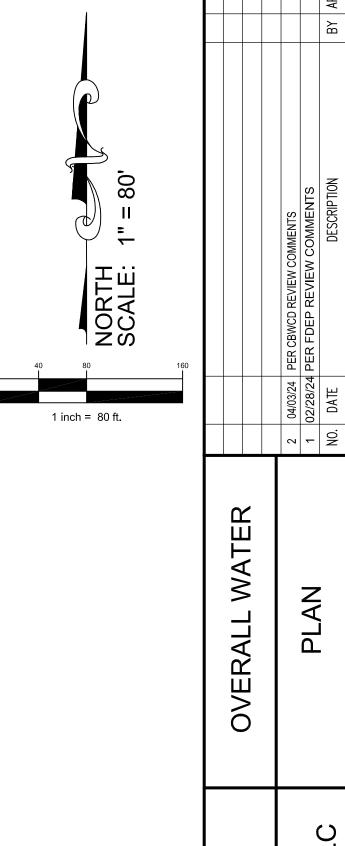
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REGISTERED ENGINEER #55315 STATE OF FLORIDA DESIGNED: AWA DRAWN: AWA CHECKED: AWA SCALE: AS NOTED DATE: 08/30/2023

> PROJ. NO. 2306A

C-16





1,749.7 L.F. OF 8" DIP WATER MAIN 20 L.F. OF 6" DIP WATER MAIN AND 4 FIRE HYDRANTS

THE PURPOSE OF THIS PLAN IS FOR OBTAINING THE LENGTHS OF THE PROPOSED WATER MAIN. REFER TO SHEETS C-23 THROUGH C-25 FOR INFORMATION ON THE JOINTS, CONNECTIONS, AND FITTINGS.

List of Materials			
Item	Unit	Quantity	
8" Gate Valves	Ea.	7	
8" PVC Water Main	LF	1,749.7	
Fire Hydrants	Ea.	4	
6" PVC Water Main	LF	20	
6" Gate Valve	Ea.	4	
Sampling Points	Ea.	4	

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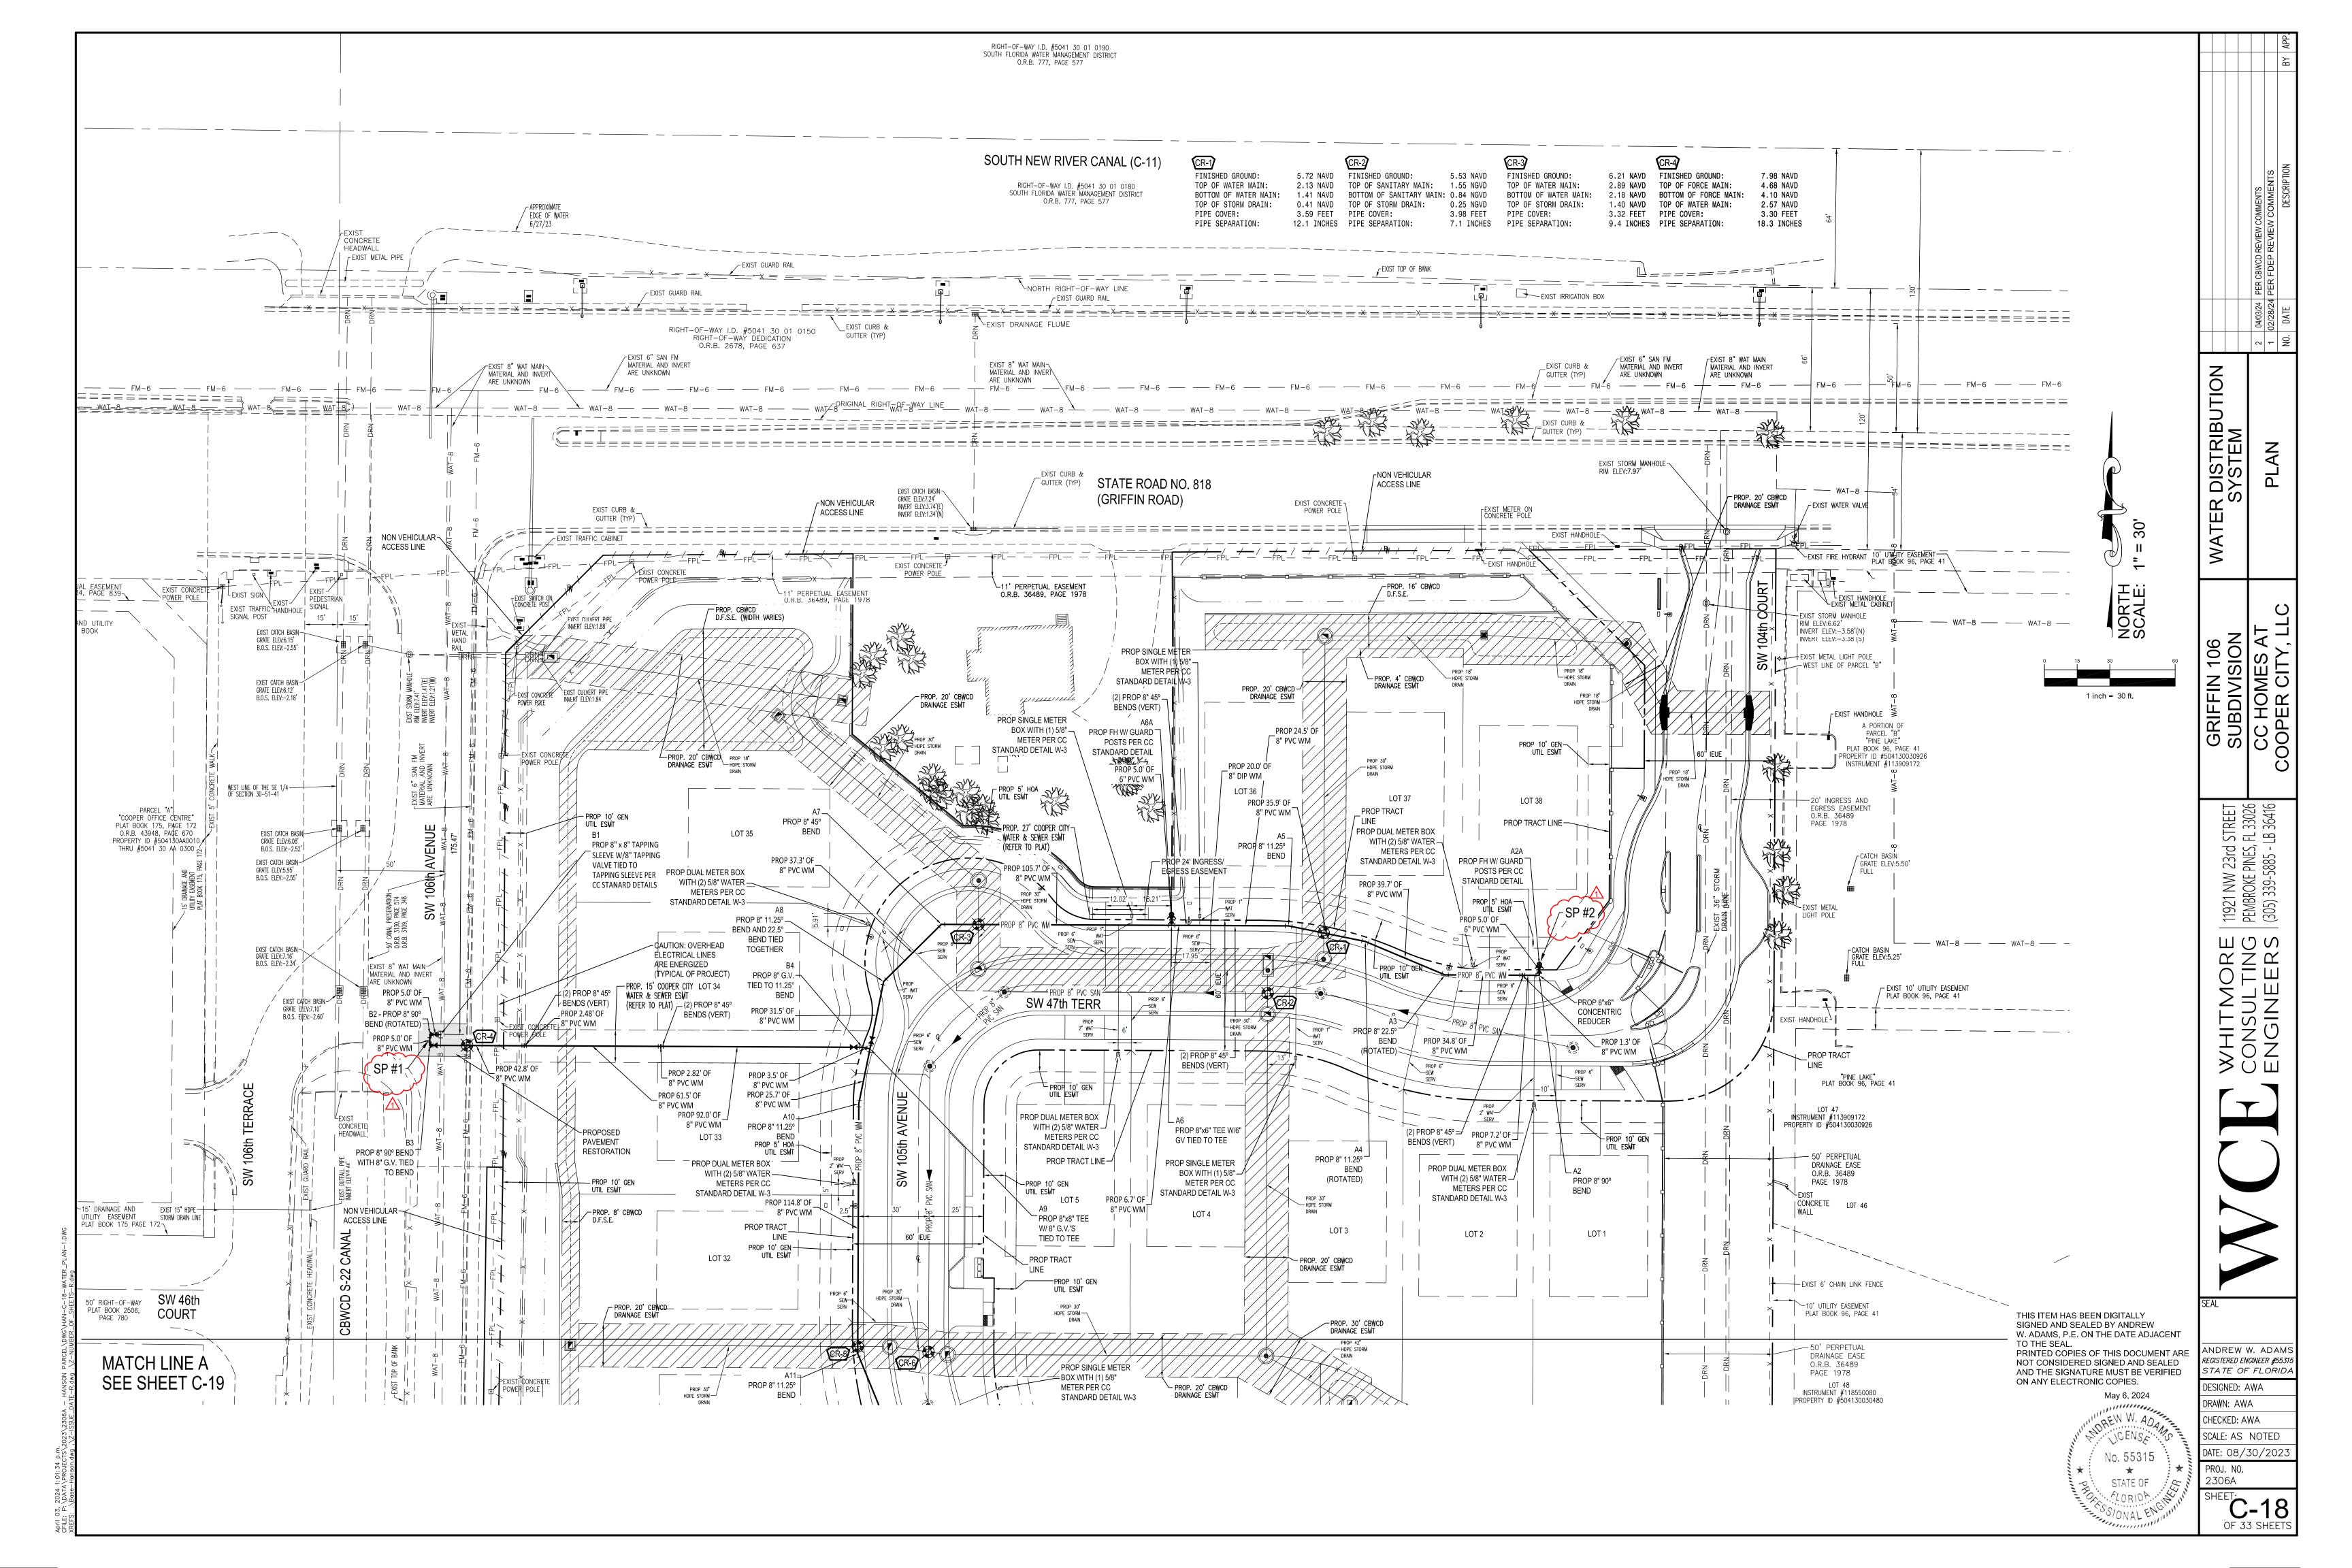
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CUMENT ARE D SEALED E VERIFIED	ANDREW W. ADAMS REGISTERED ENGINEER #55315 STATE OF FLORIDA
)24	DESIGNED: AWA
1000	DRAWN: AWA
ADAM	CHECKED: AWA
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315	DATE: 08/30/2023
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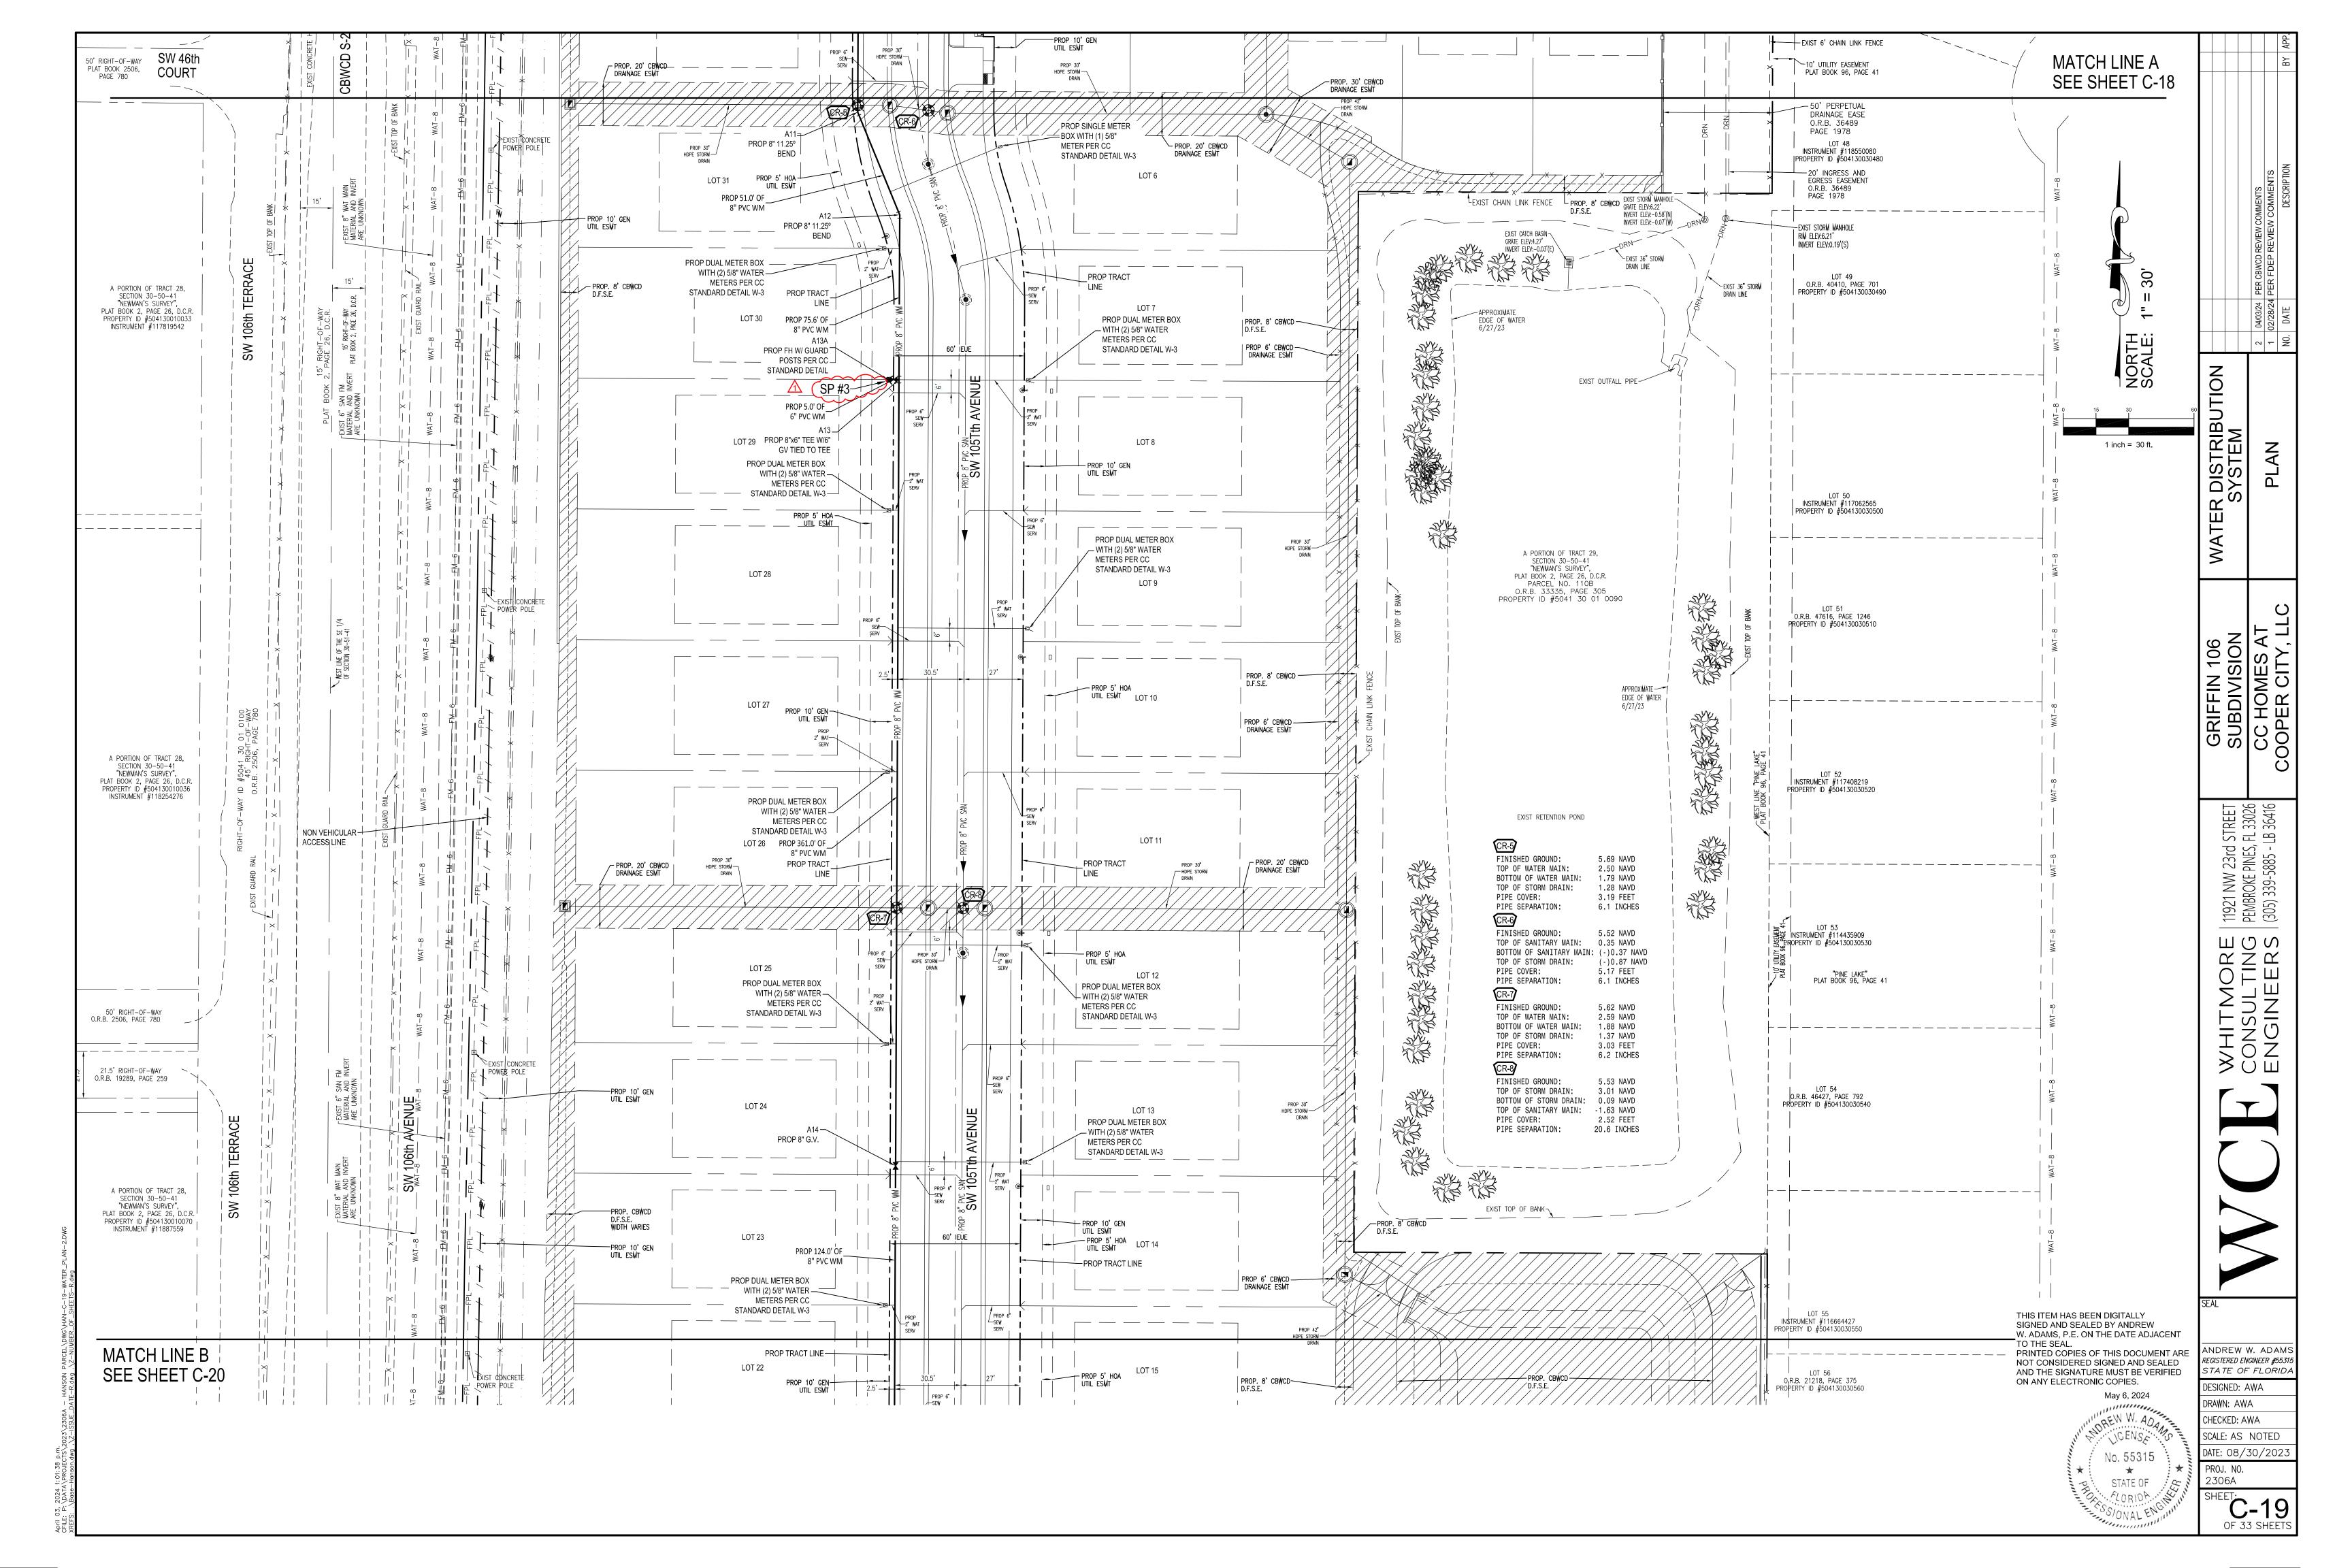
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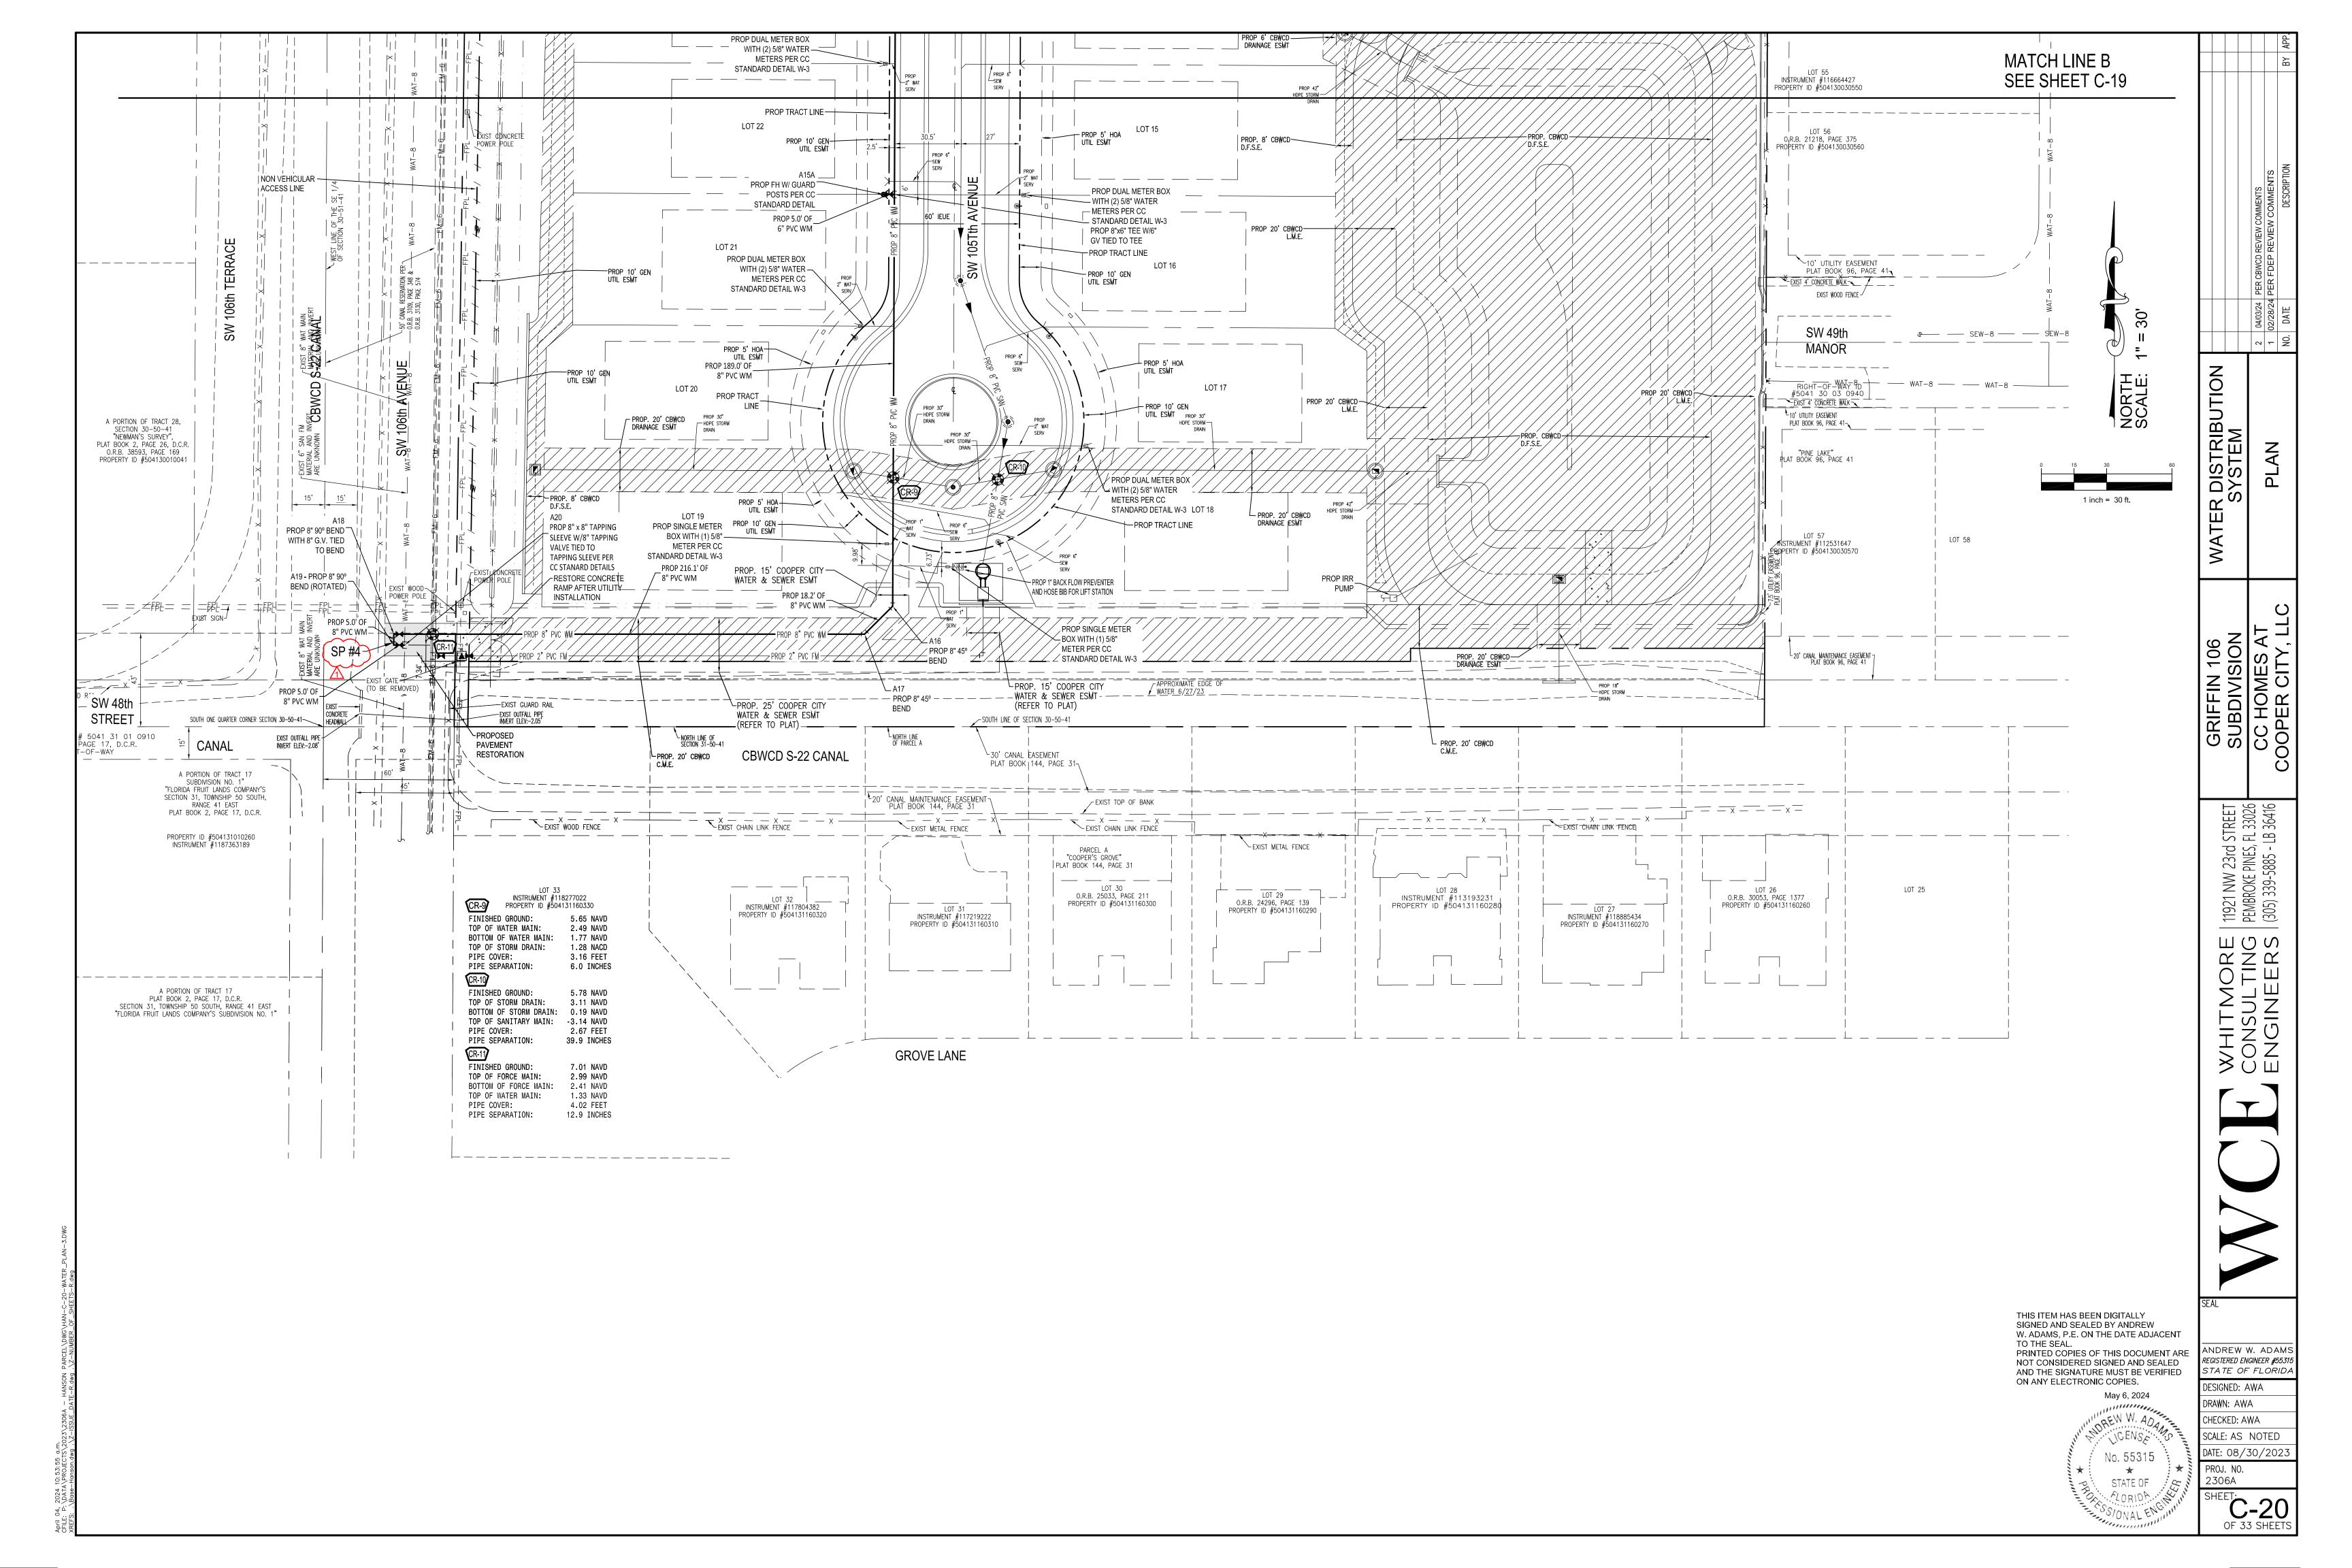
C-17 OF 33 SHEETS


| 11921 NW 23rd STREE | PEMBROKE PINES, FL 3302 | (305) 339-5885 - LB 3641


WHITMORE CONSULTING ENGINEERS










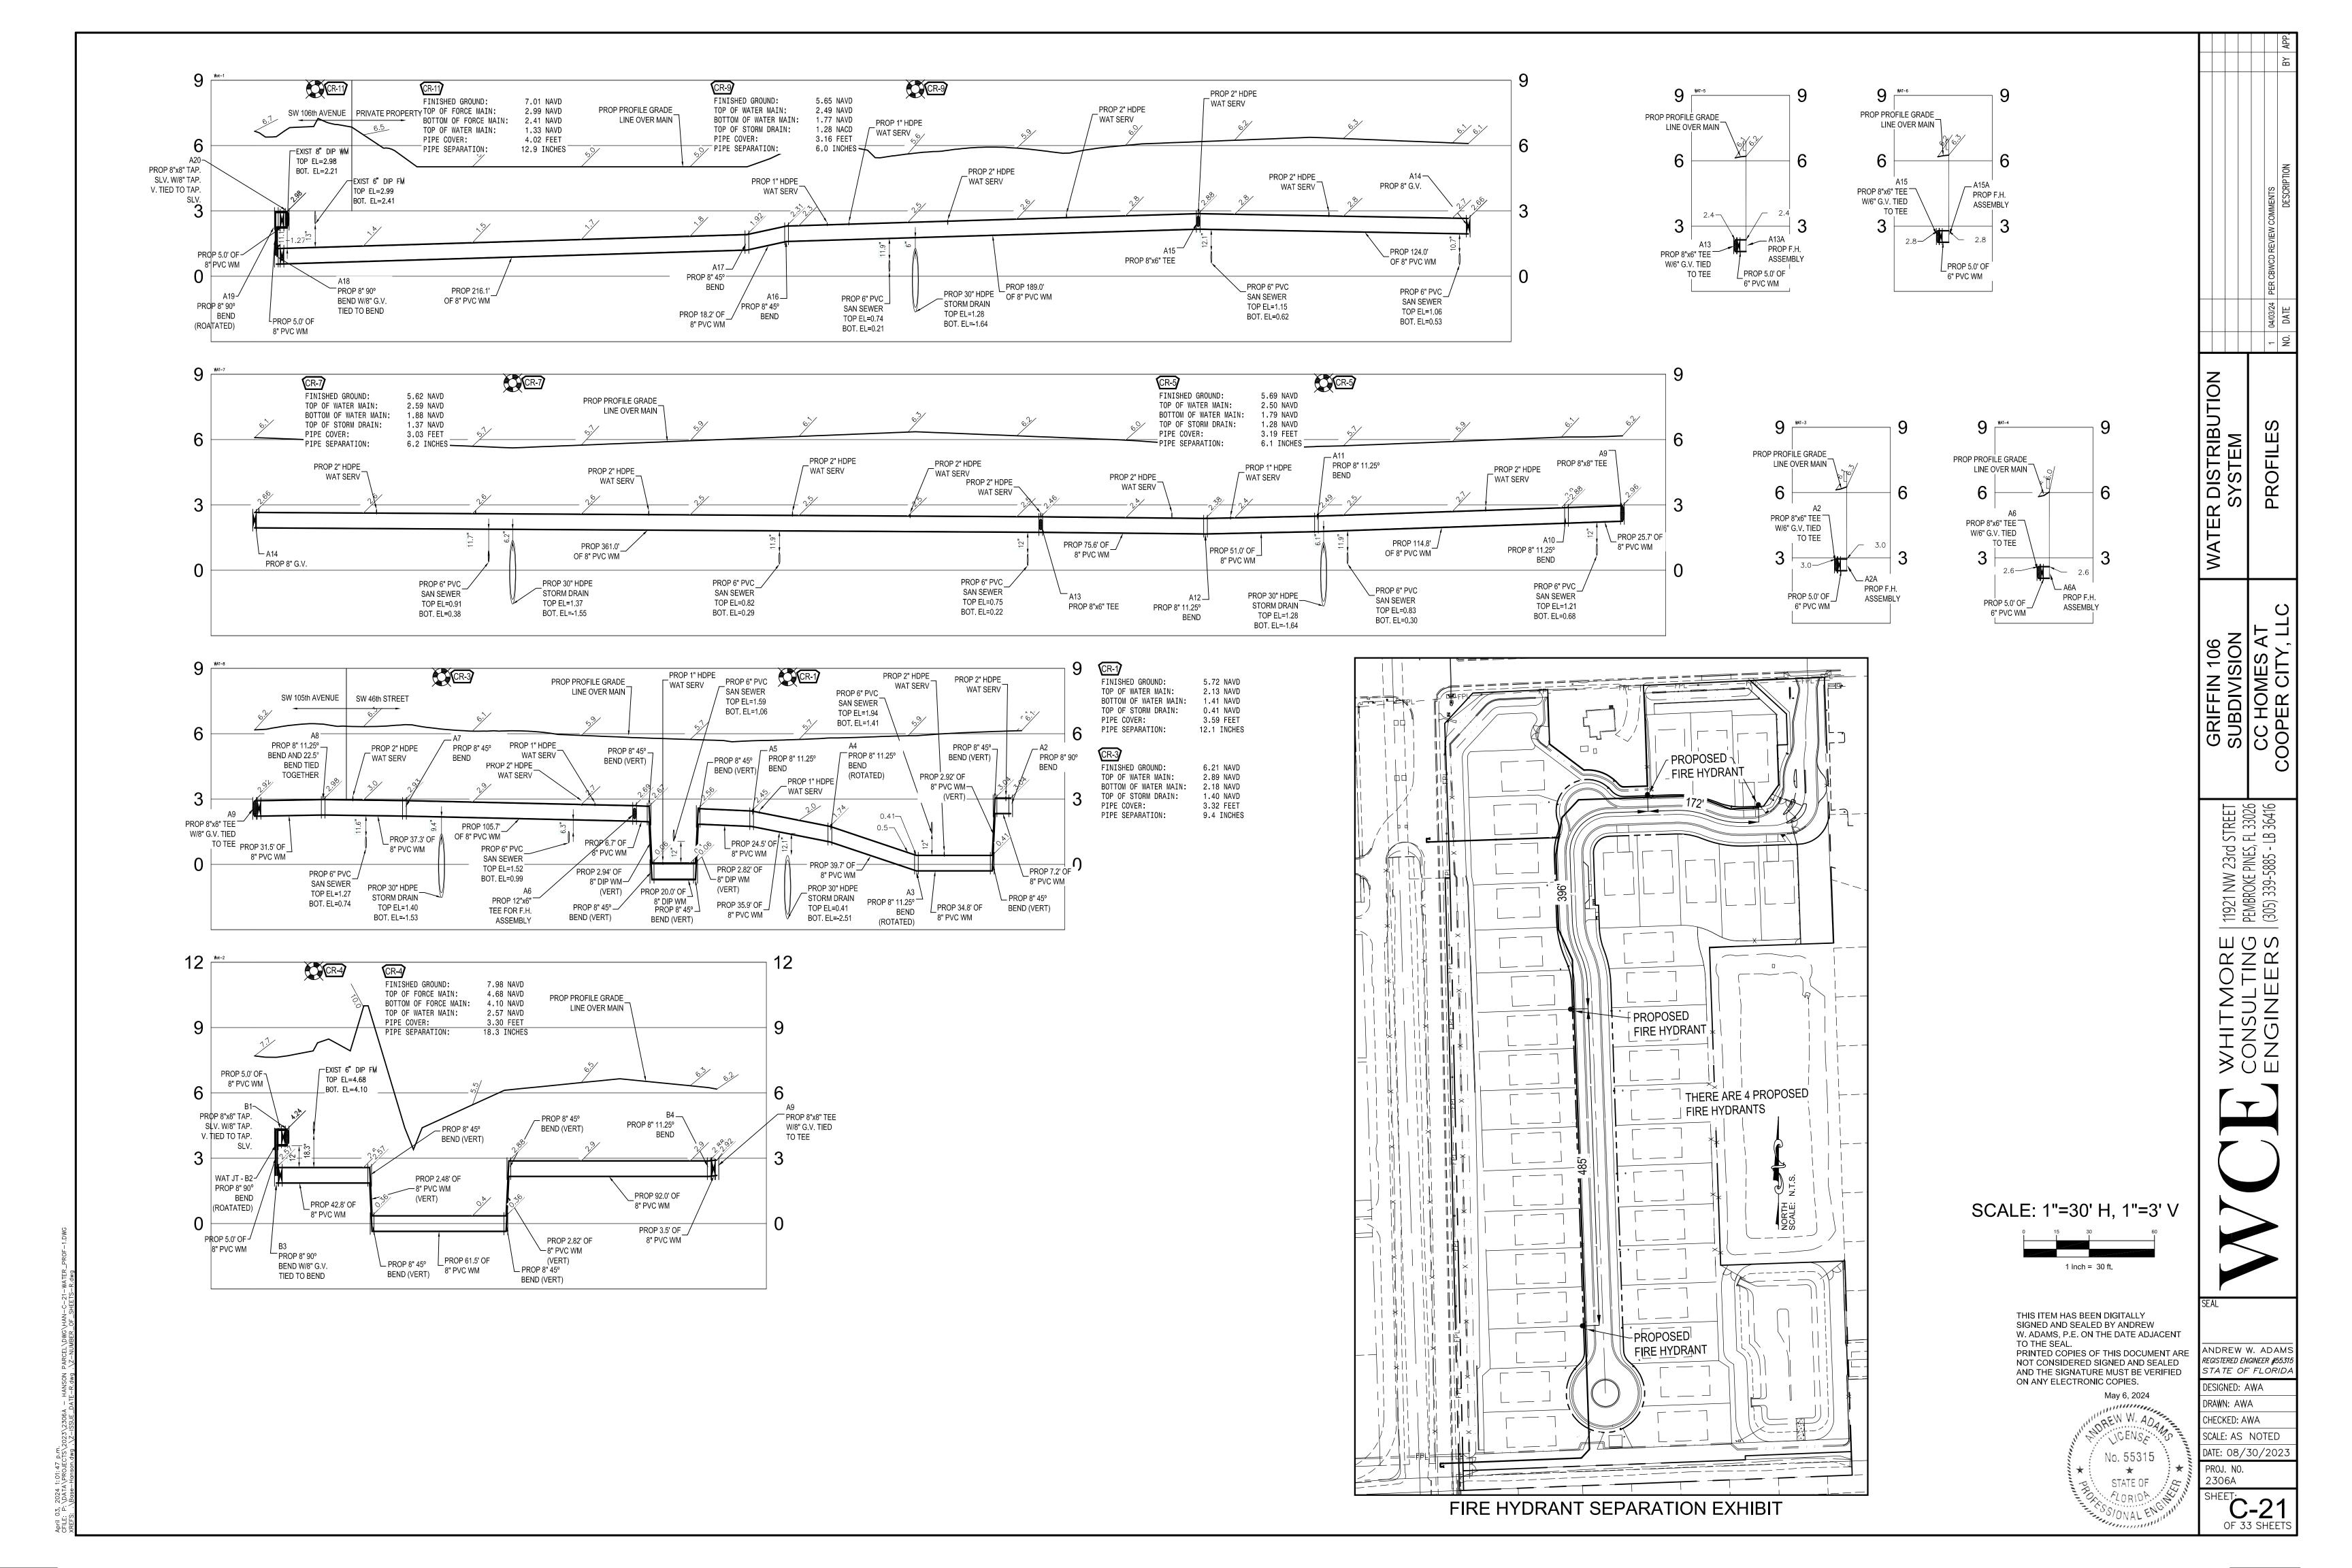


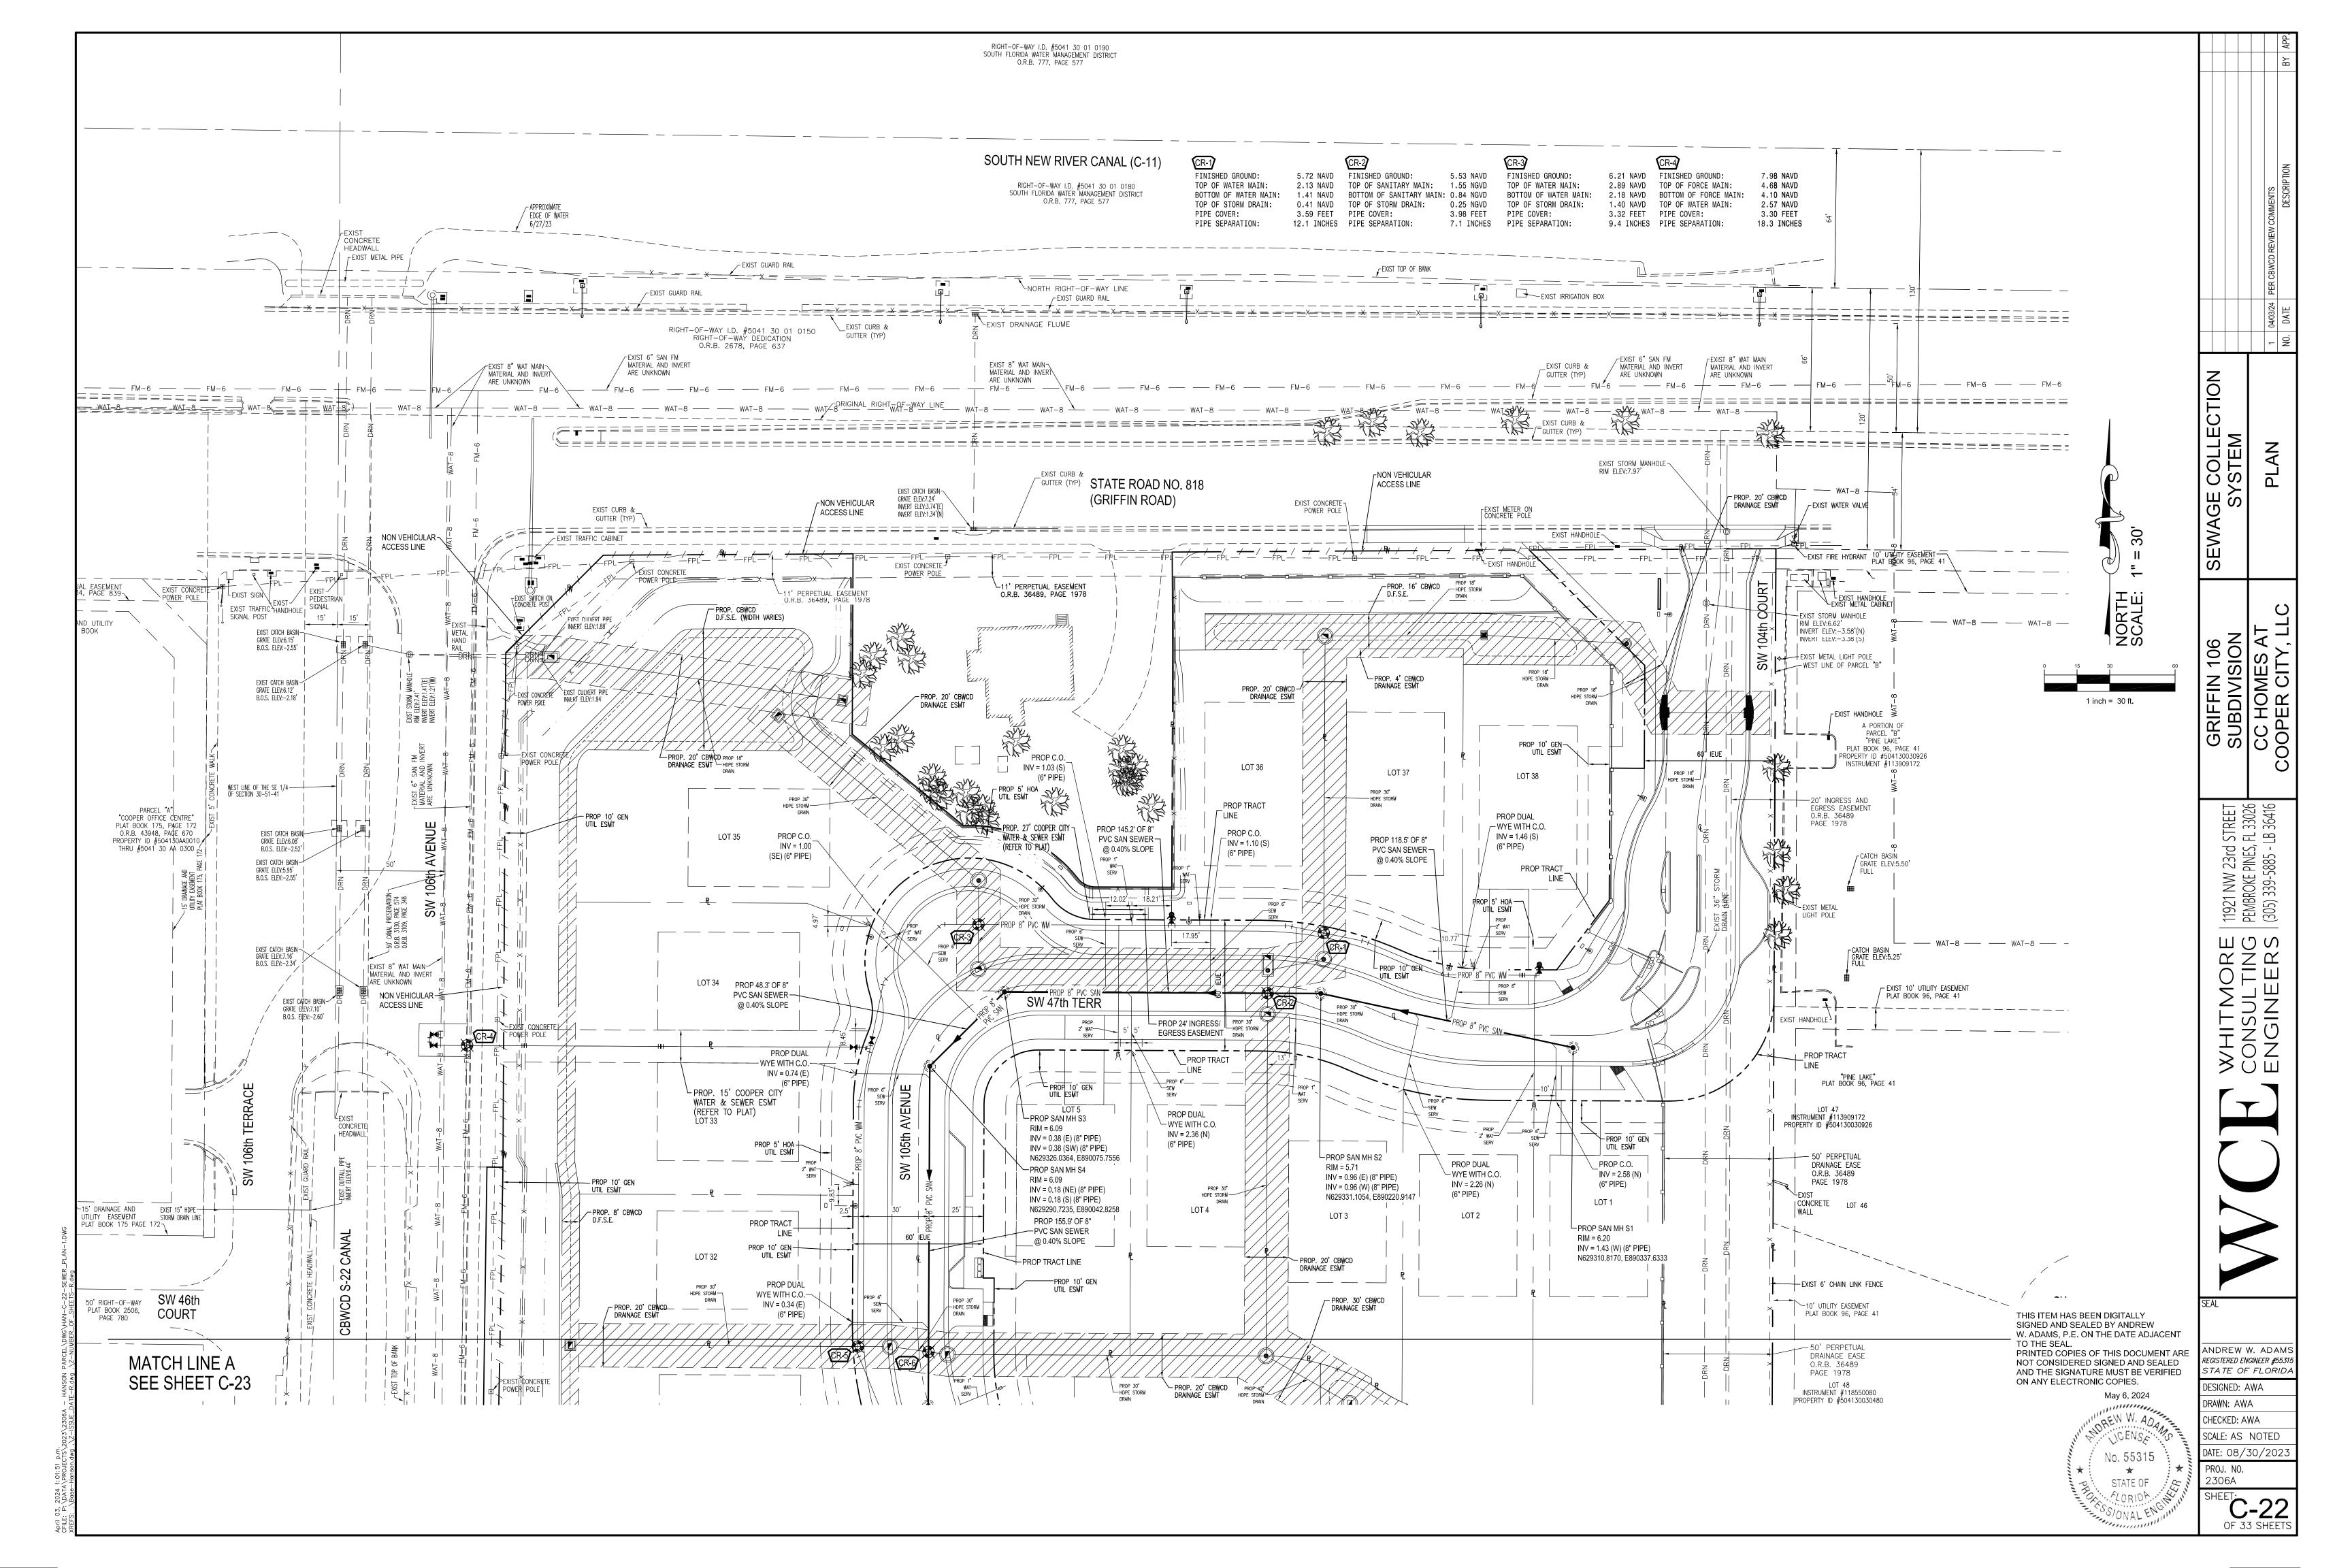


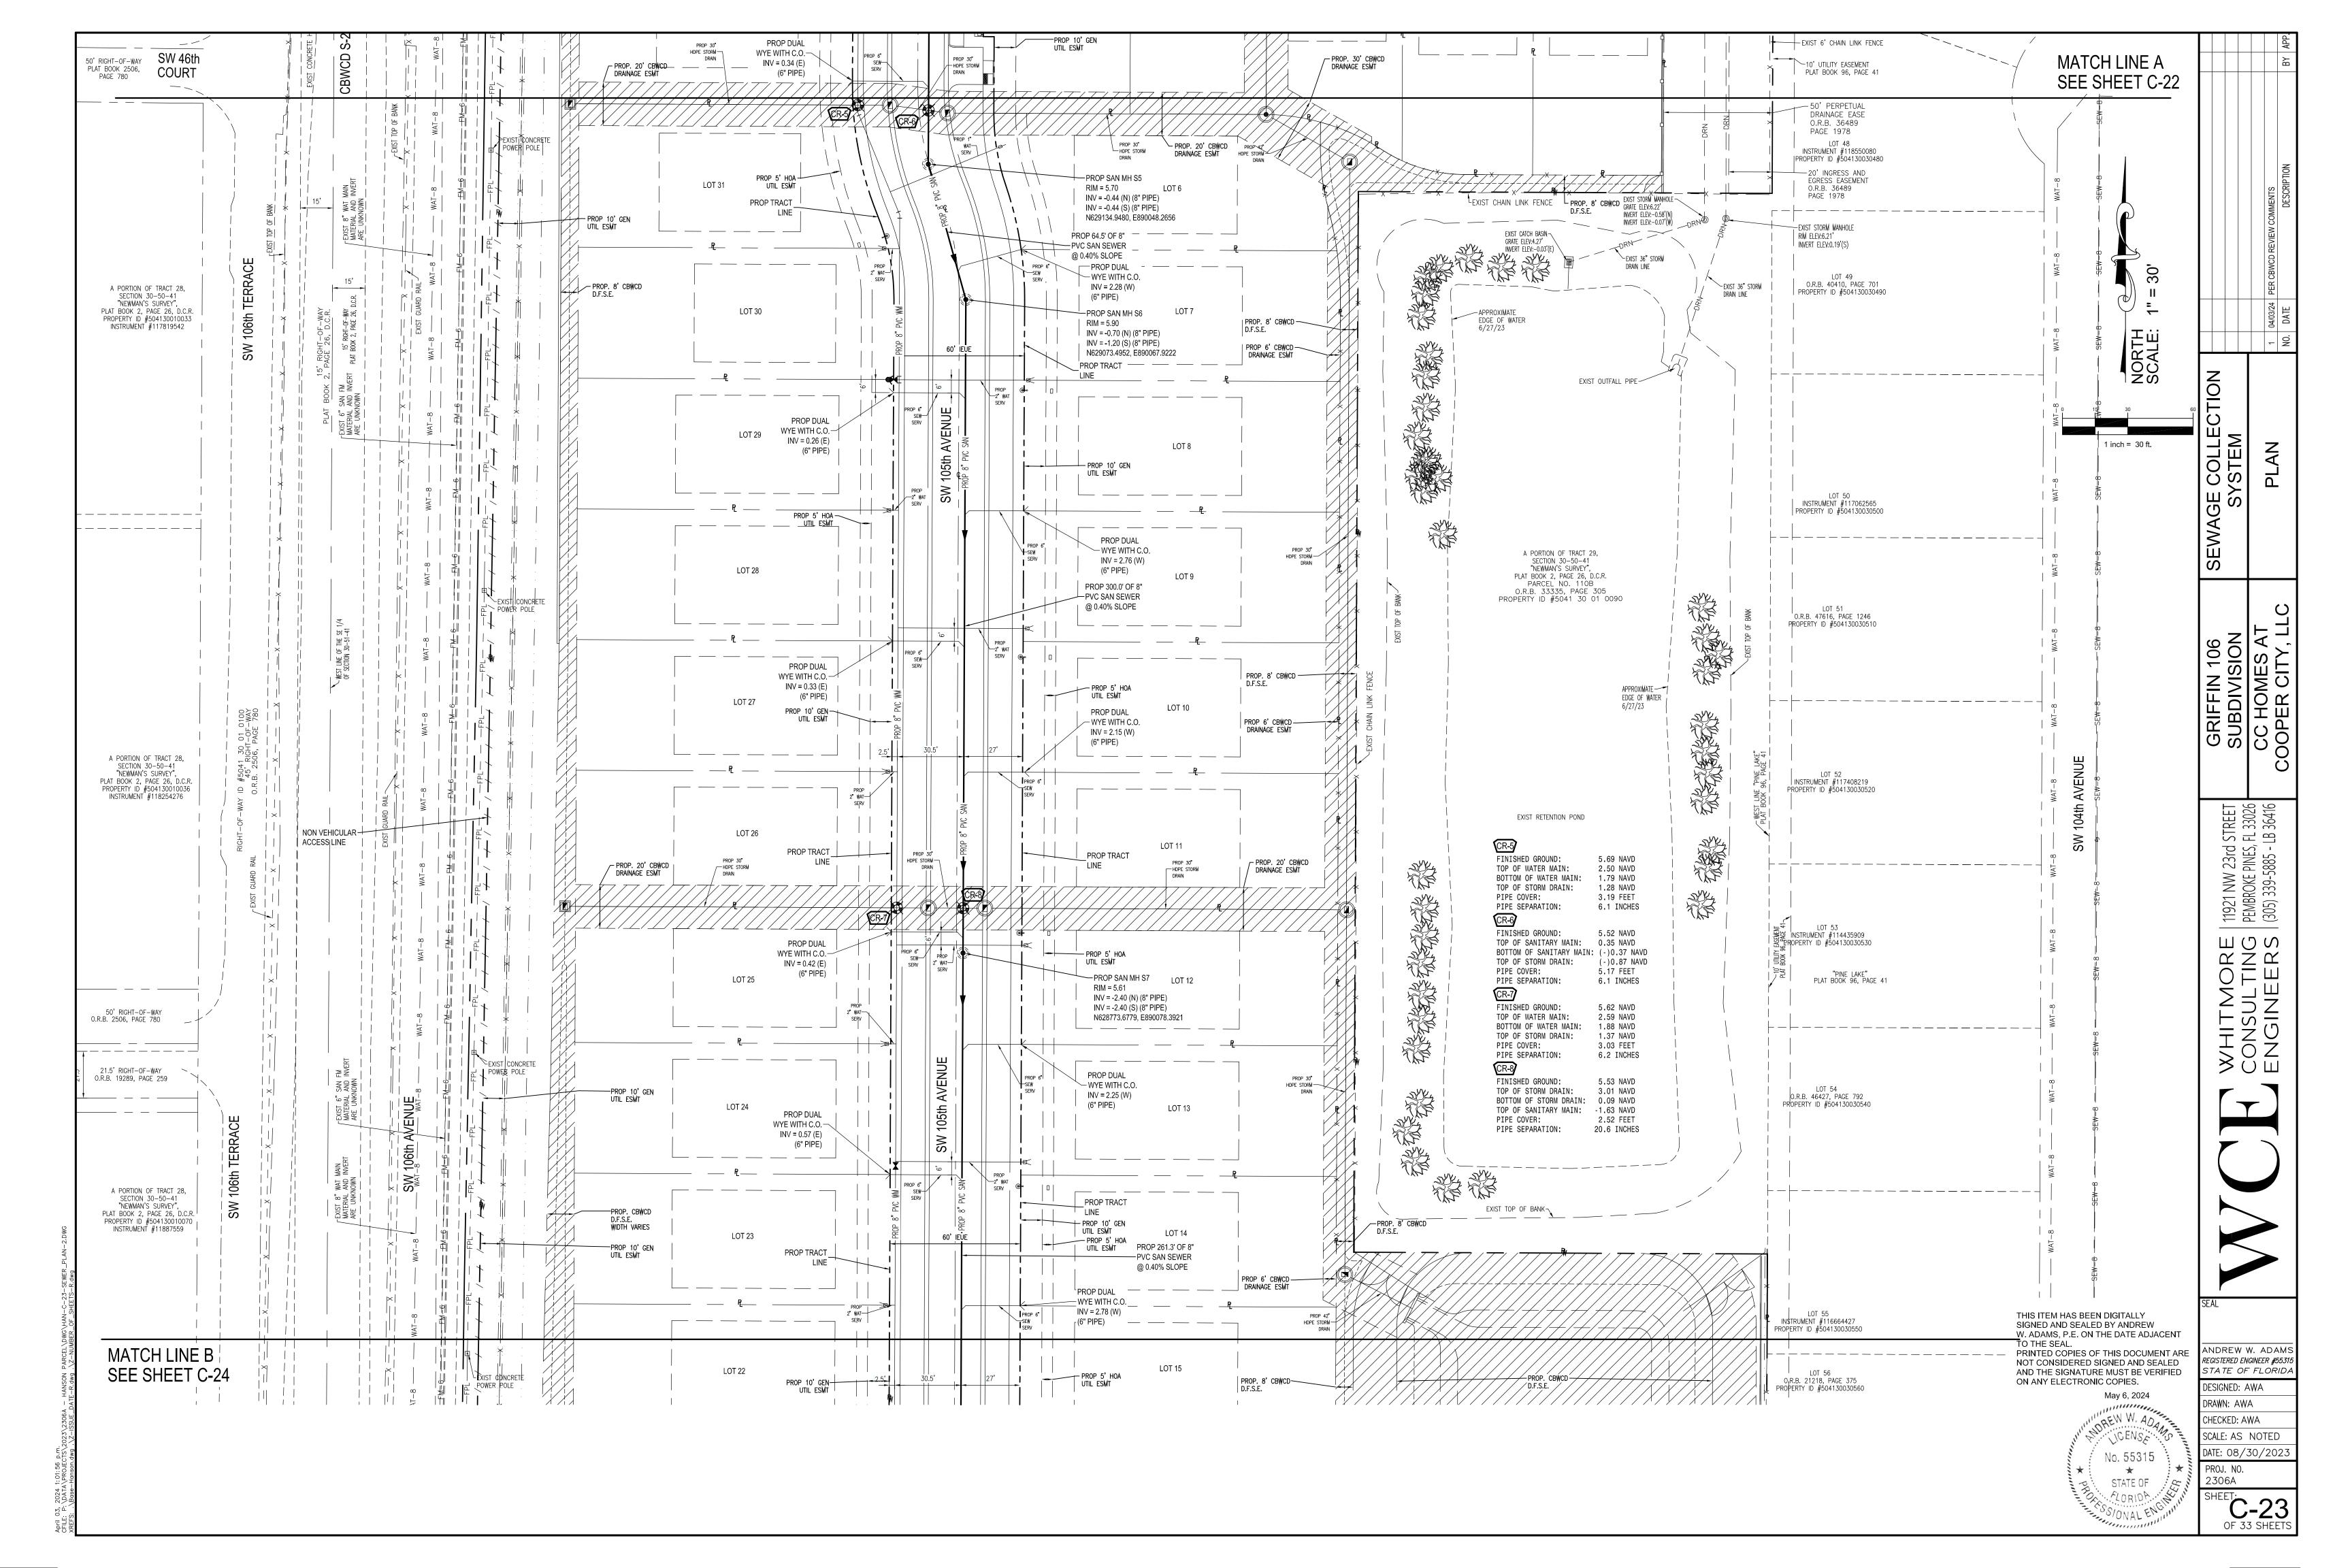

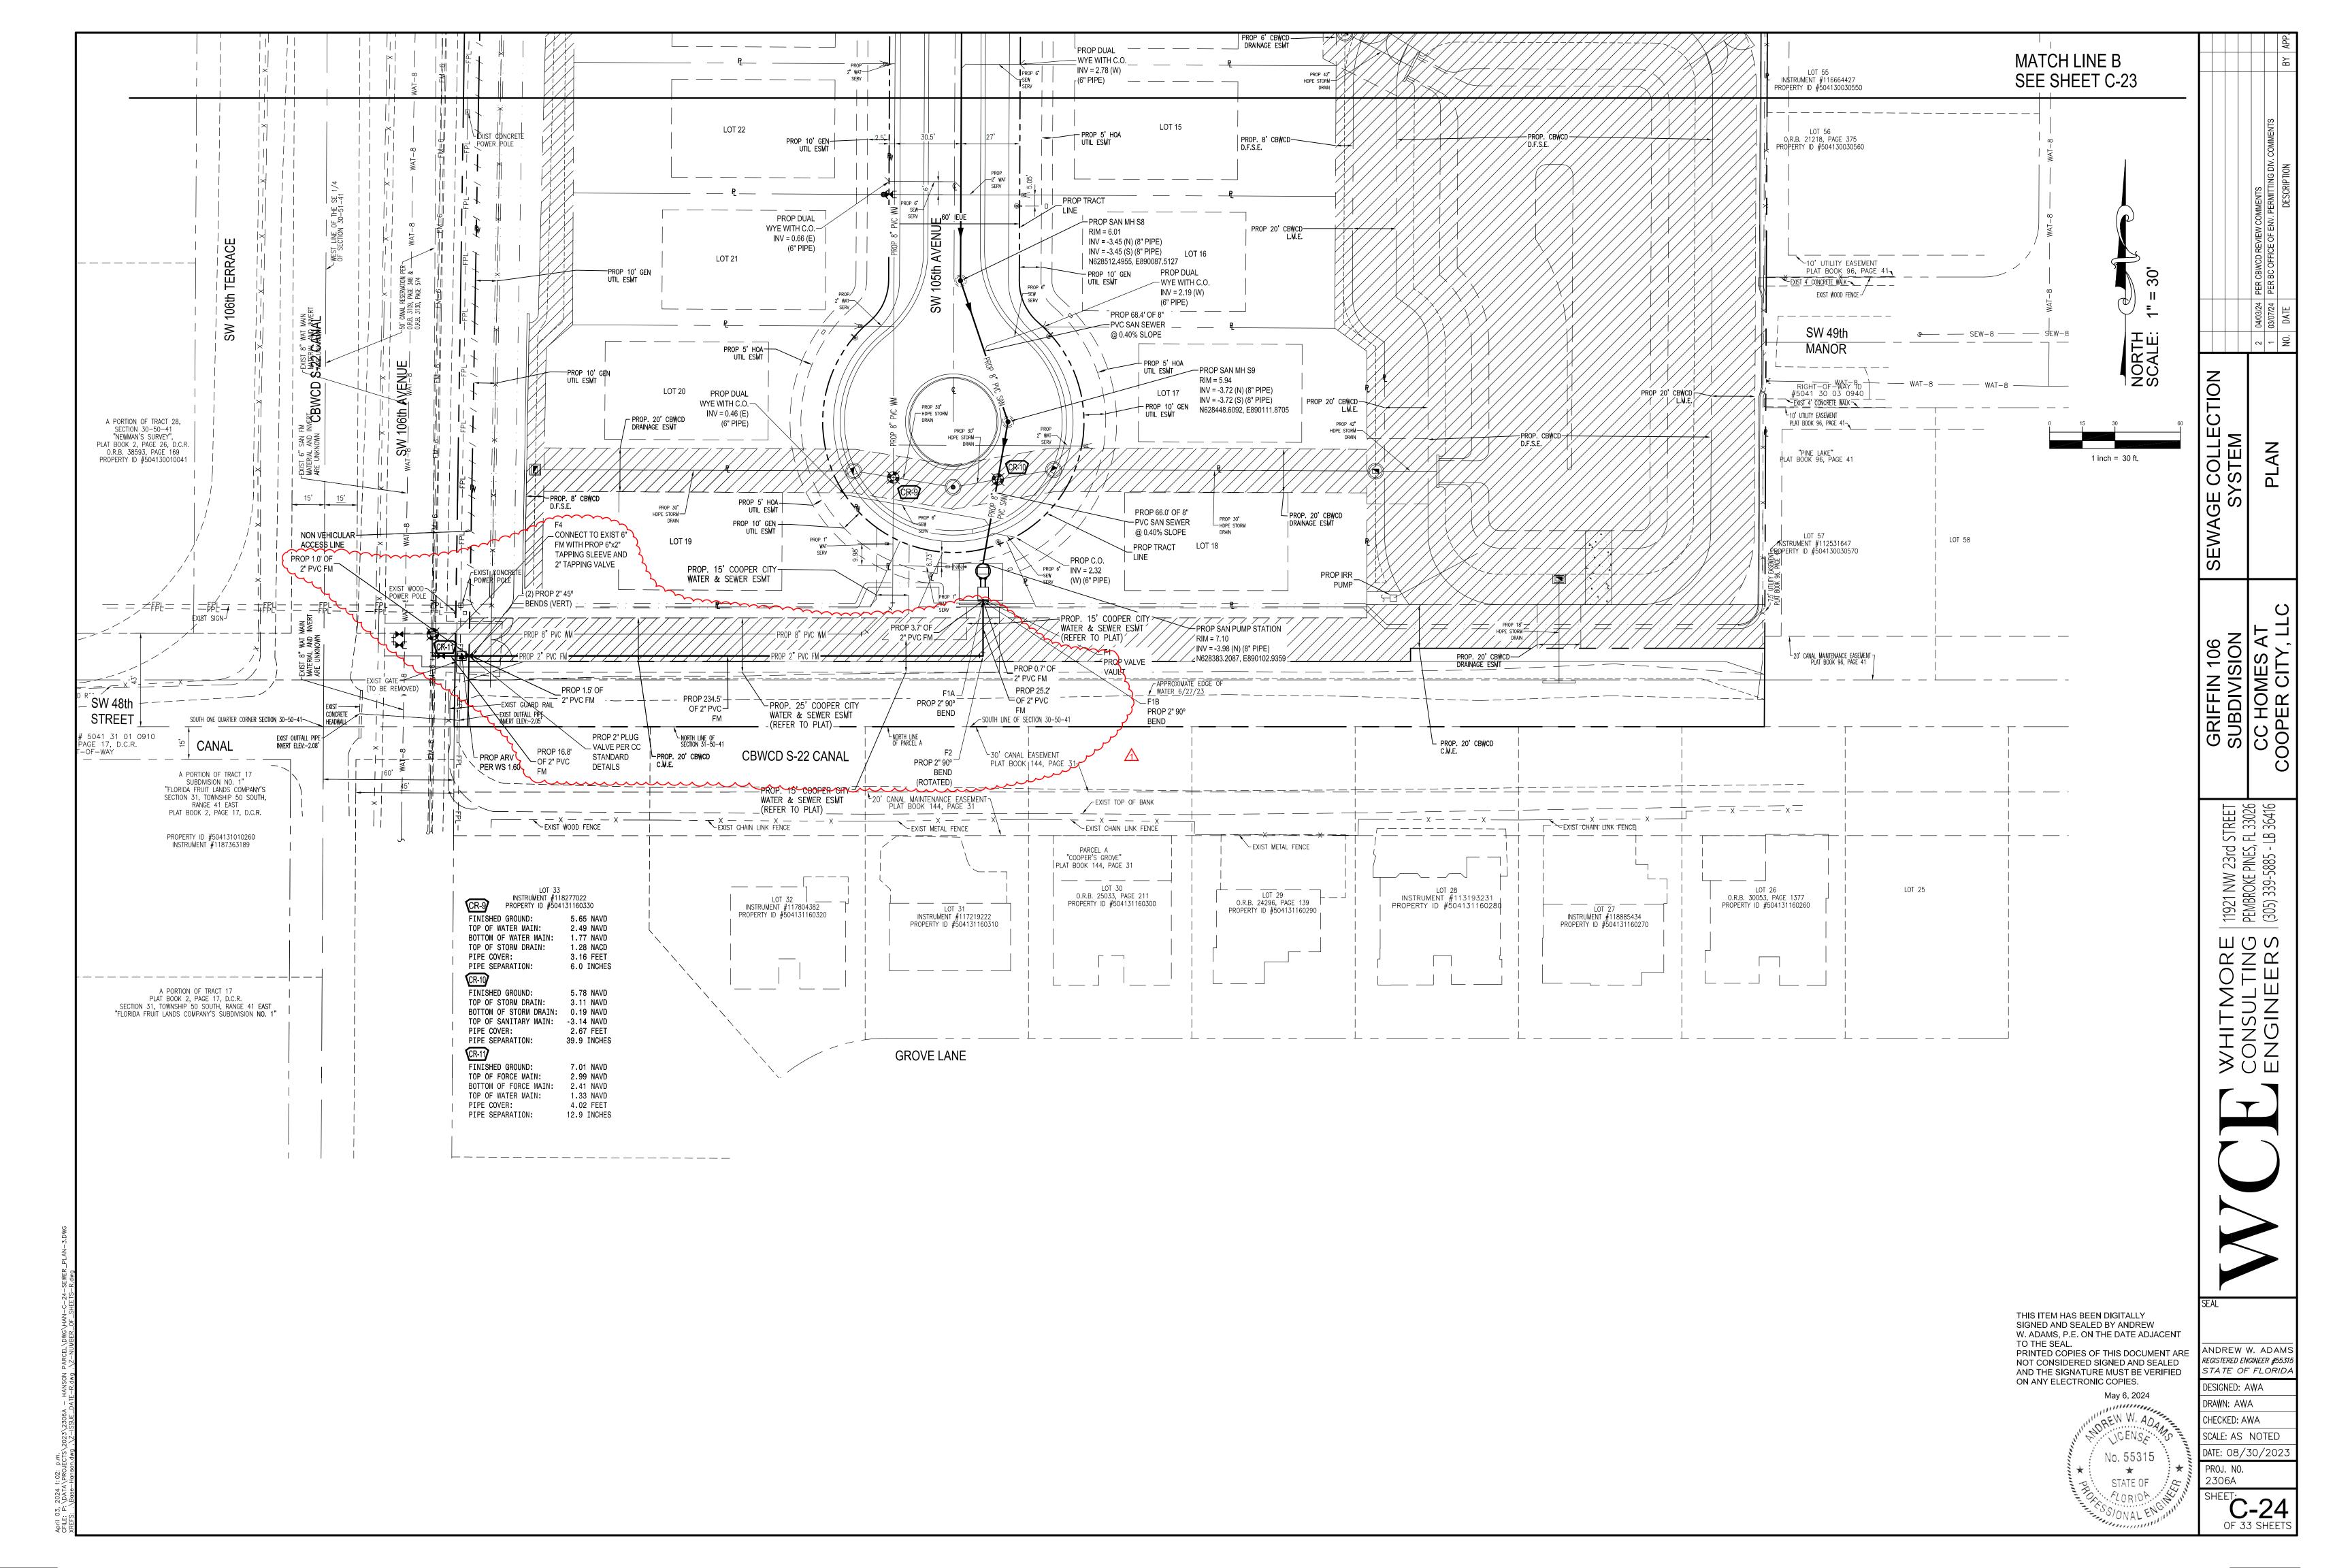


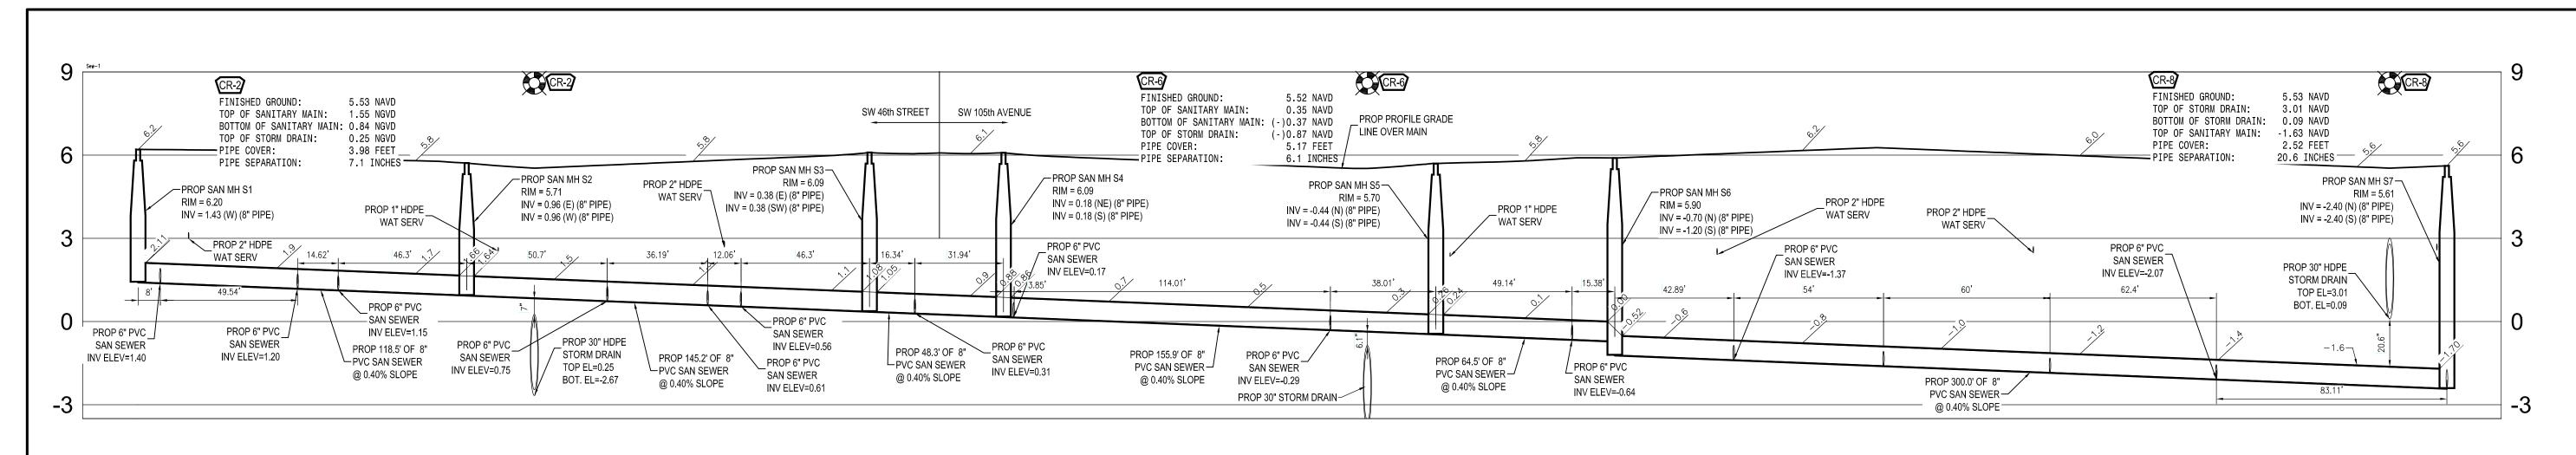

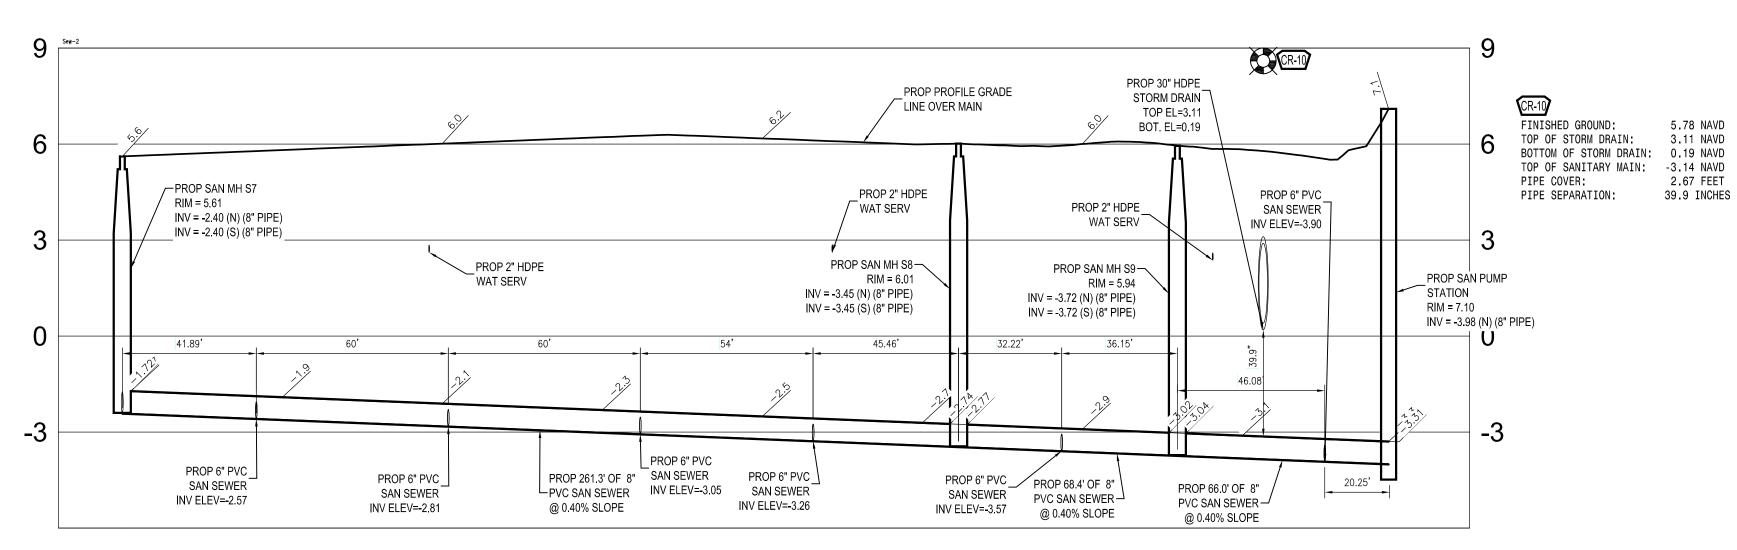

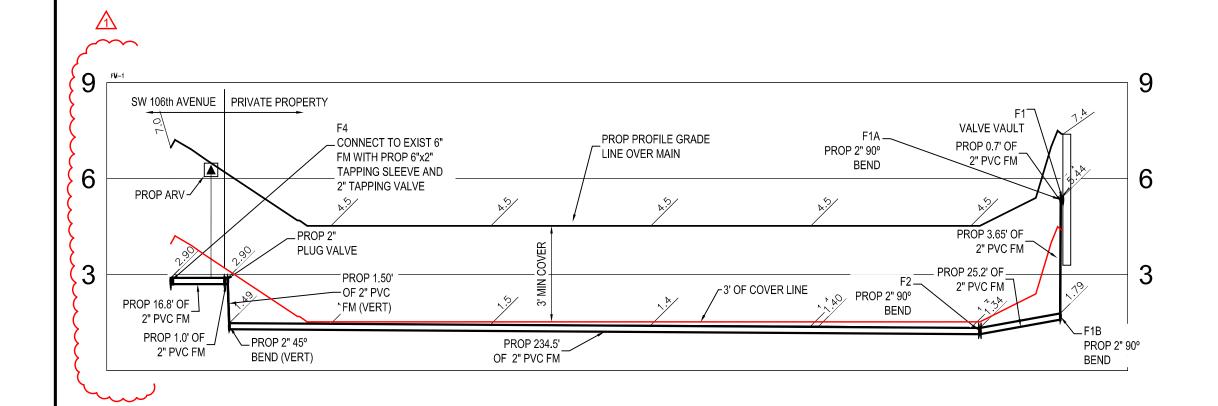

SCALE: 1"=30' H, 1"=3' V

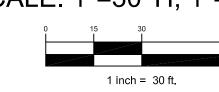

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May 6, 2024

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May 6, 2024

Mo. 55315

STATE OF

DESIGNED: AWA

DRAWN: AWA

CHECKED: AWA

SCALE: AS NOTED

DATE: 08/30/2023

PROJ. NO.
2306A

SHEET:

ANDREW W. ADAMS

REGISTERED ENGINEER #55315

EWAGE COLLECTION SYSTEM


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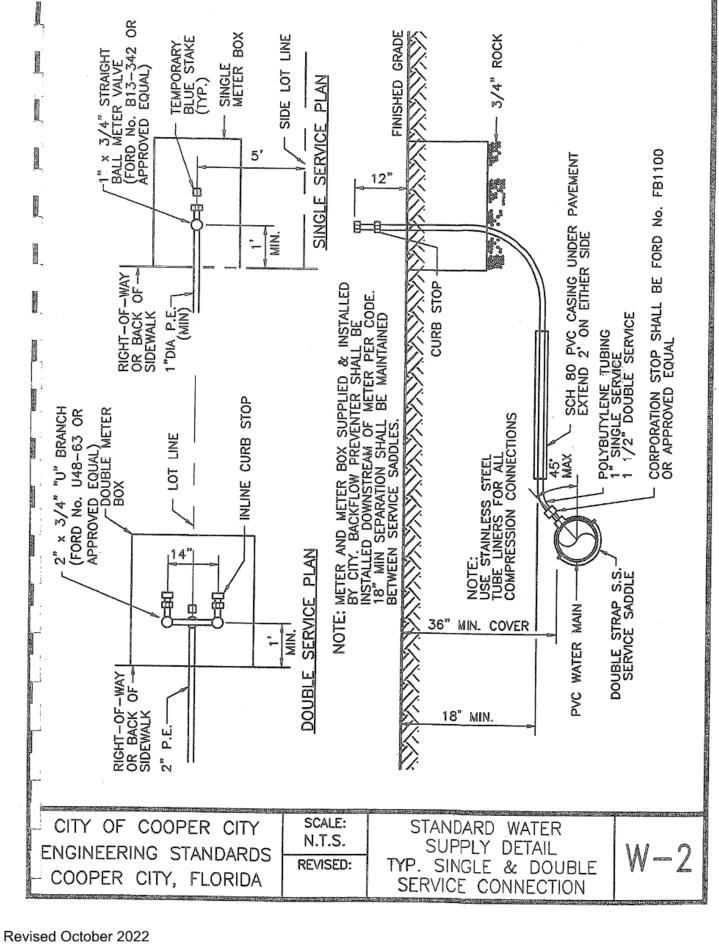
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PROFILES

SHEET: C-25 OF 33 SHEETS





OF THE NEAREST ROADWAY LANE ADJACENT TO ALL FIRE HYDRANT LOCATIONS.

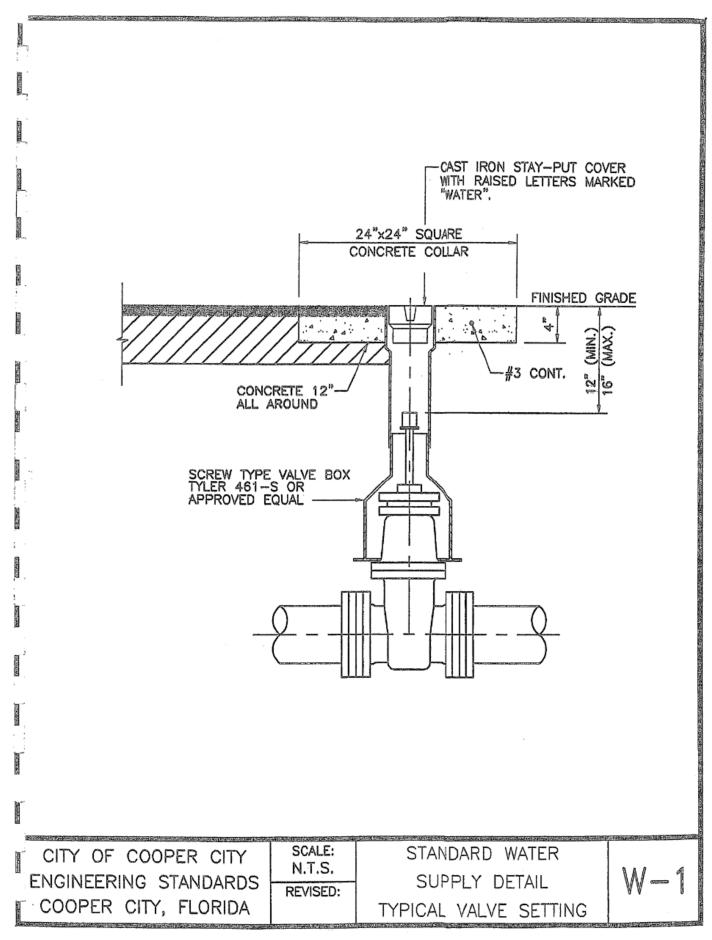
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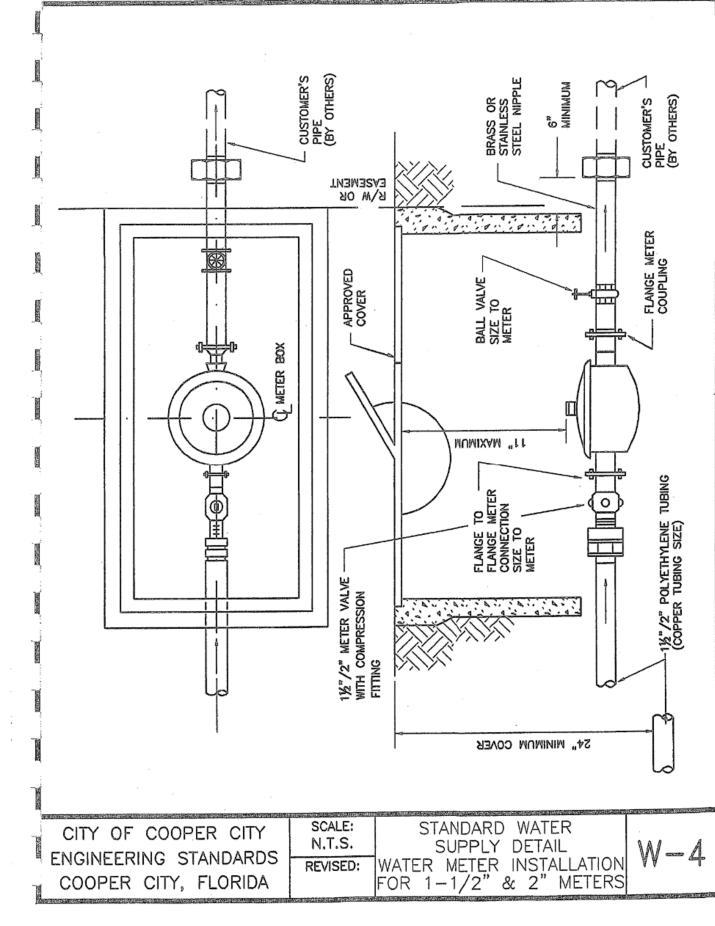
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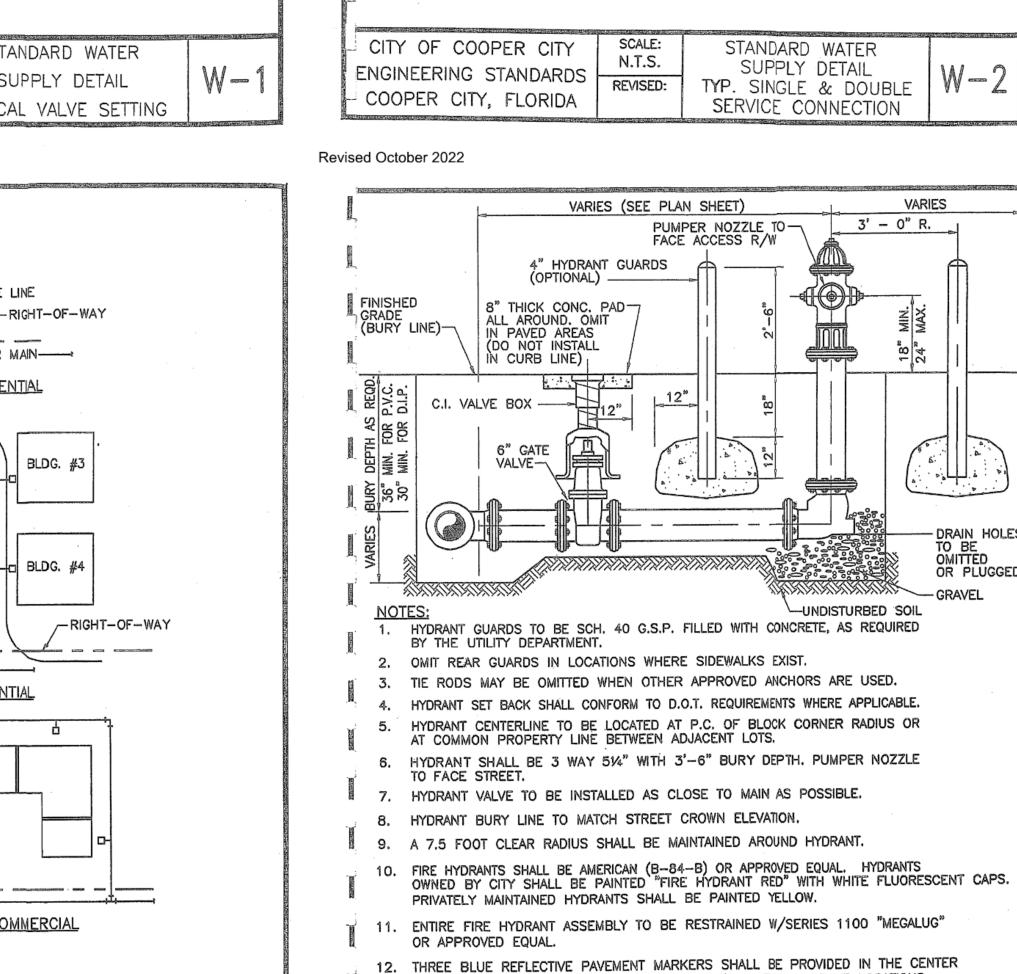
STANDARD WATER

SUPPLY DETAIL

FIRE HYDRANT DETAIL






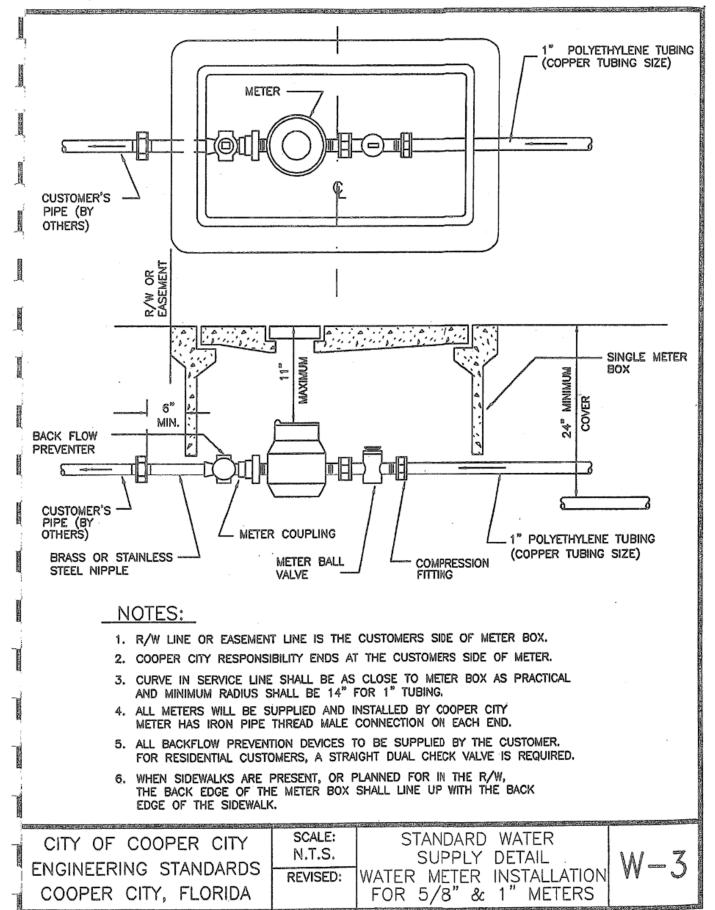



CITY OF COOPER CITY

ENGINEERING STANDARDS

COOPER CITY, FLORIDA

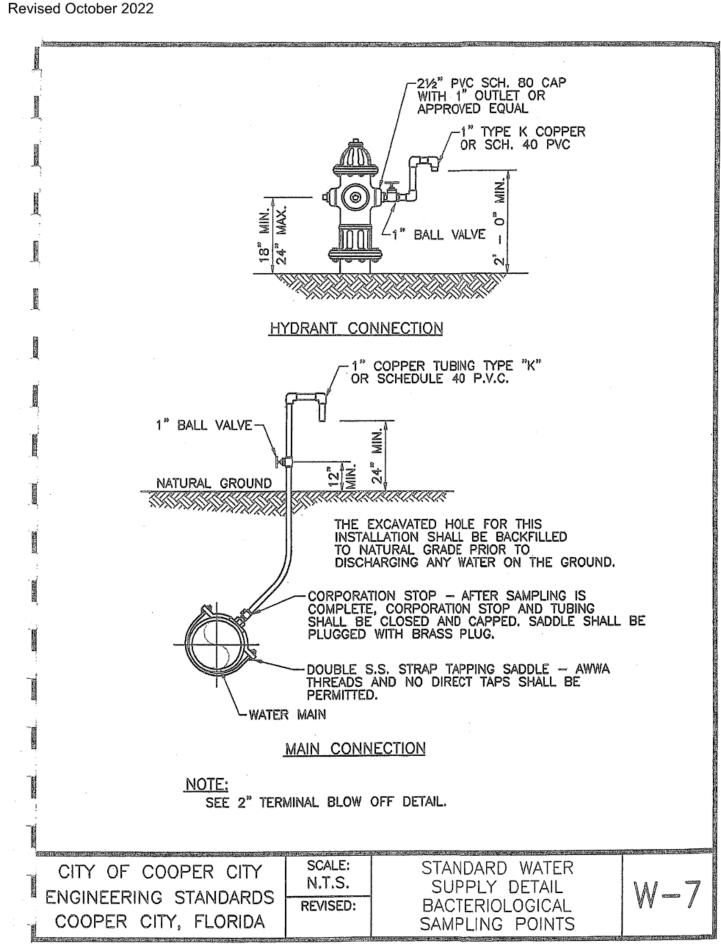

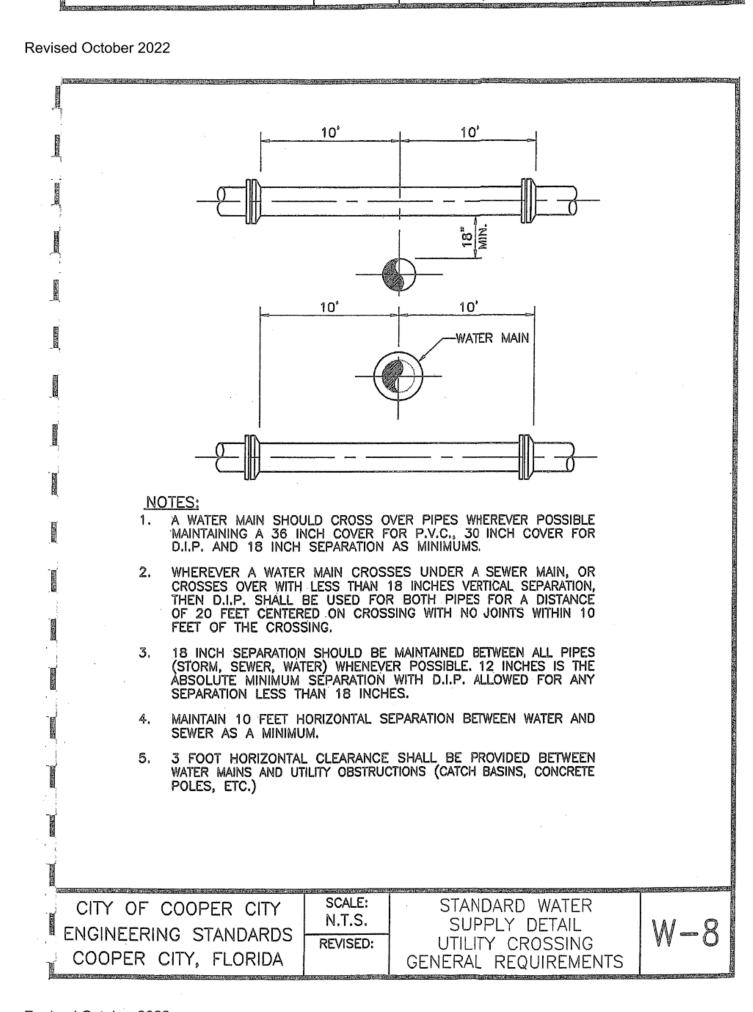

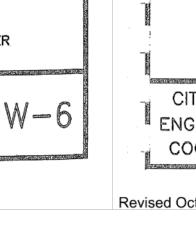

DRAIN HOLES

OR PLUGGED

Revised October 2022

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May 6, 2024 SREW W. ADD CENSE"

DETAIL

STANDARD

/ 23rd : PINES, 5885 -

INW ROKE 339-5

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M Z M

ANDREW W. ADAMS REGISTERED ENGINEER #55315 STATE OF FLORIDA

DESIGNED: AWA

DRAWN: AWA

CHECKED: AWA

PROJ. NO.

2306A

SCALE: AS NOTED

DATE: 08/30/2023

C-26

OF 33 SHEETS

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COOPER CITY, FLORIDA

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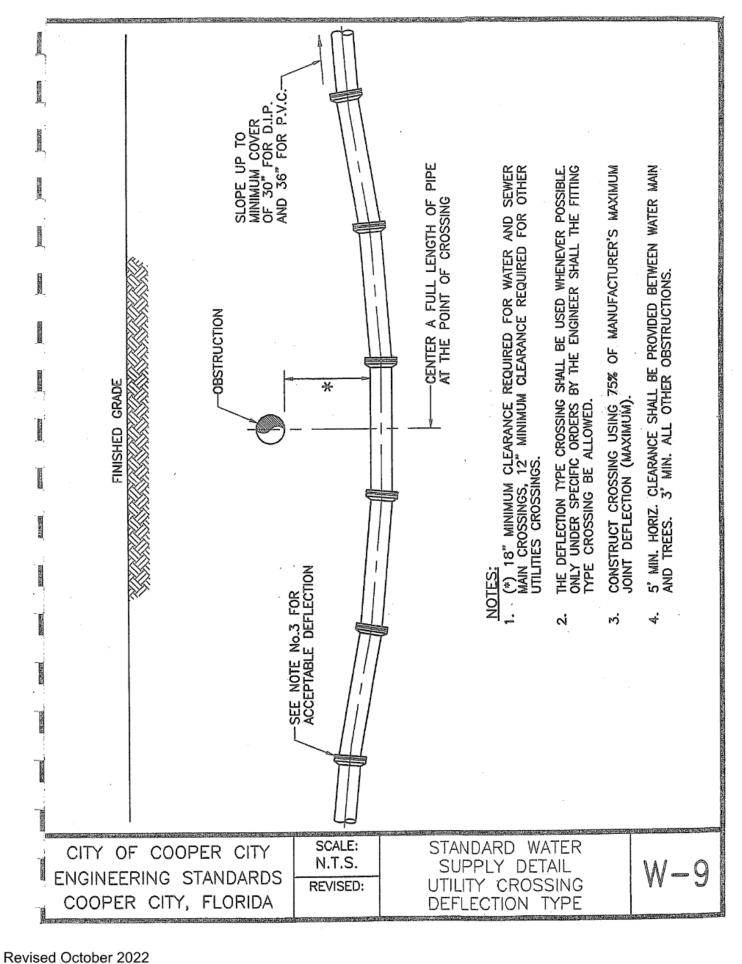
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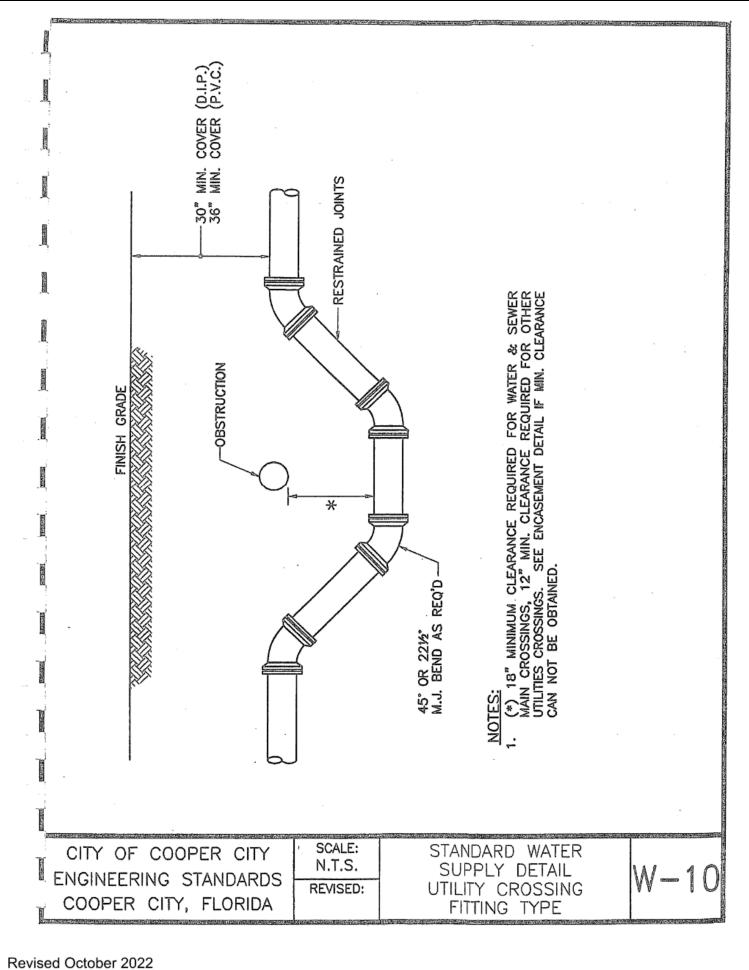
BLDG. ---SERVICE LINE WATER METER -₩ATER MAIN----SINGLE FAMILY RESIDENTIAL BLDG. # WATER METER -(TYP.) —□ BLDG. #4 BLDG. #1 MULTI-FAMILY RESIDENTIAL WATER METER (TYP.)----RIGHT-OF-WAY INDUSTRIAL/OFFICE/COMMERCIAL STANDARD WATER CITY OF COOPER CITY N.T.S. SUPPLY DETAIL W-5ENGINEERING STANDARDS REVISED:


WATER METER


LOCATIONS


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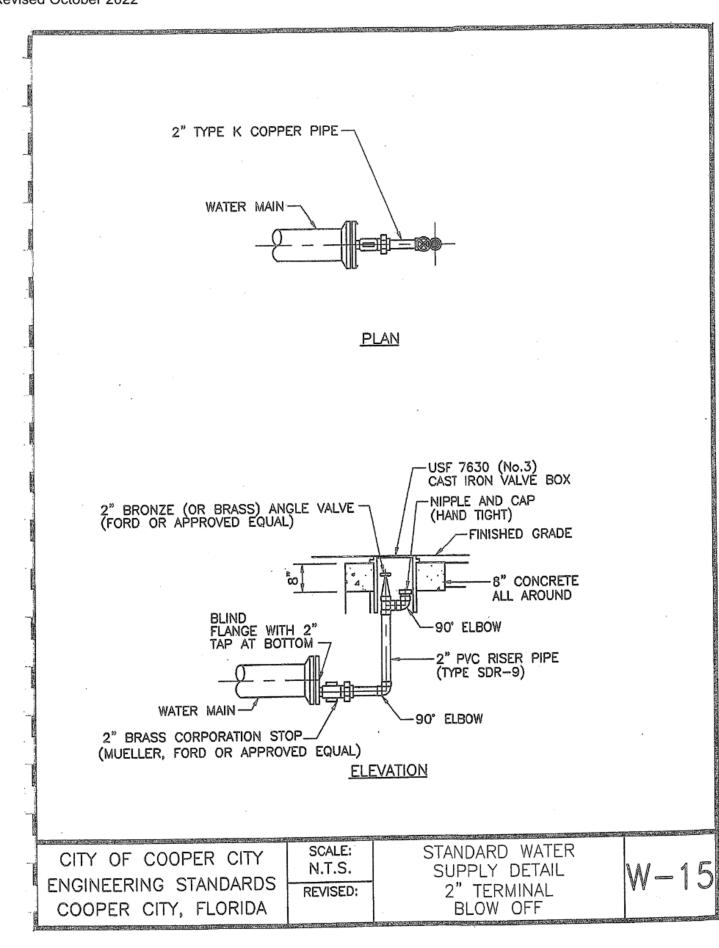



RESTRAINED JOINT DETAIL


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DETAIL

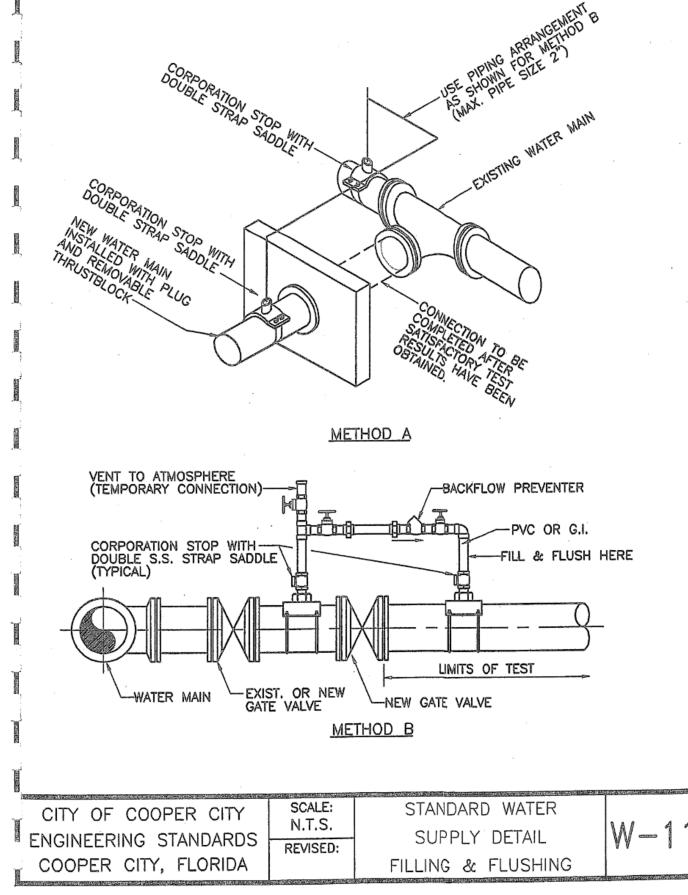STANDARD

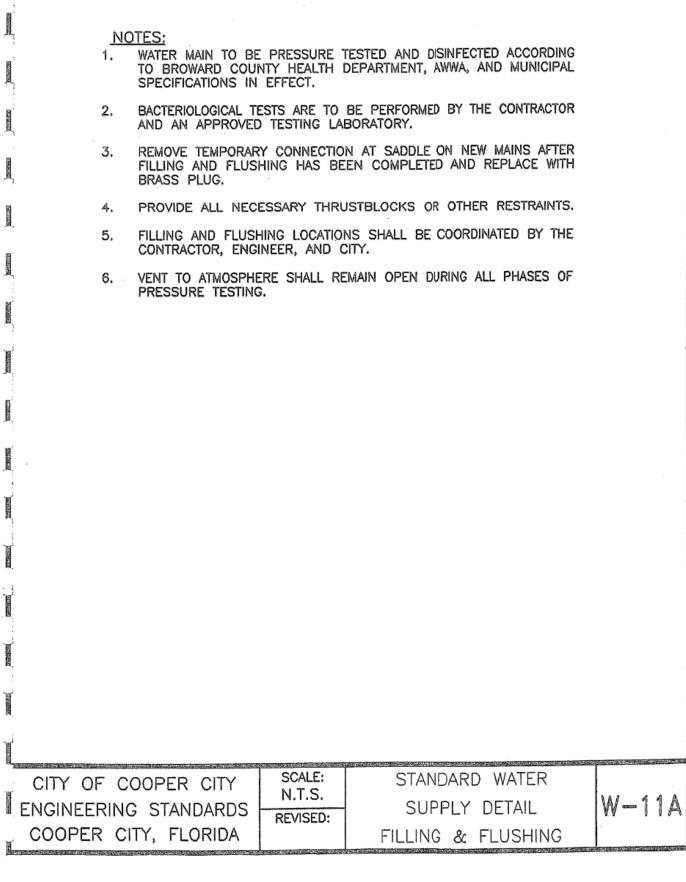:ET 026 416

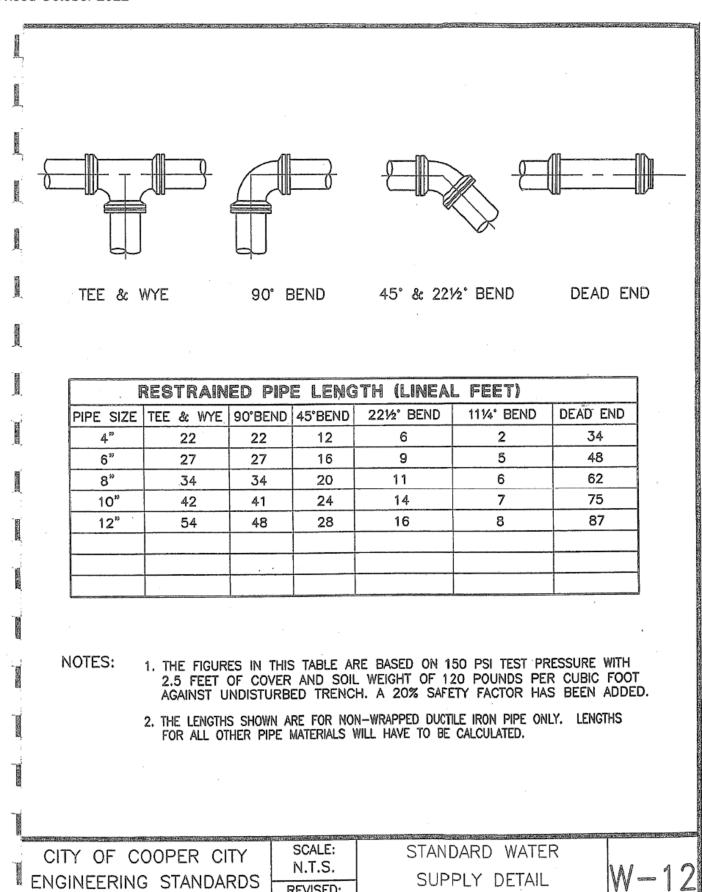S F B

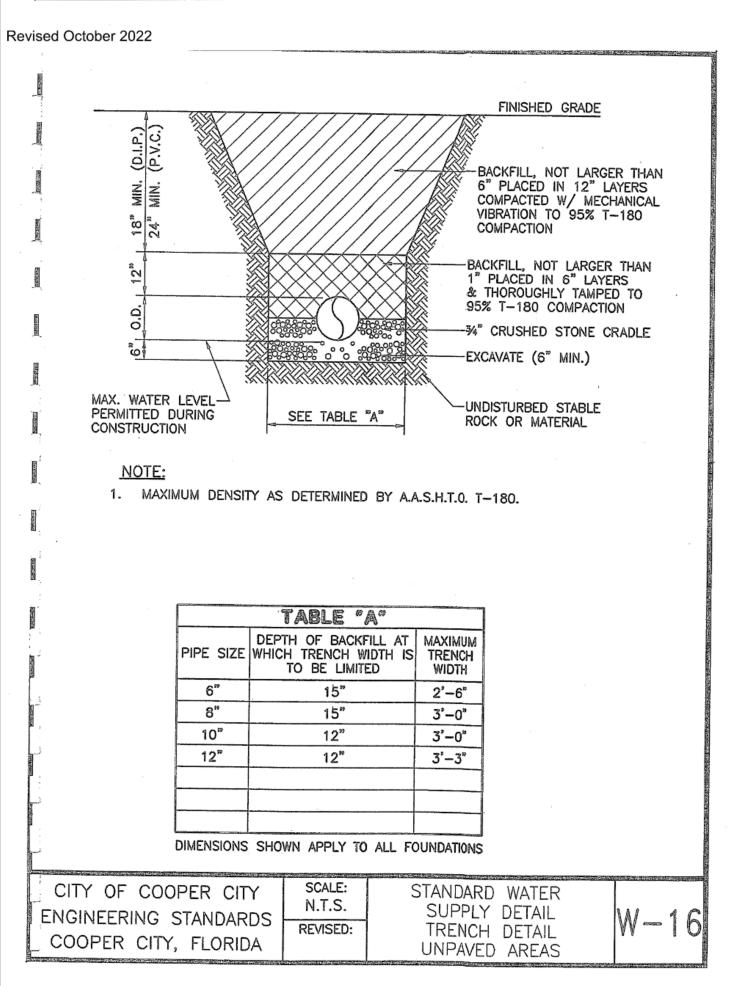/ 23rd E PINES, 5885 -

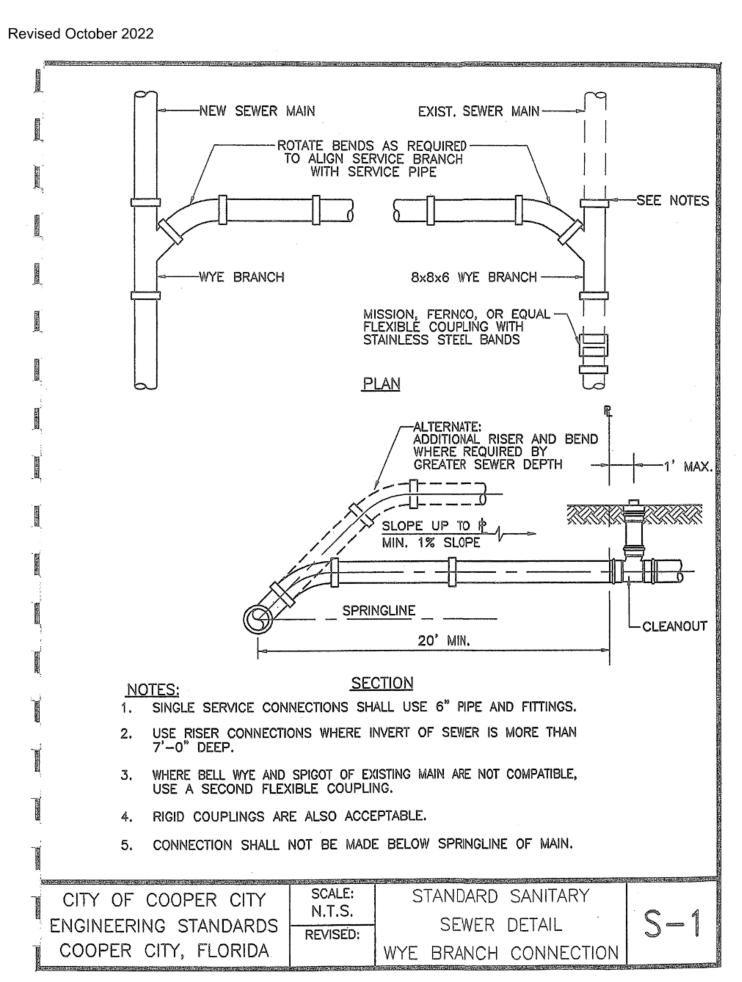NW ROKE 339-5

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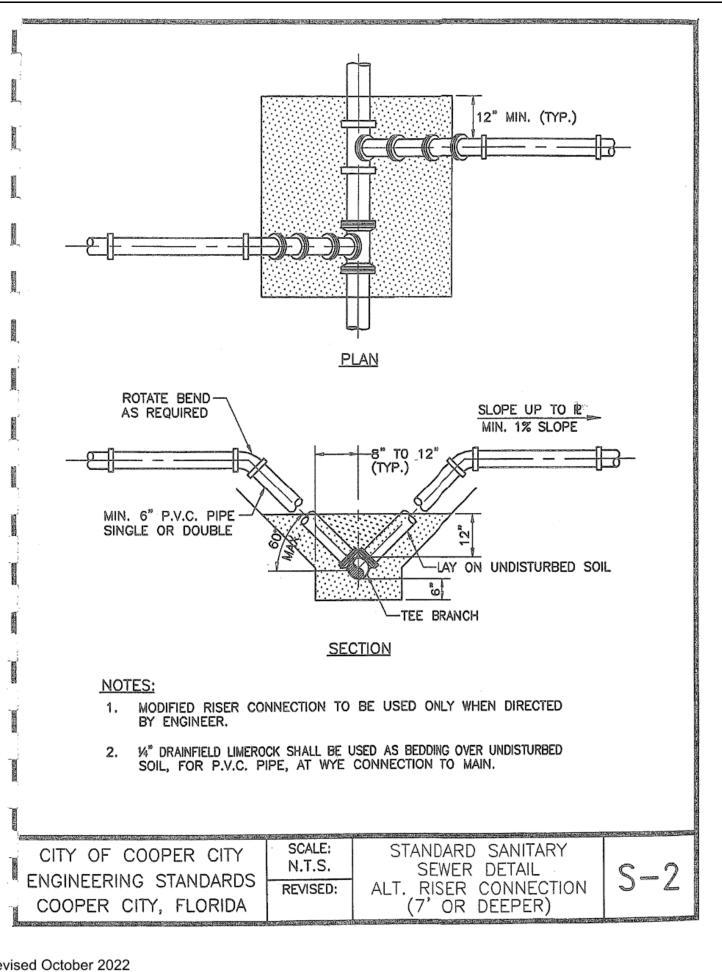
ANDREW W. ADAMS REGISTERED ENGINEER #55315 STATE OF FLORIDA


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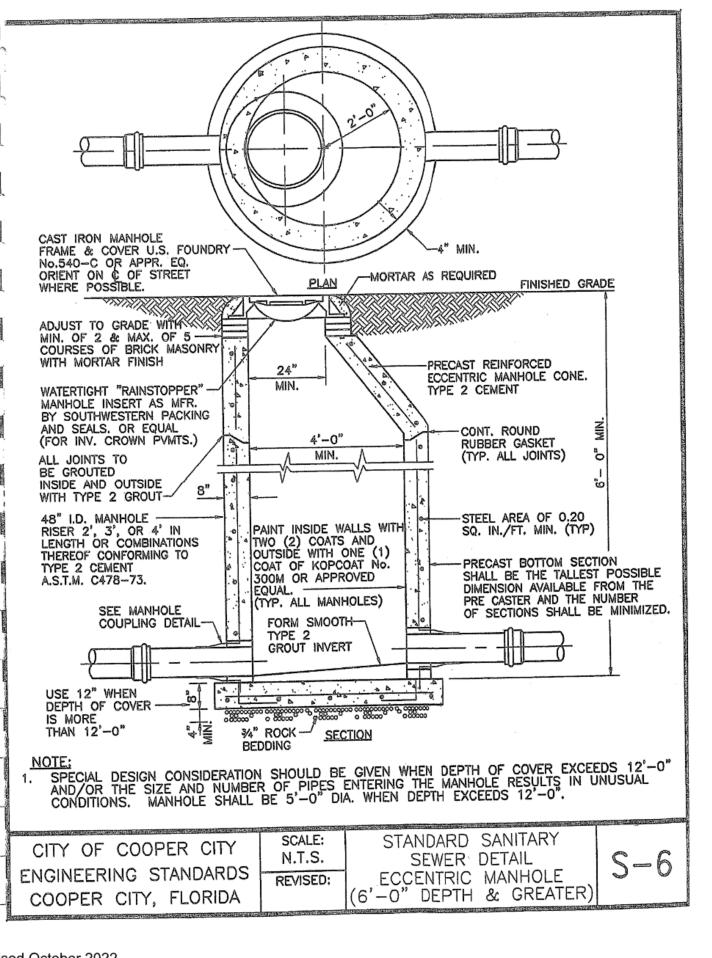
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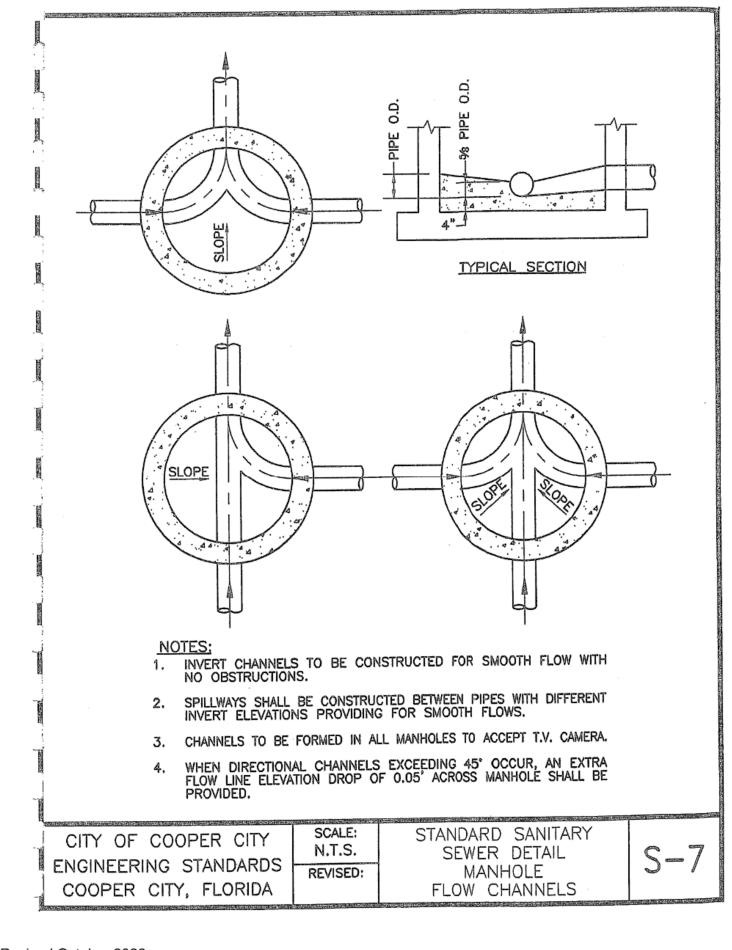
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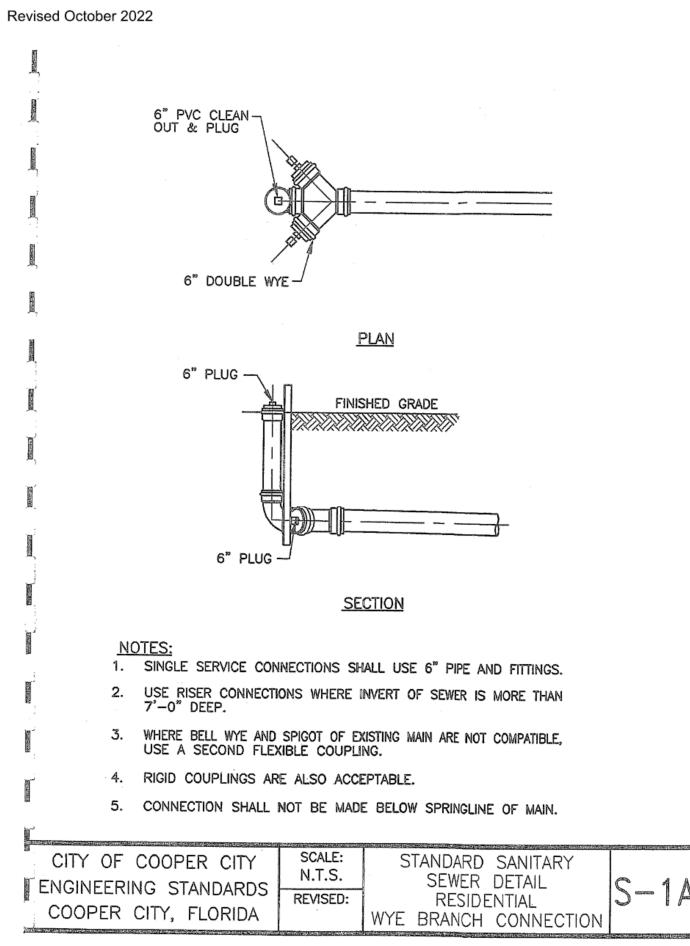
OF 33 SHEETS











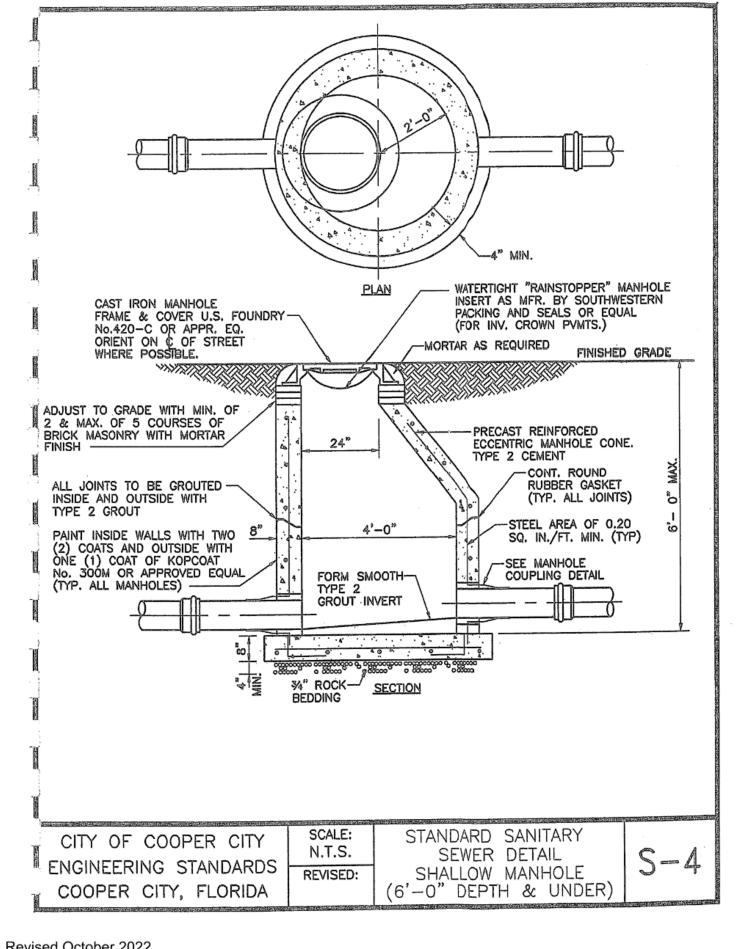


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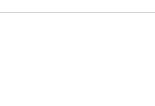

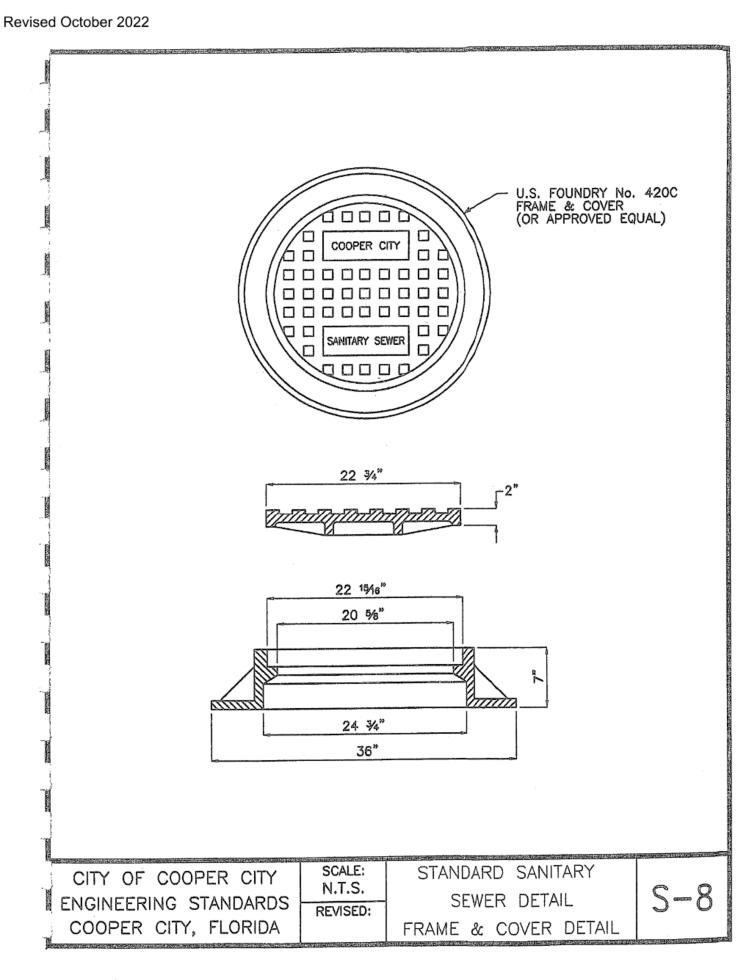
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2306A C-28 OF 33 SHEETS

ANDREW W. ADAMS REGISTERED ENGINEER #55315 STATE OF FLORIDA

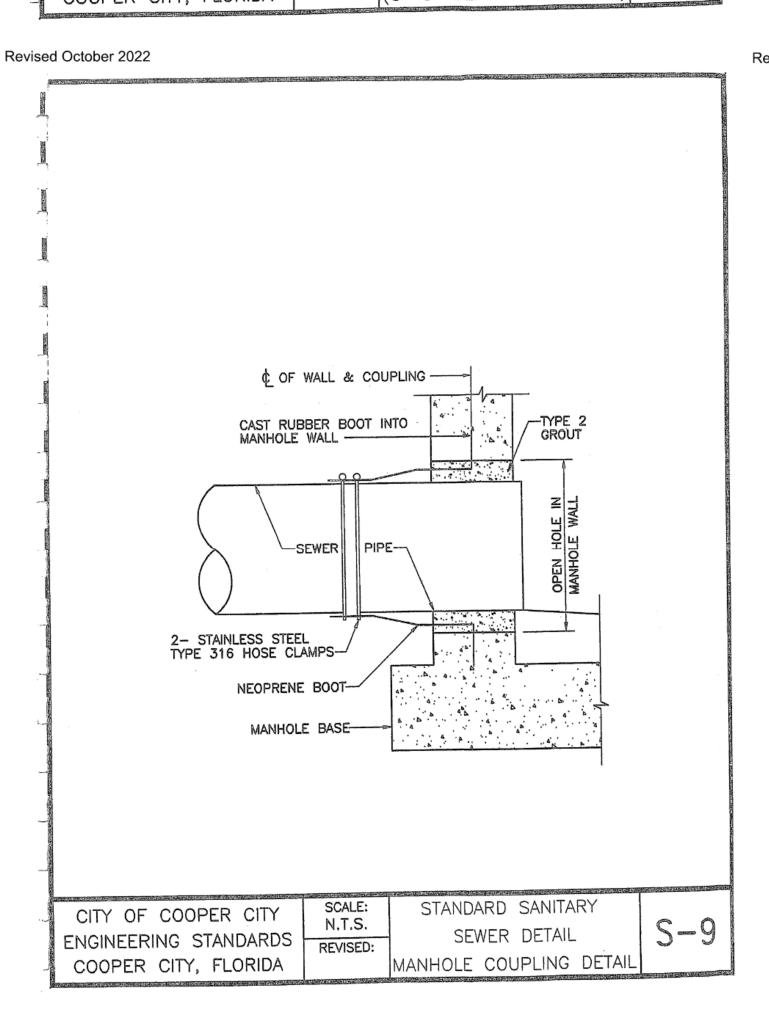DESIGNED: AWA

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DATE: 08/30/2023
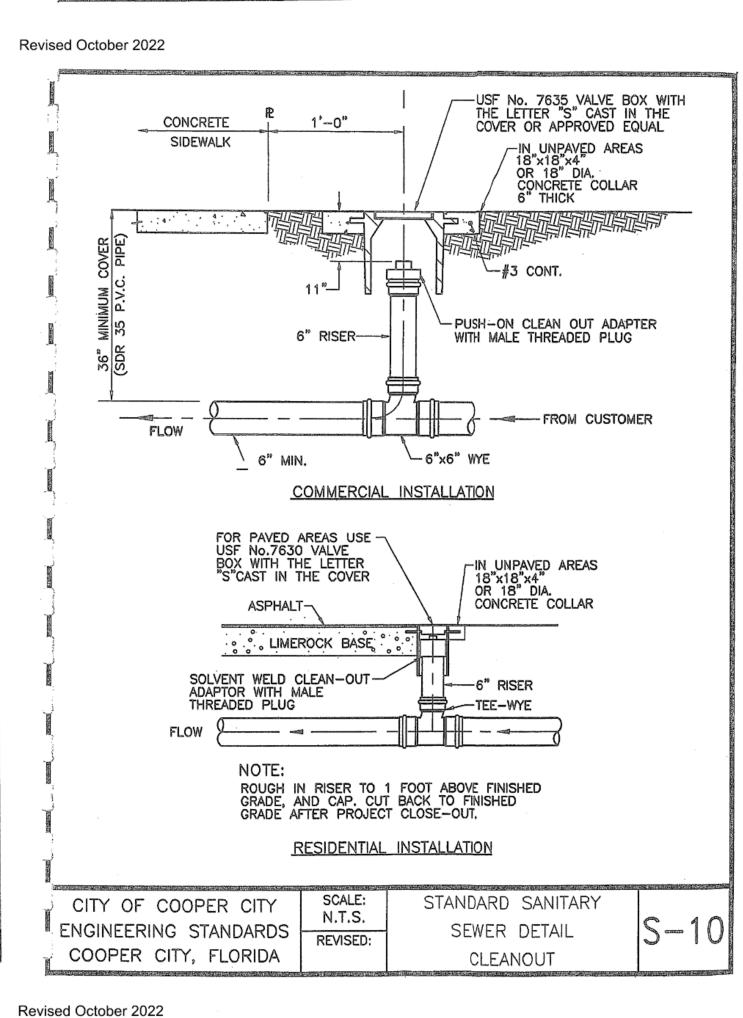
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DETAIL

STANDARD

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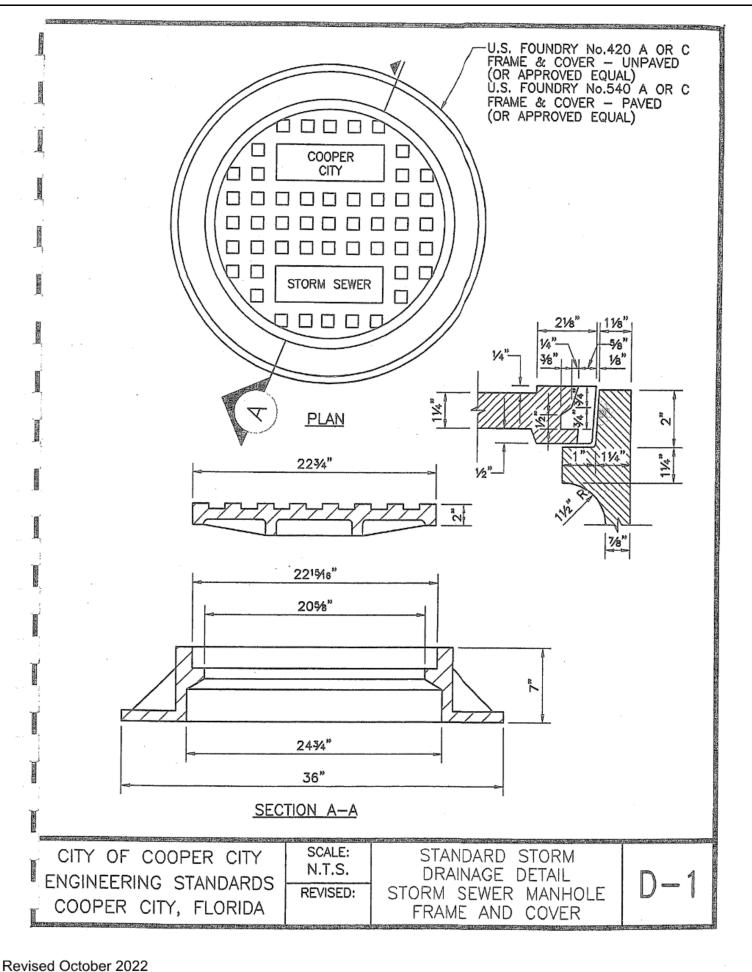
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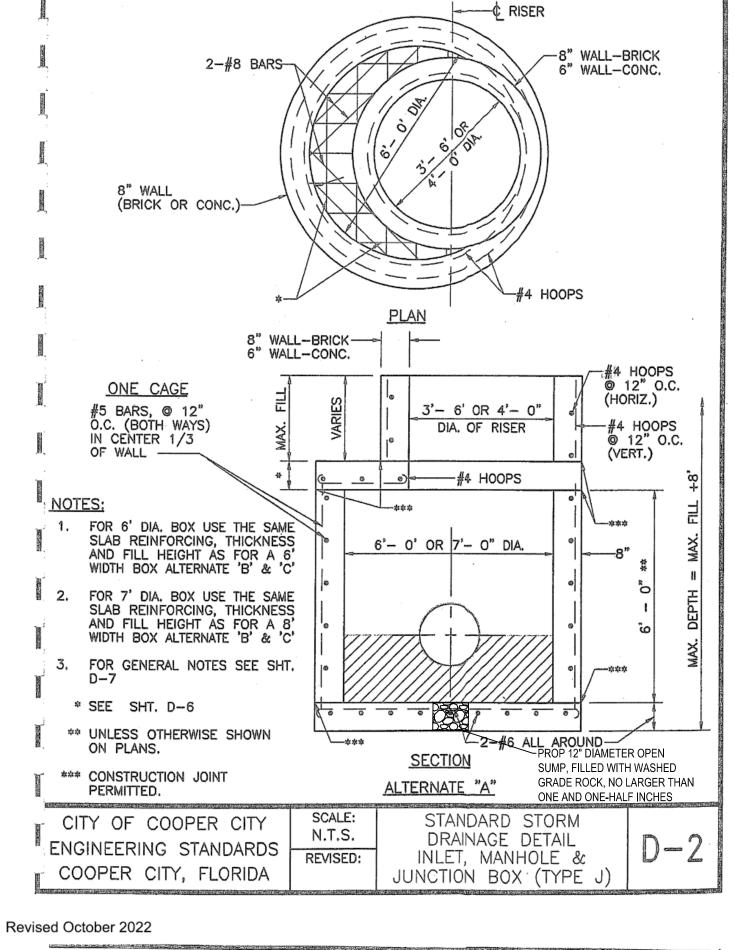
/ 23rd E PINES, 5885 - I


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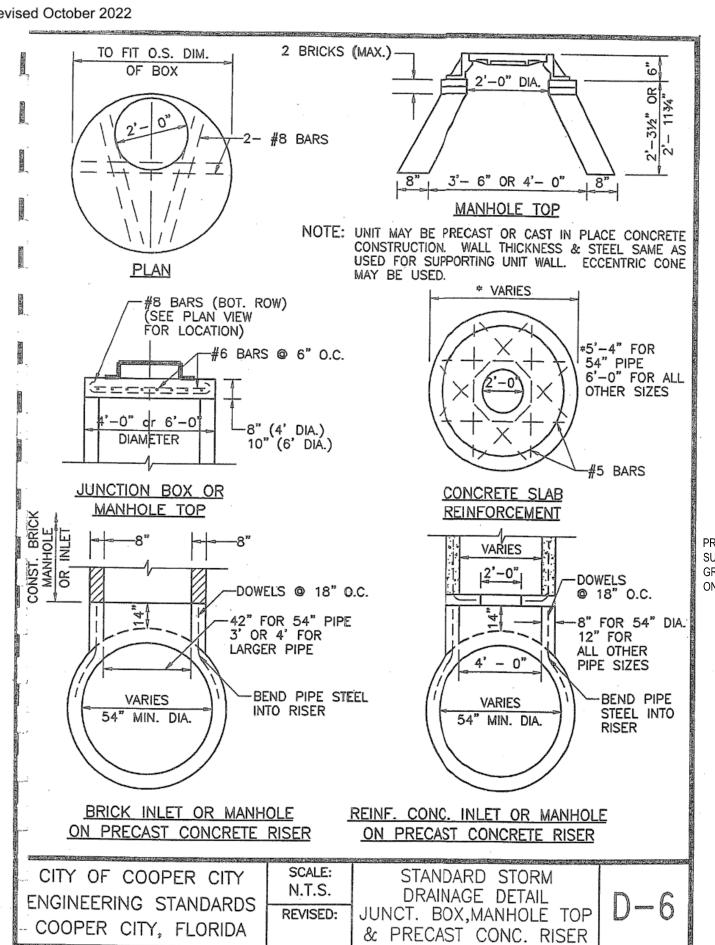





## **GENERAL NOTES:**

CIRCULAR STRUCTURES (ALTERNATES 'A') MAY BE CONSTRUCTED OF

		CONCRETE OR BRICK, BUT RECTANGULAR STRUCTURES (ALTERNATES 'B' & 'C') SHALL BE CONSTRUCTED OF CONCRETE ONLY. THE CONCRETE MAY BE CAST—IN—PLACE OR PRECAST.	
Management Company of the Company of	2.	WALL REINFORCEMENT AND THICKNESS ARE FOR EITHER CAST—IN—PLACE OR PRECAST CONCRETE EXCEPT THAT FOR PRECAST CIRCULAR UNITS A.S.T.M. SPECIFICATIONS C—76, TABLE III, FOR B WALL REINFORCED CONCRETE PIPE OR PRECAST CIRCULAR UNITS IN ACCORDANCE WITH ASTM SPECIFICATION C—478 WILL BE ACCEPTABLE. TOP AND FLOOR SLAB THICKNESS AND REINFORCEMENT ARE FOR ALL TYPES OF CONSTRUCTION.	
STORES OF THE PERSON OF THE PE	3,	PRECAST TOP AND/OR FLOOR SLABS MAY BE OF THE SAME CONCRETE AS SPECIFIED IN ASTM SPECIFICATIONS C-478 FOR PRECAST CIRCULAR UNITS.	
	4,	SMOOTH FLOW CHANNELS COMPOSED OF CONCRETE, OR BRICK AND MORTAR, SHALL BE CONSTRUCTED IN THE BOTTONS OF ALL STRUCTURES TO A DEPTH EQUAL TO HALF THE DIAMETER OF THE LARGEST PIPE.	
No.	5.	CORNER FILLETS SHOWN FOR RECTANGULAR STRUCTURES ARE NECESSARY ONLY WHEN STRUCTURES ARE USED IN CONJUNCTION WITH CIRCULAR TOPS.	
	6.	STRUCTURES SHALL BE SECURED TO INLET THROATS, RISERS OR MANHOLE TOPS WITH A MINIMUM OF 6-No. 4 BARS 12" LONG.	
Herman	7.	ANY INLET, MANHOLE, OR JUNCTION BOX MAY BE USED IN CONJUNCTION WITH ANY INLET THROAT OR MANHOLE TOP.	
Market Street	8.	MORTAR USED TO SEAL THE PIPE IN THE WALLS OF THE PRECAST UNITS SHALL BE OF SUCH A MIX THAT SHRINKAGE WILL NOT CAUSE LEAKAGE INTO OR OUT OF THE UNITS. MAXIMUM OPENING FOR PIPE SHALL BE MAXIMUM REQUIRED O.D. + 6".	STATE OF THE STATE
	9.	THE OUTSIDE OF BRICK WALLS SHALL BE PLASTERED WITH 1:2 CEMENT MORTAR.	
			HAND HIS WARREST OF
E	NGINEERIN	COOPER CITY NG STANDARDS REVISED: STANDARD STORM DRAINAGE DETAIL INLET, MANHOLE, & JUNCT. BOX (TYPES P & J)	5

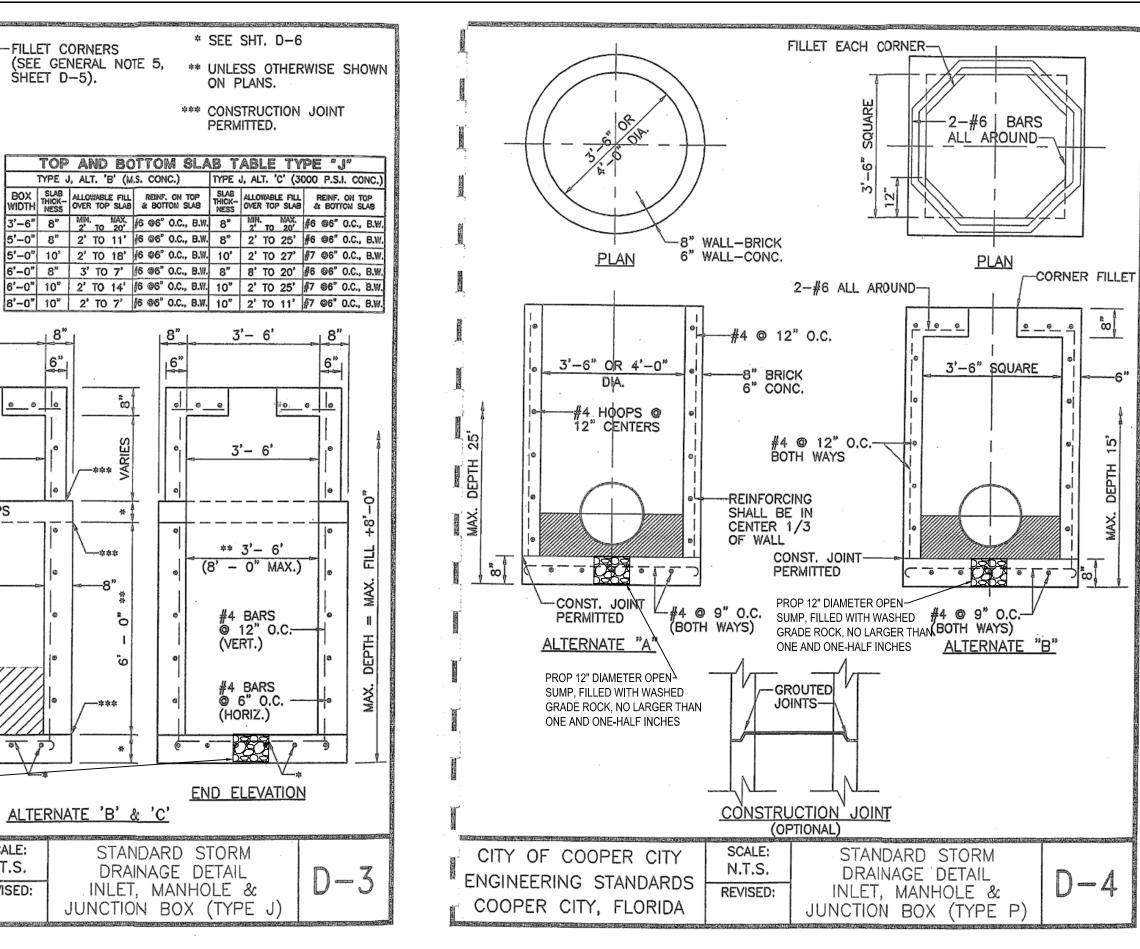

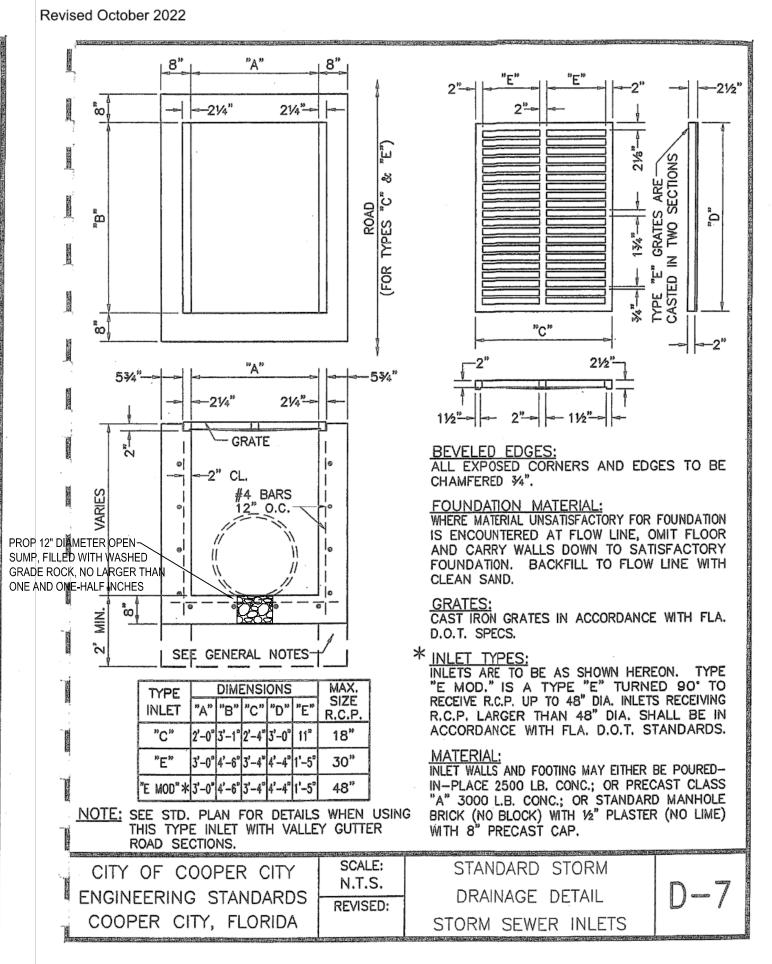

2-#6 ALL AROUND-

\*\* 2' - 6"

\_\_\_\_\_\_\_\_#4 HOOPS

\*\* 6'- 0'

(8' - 0" MAX.)

N.T.S.

REVISED:

#4 BARS @ 12" O.C.

(BOTH WAY\$)

#4 BARS

4 BARS

© 6" O.C.-

PROP 12" DIAMETER OPEN

ONE AND ONE-HALF INCHES

GRADE ROCK, NO LARGER THAN

SUMP, FILLED WITH WASHED SECTION


CITY OF COOPER CITY

\* ENGINEERING STANDARDS

COOPER CITY, FLORIDA

(HORIZ.)

Revised October 2022

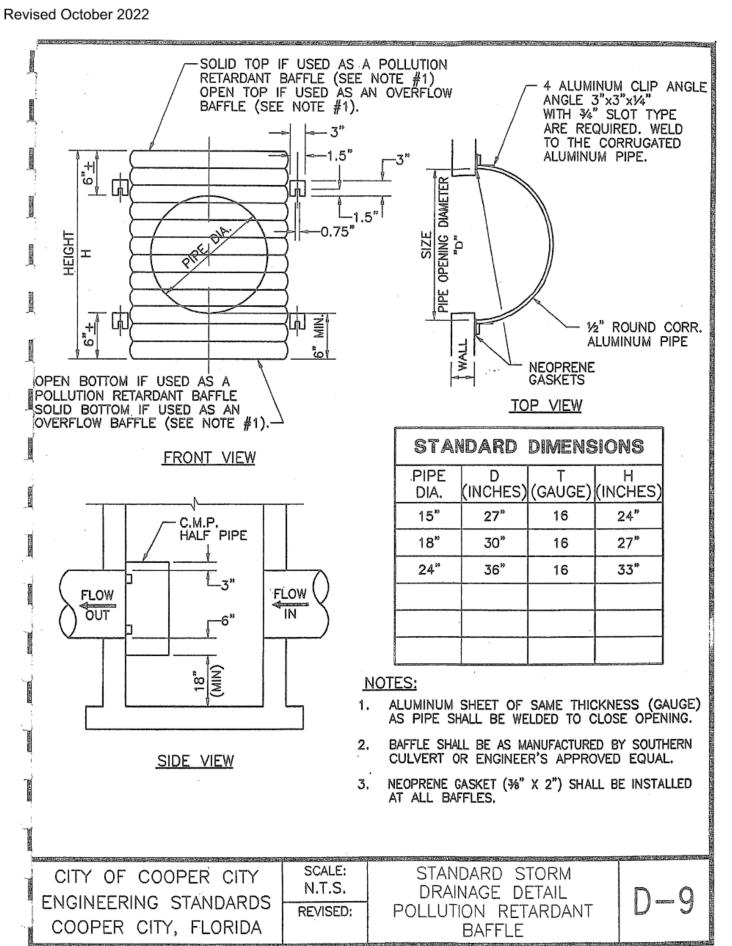

Revised October 2022

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ANDREW W. ADAMS REGISTERED ENGINEER #55315 STATE OF FLORIDA

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PROJ. NO.

2306A

SCALE: AS NOTED

DATE: 08/30/2023

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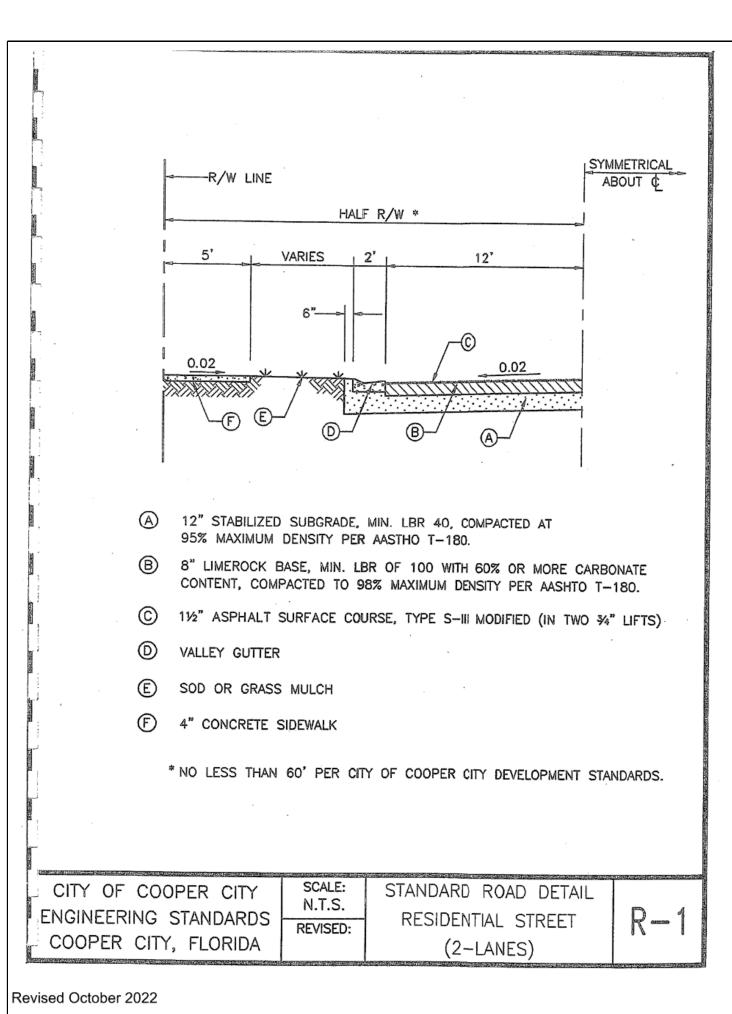
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I NW ROKE 339-5

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OR TIN EER

Revised October 2022



**LETTERS** 

ANY RD.

ONLY

COUNTY AND F.D.O.T. STANDARDS.

"SIGN FOAM" OR

STANDARD SIGN

CONC CURB

(TYP.) ---

30"x 30" STOP

SIGN (R1-1) -

WOOD BORDER EXTENDS APPROX. 0.5"-0.75" BEYOND - SILVER DIAMOND GRADES 2870 HEAT APPLICATION/OR

3870 PRESSURE SENSITIVE

2877 HEAT APPLICATION/OR

3877 PRESSURE SENSITIVE

-GREEN TRANSLUCENT INK SILK SCREENED

CLEAR COATED OR MYLAR OVER SILVER,

- DIAMOND GRADE (3M 3970G WHITE) OR EQUIVALENT, PRESSURE

SENSITIVE RED TRANSLUCENT INK

MYLAR OVER DIAMOND GRADE.

SUPPLEMENTAL

(R3-5R)

ENCASED WITHIN 5" X 5"

(ALL WOOD POSTS IN EXCESS

OF 4"X4" MUST BE DRILLED AT

GRAY PVC SLEEVE.

BREAK-AWAY POINT)

FINISH GRADE-

ALL SIGNS TO CONSIST OF HIGH INTENSITY REFLECTIVE MATERIALS.

-RIGHT TURN ONLY

-4" X 4" PRESSURE TREATED WOOD POST

SILK SCREENED, CLEAR COATED OR

ANY ST.

COMPLETELY BOLTED THROUGH WITH 3/8"

BOLTS AND WASHERS

PER BROWARD

COUNTY/F.D.O.T.

STANDARDS.


GRAY "SIGN FOAM" OR


WITH GRAY WEATHER


RESISTANT FINISH.

WOOD BACKING (APPROX.


1.5" TO 2.0" THICK) PAINTED

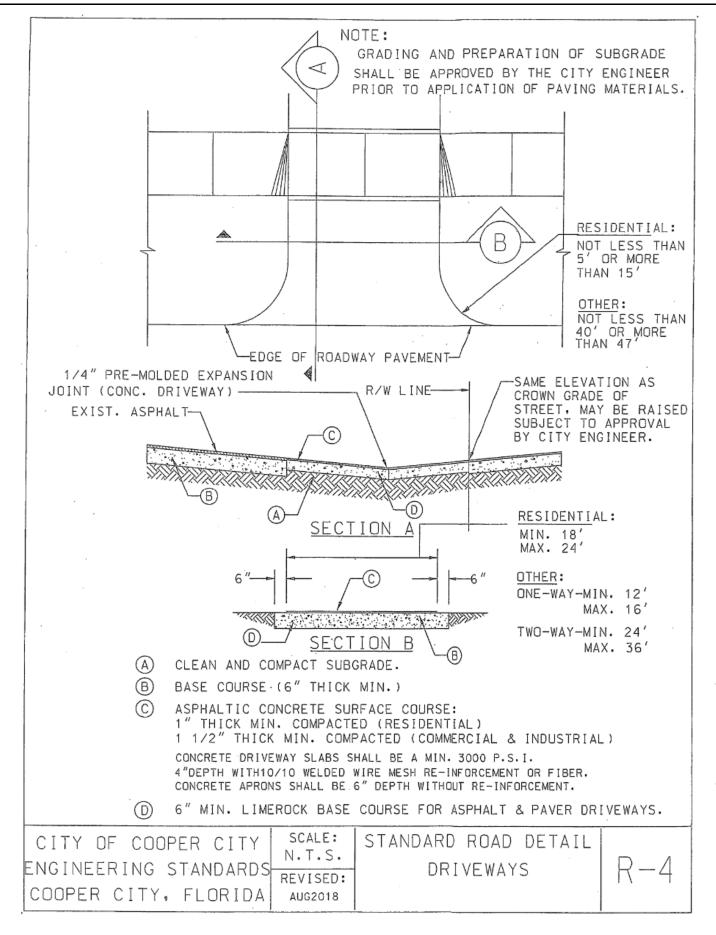


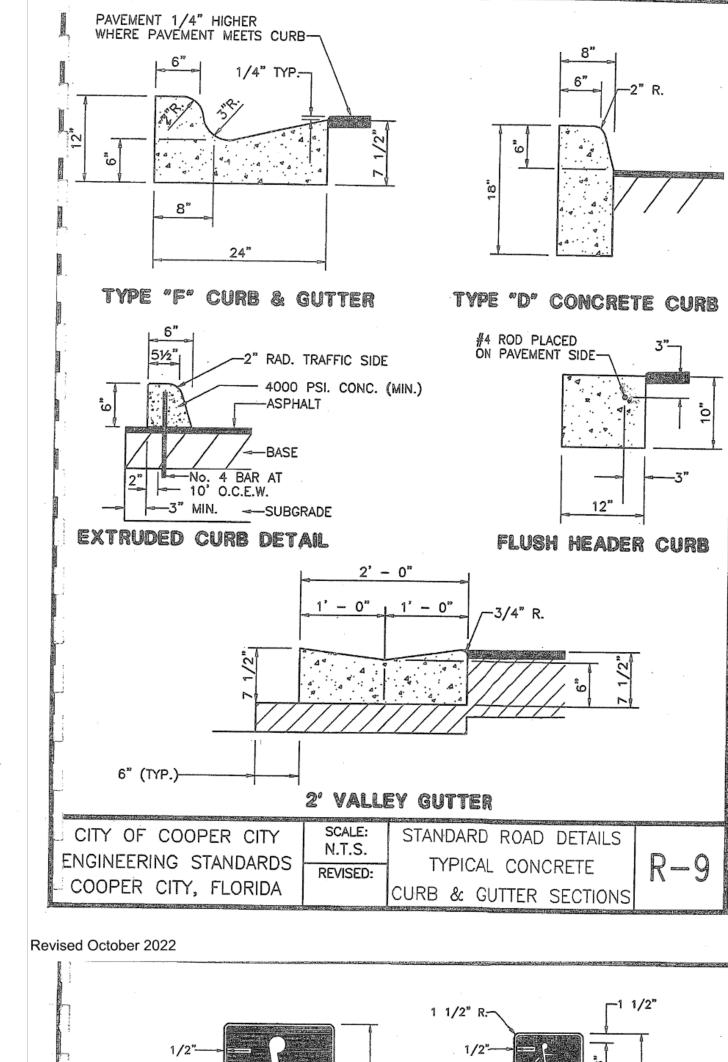


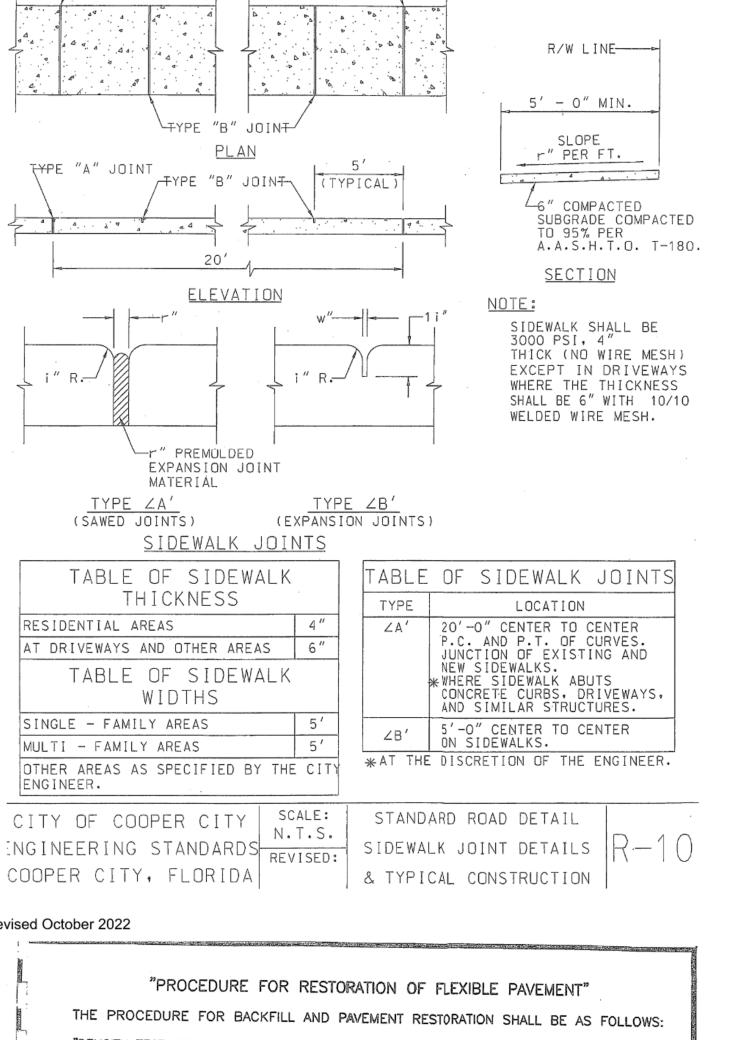


III - W DOTINE

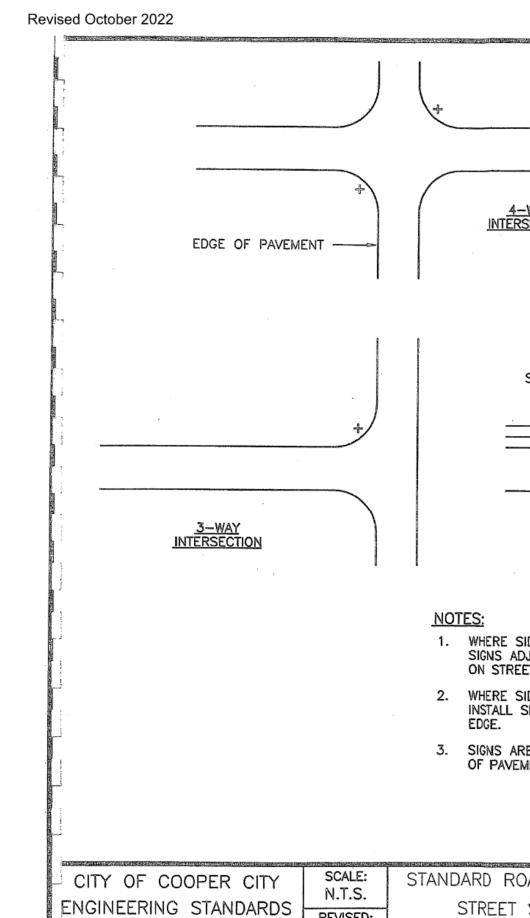

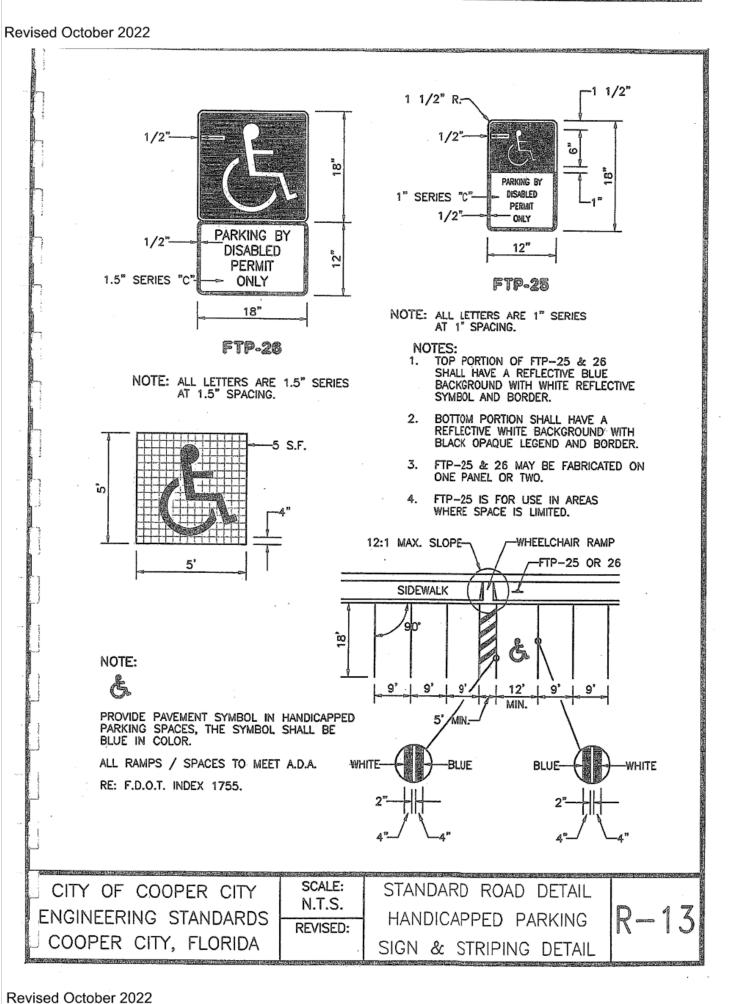

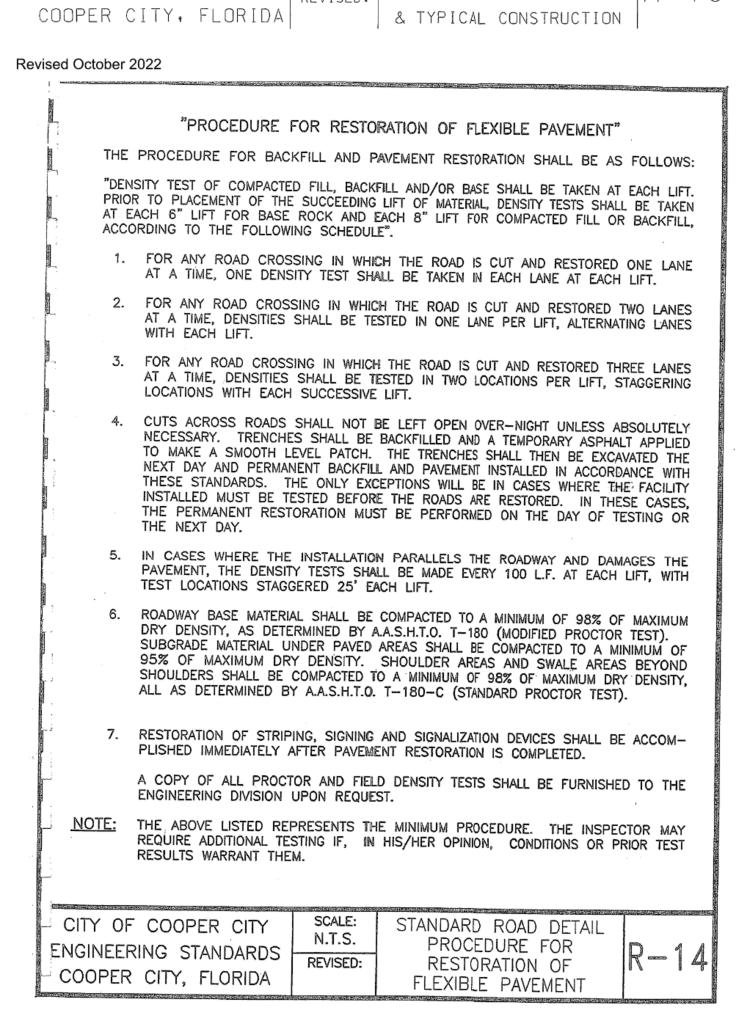

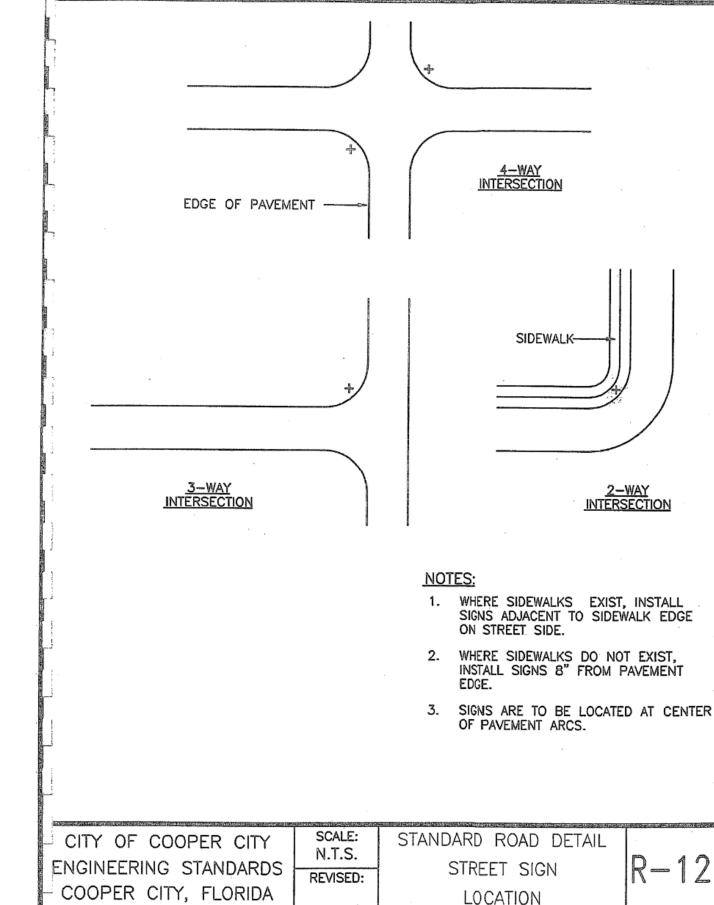

Revised October 2022

3. SIMILAR, BUT SOMEWHAT DIFFERENT AESTHETIC INSTALLATIONS MAY BE IMPLEMENTED ON PRIVATE PROPERTY SUBJECT TO CITY APPROVAL. STANDARD ROAD DETAIL CITY OF COOPER CITY N.T.S. ENGINEERING STANDARDS TYPICAL STOP SIGN AND |R-1' COOPER CITY, FLORIDA STREET NAME ASSEMBLY

2. INSTALLATION MUST MAINTAIN SIZE, SHAPE AND COLOR OF STANDARD M.U.T.C.D. SIGN. ALL SIGNS

TO BE INSTALLED IN CONFORMANCE WITH THE M.U.T.C.D. AND ALL APPLICABLE BROWARD

Revised October 2022

THIS ITEM HAS BEEN DIGITALLY SIGNED AND SEALED BY ANDREW W. ADAMS, P.E. ON THE DATE ADJACENT TO THE SEAL. PRINTED COPIES OF THIS DOCUMENT ARE NOT CONSIDERED SIGNED AND SEALED AND THE SIGNATURE MUST BE VERIFIED ON ANY ELECTRONIC COPIES.

May 6, 2024 REW W. ADA ICENSE. No. 55315 STATE OF FLORIDA.

Revised October 2022

2306A C-30 OF 33 SHEETS

ANDREW W. ADAMS REGISTERED ENGINEER #55315 STATE OF FLORIDA

DESIGNED: AWA

DRAWN: AWA

CHECKED: AWA

PROJ. NO.

SCALE: AS NOTED

DATE: 08/30/2023

DETAIL

STANDARD

:ET 026 416

Z = 8


/ 23rd : PINES, 5885 -


INW ROKE 339-5


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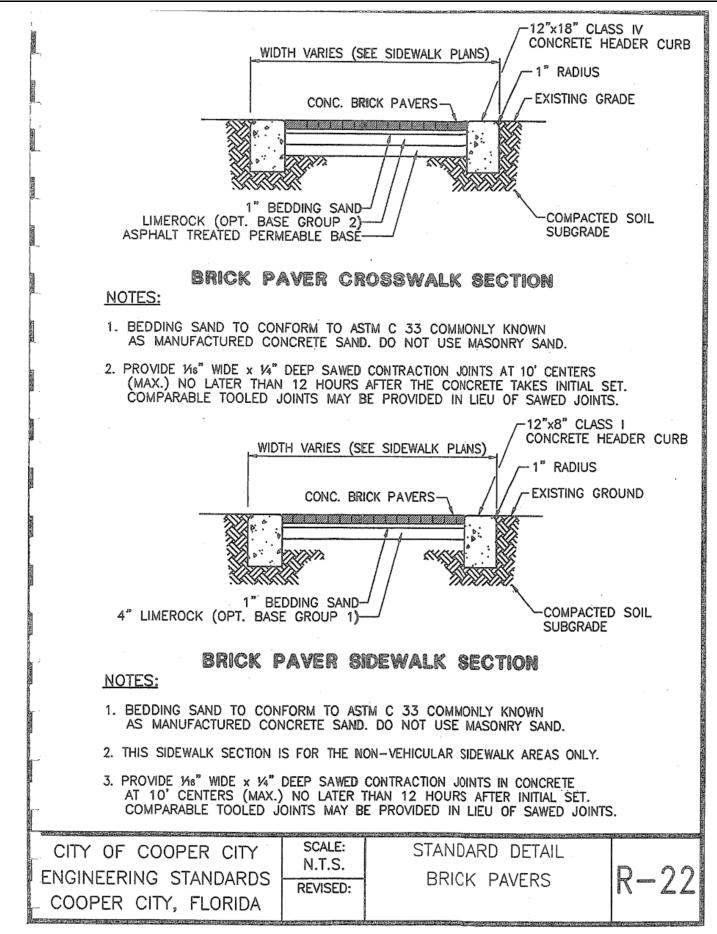
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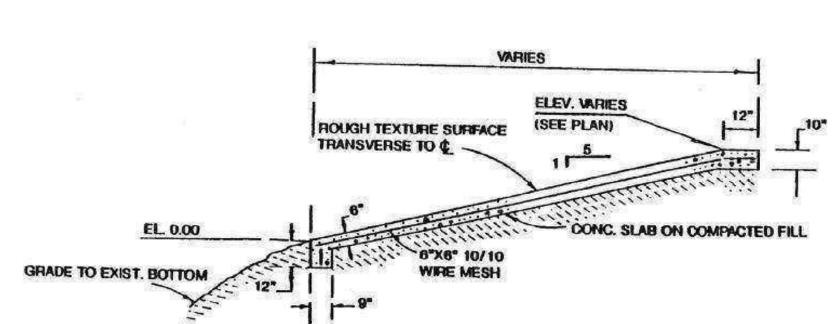
WHITMC CONSULT ENGINE





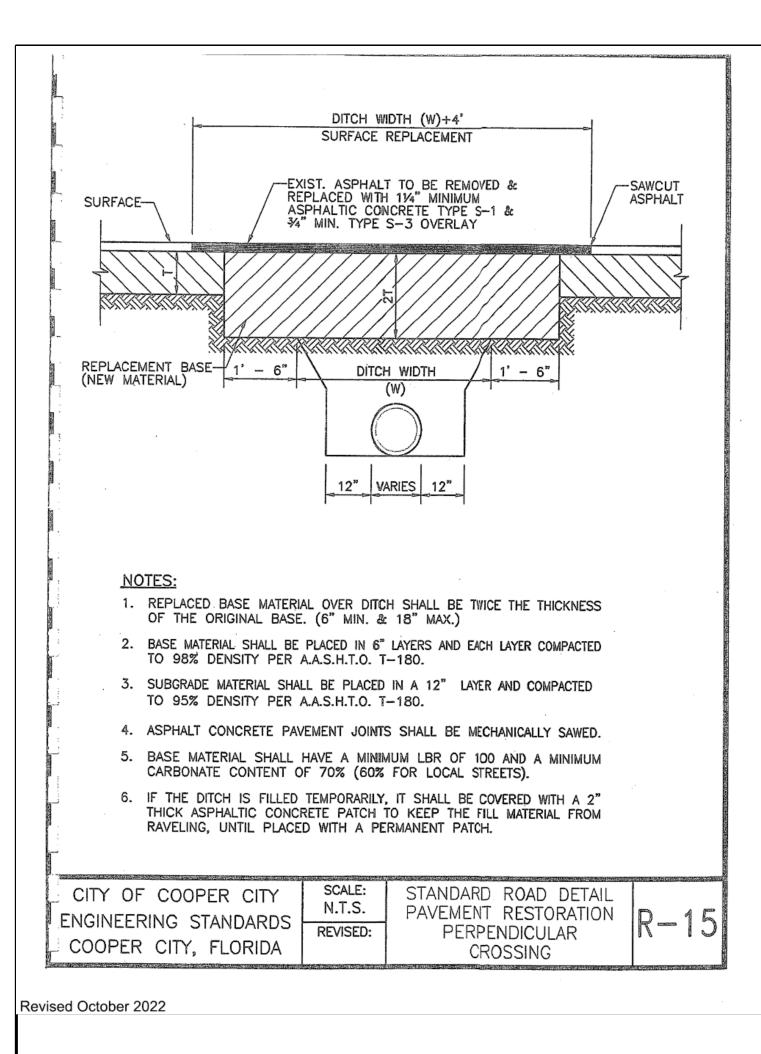

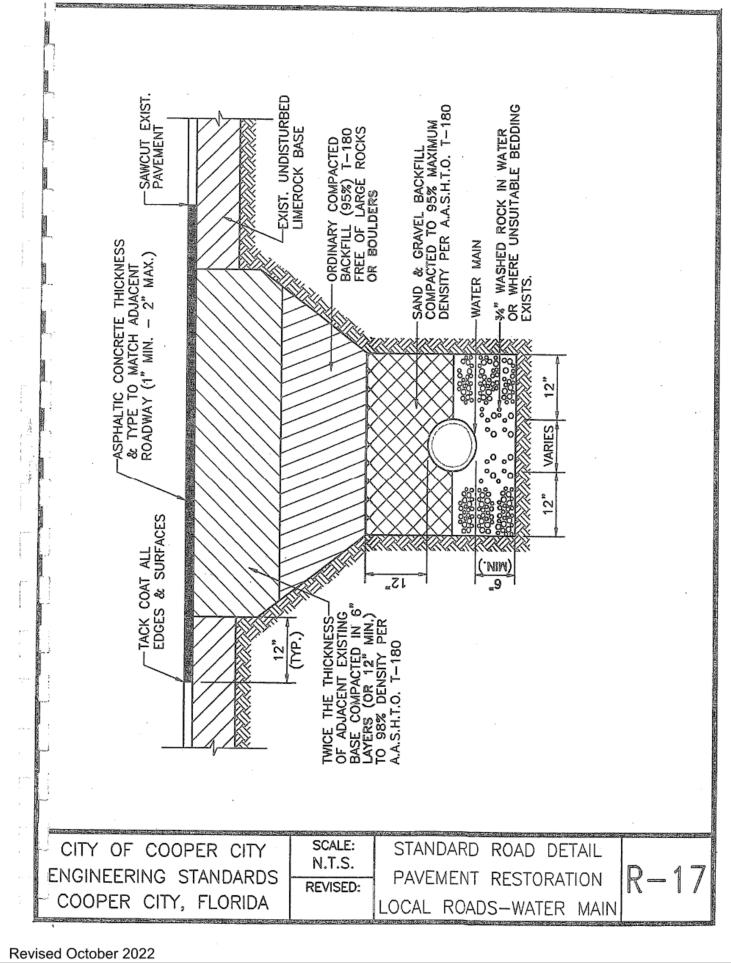

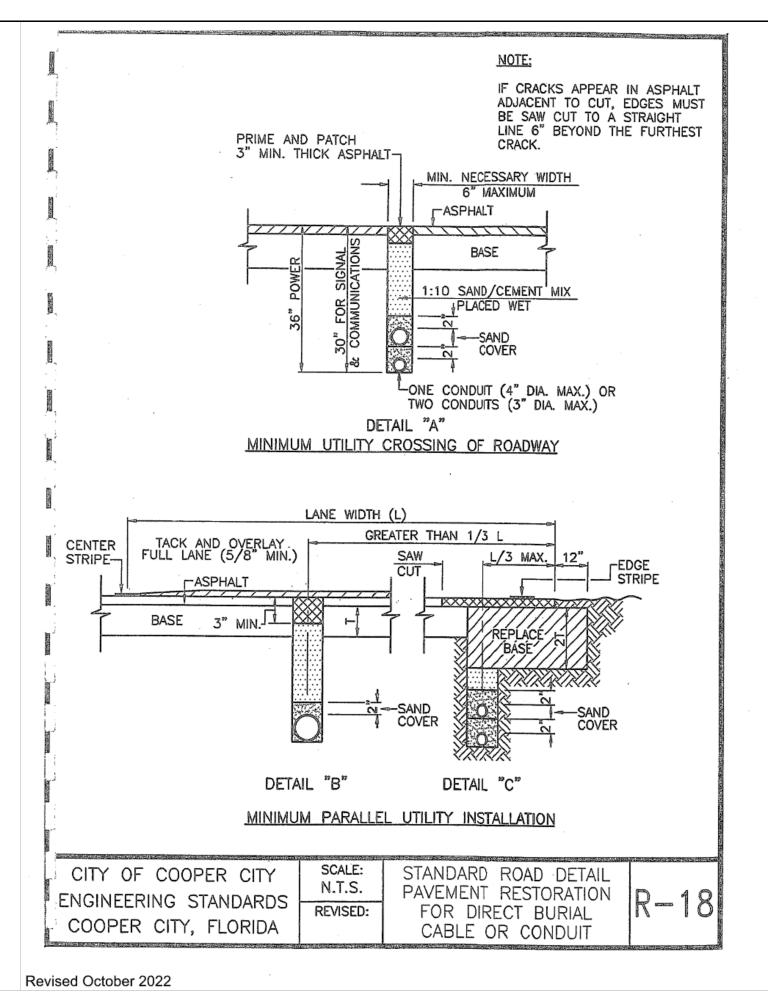

**BOAT RAMP DETAIL** 

Revised October 2022

May 6, 2024 THIS ITEM HAS BEEN DIGITALLY SIGNED AND SEALED BY ANDREW W. ADAMS, P.E. ON THE DATE ADJACENT TO THE SEAL. PRINTED COPIES OF THIS DOCUMENT ARE NOT CONSIDERED SIGNED AND SEALED AND THE SIGNATURE MUST BE VERIFIED ON ANY ELECTRONIC COPIES.

S

DETAIL

STANDARD

:ET 026 416

STREE , FL 330 LB 364

ANDREW W. ADAMS REGISTERED ENGINEER #55315 STATE OF FLORIDA

DESIGNED: AWA

SCALE: AS NOTED


DATE: 08/30/2023

C-31

DRAWN: AWA CHECKED: AWA

PROJ. NO.

2306A

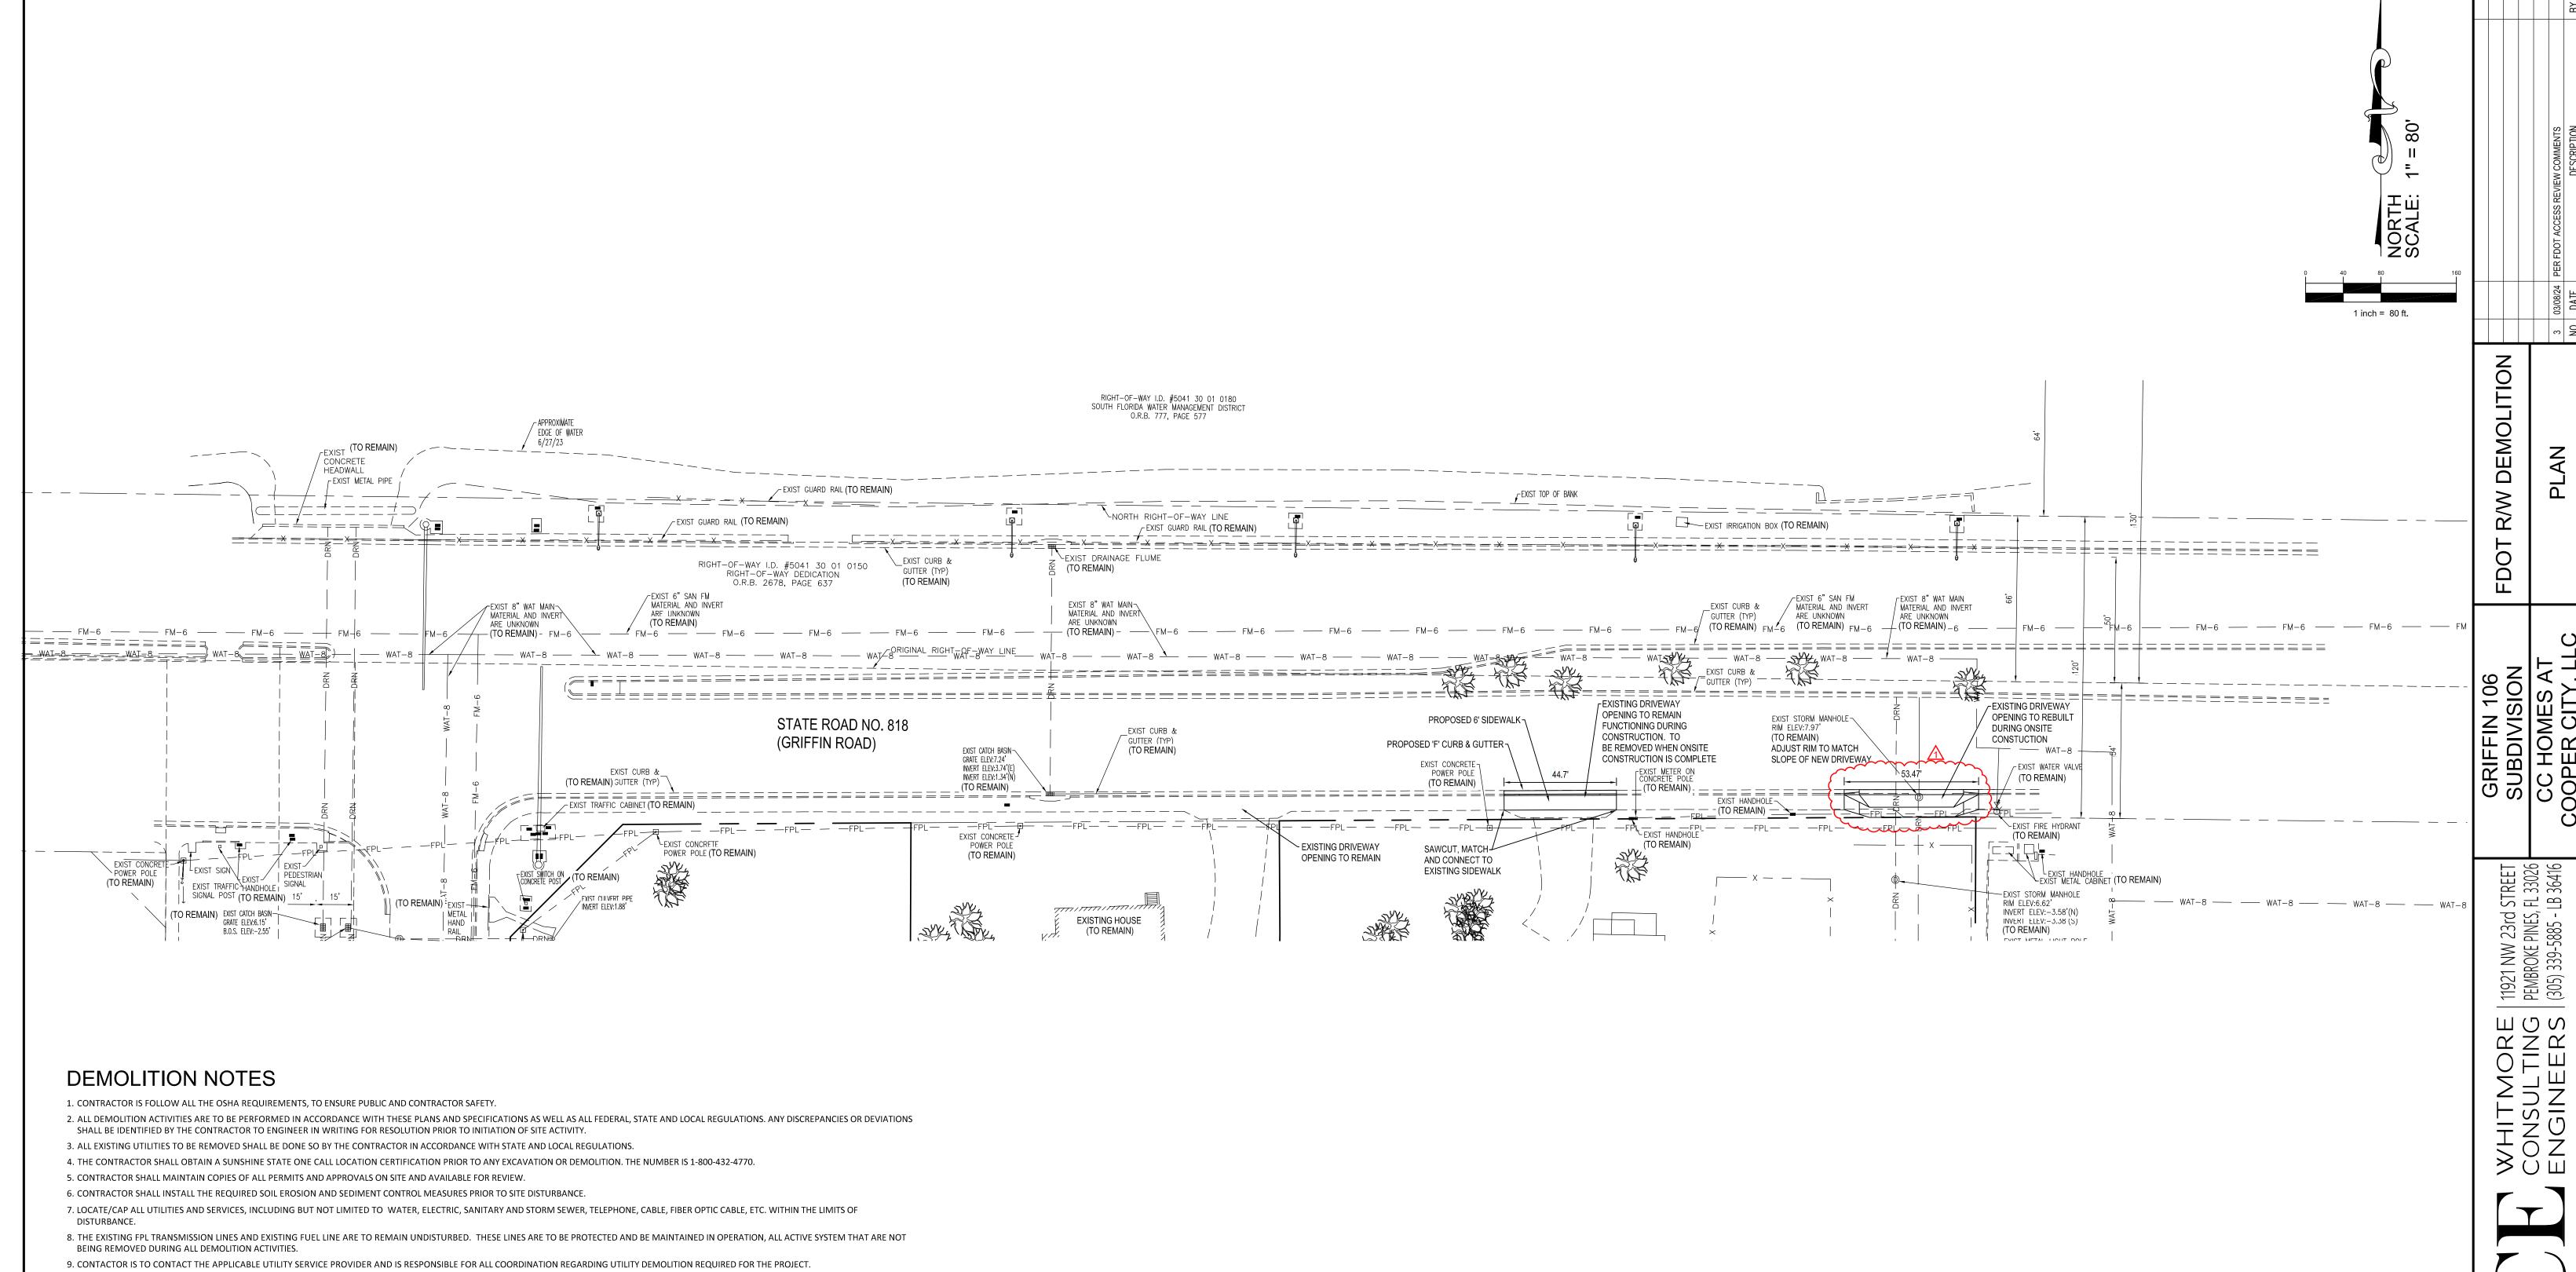

- 10. THE CONTRACTOR SHALL PROVIDE THE OWNER WRITTEN NOTIFICATION THAT THE EXISTING UTILITIES AND SERVICES HAVE BEEN TERMINATED AND ABANDONED IN ACCORDANCE WITH JURISDICTION AND UTILITY COMPANY REQUIREMENTS.
- 11. CONTACTOR IS TO COORDINATE WITH UTILITY COMPANIES REGARDING WORKING "OFF-PEAK" HOURS OR ON WEEKENDS AS MAY BE REQUIRED TO MINIMIZE THE IMPACT ON THE AFFECTED PARTIES.
- 12. THE CONTRACTOR SHALL PROVIDE ALL THE "MEANS AND METHODS" NECESSARY TO PREVENT MOVEMENT, SETTLEMENT, OR COLLAPSE OF EXISTING STRUCTURES, AND ANY OTHER IMPROVEMENTS THAT ARE REMAINING ON OR OFF SITE. THE DEMOLITION CONTRACTOR IS RESPONSIBLE FOR ALL REPAIRS OF DAMAGE TO ALL ITEMS THAT ARE TO REMAIN AS A RESULT OF HIS ACTIVITIES. ALL REPAIRS SHALL USE NEW MATERIAL. THE REPAIRS SHALL RESTORE THE ITEM TO THE PRE-DEMOLITION CONDITION.
- 13. IN THE ABSENCE OF SPECIFICATIONS, THE CONTRACTOR SHALL PERFORM EARTH MOVEMENT ACTIVITIES, DEMOLITION AND REMOVAL OF ALL FOUNDATION WALLS, FOOTINGS, AND OTHER MATERIALS WITHIN THE LIMITS OF DISTURBANCE IN ACCORDANCE WITH DIRECTION BY OWNER'S STRUCTURAL OR GEOTECHNICAL ENGINEER.
- 14. EXPLOSIVES SHALL NOT BE USED.
- 15. CONTRACTOR SHALL PROVIDE TRAFFIC CONTROL AND GENERALLY ACCEPTED SAFE PRACTICES IN CONFORMANCE WITH: THE "MANUAL ON UNIFORM TRAFFIC CONTROL," AS WELL AS FEDERAL, STATE, AND LOCAL REGULATIONS WHEN DEMOLITION RELATED ACTIVITIES IMPACT ROADWAYS OR ROADWAY RIGHTS-OF-WAY.
- 16. CONTRACTOR SHALL CONDUCT DEMOLITION ACTIVITIES IN SUCH A MANNER TO ENSURE MINIMUM INTERFERENCE WITH ROADS, STREETS, SIDEWALKS, WALKWAYS, AND OTHER ADJACENT FACILITIES. STREET
- CLOSURE PERMITS MUST BE RECEIVED FROM THE APPROPRIATE GOVERNMENTAL AUTHORITY. 17. DEMOLITION ACTIVITIES AND EQUIPMENT SHALL NOT USE AREAS OUTSIDE THE DEFINED PROPERTY LINE WITHOUT WRITTEN PERMISSION OF THE OWNER, AND/OR APPROPRIATE GOVERNMENT AGENCY.
- 18. CONTRACTOR SHALL USE DUST CONTROL MEASURES TO LIMIT AIRBORNE DUST AND DIRT RISING AND SCATTERING IN THE AIR IN ACCORDANCE WITH FEDERAL, STATE, AND/OR LOCAL STANDARDS. AFTER THE DEMOLITION IS COMPLETE, ADJACENT STRUCTURES AND IMPROVEMENTS SHALL BE CLEANED OF ALL DUST AND DEBRIS CAUSED BY THE DEMOLITION OPERATIONS. THE CONTRACTOR IS RESPONSIBLE FOR RETURNING ALL ADJACENT AREAS TO THEIR "PRE-DEMOLITION" CONDITION.
- 19. CONTRACTOR IS RESPONSIBLE TO SAFEGUARD SITE AS NECESSARY TO PERFORM THE DEMOLITION IN SUCH A MANNER AS TO PREVENT THE ENTRY OF UNAUTHORIZED PERSONS AT ANYTIME.
- 20. THIS DEMOLITION PLAN IS INTENDED TO IDENTIFY THOSE EXISTING ITEMS/CONDITIONS WHICH ARE TO BE REMOVED. IT IS NOT INTENDED TO PROVIDE DIRECTION OTHER THAN THAT ALL METHODS AND MEANS ARE TO BE IN ACCORDANCE WITH STATE, FEDERAL, LOCAL, AND JURISDICTIONAL REQUIREMENTS. THE CONTRACTOR SHALL BE RESPONSIBLE FOR ALL OSHA AND OTHER SAFETY PRECAUTIONS
- 21. DEBRIS SHALL NOT BE BURIED ON THE SUBJECT SITE. ALL DEMOLITION WASTES AND DEBRIS (SOLID WASTE) SHALL BE DISPOSED OF IN ACCORDANCE WITH ALL VILLAGE, COUNTY, STATE, AND FEDERAL LAWS AND APPLICABLE CODES. ALL DEBRIS SHALL BE DISPOSED OF OFFSITE AT A LICENSED DISPOSAL FACILITY.
- 22. CONTRACTOR IS RESPONSIBLE FOR FIELD VERIFYING ALL EXISTING SITE IMPROVEMENTS AND UTILITIES. ALL DISCREPANCIES SHALL BE IDENTIFIED TO THE ENGINEER IN WRITING.
- 23. ANY UNDERGROUND STRUCTURES FOUND ARE TO BE BROUGHT TO THE ATTENTION OF THE ENGINEER OR OWNER'S REPRESENTATIVE PRIOR TO REMOVAL.
- 24. SITE TO BE COMPACTED AND LEFT GRADED LEVEL.
- 25. EXISTING OVERHEAD ELECTRIC AND TRANSFORMERS TO BE REMOVED BY FPL.

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> May 6, 2024 REW W. ADA CENSE No. 55315 STATE OF


> > .FLORIDA

DRAWN: AWA CHECKED: AWA SCALE: AS NOTED DATE: 08/30/2023 PROJ. NO. 2306A

REGISTERED ENGINEER #55315

STATE OF FLORIDA

DESIGNED: AWA

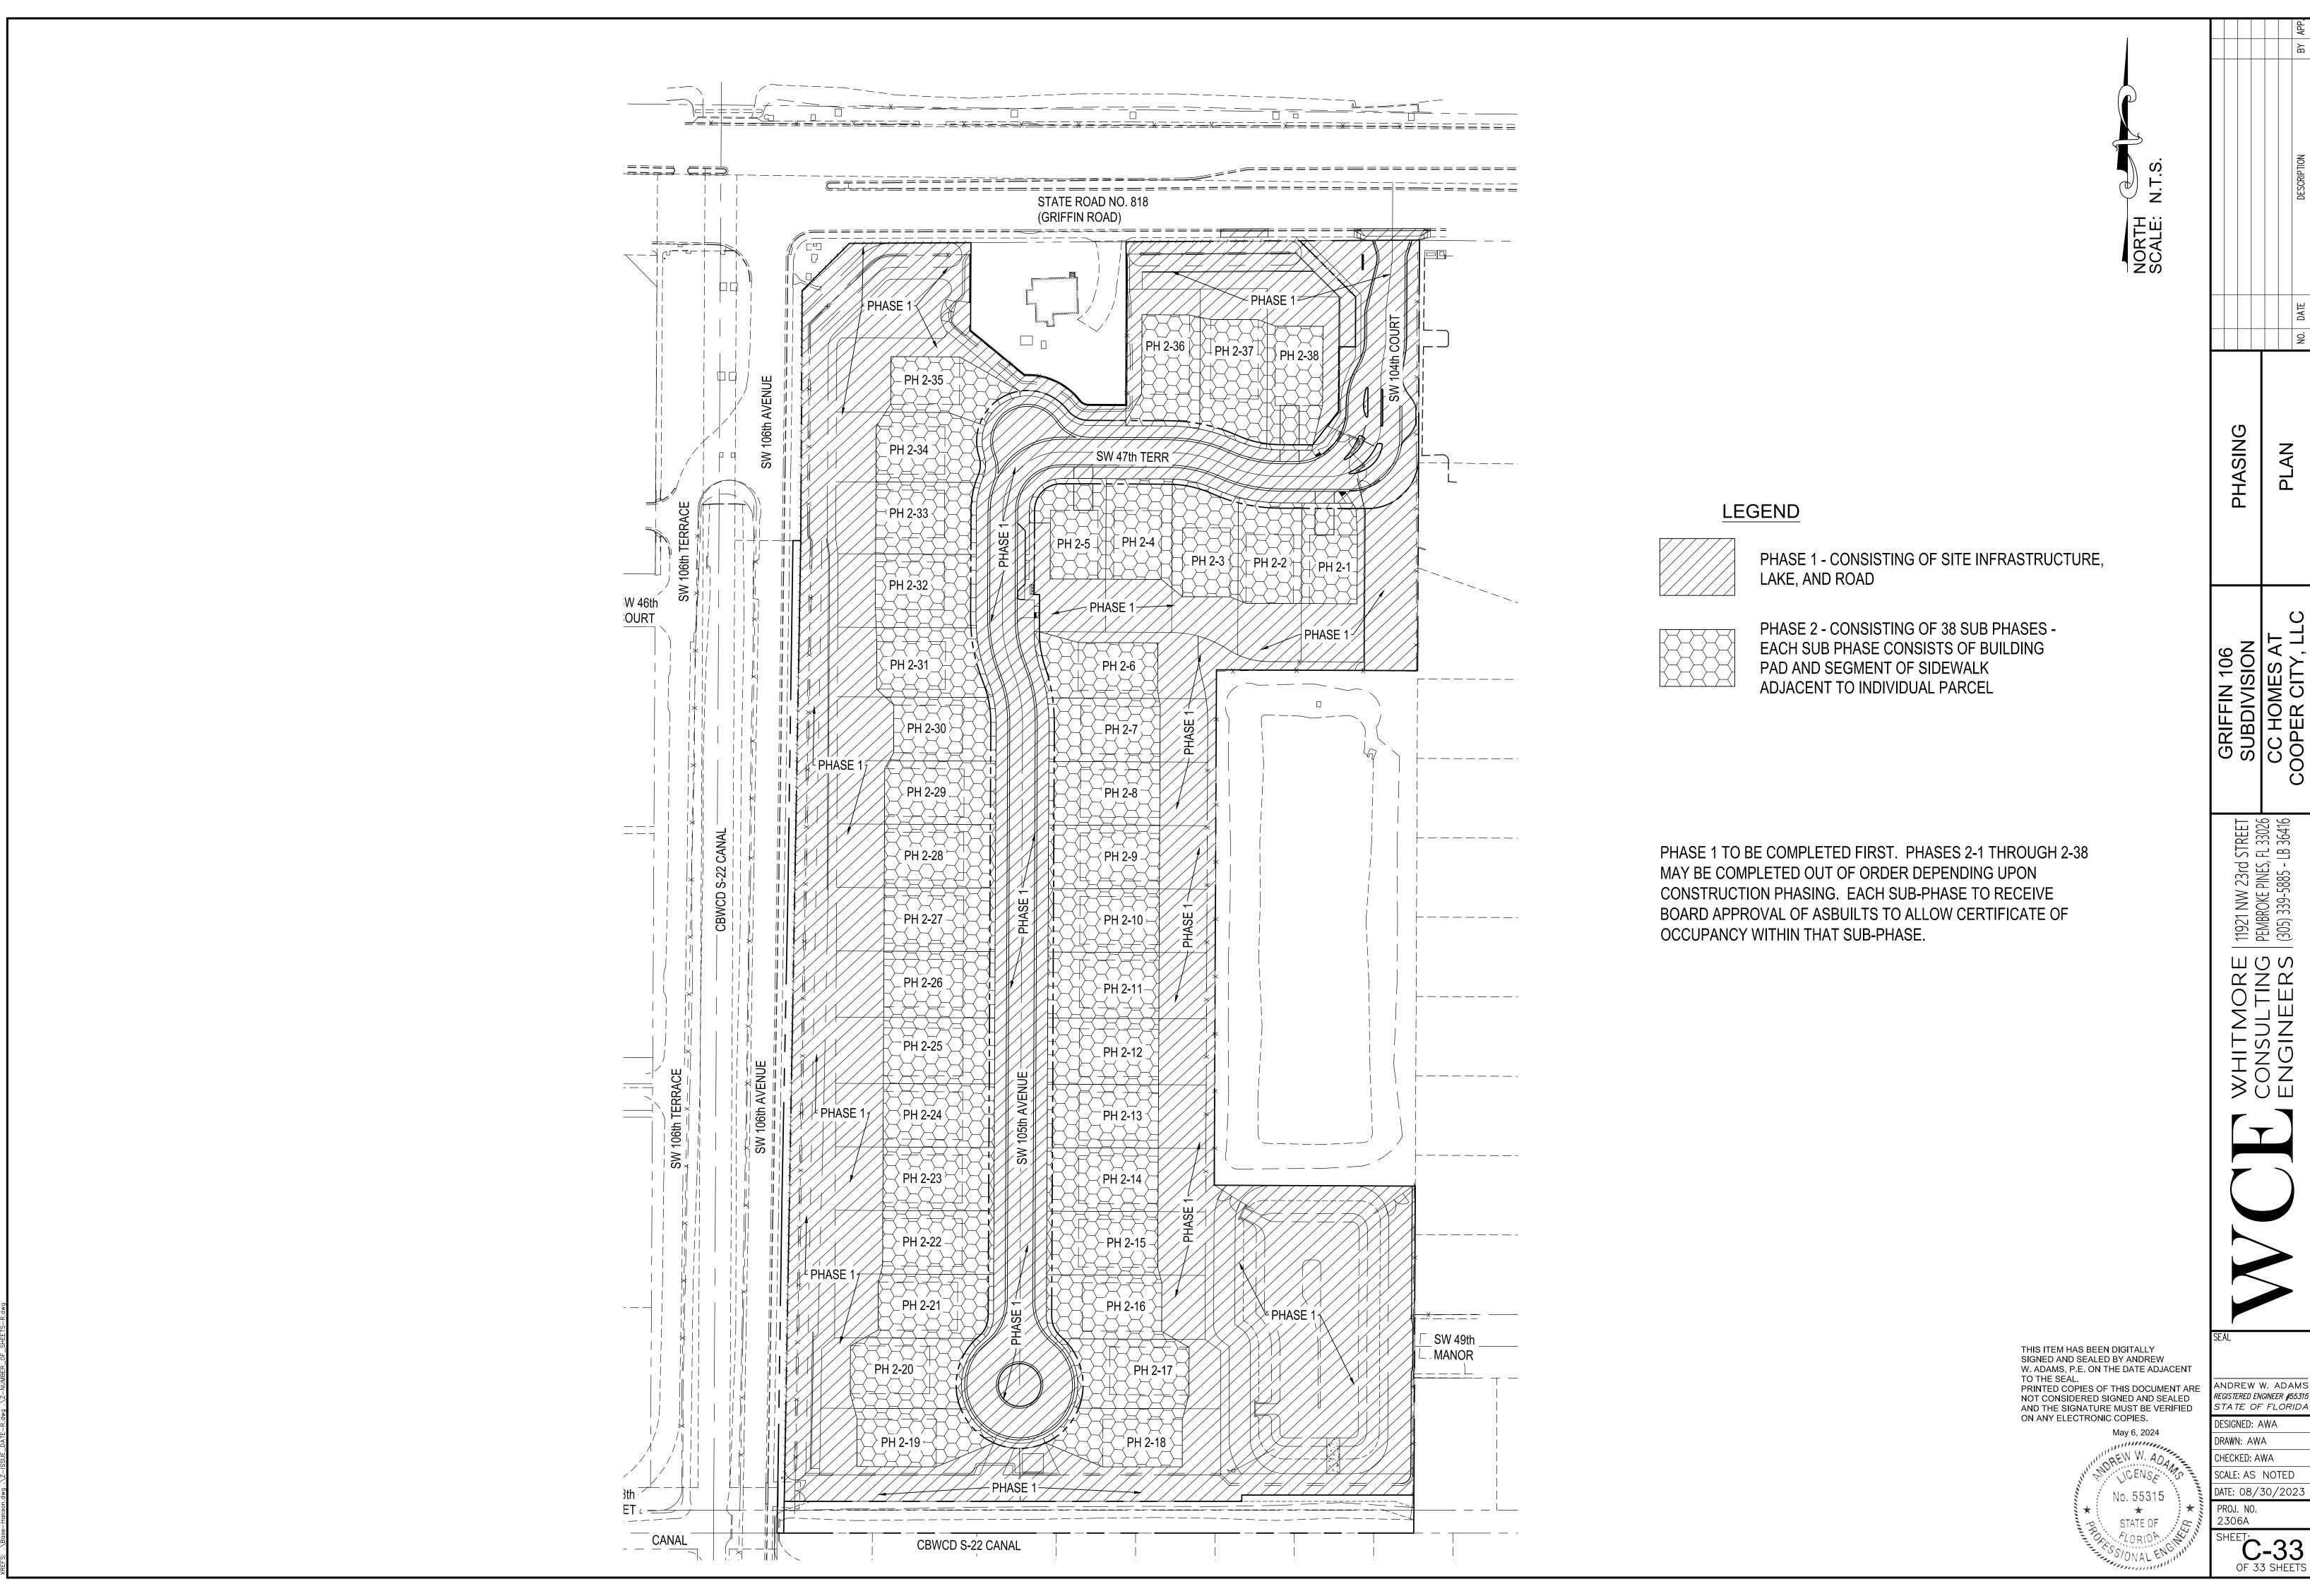

REGISTERED ENGINEER #55315 STATE OF FLORIDA