

CENTER LINE PROPERTY LINE EASEMENT LINE CIVIL LIMIT OF WORK LINE GRADE BREAK LINE RIDGE LINE FLOW LINE

PROPOSED SPOT GRADE

PROPOSED FLOW (DIRECTION AND SLOPE)

LANDSCAPE/ PLANTER AREA

SIDEWALK CONCRETE PAVEMENT

TRUNCATED DOMES

SITE CONSTRUCTION NOTES

- (1) CONSTRUCT CONCRETE CURB./CURB AND GUTTER
- (3) INSTALL VAN ACCESSIBLE PARKING STALL.
- (4) INSTALL ACCESSIBLE CURB RAMP
- 5 LANDSCAPE/PLANTER AREA. REFER TO LANDSCAPE PLANS FOR MORE INFORMATION.
- PROPOSED STORM DRAIN TO INFILTRATION SYSTEM
- (8) PROPOSED ABOVE GROUND INFILTRATION BASIN
- 9 PROPOSED STORM DRAIN LINE


ALL PROPOSED ELEVATIONS SHOWN ON THIS PLAN ARE +100.00 FT

WESTERFIELD WY. VICINITY MAP

PREPARED FOR
OUNTAINHEAD DEVELOPMENT **FOUNTAINHEAD**

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SHEET NUMBER 1 OF 2

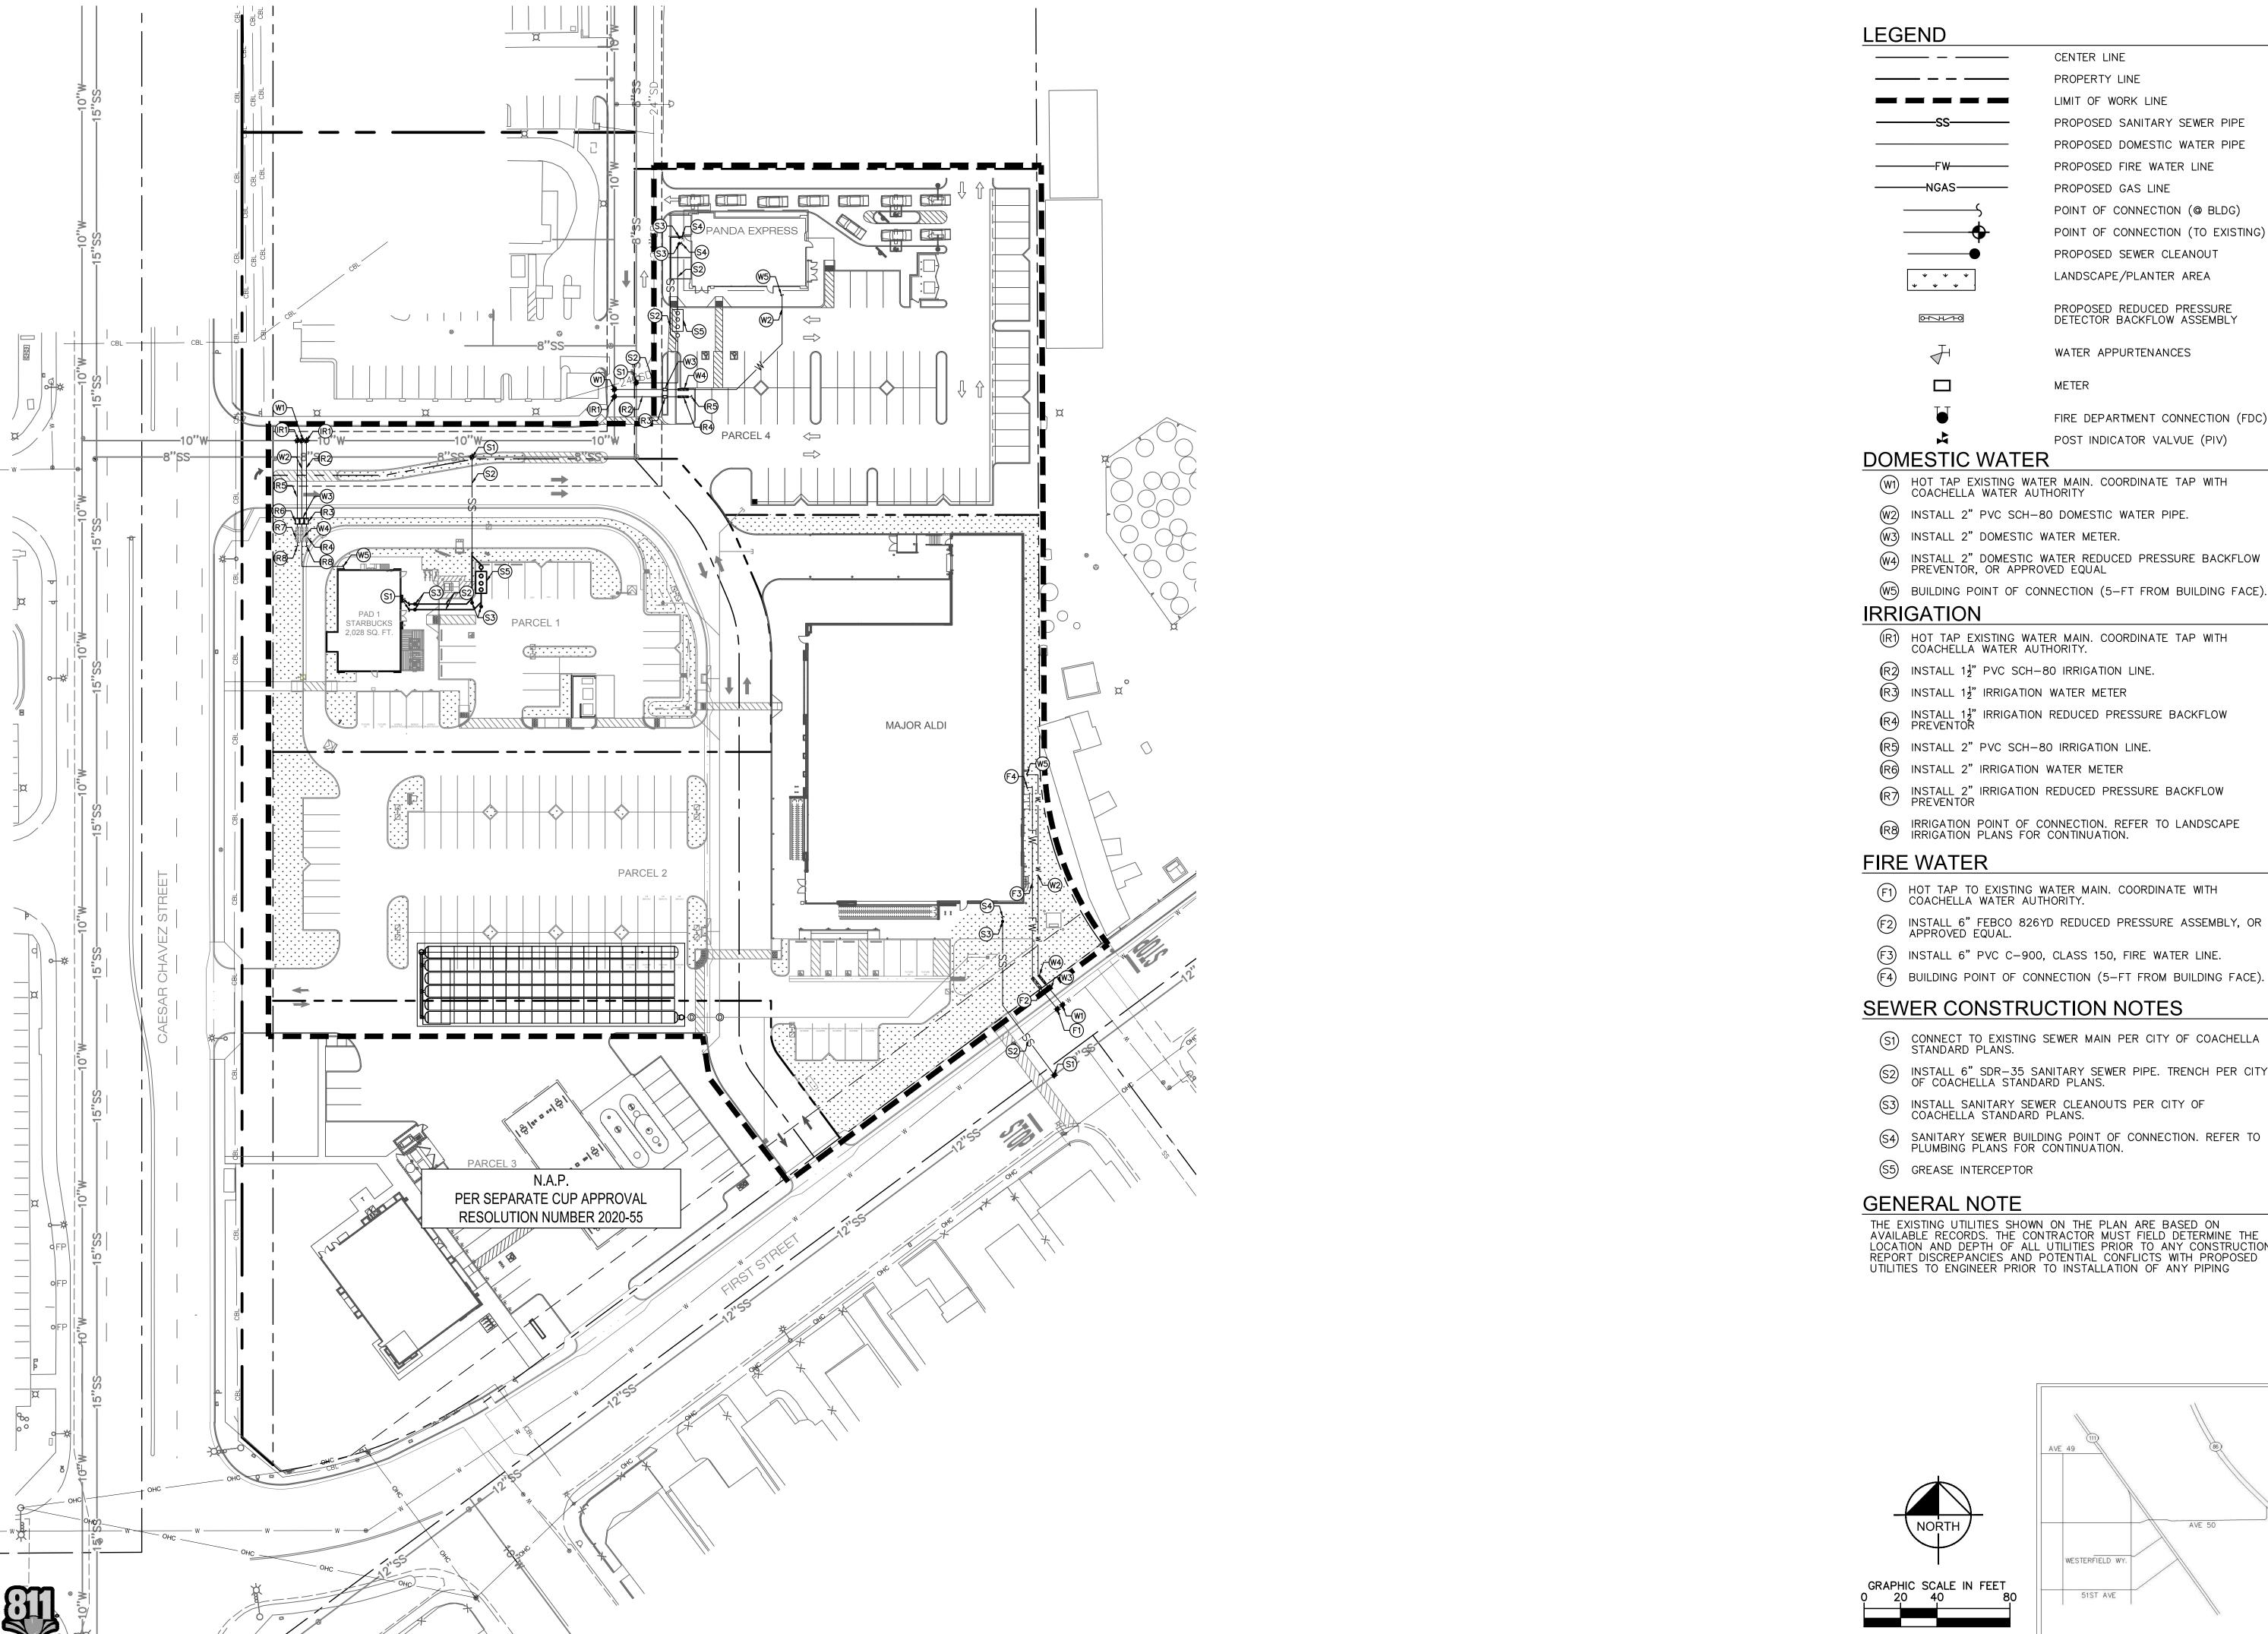

Ca 811 before you dig.

CENTER LINE PROPERTY LINE LIMIT OF WORK LINE PROPOSED SANITARY SEWER PIPE PROPOSED DOMESTIC WATER PIPE PROPOSED FIRE WATER LINE PROPOSED GAS LINE POINT OF CONNECTION (@ BLDG) POINT OF CONNECTION (TO EXISTING) PROPOSED SEWER CLEANOUT LANDSCAPE/PLANTER AREA

PROPOSED REDUCED PRESSURE DETECTOR BACKFLOW ASSEMBLY

METER

FIRE DEPARTMENT CONNECTION (FDC) POST INDICATOR VALVUE (PIV)


WATER APPURTENANCES

- W1 HOT TAP EXISTING WATER MAIN. COORDINATE TAP WITH COACHELLA WATER AUTHORITY
- (W2) INSTALL 2" PVC SCH-80 DOMESTIC WATER PIPE.
- (W3) INSTALL 2" DOMESTIC WATER METER.
- (W4) INSTALL 2" DOMESTIC WATER REDUCED PRESSURE BACKFLOW PREVENTOR, OR APPROVED EQUAL
- W5) BUILDING POINT OF CONNECTION (5-FT FROM BUILDING FACE).
- (R1) HOT TAP EXISTING WATER MAIN. COORDINATE TAP WITH COACHELLA WATER AUTHORITY.
- (R2) INSTALL $1\frac{1}{2}$ PVC SCH-80 IRRIGATION LINE.
- (R3) INSTALL $1\frac{1}{2}$ " IRRIGATION WATER METER
- R4 INSTALL 13" IRRIGATION REDUCED PRESSURE BACKFLOW PREVENTOR
- (R5) INSTALL 2" PVC SCH-80 IRRIGATION LINE.
- (R7) INSTALL 2" IRRIGATION REDUCED PRESSURE BACKFLOW PREVENTOR
- (R8) IRRIGATION POINT OF CONNECTION. REFER TO LANDSCAPE IRRIGATION PLANS FOR CONTINUATION.
- (F1) HOT TAP TO EXISTING WATER MAIN. COORDINATE WITH COACHELLA WATER AUTHORITY.
- F2 INSTALL 6" FEBCO 826YD REDUCED PRESSURE ASSEMBLY, OR APPROVED EQUAL.
- (F3) INSTALL 6" PVC C-900, CLASS 150, FIRE WATER LINE.

SEWER CONSTRUCTION NOTES

- © CONNECT TO EXISTING SEWER MAIN PER CITY OF COACHELLA STANDARD PLANS.
- (S2) INSTALL 6" SDR-35 SANITARY SEWER PIPE. TRENCH PER CITY OF COACHELLA STANDARD PLANS.
- (S3) INSTALL SANITARY SEWER CLEANOUTS PER CITY OF COACHELLA STANDARD PLANS.
- SANITARY SEWER BUILDING POINT OF CONNECTION. REFER TO PLUMBING PLANS FOR CONTINUATION.

THE EXISTING UTILITIES SHOWN ON THE PLAN ARE BASED ON AVAILABLE RECORDS. THE CONTRACTOR MUST FIELD DETERMINE THE LOCATION AND DEPTH OF ALL UTILITIES PRIOR TO ANY CONSTRUCTION. REPORT DISCREPANCIES AND POTENTIAL CONFLICTS WITH PROPOSED UTILITIES TO ENGINEER PRIOR TO INSTALLATION OF ANY PIPING

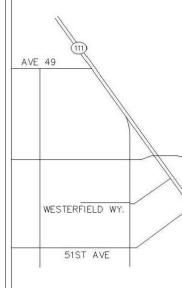

1" = 40' ONLY AT 24" X 36"

VICINITY MAP NOT TO SCALE

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PARED FOR DEVEI OUNTAINHEAD

SHEET NUMBER 2 OF 2