
Attachment 2 **→**W/D

GROUND FLOOR RCP A6-201 A6-101 SCALE: 1/4" = 1'-0"

8' - 0" BEDROOM

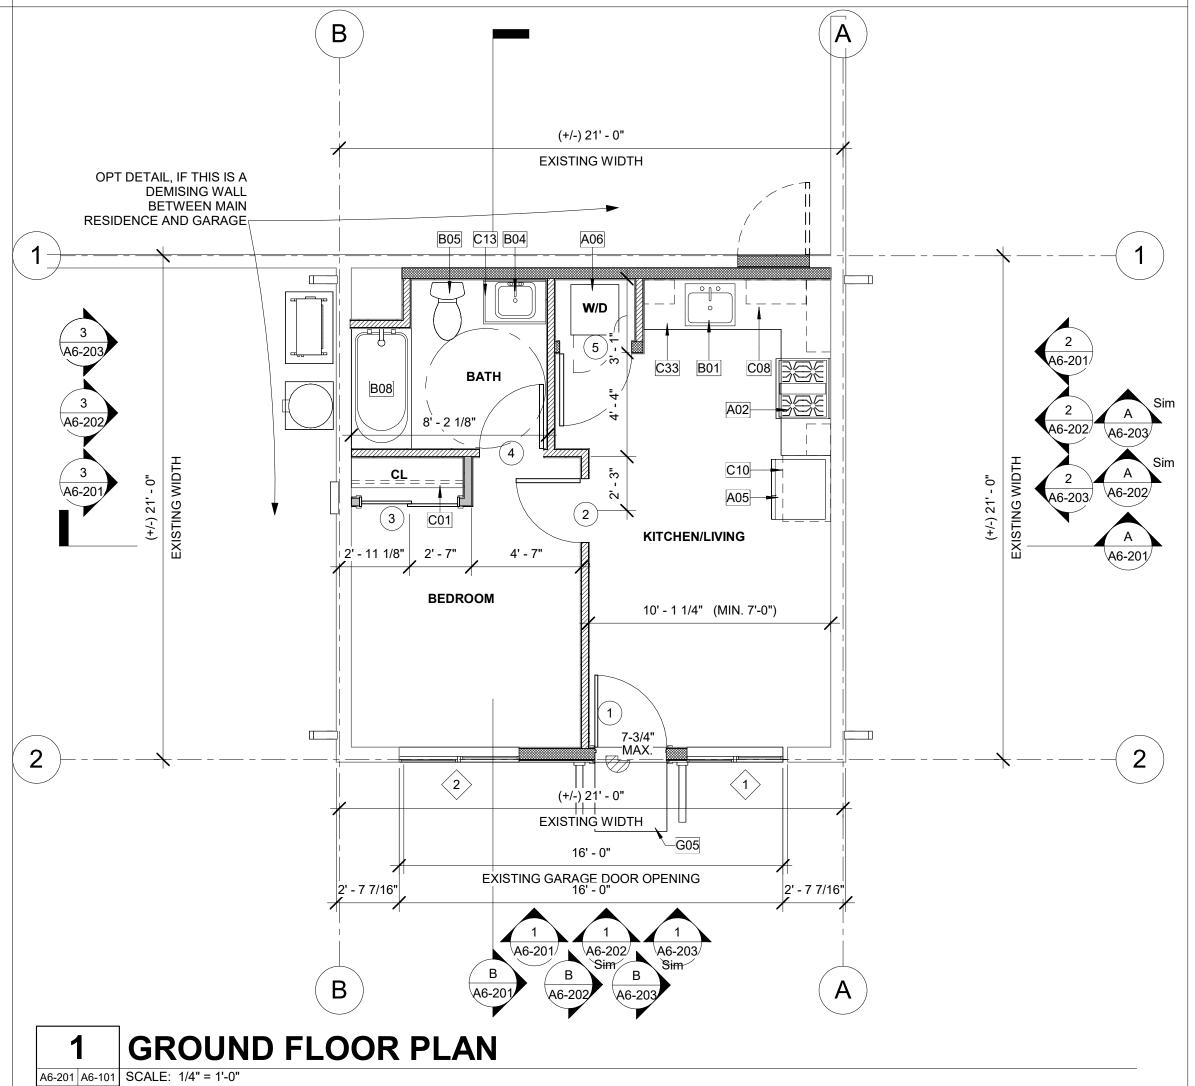

KITCHEN/LIVING

LEGEND

EXTERIOR- 5 1/2" WOOD STUD W/ PLYWOOD SHEATHING AND STUCCO/SIDING PER ELEVATION, ONE LAYER GYPSUM WALL



BOARD INTERIOR. INTERIOR- 5 1/2" WOOD STUD W/ONE LAYER GYPSUM WALL





INTERIOR- 3 1/2" WOOD STUD W/ONE LAYER GYPSUM WALL BOARD EACH SIDE.



KEYNOTES

- 30" SLIDE ELECTRIC SINGLE OVEN, STAINLESS STEEL. A05 REFRIGERATOR LOCATION. PROVIDE 37" SPACE WITH ROUGH
 - PLUMBING FOR ICE MAKER (RECESS IN WALL). STACKED WASHER/DRYER MACHINE LOCATION. PROVIDE WASTE
- AND WATER IN RECESSED WALL BOX. PROVIDE DRYER VENT. VENT TO OUTSIDE AIR THROUGH EXTERIOR WALL. DRYER VENT 4" MIN DIAMETER TO EXTERIOR WITH SCREENED AND ONE DIRECTIONAL VENT GATE. MAX LENGTH TO NOT EXCEED 14' WITH A MAX OF 2 90-DEGREE BENDS. TERMINATION SHALL BE 3' MINIMUM FROM OPERABLE OPENING IN EXTERIOR WALL.
- SINGLE COMPARTMENT UNDER-MOUNT KITCHEN SINK W/ GARBAGE DISPOSAL. REFER TO WATER EFFICIENCY REQUIREMENTS ON CALGREEN CODE NOTES SHEET.
- LAVATORY SINK. REFER TO WATER EFFICIENCY REQUIREMENTS B04 ON CALGREEN CODE NOTES SHEETS. B05 WATER CLOSET. REFER TO WATER EFFICIENCY REQUIREMENTS ON
- CALGREEN CODE NOTES SHEETS. B08 30" x 60" x 72" TUB AND SHOWER COMBINATION. MODEL BY
- BUILDER. PROVIDE SHOWER ROD. C01 SINGLE WOOD SHELF AND POLE.
 - 12" DEEP UPPER CABINET
- C10 24" DEEP UPPER CABINET. C13 34" HIGH BASE CABINET AND COUNTERTOP.
- C33 36" A.F.F. COUNTERTOP

C08

- F03 30" X 30" MIN. ATTIC ACCESS. PROVIDED SWITCH AND OUTLET AT ATTIC FOR FAU. PERMANENTLY ATTACH R-38 OR GREATER INSULATION TO ATTIC ACCESS DOOR USING ADHESIVE OR MECHANICAL FASTENERS CEnC 150.0 (a)1. PROVIDE GASKETED
- ATTIC ACCESS TO PREVENT AIR LEAKAGE CEnC 150.0 (a)1. CONCRETE STOOP. SLOPE 1/4"/FT AWAY FROM THE BUILDING. MUST BE AT LEAST AS WIDE AS DOOR AND 3' DEEP.

WINDOW GENERAL NOTES

- REFER TO FLOOR PLANS FOR WINDOW LOCATIONS. 2. CONTRACTOR TO VERIFY EXACT ROUGH OPENING SIZES PRIOR TO
- REFER TO ENERGY COMPLIANCE REPORTS FOR U-FACTOR, SHGC AND
- ADDITIONAL WINDOW REQUIREMENTS. ALL GLAZING IS DOUBLE PANE UNLESS OTHERWISE NOTED.
- EGRESS WINDOWS SHALL HAVE A CLEAR OPENING WITH A MAX. SILL HEIGHT OF 44" AFF, MIN. NET CLEAR OPENING FOR EMERGENCY ESCAPE SHALL BE 5.7 S.F. EXCEPT: 5 S.F. MIN. AT GROUND FLOOR. MINIMUM NET CLEAR OPENING DIMENSIONS: HEIGHT: 24", WIDTH: 20". [2022 CRC SEC. R310.2]


WINDOW SCHEDULE

		SIZE		HEAD	
NO.	TYPE	WIDTH	HEIGHT	HEIGHT	REMARKS
1	Α	4' - 0"	4' - 6"	6' - 8"	
2	Α	5' - 0"	4' - 6"	6' - 8"	1

WINDOW REMARKS

- THE MINIMUM NET CLEAR OPENING HEIGHT DIMENSION SHALL BE 24 INCHES. THE MINIMUM NET CLEAR OPENING WIDTH DIMENSION SHALL BE 20 INCHES THE NET CLEAR OPENING DIMENSIONS SHALL BE THE RESULT OF NORMAL OPERATION OF THE OPENING. PER CBC 2022 SEC. 1031.3.2 SHALL HAVE THE BOTTOM OF THE CLEAR OPENING NOT GREATER THAN 44
- INCHES MEASURED FROM THE FLOOR. PER CBC 2022 SEC. 1031.3.3 TEMPERED / SAFETY GLAZING.


WINDOW LEGEND

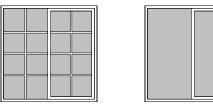






HORIZONTAL SLIDER

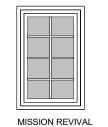

CASEMENT

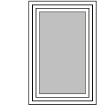

FLOOR PLAN NOTES

- 1. DIMENSIONS ARE TO FACE OF FRAMING U.N.O
- 2. REFER TO STRUCTURAL PLANS FOR FURTHER FRAMING INFORMATION. 3. REFER TO ELECTRICAL & MECHANICAL PLANS FOR FURTHER INFORMATION.
- 4. ALL FURNITURE AND EQUIPMENT IS BY OWNER AND IS SHOWN FOR
- COORDINATION PURPOSES ONLY. 5. FLOOR FINISHES TO BE DETERMINED BY THE PROPERTY OWNER.
- 6. SHOWER COMPARTMENTS AND WALLS ABOVE BATHTUBS WITH INSTALLED SHOWER HEADS SHALL BE FINISHED WITH A SMOOTH, NONABSORBENT SURFACE TO A HEIGHT NOT LESS THAN 72" ABOVE THE DRAIN INLET.
- PROVIDE ADEQUATE BLOCKING IN WALLS FOR CABINETS AND OTHER WALL MOUNTED ACCESSORIES INCLUDING BUT NOT LIMITED TO HANDRAILS, SHELVING AND BATHROOM FIXTURES.
- PROVIDE FIRE BLOCKING FOR WALL CAVITIES THAT EXCEED CBC HEIGHT LIMITATION.

RCP NOTES

- 1. HEIGHT OF CEILINGS SHALL BE MEASURED FROM TOP OF SLAB TO FINISH FACE OF GWB OR FACE OF CEILING GRID AS INDICATED ON THE REFLECTED CEILING
- 2. ALL LIGHT FIXTURES ARE TO BE INSTALLED ACCORDING TO THE ARCHITECTURAL ELECTRICAL PLAN.
- 3. REFER TO ARCHITECTURAL ELECTRICAL PLANS FOR FURTHER INFORMATION.
- 4. REFER TO MECHANICAL PLANS FOR FURTHER INFORMATION.
- 5. REFER TO FLOOR PLAN FOR ELEVATION AND SECTION REFERENCES.

AREAS

AREAS-PLAN 5	
SPACE	CONDITIONED AREA
PLAN 5-EXISTING FOOTPRINT OF GARAGE, AS SHOWN IN VIEW 1/A7-101	441 SF

DOOR GENERAL NOTES

- REFER TO GENERAL NOTES SHEET G-102 FOR ADDITIONAL REQUIREMENTS REFER TO PLANS FOR LOCATION OF DOORS. 3. VERIFY ROUGH OPENING SIZE WITH DOOR MANUFACTURER SPECIFICATIONS
- PRIOR TO CONSTRUCTION. 4. CONTRACTOR TO VERIFY ACTUAL DOOR SIZE TO FIT FINISH OPENING PRIOR
- TO FABRICATION OF DOOR AND FINISH OPENING. OPENINGS BETWEEN THE GARAGE AND RESIDENCE SHALL BE EQUIPPED WITH SOLID WOOD DOORS NOT LESS THAN 13/8 INCHES (35 MM) IN THICKNESS, SOLID OR HONEYCOMB-CORE STEEL DOORS NOT LESS THAN 13/8 INCHES (35 MM) THICK, OR 20-MINUTE FIRE-RATED DOORS **2022 CRC** SECTION R302.5.1. DOORS SHALL BE SELFLATCHING AND EQUIPPED WITH A
- SELF-CLOSING OR AUTOMATICCLOSING DEVICE. 6. GLAZING IN DOORS SHALL BE TEMPERED PER **SECTION R308.4.1**.


DOOR SCHEDULE


		S	SIZE		
NO.	TYPE	WIDTH	HEIGHT	FIRE RATING	REMARKS
1	С	3' - 0"	6' - 8"		2, 4
2	С	2' - 8"	6' - 8"		
3	D	4' - 0"	6' - 8"		
4	С	2' - 8"	6' - 8"		
5	С	3' - 0"	6' - 8"		3

DOOR REMARKS


- 1. FIRE RATED DOOR, REFER TO GENERAL DOOR NOTE #5
- GLAZING IN DOOR. TEMPERED (BOTH PANES) PROVIDE 100 SQ INCHES OF VENTING IN DOOR OR BY OTHER APPROVED
- 4. OPTIONAL DOOR

DOOR LEGEND

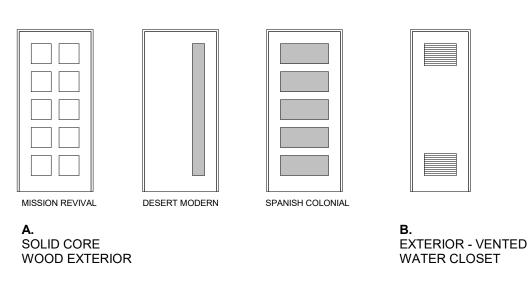

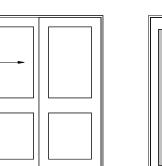

DOUBLE SLIDING SINGLE HOLLOW CORE INTERIOR

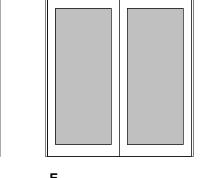

SLIDING GLASS

EXTERIOR.

A6-101

ALEX MARTINEZ RYAN JENKINS

PROJECT MANAGER

RANDALL RUSSOM DRAWN BY

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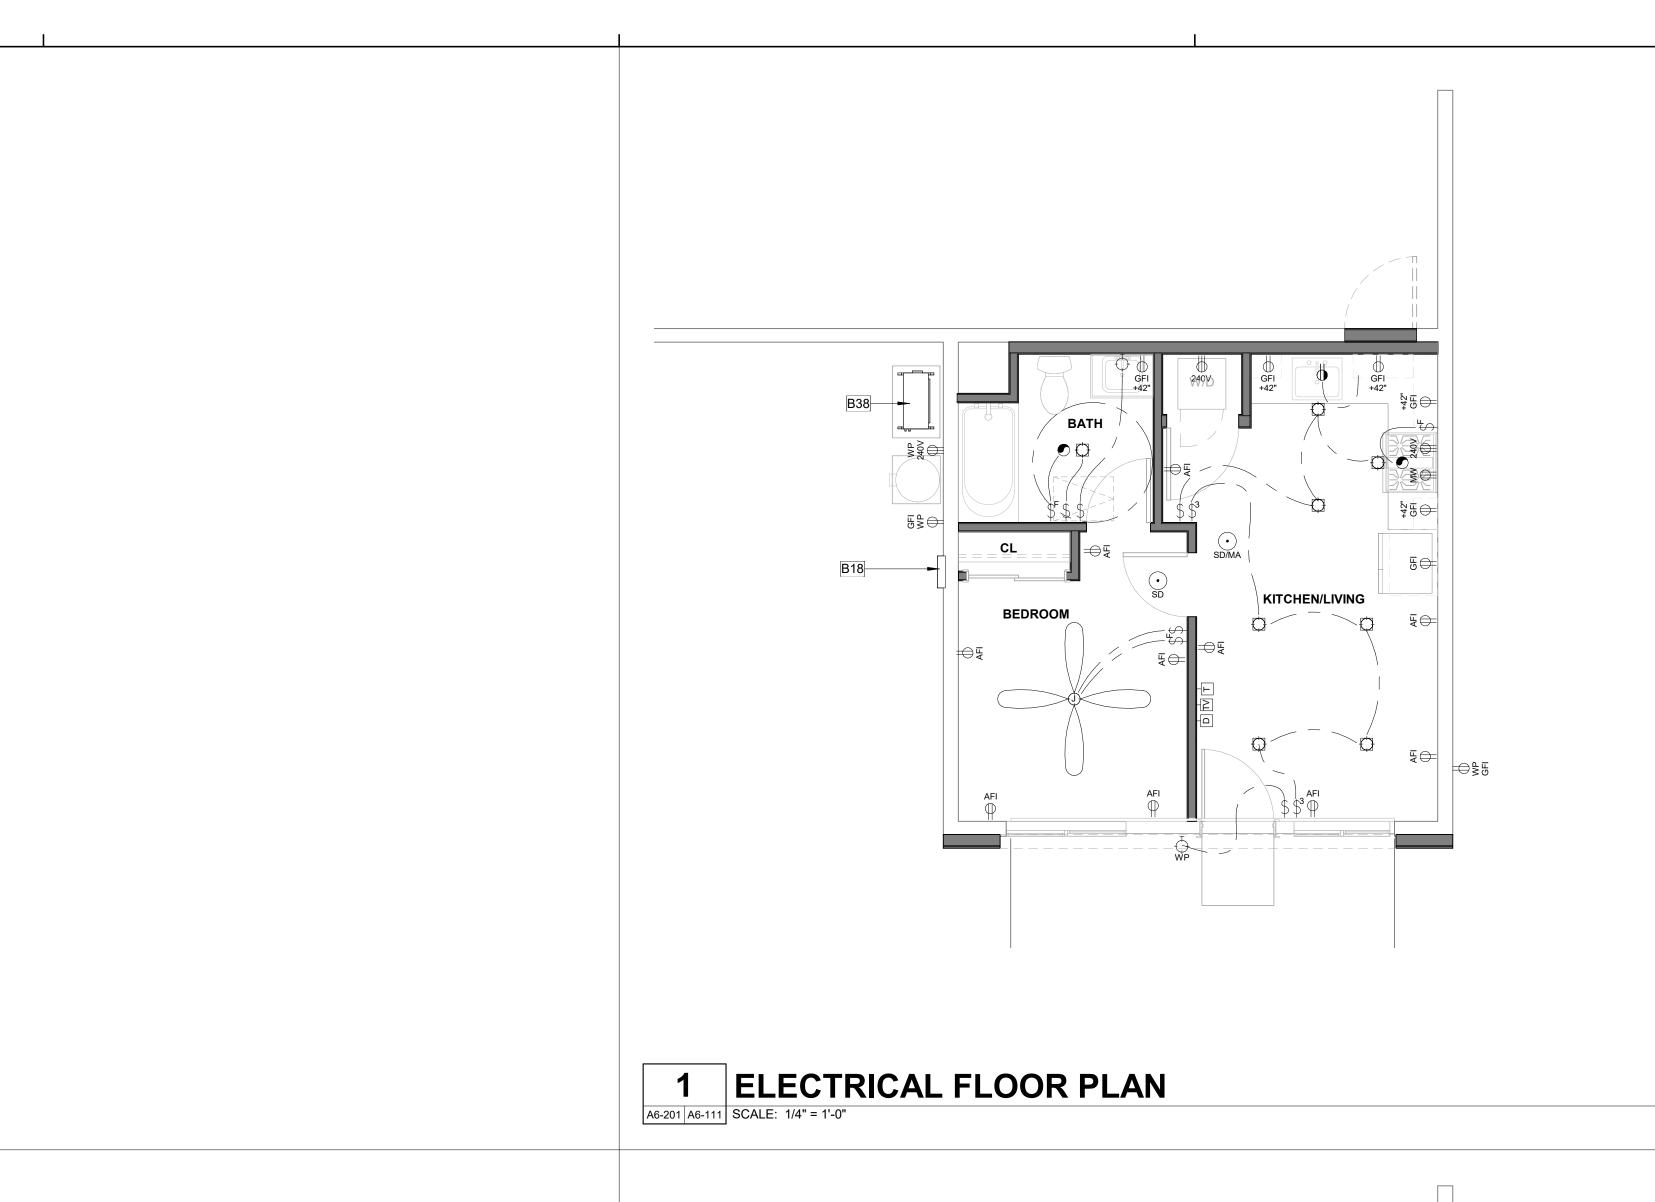
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NO. REVISION

SUBMITT

09/20/23 **PROJECT NUMBER**

2516-01-UR19



UTILITY GENERAL NOTES

1. REFER TO GENERAL NOTES SHEET G-102 FOR ADDITIONAL REQUIREMENTS. 2. SEE DETAILS FOR ADDITIONAL INFORMATION AND REQUIREMENTS. 3. SEE TITLE 24 REPORTS FOR ADDITIONAL INFORMATION.

KEYNOTES

ELECTRIC PANEL TBD.

MULTI-ZONE HEAT PUMP CONDENSING UNIT. REFER TO PLANS FOR LOCATION OF INDOOR FAN FAN COIL UNITS. REFER TO TITLE 24 FOR ADDITIONAL INFORMATION. PROVIDE CONCRETE PAD MIN. 6" LARGER THAN UNIT IN EACH DIRECTION, 3" MIN. ABOVE GRADE.

VENTILATION SUMMARIES

PER ASHRAE Standard 62.2, Table 7.1 (Perscriptive Duct Sizing Requirements) (Table 7.1 Assumes no elbows. Deduct 15-feet of allowable duct length for each turn, elbow or fitting. Fan rating cfm @ 0.25 in w.g., and rated at less than one sone.)

LOCAL VENTILATION RATE SUMMARY - BATHROOM(S) Bathroom Minimum Fan Flow (cfm) = 50 cfm Per Table 7.1, Duct Size = 4" Diameter; Flex Duct Maximun Allowable Duct Lenghth (ft) =70'

LOCAL VENTILATION RATE SUMMARY - KITCHEN Kitchen Minimum Fan Flow (cfm) = 100 cfm

DWELLING UNIT FLOOR AREA (ft2)	HOOD OVER ELECTRIC RANGE	HOOD OVER NATURAL GAS
<750	150 CFM	280 CFM

TABLE 150.0-H			
5 PARAMETER	HOOD OVER ELEC. RANGE	HOOD OVER NAT. GAS RANGE	
FAN AIRFLOW, CFM AT MINIMUM STATIC PRESSURE 0.25 IN WATER	<175	<350	
MINIMUM DUCT DIAMETER, IN FOR RIGID DUCT	7	9	
MINIMUM DUCT DIAMETER, IN FOR	7	9	

Maximun Allowable Duct Lenghth (ft) = 85 Feet

LOCAL VENTILATION RATE SUMMARY - INDOOR AIR QUALITY Per ASHRAE Standard 62.2, CEC Equation 150.0-B

TOTAL REQUIRED VENTILATION RATE Qcfm= .03(floor area) + 7.5 (# of bedrooms + 1)

<u>STUDIO</u> Qcfm = .03(205) + 7.5 (0 + 1) Qcfm = 13.65

DUCT SIZE PER ASHRAE TABLE 7.1 REFER TO LEGEND FOR INDOOR AIR QUALITY FAN (IAQ)

CONTINOUS FAN FLOW (CFM) = 50 CFM

Maximun Allowable Duct Lenghth (ft) = 70'

Per Table 7.1, Duct Size= 4" Diameter; Smooth duct Maximun Allowable Duct Lenghth (ft) = 35' Per Table 7.1, Duct Size= 5" Diameter; FLEX DUCT

ELECTRICAL LEGEND

NOTE: ALL OUTDOOR OUTLETS SHALL HAVE GFCI PROTECTION AND WEATHERPROOF COVERS. **DUPLEX OUTLET** ELECTRICAL SMOKE ARC-FAULT SWITCH SD DETECTOR/ALARM ELECTRICAL INTERRUPTER • COMBINATION

VACANCY SENSOR

\$\frac{1}{5}\$ ELECTRICAL SWITCH-FAN EXHAUST FAN


SWITCH-

→ WALL MOUNTED HIGH-EFFICACY LIGHT RECESSED HIGH-EFFICACY DOWNLIGHT RECESSED

VP HIGH-EFFICACY

VAPOR PROOF ELECTRICAL

DOWNLIGHT

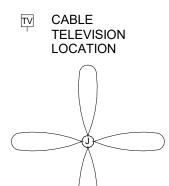

FAN ONLY)

SD/MA SMOKE/CARBON

LOCATION

TELEPHONE

MONOXIDE

COLD WATER STUB OUT HW HOT WATER STUB OUT HB WATER HOSE BIBB WATER HOSE BIBB CEILING FAN OPTIONAL (PRE WIRE FOR CEILING



DUPLEX OUTLET 240 VOLTS

DUPLEX OUTLET

GROUND FAULT INTERRUPTER

DUPLEX OUTLET

WATERPROOF

GROUND FAULT

INTERRUPTER

AFCI-HALF HOT

DUPLEX OUTLET

DU VERSION ELECTRIC, AN 6 R O S G A

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AGENCY

NO.	REVISION	DATE
1		

CHECKED BY

SUBMITT

09/20/23 **PROJECT NUMBER**

RANDALL RUSSOM

DRAWN BY

2516-01-UR19

A6-1


ALEX MARTINEZ RYAN JENKINS

2 MECHANICAL FLOOR PLAN A6-201 A6-111 SCALE: 1/4" = 1'-0"

BEDROOM

KITCHEN/LIVING

Attachment 2

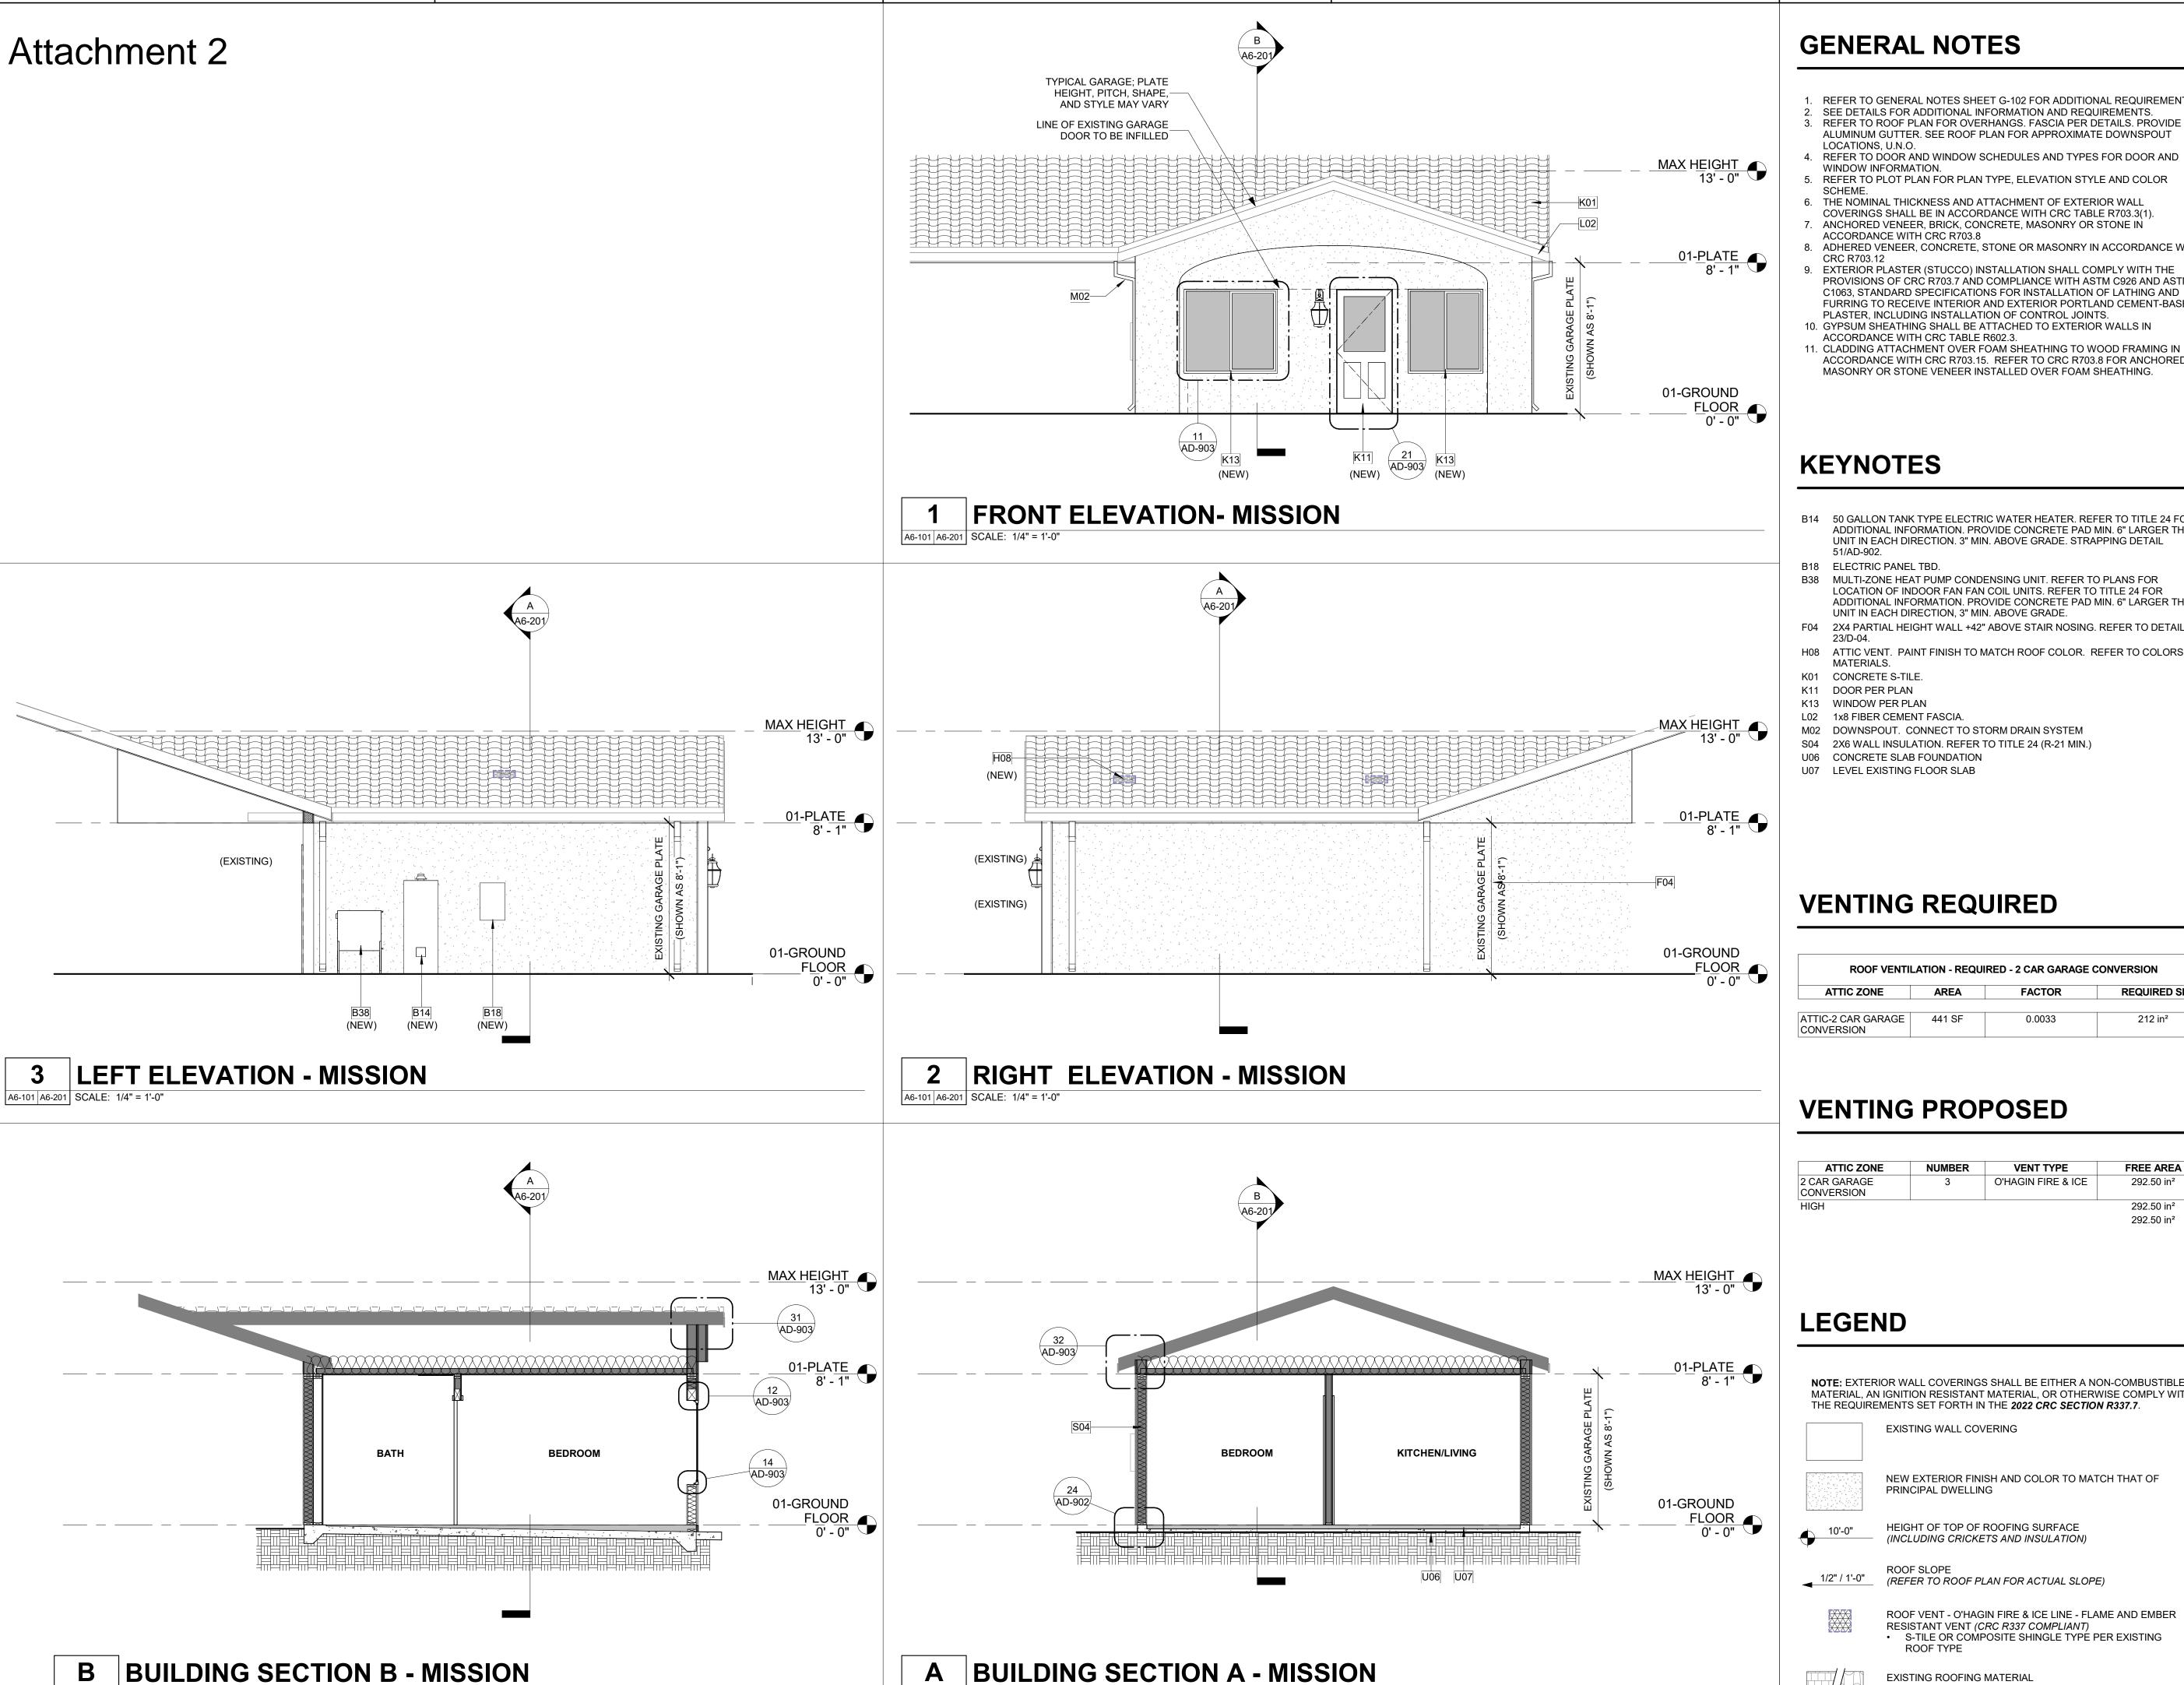

A2 A6-201 SCALE: 1/4" = 1'-0"

A2 A6-201 SCALE: 1/4" = 1'-0"

GENERAL NOTES

- REFER TO GENERAL NOTES SHEET G-102 FOR ADDITIONAL REQUIREMENTS 2. SEE DETAILS FOR ADDITIONAL INFORMATION AND REQUIREMENTS. 3. REFER TO ROOF PLAN FOR OVERHANGS. FASCIA PER DETAILS. PROVIDE
- ALUMINUM GUTTER. SEE ROOF PLAN FOR APPROXIMATE DOWNSPOUT LOCATIONS, U.N.O.
- WINDOW INFORMATION. REFER TO PLOT PLAN FOR PLAN TYPE, ELEVATION STYLE AND COLOR
- THE NOMINAL THICKNESS AND ATTACHMENT OF EXTERIOR WALL
- COVERINGS SHALL BE IN ACCORDANCE WITH CRC TABLE R703.3(1). 7. ANCHORED VENEER, BRICK, CONCRETE, MASONRY OR STONE IN
- 8. ADHERED VENEER, CONCRETE, STONE OR MASONRY IN ACCORDANCE WITH
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- 10. GYPSUM SHEATHING SHALL BE ATTACHED TO EXTERIOR WALLS IN ACCORDANCE WITH CRC TABLE R602.3.
- 11. CLADDING ATTACHMENT OVER FOAM SHEATHING TO WOOD FRAMING IN ACCORDANCE WITH CRC R703.15. REFER TO CRC R703.8 FOR ANCHORED MASONRY OR STONE VENEER INSTALLED OVER FOAM SHEATHING.

KEYNOTES

- B14 50 GALLON TANK TYPE ELECTRIC WATER HEATER. REFER TO TITLE 24 FOR ADDITIONAL INFORMATION. PROVIDE CONCRETE PAD MIN. 6" LARGER THAN UNIT IN EACH DIRECTION. 3" MIN. ABOVE GRADE. STRAPPING DETAIL
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- F04 2X4 PARTIAL HEIGHT WALL +42" ABOVE STAIR NOSING. REFER TO DETAIL
- H08 ATTIC VENT. PAINT FINISH TO MATCH ROOF COLOR. REFER TO COLORS AND MATERIALS.
- K01 CONCRETE S-TILE.
- K13 WINDOW PER PLAN
- M02 DOWNSPOUT. CONNECT TO STORM DRAIN SYSTEM
- S04 2X6 WALL INSULATION. REFER TO TITLE 24 (R-21 MIN.)
- U06 CONCRETE SLAB FOUNDATION U07 LEVEL EXISTING FLOOR SLAB

VENTING REQUIRED

ROOF VENTILATION - REQUIRED - 2 CAR GARAGE CONVERSION			
ATTIC ZONE	AREA	FACTOR	REQUIRED SI
ATTIC-2 CAR GARAGE CONVERSION	441 SF	0.0033	212 in²

VENTING PROPOSED

ATTIC ZONE	NUMBER	VENT TYPE	FREE AREA
2 CAR GARAGE CONVERSION	3	O'HAGIN FIRE & ICE	292.50 in ²
HIGH			292.50 in ²
			292.50 in ²

LEGEND

NOTE: EXTERIOR WALL COVERINGS SHALL BE EITHER A NON-COMBUSTIBLE MATERIAL, AN IGNITION RESISTANT MATERIAL, OR OTHERWISE COMPLY WITH THE REQUIREMENTS SET FORTH IN THE 2022 CRC SECTION R337.7

EXISTING WALL COVERING

NEW EXTERIOR FINISH AND COLOR TO MATCH THAT OF PRINCIPAL DWELLING

HEIGHT OF TOP OF ROOFING SURFACE (INCLUDING CRICKETS AND INSULATION)

ROOF SLOPE (REFER TO ROOF PLAN FOR ACTUAL SLOPE)

ROOF VENT - O'HAGIN FIRE & ICE LINE - FLAME AND EMBER RESISTANT VENT (CRC R337 COMPLIANT)

• S-TILE OR COMPOSITE SHINGLE TYPE PER EXISTING



EXISTING ROOFING MATERIAL

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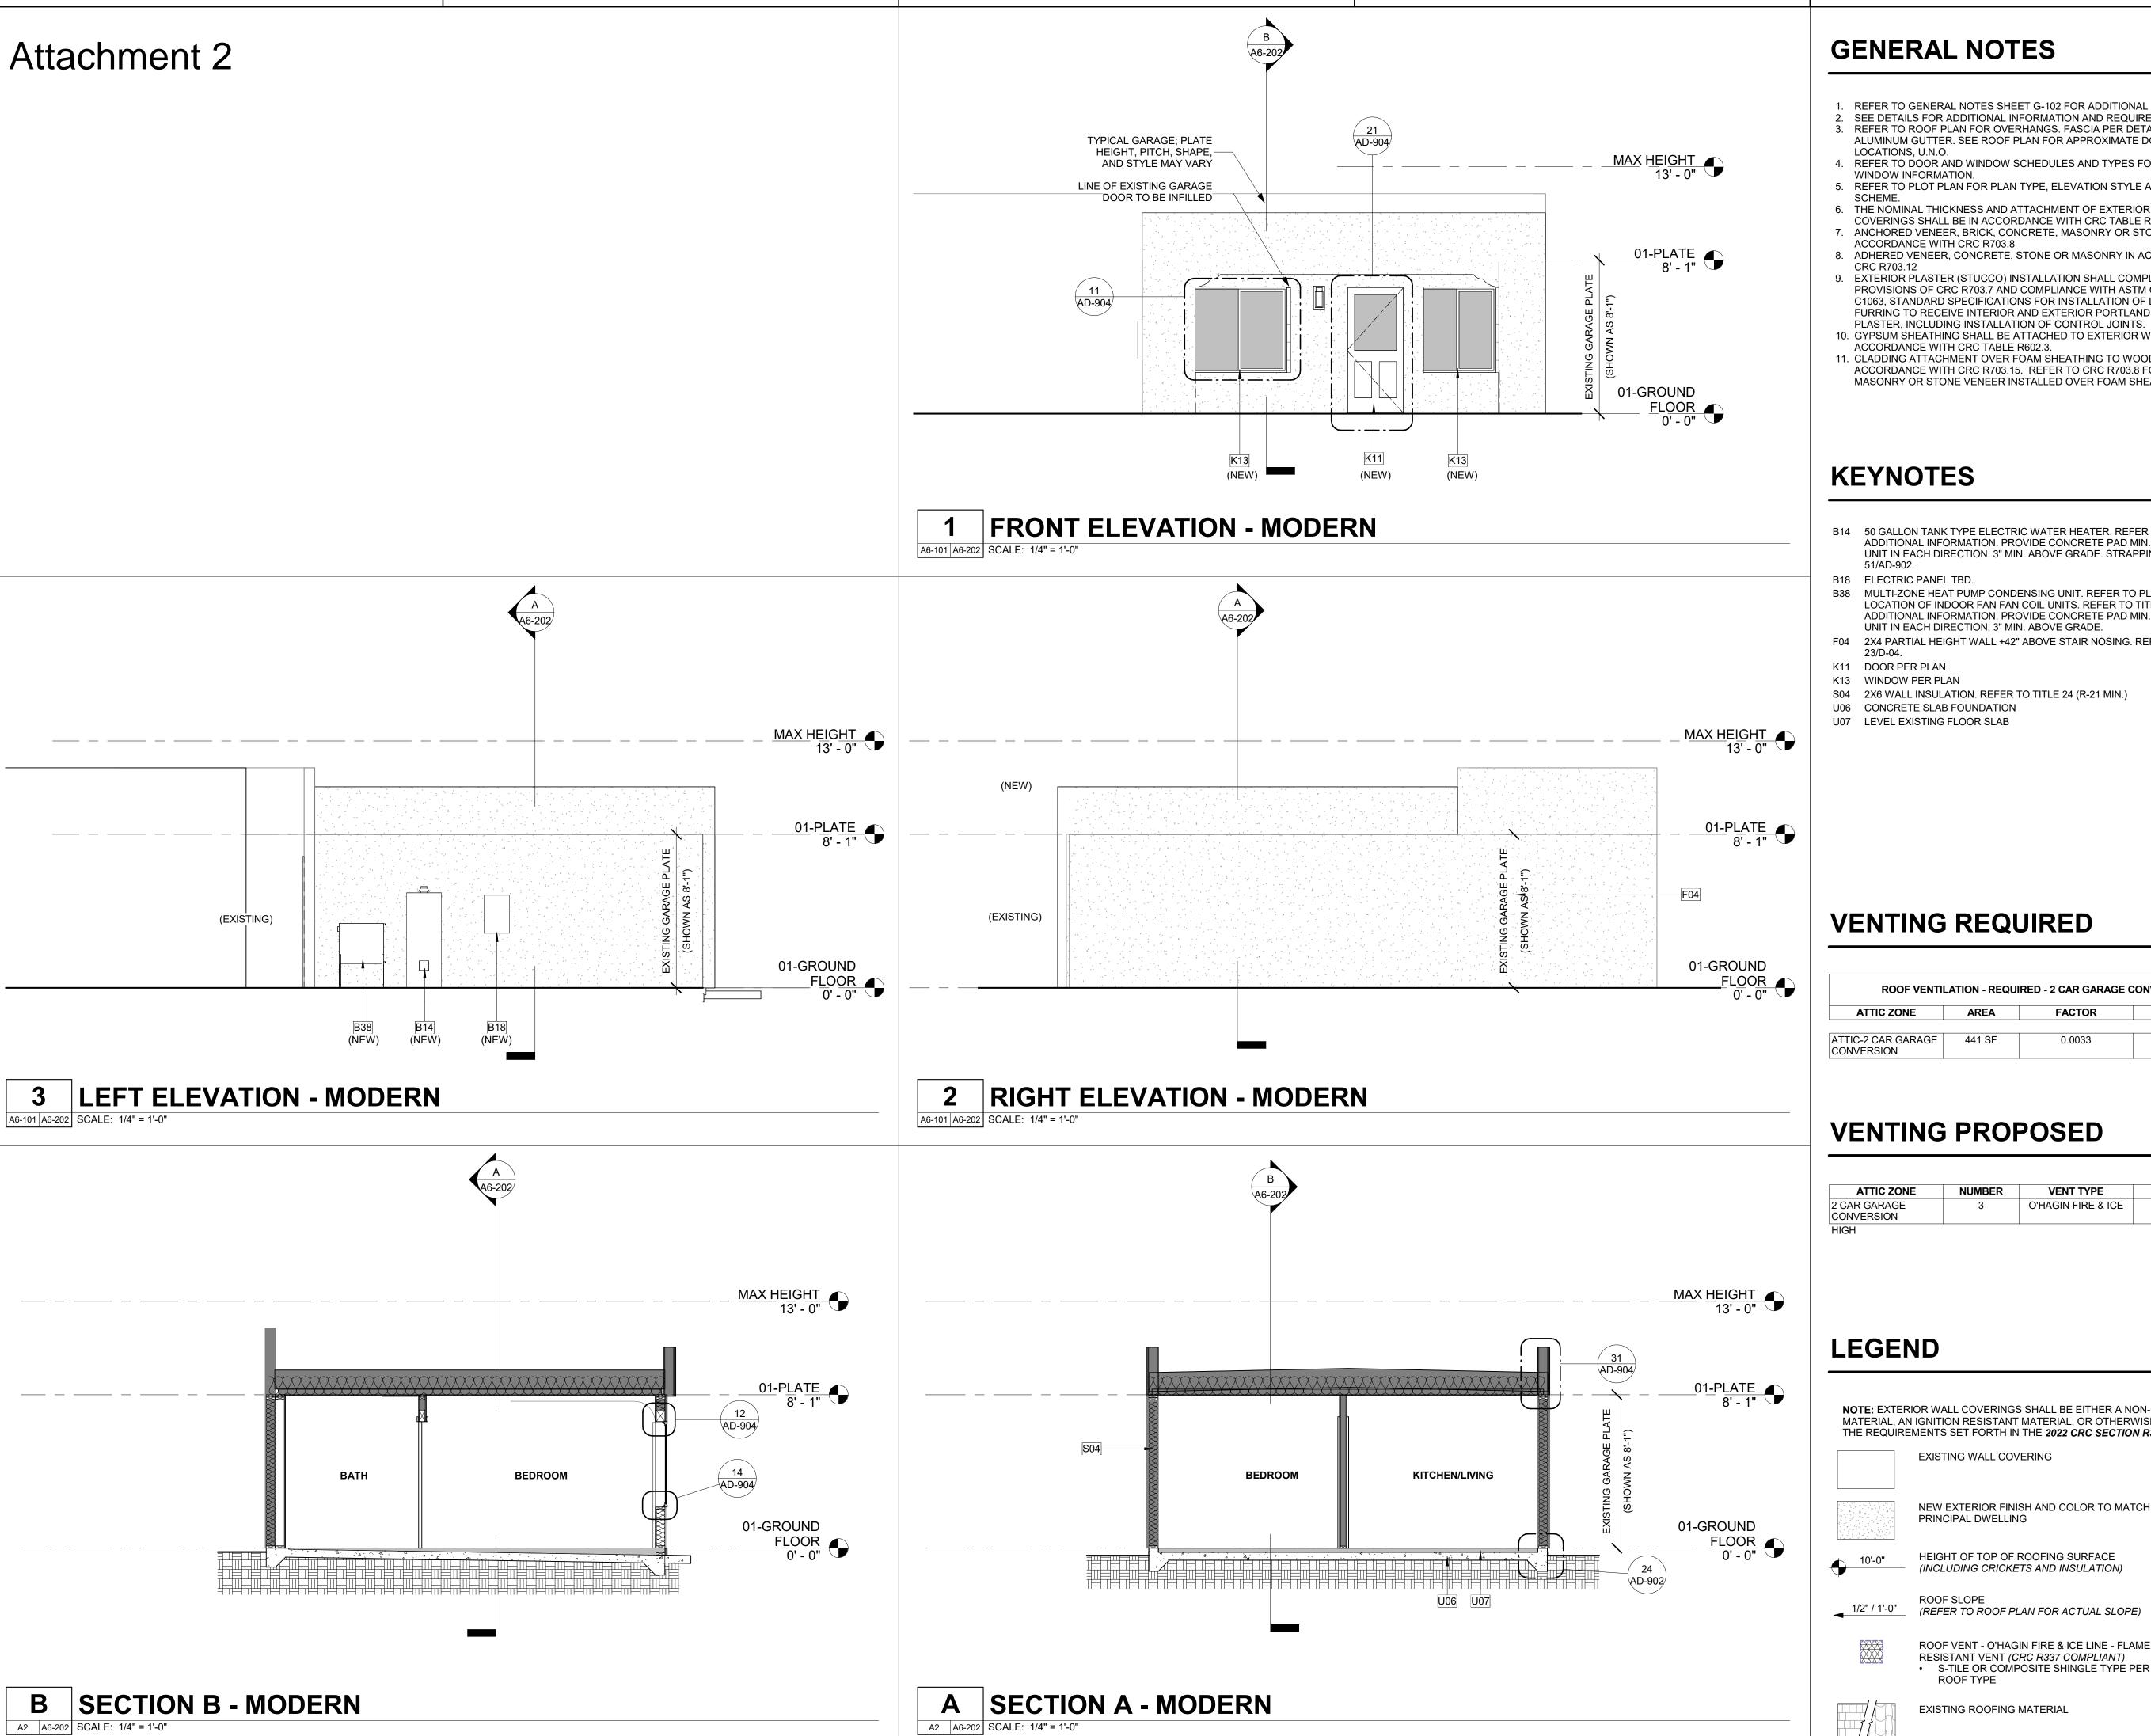
AGENCY

NO. REVISION **PROJECT MANAGER** ALEX MARTINEZ RYAN JENKINS

SUBMITT

2516-01-UR19 A6-201

09/20/23 PROJECT NUMBER



GENERAL NOTES

- 1. REFER TO GENERAL NOTES SHEET G-102 FOR ADDITIONAL REQUIREMENTS 2. SEE DETAILS FOR ADDITIONAL INFORMATION AND REQUIREMENTS. 3. REFER TO ROOF PLAN FOR OVERHANGS. FASCIA PER DETAILS. PROVIDE
- ALUMINUM GUTTER. SEE ROOF PLAN FOR APPROXIMATE DOWNSPOUT LOCATIONS, U.N.O.
- 4. REFER TO DOOR AND WINDOW SCHEDULES AND TYPES FOR DOOR AND WINDOW INFORMATION.
- REFER TO PLOT PLAN FOR PLAN TYPE, ELEVATION STYLE AND COLOR
- 6. THE NOMINAL THICKNESS AND ATTACHMENT OF EXTERIOR WALL COVERINGS SHALL BE IN ACCORDANCE WITH CRC TABLE R703.3(1). 7. ANCHORED VENEER, BRICK, CONCRETE, MASONRY OR STONE IN
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- F04 2X4 PARTIAL HEIGHT WALL +42" ABOVE STAIR NOSING. REFER TO DETAIL
- K11 DOOR PER PLAN
- K13 WINDOW PER PLAN
- S04 2X6 WALL INSULATION. REFER TO TITLE 24 (R-21 MIN.)
- U06 CONCRETE SLAB FOUNDATION
- U07 LEVEL EXISTING FLOOR SLAB

VENTING REQUIRED

ROOF VENTILATION - REQUIRED - 2 CAR GARAGE CONVERSION				
ATTIC ZONE	AREA	FACTOR	REQUIRED SI	
ATTIC-2 CAR GARAGE CONVERSION	441 SF	0.0033	212 in²	

VENTING PROPOSED

ATTIC ZONE	NUMBER	VENT TYPE	FREE AREA
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HIGH	•		292.50 in ²
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NEW EXTERIOR FINISH AND COLOR TO MATCH THAT OF PRINCIPAL DWELLING

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• S-TILE OR COMPOSITE SHINGLE TYPE PER EXISTING



EXISTING ROOFING MATERIAL

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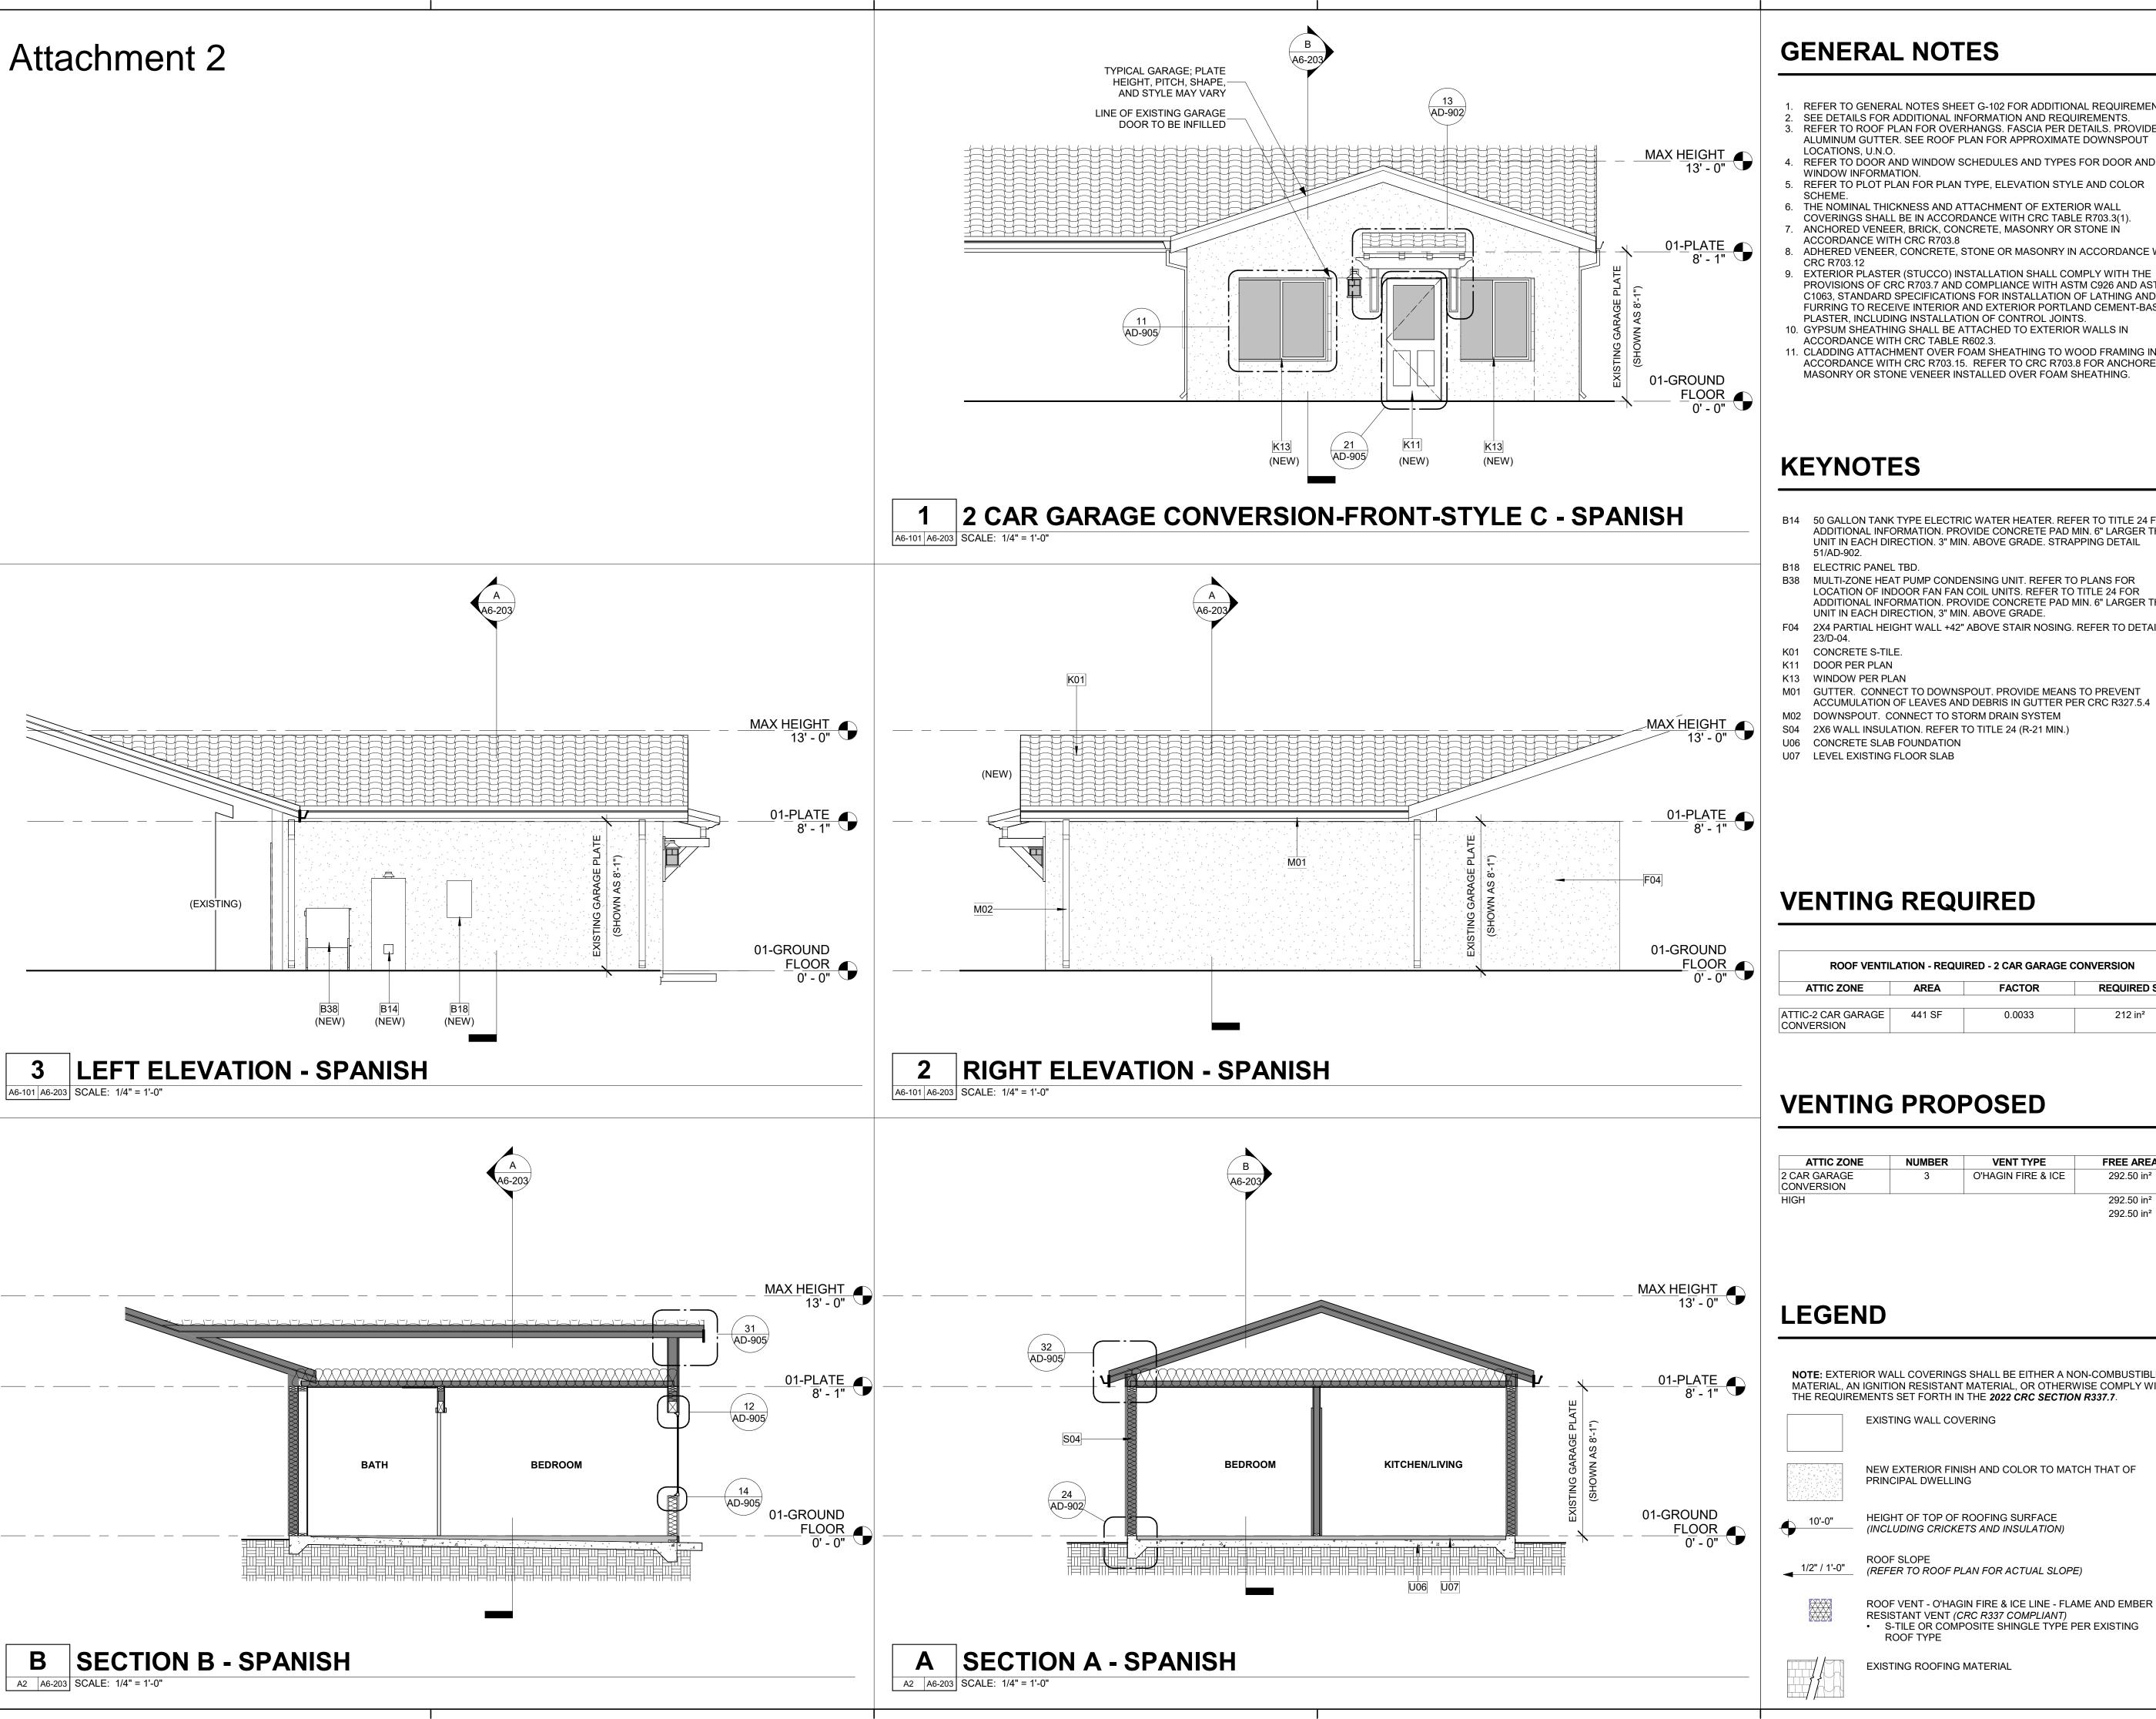
PROJECT MANAGER

ALEX MARTINEZ RYAN JENKINS SUBMITT 09/20/23

PROJECT NUMBER 2516-01-UR19

NO. REVISION

A6-202



GENERAL NOTES

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NEW EXTERIOR FINISH AND COLOR TO MATCH THAT OF PRINCIPAL DWELLING

HEIGHT OF TOP OF ROOFING SURFACE (INCLUDING CRICKETS AND INSULATION)

ROOF SLOPE (REFER TO ROOF PLAN FOR ACTUAL SLOPE) ROOF VENT - O'HAGIN FIRE & ICE LINE - FLAME AND EMBER

EXISTING ROOFING MATERIAL

ADU COVERSION 9 $\approx \frac{1}{2}$ ELEVATIONS ECTIONS - PLA PROTOTYPE A EXTERIOR BUILDING SE

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CONSULTANT

AGENCY

NO.	REVISION		DATE
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	•		

SUBMITT

09/20/23 PROJECT NUMBER 2516-01-UR19

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