
PLANS DESIGNED TO THE 2018 NORTH CAROLINA STATE RESIDENTIAL BUILDING CODE

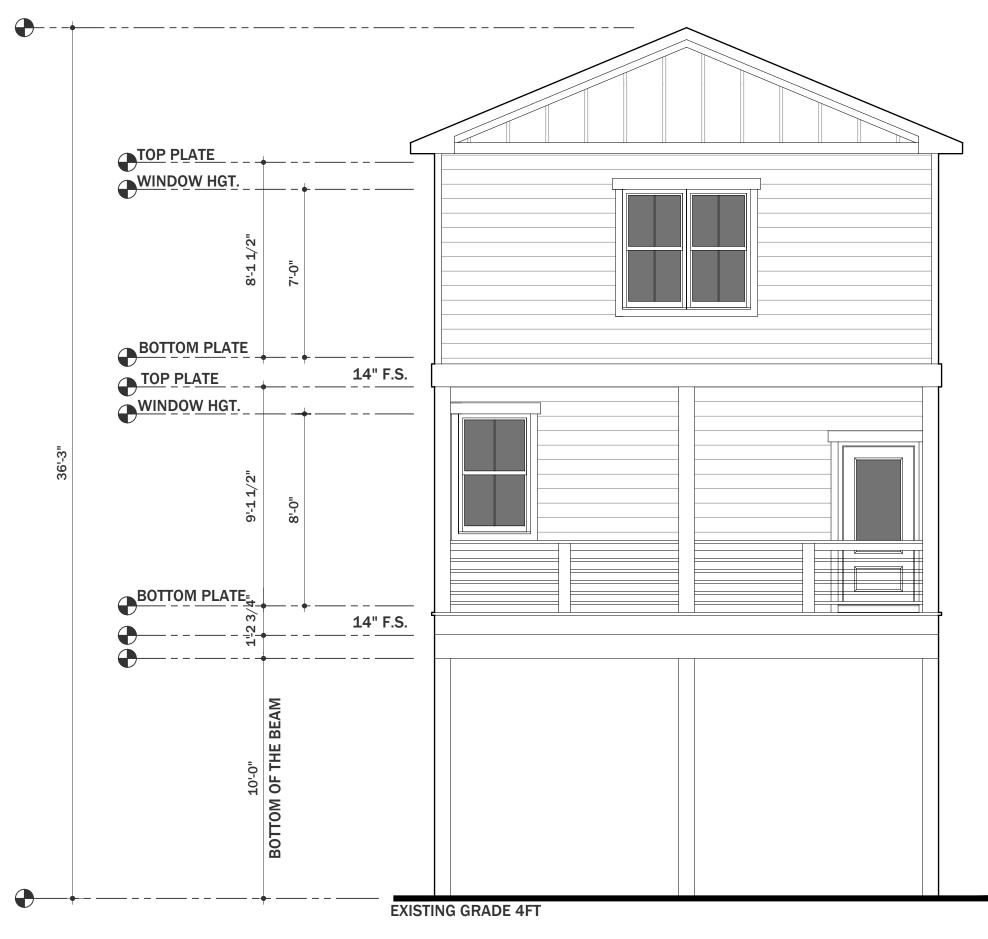

1 / A1.0


ELEVATION: front

GENERAL ELEVATION NOTES:

- 1. ROOF OVERHANGS ARE 12" UNLESS NOTED OTHERWISE.
- 2. PROVIDE FOUNDATION AND ROOF VENTS AS REQUIRED BY STATE BUILDING CODE.
- 3. PROVIDE STEPS TO FINISH FLOOR LEVEL AS REQUIRED BY STATE BUILDING CODES.
- 4. SECOND FLOOR WINDOWS TO BE 24" ABOVE FINISH FLOOR.


HIGH WIND ZONES

INFORMATION ON THIS PLAN
IS FOR CONSTRUCTION IN 150
MPH WIND ZONE,
SEE CHAPTER 45 NORTH
CAROLINA RESIDENTIAL
BUILDING CODE EDITION 2018

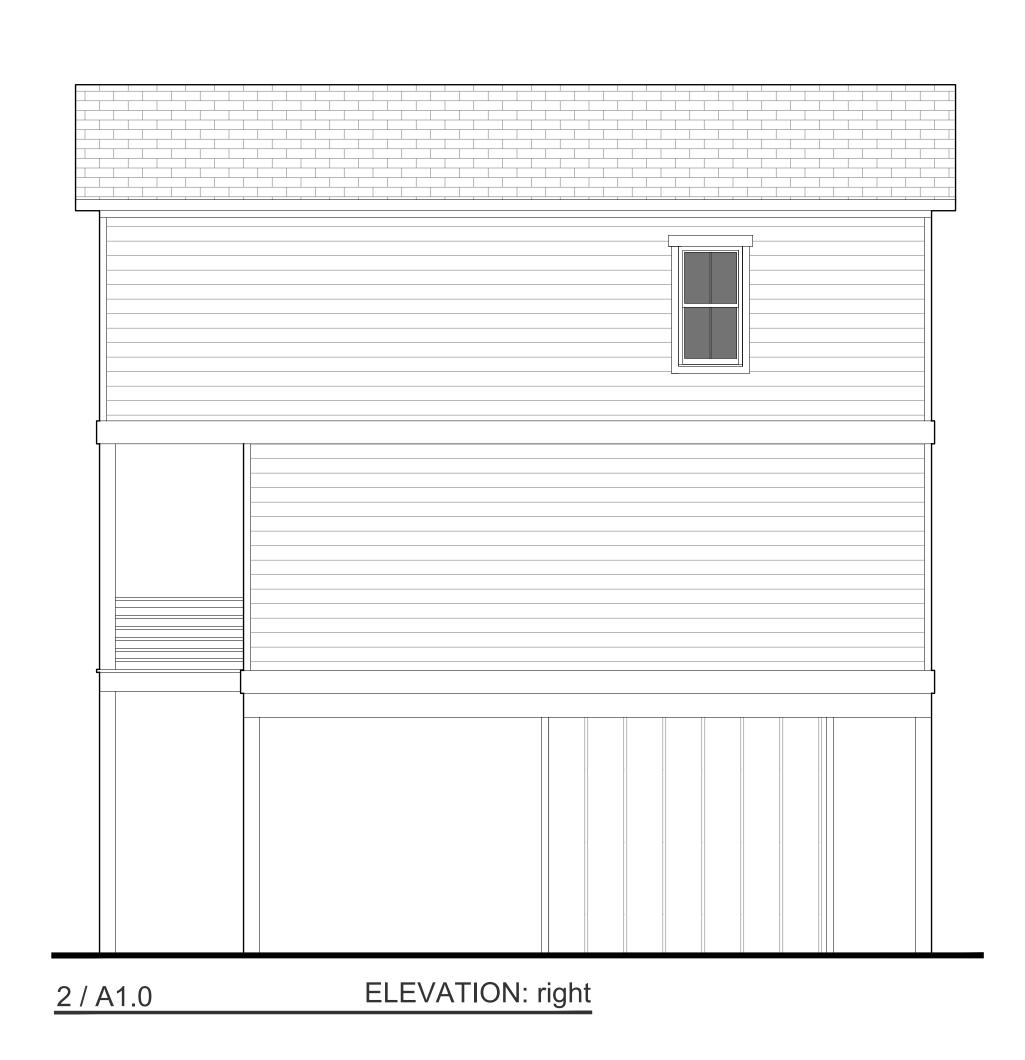






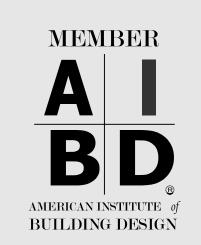



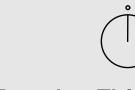


Drawing Title
Elevation

Scale -- 1/4" = 1'-0"


Sheet No.

A10

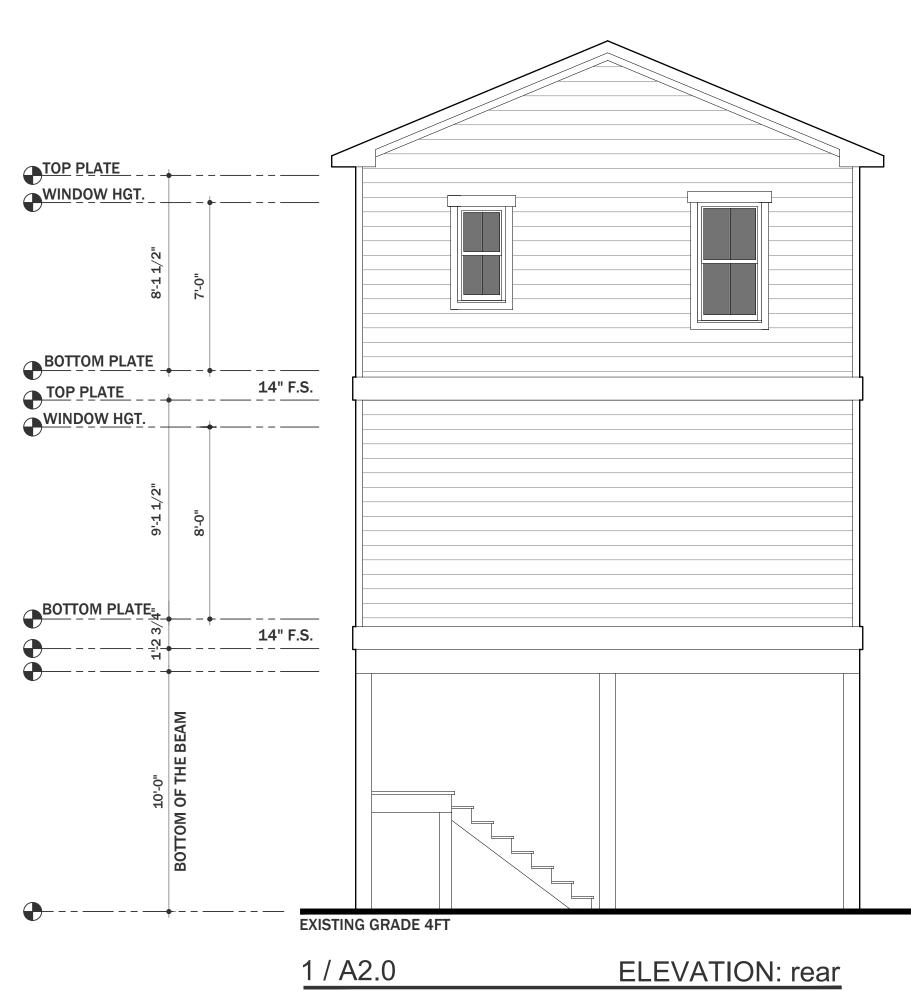

GENERAL ELEVATION NOTES:

- 1. ROOF OVERHANGS ARE 12" UNLESS NOTED OTHERWISE.
- 2. PROVIDE FOUNDATION AND ROOF VENTS AS REQUIRED BY STATE BUILDING CODE.
- 3. PROVIDE STEPS TO FINISH FLOOR LEVEL AS REQUIRED BY STATE BUILDING CODES.
- 4. SECOND FLOOR WINDOWS TO BE 24" ABOVE FINISH FLOOR.

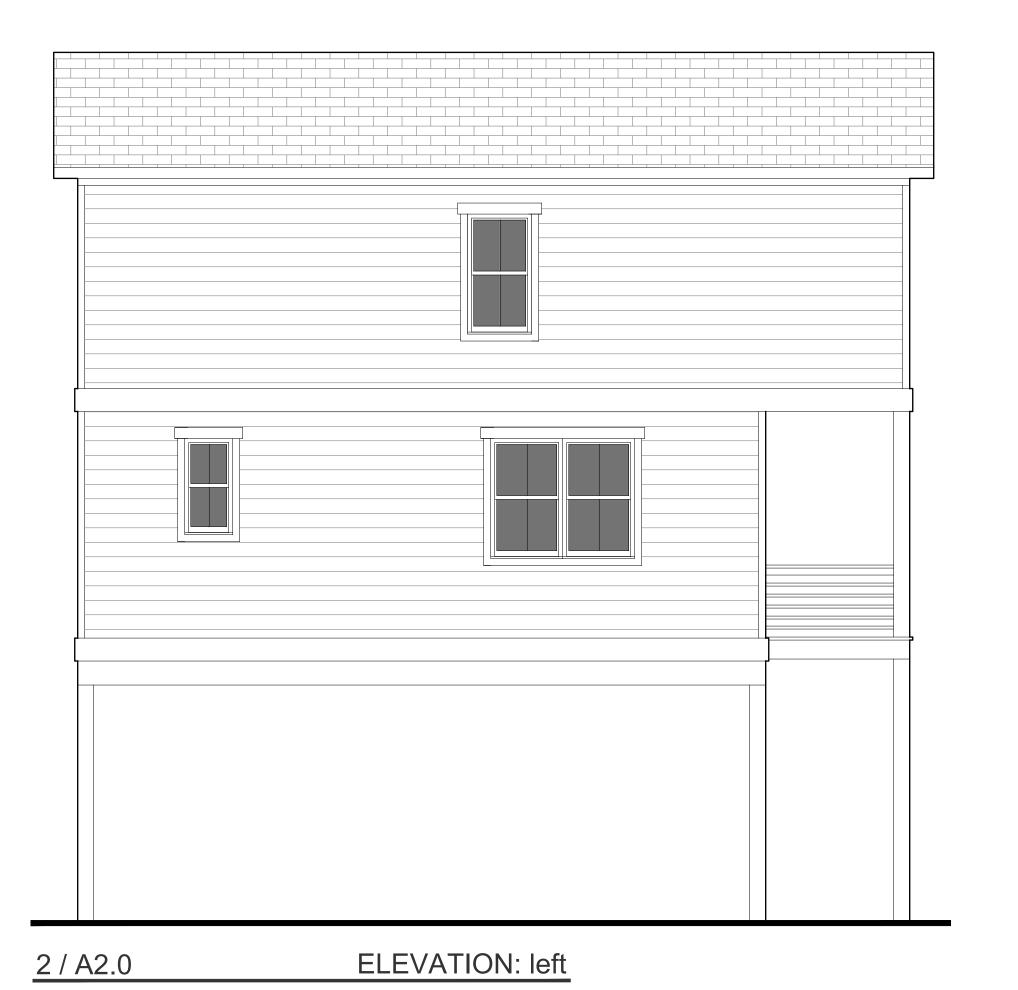


Drawing Title
Elevation

Scale -- 1/4" = 1'-0"


A2.0



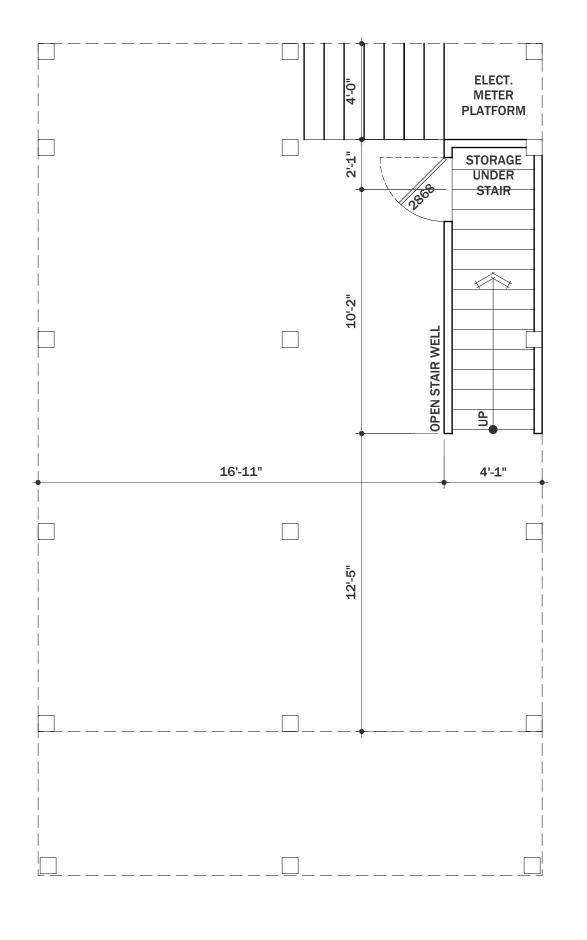


Drawing Title
Foundation
Scale -- 1/4" = 1'-0"

A3.0

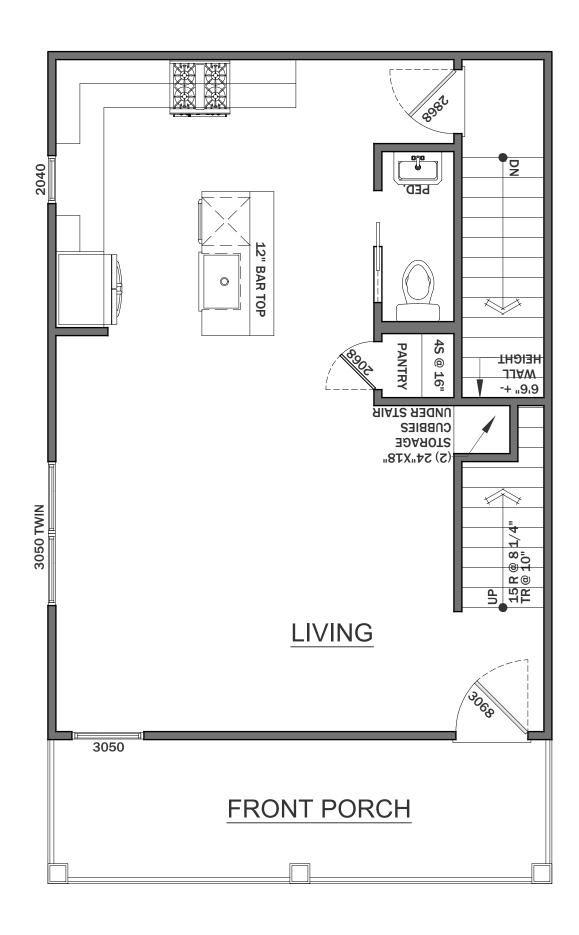



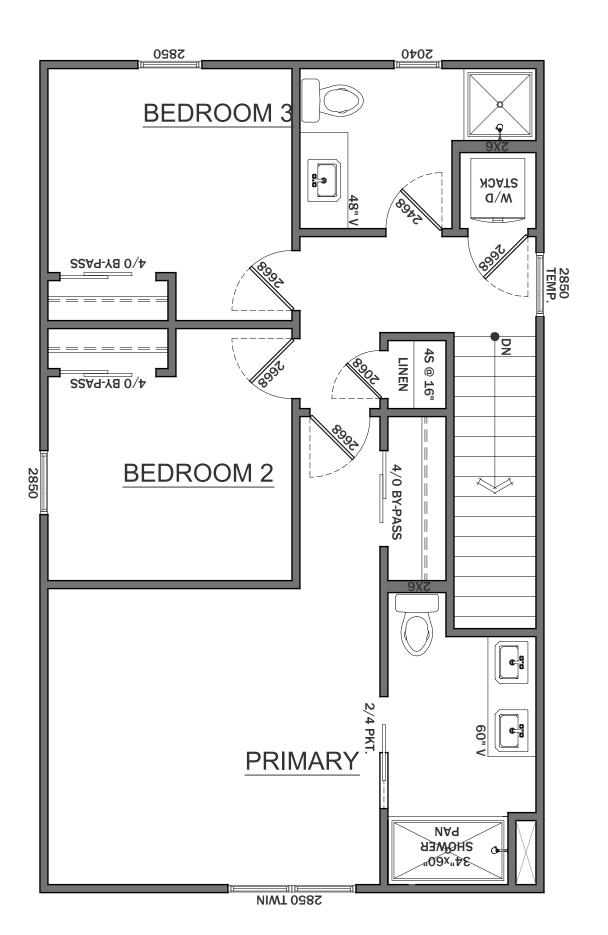

2 / A4.0 PLAN: second floor 728 HEATED SQUARE FEET

Drawing Title
Floor Plan
Scale -- 1/4" = 1'-0"