
FISHER'S RESERVE SUBDIVISION

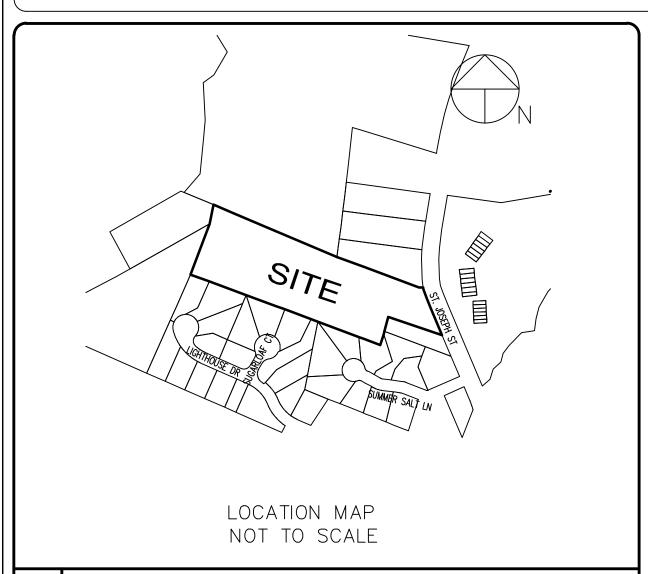

TRC APPROVAL PLANS - PHASE 2 LOTS 10-13

1215 ST. JOSEPH STREET, CAROLINA BEACH, NC 2025-08-18



VICINITY MAP

SCALE: NOT TO SCALE


FISHER'S RESERVE

CONTRACTOR: W3 BUILT, LLC WESCOTT BUTLER, OWNER 707-A ST JOSEPH AVENUE CAROLINA BEACH, NC PHONE: (910) 599-5789 EMAIL: BUTLER@W3BUILT.COM

PROJECT CIVIL ENGINEER: RICHARD COLLIER, PE RCOLLIER@MCKIMCREED.COM

PROJECT SURVEYOR:

PORT CITY 1144 SHIPYARD BOULEVARD WILMINGTON, NORTH CAROLINA 28412

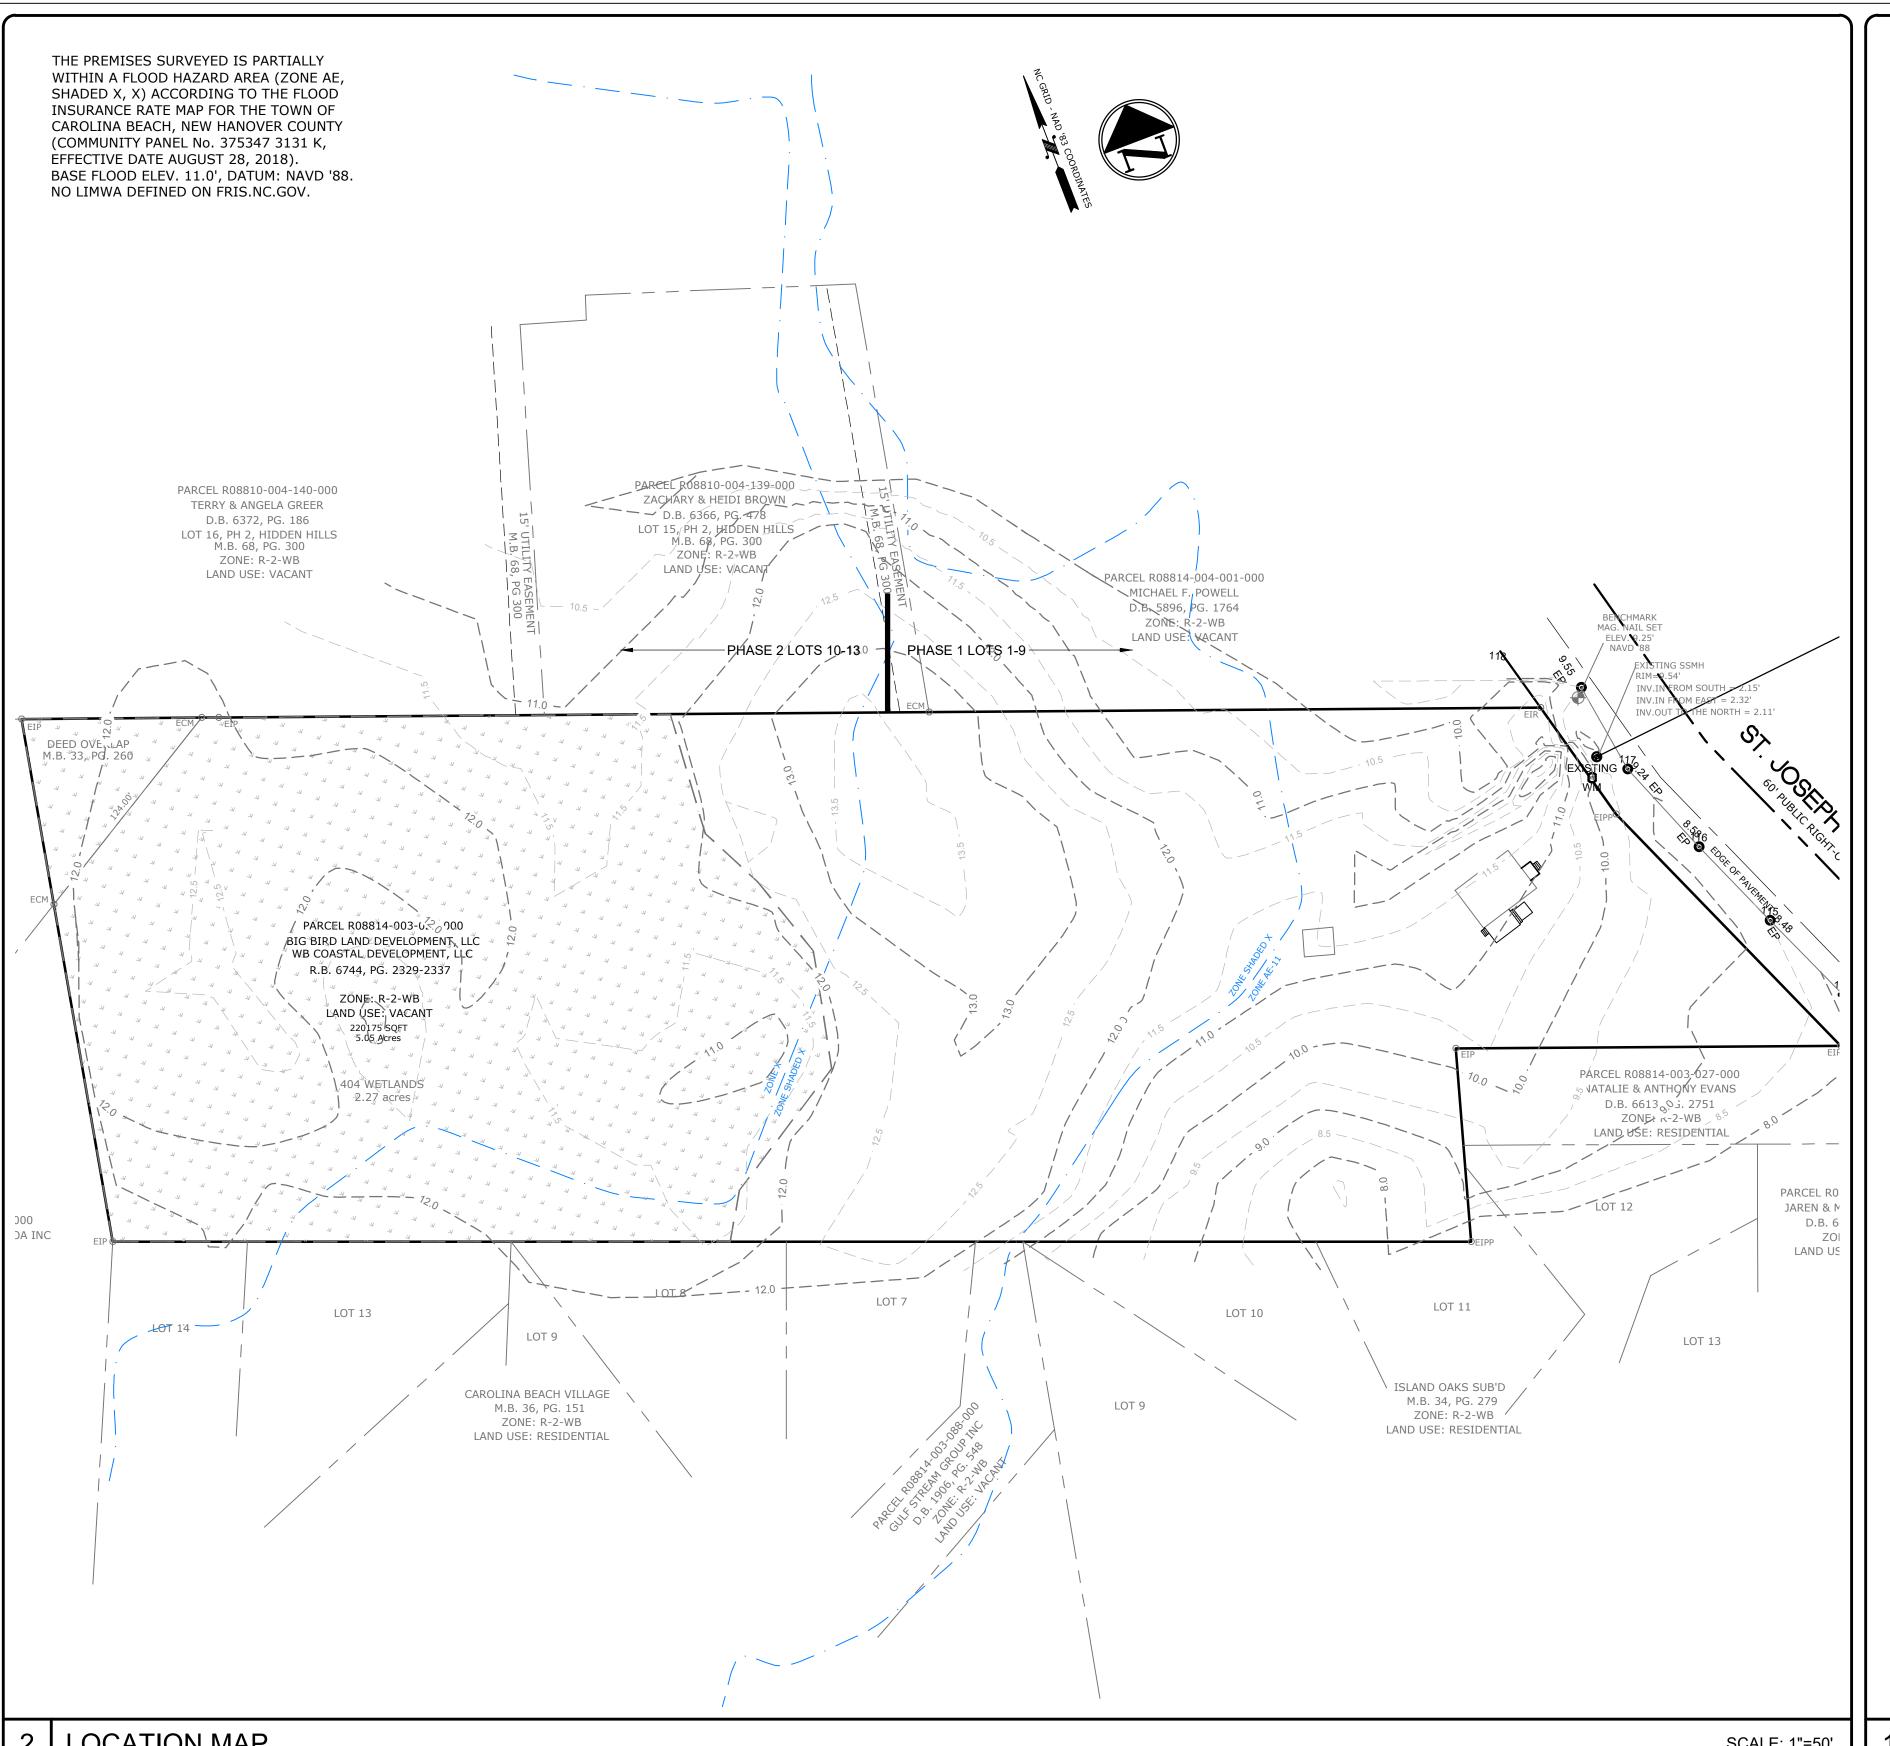

Sheet List Table		
Sheet Number	Sheet Title	
	COVER	
C1.0	OVERALL SITE PLAN	
C1.1	PRELIMINARY PLAT	
C1.2	GRADING AND DRAINAGE PLAN	
C1.3	EROSION CONTROL	
C2.0	ENLARGED LANDSCAPE PLAN	
C2.1	LANDSCAPE DETAILS	
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C4.1	UTILITY DETAILS	
C4.2	STORMWATER DETAILS	
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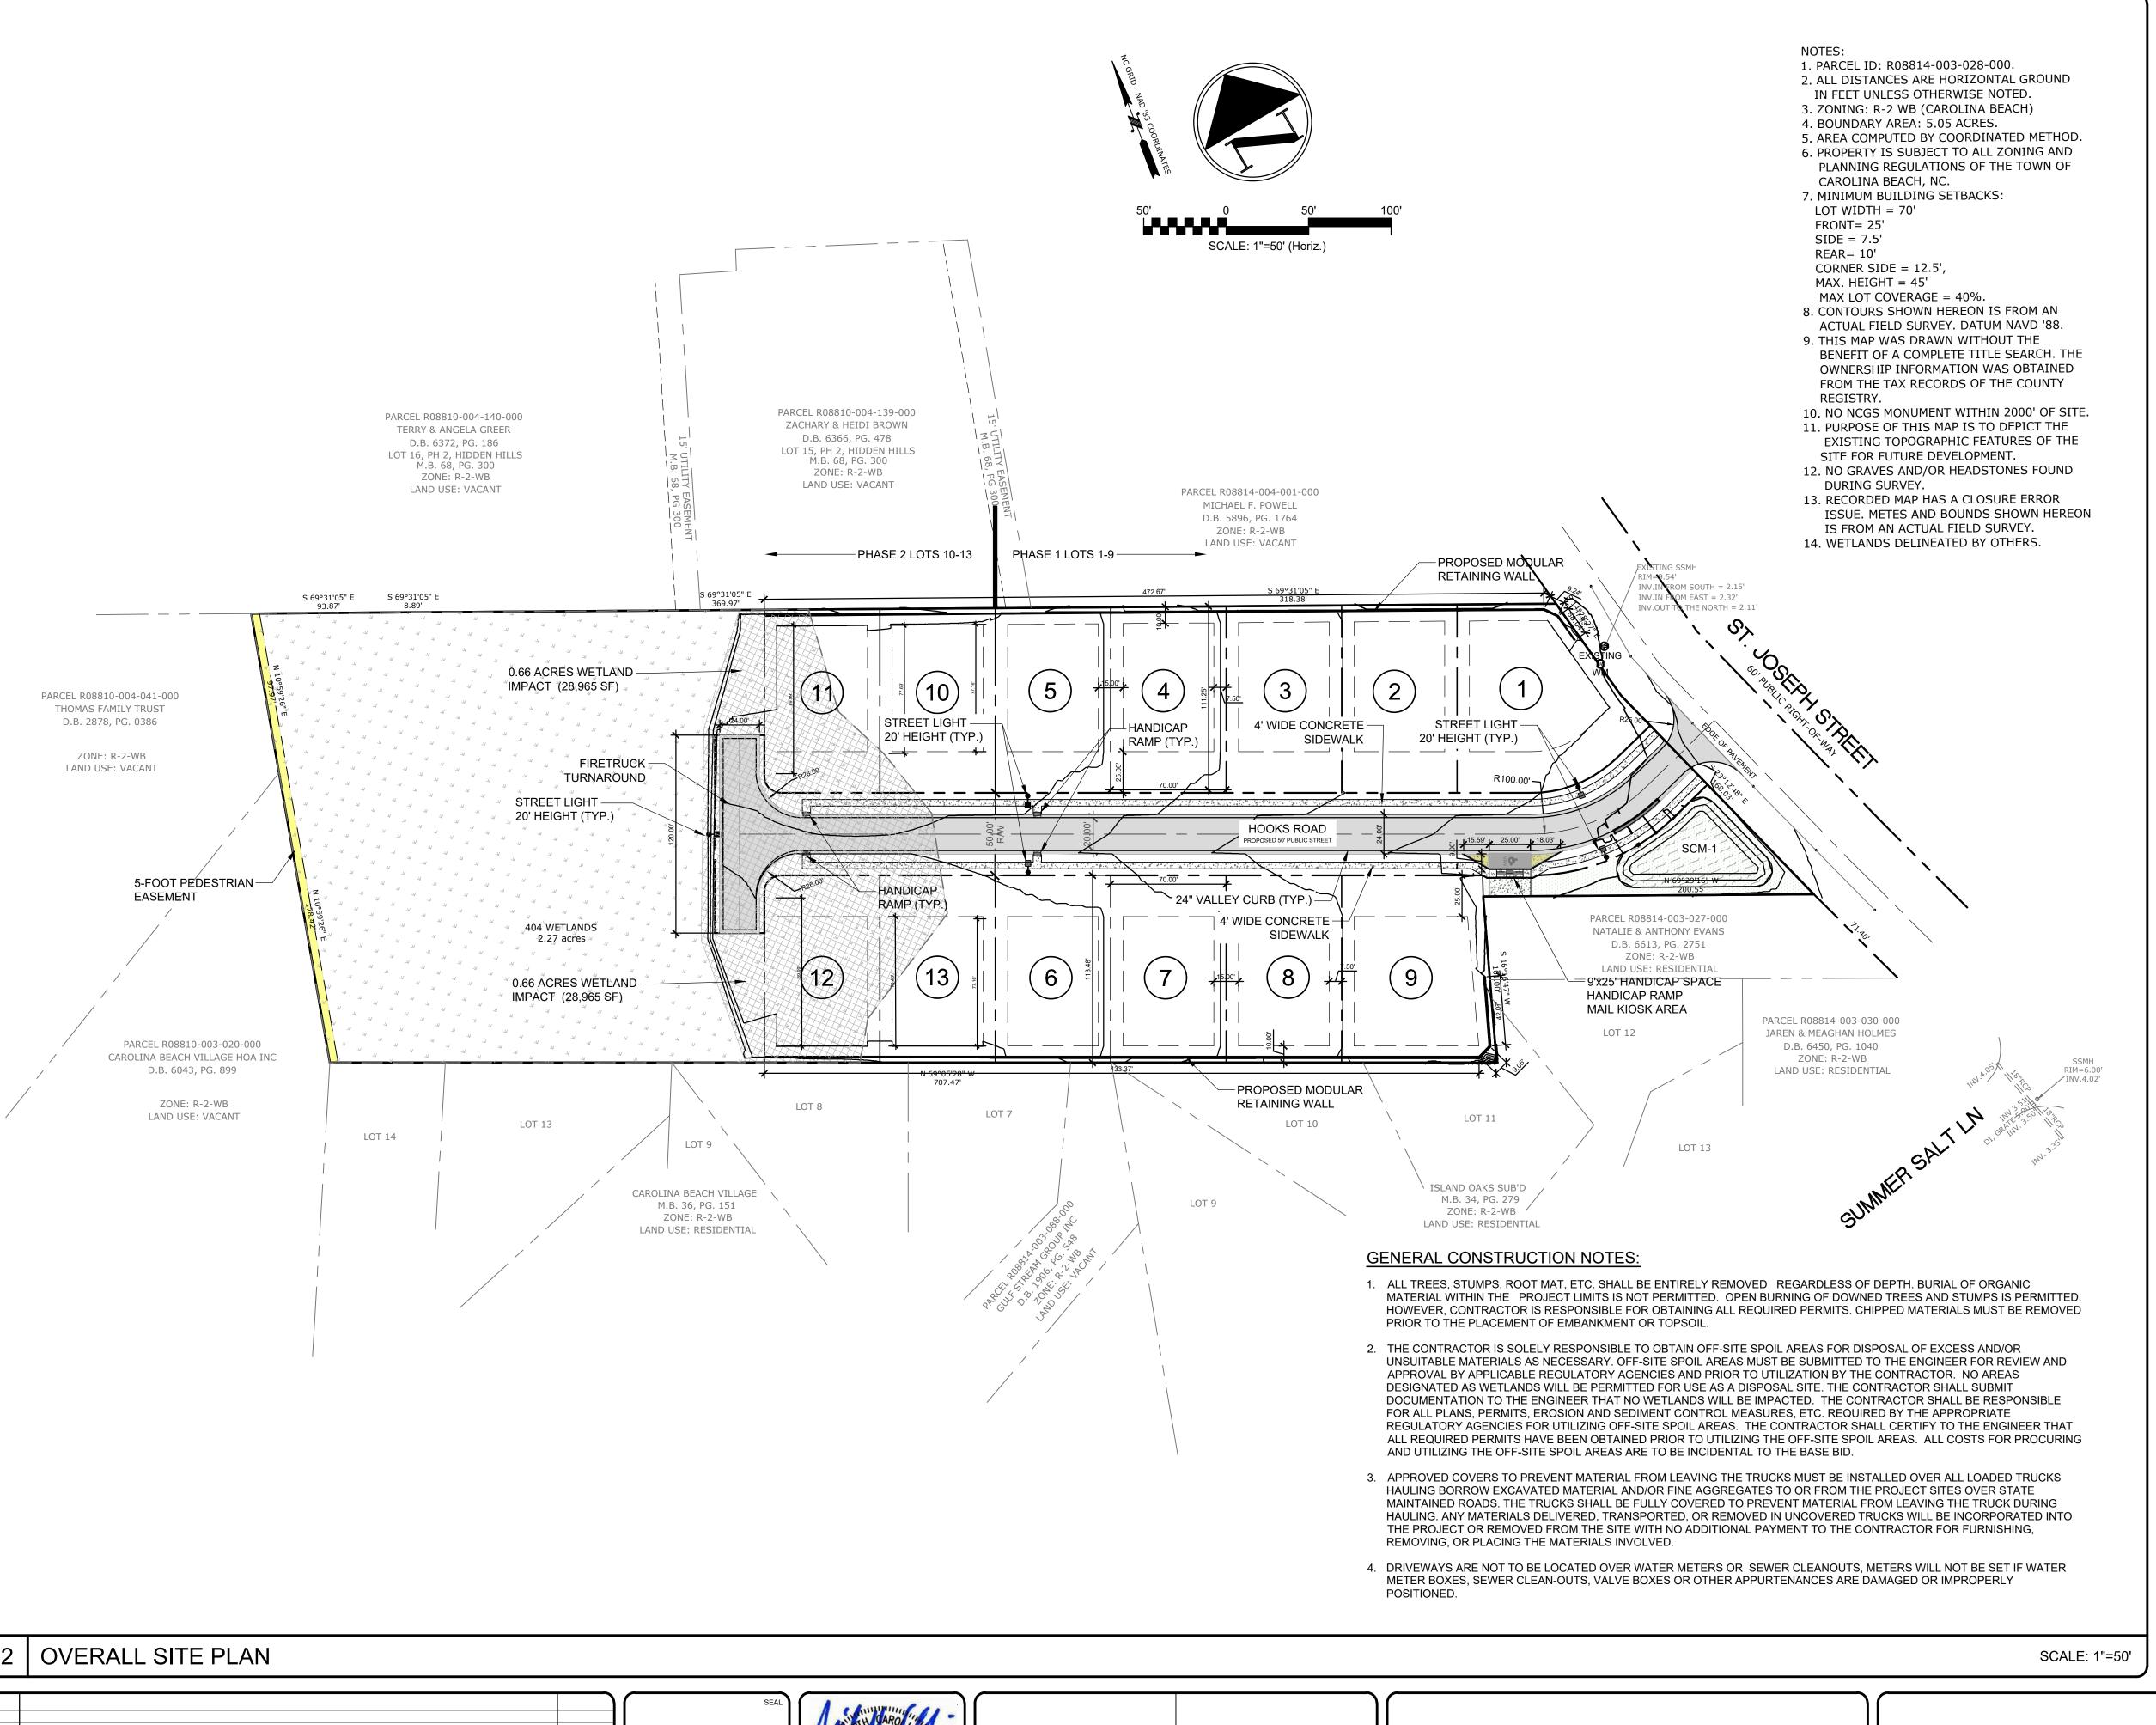


SHEET INDEX

PROJECT INFORMATION

LOCATION MAP

SCALE: 1"=50'



1215 ST JOSEPH STREET CAROLINA BEACH
R08814-003-028-000
BIG BIRD LAND DEVELOPMENT, LLC
BIG BIRD LAND DEVELOPMENT, LLC
R-2 RESIDENTIAL
R-2 RESIDENTIAL
5.05 AC (220,175 SF)
5.05 AC (220,175 SF)

BUILDING INFORMATION

DATA CLASS	REQUIRED	PROPOSED
LOT SIZE (R-2 ZONING)	7,000 SF	7,000 SF MIN
DENSITY	6.2 DUA MAX	3.76 DUA
BUILDING SETBACKS		
LOT WIDTH	70'	75' AND 80'
FRONT	25'	25'
REAR	10'	10'
SIDE CORNER	7.5	7.5'
SIDE INTERIOR	7.5	7.5'
BUILDING HEIGHT	45' MAX	45' MAX

SITE INFORMATION				
DATA CLASS	EXISTING	PROPOSED		
TOTAL IMPERVIOUS SURFACE AREA	0 SF	55,931 SF		
BUA TOTAL (PER LOT = 5,000 OR 4,500 SF)	0 SF	32,500 SF		
ROADWAY PAVEMENT	0 SF	20,046 SF		
SIDEWALKS / PLAZA	0 SF	3,385 SF		
IMPERVIOUS AREA COVERAGE	0%	45.0 %		

SURFACE MATERIAL LEGEND

ROADWAY ASPHALT


2'-0" CONCRETE VALLEY CURB

SIDEWALK / DRIVEWAY APRON

24" CONCRETE FLUME



OPEN SPACE

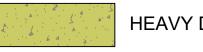

HEAVY DUTY CONCRETE

GENERAL NOTES:

- UTILITIES WILL BE LOCATED WITHIN THE PUBLIC R/W AND WILL BE PUBLIC FACILITIES DEDICATED TO THE TOWN OF CAROLINA BEACH.
- STORMWATER MANAGEMENT WILL BE TREATED ON-SITE AND WILL MEET THE STATE AND
- TOWN RULES AND REGULATIONS. LOTS 1, 2, 7, AND 9 WILL HAVE THEIR FINISHED FLOOR ELEVATION 2-FEET ABOVE THE
- BASE FLOOD ELEVATION OF 11-FEET. THE DEVELOPER RETAINS THE RIGHT TO RAISE ANY, ALL, OR NONE OF THE REMAINING LOTS ABOVE BFE.
- SIDEWALK IS PROPOSED ON BOTH SIDES OF THE STREET (4' WIDE SIDEWALKS).

OWNERS OF RECORD: DONALD L. GRADY 17418 SPRING FOREST DRIVE SPRING, TX 77379

LINDA GRADY SMITH 336 JOHN LEWIS GRADY ROAD MOUNT OLIVE, NC 28365

BEVERLY GRADY BROWN P.O.BOX 161 MARS HILL, NC 28754

SURVEY REFERENCES M.B. 33, PG. 260, NEW HANOVER COUNTY

TOPOGRAPHIC SURVEY HEIRS OF DONALD L. GRADY TOWN OF CAROLINA BEACH, FEDERAL POINT TOWNSHIP NEW HANOVER COUNTY, NORTH CAROLINA 28428 SCALE 1"= 40' DATE: FEBRUARY 14, 2024

PORT CITY FIRM LICENSE No. P-1493 1144 SHIPYARD BOULEVARD WILMINGTON, NORTH CAROLINA 28412 (910) 791-0080

SITE DATA TABLE

SCALE: NTS



PORT CITY
LAND SURVEYING, PLLC
FIRM LICENSE No. P-1493

<u>Civil Engineer:</u> Richard M. Collier, PE 3708 Needle Sound Way Wilmington, NC NC-022574

OWNER / DEVELOPER BIG BIRD LAND DEVELOPMENT, LLC 707A ST JOSEPH ST CAROLINA BEACH NC

FISHER'S RESERVE


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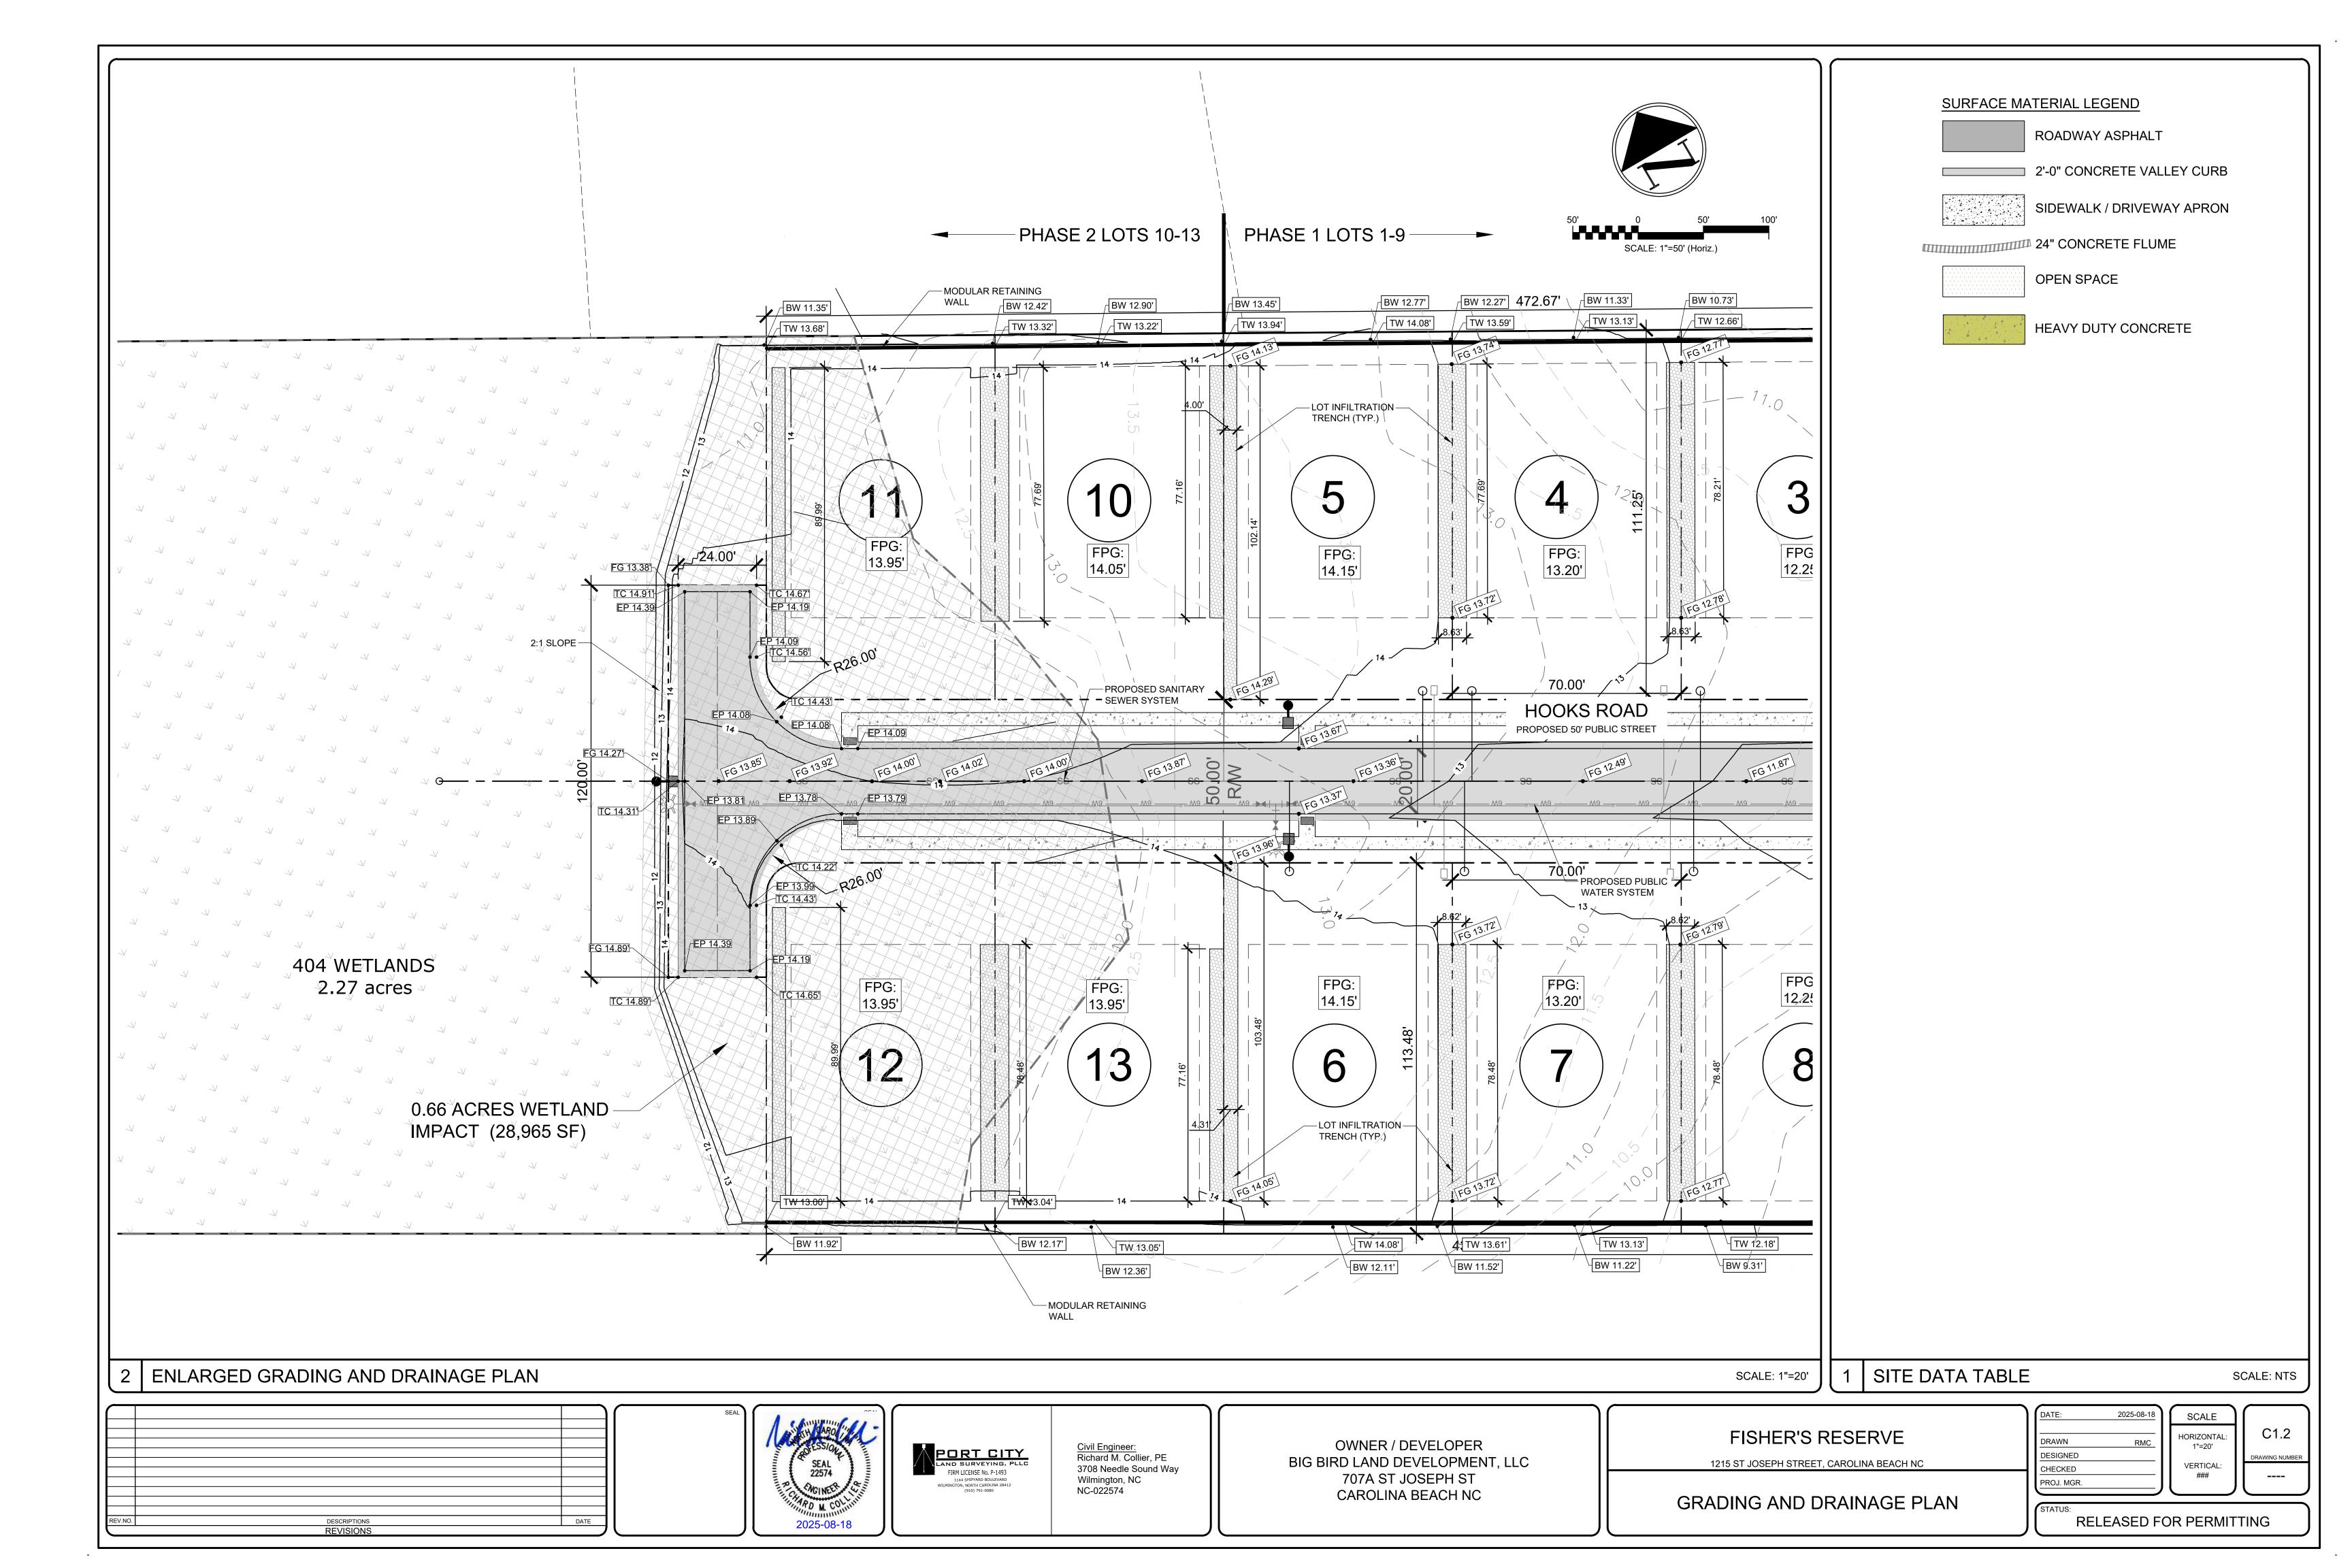
OVERALL SITE PLAN


1	DATE:	2025-08-18
	DRAWN	RMC
	DESIGNED	
ł	CHECKED	
ı	PROJ MGR	

SCALE HORIZONTAL VERTICAL:

RELEASED FOR PERMITTING



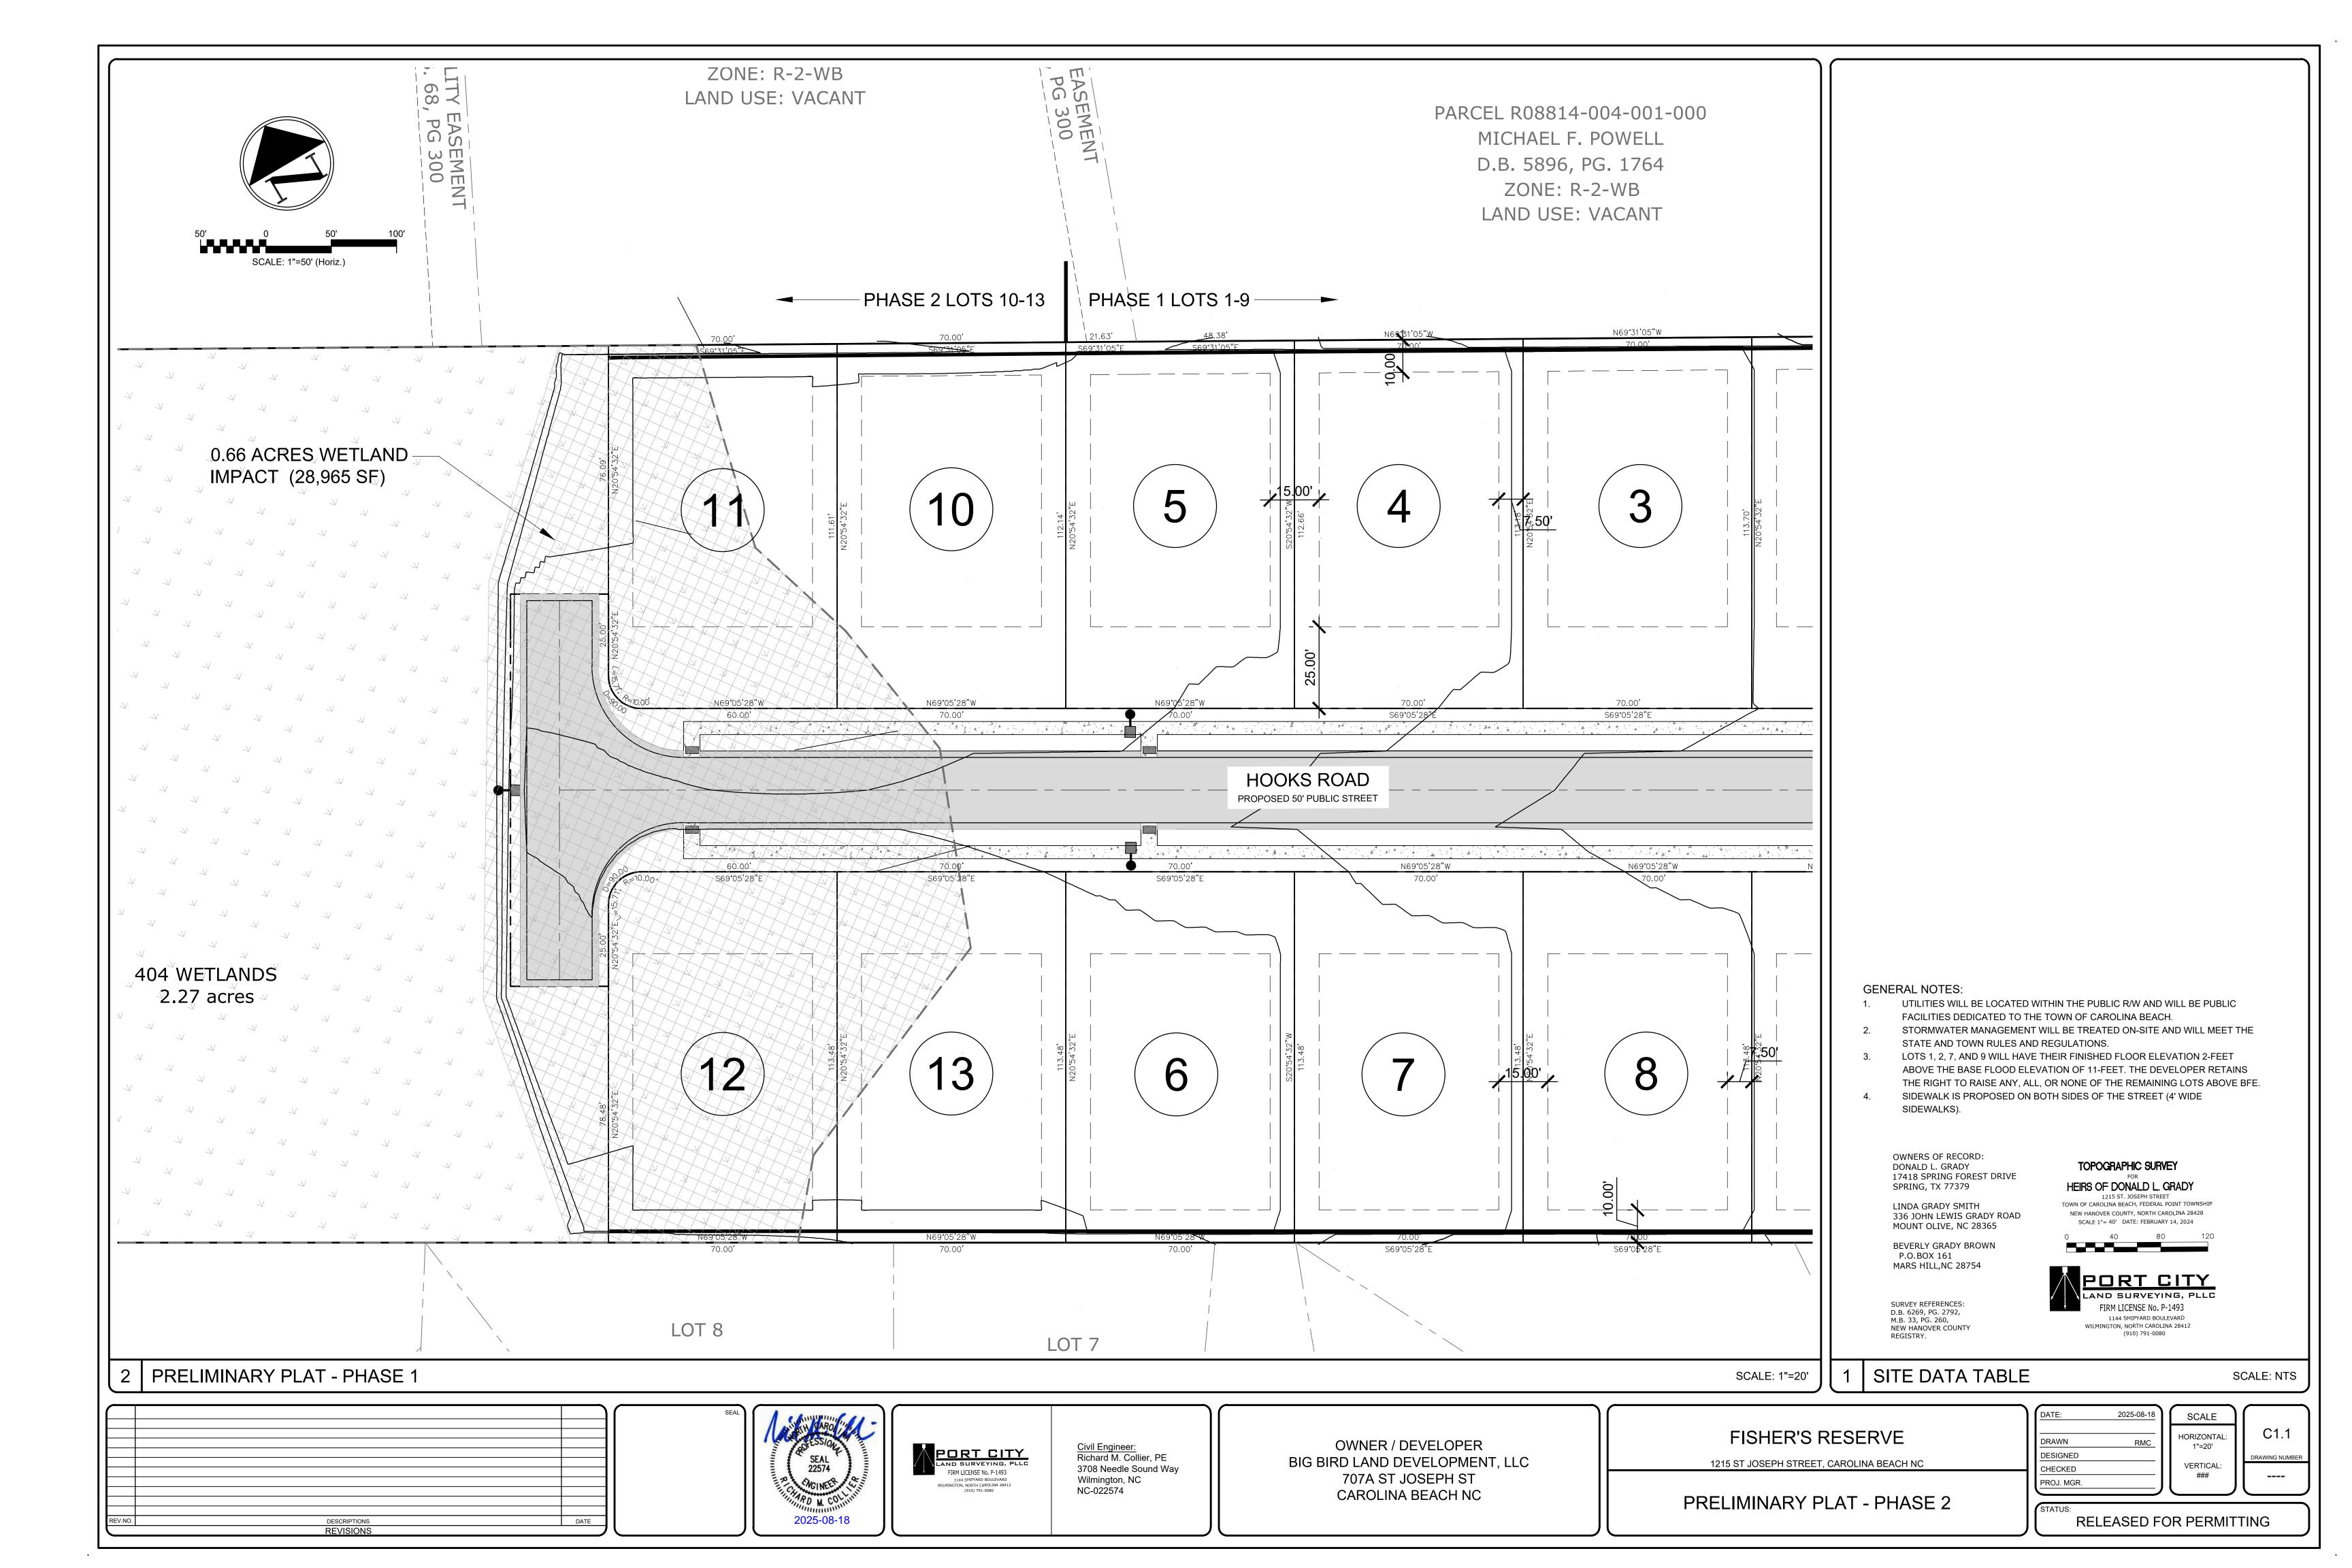


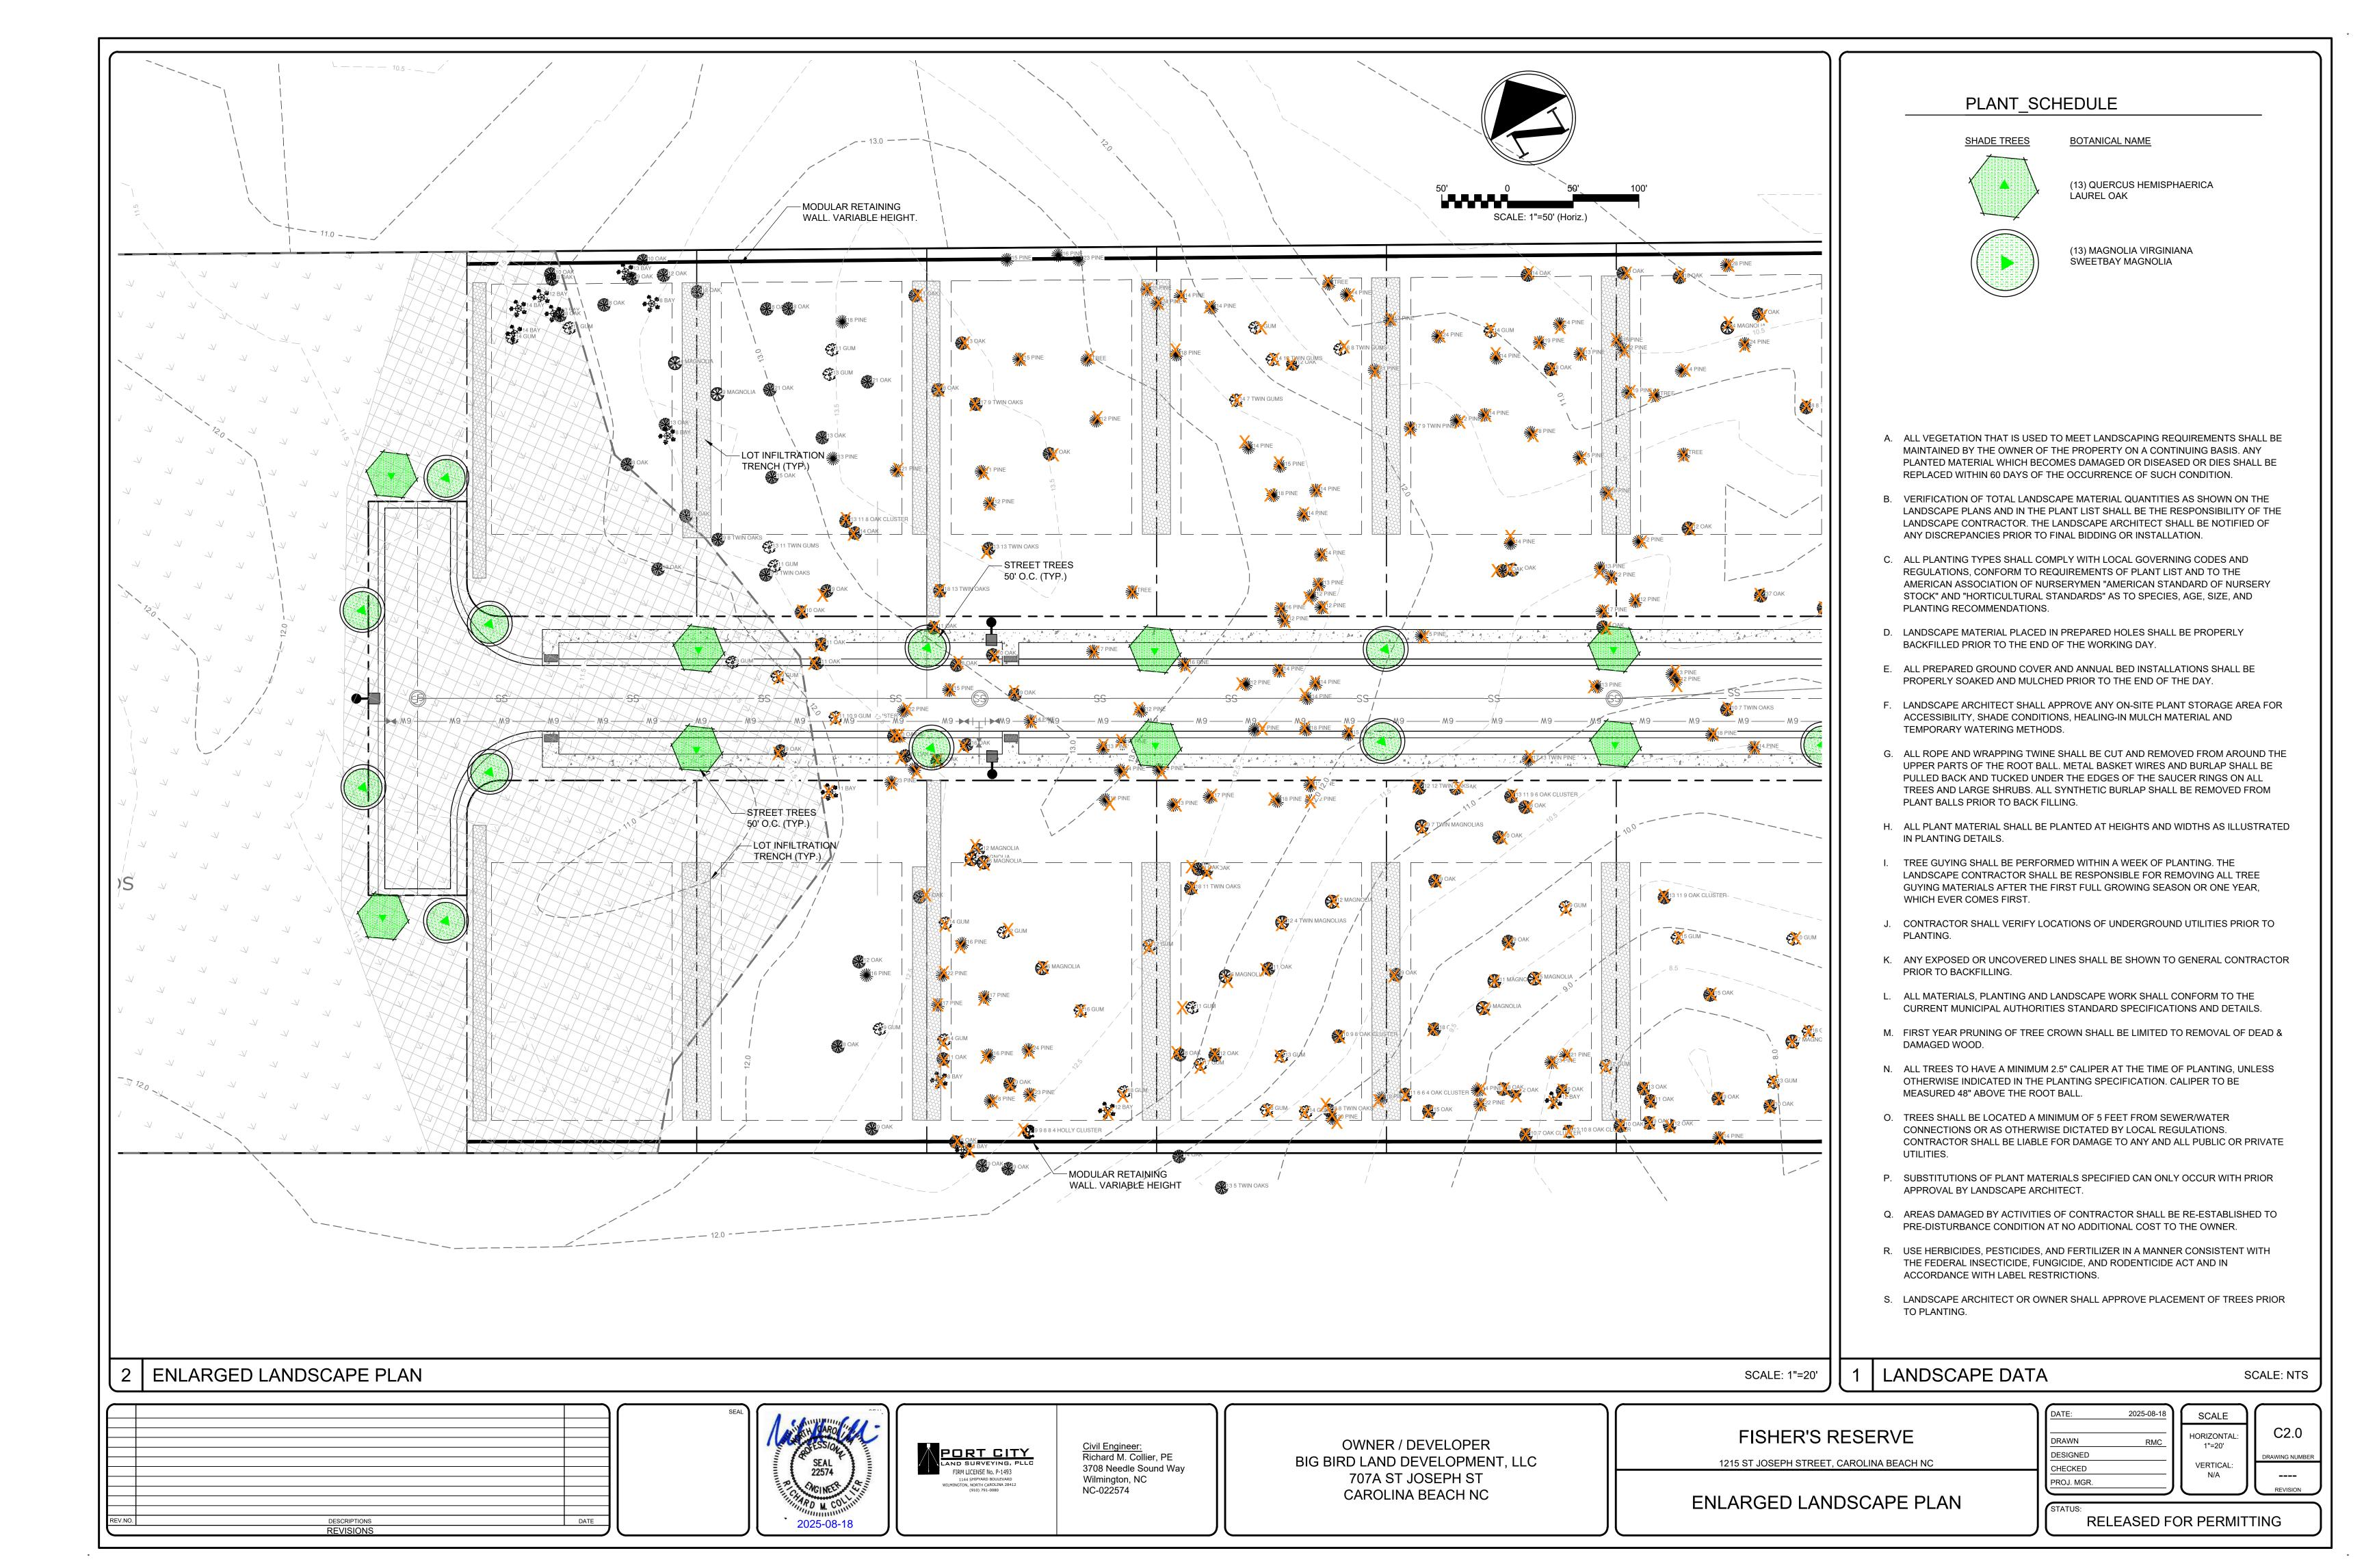


- 1. ALL EXISTING VEGETATION THAT IS USED TO MEET LANDSCAPING REQUIREMENTS, ALL REQUIRED PLANTED LIVING MATERIAL, AND ALL REQUIRED BERMS SHALL BE MAINTAINED BY THE OWNER OF THE PROPERTY ON A CONTINUING BASIS. ANY PLANTED MATERIAL WHICH BECOMES DAMAGED OR DISEASED OR DIES SHALL BE REPLACED BY THE OWNER WITHIN 60 DAYS OF THE OCCURRENCE OF SUCH CONDITION. IF, IN THE OPINION OF THE ZONING ADMINISTRATOR THERE ARE SEASONAL CONDITIONS WHICH WILL NOT PERMIT THE TIMELY REPLACEMENT OF THE VEGETATION (E.G. TOO HOT OR TOO COOL FOR SUCCESSFUL REPLANTING) THIS REQUIREMENT MAY BE ADMINISTRATIVELY WAIVED UNTIL A TIME CERTAIN WHEN THE REPLANTING WOULD BE SUCCESSFUL.
- 2. VERIFICATION OF TOTAL LANDSCAPE MATERIAL QUANTITIES AS SHOWN ON THE LANDSCAPE PLANS AND IN THE PLANT SCHEDULE SHALL BE THE RESPONSIBILITY OF THE LANDSCAPE CONTRACTOR. THE LANDSCAPE ARCHITECT SHALL BE NOTIFIED OF ANY DISCREPANCIES PRIOR TO FINAL BIDDING OR INSTALLATION.
- 3. ALL PLANTING TYPES SHALL COMPLY WITH LOCAL GOVERNING CODES AND REGULATIONS, CONFORM TO REQUIREMENTS OF PLANT LIST AND TO THE AMERICAN ASSOCIATION OF NURSERYMEN "AMERICAN STANDARD OF NURSERY STOCK" AND "HORTICULTURAL STANDARDS" AS TO SPECIES, AGE, SIZE, AND PLANTING RECOMMENDATIONS.
- 4. LANDSCAPE MATERIAL PLACED IN PREPARED HOLES SHALL BE PROPERLY BACKFILLED PRIOR TO THE END OF THE WORKING DAY
- 5. ALL SAUCERS SHALL BE SOAKED WITH WATER AND MULCHED IMMEDIATELY FOLLOWING INSTALLATION.
- 6. LANDSCAPE ARCHITECT SHALL APPROVE ANY ON-SITE PLANT STORAGE AREA FOR ACCESSIBILITY, SHADE CONDITIONS, HEALING-IN MULCH MATERIAL AND TEMPORARY WATERING METHODS.
- 7. ALL ROPE AND WRAPPING TWINE SHALL BE CUT AND REMOVED FROM AROUND THE UPPER PARTS OF THE ROOT BALL. METAL BASKET WIRES AND BURLAP SHALL BE PULLED BACK AND TUCKED UNDER THE EDGES OF THE SAUCER RINGS ON ALL TREES AND LARGE SHRUBS. ALL SYNTHETIC BURLAP SHALL BE REMOVED FROM PLANT BALLS PRIOR TO BACK FILLING.
- 8. ALL PLANT BEDS OR RAISED SAUCER RINGS SHALL BE EDGED WITH SMOOTH, CONTINUOUS CURVES.
- 9. ALL PLANT MATERIAL SHALL BE PLANTED AT HEIGHTS AND WIDTHS AS ILLUSTRATED IN PLANTING DETAILS.
- 10. TREE GUYING SHALL BE PERFORMED WITHIN A WEEK OF PLANTING. THE LANDSCAPE CONTRACTOR SHALL BE RESPONSIBLE FOR REMOVING ALL TREE GUYING STRAPPING AND STAKES AFTER THE FIRST FULL GROWING SEASON OR ONE YEAR, WHICH EVER COMES FIRST.
- 11. CONTRACTOR SHALL VERIFY LOCATIONS OF UNDERGROUND UTILITIES PRIOR TO PLANTING.
- ANY EXPOSED OR UNCOVERED LINES SHALL BE SHOWN TO GENERAL CONTRACTOR PRIOR TO BACKFILLING.
 ALL PLANT BEDS AND RAISED SAUCER RINGS SHALL BE GRADED TO PROVIDE ADEQUATE DRAINAGE AND SHALL BE MULCHED AS SPECIFIED.
- 14. ALL MATERIALS, PLANTING AND LANDSCAPE WORK SHALL CONFORM TO THE CURRENT MUNICIPAL AUTHORITIES STANDARD SPECIFICATIONS AND DETAILS.
- 15. ALL LANDSCAPE AREAS THAT ARE NOT PLANTED, MULCHED OR PAVED SHALL BE SEEDED OR SODDED.
- 16. FIRST YEAR PRUNING OF TREE CROWN SHALL BE LIMITED TO REMOVAL OF DEAD & DAMAGED WOOD.
 17. TREE PROTECTION FENCE SHALL BE INSTALLED, INSPECTED AND APPROVED PRIOR TO CLEARING, GRADING AND CONSTRUCTION ACTIVITY OR ISSUANCE OF ANY RELATED PERMITS. NO CONSTRUCTION WORKERS, TOOLS,
- MATERIALS OR VEHICLES ARE PERMITTED WITHIN THE TREE PROTECTION FENCING.

 18. MULCH LINE SHALL CONSIST OF SMOOTH CONTINUOUS CURVES.
- 19. ALL TREES NOT WITHIN A PLANT BED SHALL BE TREATED WITH A 6' DIAMETER MULCH RING TYPICAL, UNLESS OTHERWISE INDICATED ON THE PLANTING PLANS.
- 20. TREES SHALL BE LOCATED A MINIMUM OF 5 FEET FROM SEWER/WATER CONNECTIONS OR AS OTHERWISE DICTATED BY LOCAL REGULATIONS. CONTRACTOR SHALL BE LIABLE FOR DAMAGE TO ANY AND ALL PUBLIC OR PRIVATE UTILITIES.
- 21. SUBSTITUTIONS OF PLANT MATERIALS SPECIFIED CAN ONLY OCCUR WITH PRIOR APPROVAL BY LANDSCAPE ARCHITECT
- 22. ESTABLISH PLANT BED CONFIGURATION. LANDSCAPE ARCHITECT TO APPROVE BED LAYOUT IN FIELD.
- 23. AREAS DAMAGED BY ACTIVITIES OF CONTRACTOR SHALL BE RE-ESTABLISHED TO PRE-DISTURBANCE CONDITION AT NO ADDITIONAL COST TO THE OWNER.
- 24. USE HERBICIDES, PESTICIDES, AND FERTILIZER IN A MANNER CONSISTENT WITH THE FEDERAL INSECTICIDE, FUNGICIDE, AND RODENTICIDE ACT AND IN ACCORDANCE WITH LABEL RESTRICTIONS.
- 25. CONTRACTOR SHALL INSURE THAT ALL PLANT MATERIAL IS FREE OF FIRE ANTS PRIOR TO INSTALLATION.
- 26. LANDSCAPE ARCHITECT OR OWNER SHALL APPROVE PLACEMENT OF TREES PRIOR TO PLANTING.
- 27. STREET TREES SHALL BE MAINTAINED TO PROVIDE 13'-6" CLEAR HEIGHT FOR THE PORTION OF THE TREE CANOPY THAT EXTENDS OVER THE VEHICULAR NETWORK.
- 28. STREET TREES SHALL BE LOCATED A MINIMUM OF 15 FEET FROM STREETLIGHTS.
- 29. LANDSCAPING OR PARKING CANNOT BLOCK OR IMPEDE THE FDC OR FIRE HYDRANTS. A 3-FOOT CLEAR SPACE SHALL BE MAINTAINED AROUND THE CIRCUMFERENCE OF THE HYDRANT AND FDC.
- 30. DEEPROOT ROOT BARRIER OR APPROVED EQUAL SHALL BE INSTALLED AT ALL STREET TREE LOCATIONS AND WHERE A TREE IS WITHIN 10' OF A UTILITY OR HARDSCAPE. THE ROOT BARRIER SHALL BE INSTALLED ACCORDING TO MANUFACTURER RECOMMENDATION.

PLANT LEGEND

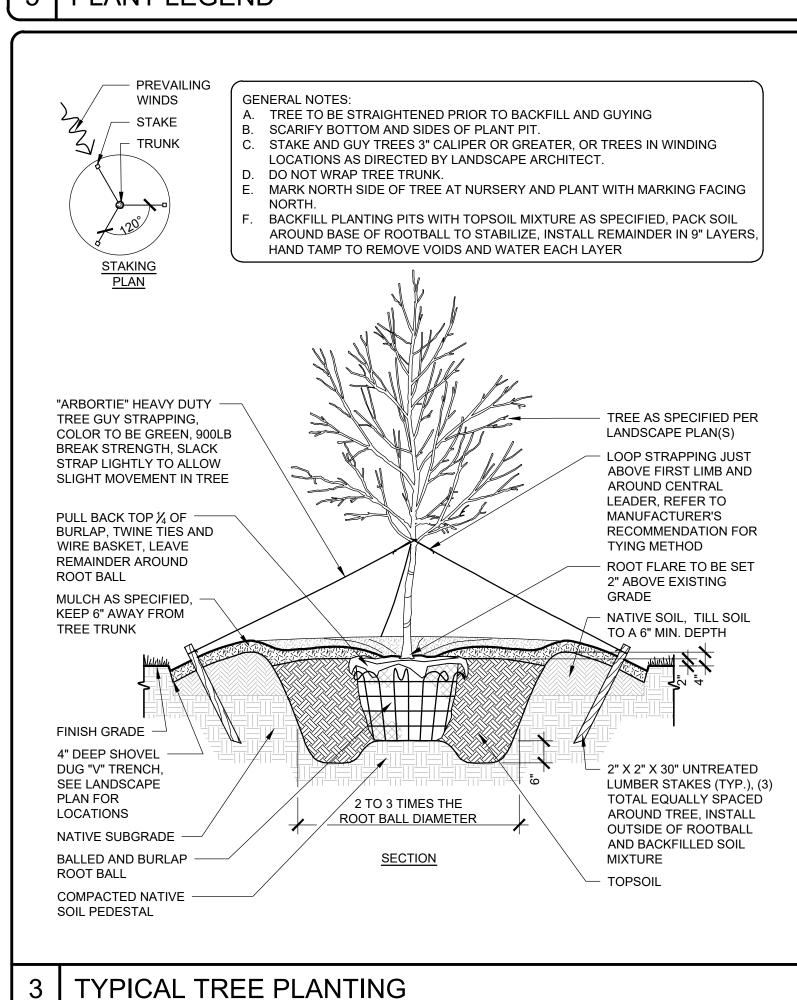

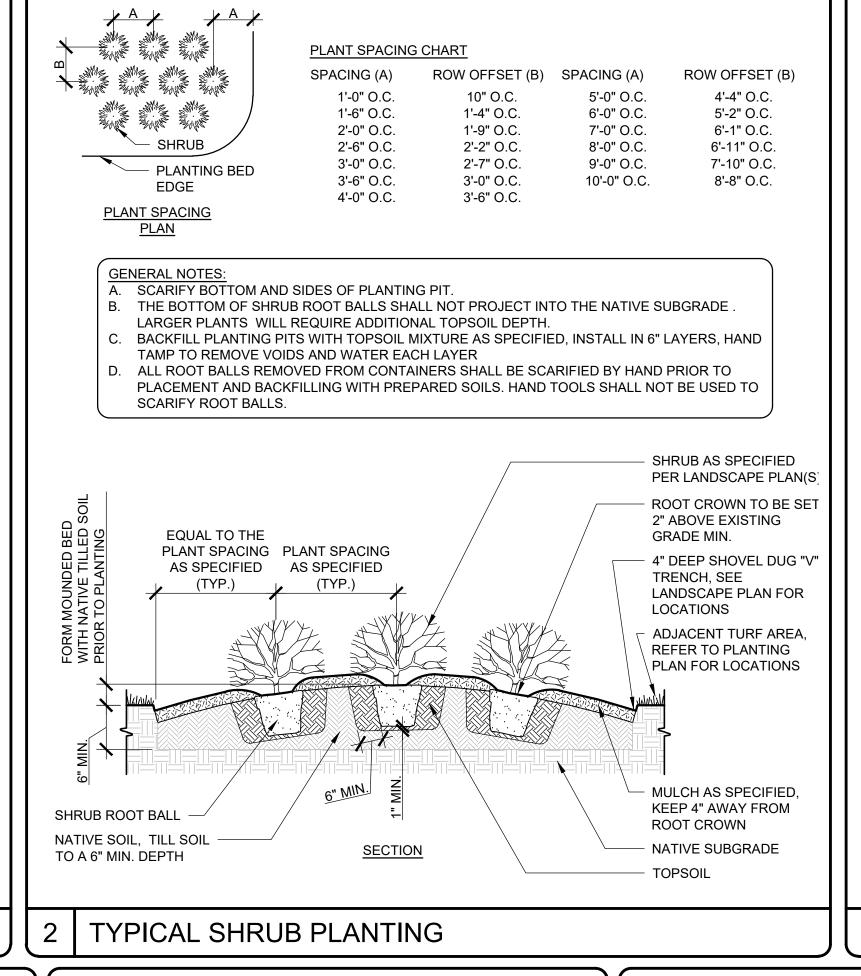

6" O.C. 5" O.C. 24" O.C. 1'-9" O.C. 8" O.C. 7" O.C. 36" O.C. 2'-7" O.C. 12" O.C. 4'-0" O.C. 3'-6" O.C. 15" O.C. 1'-1" O.C. 4'-4" O.C. 5'-0" O.C. 1'-4" O.C. 18" O.C. 6'-0" O.C. 5'-2" O.C. **PLANT SPACING** A. SCARIFY BOTTOM AND SIDES OF PLANTING PIT. B. THE BOTTOM OF GROUND COVER ROOT BALLS SHALL NOT PROJECT INTO THE NATIVE SUBGRADE LARGER PLANTS WILL REQUIRE ADDITIONAL TOPSOIL DEPTH. BACKFILL PLANTING PITS WITH TOPSOIL MIXTURE AS SPECIFIED, INSTALL IN 6" LAYERS, HAND TAMP TO REMOVE VOIDS AND WATER EACH LAYER ALL ROOT BALLS REMOVED FROM CONTAINERS SHALL BE SCARIFIED BY HAND PRIOR TO PLACEMENT AND BACKFILLING WITH PREPARED SOILS. HAND TOOLS SHALL NOT BE USED TO SCARIFY ROOT BALLS. EQUAL TO SHRUB AS SPECIFIED THE PLANT SPACING PER LANDSCAPE PLAN(S) AS SPECIFIED (TYP.) ROOT CROWN TO BE SET - PLANT SPACING 2" ABOVE EXISTING AS SPECIFIED (TYP.) GRADE MIN. 4" DEEP SHOVEL DUG "V" TRENCH, SEE LANDSCAPE PLAN FOR LOCATIONS ADJACENT TURF AREA, REFER TO PLANTING \PLAN FOR LOCATIONS 4" MIN./ MULCH AS SPECIFIED. GROUND COVER ROOT KEEP 4" AWAY FROM TREE TRUNK <u>SECTION</u> NATIVE SOIL, TILL SOIL NATIVE SUBGRADE TO A 6" MIN. DEPTH

TYPICAL GROUND COVER PLANTING

PLANT SPACING CHART

SPACING (A)

ROW OFFSET (B) SPACING (A)

ROW OFFSET (B)

GENERAL LANDSCAPE NOTES

REV.NO. DESCRIPTIONS DATE

REVISIONS






Civil Engineer: Richard M. Collier, PE 3708 Needle Sound Way Wilmington, NC NC-022574 OWNER / DEVELOPER
BIG BIRD LAND DEVELOPMENT, LLC
707A ST JOSEPH ST
CAROLINA BEACH NC


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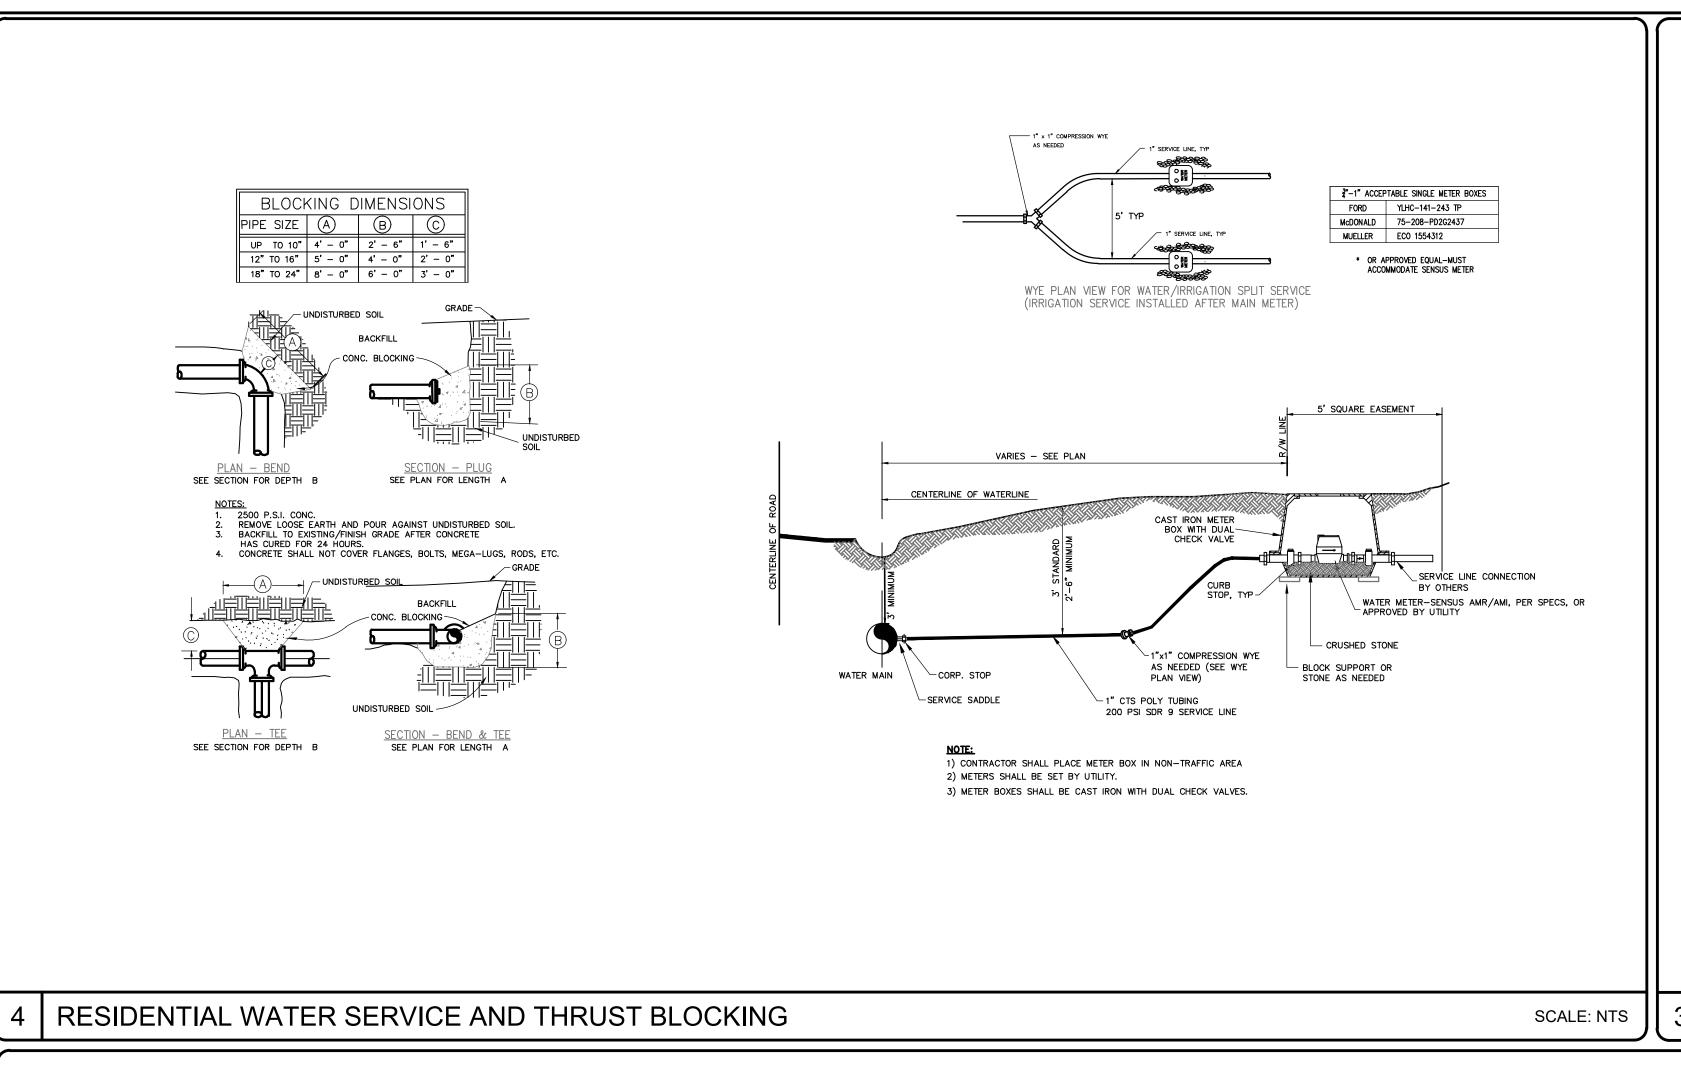
1215 ST JOSEPH STREET, CAROLINA BEACH NC


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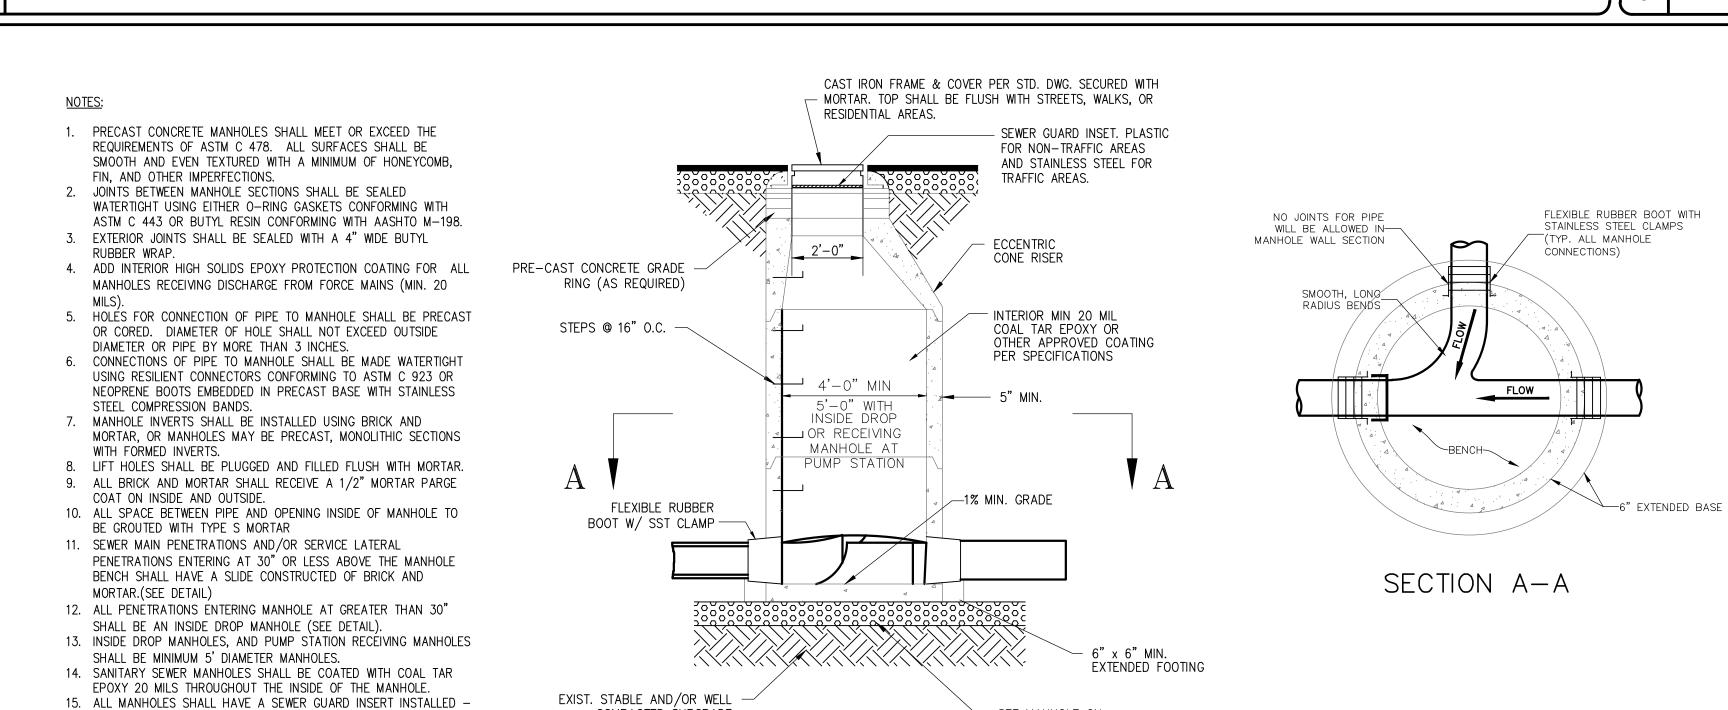
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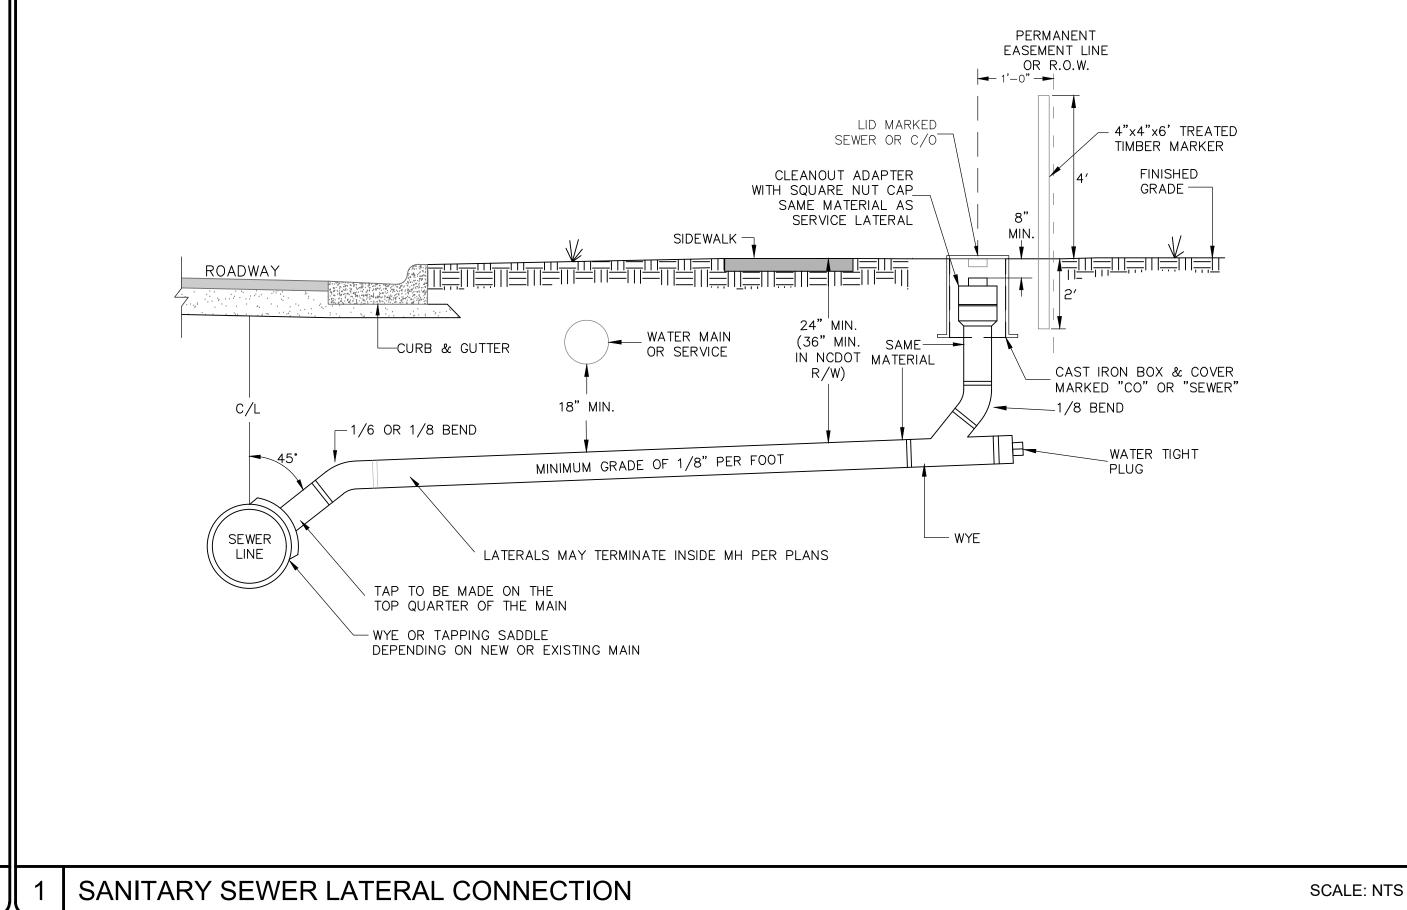






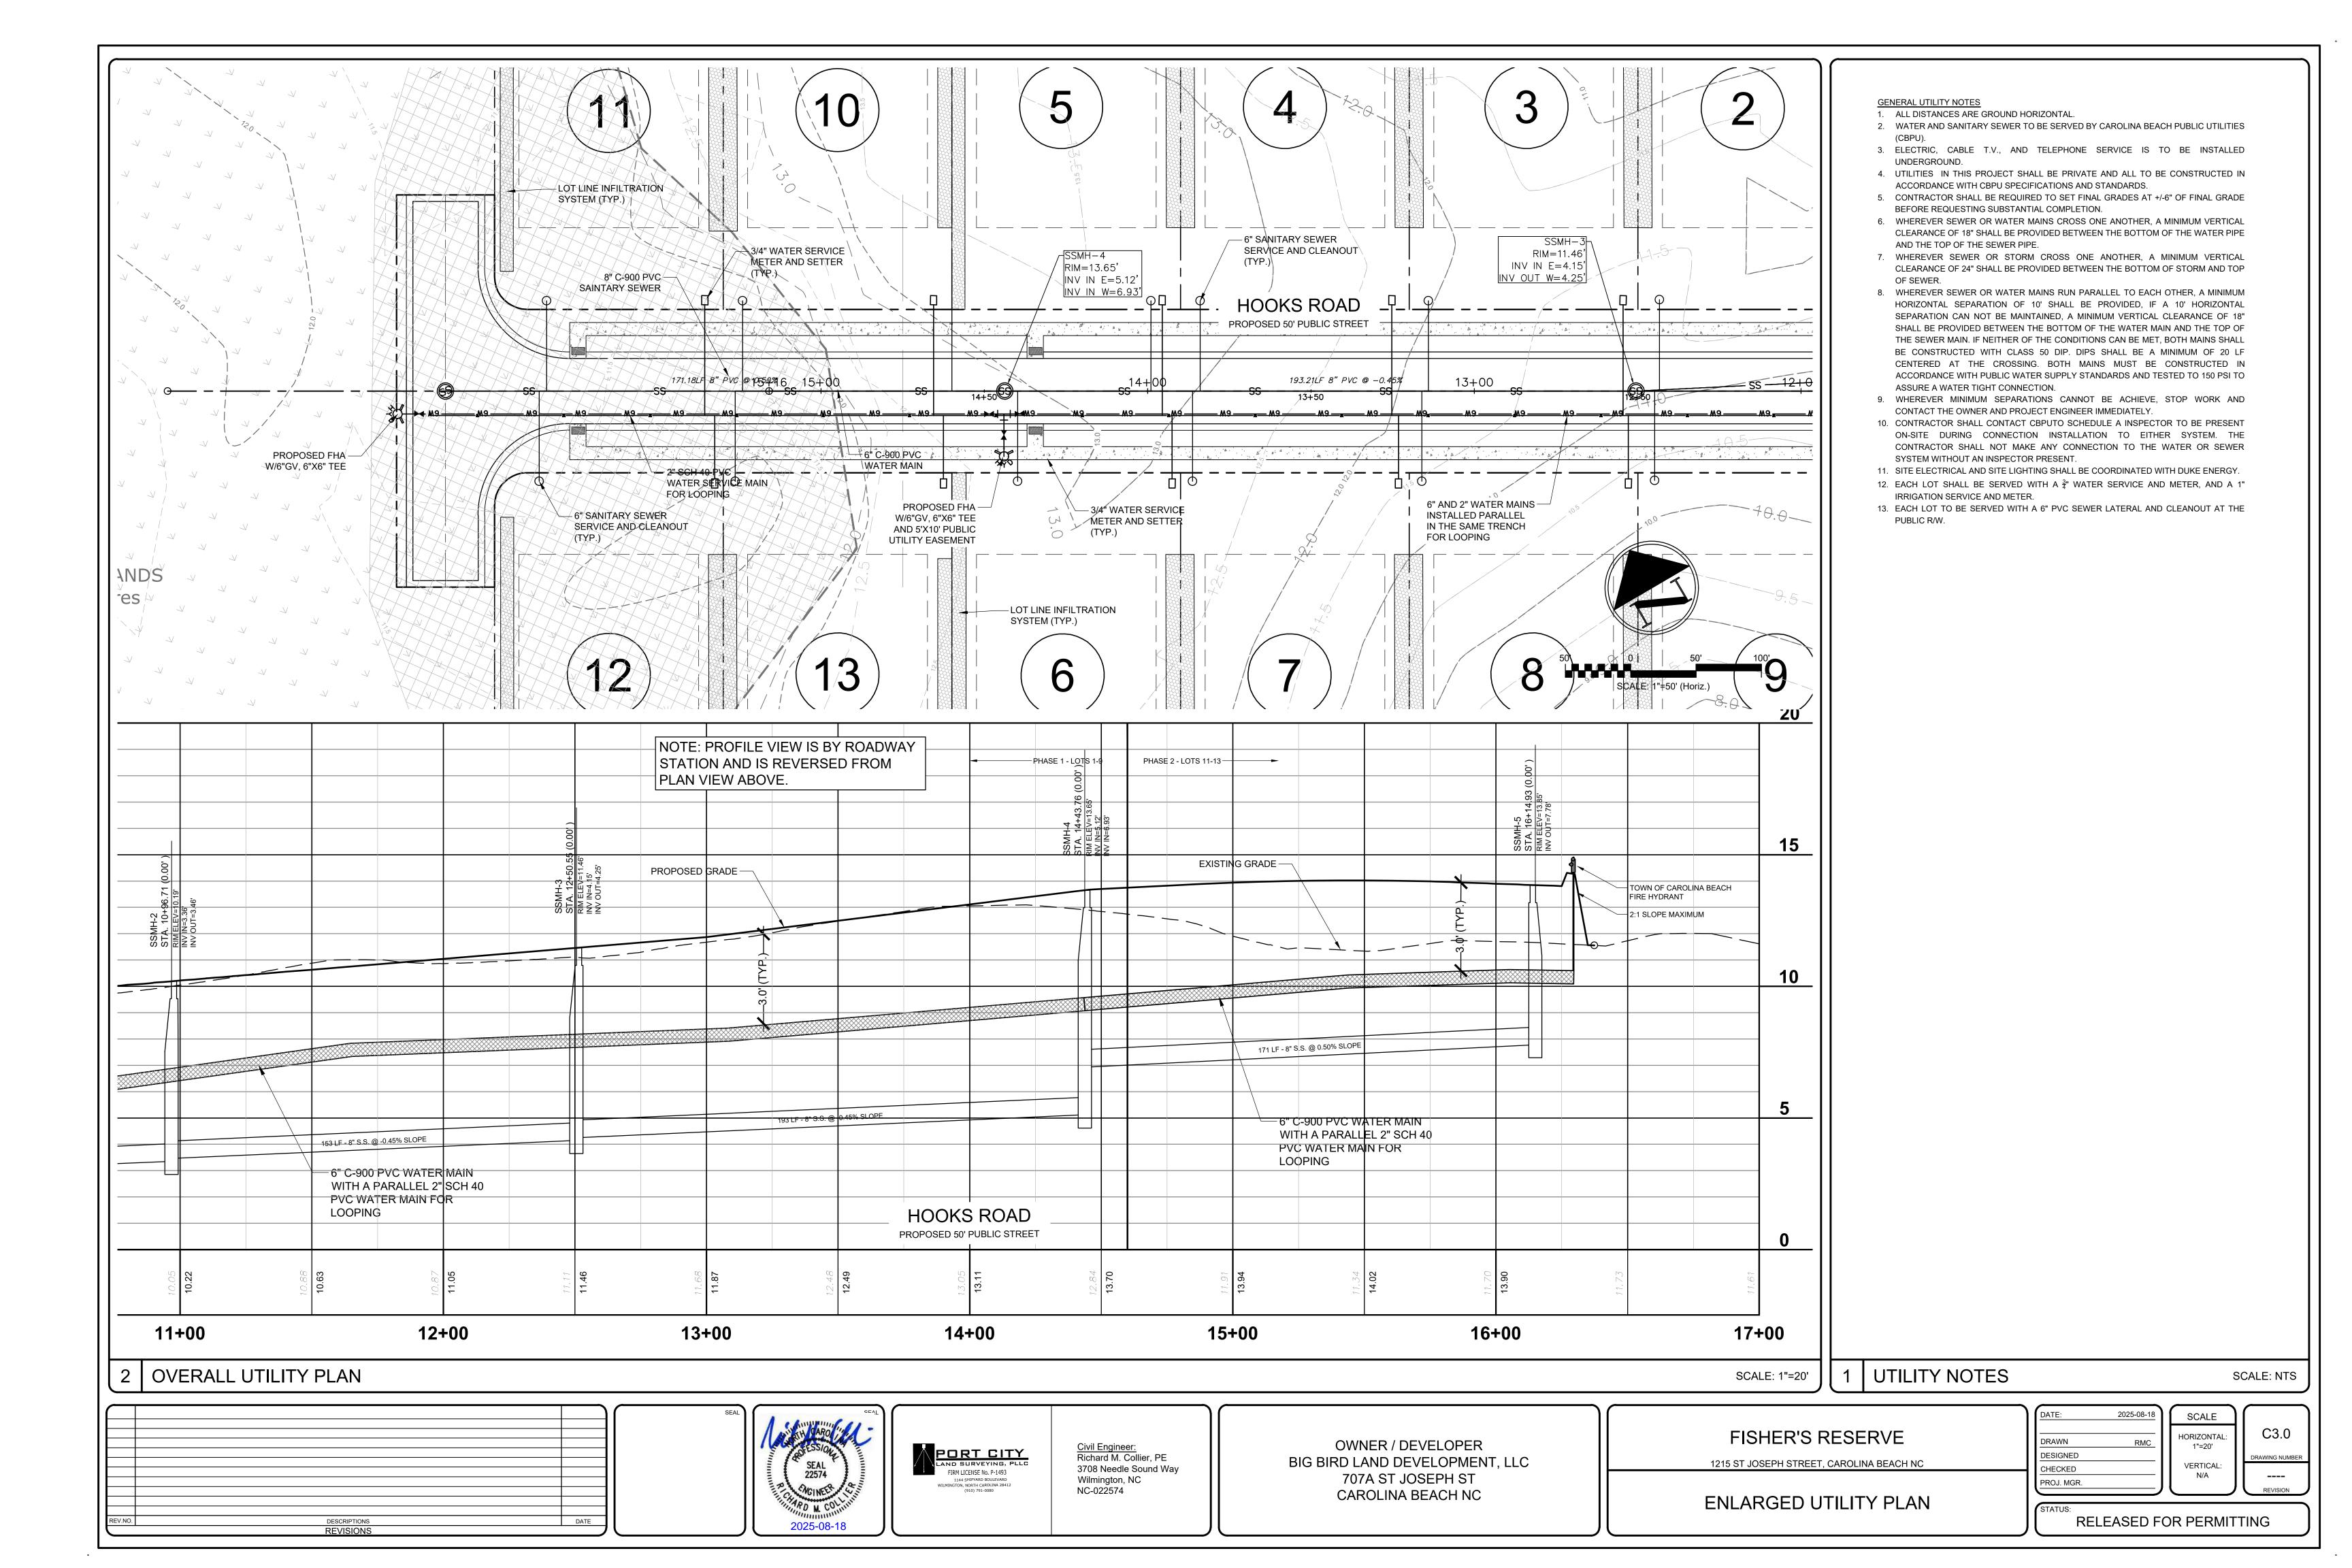

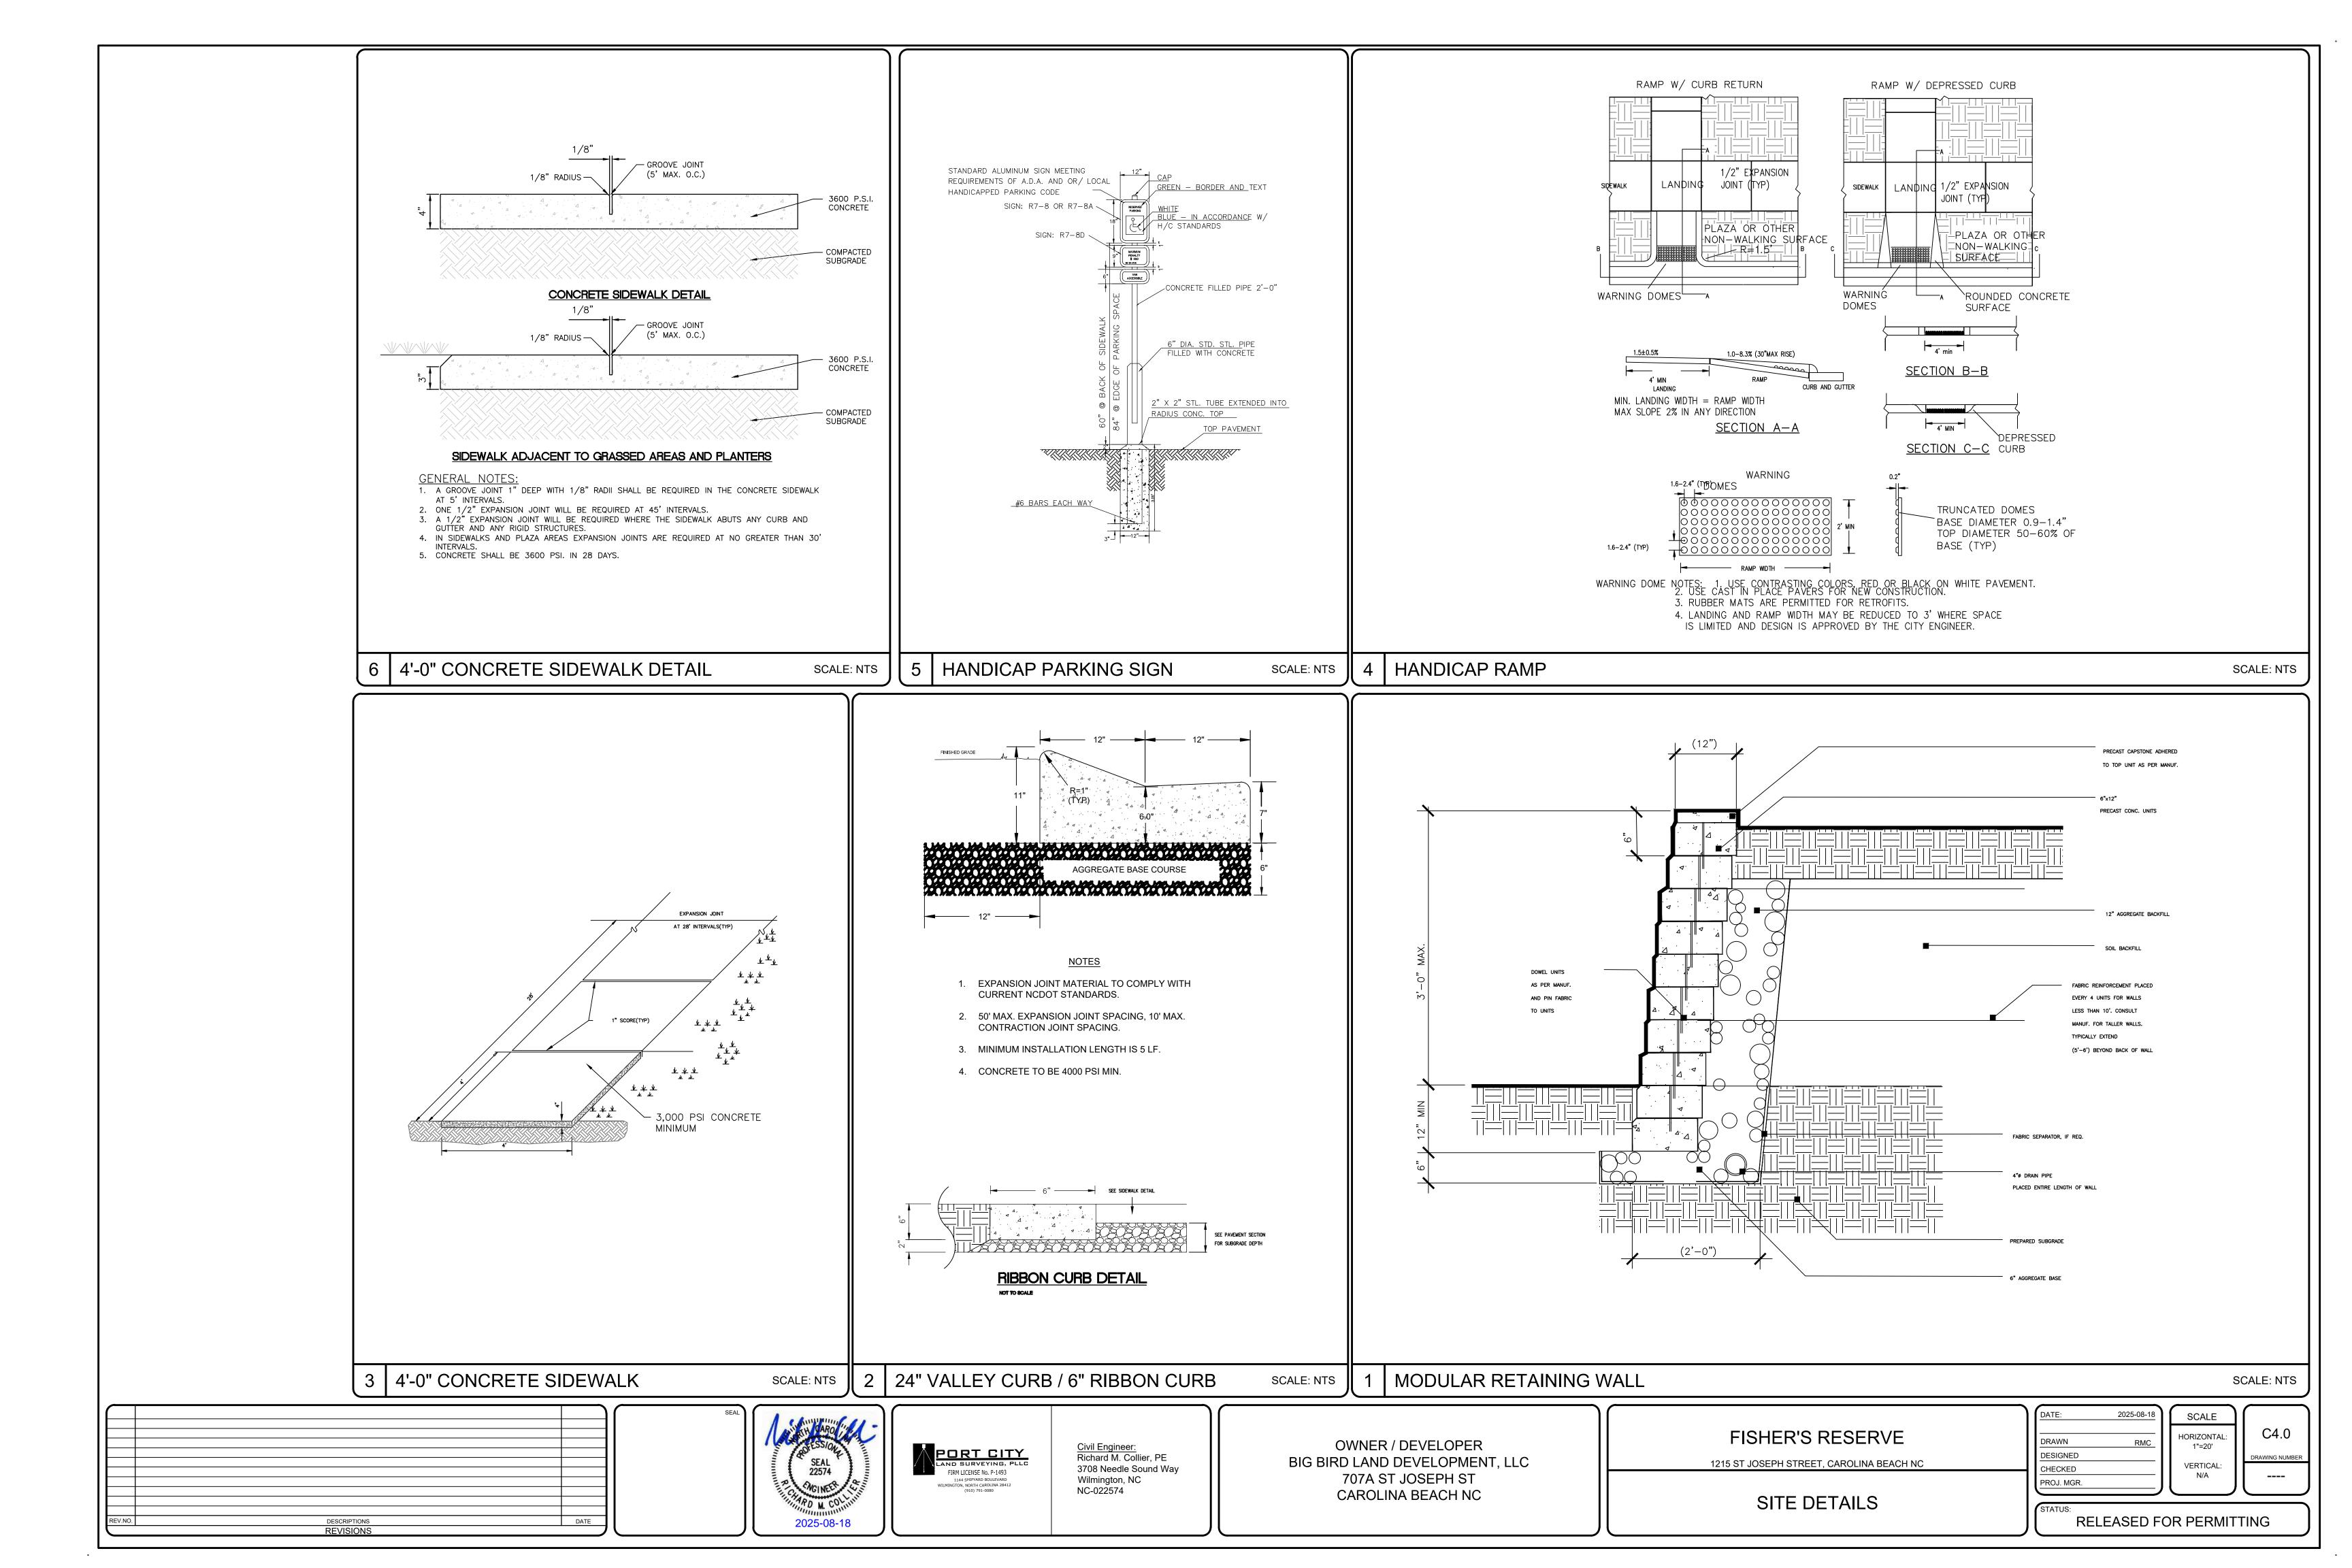

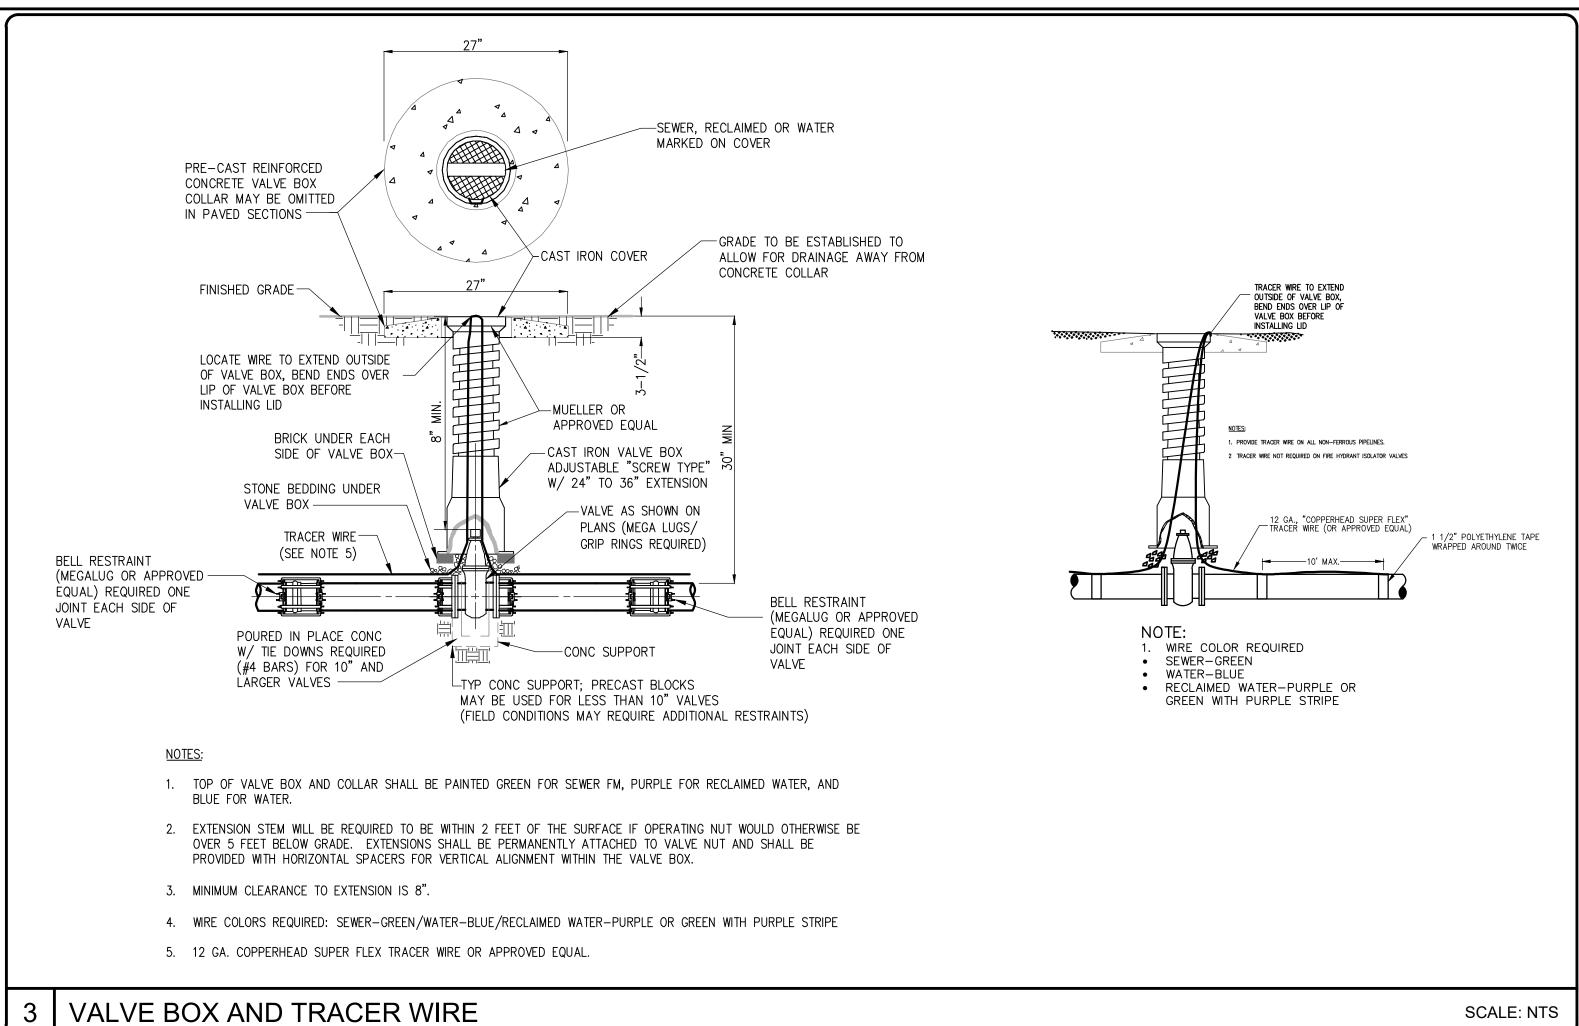

PRECAST SANITARY SEWER MANHOLE

PLASTIC IS ALLOWED IN NON-TRAFFIC AREAS - STAINLESS STEEL

16. MANHOLES SHALL BE TRAFFIC BEARING WITH A MINIMUM HS-20

INSERT PANS ARE REQUIRED IN TRAFFIC AREAS

LOAD ALLOWANCE.

SCALE: NTS

FISHER'S RESERVE

UTILITY DETAILS

DRAWN DESIGNED 1215 ST JOSEPH STREET, CAROLINA BEACH NC CHECKED PROJ. MGR.

VERTICAL:

2025-08-18

RELEASED FOR PERMITTING

SCALE

HORIZONTAL:

C4.1

COMPACTED SUBGRADE

SET MANHOLE ON

2025-08-18

MIN. 8" #57 CRUSHED STONE BASE

<u>Civil Engineer:</u> Richard M. Collier, PE 3708 Needle Sound Way Wilmington, NC NC-022574

OWNER / DEVELOPER 707A ST JOSEPH ST

PORT CITY LAND SURVEYING, PLLC SEAL 22574 FIRM LICENSE No. P-1493 WILMINGTON, NORTH CAROLINA 28412 (910) 791-0080

BIG BIRD LAND DEVELOPMENT, LLC CAROLINA BEACH NC

