

VICINITY MAP

GG JOB NO. 48TH

03/04/22

GENERAL NOTES:

- I PROJECT SHALL COMEY WITH THE 2019 CALFORNA RESIDENTIAL BULDING CODE, PLIMBING, MICHANICAL,
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- I. FINDER GRACE SHALL SLOPE (MINIAMA 55) AREA FROM STRUCTURE.

 J. ALL MATERIALS CONTAINING GRASS, BRUSH OR ROOTS SHALL BE STREPTED PRICE IN OWN GRADING OPERATION. THE MATERIAL SOUTHWARK GRASS, BRUSH OR ROOTS SHALL BE STREPTED PRICE IT OWN GRADING OPERATION. THE MATERIAL SHALL BE STRONGED FROM LATER LATE PROPERTY OF THE MATERIAL SHALL BE STRONGED FROM LATER LATER SHALL BE STRONGED FROM LATER LATER SHALL BE STRONGED FROM THE MATERIAL SHALL BE STRONGED FROM THE MATERIAL SHALL BE STRONGED FROM LATER SHALL BE

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 2. ENDOW PROCESSARY OF THE FORMANDORS SHALL BE BROUGHT TO THE ATTENTION OF THE ENGINEER BELOW THE BROWN PROPERTY OF THE PROPER

FRAMING, FINISHES, ETC.:

- 12. DETERMS STUCCO MULES SHALL HANK A 3 1/2" WEEP SOMEDA OF OR BELOW THE FORMATION

 13. PROVIDE COURSE SHYTEEN AND EMERGE AT ALL SHYSHOFT O'PHINGS.

 14. OCCUPANCY SEPHANDIN BETWEEN GANGE AND HOUSE SHALL BE A SLF-CLOSING, TIDAT FITTING,

 15. OCCUPANCY SEPHANDIN BETWEEN GANGE AND HOUSE SHALL BE A SLF-CLOSING, TIDAT FITTING,

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- PLUSHING.

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- PLUMBING CONTINUES.

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- HECHANICA:

 1. ALL WORK SHULBE DONE IN ACCORDANCE WITH (2019 C.M.C.) AND ALL APPLICABLE CODES AND LOCAL

 CONTINUACES:

 2. CONTAINANCES:

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- ALL 1989 CHALLES DONE IN ACCORDANCE WITH THE LATEST EXTENT OF (2019 C.E.C.) AND ALL APPLICABLE OCCOSS. AND LOCK ORDERWISES IS AND 20 AMP RESPERAGE STRIFFS INSTALLED OUTDOORS. ALL ADDRESS OF THE CONTROL OF THE STRIPPS OF THE STRIPPS
- 4. SHOULD DETECTORS SHALL RECIDE THEIR PROMATE FINDS THE BALLONG WINNS AND HAVE BITTEN FORCE, PP. OR SMOKE OFFICEROR SHALL BE LOUDTON IN LOCATION THE STEELEN ROOMS A HAVENUM STEELEN FORCE OF SHALL HAVE A CLEANAGE OF NOT LESS THAN 3 FEET FROM WINNINGS, DOORS, SERVICE CONDUCTION SHALL HAVE A CLEANAGE OF NOT LESS THAN 3 FEET FROM WINNINGS, DOORS, SERVICE CONDUCTION HAVE A FEED AND SHALL HAVE CODE. CONSIDERING WINDS WITH AN INSULATION HAVE A FOUR-PROMOS OFFICE AFFECTION AND THE STREET OF THE STALL HAVE A FOUR PROMOS OFFICE AND THE STALL HAVE A FOUR PROMOS OFFICE AND THE STALL HAVE A FOUR PROMOS OFFI AND THE STALL HAVE A FOUR PROMOS OF A FEED AND THE STALL HAVE A FOUR AND THE STALL HAVE AND

- J. LI, LONDRY ROOM RESPIRACES THE SERVICED BY A DEDICATE 20 AM CHICATO, A TRATON-ABILITY FREEZACES SHALL BE RESPILATED IN ACCORDANCE WITH THESE DISTRICT, AND THE ALL AND THE COLLEGE AND T
- LUMMANES SHALL NOT HAVE SOEW BASES RECARDLESS OF LAMP TYPE AS DESCRIBED IN SECTION 150.0011/LC. CENTAINING LID UNIT SOURCES. AS QU'-24 LAMP THYRING IS A TRIG-PHIC CONNECTOR 150.0014/CT FLUCKSCSDIT LAMPS (CT) ON LED LAMPS THAT USES A BAYONET MOUNT-LIKE THIS T-LOCK THOS HE CONNECTOR BESTALD OF AN DISCOS SCENE HITTING. AN USE A SECOND SCENE HITTING. AN USE OF SECOND SCENE HITTING. AN USENT SCENE CONTROL OF SECOND SCENE HITTING. AN USENT SCENE SCENE SCENE SECOND SCENE HITTING. AN USENT SCENE SCEN
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OCCUPANCY CLASSIFICATION R-3/U BUILDING CONSTRUCTION TYPE V-B

FIRE FLOW REQUIREMENTS FOR SUBJECT PROPERTY ARE A MINIMUM 1,000 GALLONS PER MINUTE FROM HYDRANT LOCATED WITHIN 250 FEET. EXISTING HYDRANT 1,509 G.P.M.

- THESE PLANS ARE IN COMPLIANCE WITH CALIFORNIA BUILDING AND FIRE CODES (2019) AND DISTRICT AMENDMENTS.

- THESE FAMAL ARE IN COMPLANCE WITH CALFORNIA BULDING AND FRE CODES (2019)

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EROSION CONTROL:

- EROSION CONTINUENCE, CARDING, OR PLOUNTION SHILL BE DONE EFFECTIVE ACTIONS IN THE PROPERTY ACTIONS IN THE PROPERTY ACTIONS OF THE PROPERTY ACTIONS OF


TESTED AND LABELED TO COMPLY WITH THE AMAA STANDARDS PER CRC, SEC. 609.3.
 SAFETY GLAZING TESTING AND LABELING PER CRC, SECTIONS 308.1 & 308.4.
 ENERGY TESTING AND CERTIFICATION PER CERC, SEC 110.6.


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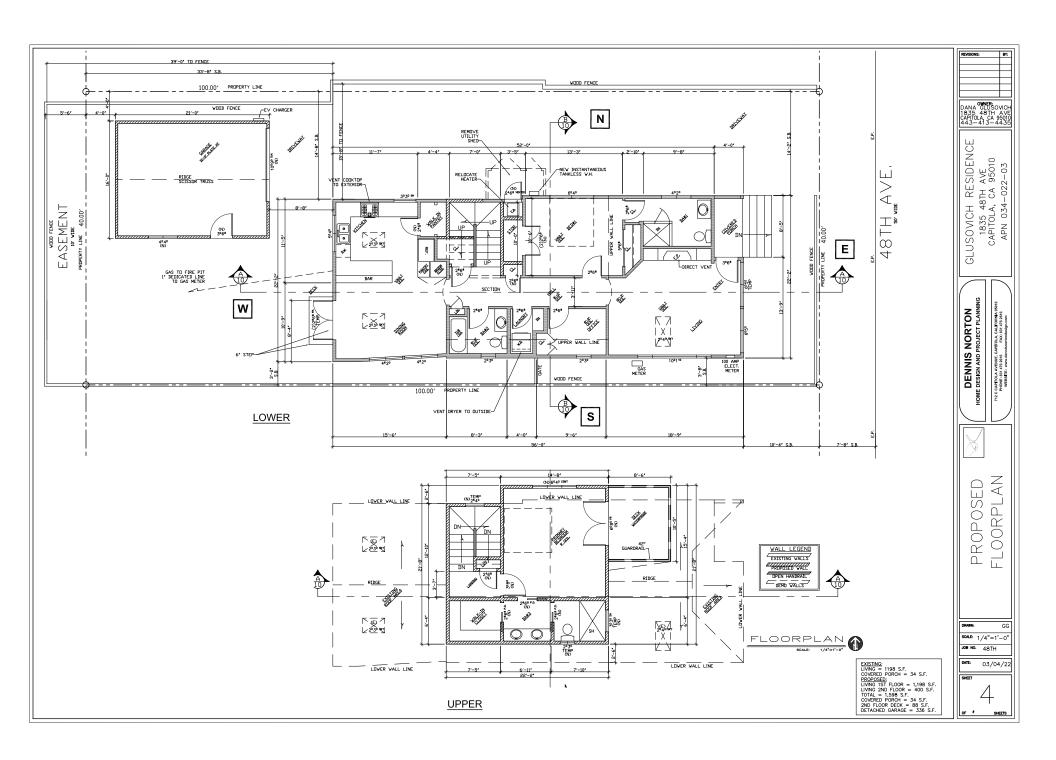
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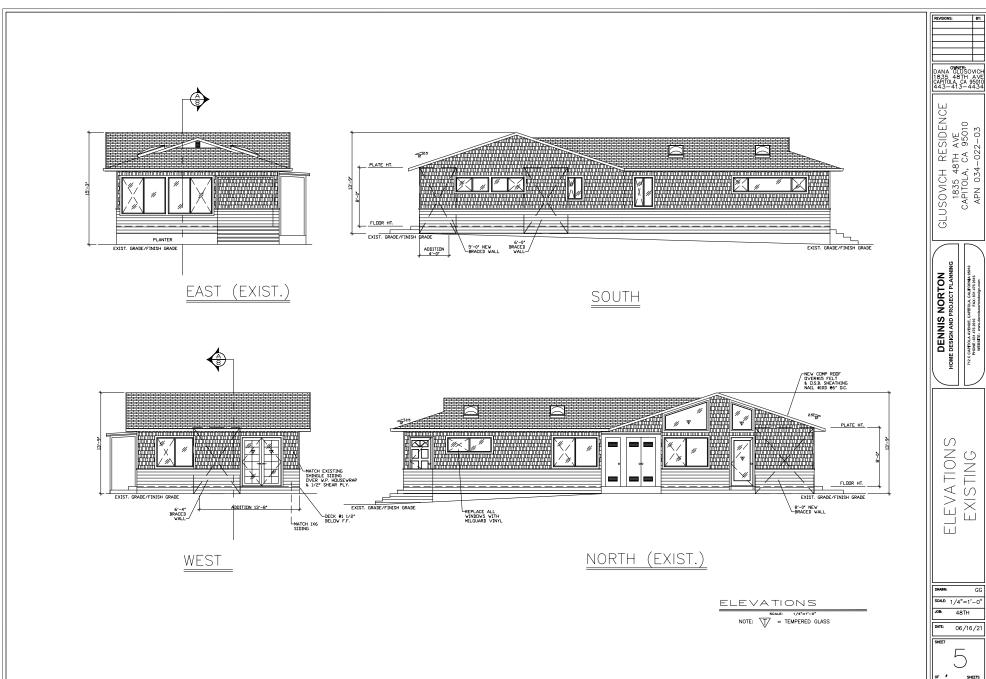
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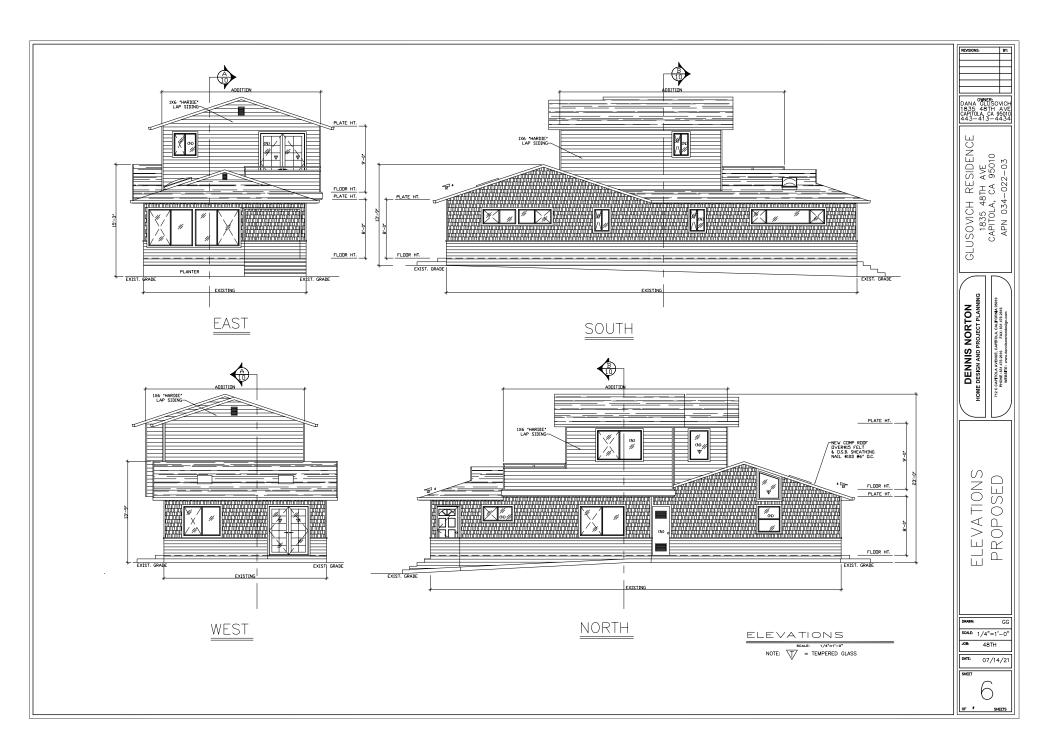









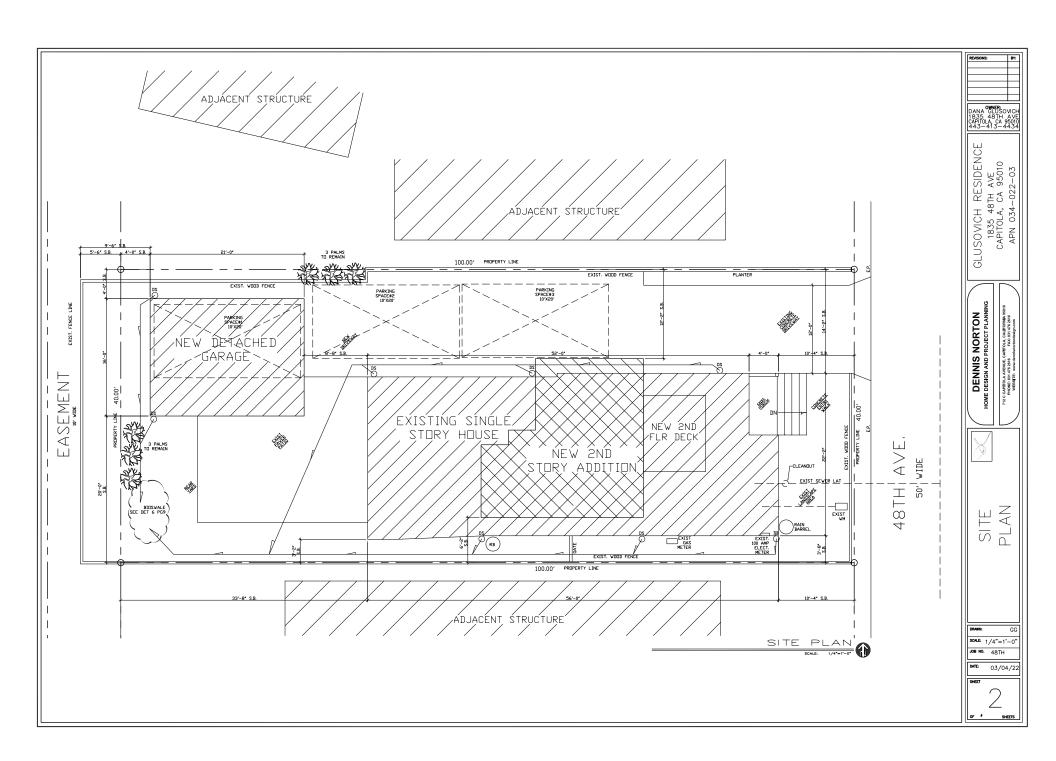

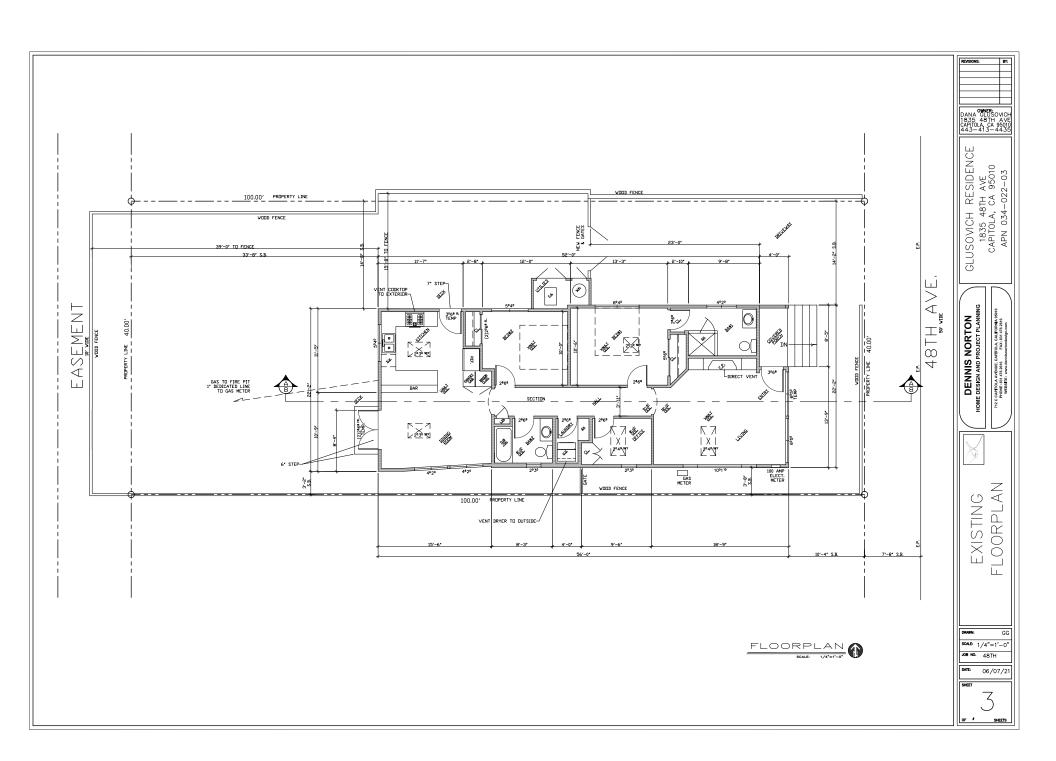

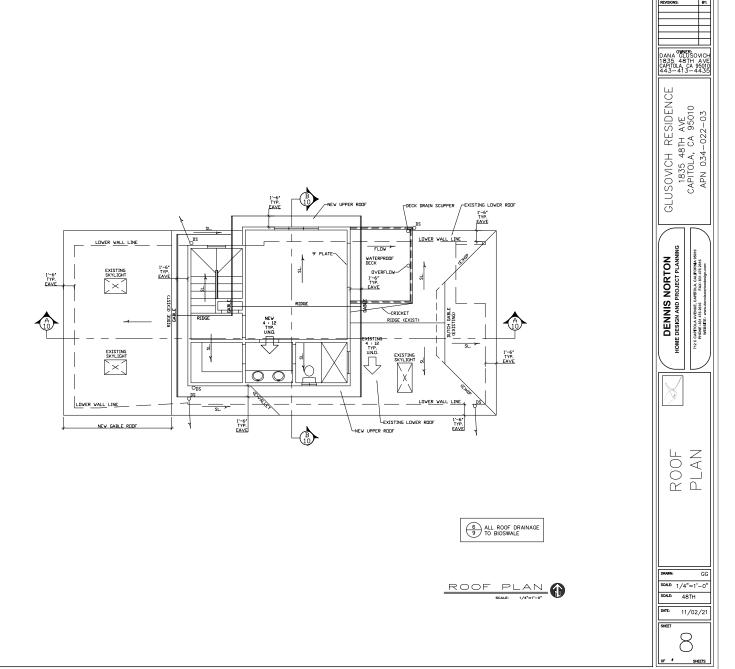

1X8 T.&G. PINE (AT EAVES)-

1X6 PINE DECKING

BLOCK & VENT EACH BAY-


SCALE: NONE

└-2X6 EXTERIOR WALL FRAME

COPPER D.G. GUTTERS TO D.S.

(1) SEMI-PERMEABLE PAVERS (DRIVEWAY) SOLDIER COURSE PAVER GROUTED ON CONC. CURB - 5 MIDE X 15 DEEP SLOPE 2% TOWARD STREET PERVIOUS PAVEMENT PER PLAN OVER 2" THK, NO. 8 AGGREGATE OPEN GRADED BEDDING COURSE & JNT: OVER MIRAFI HP370 2.5" ASPHALT CONCRETE — PAVING WITH 12" WIDE V CHANNEL 7" CLASS 2 AGGREGATE TRANSPORTED TO BASE (3/4" MAX AGGREGATE STZE) 4" CLASS 57 STONE OPEN GRADED BASE 7" CLASS 2 AGGREGATE BASE (3/4" MAX AGGREGATE SIZE) OVER GEOTEXTILE

(2) SEMI-PERMEABLE PAVERS (PATIOS & WALKWAYS)

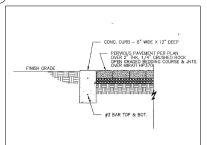

EXISTING TREE LEGEND

ex. tree to remain (typ.)

2" DIA. GALVANIZED STEEL FOST, TYP.

EXTERNITION OF PERMITTER BY SEN-BEYONG THE DRIFFLINE OF MATURE SERVING THE DRIFFLINE OF MATURE

PROTECTIVE FENCING FOR EXISTING TREES

SCALE: 1/4" = 1" - 0"

ex. tree to be removed (typ.)

(5) TREE PROTECTION PLAN

TREE RENTIFICATION (NOTES:

1. Prot to initiating any construction activity in the uses, including grading, ternormany fencing shall be invalided at each afte less. Fencing shall be located to compay dry line as other 100% of the day line will be proceded by fencing. To reduce soil compaction from equipment, a malor of 1.2 here included any of the called any of the day of a distinct shall not executed by the control to the other lines where the second control to the called any of the distincts where no exercised in is located in the dry lines of the called any of the distincts where no exercised in its located in the day of the distinct where no exercised in its located in the driving its lines exercise the procedure.

makes, sord weeks, construction machinery or construction materials shall be stored or allowed to stand for any period of time within the day line of this en-further, no one shall enter the fence per incide for any reason except for the purpose of moritaring the health of the tree. Additionally always to bank, root proving, or limits replay inverses the problematic for future declare in the health of the time.

Contractors and subcontractors shall direct all equipment and personnel to remain outside the ferced area and at all times until the p d shall instruct employees as to the purpose and importance of fencing.

Unauthorized tree removal is subject to in-kind reptacement equal to the mature resource lost as determined by the city.

15. The contractor is required to water, furtilize and etiend to other maintenance needs of existing trees as needed per arboratts recommendations to intribute healthy growth throughout the construction period. Six foot dameter minimum by six high lat each beams shall be constructed at the base of each to furtilize the foot of the construction period. These shall be watered according to weather and tree requirements.

c. Epiphon as near environment on convene minimization, in a land may or record on process.

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NOTES: ALL NEWLY PLANTD TREES TO BE DOUBLE STAKED USING RUBBER TREE TIES

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PROTECTIVE THE ERROR AND OTHER PROTECTION MEASURES

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SANITATION FACILITIES SHALL BE CONTAINED (E.G., PORTABLE TOLETS) TO PREVENT DISCHARGES OF POLLUTAINTS TO THE STORM WATER DRAINAGE SYSTEM OR RECEIVING WATER, AND SHALL BE LOCATED A INMIMUM OF 20 FEET MANY FROM AN INLET, STREET OR DRIVENAY, STREAM, RIPARIAN AREA OR OTHER DRAINAGE FACILITY.


SANITATION FACILITIES SHALL BE INSPECTED REGULARLY FOR LEAKS AND SPILLS AND CLEANED OR REPLACED AS NECESSARY.


COVER WASTE DISPOSAL CONTAINERS AT THE END OF EVERY BUSINESS DAY AND DURING A RAIN EVENT.

STOCKPILED WASTE MATERIAL SHALL BE CONTAINED AND SECURELY PROTECTED FROM WIND AND RAIN AT ALL TIMES UNLESS ACTIVELY BEING USED.


EQUIPMENT AND MATERIALS FOR CLEANUP OF SPILLS SHALL BE AVAILABLE ON SITE AND THAT SPILLS AND LEAKS SHALL BE CLEANED UP IMMEDIATELY AND DISPOSED OF PROPERLY.

3 FIBER ROLL

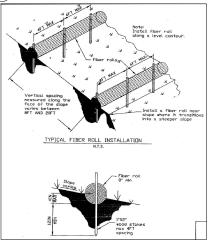


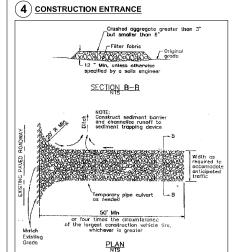

(6) BIOSWALE

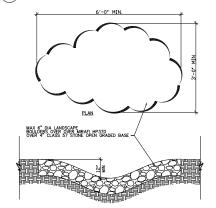

(7) STORM DRAIN INLET PROTECTION

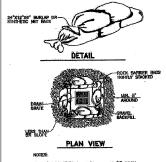

1. FILL HOCK BARRIER BAGS % FULL OF %" ROCK.

SITE HOUSEKEEPING REQUIREMENTS: (8) CONSTRUCTION MATERIALS

ALL LOOSE STOCKPILED CONSTRUCTION MATERIALS THAT ARE NOT ACTIVELY BEING USED (I.E. SOILS, SPOILS, AGGREGATE, FL-ASH, STUCCO, HYDRATED LIME, ETC.) SHALL BE COVERED AND REPUIED.

ALL CHEMICALS SHALL BE STORED IN WATERTIGHT CONTAINERS (WITH APPROPRIATE SECONDARY CONTAINMENT TO PREVENT SPILLAGE OR LEAKAGE) OR IN A STORAGE SHED (COMPLETELY ENCLOSED).

EXPOSURE OF CONSTRUCTION MATERIALS TO PRECIPITATION SHALL BE MINIMIZED. THIS DOES NOT INCLUDE MATERIALS AND EQUIPMENT THAT ARE DESIGNED TO BE OUTDOORS AND EXPOSED TO ENVIRONMENTAL CONDITIONS (I.E. POLES, EQUIPMENT PADS, CABINETS, CONDUCTORS, INSULATORS, BRICKS, ETC.).

BEST MANAGEMENT PRACTICES TO PREVENT THE OFF-SITE TRACKING OF LOOSE CONSTRUCTION AND LANDSCAPE MATERIALS SHALL BE IMPLEMENTED.

SITE HOUSEKEEPING REQUIREMENTS: VEHICLE STORAGE & MAINTENANCE AND LANDSCAPE MATERIALS

MEASURES SHALL BE TAKEN TO PREVENT OIL, GREASE, OR FUEL TO LEAK IN TO THE GROUND, STORM DRAINS OR SURFACE WARRS. ALL EQUIPMENT OR VEHICLES, WHICH ARE TO BE FUELED, MAINTAINED AND STORED ONSITE SHALL BE IN A DESIGNATED AREA FITTED WITH APPROPRIATE BMPS. LEAKS SHALL BE IMMEDIATELY CLEANED AND LEAKED MATERIALS SHALL BE DISPOSED OF PROPERLY CONTAIN STOCKPILED MATERIALS SUCH AS MULCHES AND TOPSOIL WHEN THEY ARE NOT ACTIVELY BEING USED. CONTAIN FERTILIZERS AND OTHER LANDSCAPE MATERIALS WHEN THEY ARE NOT ACTIVELY BEING USED.

DISCONTINUE THE APPLICATION OF ANY ERODIBLE LANDSCAPE MATERIAL WITHIN 2 DAYS BEFORE A FORECASTED RAIN EVENT OR DURING PERIODS OF PRECIPITATION. APPLY ERODIBLE LANDSCAPE MATERIAL AT QUANTITIES AND APPLICATION RATES ACCORDING TO MANUFACTURE RECOMMENDATIONS OR BASED ON WRITTEN SPECIFICATIONS BY KNOWLEDGEABLE AND EXPERIENCED FIELD PERSONNEL.

STACK ERODIBLE LANDSCAPE MATERIAL ON PALLETS AND COVERING OR STORING SUCH MATERIALS WHEN NOT BEING USED OR APPLIED.

(11) TYPICAL DRIVEWAY EXIST. FOR YMEES SUITER SECULER SECULER SECULER 10X MAX



DANA GLUSOVICH 1835 48TH AVE CAPITOLA, CA 95010 443-413-4435

RESIDENCE 1835 48TH AVE CAPITOLA, CA 95010 APN 034-022-03

GLUSOVICH

NORTON PROJECT PLANNIN CAPITOLA, CALIFORMA 95 FAX: 831 476 2616 mnisnortendesion.com DENNIS I CAPITOLA AVENUE, C PHONE: 831 476 2616 WEBSITE: www.der

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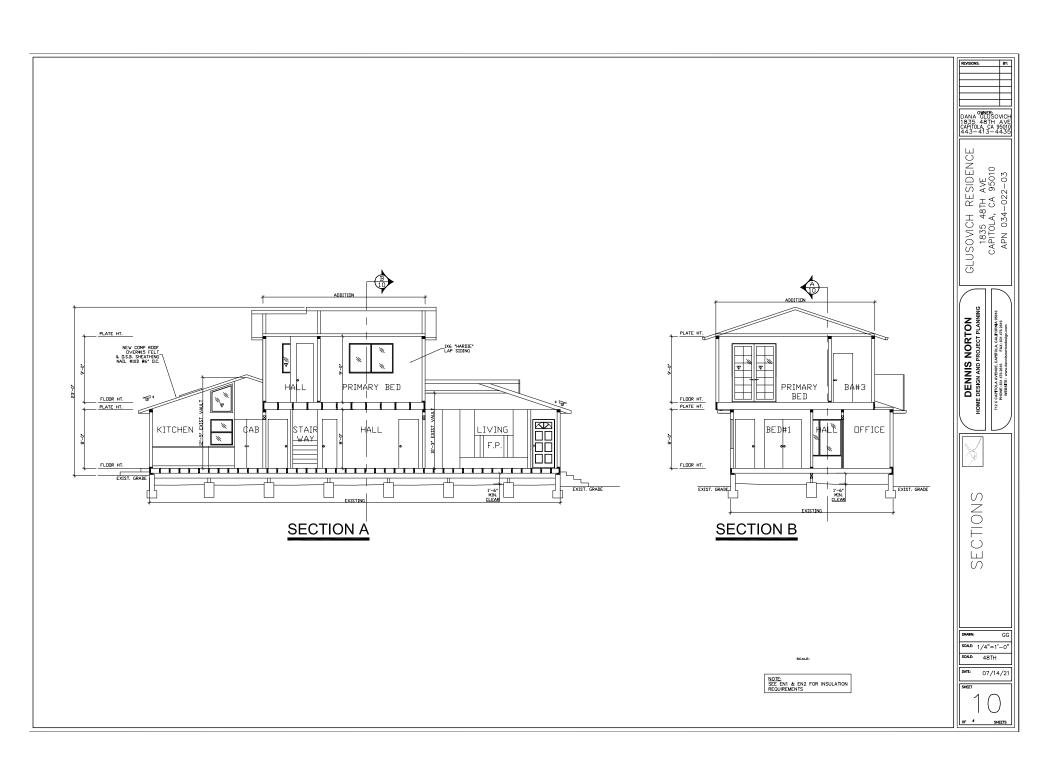
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SITE HOUSEKEEPING REQUIREMENTS: WASTE MANAGEMENT

DISPOSAL OF ANY RINSE OR WASH WATERS OR MATERIALS ON IMPERVIOUS OR PERVIOUS SITE SURFACES OR INTO THE STORM DRAIN SYSTEM SHALL BE PREVENTED.

DISCHARGES FROM WASTE DISPOSAL CONTAINERS TO THE STORM WATER DRAINAGE SYSTEM OR RECEIVING WATER SHALL BE PREVENTED.

PROCEDURES THAT EFFECTIVELY ADDRESS HAZARDOUS AND NON-HAZARDOUS SPILLS SHALL BE IMPLEMENTED.



Stormwater Pollution Prevention and Protection for Construction Projects

In the City of Capitola, water in streets, gutters, and storm drains flows directly to local creeks and Monterey Bay without any three City of Capitola, water in streets, paint, corrode and other harmful pollutants from construction sites and home construction projects spilled, leaked or washed in the tested or storm drain they can darrange sensitive oresh habitats and end up polluting our bay.

In order to reduce the amount of polutants reaching local storm drains and waterways, the City has developed "Best following for construction projects are required to abide by the following maradatory SIAPs." These SIAPs apply to both new and remodeder desidential, commercial, retail, and industrial projects.

In addition to the following mandatory BMPs, the Central Coast Regional Water Quality Control Board (Regional Water Board) In addition to the following mandatory BMPs, the Certail Coast Regional Water Quarty Cortrol Board (Regional Water Board) under the Stalle Water Recourses Certoid Board (Stale Water Board) equires conseque under and antievence to the under the Stale Water Recourses Certoid Water Board (Stale Water Board) under the Stale Water Parket Foundation of the Stale Parket Foun

♦ General Construction & Site Supervision
All construction BMPS, sediment and erosion control must be installed prior to beginning construct
Hroughout the project duration. Conpliance with the CGP and below BMPs is required year roun

- real Principles
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 Haintain equoment properly.

 Lover materials when they are not in use.

 J Reep materials away from street, guitares, sform drains and drainage channels.

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 J Resp materials away from drains away from
- Feder to the following approved references for BMP selection, implementation, and on-site management (most secent vessions unless otherwise noted)

 Feder and Sestement County Fed Manual, California Regional Water Quality Control Board San Francisco Bay Region,

 Feder and Sestement County Feder Manual, California Regional Water Quality Control Board San Francisco Bay Region,

 Feder and Sestement County Feder Sestion (Feder Sestion Sestion of Bay Area Governments (ABAG)

 **Allameted O'Standards for Erotato and Sediment Control Measures, Association of Bay Area Governments (ABAG)

 **Construction Based Management Practices (BMPs) Manual Sostemwater Quality Association (CASAG)

 **Construction Based Management Practices (BMP)

 **Construction Based M

- Social Neuralization Practices

 Geological Processing Practices

 Geological P
- way were an unable or better that up is provent washing into the storm drains.

 The province materials and subsciples out of the rain and prevent unrund contamination from the site. Sever materials, stockeles for the province of the provi
- Flace trash cans around the site to reduce litter. Dispose of non-hazardous construction wastes in covered dumpeters or

OTTO SCALE	E CAPIA	STANDARD DRAWINGS FOR	DRAWN 2/14	REV:
RAWN BY:	SE)	STORMWATER POLLUTION PREVENTION AND PROTECTION FOR CONSTRUCTION PROJECTS		
HECKED	- 18 m		DRAWI	NG No

- plean up leaks, drips and other sxills immediately so that they do not contaminate the soil or runoff nor leave residue on layed surfaces. Use dry cleanuly methods whenever possible. Water may only be used in minimum quantities to prevent
- If portable toilets are used, ensure that the leasing company properly maintains the toilets and promptly makes repairs.
- Conduct visual inspections for leaks.

 Protect vegetation and trees from accidental damages from construction activities by surrounding them with fencing or tree amoning.

- amoning.

 Advanced Planning

 Site development ability before the topography and solis in order to minimize the potential for erosion.

 Site development ability before the topography and solis in order to minimize the potential for erosion.

 Sel grading-liquidiaring imms, essentients, settlands, sensitive or ordical areas, trees, drainage courses, and buffer zones must be a consistent of the consistent of

- Materials & Waste Handling

 Practice contaminant 'Source Reduction' by estimating carefully and minimizing waste when ordering materials.

 Revycle excess materials such as concrete, asphalt, scrap metal, solvents, degressers, paper, and vehicle materianized.
- Fractice contaminant "Source Reduction" by estimating carefully and minimizing waste when ordering materials Recycle excess materials such an concerde, asphalt, script metal, solvents, degressers, paper, and vehicle maintenance materials whenever possible. Biospace of all wastes properly by ensuring that materials that cannot be recycled are taken to an appropriate land fill or disposed of as hazardous waste. Never bury waste materials or leave them in the street or nar a revet or drainage channel.

♦ Landscaping, Gardening & Ponds/Fountains/Pool/Spa Maintenance

Mary landscaping activities and practices expose soits and increase the likelihood of valetr runoff that will transport earth, as defined and agriden chemicals to the storm drain during ingleston or rain events. Other exterior arrantise such as ponds, pools and spas require regular maintenance using chlorine and/or copper based algebroides. Water treated with these chamicals is local to aquatic life and/should never be discharged to be soften drain.

- Landscapina, Edined Maintenance

 | Frotest stockples and landscappr materials from wind and rain by storing them under tarps or secured plastic at

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 | Frotest stockples and landscappr materials from wind and rain by storing them under tarps or secured plastic at

 | Frotest storing many and stockples of the first storing and the storing materials and the storing material rials from wind and rain by storing them under tarps or secured plastic sheeting.

Ponde/Fountains/Pool/Spa Maintenance

When draining a pond, buntlain, pool or spa, any volumes in excess of 500 gallons must be reported in advance to the City
of Capitole Polic Words Department. The City will provide guidance on handling special cleaning waste, flow rate restrictions and backflow prevention.

♦Preventing Water & Sediment Runoff

▼Preventina Water & Sediment Runoff
Electrice recovaries and sediment confirm assumes must be implemented and maintained on all disturbed areas in order to prevent a ref increase of sediment in the site's storm water discharge nishine to pre-construction levels. During the railway to prevent a ref increase of sediment in the site's storm subjective facions only the site's periment and at all railway to the storm drine signer. Electron emitted to protect seaming appropriate facions only the site of the site of the sediment of the sediment facility of sediment facility and sediment facility of sediment facility of sediment facility and sediment facility of sediment facility of sediment facility and the sediment facility revisions of the Maruel of Standards for Eroson and Sediment Control Measures, Association of Bay Area Governments (ABAG), and Construction East Management Praduces (BMFe) inhabitors, California Biomarder quality Association (CASAGA).

NOT TO SCALE	OF CAPITA	STANDARD DRAWINGS FOR	DRAWN 2/14	REV:
DRAWN BY:	S S	STORMWATER POLLUTION PREVENTION AND PROTECTION		
CHECKED BY:	OAPORATED IS		DRAW	NG No
S.E.J.		STEVEN JESSERS, PUBLIC WORKS DIRECTOR	STRW-	BMP-2

- Effective filtration devices, barriers, and settling devices shall be selected, installed and maintained property.

 Sit fences must be installed so that the drainage around each know does not create additional erosion and rills down slope
- of the fence, it staw audits are used to filter sediment rundft, ensure that the bales are actually filtering the water (and not just causing the water to tavel around the bably and that the staw pieces are not carried into the storm drain system. Whenever possible, use therearing suffer coupleming (e.g. with a buldiozer), and energy dissipaters (such as rigna), sand bags and rocks) on slopes to reduce rundft velocity and trap sediments. Do not use asphalt rubble or other demolition debt for this curpose.
- for rule purpose.
 All on-site derosion control measures and structural devices, both temporary and permanent, shall be properly maintained so that they do not become nuisances with stagnant water, odors, insect breeding, heavy algae growth, debris, andor safety
- vaualified person should conduct inspections of all on-site BMPs during each rainstorm and after a storm is over to ensure that the BMPs are functioning properly. For sites greater than one-acre, onsite inspections are required in accordance with

Earth Moving Activities & Heavy Equipment
Soil excession and gending sections showed large amounts of soil that can be transported into atom drains when handled ampropely. Efficient encount control practice relation could practice relation to about the flow with check dams impropely in the control of the country of the count

- Site Planning

 Martian at have yequipment, inspect frequently for leaks, and repair leaks immediately upon discovery.

 Perform major auto or heavy sequipment maintenance, repair jobs and vehicle or equipment washing off-site.

 If you must dain and replace motion oil, radiator contant or other fluids on site, use drip pans, plastic sheeting or or policitis to catch office an aplis. Collect all specified, site or in separate containes and procyl dispose as hazardous weate.
- Recycle whenever possible.

 Do not use dissel oil to lubricate equipment parts or clean equipment. Only use water for onsite cleaning.

 Cover exposed fifth wheel hitches and other oily or greasy equipment during all rain events.

Practices During Construction

Remove existing vegetation only when absolutely necessary. Plant temporary vegetation for erosion control on slopes or where construction is not immediately planned.

- Remove examing vegetation con yr were assumed to the property of the property
- Governments (ABAG), and Construction Best Wanagement Practices (BMP Association (CASQA). Cover stockples and excavated soil with secured tarps or plastic sheeting.

- Spill Clean Up

 **Anintain a spill clean-up kit on site.

- Nadratina signi clean-up ixt or six any pleaning nethods of possible.

 New Hose Sound Ring Powershot or Imperiments extraction where fluids have spilled. Use dry cleaning methods (bisorbent materials, call liter and/or rap) whenever possible and properly dispose of absorbent materials. call liter and/or rap) whenever possible and properly dispose of absorbent materials. Settled in spilled of the materials mirredisting, Newer attempts to was them neavy with water or bury them.

 Call 911 or spillcant spills, if the spill poses a significant hazard to lumina health and calledy, you must also report to the

NOT TO SCALE	OF CAPITA	STANDARD DRAWINGS FOR	DRAWN: 2/14	REV:
DRAWN BY: M.P.	5	STORMWATER POLLUTION PREVENTION AND PROTECTION		
CHECKED BY:	COMPORATED BY		DRAWII	NG No.
S.E.J.		STEVEN JESSERG, PUBLIC WORKS DIRECTOR	STFM-	BMP-3

Paints, varials, relevants and adhesives contain centricise that are harmful for white field aquatic life in our community. Toxic chemicals may come from liquid or sold importator from cliendary residues or regs. Paint materials and wastes, adhesives an interest and should be recycled when possible or properly disposed to prevent these substances from entering the storm frains and wastercounts.

Haddling of Surface Coatings

Ree part, variah, solvents and adhelve products and wastes away from the guiter, street and atorm drains. Wastewater or runoff containing part or paint thinner must rever be dischaped into the stom drain system.

When there is a risk of a spill resching the storm drain, nearby storm drain inlets must be protected prior to starting painting.

- Removal of Surface Coatings

 Non-hazardous paint chips and dust from dry stripping and sand blasting may be swept up or collected in plastic drop cloth
- Non-hazardous paint chips and dust from dry stipping and sand beating may be exectly up or concerce in passic dwulp cours and disposed of a stip start or variety stipping residue, chips and dust from marine paints or varieties, or participating lead, memory or brought must be disposed of as hazardous westers. Lead based paint removal requires a static-ortified memory or brought or the control of the contr
- intendency usa;. Wash water from painted buildings constructed pre-1978 can contain high amounts of lead even if paint chips are not present. Before stripping paint or cleaning a pre-1978 building's exterior with water under high pressure, test paint for lead by taking pair to scrapings to a ceal, state-certifed laboratory.

- Clean Up of Surface Coatings

 Never clean trushes or rinee paint or varnish containers into a gutter, street, storm drain, French drain or creek.

 For water based paints, paint out trushes to the extent possible and rinse into an interior sink drain that goes to the sanitary
- sewsi.
 For all based paints, paint out brushes to the extent possible and clean with thinner or solvent. Filter and reuse thinners and solvents where possible. Dispose of excess liquids and residue as hazardous waste.
 When thorough dy'd, emerby paint cans, used trushes, rags and drop citchs may be disposed of as garbage.

Description of the control of the co

- ♦ Roadwork & Pavins

 □ Protot nearly atom dams interest and adjacent patter borises part as breaking up applied or concerts

 □ Protot nearly atom dams interest and adjacent patter borises part as breaking up applied or concerts

 □ Protot nearly catch bearing or patter. If selver yet each patter is provided. They are particularly and protoct nearby catch bearing or gatter. If selver yeters the selont direct system, renow meeting climated immediately.

 □ Dred, saw out sturry must be deamed up and properly disposes so that it will not be carried into the storm drain system by write. Letting, committed.
- o, or railman. ting up old pavement, sweep up materials and recycle as much as possible. Properly dispose of non-recyclable
- Cover and seal nearby storm drain inlets and manholes before applying seal coat, slurry seal, etc. Leave covers in place
- Cover and sea meantly sourm to any service we must recover and the control service and search and the control service and cover materials.

 Park paying natchines over the past or absorbert miserials.

 Park paying natchines over the past or absorbert miserials.

 Never wash neverified from exposed aggingle concrete into a street or a storm drain intel. Collect and return to aggregate base obsolve or dispose of in the trash.

 Remove and clean upmarise absorberials (i.e. asphalt and sample by the end of each week or, if during the miny season, by the end of each day. Stockples must be removed by the end of each day. Stockples must be removed by the end of each day.

NOT TO SCALE	OF CAPITA	STANDARD DRAWINGS FOR	DRAWN: 2/14	REV
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Concrete, Cement, & Masonry Products

- llutant laden water shall never be discharged into or allowed to reach
- the storm drain system. Avoid mixing sources around of fresh concrete or cement mortal on-eile. During sile outing, ensure that the sturry water does not our off into the street or storm drain system. The discharge of sturry of the storm drain system. The discharge of sturry on the canded up and disposed of properly. On the storm drain system is prohibble. Of the dainy must be deaded or made disposed of properly. On the storm drain system is prohibble. On the storm of the standard or and disposed of properly of the standard or sold and the storm of the standard or sold and the standard
- be provided on-site.

 Never wash or rinner inning containers and tools into the gutter, street, storm drain inlet, drainage disches or water body.

 If conducting sidewalk work, material stockpiles must be removed and cleaned up by the end of each day. Sweep or collect
 unused materies and debris that remain on persentent and dispose of property.

 When the pols completed, collect all unused or waster materials and dispose of property. Never leave or abandon materials
 onside. Ensule that nothing has drifted bowrist the stitled, putter or contribution.

Site Clean Up Clean up by sweepi

- Site Clean Up

 Clean up by reverping instead of hosing down whenever possible. Dispose of liter and debris in the garbage.

 The street, soldwark and other power areas may not be cleaned by washing or by directing sediment. concrete, apphalt, or other particles in the selection dainy selection. These this substitution of the selection of particles from previnent. The water must be offered to the selection of the

Signed and Agreed to by: Project Owner or General Contractor		
Project Owner or General Contractor		
Signed:	Date:	

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CHECKED BY:	A ORPORATED AS		DRAWI	NG No.
S.E.J.		STEVEN LESSING, PUBLIC WORKS DISECTOR	STRM-	BMP-5

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SCALE: 1/4"=1'-0" JOB NO. 48TLI

06/17/21



