

KEY PLAN



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BUILDING A - FLOOR AND ROOF PLAN
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LANDSCAPE PLAN SITE PLAN RENDERING FENCING EXHIBIT LANDSCAPE MATERIALS EXHIBIT IRRIGATION PLAN AND SCHEDULE IRRIGATION NOTES PL2,3 PL2.4 BUILDING B - EXTERIOR ELEVATIONS BUILDING C - FLOOR PLANS

PL2.2

ARCHITECTSFORA.COM

MIDPEN HOUSING 1098 38TH AVE. CAPITOLA, CA 95062

CHARLES CHARLES CHARLES

JT1.01 DRY UTILITY STANDARDS JT1.02 DRY UTILITY INTENT TOTAL: 51

MARCH 5, 2024

PROJECT INFORMATION

SITE: 1098 38TH AVE, CAPITOLA, CA 95062

APPI: 034-172-01
SITE AREA: 1.977 ACRES (86,118:12 SF)
ZONING: RM-M (MULTI-FAMILY RESIDENTIAL, MEDIUM DENSITY)
GENERAL PLAN: R-M (MULTI-FAMILY RESIDENTIAL)

SITE COVERAGE:

ADDINUM BUILDING COVERAGE:

ADDINUM BUILDING COVERAGE

ADDINUM BUILDING BUILD

MAXIMUM ALLOWABLE FAR: NO REQUIREMENT INDICATED

5: 15% OF SITE AREA MIN 50% UNITS WITH PRIVATE OPEN SPACE MIN 48 SF FOR INDIVIDUAL UNITS

PROPOSED COMMON OPEN SPACE: 22,830 SF / 26% NOT PROVIDED, **SEE REQUESTED CONCESSIONS PROPOSED PRIVATE OPEN SPACE:

REQUIRED SETBACKS:

REQUIRED STEMONS:

MAIN STRUCTURE: 15: 0°, GARAGE: 20'-0'
INTERIOR SIDE - NORTH : JON PARCEL WIDTH: {{14.19:" 20.51:7/27'(0.10) = 17.17" *
INTERIOR SIDE - SOUTH : JON PARCEL WIDTH: {{14.19:" 20.51:7/27'(0.10) = 17.17" *
INTERIOR SIDE - SOUTH : JON PARCEL WIDTH: {{14.19:" 20.51:7/27'(0.10) = 17.17" *
EXCEPTION: MINIMUM INTERIOR SIDE STRUCK SHOULD NOT BE LESS THAN 7 '0' GREATER THAN 7'

*EXCEPTION: MINIMUM INTERIOR SIDE STRUCK SHOULD NOT BE LESS THAN 7' O' GREATER THAN 7'

PROPOSED SETBACKS: 18'-0" (PROVIDING CLEAR ACCESS TO OVERHEAD POWER LINES)

FRONT PORCHES PROJECT 6' INTO SETBACK PER CITY CODE SECTION 7'-0" (AT BUILDING D), 12'-0" (AT BUILDING B)

SIDE - NORTH SIDE - SOUTH REAR 29"-6" (AT BUILDING A), 30"-2" (AT BUILDING C) 131"-0" (AT BUILDING D), 158"-0" (AT BUILDING C)

BUILDING INFORMATION: MAX. ALLOWABLE HEIGHT: PROPOSED HEIGHT:

30°.0"
40°-6" (AT HIGHEST RIDGE OF BUILDING C INTERNAL TO SITE)
26°-3" (AT HIGHEST RIDGE OF BUILDING A & B ALONG 38TH)
**SEE REQUESTED CONCESSIONS

BUILDING A: 2 STORIES TYPE VA CONSTRUCTION BUILDING B. C. D: 3 STORIES TYPE VA CONSTRUCTION

3,723 / FLOOR = 7,446 SF TOTAL 6,034 SF / FLOOR = 18,102 SF TOTAL 7,698 SF / FLOOR = 23,094 SF TOTAL 4,055 SF / FLOOR = 12,163 SF TOTAL BUILDING B: BUILDING C: BUILDING D:

TOTAL BUILDING AREA: 60,805 SF TOTAL

OCCUPANCY TYPES:

PANCY TYPES:

-3 COMMUNITY ROOMS (FIRST FLOOR)

-3 COMMUNITY ROOMS (FIRST FLOOR)

-4 COMMUNITY ROOMS (FIRST FLOOR)

-5 EQUIPMENT 4 UTILITY SPACES (FIRST FLOOR)

USE TYPES & AREAS:

COMMON AREA/SUPPORT FOR RESIDENTIAL/UTILITY:

RESIDENTIAL:

4,265 SF

66,950 SF

BUILDINGS WILL BE ALL ELECTRIC

RESIDENTIAL UNITS: STUDIO UNITS:

1-BEDROOM UNITS 14 (1 MANAGER'S UNIT) 2-BEDROOM UNITS: 3-BEDROOM UNITS:

TOTAL UNITS: 52 UNITS (51 100% BELOW MARKET RATE UNITS WITH 1

DENSITY:

MAXIMUM ALLOWABLE DENSITY:

PARCEL AREA PER UNIT: 2,900 SF MINIMUM = 15 DWELLING UNITS PER ACRE MAXIMUM

STATE DENSITY BONUS LAW ALLOWS 100% AFFORDABLE HOUSING PROJECTS TO UTILIZE THE 80% DENSITY BONUS INCREASE AND UP TO FOUR CONCESSIONS/INCENTIVES FROM THE CITY'S DEVELOPMENT STANDARD.

PROPOSED DENSITY WITH 180% DENSITY BONUS LAW:
PROPOSED DENSITY, 15 DU/AC * 180% = APPROXIMATELY 27 DU/AC
15 DU/AC * 1.977 AC = 29 UNITS * 180% = 52 UNITS
TOTAL PROPOSED UNITS: \$2 UNITS

REQUESTED CONCESSIONS

2) MAXIMUM BUILDING HEIGHT (3) TREE REPLACEMENT RATIO (4) PARKING LOT LANDSCAPING

VEHICLE, EV., AND BICYCLE PARKING



PLANNING RESUBMITTAL

TITLE SHEET

ISSUED: 3/5/2024

DRAWN: JG, KS, YJ CHECKED: SV PA0.1 SCALE:





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38TH AVE APARTMENTS

MIDPEN HOUSING 1098 38TH AVE, CAPITOLA, CA 95062 PLANNING RESUBMITTAL

MARCH 5, 2024

AMENITY MAP

No.	DATE	ISSUE	
<u> </u>	_		
	-		









SHANGRI-LA ESTATES MOBILE HOME PARK SOUTH OF PROJECT SITE ALONG 38TH AVENUE D











MURAL ON O'NEILL SURF SHOP BUILDING ALONG 41ST AVENUE





RETAIL ALONG 41ST AVENUE STREETFRONTAGE WITH RESIDENTIAL ABOVE









SURROUNDING CHARACTER: CAPITOLA BY THE SEA SIGNAGE




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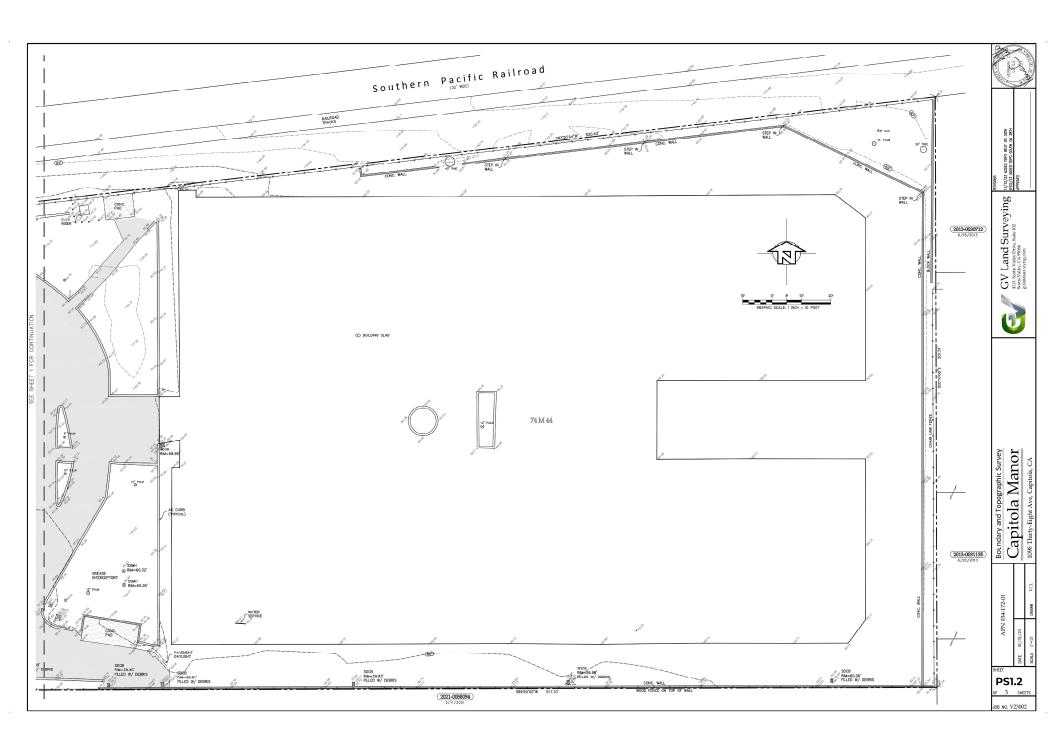
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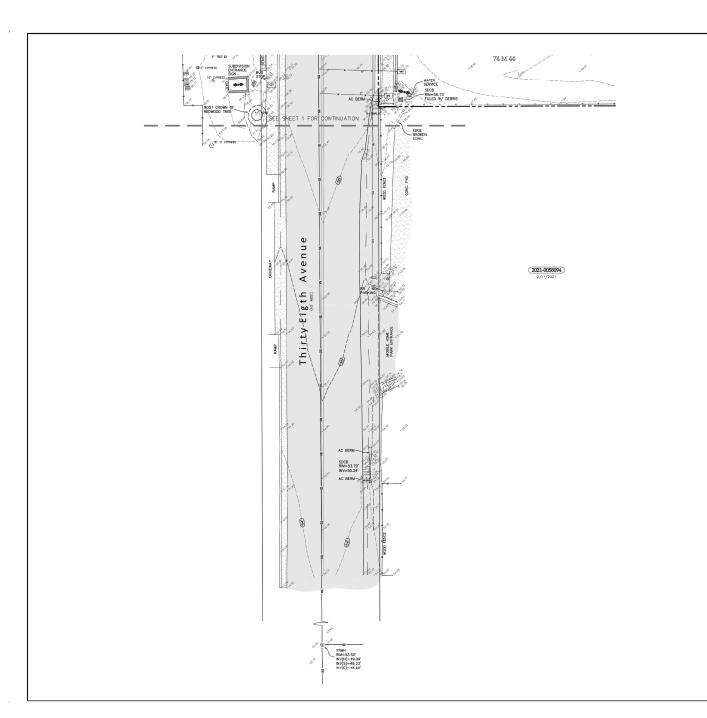
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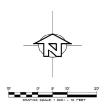
EXISTING SITE CONTEXT

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Legend

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ASPHALT CONCRETE, AC (SHADED)

CONCRETE GRADE BREAK
ON OVERREAD UTILITY LINE
OF GRASHEAD UTILITY LINE
OF GRASHEAD UTILITY LINE
OF LICETRICAL LINE USA LOCATED
FENCE
PROPERTY BOUNDARY
CONTINUE LINE
FLORBIE
MATOL LINE
ALL DISTANCES SHOWN ARE IN FEET AND DEDMAS THEREOF.

GV Land Surveying
4113 Scote Valley Drive, Suite 102
Scotes Valley, CA 95066
g/landsurveying.com

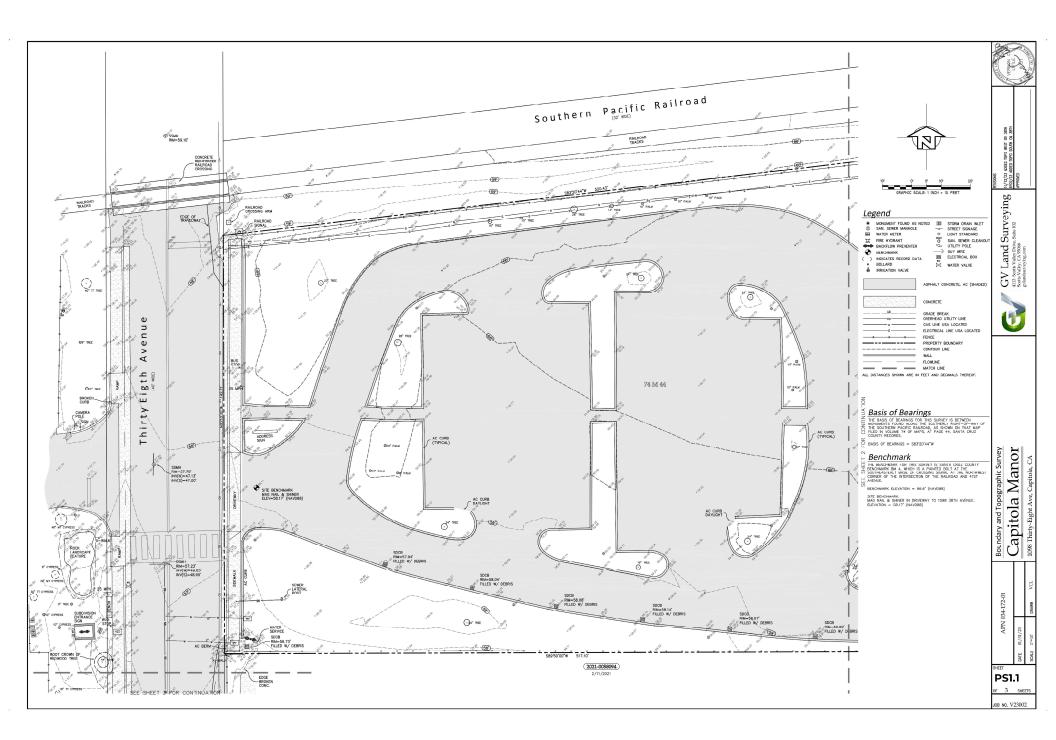

Boundary and Topographic Survey


Capitola Manor


1098 Thirty-Eight Ave, Capitola, CA


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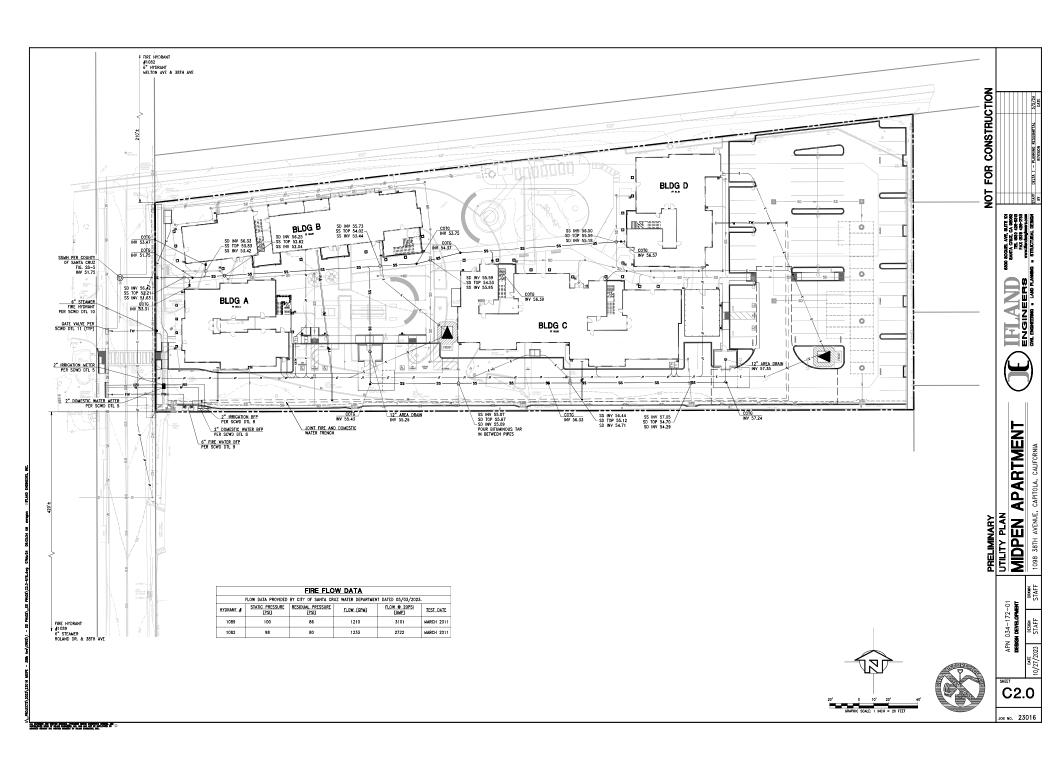
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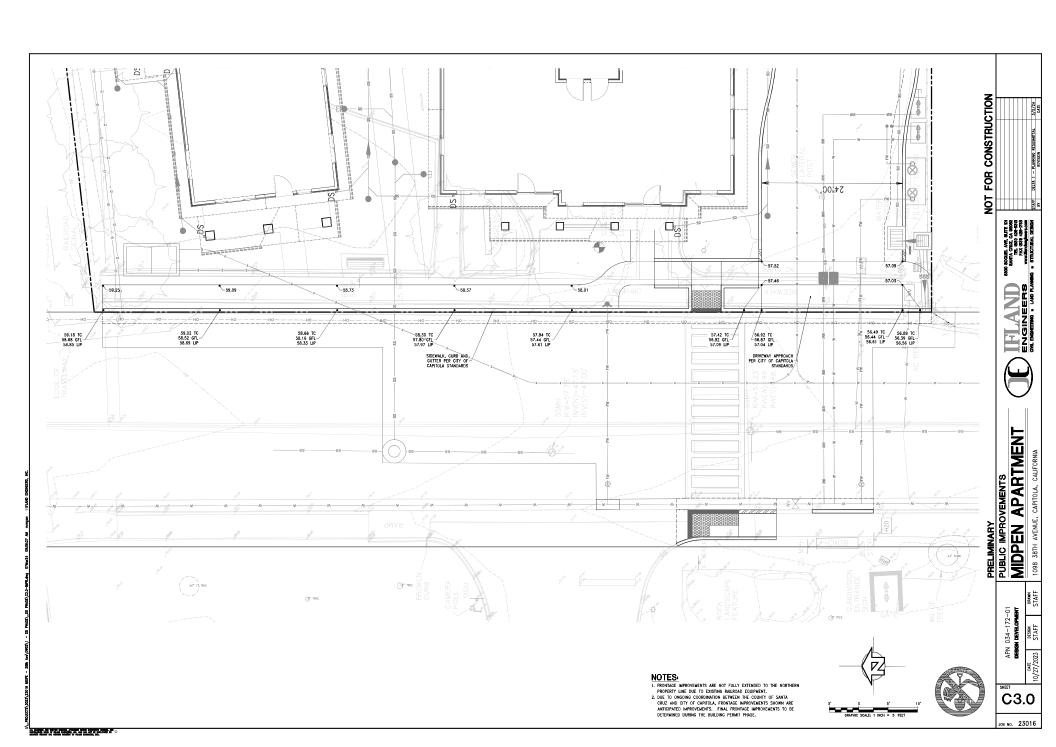
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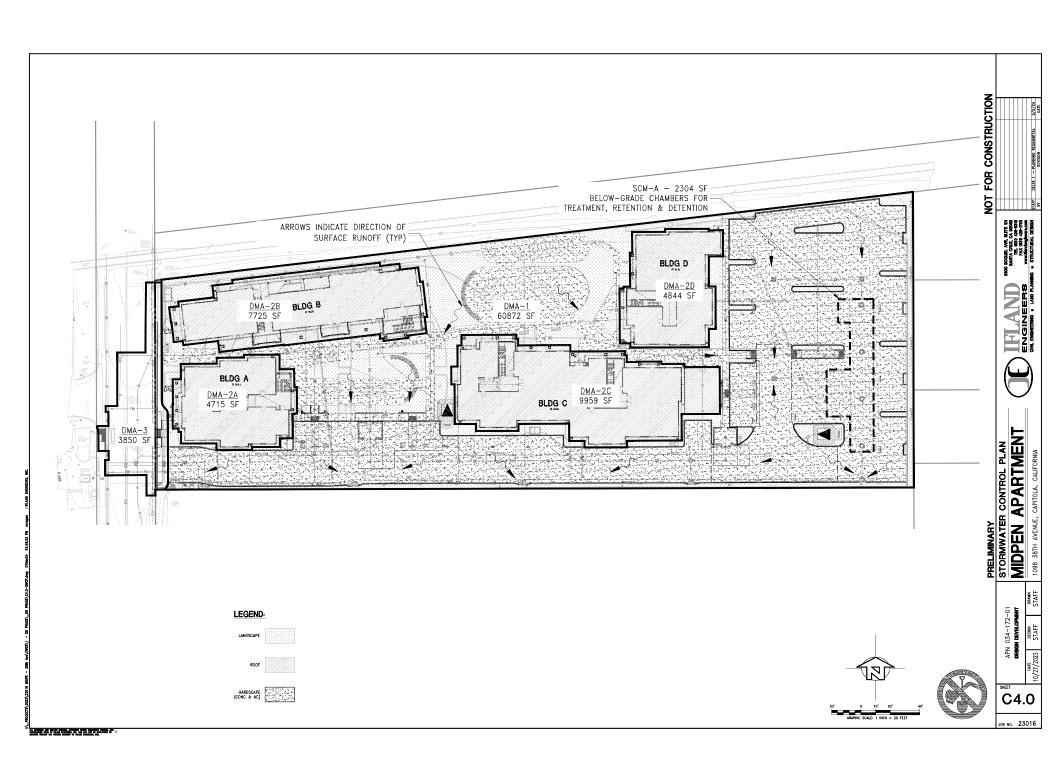







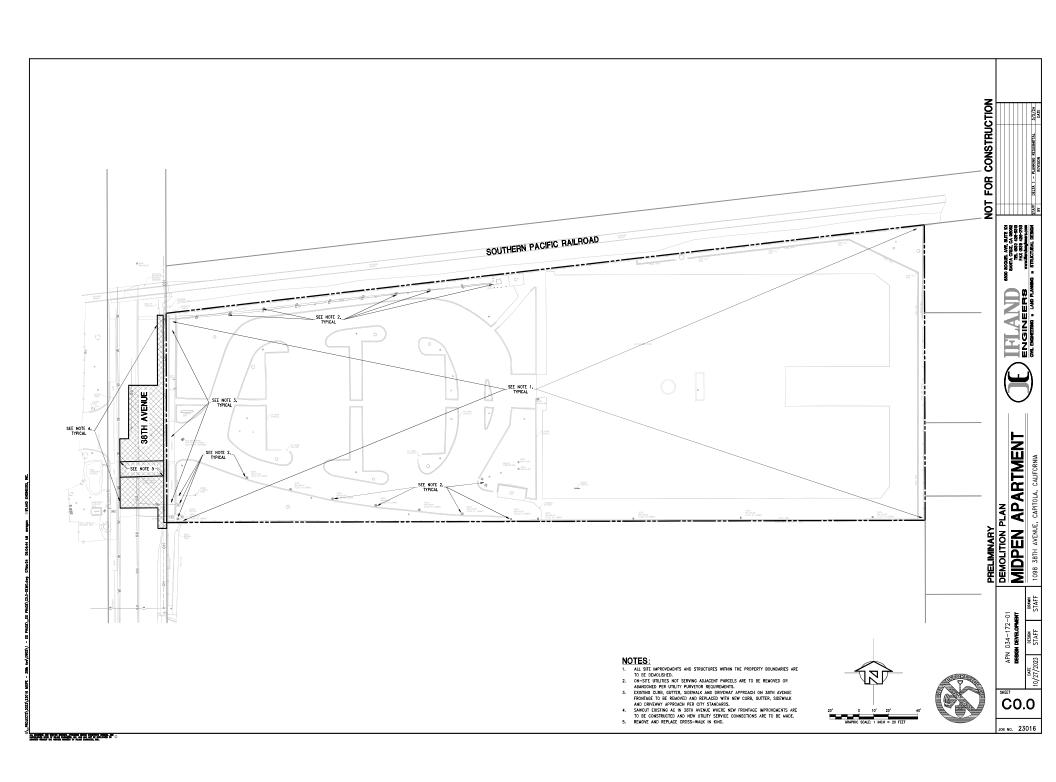

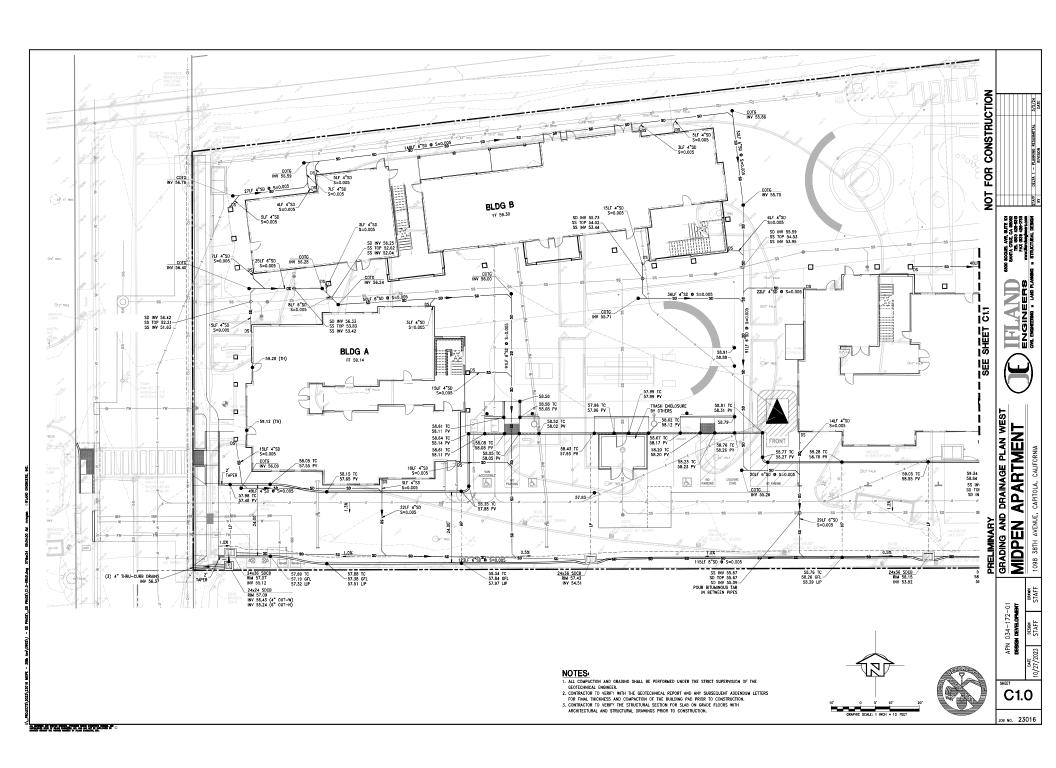

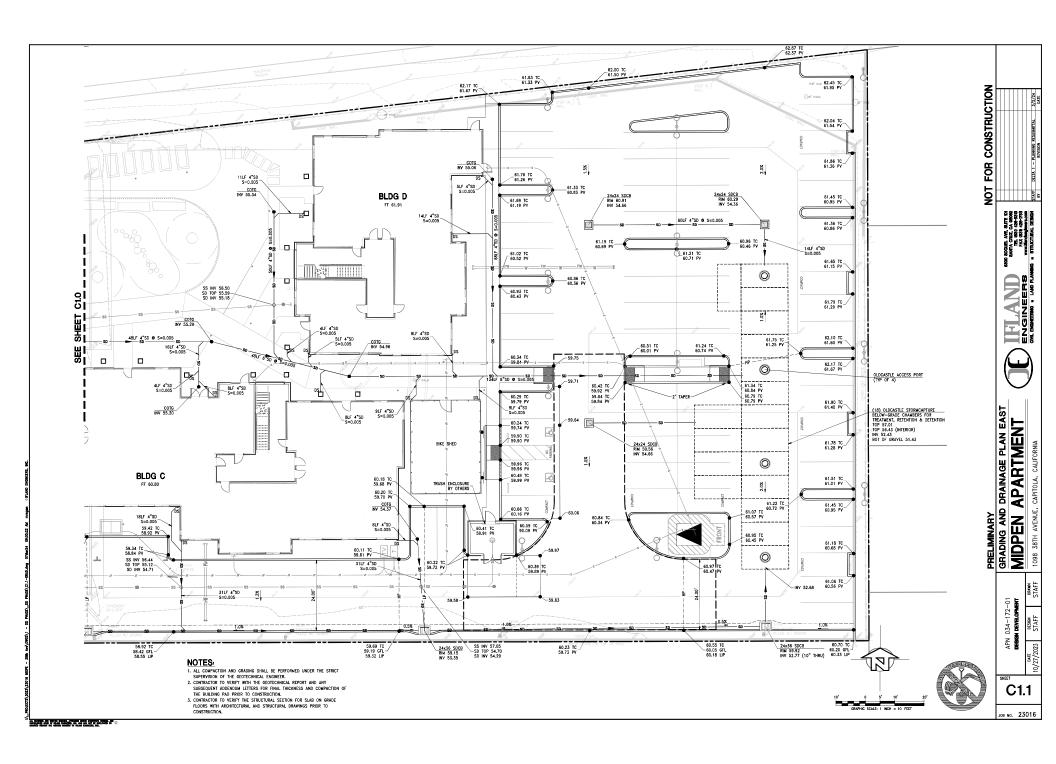

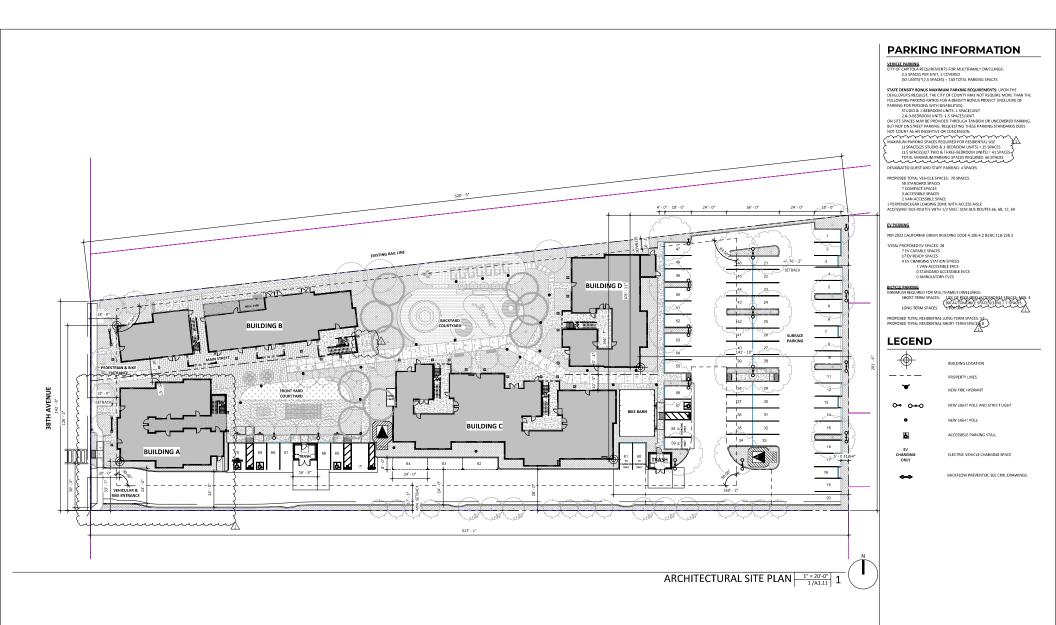



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38TH AVE APARTMENTS

MIDPEN HOUSING 1098 38TH AVE, CAPITOLA, CA 95062 PLANNING RESUBMITTAL

MARCH 5, 2024

ARCHITECTURAL SITE PLAN

No.	DATE	
1	03/05/2024	PLANNING RESUBMITTAL
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ISSUED: 3/5/2024


DRAWN: JG, KS, YJ

CHECKED: SV

JOB: 23003

SCALE: As indicated

PLANNING RESUBMITTAL

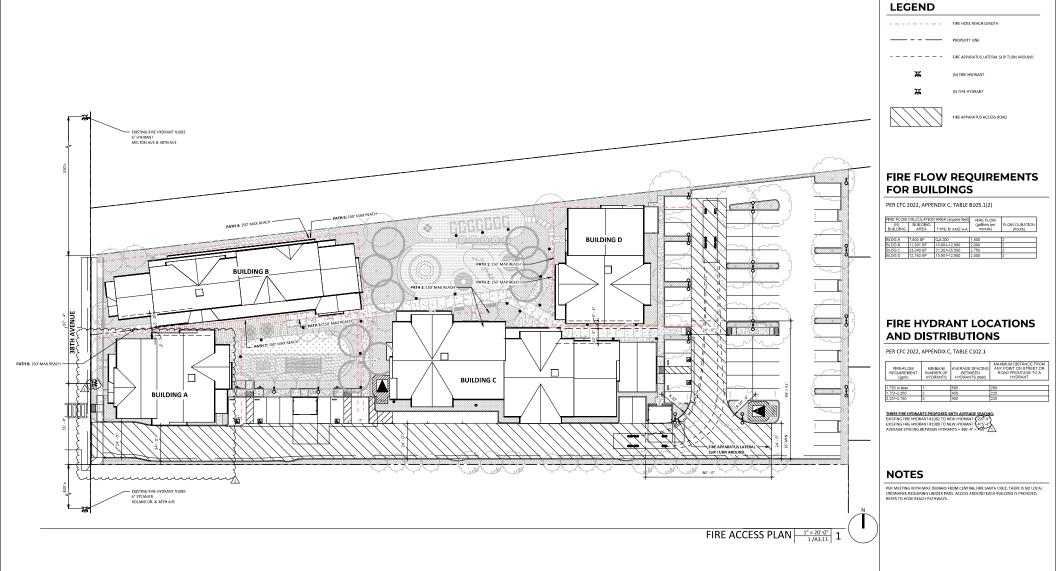



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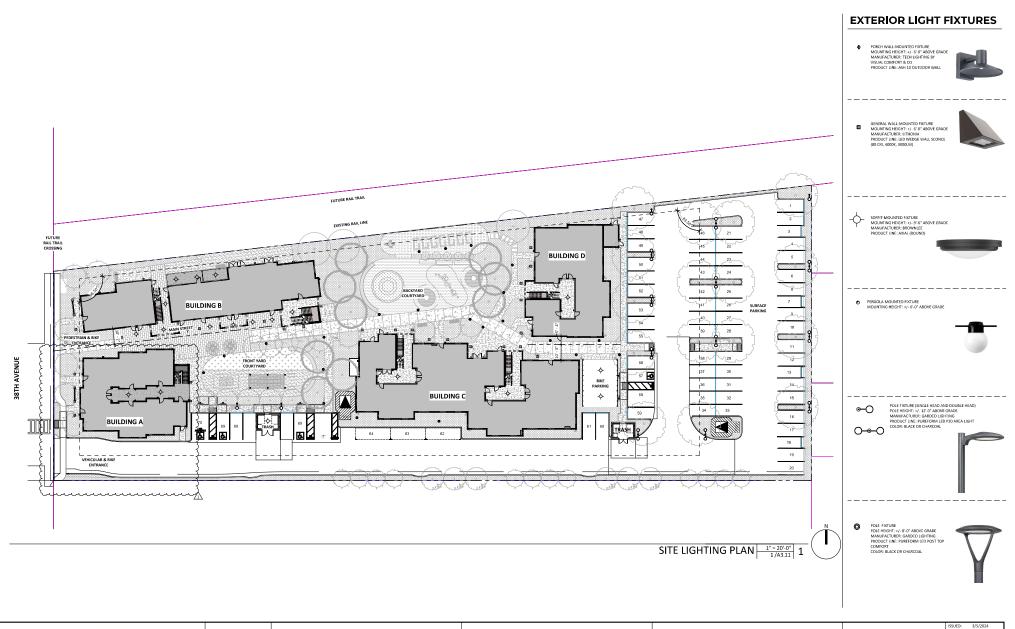
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MIDPEN HOUSING 1098 38TH AVE, CAPITOLA, CA 95062 PLANNING RESUBMITTAL

MARCH 5, 2024

FIRE ACCESS PLAN

No.	DATE	ISSUE	ISSUED:	3/5/2
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	03/05/2024	PLANNING RESORATIVAL	CHECKED:	SV
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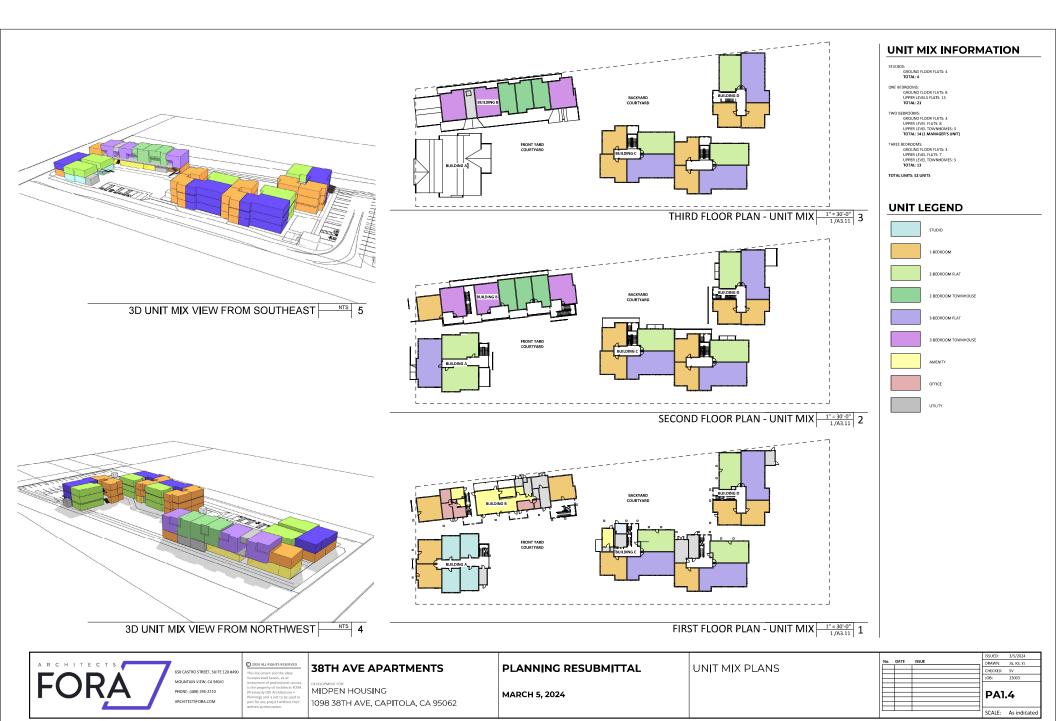
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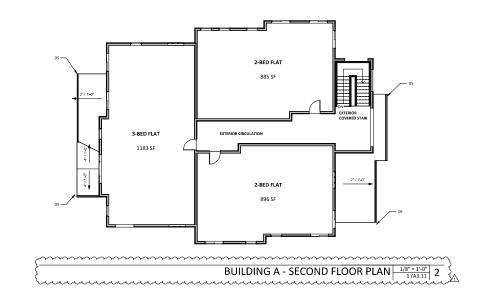
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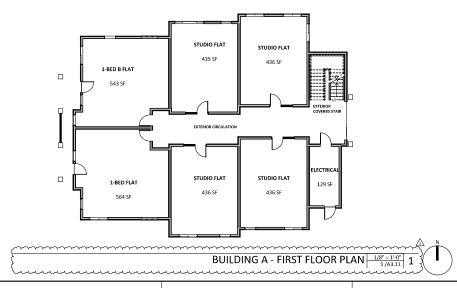
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SITE LIGHTING PLAN

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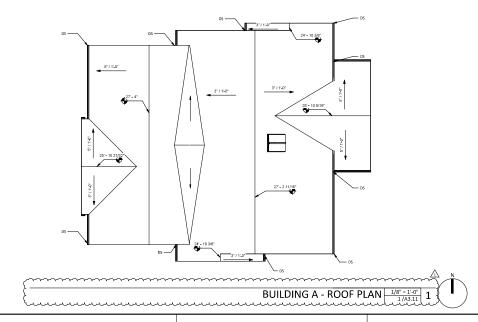
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MARCH 5, 2024

BUILDING A - FLOOR PLANS

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BUILDING A - FLOOR AND ROOF PLAN

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					SCALE:	1/8" =





BUILDING A - WEST ELEVATION 1/8"-11-0" 4



BUILDING A - EAST ELEVATION 1/8" = 1'-0" 2



BUILDING A - SOUTH ELEVATION 1/8" = 1'-0" 1



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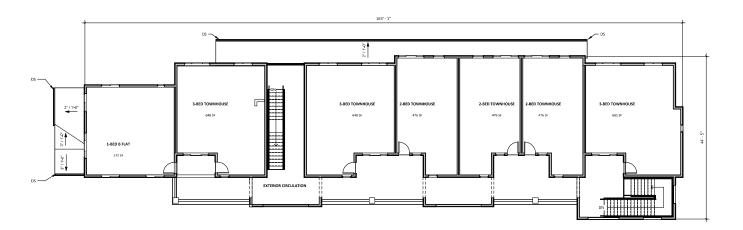
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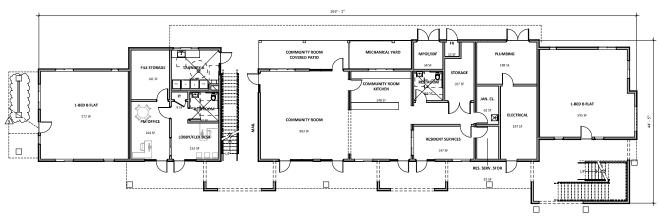
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BUILDING A - EXTERIOR ELEVATIONS

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-		1	SCALE:	1/8



BUILDING B - SECOND FLOOR 1/A4.11 2



BUILDING B - FIRST FLOOR PLAN 1/8" = 1'-0" 1 /A4.11 1



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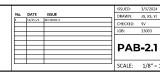
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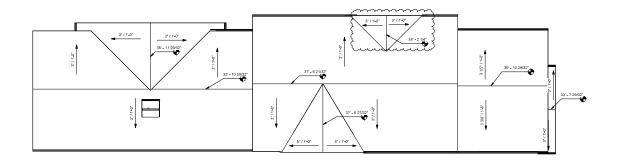
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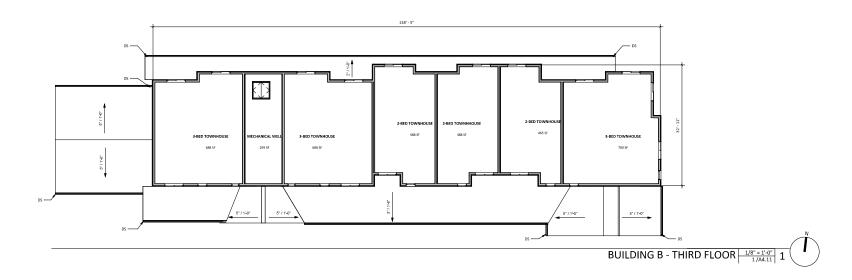
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BUILDING B - FLOOR PLANS





BUILDING B - ROOF PLAN 1/8" = 1'-0" 2






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BUILDING B - FLOOR AND ROOF PLAN





BUILDING B - NORTH ELEVATION 1/8" = 1'-0" 3



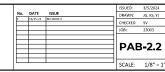



BUILDING B - SOUTH ELEVATION 1/8" = 1'-0" 1



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BUILDING B - EXTERIOR ELEVATIONS








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BUILDING C - FLOOR PLANS







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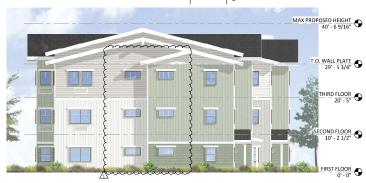
BUILDING C - FLOOR AND ROOF PLANS

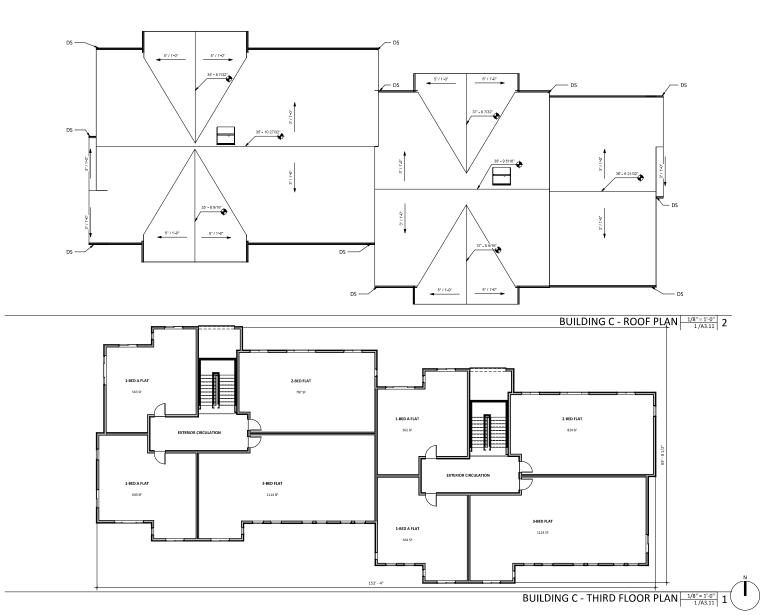





BUILDING C - WEST ELEVATION 1/8"=1"-0" 4



BUILDING C - EAST ELEVATION 1/8" = 1'-0" 2



BUILDING C - SOUTH ELEVATION 1/8" = 1-0" 1



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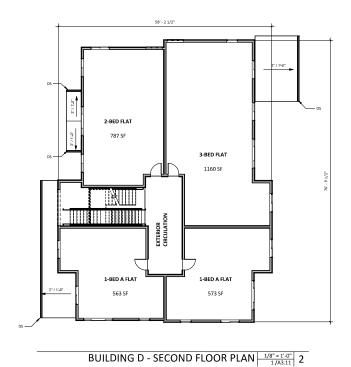
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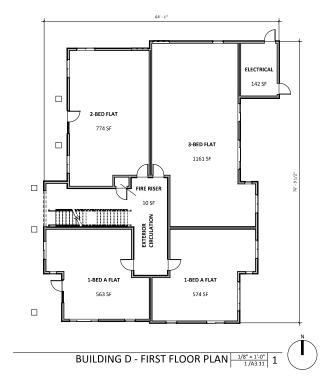
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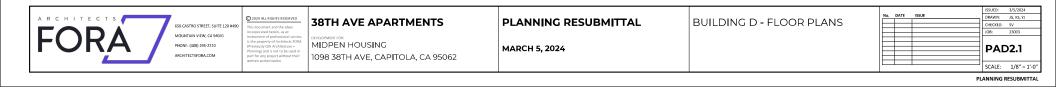
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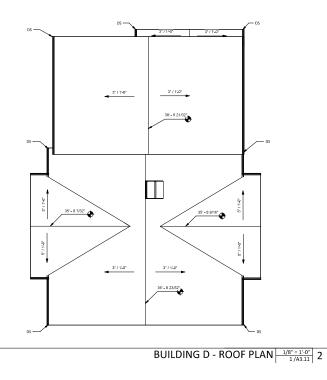
BUILDING C - EXTERIOR ELEVATIONS












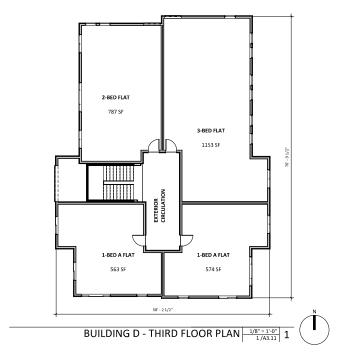




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MARCH 5, 2024

BUILDING D - FLOOR AND ROOF PLANS







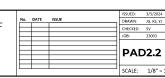

BUILDING D - WEST ELEVATION 1/8" = 1'-0" 4



BUILDING D - EAST ELEVATION 1/8" = 1'-0" 2



BUILDING D - SOUTH ELEVATION 1/8" = 1'-0" 1




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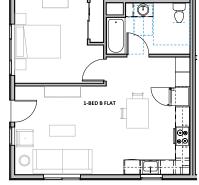
MARCH 5, 2024

BUILDING D - EXTERIOR ELEVATIONS

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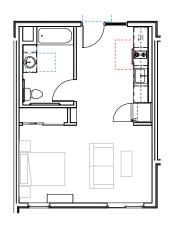




1-BEDROOM C FLOOR PLAN 1/4" = 1'.0" 3

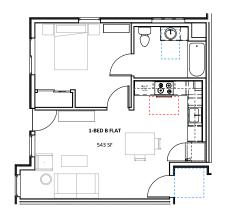

1-BEDROOM A FLOOR PLAN 1/4" = 1'-0" | 2



STUDIO FLOOR PLAN 1/4" = 1'-0" 1/A3.11 1



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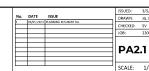
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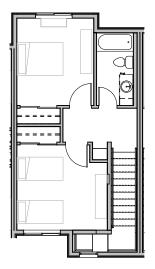
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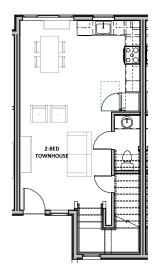
MARCH 5, 2024

STUDIO AND 1-BEDROOM UNIT






2-BEDROOM TOWNHOUSE - UPPER FLOOR PLAN 1/4" = 1'.0" 4



2-BEDROOM TOWNHOUSE - LOWER FLOOR PLAN 1/4" = 1'-0" 3

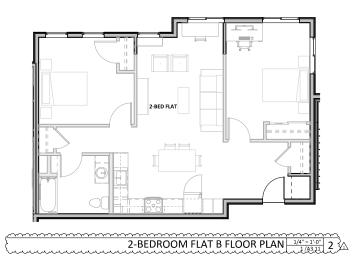



2-BEDROOM FLAT A FLOOR PLAN 1/4" = 1'-0" 1/A3.11 1



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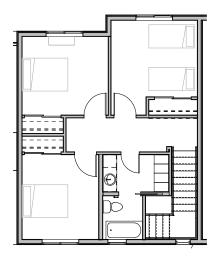
38TH AVE APARTMENTS

MIDPEN HOUSING 1098 38TH AVE, CAPITOLA, CA 95062 PLANNING RESUBMITTAL

MARCH 5, 2024


2-BEDROOM UNIT PLANS





3-BEDROOM TOWNHOUSE - UPPER FLOOR PLAN 1/4"=1".0" 4



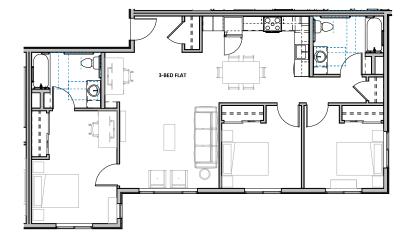

3-BEDROOM TOWNHOUSE - LOWER FLOOR PLAN 1/4"=1"-0" 3

3-BEDROOM FLAT B FLOOR PLAN 1/4"=1"0" | 2

3-BEDROOM FLAT A FLOOR PLAN 1/4" = 1'-0" 1/A3.11 1



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MARCH 5, 2024

3-BEDROOM UNIT PLANS



COLOR INSPIRATION



ARCHITECTURAL DESIGN NARRATIVE:

FOR THE CHARACTER OF 1098 38TH AVENUE, WE ENVISION A PLACE THAT FEELS ACCESSIBLE, WELCOMING, AND SAFE. IT'S FRESH AND BREEZY LIKE THE TOWN AND COASTLINE OF CAPITOLA, YET WARM LIKE HOME, TAKING CUES FROM HISTORIC CRAFTSMAN BEACH HOUSES FROM THE SURROUNDING NEIGHBORHOODS. THE RESULTING STYLE, AFFECTIONATELY TERMED CONTEMPORARY CALIFORNIA CRAFTSMAN, BLENDS TRADITIONAL AND MODERN AESTHETICS, CREATING A DESIGN LANGUAGE THAT FEELS FAMILIAR AND RELATABLE ACROSS A SPECTRUM OF GENERATIONS, WHILE AN ATTENTION TO SIMPLICITY OF FORMS AND DURABILITY OF MATERIALS YIELDS A SENSE OF TIMELESSNESS.





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38TH AVE APARTMENTS

MIDPEN HOUSING 1098 38TH AVE, CAPITOLA, CA 95062 PLANNING RESUBMITTAL

MARCH 5, 2024

DESIGN NARRATIVE

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VIEW FROM 38TH AVE





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38TH AVE APARTMENTS

MIDPEN HOUSING
1098 38TH AVE, CAPITOLA, CA 95062

PLANNING RESUBMITTAL

MARCH 5, 2024

EXTERIOR CONCEPTUAL RENDERINGS

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No.	DATE	ISSUE	DRAWN: CHECKED:	3/5/202 JG, KS, Y SV



VIEW FROM COURTYARD TO BUILDINGS C & D NTS 1



38TH AVE APARTMENTS

MIDPEN HOUSING 1098 38TH AVE, CAPITOLA, CA 95062 PLANNING RESUBMITTAL

MARCH 5, 2024

EXTERIOR CONCEPTUAL RENDERINGS

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VIEW FROM COURTYARD TO BUILDINGS A & B NTS 1



38TH AVE APARTMENTS

MIDPEN HOUSING 1098 38TH AVE, CAPITOLA, CA 95062 PLANNING RESUBMITTAL

MARCH 5, 2024

EXTERIOR CONCEPTUAL RENDERINGS

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ENTRY PORCH DETAIL

NTS 3

ROOF AND WINDOW DETAIL

NTS 2











CONTEMPORARY CALIFORNIA CRAFTSMAN REFERENCES

NTS 1



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38TH AVE APARTMENTS

DEVELOPMENT FOR: MIDPEN HOUSING 1098 38TH AVE, CAPITOLA, CA 95062 PLANNING RESUBMITTAL

MARCH 5, 2024

ARCHITECTURAL CHARACTER -CONTEMPORARY CALIFORNIA CRAFTSMAN

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COLOR AND MATERIALS PALETTE




1. ASPHALT SHINGLE GAF TIMBERLINE HDZ PEWTER GRAY



2. BOARD & BATTEN FIBER CEMENT SIDING PAINT: SHERWIN-WILLIAMS SW 7015 OR SW 7005 REPOSE GRAY PURE WHITE

PER ELEVATIONS

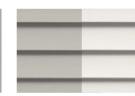

3. LAP SIDING FIBER CEMENT SIDING PAINT: SHERWIN-WILLIAMS OR SW 7005 SW 7015 PURE WHITE REPOSE GRAY PER ELEVATIONS



4. SHINGLE SIDING FIBER CEMENT SIDING PAINT: SHERWIN-WILLIAMS SW 7005 PURE WHITE



6. UNIT ENTRY DOORS PAINT: SHERWIN-WILLIAMS PAINT: SHERWIN-WILLIAMS SW 6376 GOLD COAST



7. VINYL WINDOW FRAMES COLOR: CHARCOAL GRAY FROM MANUFACTURER'S STANDARD COLORS



8. BUILDING LIGHT FIXTURE 1 TECH LIGHTING ASH 10 WALL SCONCE CHARCOAL

AT BUILDING A



AT. ACCENT COLOR PAINT: SHERWIN-WILLIAMS SW 6512 BALMY



A2. ACCENT COLOR PAINT: SHERWIN-WILLIAMS SW 9058 SECRET COVE

AT BUILDING B



B1. ACCENT COLOR PAINT: SHERWIN-WILLIAMS SW 6457 KIND GREEN



B2. ACCENT COLOR PAINT: SHERWIN-WILLIAMS SW 2811 ROCKWOOD BLUE GREEN

AT BUILDING C



C1. ACCENT COLOR PAINT: SHERWIN-WILLIAMS SW 6723 JARDIN

5. FASCIA/TRIM

FIBER CEMENT

SW 7005

PURE WHITE



C2. ACCENT COLOR PAINT: SHERWIN-WILLIAMS SW 6439

AT BUILDING D



DI. ACCENT COLOR PAINT: SHERWIN-WILLIAMS SW 7601 DOCKSIDE BLUE



D2. ACCENT COLOR PAINT: SHERWIN-WILLIAMS SW 7604 SMOKY BLUE



9. BUILDING LIGHT FIXTURE 2 LITHONIA LED WEDGE WALL SCONCE BLACK OR CHARCOAL

650 CASTRO STREET, SUITE 120 #490 MOUNTAIN VIEW, CA 94041 ARCHITECTSFORA.COM

38TH AVE APARTMENTS

MIDPEN HOUSING 1098 38TH AVE, CAPITOLA, CA 95062


PLANNING RESUBMITTAL

MARCH 5, 2024

MATERIALS BOARD

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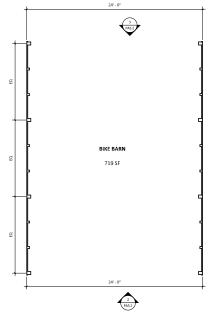




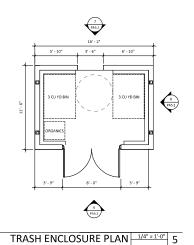











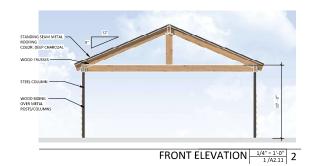

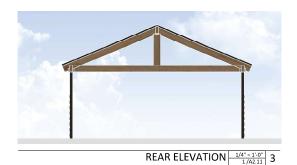





38TH AVE APARTMENTS


MIDPEN HOUSING 1098 38TH AVE, CAPITOLA, CA 95062 PLANNING RESUBMITTAL


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SITE ELEMENTS - TRASH ENCLOSURE & BIKE BARN



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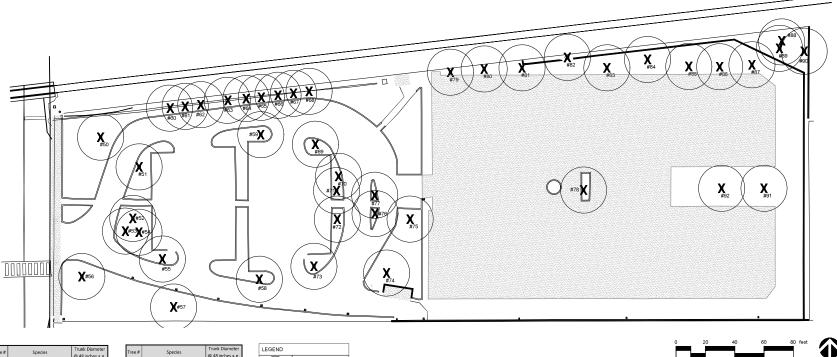
MIDPEN HOUSING 1098 38TH AVE, CAPITOLA, CA 95062 PLANNING RESUBMITTAL

MARCH 5, 2024

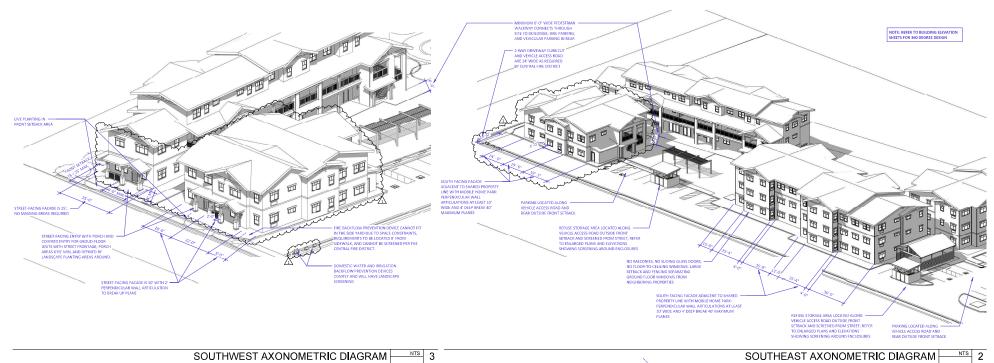OBJECTIVE DESIGN STANDARDS
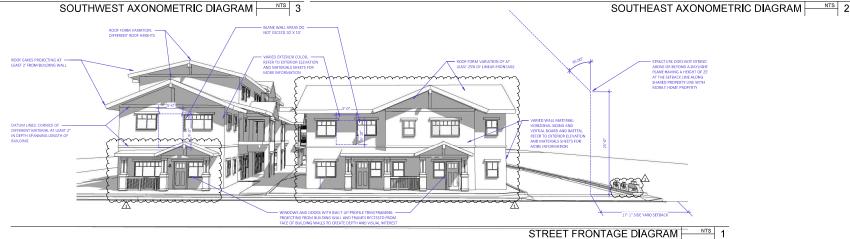
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PLANNING RESUBMITTAL



Tree#	Species	Trunk Diameter @ 48 inches a.g.
T50	flaxleaf paperbark (Melaleuca linariifolia)	24"
T51	flaxleaf paperbark	20"
T52	queen palm (Syagrus romanzoffiane)	12"
T53	queen palm	9"
T54	queen palm	6"
T55	flaxleaf paperbark	22"
T56	queen palm	5"
T57	flaxleaf paperbark	30"
T58	flaxleaf paperbark	18"
T59	flaxleaf paperbark	16", 13"
T60	Monterey cypress (Hesperocyparis macrocaipa)	18"
T61	Monterey cypress	13"
T62	Monterey cypress	7",6",5"
T63	Monterey cypress	14"
T64	queen palm	10"
T65	queen palm	9"
T66	queen palm	9"
T67	queen palm	4"
T68	queen palm	4"
T69	flaxleaf paperbark	19"
T70	queen palm	12"
T71	queen palm	12"

Tree #	Species	Trunk Diameter @ 48 inches a.g.
T72	flaxleaf paperbark	18"
T73	flaxleaf paperbark	22"
T74	queen palm	13"
T75	queen palm	9"
T76	queen palm	8"
T77	queen palm	6"
T78	queen palm	14"
T79	queen palm	4"
T80	queen palm	4"
T81	queen palm	5*
T82	Monterey pine	44"
_	(Pinus radiata)	
T83	queen palm	4"
T84	queen palm	4"
T85	queen palm	6"
T86	queen palm	4"
T87	queen palm	6"
T88	fan palm (Washinatonia spp.)	15"
Т89	coast live oak (Quercus agrifolia)	9"
Т90	podocarpus (Podocarpus macrophyllus	15" (at base) multi-trunk
T91	queen palm	4"
T92	queen palm	4"







San Francisco, CA 94114

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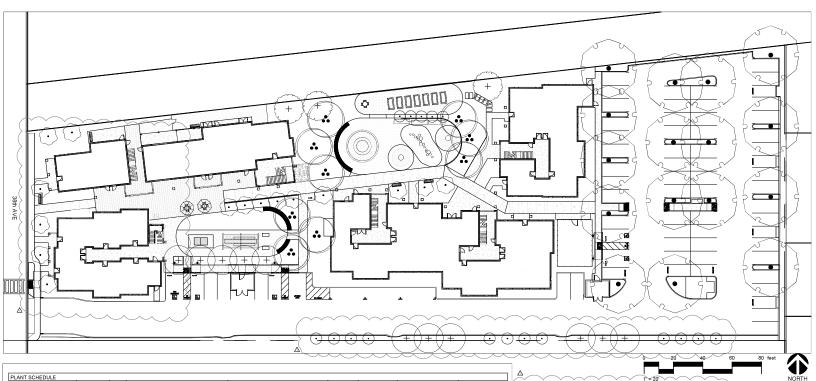
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DEVELOPMENT FOR:
MIDPEN HOUSING 1098 38TH AVE, CAPITOLA, CA 95062 PLANNING SUBMITTAL

OCTOBER 23, 2023

TREE PROTECTION AND REMOVAL PLAN

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PLANT SCHEDULE								
SYMBOL	CODE	QTY	BOTANICAL NAME	COMMON NAME	SIZE	WUCOLS	MATURE SIZE	MATURE CANOPY
REES								
+	HYM FLA	11	HYMENOSPORUM FLAVUM	SWEETSHADE	24" BOX	MODERATE	35'H X 20'W	300SF
\odot	MAG VIR	15	MAGNOLIA VIRGINIANA 'JIM WILSON'	MOONGLOW® SWEETBAY MAGNOLIA	24" BOX	MODERATE	35°H X 20°W	300SF
\odot	POD ELO	17	PODOCARPUS ELONGATUS 'MONMAL'	ICEE BLUE® YELLOW WOOD	15 GAL	MODERATE	15`-25` H X 10`-15` W	110SF
+	SAP SAP	3	SAPINDUS SAPONARIA	WINGLEAF SOAPBERRY	15 GAL	LOW	25'-40' H X 15'-30' W	700SF
	ULM DRA	16	ULMUS PARVIFOLIA 'DRAKE'	DRAKE LAGEBARK ELM	24" BOX	LOW	50'H X 40'W	1250SF
	CHI TAS	9	X CHITALPA TASHKENTENSIS	CHITALPA	24"BOX	LOW	20'-30' H X 20'-30' W	700SF

	V V V V V V T"#20 V V	
	TREE REPLACEMENT CALCULATION	S
	Number of trees removed - See L1.1	43
\Box	Number of replacement trees	71
	Total Site Area (sq. ft.)	88,997
Ca	nopy coverage of replacement trees (sq. ft.)	38,070
Ca	nopy coverage as percent of total site area	43%













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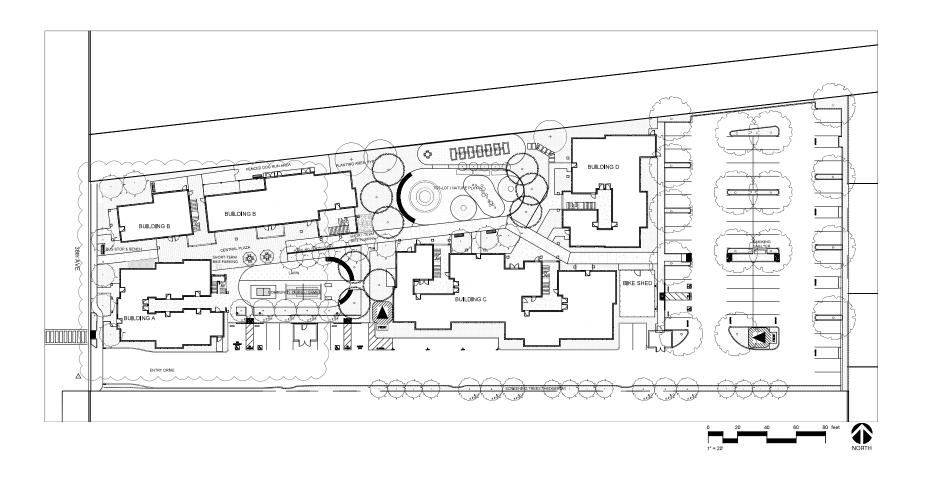
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MIDPEN HOUSING 1098 38TH AVE, CAPITOLA, CA 95062 PLANNING SUBMITTAL

OCTOBER 23, 2023

TREE MITIGATION AND PLANTING PLAN

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OCTOBER 23, 2023

LANDSCAPE PLAN

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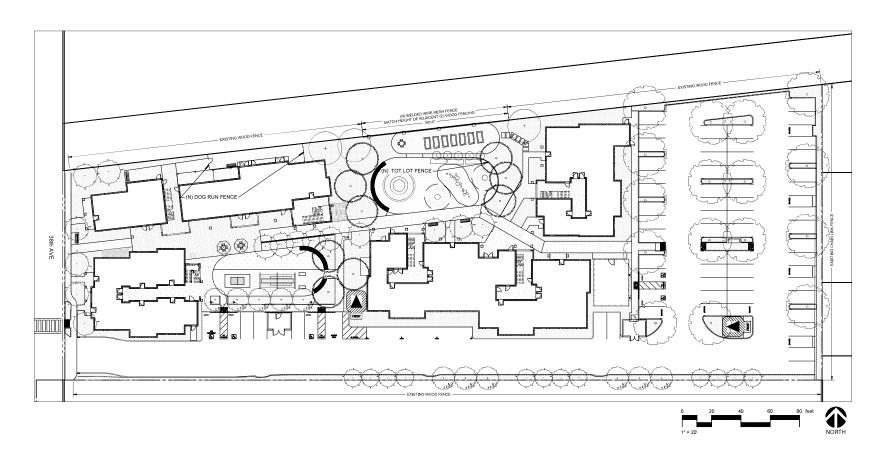
DEVILIPMENT FOR:
MIDPEN HOUSING

MIDPEN HOUSING 1098 38TH AVE, CAPITOLA, CA 95062 PLANNING SUBMITTAL

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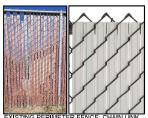
SITEPLAN RENDERING

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WOOD MEMBERS: STAIN PLATINUM GRAY



NEW DOG RUN FENCE: 4' TALL WELDED WIRE MESH PANEL WOOD MEMBERS: STAIN PLATINUM GRAY



NEW TOT LOT FENCE: VARIABLE HEIGHT TIMBER BARRIER



San Francisco, CA 94114

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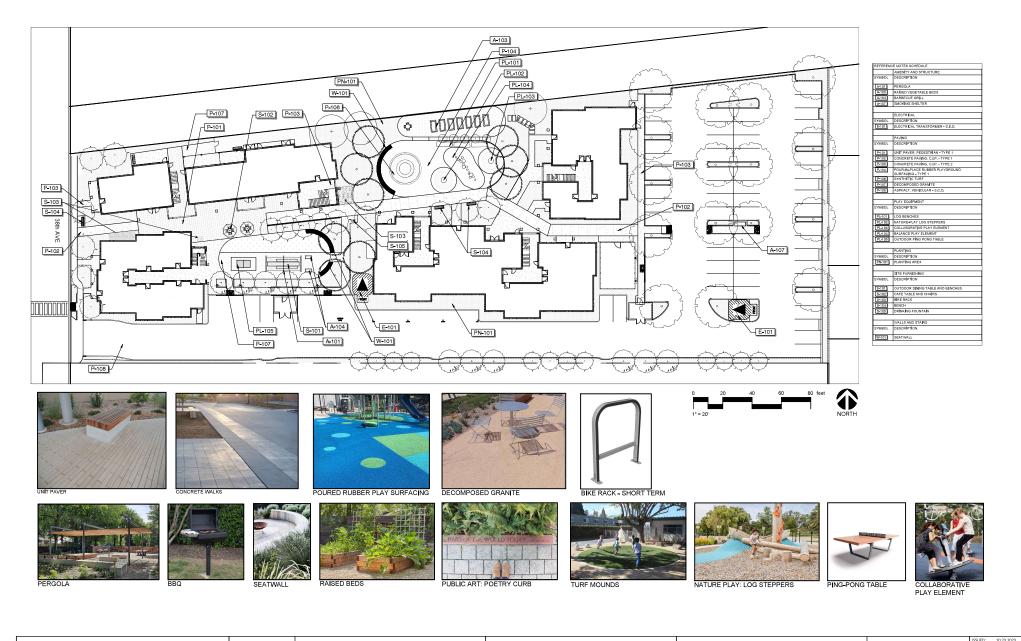
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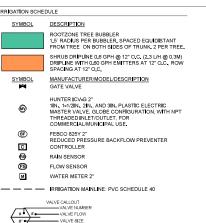
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OCTOBER 23, 2023

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MIDPEN HOUSING 1098 38TH AVE, CAPITOLA, CA 95062 PLANNING SUBMITTAL

OCTOBER 23, 2023

IRRIGATION PLAN AND SCHEDULE

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IRRIGATION NOTES

- THESE IRRIGATION DRAWINGS ARE DIAGRAMMATIC AND INDICATIVE OF THE WORK TO BE INSTALLED, ALL PIPING INDICATIVE OF THE WORK TO BE INSTRUCED, ALL PHINIS, VALVES, AND OTHER IRRIGATION COMPONENTS MAY BE SHOWN WITHIN PAVED AREAS FOR GRAPHIC CLARITY ONLY AND ARE TO BE INSTALLED WITHIN PANTING AREAS, DUE TO THE SCALE OF THE DRAWINGS, IT IS NOT POSSIBLE TO INDICATE ALL OFFSETS, FITTINGS, SLEEVES, CONDUIT, AND OTHER ITEMS WHICH MAY BE REQUIRED. INVESTIGATE OTHER TIEMS WHICH MAY BE REQUIRED. INVESTIGATE STRUCTURAL AND FINISHED CONDITION AFFECTING THE CONTRACT WORK INCLUDING OBSTRUCTIONS, GRADE DIFFERENCES OR AREA DIMENSIONAL DIFFERENCES, IN THE EVENT OF FIELD DISCREPANCY WITH CONTRACT DOCUMENTS, PLAN THE INSTALLATION WORK ACCORDINGLY BY NOTIFICATION AND APPROVAL OF THE OWNER'S AUTHORIZED REPRESENTATIVE AND ACCORDING TO THE CONTRACT SPECIFICATIONS, NOTIFY AND COORDINATE IRRIGATION CONTRACT WORK WITH OWNER FOR THE LOCATION AND INSTALLATION OF PIPE. CONDUIT OR SLEEVES THROUGH OR UNDER WALLS, ROADWAYS, PAVING AND STRUCTURES BEFORE CONSTRUCTION. IN THE EVENT THESE NOTHIFICATIONS ARE NOT PERFORMED, THE CONTRACTOR ASSUMES FULL RESPONSIBILITY FOR REQUIRED REVISIONS.
- THE CONTRACTOR SHALL COMPLY WITH ALL APPLICABLE CODES, STANDARDS, AND REGULATIONS OF THE NATIONAL ELECTRIC CODE: THE UNIFORM PLUMBING CODE, PUBLISHED BY THE WESTERN PLUMBING OFFICIALS ASSOCIATION, AND OTHER STATE OR LOCAL LAWS OR REGULATIONS, NOTHING OTHER STATE OF LOCAL DAWS OR RESULATIONS. NOTHING IN THESE DRAWINGS IS TO BE CONSTRUED TO PERMIT WORK NOT CONFORMING TO THESE CODES OR REGULATIONS. THE CONTRACTOR SHALL FURNISH WITHOUT ANY EXTRA CHARGE, ANY ADDITIONAL MATERIAL AND LABOR WHEN REQUIRED BY THE COMPLIANCE WITH THESE CODES AND REGULATIONS.
- THE CONTRACTOR SHALL COORDINATE INSTALLATION OF IRRIGATION SYSTEM WITH LAYOUT AND INSTALLATION OF THE PLANT MATERIALS TO INSURE THAT THERE WILL BE COMPLETE AND UNIFORM IRRIGATION COVERAGE OF COMPLETE AND UNIFORM INFRAM TOWN COVERAGE OF PLANTING IN ACCORDANCE WITH THESE DRAWNINGS, AND CONTRACT DOCUMENTS. THE IRRIGATION LAYOUT SHALL BE CHECKED BY THE CONTRACTOR AND OWNERS AUTHORIZED REPRESENTATIVE PRIOR TO CONSTRUCTION TO DETERMINE IF ANY CHANGES, DELETIONS, OR ADDITIONS ARE REQUIRED. IRRIGATION SYSTEM SHALL BE INSTALLED AND TESTED PRIOR TO INSTALLATION OF PLANT MATERIAL
- THE INTENT OF THIS IRRIGATION SYSTEM IS TO PROVIDE THE MINIMUM AMOUNT OF WATER REQUIRED TO SUSTAIN GOOD PLANT HEALTH.
- IT IS THE RESPONSIBILITY OF THE IRRIGATION CONTRACTOR THE RESPONSIBILITY OF THE RIKNSAL TO CONTRACTED TO PROORAM THE IRRIGATION CONTROLLER(S) TO PROVIDE THE MINIMUM AMOUNT OF WATER NEEDED TO SUSTAIN GOOD PLANT HEALTH. THIS INCLUDES MAKING ADJUSTMENTS TO THE PROGRAM FOR SEASONAL WEATHER CHANGES, PLANT MATERIAL, WATER REQUIREMENTS, SUN. SHADE AND WIND EXPOSURE.
- USE EXISTING 120 VOLT A.C. (0.5 AMP DEMAND PER CONTROLLER) ELECTRICAL SERVICE CONTROLLER LOCATION(S). IT IS THE RESPONSIBILITY OF THE IRRIGATION CONTRACTOR TO COORDINATE THE ELECTRICAL SERVICE STUB-OUT TO THE CONTROLLER(S). PROVIDE PROPER GROUNDING PER CONTROLLER MANUFACTURER'S INSTRUCTIONS AND IN ACCORDANCE WITH LOCAL CODES.
- PROVIDE EACH CONTROLLER WITH ITS OWN GROUND ROD. SEPARATE THE GROUND RODS BY A MINIMUM OF FIGHT SEPARA IE THE GROUND RODS BY A MINIMUM OF EIGHT FEET. THE GROUND ROD SHALL BE AN EIGHT FOOT LONG BY 5/8" DIAMETER U.L. APPROVED COPPER CLAD ROD, INSTALL NO MORE THAN 8" OF THE GROUND ROD ABOVE FINISH GRADE, CONNECT #6 GAUGE WIRE WITH A U.L. APPROVED GROUND ROD CLAMP TO ROD AND BACK TO GROUND SCREW AT BASE OF CONTROLLER WITH APPROPRIATE CONNECTOR.
 MAKE THIS WIRE AS SHORT AS POSSIBLE, AVOIDING KINDS
- SCHEDULE A MEETING WHICH INCLUDES REPRESENTATIVES OF THE IRRIGATION CONTROLLER MANUFACTURER, THE MAINTENANCE CONTRACTOR, THE OWNER AND THE RRIGATION CONTRACTOR, THE OWNER AND THE RRIGATION CONTRACTOR AT THE SITE FOR INSTRUCTION ON THE PROPER PROGRAMMING AND OPERATION OF THE IRRIGATION CONTROLLER.
- INSTALL 3" DETECTABLE TAPE ABOVE ALL PRESSURIZED MAIN LINES AS DETAILED, USE CHRISTY MODEL #TA-DT-3-BIRR FOR POTABLE IRRIGATION SYSTEMS OR #TA-DT-3-PRW FOR RECYCLED IRRIGATION WATER SYSTEMS.
- 10. PROVIDE EACH IRRIGATION CONTROLLER WITH ITS OWN INDEPENDENT LOW VOLTAGE COMMON GROUND WIRE.

- 11. INSTALL BLACK PLASTIC LOCKABLE VALVE BOXES WITH BOLT DOWN, NON HINGED COVER MARKED 'IRRIGATION'. BOX BODY SHALL HAVE KNOCK OUTS. ACCEPTABLE VALVE BOX MANUFACTURER'S INCLUDE NDS, CARSON OR APPROVED EQUAL.
- 12. INSTALL REMOTE CONTROL VALVE BOXES 12" FROM WALK, CURB, OR BUILDING AT MULTIPLE VALVE BOX GROUPS. INSTALL EACH BOX OR BUILDING AI WOLFFILE VALVE BOX OROOFS, INSTALL EACH BOY AN EQUAL DISTANCE FROM THE WALK, CURB, OR BUILDING AND PROVIDE 12" BETWEEN BOX TOPS, ALIGN THE SHORT SIDE OF RECTANGULAR VALVE BOXES PARALLEL TO WALK, CURB, OR BUILDING, LANDSCAPE ARCHITECT TO APPROVE BOX LOCATIONS PRIOR TO INSTALLATION.
- 13. VALVE LOCATIONS SHOWN ARE DIAGRAMMATIC. INSTALL IN GROUND COVER/SHRUB AREAS, LOCATE IN PLACES THAT ARE NOT VISUALLY PROMINENT.
- 14. THE CONTRACTOR SHALL LABEL CONTROL LINE WIRE AT EACH REMOTE CONTROL VALVE WITH A 2 1/4" X 2 3/4" POLYURETHANE I.D. TAG, INDICATING IDENTIFICATION NUMBER OF VALVE (CONTROLLER AND STATION NUMBER). ATTACH LABEL TO CONTROL WIRE.
- INSTALL A GATE VALVE TO ISOLATE EACH REMOTE CONTROL VALVE OR GROUP OF RCVS LOCATED TOGETHER. GATE VALVE SIZE SHALL BE SAME AS THE LARGEST REMOTE CONTROL
- 16. WHERE IT IS NECESSARY TO EXCAVATE ADJACENT TO EXISTING TREES. USE CAUTION TO AVOID INJURY TO TREES AND TREE ROOTS, EXCAVATE BY HAND IN AREAS WHERE TWO (2) INCH AND LARGER ROOTS OCCUR. BACK FILL TRENCHES ADJACENT TO TREE WITHIN TWENTY-FOUR (24) HOURS, WHERE THIS IS NOT POSSIBLE, SHADE THE SIDE OF THE TRENCH ADJACENT TO THE TREE WITH WET BURLAP OR CANVAS, REFER TO TEMPORARY TREE AND PLAN PROTECTION SPECIFICATIONS.
- NOTIFY LOCAL JURISDICTIONS FOR INSPECTION AND TESTING OF EXISTING BACKFLOW PREVENTION DEVICE.
- 18. THE IRRIGATION SYSTEM DESIGN IS BASED ON THE MINIMUM THE TRIGIATION STATEM DESIGN IS BASED ON THE WINNOWN OPERATING PRESSURE SHOWN ON THE RRIGIATION DRAWINGS, VERIFY WATER PRESSURE PRIOR TO CONSTRUCTION, REPORT ANY DIFFERENCE BETWEEN THE WATER PRESSURE INDICATED ON THE DRAWINGS AND THE ACTUAL PRESSURE READING AT THE IRRIGATION POINT OF CONNECTION TO THE OWNER'S AUTHORIZED REPRESENTATIVE.
- IRRIGATION DEMAND: REFER TO PLANS.
- 20. PIPE SIZING SHOWN ON THE DRAWINGS IS TYPICAL, AS CHANGES IN LAYOUT OCCUR DURING STAKING AND CONSTRUCTION THE SIZE MAY NEED TO BE ADJUSTED
- 21. PIPE THREAD SEALANT COMPOUND SHALL BE RECTOR SEAL #5.
- 22. THE LANDSCAPE CONTRACTOR SHALL BE RESPONSIBLE FOR MINOR CHANGES IN THE IRRIGATION LAYOUT DUE TO OBSTRUCTIONS SUCH AS LIGHTS, FIRE HYDRANTS, SIGNS, ELECTRICAL ENCLOSURES, ETC.
- 23. THE LANDSCAPE CONTRACTOR SHALL BE RESPONSIBLE FOR THE LANDSBLEFOR CRITICATION ACTOR SHALL BE RESPONSIBLE FOR CHANGES IN THE RRIFERON LAYOUT AND VALVE ZONING DUE TO EXPOSURE FROM BUILDINGS, TRELLISES, TREES, ETC., AS WELL AS SOLF AS SOLE CANDITIONS, THE CONTROL OF THE WELL AL SOLFF AND SOLE CONDITIONS, THE CONTROL OF THE MEDICAL SOLE AND SOLE CONDITIONS, THE CONTROL OF THE MEDICAL SOLE AND SOLE CONDITIONS, THE CONTROL OF THE MEDICAL SOLE AND SOLE CONDITIONS. THE CONTROL OF THE MEDICAL SOLE AND SOLE CONDITIONS AND CONTROL OF THE MEDICAL SOLE AND SOLE CONDITIONS. PROPOSED CHANGES PRIOR TO INSTALLATION FOR APPROVAL.
- THE LANDSCAPE CONTRACTOR IS RESPONSIBLE FOR ADJUSTING THE IRRIGATION SYSTEM DESIGN IF THE PLANTING DESIGN CHANGES FROM THE ORIGINAL PLAN AND NEEDS TO ADAPT TO THE NEW PLANTING DESIGN. THE LANDSCAPE CONTRACTOR NEEDS TO NOTIFY THE LANDSCAPE ARCHITECT AND OWNER OF PROPOSED CHANGES
- 25. WHEN WORK OF THIS SECTION HAS BEEN COMPLETED AND SUCH OTHER TIMES AS MAY BE DIRECTED, REMOVE ALL TRASH, DEBRIS, SURPLUS MATERIALS AND EQUIPMENT FROM SITE.
- 26. CONTRACTOR SHALL BE RESPONSIBLE FOR SUPPLEMENTAL AND HAND WATERING OF ALL PLANT MATERIAL WITHIN DRIPLINE AREAS DURING MAINTENANCE PERIOD TO ASSURE THAT PLANTS ARE SUFFICIENTLY ESTABLISHED.
- 27. VERIFY LOCATIONS OF ALL IRRIGATION COMPONENTS INSTALLED WITHIN A VALVE BOX WITH LANDSCAPE ARCHITECT PRIOR TO INSTALLATION, DO NOT INSTALL UNTIL LANDSCAPE ARCHITECT PROVIDES ACCEPTABLE LOCATIONS.

WATER USE CALCULATIONS

				WATER USE ES	STIMATION - 38TH AVE. C	APITOLA PROJECT					
WATER TYPE		POTABLE	1								
CITY		CAPITOLA, CA	1								
TOTAL ANNUAL ETO		36.7									
PEAK MONTHLY ETO		4.8									
DATE		2/6/24		B	EGULAR LANDSCAFE A	DEAC					
		1		WATER USE	EGULAR LANDSCAPE A	KEAS	1		1		
HYDROZONE	VALVE#	GPM	AREA (sq.ft) (HA)	(LW=LOW, MW=MOD, HW = HIGH)	PLANT TYPE	IRRIGATION TYPE	PLANT FACTOR (PF)	IRRIGATION EFFICIENCY (IE)	ETAF (PF/IE)	ETWU (GALIYEAR)	PERCENTAGE OF LANDSCAPE
1	TBC	15.41	1,545	LW	SHRUBS/GC	DRIPLINE 12"	0.2	0.81	0.25	7,031	9%
2	TBC	35.47	710	MW	TREES	BUBBLER	0.5	0.81	0.62	8,076	4%
3	TBC	24.9	2402	LW	SHRUBS/GC	DRIPLINE 12"	0.2	0.81	0.25	10,931	13%
4	TBC	9.85	197	MW	TREES	BUBBLER	0.5	0.81	0.62	2,243	1%
5	TBC	9.96	998	LW	SHRUBS/GC	DRIPLINE 12"	0.2	0.81	0.25	4,542	6%
6	TBC	23.65	473	MW	TREES	BUBBLER	0.5	0.81	0.62	5,384	3%
7	TBC	27.48	2,755	LW	SHRUBS/GC	DRIPLINE 12"	0.2	0.81	0.25	12,537	15%
8	TBC	9.85	197	WW	TREES	BUBBLER	0.5	0.81	0.62	2,243	1%
9	TBC TBC	31.69 23.65	3177 473	LW	SHRUBS/GC TREES	DRIPLINE 12" BUBBLER	0.2	0.81 0.81	0.25	14,458 5.384	18%
10	TBC	23.65	2,269	LW	SHRUBS/GC	DRIPLINE 12"	0.5	0.81	0.62	5,384 10.326	13%
12	TBC	22.03	2,269	LW	SHRUBS/GC	DRIPLINE 12"	0.2	0.81	0.25	9,994	12%
13	TBC	31.53	631	MW	TREES	BUBBLER	0.5	0.81	0.62	7.179	4%
10	100	TOTAL	18,024	1000	INCLO	DODUCEN	0.0	0.01	TOTAL	100,329	100%
				0%							
MAWA		GALLON	IS/YEAR	184551							
		ACRE FEET/YEAR		0.57							
		HCF/	YEAR	246.73	l						
		GALLON	IS/YEAR	100329							
ETWU		ACRE FEET/YEAR		0.31	MAWA FORMULA				ETWU FORMULA		
HCFA			YEAR	134.13]		LIED WATER ALLOWAN GALLONS PER YEAR			D TOTAL WATER SALLONS PER Y	EAR
SITE IRRIGATION		SITE PLANT				MAWA= (ETc	a)(0.62)(LA x 0.45) - (0.5	X SLA)	ETWI	J= ((ETo)(0.62)(E	IAF x LA)
EFFICIENCY 81.00%		FACTOR 0.34	MAWA COMPLIANT YES			Eto= REFERENCE EVAOPTRAN	ISPIRATION		Eto= REFERE	NCE EVAPOTRA	NSPIRATION
	FAF CALCULATIONS					0.45= ET ADJUSTMENT FACTOR				ACTOR FOR HYD	
EGULAR LANDSCAPE AREAS						LA= LANDSCAPED AREA (SQUA 0.62= CONVERSION FACTOR (C	ARE FEET)		HA= HYDROZ 0.62= CONVE	ONE AREA (SQ.	FT) (GALLONS/SQ. FT/YE/



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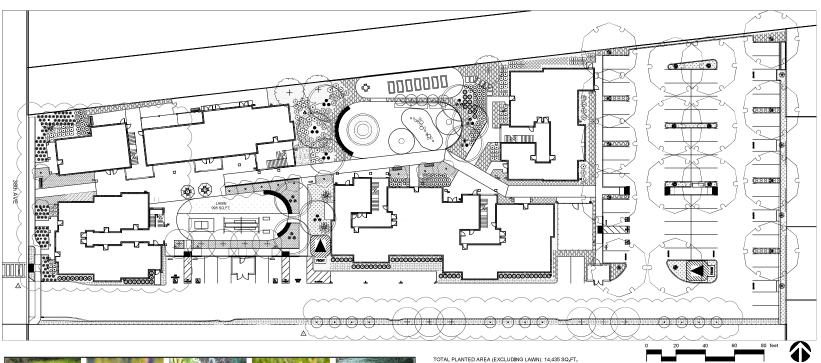
38TH AVE APARTMENTS

MIDPEN HOUSING 1098 38TH AVE, CAPITOLA, CA 95062 PLANNING SUBMITTAL

OCTOBER 23, 2023

IRRIGATION NOTES

DRAWN: SW, JR 23003 PL3.2 SCALE: 1" = 20'-0"





TOTAL PLANTED AREA (EXCLUDING LAWN): 14,435 SQ FT. TOTAL LAWN AREA: 995 SQ FT.

PLANT SCH	EDOLE					
CODE	BOTANICAL NAME	COMMON NAME	SIZE	WUCOLS	MATURE SIZE	MATURE CANOPY
TREES						
HYM FLA	HYMENOSPORUM FLAVUM	SWEETSHADE	24" BOX	MODERATE	35"H X 20"W	300SF
MAG VIR	MAGNOLIA VIRGINIANA 'JIM WILSON'	MOONGLOW® SWEETBAY MAGNOLIA	24" BOX	MODERATE	35°H X 20°W	300SF
POD ELO	PODOCARPUS ELONGATUS 'MONMAL'	ICEE BLUE® YELLOW WOOD	15 GAL	MODERATE	15'-25' H X 10'-15' W	110SF
SAP SAP	SAPINDUS SAPONARIA	WINGLEAF SOAPBERRY	15 GAL	LOW	25'-40' H X 15'-30' W	700SF
ULM DRA	ULMUS PARVIFOLIA 'DRAKE'	DRAKE LACEBARK ELM	24" BOX	LOW	50°H X 40°W	1250SF
CHI TAS	X CHITALPA TASHKENTENSIS	CHITALPA	24"BOX	LOW	20,-30, H X 50,-30, M	700SF
CODE	BOTANICAL NAME	COMMON NAME	SIZE	WATER USAGE	FIELD3	
SHRUBS						
AGA X '	AGAVE X 'BLUE FLAME'	BLUE FLAME AGAVE	5 GAL	LOW		
ALO X '	ALOE X 'LEO 4520'	BUSH BABY™ YELLOW ALOE	5 GAL	LOW		
CHA HUM	CHAMAEROPS HUMILIS ARGENTEA	BLUE MEDITERRANEAN FAN PALM	15 GAL	LOW		
DEN HAR	DENDROMECON HARFORDII	ISLAND BUSH POPPY	5 GAL	LOW		
ELE EER	ELEGIA TECTORUM 'DWARF'	DWARF CAPE RUSH	5 GAL	LOW		
MAH EUR	MAHONIA EURYBRACTEATA 'SOFT CARESS'	SOFT CARESS MAHONIA	5 GAL	MODERATE		
OPU EL7	OPUNTIA CACANAPA 'ELLISIANA'	SPINELESS PRICKLY PEAR	5 GAL	VERY LOW		
RHA CAL	RHAMNUS CALIFORNICA 'MOUND SAN BRUNO'	MOUND SAN BRUNO COFFEEBERRY	5 GAL	LOW		
TAG LEM	TAGETES LEMMONII	COPPER CANYON DAISY	5 GAL	LOW		
GROUND CO	OVERS					
ANI FLA	ANIGOZANTHOS FLAVIDUS	GREEN KANGAROO PAW	1 GAL	LOW		
LOM IRA	LOMANDRA LONGIFOLIA 'BREEZE'	BREEZE™ MAT RUSH	1 GAL	LOW		
NEP COR	NEPHROLEPIS CORDIFOLIA	SWORD FERN	1 GAL	MEDIUM		
SAL BEE	SALVIA X 'BEE'S BLISS'	BEE'S BLISS SAGE	1 GAL	LOW		
SES AOP	SESLERIA AUTUMNALIS 'CAMPO VERDE'	CAMPO VERDE AUTUMN MOOR GRASS	1 GAL	MEDIUM		



San Francisco, CA 94114


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38TH AVE APARTMENTS DEVELOPMENT FOR:
MIDPEN HOUSING 1098 38TH AVE, CAPITOLA, CA 95062 PLANNING SUBMITTAL

OCTOBER 23, 2023

PLANTING LIST

			ISSUED:	10.23.20
No.	DATE	ISSUE	 DRAWN:	SW, JR
	08-85-2024	Planning Presidentital	CHECKED:	SW
			JOB:	23003
			PL4	.1
_	1		SCALE:	1" = 20'-

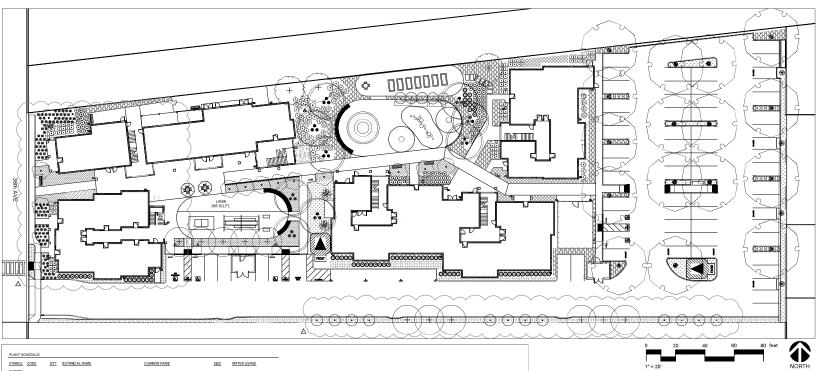

PLANT SO	CHEDULE						
SYMBOL	CODE	QTY	BOTANICAL NAME	COMMON NAME	SEE	WATER USAGE	
SHRUBS (2)	AGA X '	28 101 3	AGAVE X 'BLUE FLAME' ALOE X 'LEO 4620' CHAMAEROPS HUMILIS ARGENTEA	BLUE FLAME AGAVE BUSH BABY™ YELLOWALOE BLUE MEDITERRANEAN FAN PALM	5 GAL 5 GAL 15 GAL	LOW LOW	
	DEN HAR ELE EER MAH EUR OPU EL7 RHA CAL TAG LEM	2 71 85 4 121 10	DENDROMECON HARFORDII ELEGIA TECTORIUM DWARF MAHONIA EURYBRACTEATA 'SOFT CARESS' OPUNTIA CACANAPA 'ELISIANA' RHAMNUS GALFORNICA MOUND SAN BRUNO' TAGETES LEMMONII	ISLAND BUSH POPPY DWARF CAPE RUSH SOFT CARESS MAHONIA SPIRELESS PRICKLY PEAR MOUND SAN BRUNO COFFEEBERRY COPPER CANYON DAISY	5 GAL 5 GAL 5 GAL 5 GAL 5 GAL 5 GAL	LOW LOW MODERATE VERY LOW LOW LOW	
SYMBOL	CODE	OTY	BOTANICAL NAME	COMMON NAME	SPE	WATER USAGE	SPACE
GROUND	ANI FLA LOM IRA NEP COR	180 212 132	ANIGOZANTHOS FLAVIDUS LOMANDRA LONGIFOLIA "BREEZE" NEPHROLEPIS CORDIFOLIA	GREEN KANGAROO PAW BREEZE™ MAT RUSH SWORD FERN	1 GAL 1 GAL 1 GAL	LOW MEDIUM	36" o.c 36" o.c 24" o.c
300000	SAL BEE SES AOP	228 752	SALVÍA X 'BEE'S BLISS' SESLERÍA AUTUMNALÍS 'CAMPO VERDE'	BEE'S BLISS SAGE CAMPO VERDE AUTUMN MOOR GRASS	1 GAL 1 GAL	MEDIUM	36° 0,0 24° 0,0



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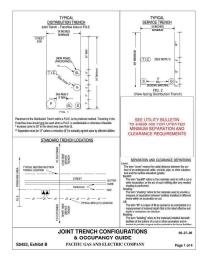
38TH AVE APARTMENTS DEVELOPMENT FOR:
MIDPEN HOUSING

1098 38TH AVE, CAPITOLA, CA 95062

PLANNING SUBMITTAL OCTOBER 23, 2023

PLANTING PLAN

			ISSUED:	10.23.2023
No.	DATE	ISSUE	 DRAWN:	SW, JR
-	09-85-2024	Planning Presidentity	CHECKED:	SW
	-		 JOB:	23003
			PL4.	.2
_	1	1	 SCALE:	1" = 20'-0"



Updated Separation Requirements For Conduit in Joint Trench

The minimum separation requirement must be 1.5 inch (in.) betweer

— Secondary te: Secondary, cervice, and streatlight conduit

— Service to: Service and streetlight conduit

The minimum separation requirement must be 3 in. between:

— Primary-O-primary conduit

· Primary to: Secondary, service, and streetlight conduit

AFFECTED DOCUMENT

This utifity bulletin updates <u>Electric Standard 062288</u>, "<u>Underground Conduits</u>" and <u>Utifity Standard S5453</u>, "Joint Trench" with the requirements listed below:

This increase in separation is required to improve access to the conduits during future maintenance, re-routing and replacement of the facilities.


Note that the 3 in, requirement above is already included in <u>Electric Standard 052288</u> but **not** in <u>Utility Standard 95453</u>.

Additionally, separation requirements between Paolitic Gas and Electric Company (PG&E or Company) Joint Trench utilities and Non-PG&E owned Foreign Electric dust (e.g., non-PG&E Streetlight) have been added to the updoed Take, "Marriman Reperation and Companies Streetlight (have been added to the updoed Take, "Marriman Reperation and Companies Requirements) (inches)", in this utility bulletin. These are not new requirements, but they were not previously bottom in the Exhibit District.

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Utility Bulletin: TD-5453B-002

Publication Date: 07/10/2015 Effective Date: 07/31/2015 Rev

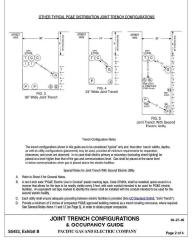

pdated Separation Requirements For Conduit in Joint Trench

Utility Standard S5453, "Joint Trench," Exhibit B, is updated per this bulletin as follows

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WHAT YOU NEED TO KNOW

9 /EI ECTRIC SECONDARY

(ELECTRIC PRIMARY)

Command Montes 1. The preferred forced brazders in its in Public URIN presenter (PULE). 2. Ad applic and resident great requirements are instanced from the great product of the public and strategies are requirements and the public of the

1. Presente the dependence of the control of strong it must be deserted and the College of the control of strong the college of the college

JOINT TRENCH CONFIGURATIONS & OCCUPANCY GUIDE

PACIFIC GAS AND ELECTRIC COMPANY

S5453, Exhibit B

09-27-06

General Notes, continued

e backfill for shading at PG&E electric facilities

GENERAL NOTES

- THE LAYOUT OF JOINT TRENCH IS DIAGRAMMATIC, CONTRACTOR SHALL MAKE ALL NECESSARY FIELD CHANGES TO ACCOMMODATE WITH EXISTING FIELD CONDITION PROVIDE ALL NECESSARY WORK FOR OFF-SETS, CHANGES OF DIRECTION AND ELEVATION TO AVOID CONFLICTS WITH EXISTING AND NEW FACILITIES AND WORK TO BE PROVIDED BY OTHER DIVISIONS.
- PROVIDE ALL REQUIRED TRENCHING INCLUDING DEEPER TRENCHES TO ALLOW CONDUIT OFF-SETS, AND CHANGE OF ELEVATIONS, CONDUIT CROSSING, CONNECTIONS TO MANHOLES AND PULL BOXES FOR A COMPLICETE INSTALLATION.
- ALL CONNECTIONS TO MANHOLES AND PULL BOXES SHALL COMPLY WITH UTILITY COMPANIES REQUIREMENTS. COORDINATE ALL WORK WITH UTILITY COMPANIES.
- UTILITY STANDARD PRACTICES FOR TRENCHING SHALL APPLY TO ALL TRENCHING, BACK FILLING AND INSTALL ATION IMPORE
- THE CONTRACTOR IS RESPONSIBLE TO HAVE ALL INSTALLATIONS INSPECTED AND APPROVED BY TH RESPECTIVE UTILITY COMPANY, MUNICIPALITY, OR SOILS ENGINEER PRIOR TO ANY BACK FILLING. (4)
- SHOULD A DISPUTE OR DISAGREEMENT OVER ANY INSTALLATION, DESIGN, PLAN, OR DRAWING OCCUR
 THE SPECIFICATIONS AND REQUIREMENTS OF THE INDIVIDUAL UTILITY COMPANY AND THEIR
 INSPECTOR SHALL TAKE PRECEDENCE.
- CONTRACTOR SHALL COORDINATE WITH UTILITY COMPANIES. LACK OF TIMELINESS ON THE PART OF ANY UTILITY COMPANY SHALL NOT BE THE BASIS FOR ANY REQUEST FOR ADDITIONAL COMPENSATION.
- THE DRAWINGS AND SPECIFICATIONS SHALL BE CONSIDERED TO BE COMPLEMENTARY TO ONE
 ANOTHER, ANYTHING MENTIONED IN THE SPECIFICATIONS AND NOT SHOWN ON THE DRAWINGS, OR
 SHOWN ON THE DRAWINGS AND NOT MENTIONED IN THE SPECIFICATIONS SHALL BE CONSIDERED OF
 LIKE EFFECT AS IF APPEARING IN BOTH. CONTACT THE OWNER PRIOR TO START OF WORK IF A
 INCREPANCY IS FOLKIO.
- CONSULT PARTICIPATING UTILITIES, SOILS ENGINEER, AND THE CITY OF SAN FRANCISCO FOR APPROVED BACK FILL MATERIAL. COMPACTION TO MEET LOCAL. AGENCIES REQUIREMENTS.
- 10. CONTRACTOR SHALL COMPLY WITH ALL LAWS, CREINANCES AND REGULATIONS CONTRACTOR SHALL BE FAMILIAR WITH O.S.H.A. INDUSTRIAL DOCERS AND SHALL CONDUCT HIS WORK ACCORDINGLY. WHEN WORKING ENERGIZED BOURPAINT, THE UTILITY OWNER SHALL BE WORTHED TO SUPPLY THE APPROPRIATE DIAPPOWER AND SAFETY PRECAUTIONS AS INSECTED THE CONTRACTOR IS RESPONSIBLE FOR THE SAFETY AND TRAFFIC CONTROL IMEASURES.
- THE CONTRACTOR SHALL MAINTAIN POINTS OF ACCESS THAT ARE AGREEABLE TO ADJACENT LAND USERS AND TENANTS AT ALL TIMES.
- 12. CONTRACT DOCUMENTS ASSUMES NO RESPONSIBILITY FOR THE PROJECT CONDITIONS, THE CONTRACTOR SHALL BE RESPONSIBLE TO REVIEW THE PROJECT AND SITE PRIOR TO SUBMITTING HIS
- THE CONTRACTOR IS RESPONSIBLE FOR COORDINATION OF CONSTRUCTION WITH THE RESPECTIVE UTILITY AGENCIES, ALLOWING 48 HOURS PRIOR TO THE NEED FOR INSTALLATION.
- ALL LENGTHS SHOWN ON THESE PLANS ARE ESTIMATES. FINAL QUANTITIES SHALL BE BASED ON WHAT WILL BE NEEDED TO COMPLETE THIS PROJECT. DUE TO CHANGES, ADDITIONS, DELETIONS OF
- 15. THE CONTRACTOR IS RESPONSISE TO POTECT IN PLACE ALL EXISTING FACILITIES, EXCAVATION MAY BE REQUIRED OVER, UNDER OR ADJACENT TO EXISTING UNDERSOROUND UTILITIES. THE CONTRACTOR IS RESPONSIBLE FOR LOCATING, EXPONSION AND PROTECTIONS ALL EXISTING FACILITIES.
- 16 THE CONTRACTOR SHALL PROVIDE AS BUILT DRAWINGS AFTER INSTALLATION
- ALL CONDUIT ENTRANCE TO MANHOLE, PULL BOX, & VAULTS SHALL BE WATER PROOFED. ALL INSTALLATION SHALL CONFORM TO REQUIREMENTS OF UTILITY COMPANIES AND COMMUNICATION SERVICE PROVIDER.
- IN THE STREET, ALL CONDUITS SHALL BE INSTALLED WITH MINNUM OF 38" COVERAGE, EXCEPTIONS SHALL BE APPROVED BY THE CITY AND UTILITY COMPANY AUTHORIZED AGENTS. PROVIDE 4"THICK RED DYE CONCRETE CAP ABOVE CONDUITS WHICH DO NOT HAVE 38" COVERAGE.
- THE CONTRACTOR, PRIOR TO BIDDING, SHALL VISIT THE JOB SITE TO BE FAMILIARIZED WITH THE EXISTING UTILITIES INSTALLATIONS, CONDITIONS, AND SYSTEMS RELATED TO THE SCOPE OF WORK.
- 20. THE CONTRACTOR SHALL FURNISH ALL LABOR, MATERIALS, FEES AND EQUIPMENT SPECIFIED, INDICATED OR IMPLIED IN THESE DOLUMENTS TO ACCOMPLISH THE CONSTRUCTION IN A PROFESSIONAL WORKMANLE MANURE, MY INSCREPANCIES BETWEEN THE CONSTRUCTION TASKS INDICATED AND LOCAL CODES AND/OR ORDINANCES SHALL BE BROUGHT OF THE MINECLATE ATTENTION OF THE GENERAL CONTRACTOR FOR RESOLUTION BETWEEN PRECEDING WITH THE WORK
- THE CONTRACTOR SHALL REVIEW AND COORDINATE WITH OTHER DISCIPLINES DRAWINGS RELATED TO THE PROJECT FOR OTHER WORK TO BE PROVIDED.
- 22. ANY WORK INSTALLED INCORRECTLY, OR BEFORE APPROVAL HAS BEEN OFFICIALLY GRANTED FOR THOSE ITEMS AT ISSUE, SHALL BE CORRECTED BY THE CONTRACTOR AT NO CHARGE TO CLIENT.
- ALL MATERIALS AND EQUIPMENT FURNISHED BY THE CONTRACTOR SHALL BE NEW AND COMPLETELY SERVICEABLE UNLESS OTHERWISE SPECIFIED.
- 24. CONTRACTOR SHALL BE COMPLETELY FAMILIAR WITH EXISTING CONDITIONS BEFORE STARTING NEW WORK, VERIFY FINAL PLACEMENT AND CONNECTION REDUIREMENTS PRIOR TO ROUGHING-IN EQUIPMENT.
- FINAL ACCEPTANCE OF WORK IN PLACE SHALL BE SUBJECT TO APPROVAL BY OWNER'S REPRESENTATIVE AND ENGINEER, INSTALLATION APPROVAL SHALL BE BASED ON APPROVED SUBMITTAL, SHOP DRAWINGS AND LOCAL, INSPECTION.
- 26. ALL JOINT TRENCH CONDUIT SHALL COMPLY WITH PG&E GREEN BOOK, CURRENT EDITION.
- CONTRACTOR SHALL INSTALL 2/4" x 10" GROUND RODS IN ALL PRIMARY SUBSURFACE ENCLOSURES AND 5/9" x 10" GROUND RODS IN ALL SECONDARY SUBSURFACE ENCLOSURES. THE RESISTANCE AT THE GROUND ROD 5/44L MEET ARTICLE 250.5 NEC.
- 28. ALL CONDUIT SYSTEMS SHALL BE PROVEN BY USING MANDRELS.
- 29. ALL CONDUITS SHALL ENTER AND LEAVE ON THE SIDES OF THE PRIMARY ENCLOSURES.
- 30. PRIMARY AND SECONDARY CONCRETE ENCLOSURES SHOULD NOT BE INSTALLED IN ANY DRIVEWAY AREAS.
- 31. SWEDGE REDUCERS ARE REQUIRED IF THE CONDUIT KNOCKOUTS ARE 6" AND THE CONDUITS ARE 4".
- 32. ALL WORK INCLUDING SIDEWALK AND PAYEMENT CUTTING AND REMOVAL, LAGGING, EXCAVATION BROTHLE, AND SIDEWALK AND PAYEMENT RESTORATION SHALL BE DONE BY A LICENSED PANIS CONTINUED AND IN ACCORDING WITH THE REQUESTED FOR THE STRAND OF STRONG SECRETARIONS OF THE BURBALD FOR SIDEWARD FOR THE STRONG STRONG SECRETARIONS OF THE SURFACION FOR BURBALD FOR THE STRONG STRONG SIDEWARD FOR THE STRONG STRONG SIDEWARD FOR THE STRONG STRONG SIDEWARD FOR STRONG SIDEWARD FOR SIDEWARD FOR THE STRONG SIDEWARD FOR SIDEWARD FOR THE STRONG SIDEWARD FOR SIDE
- 33. CONTRACTOR SHALL NOTIFY UNDERGROUND SERVICES ALERT (U.S.A.) AT 1-800-227-2500 AT LEAST 48 HOURS PRIOR TO ANY EXCAVATION CONTACTING U.S.A. DOES NOT RELIEVE THE CONTRACTOR FROM HIS RESPONSIBILITY TO EXTERNIBLE LOCATION AND DEFTH OF BURIED UTILITIES.

CONSULTINGENGINEERS

SERVICE OF THE PROPERTY O

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38TH AVE APARTMENTS

Utility Bulletin: TD-5453B-002

Publication Date: 07/10/2015 Effective Date: 07/31/2015 Rev

MIDPEN HOUSING 1098 38TH AVE, CAPITOLA, CA 95062 OCTOBER 23, 2023

PLANNING SUBMITTAL

DRY UTILITY STANDARDS

No. DATE ISSUE 10.23.2023


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JOB: 23003

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SCALE: AS INDICATES





LEGEND:

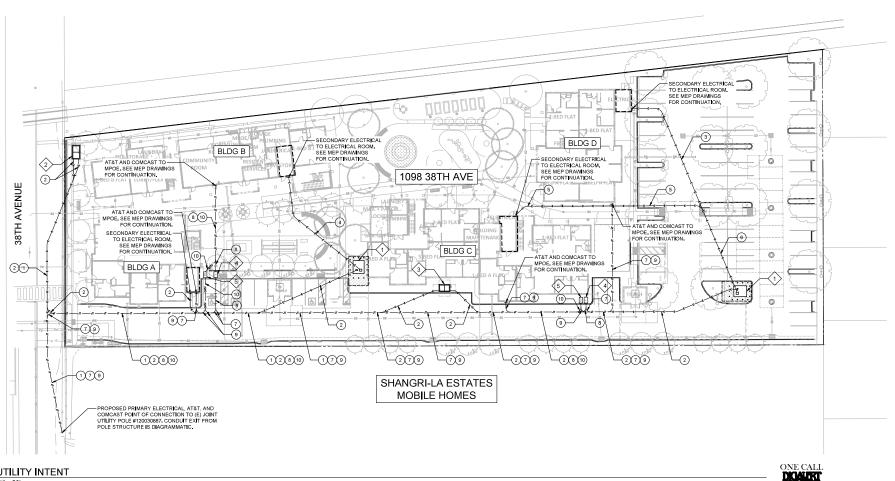--- PROPERTY LINE PROPOSED JOINT TRENCH PROPOSED ELECTRICAL TRENCH PROPOSED AT&T TRENCH

EQUIPMENT TAG:

- PRECAST PAD FOR TRANSFORMER, TYPE IIE-LBM 90" X 106", SEE PG&E DRAWINGS, REFER TO PG&E GREENBOOK SECTION 045292 (PG&E ORDERING CODE: 040292)
- PG&E SUBSURFACE SWITCH INTERRUPTER SWITCH (PRIMARY UNDERGROUND EQUIPMENT ENCLOSURE) #7, TYPE 2, 4'-6" X 8'-6" X 6'-0" (PG&E ORDERING CODE: 043411)
- PG&E JUNCTION BOX (PRIMARY UNDERGROUND EQUIPMENT ENCLOSURE) #6, TYPE 2, 4"-0" X 6"-6" X 5"-0" (PG&E ORDERING CODE: 041495) $\langle 3 \rangle$
- 4> AT&T VAULT, 30" X 48" X 36"
- COMCAST B44 VAULT, 28" X 48" X 12"

CONDUIT NOTE TAG:

- (1) PG&E PRIMARY ELECTRICAL (2) 6"
- 2 PG&E PRIMARY ELECTRICAL (1) 6"
- (3) PG&E SECONDARY ELECTRICAL (2) 5"
- 4 PG&E SECONDARY ELECTRICAL (3) 5"
- (5) PG&E SECONDARY ELECTRICAL (5) 5"
- 6 PG&E SECONDARY ELECTRICAL (7) 5"
- Ō AT&T (1) 4"
- 8 AT&T (2) 4"
- 9 COMCAST (2) 2"
- 10) COMCAST (4) 2"

CONTRACTOR TO MAINTAIN 3' MIN HORIZONTAL AND 1' MIN VERTICAL SEPARATIONS BETWEEN WET AND DRY UTILITIES, TYP.

CONTRACTOR TO MAINTAIN 5' MIN HORIZONTAI SEPARATION BETWEEN DRY UTILITY AND CENTER OF STREET TREE, TYP.





NOT FOR CONSTRUCTION



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PROPOSED COMCAST TRENCH

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38TH AVE APARTMENTS

MIDPEN HOUSING 1098 38TH AVE, CAPITOLA, CA 95062

PLANNING SUBMITTAL

OCTOBER 23, 2023

DRY UTILITY INTENT

			 JOB:	JL, NL, DH 23003
			JTI.	02
			 SCALE:	AS INDICATED