

# Vicinity Map



## Project Data

All work to comply with all City of Capitola local codes and approved building standards. All work to comply with 2019 California Building, 2019 California Electrical Code, 2019 California Mechanical Code, 2019 California Fuento Code, 2019 California Green Code, 2019 California Fire and Energy Codes and the 2019 California Residential Building Code.

This project is to demolish an existing 1900 SF house and garage and build a new residence.

A.P.N.: Lot Size: 036-185-10 6,003 SF 61' x 100' R-1 2,881 SF VB Sprinklered R-3/U Zoning: Max FAR ( 48%): Construction Type: Occupancy: Fire Sprinklers:

Yes
20' front + rear yard, side : 6' 1st floor,
9' 2nd floor side yard setback Existing New

Habitable Space: 1st Floor 1,900 SF 1,255 SF 397 SF 177 SF 341 SF 2nd Floor 2nd Flr 16' ht ADU

Garage: Total Impervious Surfaces 1st Floor

Garage ADU 409 SF 495 SF 341 SF Conc Driveway + Walks Total 1.056 SF 56.1% 3,365 SF

Owner: Chris + Lee Heck 121 Cabrillio Capitola CA

2 Project Data 1/4" = 1'-0"

## **Drawing Index**

Site Plan + Project Data Existing Site + Floor Plan Proposed Floor Plans Proposed Exterior Elevations Proposed Exterior Elevations Building Sections + Roof Plan Colors + Material Board Public Works Details A101 A102 A103 A104 A105 A106 A107 A108 L1 Landscape Site Plan

C1 Land Survey

3 Drawing Index 1/4" = 1'-0"

### Consultants

Architect: Kurt Useldinger Architect 218 Mount Hermon Rd #E Scotts Valley CA 95066 408-204-3431

Landscape Architect Greg Lewis Landscape Architect 730 Park Way Santa Cruz CA 95065 831-359-0960

Land Survey Hogan Land Services 2601 41st Ave #B Soquel CA 95073 831-425-1617

4 Consultants 1/4" = 1'-0"

rarchitects.com Kurt Useldinger Architect Bay Area 218 Mount Hermon Rd #E Scotts Valley CA 95066 Northern California 2173 De Mille Rd Paradise CA 95969

> Heck Residence 121 Cabrillo St Capitola CA 95010 APN 036-185-10

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Heck Residence

Site + Roof Plan


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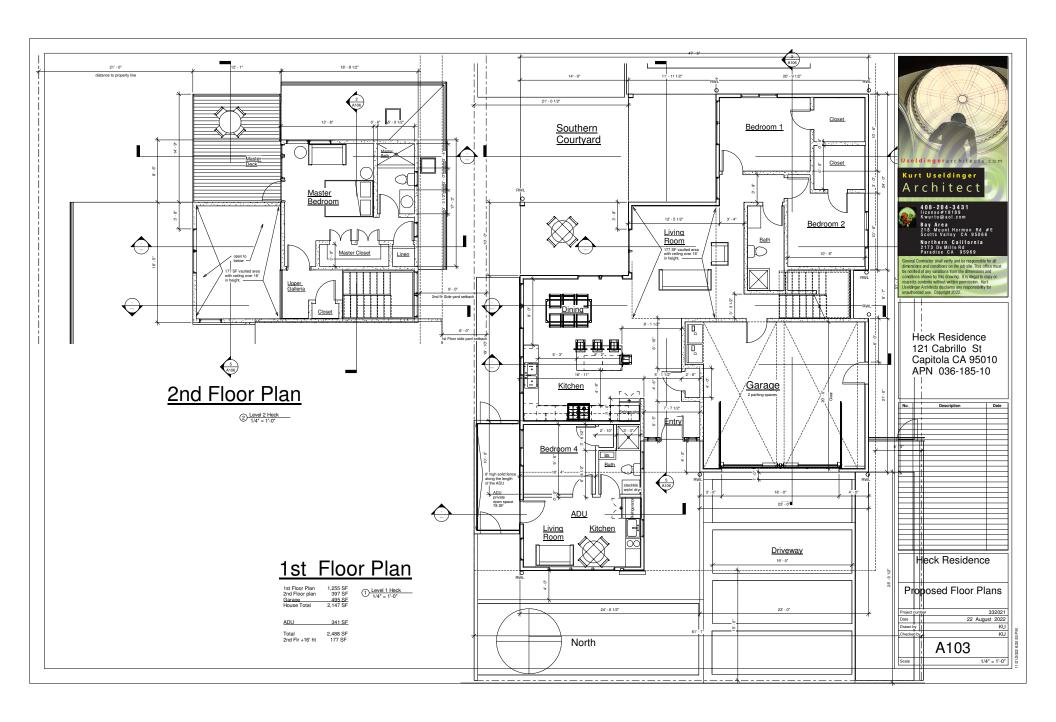
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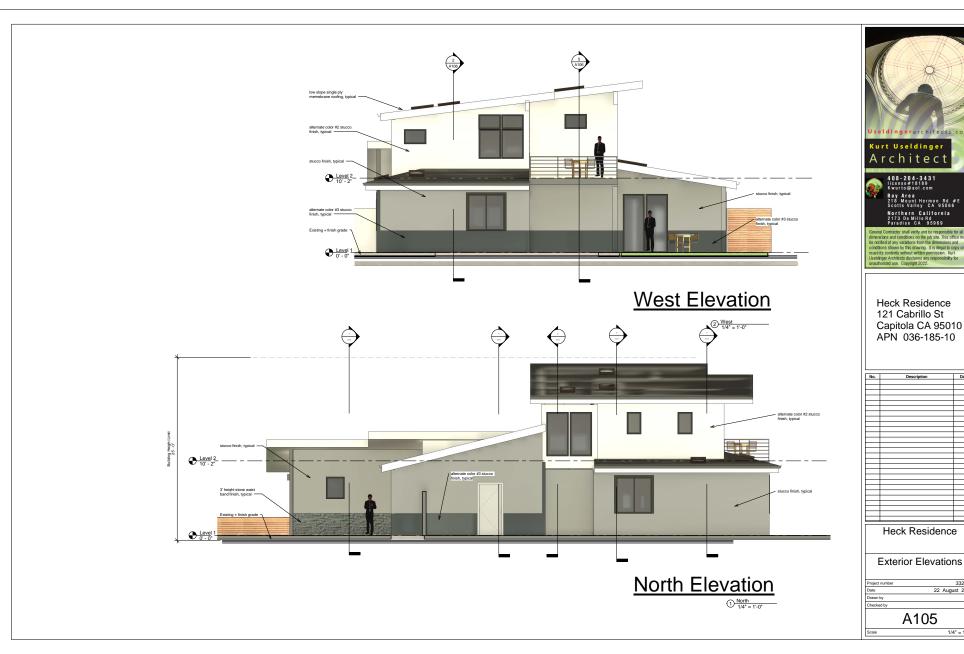
# Proposed Site Plan

1/8" = 1'-0"







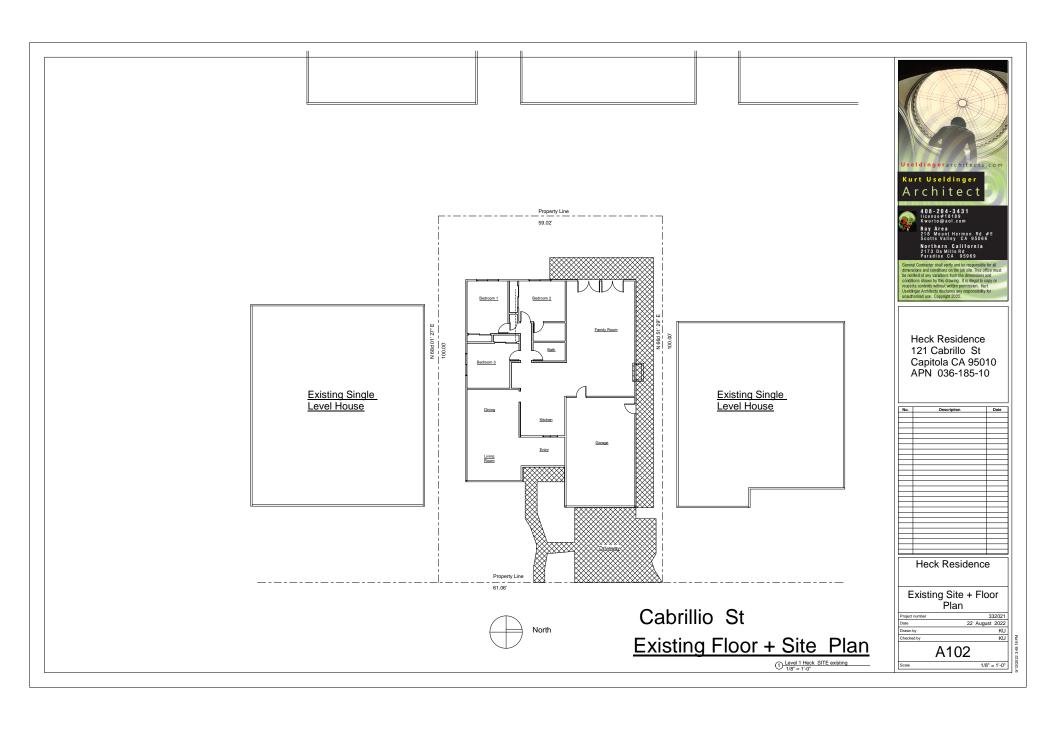




Heck Residence 121 Cabrillo St Capitola CA 95010 APN 036-185-10

No.	Description	Date

332021 22 August 2022

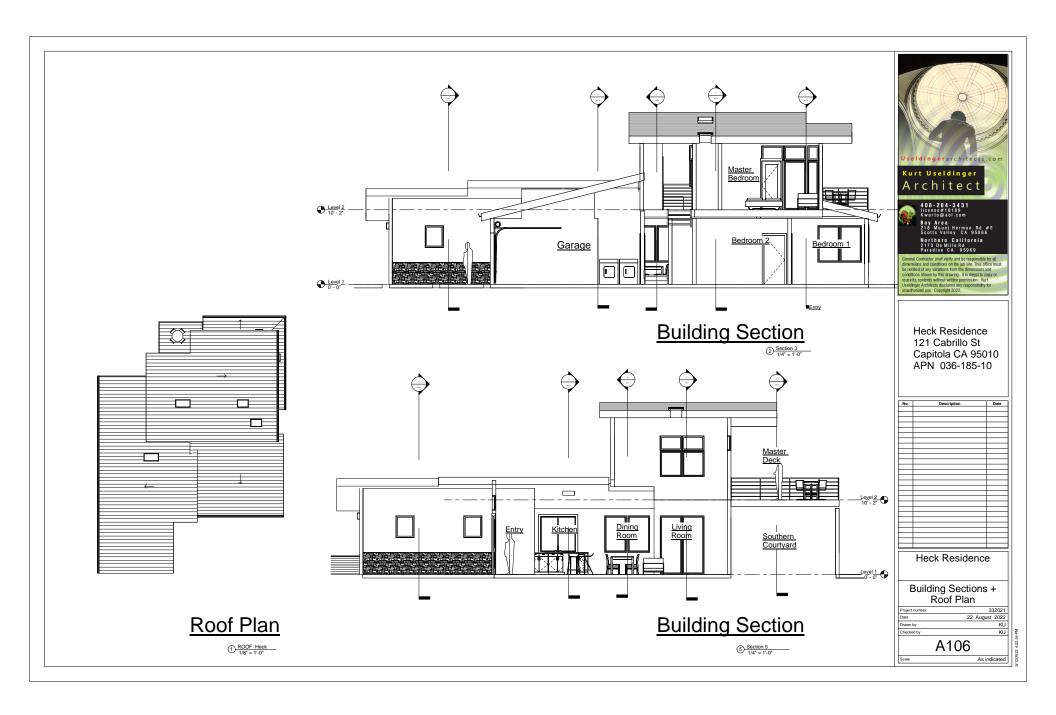

# Color + Material Board







5 05082022 2 Int Galleria 1\_1 12" = 1'-0"

6 05082022 1 Int Nook to LR 1 12" = 1'-0"





③ 05082022 Ext Street 1\_1

Useldingerarchitects.com

Kurt Useldinger
Architect

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Research 188

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Heck Residence 121 Cabrillo St Capitola CA 95010 APN 036-185-10

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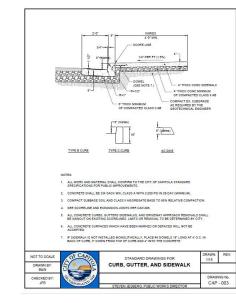
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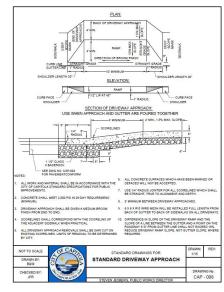
Colors + Material Board

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12" = 1

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Heck Residence 121 Cabrillo St Capitola CA 95010 APN 036-185-10

No.	Description	Date
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Heck Residence

Public Works Detail

Project number	332021	
Date	22 August 2022	
Drawn by	Author	
Checked by	Checker	
1 100		


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control and exists of 2 moins grobe of surrounding soil when it settles, Install some or recuser prodest under root boil.

5) Fill around rootbell with boadfill mix to 1/2 its height and pook soil as you fill with showed that or feet being created not to destinate not bed oil-joined. To credate and of better not boil of the control and oil better of boil of the control and oil better of boil of the control and oil or the control and oil better of boil to destine the boil of the control and oil or the control and oil or the control of the boil of the control of the boil of the control of the boil of the control of the control of the control of the boil of the control of the

Tree Planting




- allation, water all plants while still in containers sufficiently
- 1) 8.1 (2) not before initiations, where of pulsar where all no contrares sufficiently (1) 8.1 (2) not before initiations, where of pulsar sufficiently (2) 0 g the plant for of bed and 3 times the depth of the plant contrares.

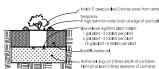  3) Replace his matters in bottom had for the cond wide on. 1. the level of 3 thought be such that when the plant in instanct and retained will be being the copied of earlier and the contrared that the plant of the plant

Shrub Planting

No Scale

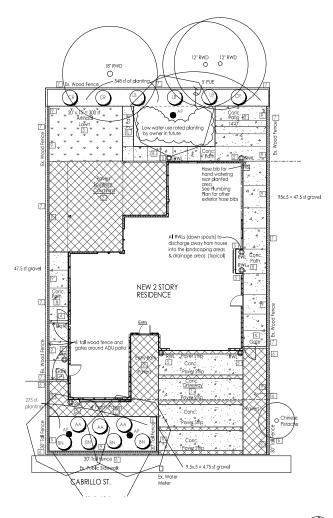

Landscape Plan &



Tree Canopy Coverage Lot Size is 6003 sf

- Landscape Site Legend

  Driveway Poured in place concrete, natural color, with 12 inch wide strips of interboking conc. powers or just all concrete
- Paths and Patios Interlocking conc. pavers or poured in place concrete brand, pattern, and color to be selected by owner one option is Calstone Mission, gray, charcoal, tan
- 3' wide x 6' tall wood gate and fence with horiz, 1x4s
- 5 Down spouts (rain water leaders RWL) locations
- 6 30 inch tall wood fence with horiz. 1x4 or 1x6 stained to match wood on house
- Existing solid wood fence to remain
- B Poured in place conc. paving color and finish to be selected by owner

#### Plant Palette

KEY	QTY S	SIZE	BOTANICAL NAME	COMMON NAME	WUCOLS RATING
AP	3	15	Acer palmatum Oshio Beni ar Sango Kaku	Red Japanese Maple Coral Bark Maple	MED MED
SHRU	BS				
CR	3	5	Cycas revoluta	Sago Palm	MED
GRO	UND C	OVERS			
LB	3	1	Lomandra Breeze		LOW
BN	4	1	Bilibergia Nutans	Queens Tears	LOW
AA	3	5	Agave attenuata Ray of Light	Variegated Agave	LOW

### Tree Canopy Coverage

Total Parcel Area = 6003 sf 15% required Min. canopy coverage required .15 x 6003 = 900.45 sf

> Front Yard Japanese Maples 20' dia. mature canopy = 314 sf each 2 x 314 sf = 628 sf Rear Yard Japanese Maple Total canopy coverage = 942/6003 = 15.7%

### Landscape Notes

1 There is 823 st of Planting and Irrigation (Saquel Creek Water District Tier I) The plants will be hand watered with a hose bib and hose so no Irrigation Plan is being provided.

- 2 There is 300 sf of Artificial Lawn (rear yard) that is considered pervious.
- 3 There is 115 sf of 6" wide gravel strip that is pervious

