

Pervious/ Impervious:
 1,255 SF 1st Floor
 341 SF ADU
 495 SF Garage
 1,410 SF Concrete Driveway + Walks
 1,192 SF Pervious Pavers
 300 SF Artificial Turf

Note:
 Existing overhead utilities lines will be underground to the nearest utility pole.

Public Works Notes

- The extent of all improvements or modifications shall be limited to those areas fronting the property boundary and shall not impact the frontage of adjacent parcels.
- Capitola Public Works ADA compliant details are called out on the Site Plan. Any existing vegetation blocking the sidewalk shall be removed.
- RWL's in front half will drain to front planting areas and RWL's in back half will drain to rear yard planting areas.

Public Works
 1/4" = 1'-0"



Public Works Notes


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Public Works
 1/4" = 1'-0"

Proposed Site Plan

① Level 1 Heck SITE proposed
 1/8" = 1'-0"

Vicinity Map

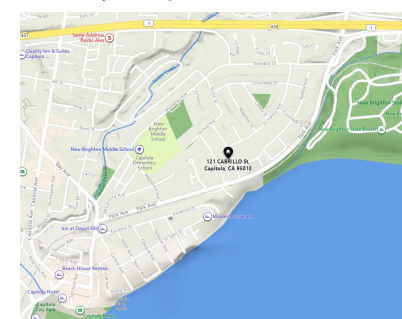

Project Data

All work to comply with all City of Capitola local codes and approved building standards. All work to comply with 2019 California Building, 2019 California Electrical Code, 2019 California Mechanical Code, 2019 California Plumbing Code, 2019 California Green Code, 2019 California Fire and Energy Codes and the 2019 California Residential Building Code.

This project is to demolish an existing 1900 SF house and garage and build a new residence.

A.P.N.:	036-185-10
Lot Size:	6,003 SF 61' x 100'
Zoning:	R-1
Max FAR (48%):	2,881 SF
Construction Type:	VB Sprinklered
Occupancy:	R-3U
Fire Sprinklers:	Yes
Setbacks:	20' front + rear yard, side : 6' 1st floor, 9' 2nd floor side yard setback

	Existing	New
Habitable Space:		
1st Floor	1,900 SF	1,255 SF
2nd Floor		397 SF
2nd Flr 16' ht		177 SF
ADU		341 SF
Garage:	409 SF	495 SF
Total	2,309 SF	2,665 SF (2,881 Max)

	Existing	New
Impervious Surfaces		
1st Floor	1,900 SF	1,255 SF
Garage	409 SF	495 SF
ADU		341 SF
Conc Driveway + Walks	1,056 SF	1,410 SF
Total	56.1%	3,365 SF
		58.3% 3,501 SF

Owner:
 Chris + Lee Heck
 121 Cabrillio
 Capitola CA

② **Project Data**
 1/4" = 1'-0"

Drawing Index

A101	Site Plan + Project Data
A102	Existing Site + Floor Plan
A103	Proposed Floor Plans
A104	Proposed Exterior Elevations
A105	Proposed Exterior Elevations
A106	Building Sections + Roof Plan
A107	Colors + Material Board
A108	Public Works Details
L1	Landscape Site Plan
C1	Land Survey

③ **Drawing Index**
 1/4" = 1'-0"

Consultants

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 Kurt Useldinger Architect
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 408-204-3431

Landscape Architect:
 Greg Lewis Landscape Architect
 730 Park Way
 Santa Cruz CA 95065
 831-359-0960

Land Survey:
 Hogan Land Services
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 Sequoia CA 95073
 831-425-1617

④ **Consultants**
 1/4" = 1'-0"

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Kurt Useldinger
Architect

408-204-3431
 license #18189
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 Paradise CA 95969

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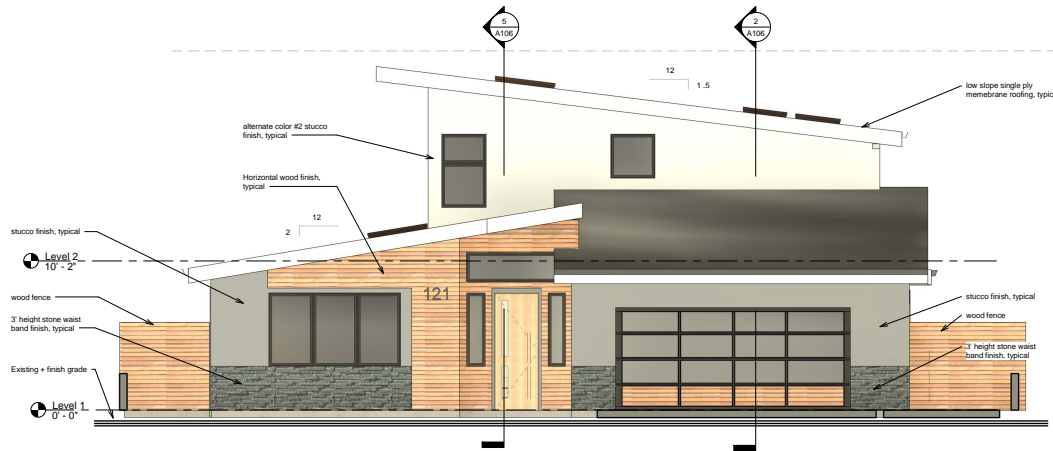
Heck Residence
 121 Cabrillo St
 Capitola CA 95010
 APN 036-185-10

No.	Description	Date

Heck Residence


Site + Roof Plan

Project number	332021
Date	22 August 2022
Drawn by	KU
Checked by	KU
A101	
Scale	As indicated



East Elevation

2 East
1/4" = 1'-0"

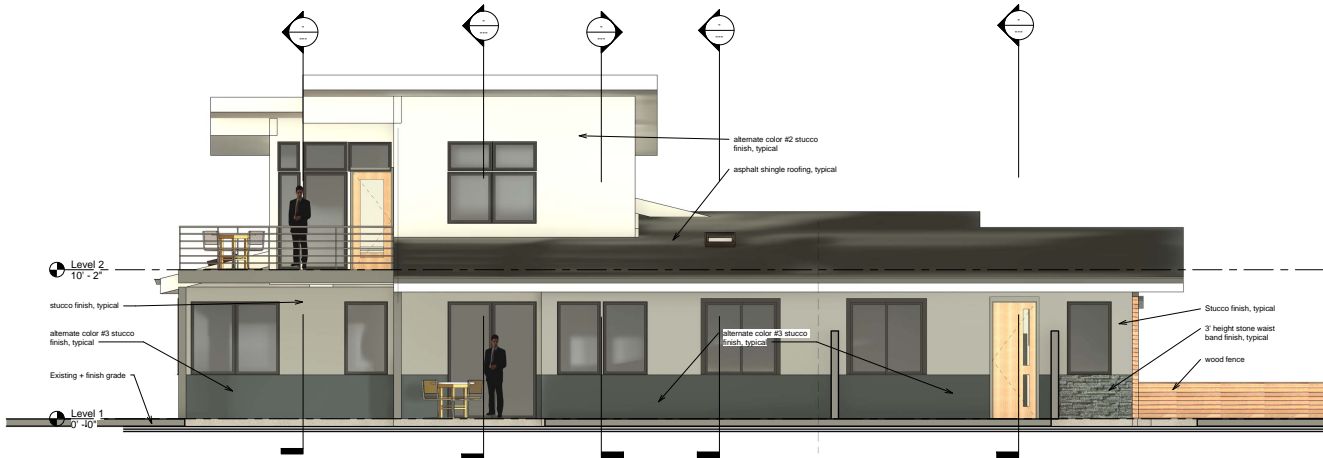

South Elevation

1 South
1/4" = 1'-0"

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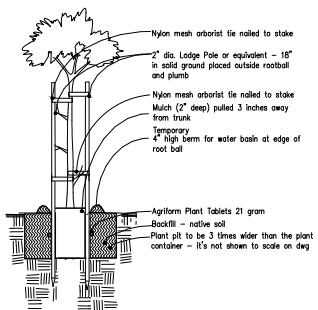
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Heck Residence
 121 Cabrillo St
 Capitola CA 95010
 APN 036-185-10

No.	Description	Date


Heck Residence
 Exterior Elevations

Project number	332021
Date	22 August 2022
Drawn by	KU
Checked by	KU
A104	
Scale	1/4" = 1'-0"




- 1) 8 - 12 hours before installation, water all plants while still in containers sufficiently to thoroughly wet root balls.
- 2) Dig hole at least 3" deeper than the container and 3 times wider than the diameter of the container the plants were delivered in.
- 3) Gauge holes in the side of the plant pit - 2 holes per sq. ft. of wall surface.
- 4) Remove rootball carefully from container with support from below. Sever any circling roots (3/16" dia. or greater) with sharp knife. Do not pull roots apart. The severing of large roots will encourage new roots of the cuts. Install enough backfill under root ball so top of rootball ends up 2" above grade of surrounding soil when it settles. Install some of fertilizer packets under root ball.
- 5) Fill around rootball with backfill mix to 1/2 its height and pack soil as you fill with shovel hands or feet being careful not to disturb root ball.
- 6) Put Agriform Plant Tablet fertilizer at this level adjacent to rootball and at bottom of hole (5 tablets per 15 gal. or 5 tablets per 1 inch of collar width. Fill the remainder of the hole with backfill and pack it.
- 7) Water tree thoroughly by filling the basin and allowing the water to percolate in, doing this 3 times or more until root ball and backfill is wet.
- 8) Install stakes such that the stakes and the tree ties won't damage the tree and the stakes won't lean toward each other. Cut off tops of stakes if necessary to lower below branches that could be rubbed by stakes. Install stakes so they are straight up and don't lean in to each other.

Tree Planting
No Scale

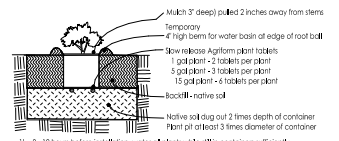

- 1) 8 - 12 hours before installation, water all plants while still in containers sufficiently to thoroughly wet root balls.
- 2) Dig the plant hole at least 3 times the dia. and 2 times the depth of the plant container.
- 3) Replace this mulch in bottom of hole and walk on it. The level of it should be such that when the plant is installed and settled it will be slightly above grade of existing soil. Fill hole with water.
- 4) Remove rootball carefully from container by tapping out, not pulling out by the stem. Scuff rootball walls in 3 vertical cuts and bottom to 1/2" deep, or by cutting roots of 1/2" or larger with shears. Do not pull roots apart.
- 5) Install fertilizer packets under rootball of plant. Set rootball on prepared surface and fill hole to 1/2 the depth, tamping soil around rootball. Fill hole with water.
- 6) Fill the remainder of the hole with backfill and pack it but do not tamper rootball.
- 7) Make the water basin.
- 8) Water shrub thoroughly within 1 hour of planting by filling the basin and allowing the water to percolate in, doing this 3 times or more until root ball and backfill is wet.
- 9) Install mulch.

Shrub Planting
No Scale

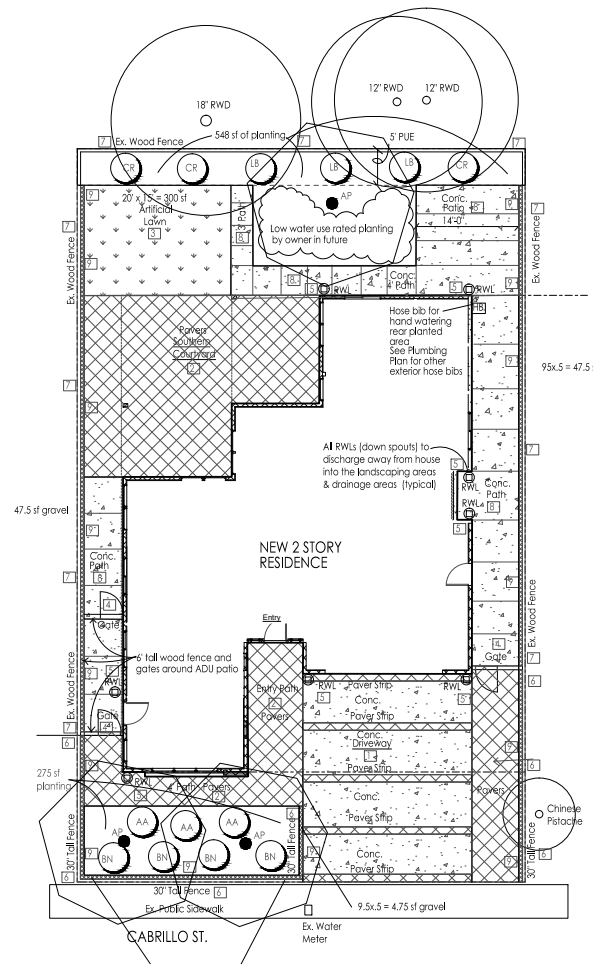

Landscape Plan & Tree Canopy Coverage
Lot Size is 6003 sf

1/8" = 1'-0"
0' 8' 16'

Landscape Site Legend

- 1) Driveway - Poured in place concrete, natural color, with 12 inch wide strips of interlocking conc. pavers or just all concrete.
- 2) Paths and Patios - Interlocking conc. pavers or poured in place concrete - brand, pattern, and color to be selected by owner - one option is Cobble Mission, gray, charcoal, tan.
- 3) Artificial Lawn
- 4) 3 wide x 6' tall wood gate and fence with horiz. 1x4s
- 5) Down spouts (rain water leaders RWL) locations
- 6) 30 inch tall wood fence with horiz. 1x4 or 1x6 stained to match wood on house
- 7) Existing solid wood fence to remain
- 8) Poured in place conc. paving - color and finish to be selected by owner
- 9) 6 inch wide gravel border with 2" to 1-1/2" Napa rounded gravel 3 inches deep

Plant Palette

KEY	QTY	SIZE	BOTANICAL NAME	COMMON NAME	WUCOLS RATING
TREES					
AP	3	15'	Acer palmatum, Coryla Berr, or Sango Kaku	Red Japanese Maple, Condition-Muscle	MED
SHRUBS					
CR	3	5'	Cycas revoluta	Sago Palm	MED
GROUND COVERS					
LB	3	1'	Lomandra Breeze		LOW
BN	4	1'	Bergia hirtans	Queens Tears	LOW
AA	3	5'	Agave attenuata Ray of Light	Varegated Agave	LOW

Tree Canopy Coverage

Total Parcel Area = 6003 sf
15% required
Min. canopy coverage required .15 x 6003 = 900.45 sf

Front Yard Japanese Maples
20' dia. mature canopy = 314 sf each
2 x 314 sf = 628 sf

Rear Yard Japanese Maple
1 x 314 sf = 314 sf

Total canopy coverage = 942 sf
942/6003 = 15.7%

Landscape Notes

- 1) There is 823 sf of Planting and Irrigation (Soquel Creek Water District Tier I). The plants will be hand watered with a hose bib and hose so no Irrigation Plan is being provided.
- 2) There is 300 sf of Artificial Lawn (rear yard) that is considered pervious.
- 3) There is 115 sf of 6" wide gravel strip that is pervious.

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THIS MAP WAS PREPARED BY ME OR UNDER MY DIRECTION AT THE REQUEST OF CHRIS HECK IN FEBRUARY, 2022

LS 8431

ADAM S. RIVERA PLS 8431

DRN	JRC	DATE	02/07/22
CHK	KB	JOB#	500
PK	ASR		

HOGAN LAND SERVICES
A CALIFORNIA CORPORATION


200141ST AVENUE SUITE B
SOCIEL, CA 95073
TEL: (925) 425-1874
WWW.HOGANLANDSERVICES.COM

TOPOGRAPHIC SITE PLAN

121 CABRILLO STREET
CAPITOLA, CALIFORNIA

APN: 036-185-10

1 OF 1

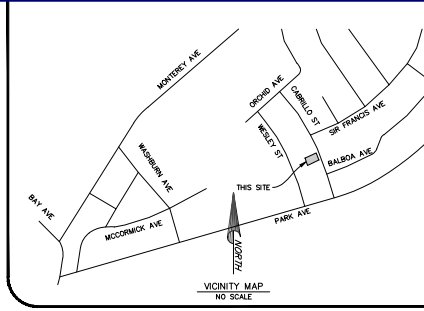

LEGEND



- RECORD BOUNDARY LINE
- - - RECORD ADJOINING BOUNDARY LINE
- - - RECORD EASEMENT LINE
- TIE LINE
- EDGE OF CONCRETE
- EDGE OF ASPHALT CONCRETE
- EDGE OF BUILDING
- WOOD FENCE
- OH --- OVERHEAD WIRE
- MINOR CONTOUR
- MAJOR CONTOUR
- 12" CUP
- STORM-DRAIN W/SIZE & TYPE
- ASPHALT CONCRETE SURFACE
- CONCRETE SURFACE
- SLATE/PANERS SURFACE
- BRICK SURFACE

SYMBOLS

- 143.2 SPOT ELEVATION
- ☉ POWER POLE W/ GUY ANCHOR
- ⊞ ELECTRIC METER
- ⊞ WATER METER
- ⊞ HOSE BIB
- ⊞ GAS METER
- ⊞ SEWER CLEAN OUT
- ⊞ ROOF DOWNSPOUT
- ⊞ MAIL BOX
- ⊞ FOUND 1/2" IRON PIPE, NO TAG
- ⊞ RANDOM CONTROL POINT W/#

ABBREVIATIONS

- ABS ACRYLONITRILE BUTADIENE STYRENE
- IG INVERT GRADE
- FF FINISHED FLOOR
- FS FINISHED SLAB

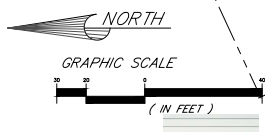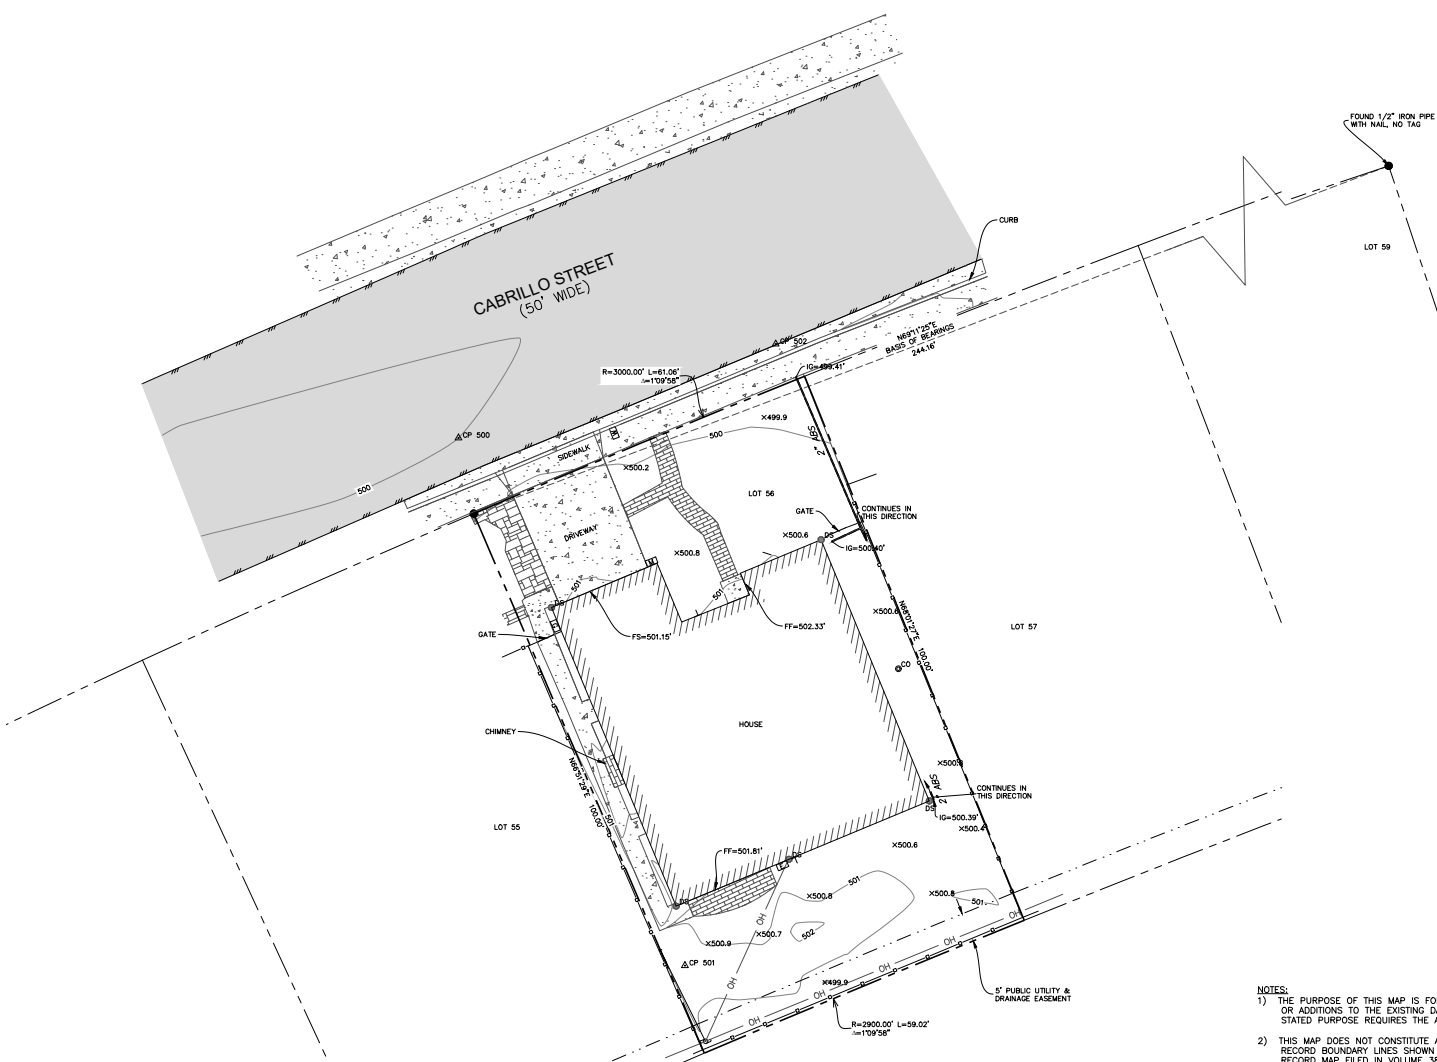

- NOTES:**
- THE PURPOSE OF THIS MAP IS FOR DESIGN AND THE CONTENT IS RELATIVE TO THE INTENDED USE. UNAUTHORIZED CHANGES OR ADDITIONS TO THE EXISTING DATA SHOWN ON THIS MAP IS STRICTLY PROHIBITED. ANY USES OF THIS MAP BEYOND THE STATED PURPOSE REQUIRES THE AUTHORIZATION OF HOGAN LAND SERVICES.
 - THIS MAP DOES NOT CONSTITUTE A BOUNDARY DETERMINATION BY THIS SURVEYOR. RECORD BOUNDARY LINES SHOWN ARE BASED ON EVIDENCE FOUND AS SHOWN FROM THE RECORD MAP FILED IN VOLUME 38 AT PAGE 27, SANTA CRUZ COUNTY RECORDS.
 - HORIZONTAL CONTROL:
BETWEEN A 1/2" IRON PIPE FOUND ON THE NORTHEASTERN BOUNDARY OF LOT 56 AND A 1/2" IRON PIPE ON THE NORTHEASTERN BOUNDARY OF LOT 59 AS SHOWN ON 38M27 (N69°11'25"E)
 - VERTICAL CONTROL:
ELEVATION DATUM IS ASSUMED OVER CP 500 (500.00 FEET)