# ABBREVIATIONS

HOSE BIB

&	AND	H.B.	HOSE BIB
L, A	ANGLE	HDR.	HEADER
@	AT	HDWR. HORIZ. HT., H.	HARDWARE
*	DEGREE	HORIZ.	HORIZONTAL
		HT., H.	HEIGHT
A.B.	ANCHOR BOLT	I.D.	INSIDE DIAMETER
(A)	ABOVE	IN.	INCH(ES)
A.C.I.	AMERICAN		
	CONCRETE	INSUL.	INSULATION
	INSTITUE	INT.	INTERIOR
ADJ.	ADJACENT	JT.	JOINT
A.F.F.	ABOVE FINISH	K.P.	KING POST
A.F.F.		L.	LENGTH
	FLOOR	LIN.	LINEAR
A.I.S.C.	AMERICAN INSTITUE	LIIN.	
	OF STEEL CONSTRUCTION	MAX.	MAXIMUM
ALT.	ALTERNATE	M.B.	MACHINE BOLT
ALUM.	ALUMINUM	MEMB.	MEMBRANE
APPROX.	APPROXIMATELY	MFR.	MANUFACTURER
ARCH.		MIN.	MINIMUM
	ARCHITECTURAL	MISC.	MISCELLANEOUS
A.S.T.M.	AMERICAN SOCIETY	MTL.	
	OF TESTING MATERIALS		METAL
(B)	BELOW	MW.	MICROWAVE
BD.	BOARD	N.	NORTH
BLDG.	BUILDING	(N)	NEW
BLDG.		N.T.S.	NOT TO SCALE
BLKG.	BLOCKING	0/	OVER
BM.	BEAM	O.C.	
B.N.	BOUNDARY NAILING	O.C.	ON CENTER
B.O.	BOTTOM OF	O.D.	OUTSIDE DIAMETER
BOT.,	BOTTOM	O.H.	OPPOSITE HAND
BOTT.		OV.	OVEN
BTWN.	BETWEEN	N.I.C.	NOT IN CONTRACT
		PL.	PLATE
CAB.	CABINET	PLYWD.	
C.B.	CEILING BEAM		PLYWOOD
C.J.	CEILING JOIST	PKG.	PARKING
CLG.	CELLING	P.S.F.	POUNDS PER
CLR.	CLEAR		SQUARE FOOT
COL.	COLUMN	P.S.I.	POUNDS PER
			SQUARE INCH
CONC.	CONCRETE	QTY.	QUANTITY
CONT.	CONTINUOS	RAD.	
CTR.	CENTER		RADIUS
CL	CENTERLINE	R.B.	ROOF BEAM
Db	BAR DIAMETER	RCP.	REFLECTED
	DOUBLE		CEILING PLAN
DBL.	DOUBLE	RE:	REFERENCE
DEG.	DEGREE		
DEMO.	DEMOLISH DETAIL	REF.	REFRIGERATOR
DET., DTL.	DETAIL	REINF.	REINFORCED
D.W.	DISHWASHER	REQ'D.	REQUIRED
DWG.	DRAWING	RM.	ROOM
	DOWN	R.O.	ROUGH OPENING
DWN.,	DOWN	R.R.	ROOF RAFTER
DN.		SCHED.	
(E)	EXISTING		SCHEDULE
EA.	EACH	SF.,	SQUARE FOOT
E.N.	EDGE NAILING	SQ. FT.	
EL	ELEVATION	SHTG.	SHEATHING
ELEV.	LLLTTMOTT	SHT.	SHEET
ELEV.	FLEVATOR	SIM.	SIMILAR
	ELEVATOR	SL.	SLOPED
ENG.	ENGINEER	SL.	
EQ.	EQUAL	SPKL.	SPRINKLER
EXT.	EXTERIOR	SQ.	SQUARE
E.W.	EACH WAY	STAGG.	STAGGER
F.B.	FLOOR BEAM	STD.	STANDARD
F.F.	FINISHED FLOOR	STL.	STEEL
FIN.		STR.,	STRUCTURAL
	FINISH(ED)		
F.J.	FLOOR JOIST	STRUCT.	
FL.	FLUSH	T&B	TOP & BOTTOM
FLR.	FLOOR	T&G	TONGUE & GROOT
F.N.	FIELD NAILING	THK.	THICK
F.N.	FOUNDATION	T.O.	TOP OF
F.O.	FACE OF	T.P.	TOILET PAPER
FP.	FIREPLACE	TYP.	TYPICAL
F.R.	FIRE RATED	U.B.C.	UNIFORM BUILDING
FT.	FOOT OR FEET		CODE
FTG.	FOOTING	VERT.	VERTICAL
FZR.	FREEZER	W.	WIDTH
		WD.	
GA.	GAUGE		WOOD
GALV.	GALVANIZED	WH.	WATER HEATER
G.B.	GRADE BEAM		
CLR	CITITION		

GLB.

GYP. BD.,

GLU-LAM BEAM

GYPSUM WALL BOARD

# **GUNDERSGAARD**

REMODEL/ADDITION 520 RIVERVIEW DRIVE CAPITOLA, CA 95010

# VICINITY MAP

# PARCEL MAP



### **CONSULTANTS**

ARCHITECT:	MATSON BRITTON ARCHITECTS
	700 NU DO ANICIFORTE

SANTA CRUZ, CA 95062 PHONE: 831-425-0544

SURVEYOR: HANAGAN LAND SURVEYING, INC 305-C SOQUEL AVE

SANTA CRUZ, CA 95062 831-469-3428

RICHARD IRISH ENGINEERING, INC. CIVIL ENGINEER:

POTRERO ST #42 SANTA CRUZ, CA 95060 (831) 425-3901

# PROJECT INFORMATION

OWNER: TARRA GUNDERSGAARD

520 RIVERVIEW DRIVE CAPITOLA, CA 95010

R-1

A. P. N.:

OCCUPANCY GROUP: R-3 (PER 2019 CBC)

CONSTRUCTION TYPE: V-B (NOT SPRINKLERED)

# PROJECT DESCRIPTION

REMODEL OF EXISTING 2 STORY, 2 BEDROOM 2 BATH RESIDENCE AND

# SHEET INDEX

TITLE SHEET SITE PLAN

70NING:

EXISTING FLOOR PLANS EXISTING ELEVATIONS

PROPOSED FLOOR PLANS PROPOSED ELEVATIONS SURVEY STORM WATER PLAN

## PROJECT CALCULATIONS

PARCEL AREA 2241.4 S.F.

EXISTING AREAS

FIRST FLOOR CONDITIONED 761 S.F. SECOND FLOOR CONDITIONED 416 S.F. TOTAL EXISITING CONDITIONED AREA 1177 S.F.

EXISTING UNCONDITIONED AREAS:

STORAGE ACCESSORY BUILDING 58 S.F. ATTATCHED MECHANICAL 19 S.F. ATTACHED STORAGE CLOSET 12 S.F. COVERED DECKS 125 S.F.

### PROPOSED AREAS

FIRST FLOOR AREA EXISTING TO REMAIN 777 S.F 103 S.F. FIRST FLOOR AREA PROPOSED SECOND FLOOR AREA 419 S.F. 1299 S.F. TOTAL AREA MAIN HOUSE

NOTE: COVERED & UNCOVERED DECKS TO REMAIN

ALLOWABLE F.A.R. = 2241 S.F. X .58 = 1300 S.F. PROPOSED F.A.R.= 1299 S.F. / 2241 S.F. = 49.9%





GUNDERSGAARD RESIDENC \$20 RIVERVIEW CAPITOLA, CA 95010 APN: 03508110



10/14/2022 NH

GUNDERSGAARD

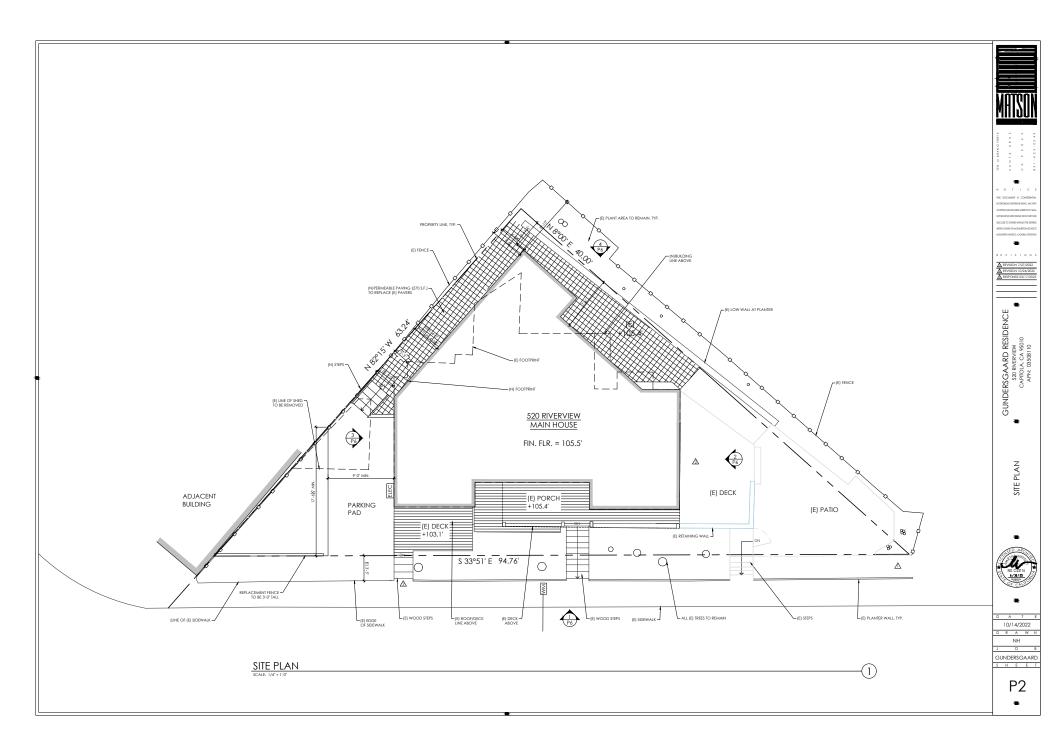

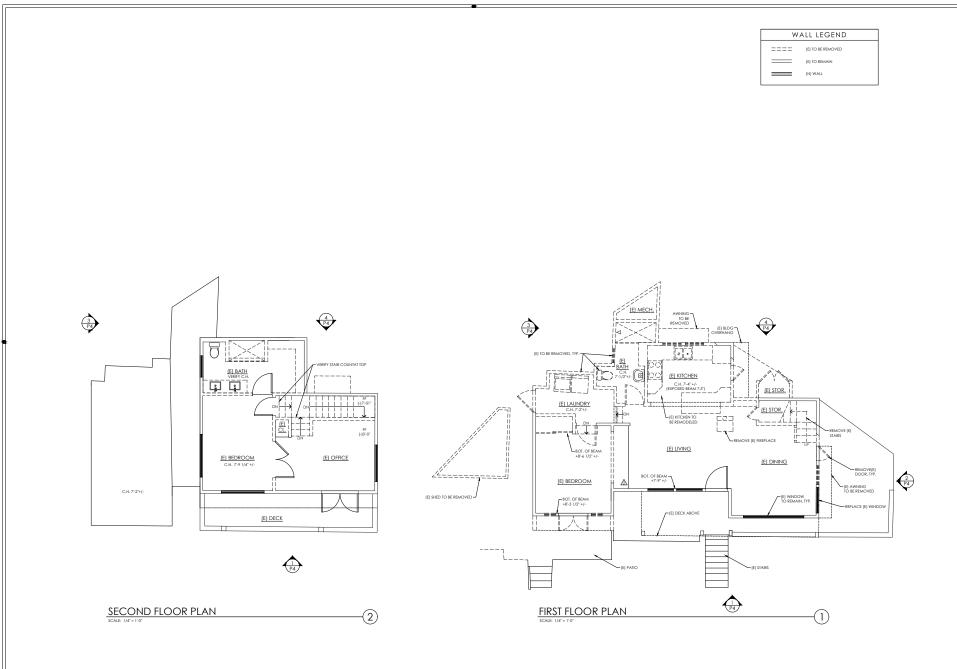



OT I C E

DOCUMENT IS CONFIDENTIAL
BYOGHIG FEOTIBLES BESS, NO 1929.

R E V I S I O N S

A REVISION 1/27/2022

A REVISION 10/24/2022

A RESPONSE 03/17/2023

GUNDERSGAARD RESIDENCE SOD RIVERVIEW CAPITOLA, CA 95010 APN: 03508110

EXISITING FLOOR PLANS



D A T E 10/14/2022 D R A W N NH

GUNDERSGAARD S H E E T

P3



MATSON

A COMPOSITION OF THE COMPOSITION

DECORET FOR THE SENSOR THE EXPRESS

METER CONSIDER OF METER CONSIDERATION ACCRECATION

METER CONSIDERATION ACCRECATION CONTROL OF METER CONTROL

METER CONTROL OF THE CONTR

R E V I S I O N S

AREVISION 7/27/2022

REVISION 10/24/2022

RESPONSE 03/17/2023

A REVISION 10/24/202
A RESPONSE 03/17/20

GUNDERS GAARD RESIDENCE 530 RIVERVIEW CAPITOLA, CA 95010
APN: 03508110


EXISTING ELEVATIONS

NO.0514 NO.0514 N.73/8

D A T E 10/14/2022
D R A W N NH J O B

GUNDERSGAARD S H E E T


P4

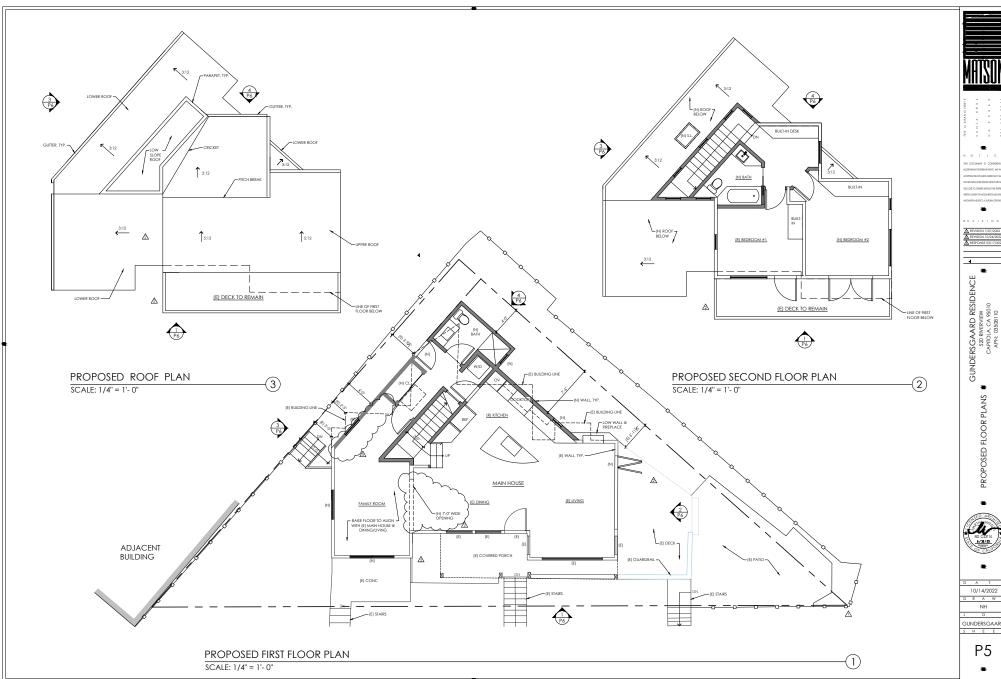




10/14/2022

GUNDERSGAARD

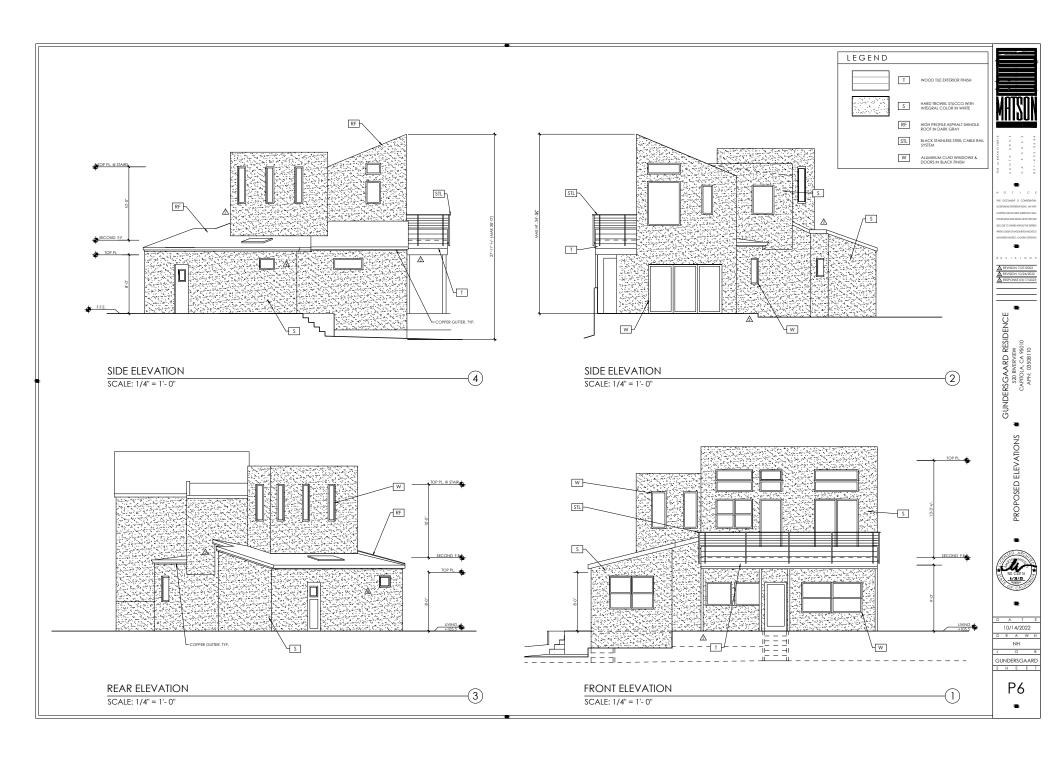

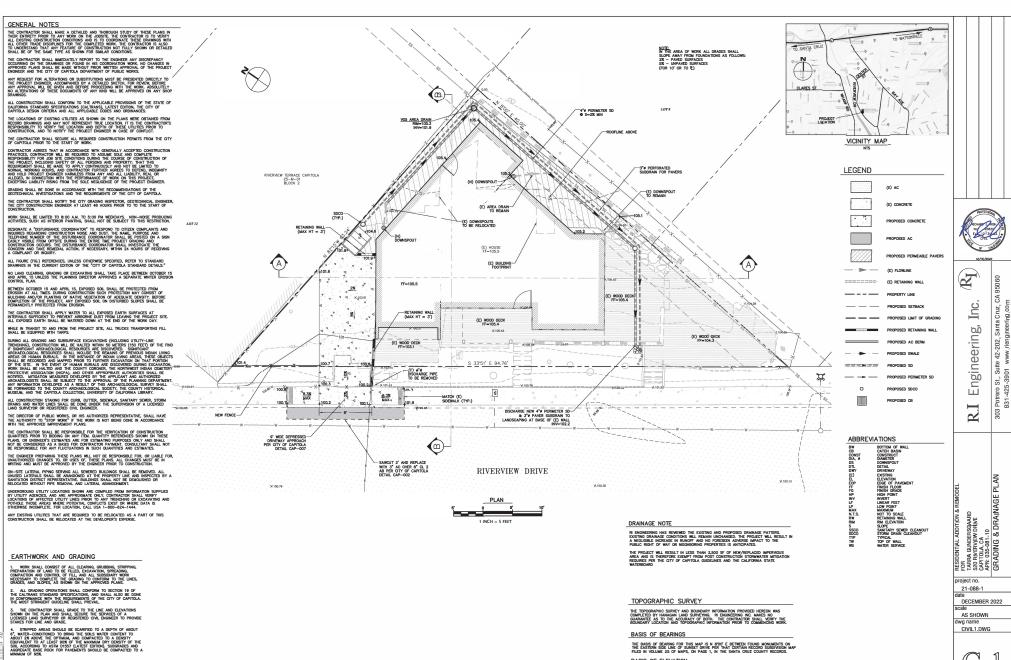


AN ASSUMED ELEVATION OF 100.00 FEET WAS USED ON A SET NAIL IN ASPHALT, AS SHOWN ON THIS MAP.


**BUILDING PERMIT SUBMITTAL** 

EXCEEDING 8" IN LOOSE THICKNESS, MOISTURE CONDITION.

COMPACTED TO AT LEAST 90% RELATIVE COMPACTION.

BARE GROUND WITHIN 10' OF FOUNDATIONS SHALL BE SLOPED AWAY 9 5% MINIMUM OR 2% MINIMUM FOR PAVED SURFACES.

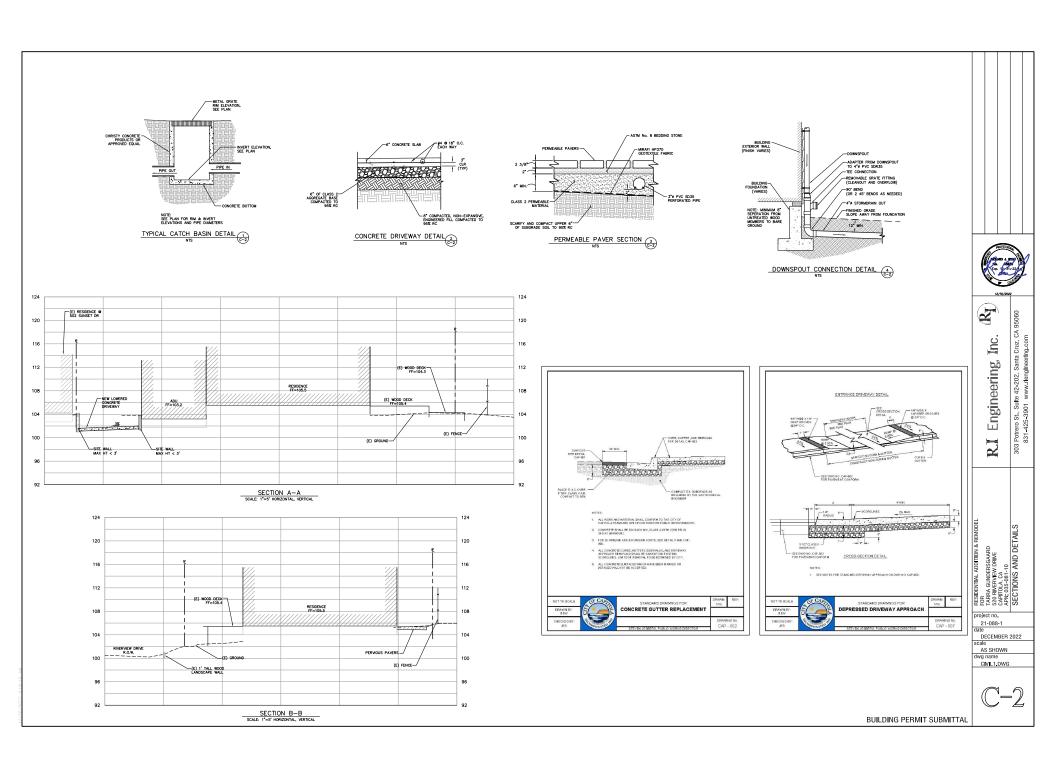

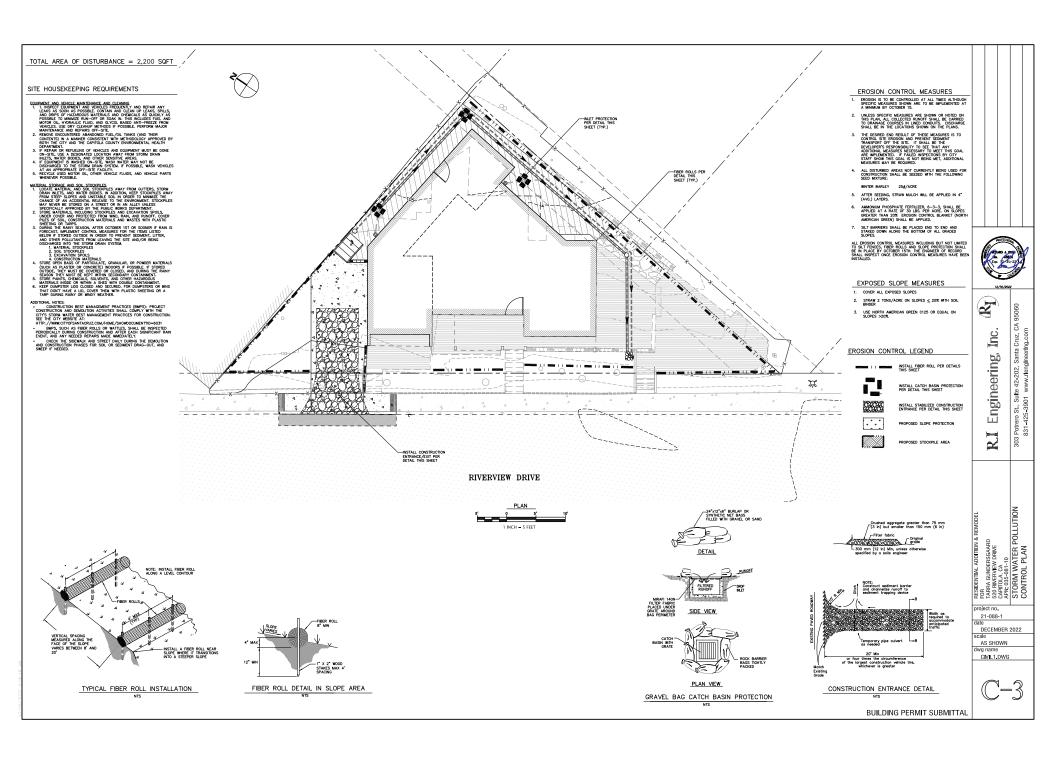

project no. 21-088-1 date MARCH 2023 scale AS SHOWN dwg name CIVIL2.DWG



