## LOCATION MAP



FROM HIGHWAY I, TAKE EXIT #437. TURN RIGHT ONTO BAY AVENUE. TURN RIGHT ON CAPITOLA AVENUE. TURN RIGHT ON RIVERVIEW DR. THEN TURN LEFT ON BLUE GUM AVE. MAKE A SLIGHT RIGHT ONTO RIVERVIEW AVE. ARRIVE AT 427 RIVERVIEW AVE.

#### VICINITY MAP



#### TITLE 24 & GREEN BUILDING

SEE SHEETS A10.3 & A10.4 FOR TITLE 24 COMPLIANCE & MANDATORY MEASURES SEE SHEETS A10.5 & A10.6 FOR CAL GREEN

#### APPLICABLE CODES & REGULATIONS

BUILDING CODE ELECTRICAL CODE MECHANICAL CODE PLUMBING CODE ENERGY CODE FIRE CODE GREEN BUILDING RESIDENTIAL CODE COUNTY CODE

2022 CBC (2022 CALIFORNIA BUILDING CODE, TITLE 24, PT 2)
2022 CEC (2022 CALIFORNIA ELECTRICAL CODE, TITLE 24, PT 3)
2022 CHC (2022 CALIFORNIA MECHANICAL CODE, TITLE 24, PT 4)
2022 CHC (2022 CALIFORNIA MECHANICAL CODE, TITLE 24, PT 4)
2022 CHC (2022 CALIFORNIA PRICE CODE, TITLE 24, PT 5, APPENDIX B 6 C)
2022 CALIFORNIA PRICE CODE, TITLE 24, PT 7, APPENDIX B 8 C)
2022 CALIFORNIA PRICE CODE, TITLE 24, PT 7, APPENDIX B 8 C)
2022 CALIFORNIA PRICE CODE, TITLE 24, PT 10, APPENDIX B 8 C)
2022 CAC (2022 CALIFORNIA PRICE CODE)
2022 CAC (2022 CALIFORNIA PRICE CODE)
2022 CAC (2022 CALIFORNIA PRICE CODE)

### **DEFERRED SUBMITTALS**

SUBMITTAL DOCUMENTS FOR DEFERRED ITEMS SHALL BE SUBMITTED TO THE ARCHITECT OR ENGINEER OF RECORD WHO SHALL REVER THEM AND FORWARD TO THE BUILDING OFFICIAL WITH A NOTATION FOR THE SUBJECT OF THE SUBJECT

THE ENGINEER(S) RESPONSIBLE FOR THE DESIGN OF THE DEFERRED SUBMITTAL ITEMS SHALL STAMP AND SIGN THOSE DRAWINGS AND CALCULATIONS FOR WHICH HEISHE IS RESPONSIBLE.

ITEMS TO HAVE DEFERRED SUBMITTAL INCLUDE:

JOB COPIES OF THE BUILDING & FIRE SYSTEMS PLANS & PERMITS MUST BE ON-SITE DURING INSPECTIONS.

#### FIRE NOTES

1. THESE PANG ARE IN COMPANIES WITH CALLIONNA BUILDING AND FIRE CODES (2019 EDITION)
AND TREL COSE, BED ERREY TH AWAY SHOULD.

2. SHOEL ALARMS SHALL BE INTRALED ACCORDING TO THE FOLLOWING MINIMUM REQUIREMENTS:

ONE ALARM SHALL BE INTRALED. ACCORDING TO THE FOLLOWING MINIMUM REQUIREMENTS:

ONE ALARM SHE SHOT SHEPPING ROOM
ONE AT THE TOP OF SHEAT SHAWAYOF OF 2"F RISE OR GREATER AND IN AN ACCESSIBLE

#### ........

A		М	
AFF	ABOVE FINISHED FLOOR	MAX	MAXIMUM
AL	ALUMINUM	MFD MFR	MANUFACTURED MANUFACTURER
ALT	ALTERNATE	MECH	MANUFACTURES MECHANICAL
APPL	APPLIANCE	MIN	MINIMUM
ARCH AUTO	ARCHITECT(URAL) AUTOMATIC	MISC	MISCELLANEOUS
AUTO AVG	AVERAGE	MLWK	MILLWORK
8	AND	MTD	MOUNTED
В	And	N	
		NIC	NOT IN CONTRACT
BTWN	BETWEEN	NO.	NUMBER
BLDG	BUILDING	NTS	NOT TO SCALE
BD	BOARD	(N)	NEW
BM BLKG	BEAM BLOCKING	Ö	
	BLOCKING	_	
С		OVFL	OVERFLOW
CPT	CARPET	OVHD	OVERHEAD
CEM	CEMENT(ITIOUS)	OPNG	OPENING(S)
CLG	CEILING	P	
CONC	CONCRETE	PBD	PARTICLE BOARD
CONST	CONSTRUCTION	PNL	PANEL
CONT	CONTINUOUS(ATION)	POB	POINT OF BEGINNING
CMU	CONCRETE MASONRY UNIT	PREFIN	PREFINISHED
D		PREFAB	PREFABRICATED
DBL	DOUBLE	PLAM	PLASTIC LAMINATE
DEPT	DEPARTMENT	PLYWD	PLYWOOD
DET	DETAIL	_	
DF	DRINKING FOUNTAIN	R	
DIA	DIAMETER	RECES	RECESSED
DIFF	DIFFUSER	REF	RECESSED REFERIENCE)
DIM	DIMENSION	REFL	REFLECTED
DISP	DISPENSER	REGS	REGULATIONS
DIV	DIVISION	RM	ROOM
DN	DOWN	REQD	REQUIRED
\$ DR	DOLLAR (US CURRENCY) DOOR	REQD	REQUIRED
DWR.	DRAWER	(R)	RELOCATED
E	DKAWEK	S	
ELEC	ELECTRICAL	SEC	SECURITY
ENGR	ENGINEER(ED)	SF	SQUARE FEET
ENTR.	ENTRANCE	SIM	SMILAR
EQ	EQUAL	T22 GTD	STAINLESS STEEL STANDARD
EQUIP	EQUIPMENT	STD	STANDARD STEEL
EXIST	EXISTING EXTERIOR	STRUCT	STRUCTURAL
EXT (E)	EXTERIOR EXISTING	SUSP	SUSPENDED
F	Destined	Т	
•			
FAB	FABRICATION	TRTD	TREATED
FD	FLOOR DRAIN	TBG	TONGUE AND GROOVE
FE	FIRE EXTINGUISHER FIRE EXTINGUISHER AND	TYP	TYPICAL TEMPERED GLASS
FEC	CABINET CABINET		LEMPERED GLASS
FHC	FIRE HOSE CABINET	U	
FIN	FINISH	UTIL	UTILITY
FR	FIRE RAT(ING)(ED)	UON	UNLESS OTHERWISE NOTED
FRM	FRAME	V	UNLESS OTHER MISE MOTEO
FRMG	FRAMING	_	
FLR	FLOOR(ING)	VERT	VERTICAL
FURN	FURNITURE	VIF	VERIFY IN FIELD
FWC	FABRIC WALL COVERING	W	
_		W/	WITH
G		WC.	WATER CLOSET
GA	GAUGE	WD	WOOD
	GENERAL CONTRACTOR	W/O	WITHOUT
		WT	WEIGHT
GC	GLASS FIBER REINFORCED CONCRETE		
GC GFRC	GLASS FIBER REINFORCED CONCRETE		
GC GFRC GFRG	GLASS FIBER REINFORCED GYPSUM		
GC GFRC GFRG GFRP	GLASS FIBER REINFORCED GYPSUM GLASS FIBER REINFORCED PLASTER		
GC GFRC GFRG GFRP GL	GLASS FIBER REINFORCED GYPSUM GLASS FIBER REINFORCED PLASTER GLASS		
GC GFRC GFRG GFRP GL	GLASS FIBER REINFORCED GYPSUM GLASS FIBER REINFORCED PLASTER		
GC GFRC GFRG GFRP GL	GLASS FIBER REINFORCED GYPSUM GLASS FIBER REINFORCED PLASTER GLASS		
GC GFRC GFRG GFRP GL GYP	GLASS FIBER REINFORCED GYPSUM GLASS FIBER REINFORCED PLASTER GLASS		
GC GFRC GFRG GFRP GL GYP	GLASS PIBER REINFORCED GYPSUM GLASS PIBER REINFORCED PLASTER GLASS GYPSUM		
GC GFRC GFRG GFRP GL GYP HD	GLASS FIBER REINFORCED CYPSUM GLASS FIBER REINFORCED PLASTER GLASS GYPSUM HEAD		
GC GFRC GFRG GFRP GL GYP HD HD HDWE	GLASS PIBER REINFORCED CITISUM GLASS PIBER REINFORCED PLASTER GLASS CITISUM  HEAD HARDWARE		
GC GFRC GFRG GFRP GL GYP HD HD HDWE HGT	GLASS FIBER REINFORCED CYPSUM GLASS FIBER REINFORCED PLASTER GLASS GYPSUM HEAD		
GC GFRC GFRG GFRP GL GYP HD HD HDWE HGT HM	GLASS FIRST REPRODUCTO CITISUM GLASS FIRST REPRODUCTO PLASTER GLASS FIRST REPRODUCTO PLASTER GYPSUM MEAD MADOWARE HEIGHT HOLDOW WITHAL HOLEDOMTAL		
GC GFRC GFRG GFRP GL GYP HD HD HD HD HGT HM HORIZ	GLASS FIRST REMODECED CYPSUM GLASS FIRST REMODECED MASTER GLASS GYPSUM  MEAD  MEAD  MEAD  MEAD  MEAD  MEADOWNEE  HEIGHT  MOLICOWNEE  HOLICOWNEE  HEIGHT  HEIGH		
GC GFRC GFRR GFRR GL GYP H H H H H H H H H H H H H H H H H H H	GLASS FIRST REPRODUCTO CITISUM GLASS FIRST REPRODUCTO PLASTER GLASS FIRST REPRODUCTO PLASTER GYPSUM MEAD MADOWARE HEIGHT HOLDOW WITHAL HOLEDOMTAL		
GC GFRC GFRR GFRR GL GYP HD HD HD HD HGT HM HORIZ HVAC	CALS THE MENDOLIC OF PRINT CALS THE MENDOLIC PRINTE CHAST OFFICH  HAD  MADOWAE HEDO  MOLOW METAL HOLLOWITH AL HOLLOWITH AL AGE CONDITIONNE		
GC GFRC GFRG GFRP GL GYP HD HD HDWE HGT HM HORIZ HVAC	CAST SIES EMPORACIO CHIUNI CAST SIES EMPORACIO CHIUNI CASTO COTUNI  NELO MARCHIMI MOLOVIMI MOLOVIMI MATTINI MOLOVIMI MATTINI MOLOVIMI MATTINI		
GC GFRC GFRG GFRP GL GYP HD HDWE HGT HM HORIZ HVAC I	CALS THE REMODELD PRATE GASS GENERAL STATE GASS HEAD HEAD HEAD HEAD HEAD HEAD HEAD HEAD		
GC GFRC GFRG GFRP GL GYP HD HD HDWE HGT HM HORIZ HVAC	CAST SIES EMPORACIO CHIUNI CAST SIES EMPORACIO CHIUNI CASTO COTUNI  NELO MARCHIMI MOLOVIMI MOLOVIMI MATTINI MOLOVIMI MATTINI MOLOVIMI MATTINI		
GC GFRC GFRG GFRP GL GYP HD HD HD HD HORIZ HVAC INSUL INT	CALS THE REMODELD PRATE GASS GENERAL STATE GASS HEAD HEAD HEAD HEAD HEAD HEAD HEAD HEAD		
GC GFRC GFRG GFRP GL GYP HD HDWE HGT HM HORIZ HVAC I	CALS THE REMODELD PRATE GASS GENERAL STATE GASS HEAD HEAD HEAD HEAD HEAD HEAD HEAD HEAD		
GGC GGRRC GGRRG GGRR GL GGYP HD HD HHD HHOME HHORIZ HIVAC I	CALS THE REMODELD FROM  GASS THE REMODELD FASTER  GASS  GEFUR  HEAD  HEAD  HEAD  HADWARE  HEBOT  HOURWHITEL  HOURWHITEL  HERTING, WORLAND, AND  HAT CONDITIONING  ROBANTON  MORANTON  MORANTON  MORANTON  MORANTON  MORANTON		

#### PROJECT DESCRIPTION

RENOVATION OF EXISTING LEGAL NON-CONFORMING RESIDENCE WHICH INCLUDES 3-BED RM'S., 3-BATHS, LIVING AREA, KITCHEN & (2) ONE CAR GARAGES.

THE PROPOSED RENOVATION WILL HAVE 3-BED RMS, 2.5 BATHS, LIVING AREA, KITCHEN, (1) ONE CAR GARAGE, (1) CARPORT, AND AN CONNECTING BRIDGEHALLWAY TO CONNECT THE PROFIT RESPORTED TO THE BACK RESIDENCE. THE PROPOSED RENOVATION WILL BE AN REDUCTION OF 18 SF. OF FLOOR AREA.

2.695 SF

1119.5 SF

2.553.75 SF \*REDUCTION OF 141.25 SF FROM EXISTING TO PROPOSED

CONTACT INFORMATION

2,583.75 SF - 30 SF (PER 17.48.040(B)(F)) 1,720 - 1,750 = 30 SF

GEOTECHNICAL ENGINEER: ROCK SOLID ENGINEERING, INC. YVETTE M. WILSON, P.E. 1100 MAIN ST., SUITE 'A'

WATSONVILLE, CA 95079 831-724-5868

MEP, TITLE-24, & SOLAR ENGINEER MONTEREY ENERGY GROUP, INC. 26465 CARMEL RANCHO BLVD. SUITE 8 CARMEL, CA 93923 831-372-8328

SURVEYOR: ROPER ENGINEERING JEFF ROPER 48 MAIN AVE. CORRALITOS, CA 95076 831-724-5300

REDUCTION:

TOTAL EXISTING:

TOTAL PROPOSED:

TERRI ROBBINS & JOE MCLEAN 427 RIVERVIEW CAPITOLA, CA 95010

ARCHITECT: FUSE ARCHITECTS, INC. DAN GOMEZ 512 CAPITOLA AVENUE CAPITOLA, CA 95010 831-479-929 WWW.FUSEARCHITECTURE.COM

CIVIL ENGINEER: BOWMAN & WILLIAMS JOEL RICCA 3949 RESEARCH PARK CT, SUITE 100 SOQUEL CA 95073 831-426-3560

STRUCTURAL ENGINEER: REDWOOD ENGINEERING LEONARD WILLIS 1535 SEABRIGHT AVE., SUITE 200

SANTA CRUZ, CA 95062 831-426-8444

PROPOSED FIRST FLOOR:

PARKING REQUIREMENTS:

PROPOSED SECOND FLOOR: 1.464.25 SE

REQUIRED: 3 (Per Table 17.76-2) PROVIDED: 2 - (1) ONE CAR GARAGE & (1) CARPORT

CALCULATION OF REQ'D SPACES (PER 17.76.030):

PROPOSED FAR TOTAL: 2,553.75 CARPORT REDUCTION: -239.25 GARAGE REDUCTION:

THE RENOVATION WILL INCLUIDE NEW EXTERIOR SIDING, METAL SEAM ROOF, DOORS, WINDOWS, INTERIOR LAYOUT, ELEVATOR, EXTERIOR ACCESS STAIRS (TO SECOND FLOOR), & CONNECTING BRIDGEPHALLWAY. SEE		SHE		SHEET NAME	06/20/25	08/18/25	09/4/25	22/52/60		
	PLANS FOR FURTHER SPECIFICS OF THIS PROJECT.		Al		PROJECT INFO	Х	х	х	х	
			A2	$\neg$	SURVEY	х	х	х	х	
	PROIE	CT INFORMATION	A3		EXISTING SITE PLAN	х	х	х	х	
_	,-		A4		PROPOSED SITE PLAN	х	х	х	х	
	APN-	035-132-01	A5		FIRST FLOOR EXISTING/PROPOSED AREA CALCULATIONS	х	х	х	х	
	ZONING:	R-1 (SINGLE-FAMILY RESIDENTIAL)	A6		SECOND FLOOR EXISTING/PROPOSED AREA CALCULATIONS	х	х	х	х	
	CONSTRUCTION TYPE:	VB	A7		FIRST FLOOR DEMOLITION PLAN	х	х	х	х	
	OCCUPANCY CLASSIFICATION		A8		SECOND FLOOR DEMOLITION PLAN	х	х	х	х	
	STORIES:	(2) STORIES	A9		ROOF DEMOLITION PLAN	х	х	х	х	1
			A10		PROPOSED FIRST FLOOR PLAN	х	х	х	х	
	MAX HEIGHT ALLOWED: 25'-0	r	All		PROPOSED SECOND FLOOR PLAN	х	х	х	х	
	MAX HEIGHT EXISTING: 24'-6"		A12		PROPOSED ROOF PLAN	х	х	х	х	
	MAX HEIGHT PROPOSED: 24-6	s" (NO ADJUSTMENTS TO ROOF HEIGHT FROM EXISTING)	AI3		EXISTING/PROPOSED FRONT AND REAR ELEVATIONS	Х	х	х	х	1
	LOT COVERAGE:		AI4		EXISTING/PROPOSED COURTYARD ELEVATIONS	х	х	х	х	
	·		A15		EXISTING/PROPOSED NORTH ELEVATIONS	х	х	х	х	
	LOT AREA:	3,018 SF (.069 ACRES) N/A PER 17 16 030	A16	$\neg$	EXISTING/PROPOSED SOUTH ELEVATIONS	х	Х	Х	х	
	ALLOWED:	N/A PER 17.16.030	A17		PROPOSED BUILDING SECTIONS	х	х	х	х	
			A22		PERSPECTIVE #I	х	х	х	х	
	FLOOR AREA RATIO:		A24	$\neg$	PERSPECTIVE #3	х	х	х	х	
	ALLOWED (57%):	3.018 X .57 = 1.720 SF	A25,	$\sim$	CSOSPOSED-MATERIALS COSPOSIONS	-X/	X	X	X	
	ALLOWED (37%):	3,016 X 37 = 1,720 3F	A26		PERSPECTIVE COMPARISON #1				×	k
	EXISTING FIRST FLOOR:	1,244 SF	A27	$\neg$	PERSPECTIVE COMPARISON #2				х	R
	EXISTING SECOND FLOOR:	1.480.75 SF	A28		PERSPECTIVE COMPARISON #3				х	1)
	EXISTING TOTAL: REDUCTION:	2,725 SF . 30 SF (PER 17 48 040(RMF)) 1 720 . 1 750 = 30 SF	1	$\sim$	DHI DISEAPE PHAIN COUNTY	-X	X	N.	W	T 4

CIVIL

LANDSCAPE LIGHTING SPEC. SHEETS

LANDSCAPE LIGHTING SPEC. SHEETS

SHEET NUMBER	SHEET NAME	
C1.0	GRADING PLAN	×
C2.0	DRAINAGE PLAN	
C2.I	STORMWATER CONTROL PLAN	
C3.0	EROSION CONTROL PLAN	
TI	TOPOGRAPHY SURVEY	
T2	UTILITY PLAN	

FEMA NOTES I. THIS PROJECT WILL COMPLY (ONLY AS IT APPLIES TO THE SCOPE WITHIN THIS PROJECT) WITH THE LOCAL FLOODPLAIN MANAGEMENT REGULATIONS OF CHAPTER 15.20 AND FEDERAL (FEMA) GUIDELINES OF THE NATIONAL FLOOD INSURANCE PROGRAM (FIRIP) FOR FLOODPLAIN DEVELOPMENT.

DRAWING INDEX

ARCHITECTURAL & LANDSCAPE

2. THIS PROJECT WILL PREVENT OR REGULATE THE CONSTRUCTION OF FLOOD BARRIERS WHICH WILL UNNATURALLY DIVERT FLOODWATERS OR WHICH MAY INCREASE FLOOD HAZARDS IN OTHER AREAS.

1. AS REQUIRED THIS PROJECT WILL PROVIDE BREAKAWAY WALL(S) OR BREAKAWAY PORTION OF PROPOSED WALL(S) THAT ARE DESIGNED TO BREAK AWAY LINDER ABNORMALLY HIGH TIDES OR WIVE ACTIONS WOUT CLASING ANY OF THAT OF THE STRUCTURE HISTORY OF THE BUILDING ON WHICH THEY ARE BRING USED OR ANY BUILDINGS TO WHICH THEY MIGHT BE CARRED BY PRODOWNITES.

THESE BREAKAWAY WALLS OR BREAKAWAY PORTIONS OF PROPOSED WALL(S) SHALL HAVE A SAFE THESE BREDADAWAT WALLS OR BREDADAWAT PORTIONS OF PROPOSED WALLED) SHALL HAVE A SHE DESIGN LOADING RESISTANCE OF NOT LESS THAN TEN AND NOR MORE THAN TWENTY POUNDS PER SQUARE FOOT. THESE BREAKAWAY WALLS WILL BE CERTIFIED BY A REGISTERED ENGINEER OR ARCHITECT AND WILL MEET THE FOLLOWING CONDITIONS.

I. BREAKAWAY WALL COLLAPSE SHALL RESULT FROM A WATER LOAD LESS THAN THAT WHICH WOULD OCCUR DURING THE BASE FLOOD;

2. THE ELEVATED PORTION OF THE BUILDING SHALL NOT INCUR ANY STRUCTURAL DAMAGE DUE TO THE EFFECTS OF WIND AND WATER LOADS ACTING SIMULTANEOUSLY IN THE EVENT OF THE BASE RAOD

4.THE GARAGE WILL BE DESIGNED TO ALLOW FOR AUTOMATIC ENTRY OF FLOODWATERS

5. ALL NEW AND REPLACEMENT WATER SUPPLY AND SANITARY SEWAGE SYSTEMS SHALL BE DESINGED TO MINIMIZE OR ELIMINATE

I. INFILTRATION OF FLOODWATERS INTO THE SYSTEMS; AND

2. DISCHARGE FROM THE SYSTEMS INTO FLOODWATERS

## RIVERVIEW

427 RIVERVIEW CAPITOLA, CA 95010



Project Submittal Record Date Issue Description 06/20/2025 | ISSUED | PLANNING REVIEW #1 | ISSUED PLAN | CHECK RESPONSE #1 9/4/2025 ISSUED PLAN CHECK RESPONSE #2 ISSUED PLANNING ADDENDUM #I 9/25/2025

Seal/ Signature



Riverview Residence


APN #: 035-132-01


Sheet Title
PROIECT INFO

As Indicated

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9/25/2025 5:22 PM



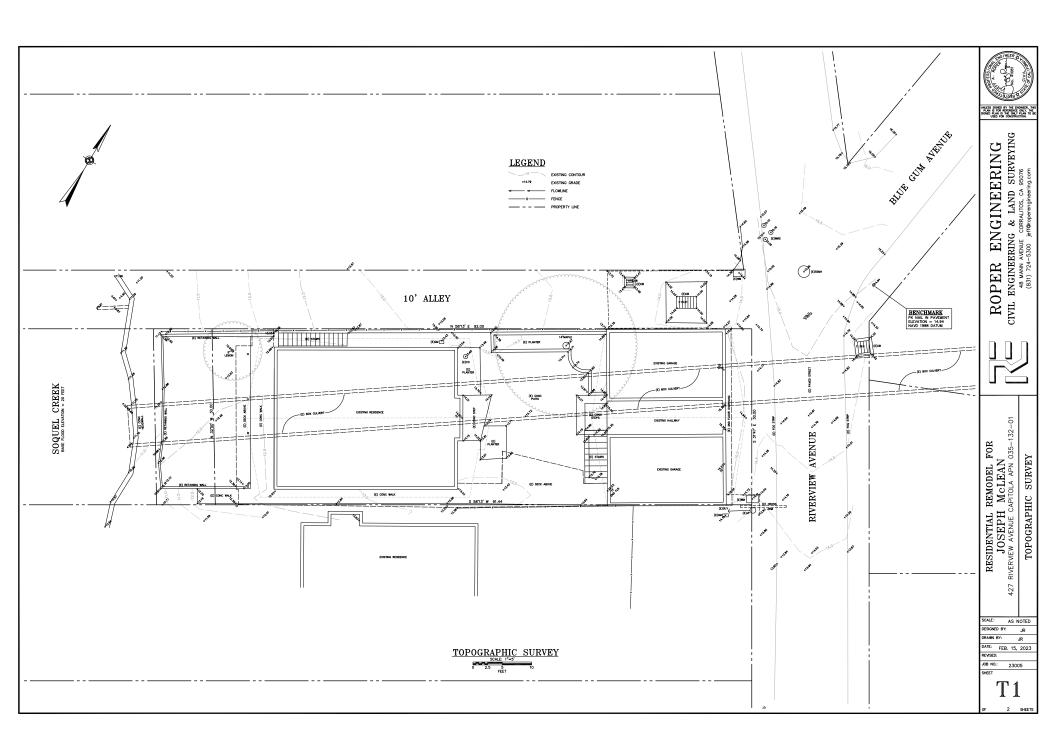
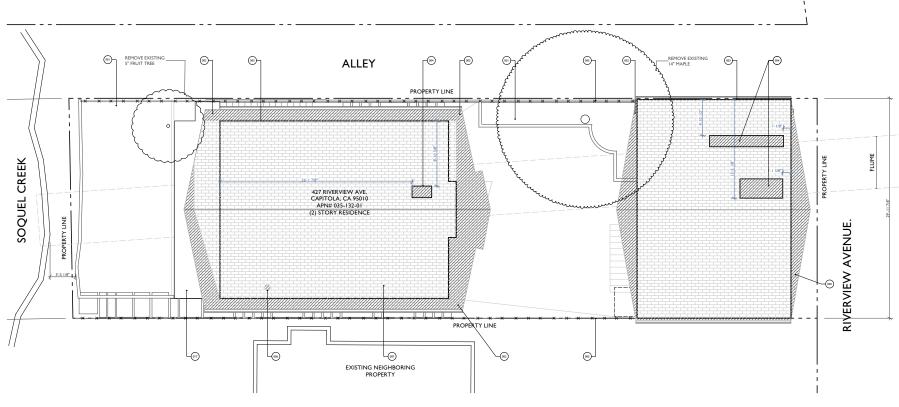
# 9/25/2025 Seal/ Signature



**RIVERVIEW** 427 RIVERVIEW CAPITOLA, CA 95010

architects + builders
512 Capitola Ave + Capitola + California + 95010
fusearchitecture.com 831.479.9295

_	
l .	
Project Name	
Disconsisson Desidence	

Accessor's Parcel Number APN #: 035-132-01

Sheet Title

EXISTING SITE PLAN

Scale As Indicated

**A3** 

**EXISTING SITE PLAN** SCALE: 1/4" = 1'-0"



WINDOW TAG. SEE WINDOW SCHEDULE ON SHEET AS.I

WALL TAG, SEE PARTITION SCHEDULE ON SHEET AS 2

#### **KEY NOTES**

EXISTING HARDSCAPE, PLANTERS, SITE WALLS TO BE DEMOLISHED & REMOVED

PORTION OF EXISTING ROOF EAVE TO BE REMOVED. SEE DEMO ROOF PLAN FOR MORE INFORMATION

DASHED LINE INDICATES EXTERIOR WALLS BELOW

INDICATES PROPOSED SKYLIGHT, G.C TO COORD. CUTOUT WIIN ROOF FOR SKYLIGHT BASED ON REVIEWED/APPROVED WINDOW PACKAGE


EXISTING FENCE TO BE REMOVED

INDICATES LOCATION OF PROPOSED CHIMNEY G.C. TO COORD, CUTOUT FOR FLUE

EXISTING ASPHALT SHINGLED ROOF TO BE REMOVED DOWN TO SUBLAYER

INDICATES UPPDER DECK TO BE REMOVED

×-

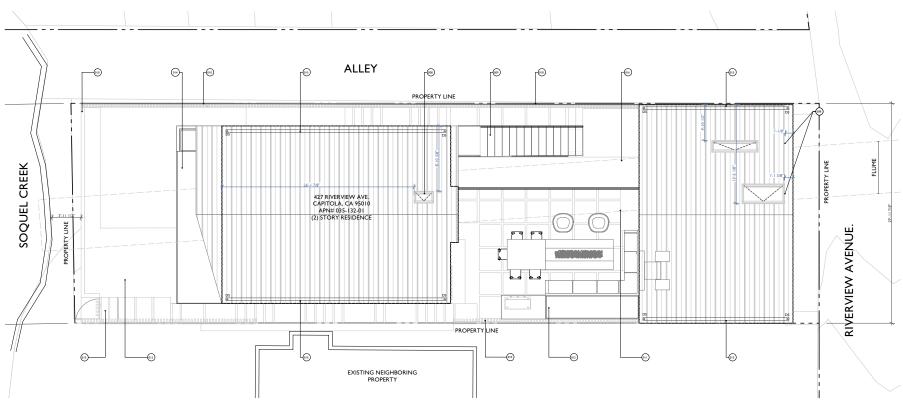

## 9/4/2025 ISSUED PLAN CHECK RESPONSE #2 9/25/2025 ISSUED PLANNING ADDENDUM #I Seal/ Signature



06/20/2025 | ISSUED | PLANNING REVIEW #1 | ISSUED PLAN | CHECK RESPONSE #1

**RIVERVIEW** 427 RIVERVIEW CAPITOLA, CA 95010

architects + builders 512 Capitola Ave + Capitola + California + 95010 fusearchitecture.com 831.479.9295

Project Name
Riverview Residence


Accessor's Parcel Number APN #: 035-132-01

Sheet Title
PROPOSED SITE PLAN

Scale As Indicated

**A4** 

PROPOSED SITE PLAN

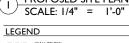

---- WALL BELOW

DETAIL/ SECTION/ ELEVATION NUMBER SHEET NUMBER

★ KEYNOTE TAG

DOOR TAG, SEE DOOR SCHEDULE ON SHEET AS.0 WINDOW TAG, SEE WINDOW SCHEDULE ON SHEET AS.I ×-WALL TAG. SEE PARTITION SCHEDULE ON SHEET AS 2

BUILDING SECTION KEY:

#### **KEY NOTES**

INDICATES NEW SKYLIGHT


INDICATES NEW ACCESS STAIR INDICATES NEW FENCE

INDICATES NEW CONC. PAVERS

INDICATES NEW PLANTER 013 INDICATES NEW ACCESS GATE


INDICATES NEW CANTILEVERED DECK 015 INDICATES INTEGRATED GUTTER

9/25/2025 5:22 PM

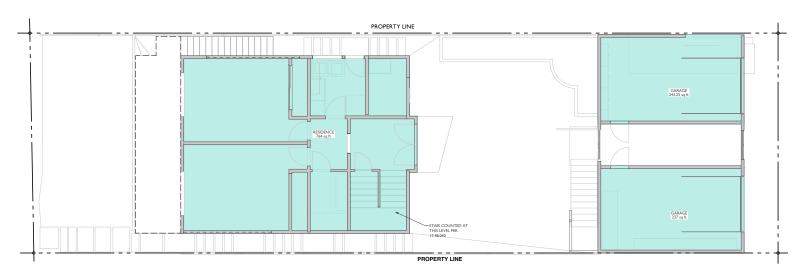

## EXISTING FIRST FLOOR PLAN\_FLOOR AREA

SCALE: 1/4" = 1'-0"

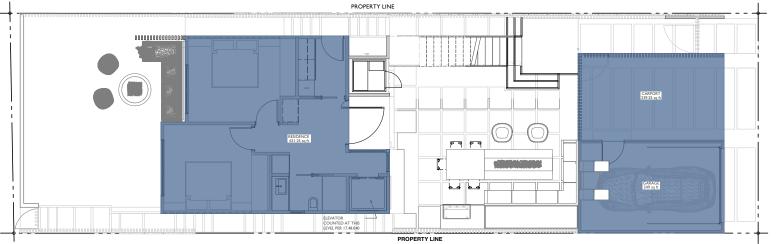

#### PROPOSED FIRST FLOOR PLAN\_FLOOR AREA (2)

SCALE: 1/4" = 1'-0"

**EXISTING FLOOR AREA** 

IST FLR. -FLOOR AREA: 1,244 SF 2ND FLR. - FLOOR AREA: 1,480.75 SF TOTAL FLOOR AREA= 2,725 SF

PROPOSED FLOOR AREA

IST FLR. -FLOOR AREA: 1,119.5 SF 2ND FLR. - FLOOR AREA: 1,464.25 SF TOTAL FLOOR AREA= 2,583.75 SF

## RIVERVIEW

427 RIVERVIEW CAPITOLA, CA 95010



9/25/2025


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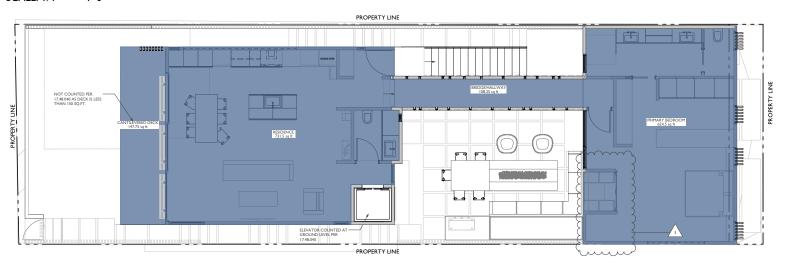
Accessor's Parcel Number APN #: 035-132-01

Sheet Title
FIRST FLOOR EXISTING/
PROPOSED AREA
CALCULATIONS
Scale
As Indicated

**A5** 



EXISTING SECOND FLOOR PLAN\_FLOOR AREA SCALE: 1/4" = 1'-0"

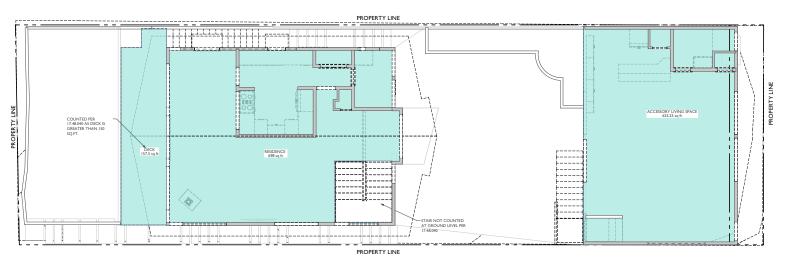

2 PROPOSED SECOND FLOOR PLAN\_FLOOR AREA SCALE: I/4" = I'-0"

**EXISTING FLOOR AREA** 

IST FLR. -FLOOR AREA: 1.244 SF 2ND FLR. - FLOOR AREA: 1,480.75 SF TOTAL FLOOR AREA= 2,725 SF

PROPOSED FLOOR AREA

IST FLR. -FLOOR AREA: 1,119.5 SF 2ND FLR. - FLOOR AREA: 1,464.25 SF TOTAL FLOOR AREA= 2,583.75 SF

## RIVERVIEW

427 RIVERVIEW CAPITOLA, CA 95010



9/25/2025


Seal/ Signature




Accessor's Parcel Number APN #: 035-132-01

Sheet Title
SECOND FLOOR EXISTING/
PROPOSED AREA
CALCULATIONS
Scale
As Indicated

**A6** 

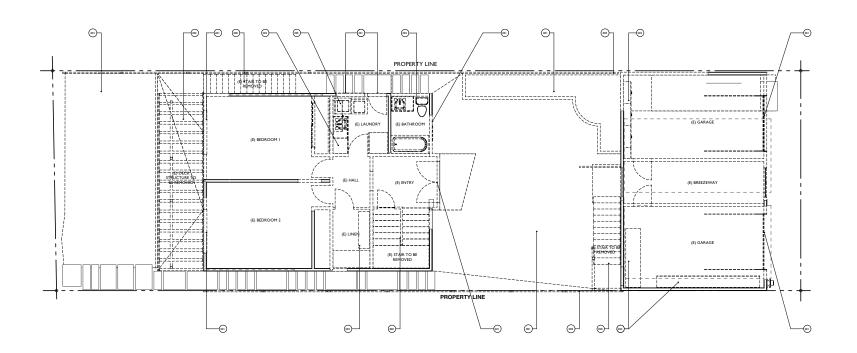

### EXISTING/DEMOLITION FIRST FLOOR PLAN SCALE: 1/4" = 1'-0"

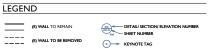







#### **KEY NOTES**

EXISTING HARDSCAPE, PLANTERS, SITE WALLS TO BE DEMOLISHED & REMOVED

EXISTING STAIR TO BE DEMOLISHED & REMOVED

EXISTIING OPENING TO BE DEMOLISHED, & REMOVED, INFILLED OR REPLACED, G.C TO COORD.

202 EXISTING DECK TO BE DEMOLISHED & REMOVED

EXISTING PLUMBING FIXTURES TO BE DEMOLISHED & REMOVED, SEE PROPOSED PLANS FOR LOCATION OF NEW PLUMBING

EXISTING APPLIANCES TO BE DEMOLISHED & REMOVED

### **RIVERVIEW**

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Revision	Date	Issue Description
0	06/20/2025	ISSUED
U	06/20/2025	PLANNING REVIEW #
- 1	08/18/2025	ISSUED PLAN
	00/10/2023	CHECK RESPONSE #
	9/4/2025	ISSUED PLAN
2	9/4/2025	CHECK RESPONSE #3
		ISSUED PLANNING
3	9/25/2025	ADDENDUM #I

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Project Name
Riverview Residence

Accessor's Parcel Number APN #: 035-132-01

Sheet Title
FIRST FLOOR DEMOLITION PLAN


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**A7** 

9/25/2025 5:23 PM

## **RIVERVIEW** 427 RIVERVIEW CAPITOLA, CA 95010



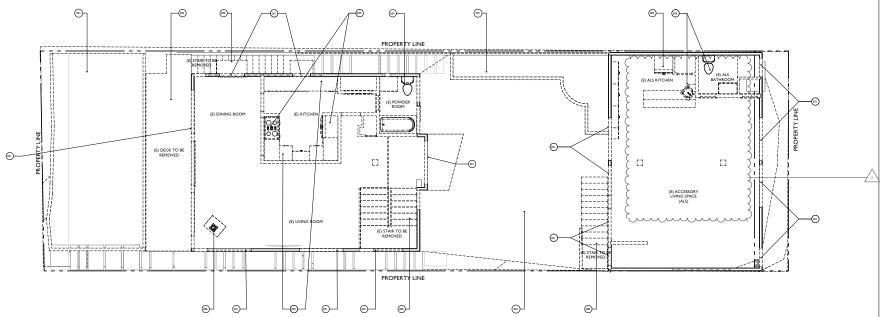

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SECOND FLOOR DEMOLITION PLAN

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**A8** 


## EXISTING/DEMOLITION SECOND FLOOR PLAN

SCALE: 1/4" = 1'-0"

#### LEGEND DETAIL SECTION ELEVATION NUMBER (E) WALL TO REMAIN (E) WALL TO BE REMOVED ★ KEYNOTE TAG DOOR TAG, SEE DOOR SCHEDULE ON SHEET AS.0 WINDOW TAG. SEE WINDOW SCHEDULE ON SHEET AS.I WALL TAG, SEE PARTITION SCHEDULE ON SHEET AS.2

KEY	NOTES
001	EXISTING HARDSCAPE, PLANTERS, SITE WALLS TO BE DEMOLISHED & REMOVED
005	EXISTING FENCE TO BE REMOVED
200	EXISTING STAIR TO BE DEMOLISHED & REMOVED
201	EXISTIING OPENING TO BE DEMOLISHED, & REMOVED, INFILLED OR REPLACED, G.C TO COORD.
202	EXISTING DECK TO BE DEMOLISHED & REMOVED
203	EXISTING MILLWORK TO BE DEMOLISHED & REMOVED
204	EXISTING PLUMBING FIXTURES TO BE DEMOLISHED & REMOVED, SEE PROPOSED PLANS FOR LOCATION OF NEW PLUMBING
205	EXISTING APPLIANCES TO BE DEMOLISHED & REMOVED

EXISTING FIREPLACE TO BE DEMOLISHED & REMOVED, SEE PROPOSED PLANS FOR LOCATION OF NEW FIREPLACE

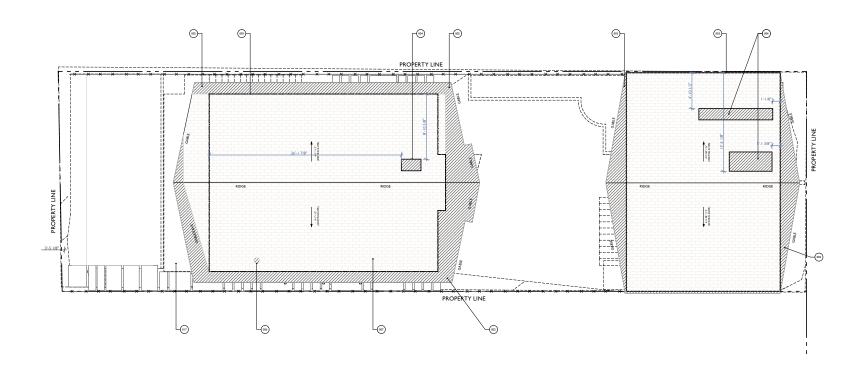

### **EXISTING/DEMOLITION ROOF PLAN** SCALE: 1/4" = 1'-0"



WALL TAG, SEE PARTITION SCHEDULE ON SHEET AS 2

#### **KEY NOTES**

PORTION OF EXISTING ROOF EAVE TO BE REMOVED. SEE DEMO ROOF PLAN FOR MORE INFORMATION

INDICATES PROPOSED SKYLIGHT, G.C TO COORD, CUTOUT WIN ROOF FOR SKYLIGHT BASED ON REVIEWED/APPROVED WINDOW PACKAGE

INDICATES LOCATION OF PROPOSED CHIMNEY G.C. TO COORD. CUTOUT FOR FLUE

EXISTING ASPHALT SHINGLED ROOF TO BE REMOVED DOWN TO SUBLAYER

## **RIVERVIEW**

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Revision	Date	Issue Description
0	06/20/2025	ISSUED PLANNING REVIEW #
-1	08/18/2025	ISSUED PLAN CHECK RESPONSE #
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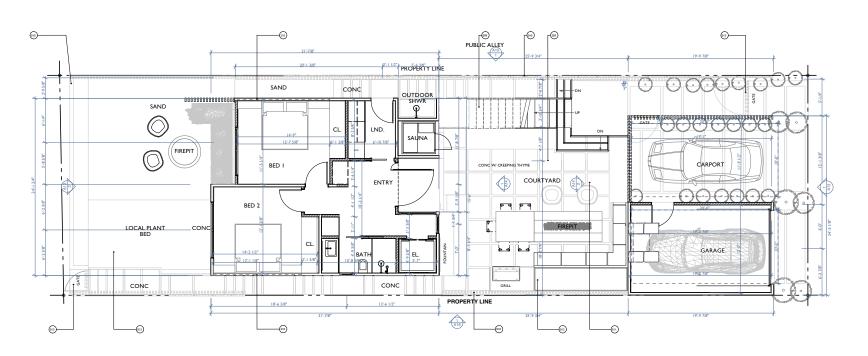
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Sheet Title
ROOF DEMOLITION PLAN

Scale As Indicated

**A9** 



# PROPOSED FIRST FLOOR SCALE: I/4" = I'-0"



WALL TAG, SEE PARTITION SCHEDULE ON SHEET AS.2

#### KEY NOTES

- 009 INDICATES NEW ACCESS STAIR
  010 INDICATES NEW FENCE
  011 INDICATES NEW CONC. PAVERS
  012 INDICATES NEW PLANTER
  013 INDICATES NEW ACCESS GATE
- 209 DASHED LINES INDICATE NEW BRIDGE ABOVE
  210 DASHED LINES INDICATE CLERESTORY ABOVE

RIVERVIEW

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Project Su	bmittal Recor	d
Revision	Date	Issue Description
0	06/20/2025	ISSUED PLANNING REVIEW #
7	08/18/2025	ISSUED PLAN CHECK RESPONSE #1
2	9/4/2025	ISSUED PLAN CHECK RESPONSE #2
3	9/25/2025	ISSUED PLANNING ADDENDUM #I

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Riverview Residence	
l .	
Accessor's Parcel Number	
APN #: 035-132-01	

| Sheet Title | PROPOSED FIRST FLOOR PLAN


PROPOSED FIRST FLOC

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AI0

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## 06/20/2025 | ISSUED | PLANNING REVIEW #1 | ISSUED PLAN | CHECK RESPONSE #1 9/4/2025 ISSUED PLAN CHECK RESPONSE #2 9/25/2025 ISSUED PLANNING ADDENDUM #I Seal/ Signature



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ı	Riverview Residence

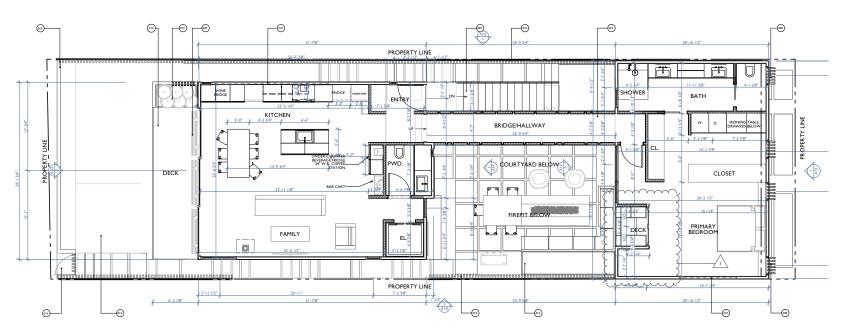APN #:	035-132-01	

| Sheet Title | PROPOSED SECOND FLOOR PLAN

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All

### PROPOSED SECOND FLOOR SCALE: 1/4" = 1'-0"




DETAIL/ SECTION/ ELEVATION NUMBER
SHEET NUMBER 

DOOR TAG, SEE DOOR SCHEDULE ON SHEET AS.0 WINDOW TAG, SEE WINDOW SCHEDULE ON SHEET AS.I WALL TAG, SEE PARTITION SCHEDULE ON SHEET A5.2



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### PROPOSED ROOF PLAN SCALE: 1/4" = 1'-0"

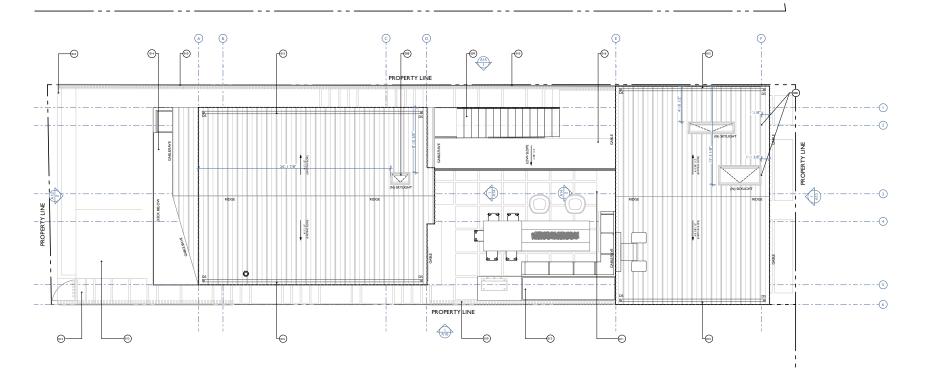

---- WALL BELOW



DOOR TAG, SEE DOOR SCHEDULE ON SHEET AS.0

WINDOW TAG, SEE WINDOW SCHEDULE ON SHEET AS.I WALL TAG, SEE PARTITION SCHEDULE ON SHEET AS 2



BUILDING ELEVATION KEY: ELEVATION # / SHEET #



BUILDING SECTION KEY: SECTION #/ SHEET #

#### KEY NOTES

INDICATES NEW SKYLIGHT

INDICATES NEW FENCE

INDICATES NEW CONC. PAVERS

INDICATES NEW ACCESS GATE

INDICATES NEW CANTILEVERED DECK

015 INDICATES INTEGRATED GUTTER

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0	06/20/2025	ISSUED PLANNING REVIEW #
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3	9/25/2025	ISSUED PLANNING ADDENDUM #I

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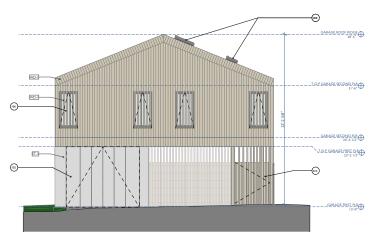
Accessor's Parcel Number APN #: 035-132-01

Sheet Title
PROPOSED ROOF PLAN


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AI2


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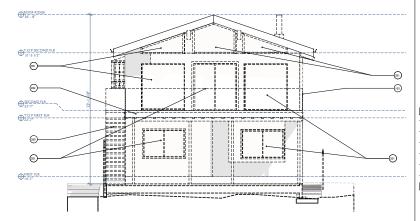
PROPOSED GARAGE /PRIMARY BEDROOM EAST ELEVATION SCALE: 1/4" = 1'-0"



EXISTING/DEMOLITION GARAGE /ALS EAST ELEVATION SCALE: 1/4" = 1'-0"

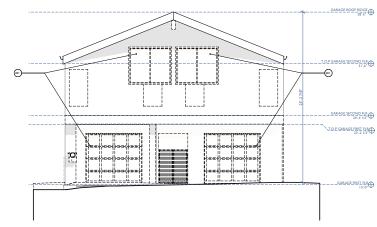

PROPOSED RESIDENCE WEST ELEVATION SCALE: 1/4" = 1'-0"

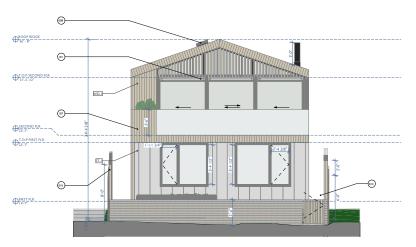

**EXISTING/DEMOLITION WEST ELEVATION** SCALE: 1/4" = 1'-0"

### LEGEND (E) CONSTRUCTION (E) CONSTRUCTION TO BE REMOVED DETAIL/ SECTION. SHEET NUMBER (x)→ KEYNOTE TAG DOOR TAG, SEE DOOR SCHEDULE ON SHEET AS.0 WINDOW TAG, SEE WINDOW SCHEDULE ON SHEET AS.I ■ WALL TAG, SEE PARTITION SCHEDULE ON SHEET A5.2

**DEMO KEY NOTES** 

RAILING TO BE REMOVED

EXISTING STAIR TO BE DEMOLISHED & REMOVED

EXISTIING OPENING TO BE DEMOLISHED, & REMOVED, INFILLED OR REPLACED, G.C TO COORD.

EXISTING DECK TO BE DEMOLISHED & REMOVED

CONSTRUCTION KEY NOTES

INDICATES NEW ACCESS STAIR

INDICATES NEW FENCE

INDICATES NEW ACCESS GATE

INDICATES RADIANT HEATERS

INDICATES LINE OF FLUSH GARAGE DOOR OPENING

INDICATES NEW GLASS RAILING

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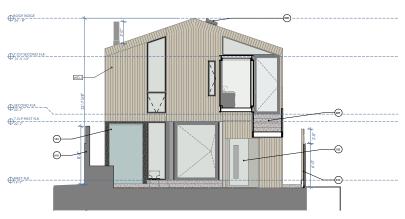


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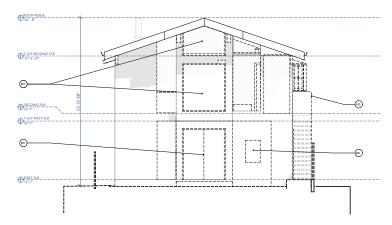
Sheet Title
EXISTING/PROPOSED FRONT AND REAR ELEVATIONS

Scale As Indicated


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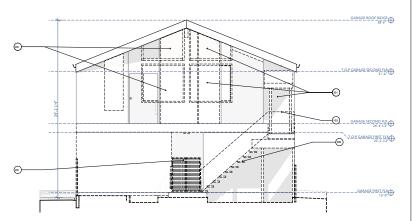




3 EXISTING/DEMOLITION RESIDENCE EAST COURTARD ELEVATION SCALE: 1/4" = 1'-0"



2 PROPOSED GARAGE/PRIMARY BEDROOM WEST COURTYARD ELEVATION SCALE: 1/4" = 1'-0"

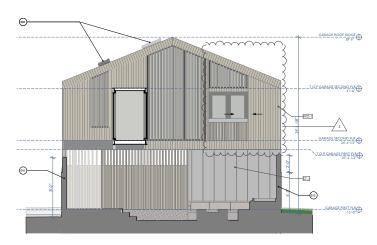

4 EXISTING/DEMOLITION GARAGE/ALS WEST COURTYARD ELEVATION SCALE: I/4" = I'-0"

### 

■ WALL TAG, SEE PARTITION SCHEDULE ON SHEET A5.2

DEMO KEY NOTES

103 RAILING TO BE REMOVED
200 EXISTING STAIR TO BE DEMOLISHED & REMOVED

EXISTIING OPENING TO BE DEMOLISHED, & REMOVED, INFILLED OR REPLACED, G.C. TO COORD.

#### CONSTRUCTION KEY NOTES

008 INDICATES NEW SKYLIGH

009 INDICATES NEW ACCESS STAIR

010 INDICATES NEW FENCE

104 INDICATES NEW WATERFALL/FOUNTAIN

105 INDICATES TENANT PROVIDED HOT SAUNA

106 INDICATES OPERABLE WINDOW SCREEN IN OPEN POSITION

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EXISTING/PROPOSED


EXISTING/PROPOSED COURTYARD ELEVATIONS


Scale As Indicated

**A14** 



PROPOSED NORTH ELEVATION

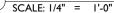

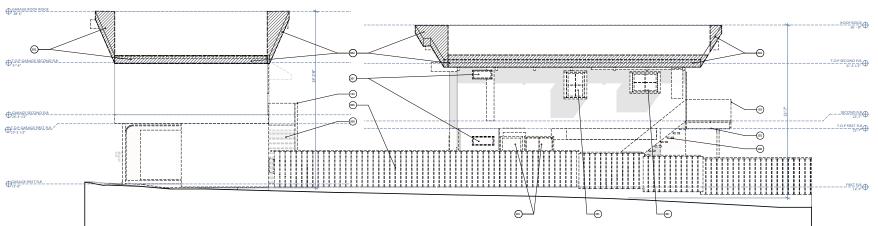

### EXISTING/DEMOLITION NORTH ELEVATION SCALE: 1/4" = 1'-0"

LEGEN	1D	
=	(E) CONSTRUCTION	DETAIL SECTION ELEVATION NUMBER
	(E) CONSTRUCTION TO BE REMOVED	KEYNOTE TAG
	(E) ROOF EAVE TO BE REMOVED	DOOR TAG, SEE DOOR SCHEDULE ON SHEET AS.0
		WINDOW TAG, SEE WINDOW SCHEDULE ON SHEE
		WALL TAG, SEE PARTITION SCHEDULE ON SHEET A

KEY	NOTES
002	PORTION OF EXISTING ROOF EAVE TO BE REMOVED. SEE DEMO ROOF PLAN FOR MORE INFORM.

EXISTING FENCE TO BE REMOVED

INDICATES OPERABLE WINDOW SCREEN IN OPEN POSITION

EXISTIING OPENING TO BE DEMOLISHED. & REMOVED, INFILLED OR REPLACED, G.C TO COORD.

EXISTING DECK TO BE DEMOLISHED & REMOVED

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Sheet Title
EXISTING/PROPOSED NORTH
ELEVATIONS

Scale As Indicated


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### PROPOSED SOUTH ELEVATION

SCALE: 1/4" = 1'-0"



# EXISTING/DEMOLITION SOUTH ELEVATION SCALE: I/4" = I'-0"

#### LEGEND KEY NOTES PORTION OF EXISTING ROOF EAVE TO BE REMOVED. SEE DEMO ROOF PLAN FOR MORE INFORMATION (E) CONSTRUCTION - DETAIL/ SECTION/ ELEVATION NUMBER RAILING TO BE REMOVED (E) CONSTRUCTION TO BE REMOVED ★ KEYNOTE TAG EXISTING FENCE TO BE REMOVED INDICATES OPERABLE WINDOW SCREEN IN OPEN POSITION DOOR TAG, SEE DOOR SCHEDULE ON SHEET AS.0 EXISTING STAIR TO BE DEMOLISHED & REMOVED WINDOW TAG, SEE WINDOW SCHEDULE ON SHEET AS.I EXISTIING OPENING TO BE DEMOLISHED, & REMOVED, INFILLED OR REPLACED, G.C TO COORD. WALL TAG. SEE PARTITION SCHEDULE ON SHEET AS 2 EXISTING DECK TO BE DEMOLISHED & REMOVED
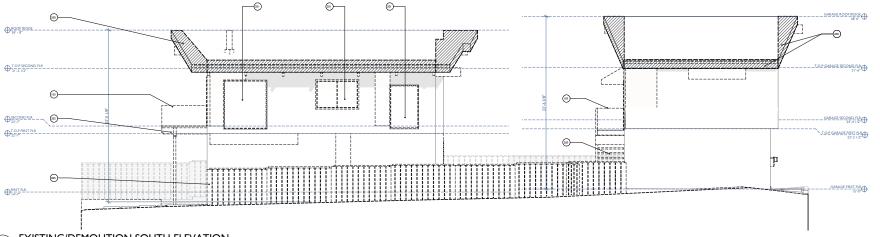
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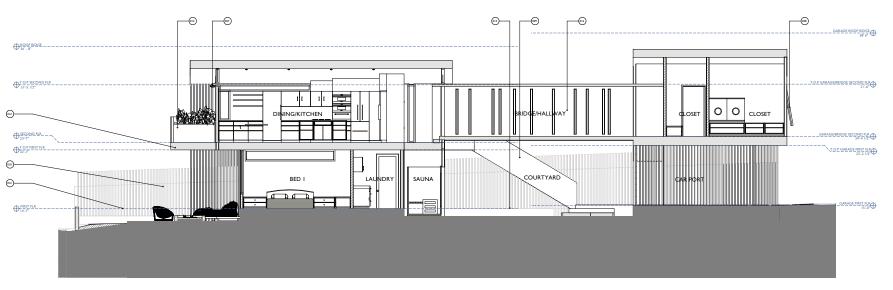
| Sheet Title |
EXISTING/PROPOSED SOUTH |
ELEVATIONS

Scale As Indicated

AI6


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3 BUILDING SECTION - LONGITUDINAL

SCALE: 1/4" = 1'-0"



2 D-E17 BUILDING SECTION - LONGITUDINAL SCALE: 1/4" = 1'-0"

LEGEND

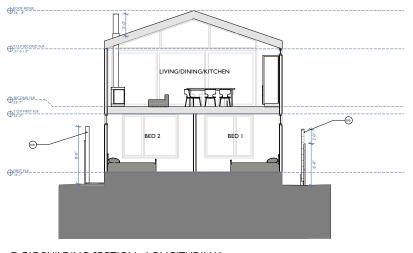★ KEYNOTE TAG

(XXX-X) DOOR TAG, SEE DOOR SCHEDULE ON SHEET AS.0 WINDOW TAG, SEE WINDOW SCHEDULE ON SHEET AS.I

#### KEY NOTES

INDICATES NEW FENCE

INDICATES NEW PLANTER

INDICATES NEW CANTILEVERED DECK

INDICATES NEW ENCLOSED BRIDGE

INDICATES OVERHEAD HEATERS

INDICATES AWNING WINDOW SCREEN IN THE OPEN POSITION

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Sheet Title
PROPOSED BUILDING SECTIONS

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AI7



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Accessor's Parcel Number APN #: 035-132-01

Sheet Title
PERSPECTIVE #1

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0	06/20/2025	ISSUED PLANNING REVIEW #
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2	9/4/2025	ISSUED PLAN CHECK RESPONSE #:
3	9/25/2025	ISSUED PLANNING ADDENDUM #I

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Accessor's Parcel Number APN #: 035-132-01

Sheet Title
PERSPECTIVE #3

Scale As Indicated

A24



FINISH: WD-I MFR: MOSO

MATERIAL: COMPOSITE SIDING/DECKING COLOR: BAMBOO X-TREME DECKING

LOCATION: VERTICAL SIDING

NOTE: WUI COMPLIANT / CLASS 'A' MATERIAL.

**INSTALLED ON A RAINSCREEN** 



FINISH #: ST-I

MFR: NEOLITH

MATERIAL: CENTERED STONE

COLOR: SHILIN

LOCATION: LOWER LEVEL

NOTE: PANELIZED SYSTEM ON RAINSCREEN, SIZE

TBD. WUI COMPLIANT / FIRE RESISTANT



FINISH #: MTL-I

MATERIAL: ALUMINUM WINDOW TRIM COLOR: DARK BRONZE / BLACK MFR: BY WINDOW MFR.

LOCATION: WINDOWS + GL. DOOR FRAMES



FINISH #: MTL-2

MATERIAL: METAL - STANDING SEAM ROOF + FENCE

COLOR: CHARCOAL GRAY

MFR: BY WESTERN STATES MTL. ROOFING

LOCATION: ROOF + FENCE

RIVERVIEW

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Project Submittal Record			
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0	06/20/2025	ISSUED PLANNING REVIEW #1	
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2	9/4/2025	ISSUED PLAN CHECK RESPONSE #2	
3	9/25/2025	ISSUED PLANNING ADDENDUM #1	

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Accessor's Parcel Number APN #: 035-132-01

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Sheet Title
PROPOSED MATERIALS

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3	9/25/2025	ISSUED PLANNING

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Accessor's Parcel Number APN #: 035-132-01

Sheet Title
PERSPECTIVE COMPARISON #1

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Revision	Date	Issue Description
0	06/20/2025	ISSUED PLANNING REVIEW #1
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3	9/25/2025	ISSUED PLANNING ADDENDUM #I

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Accessor's Parcel Number APN #: 035-132-01

Sheet Title
PERSPECTIVE COMPARISON #2

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0	06/20/2025	ISSUED PLANNING REVIEW #
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3	9/25/2025	ISSUED PLANNING ADDENDUM #I

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Accessor's Parcel Number APN #: 035-132-01

Sheet Title
PERSPECTIVE COMPARISON #3

Scale As Indicated



#### PROPOSED PLANTING SELECTIONS



<u>lue Glow Agave</u> - (Agave attenuata) A single rosette can grow up to 3-5 feet tall ad 3-5 feet wide, with the flower stalk reaching out to 10 feet tall. It makes a unique ramatic focal point in garden beds, or used in decorative containers. MUCOLS DATABASE BATING: REGION 01 / VERY LOW WATER USE / #10% FTo

ATIVE: NO / SUCCULENT

ATIVE: NO / ORNAMENTAL GRASS



asket Grass - (lomandra confertifolia) It features a strong clumping form and its sep rhizomes make it a much hardler than most of the confertifolia family. Growing 30 cm high it will do well in pots or as a mass or border planting. WUCOLS DATABASE RATING: REGION 01 / LOW WATER USE / 10-30% ETo



WUCOLS DATABASE RATING: REGION 01 / LOW WATER USE / 10-30% ETo ATIVE: NO / PERENNIAL



lue Fescue 'Elijah Blue' - (Festuca glauca) Forms small, dense mounds of tufted aves with small seed heads held nicely above the foliage. Prefers cooler weather. VUCOLS DATABASE RATING: REGION 01 / LOW WATER USE / 10-30% ETo



Blue Chalksticks Plant - (Senecio serpens) small su cranching from the base and rooting along the stems.

LICOLS DATABASE RATING: REGION 01 / LOW WATER LISE / 10:30% FTo ATIVE: NO / GROUND COVER PERENNIAL SUCCULENT



Silver Carpet - (Dymondia Margaratae) small succulent that hugs the ground, tranching from the base and rooting along the stems.

VUCOLS DATABASE RATING: REGION 01 / LOW WATER USE / 10-30% ETo ATIVE: NO / GROUND COVER PERENNIAL





VUCOLS DATABASE RATING: REGION 01 / LOW WATER USE / 10-30% ETo



WUCOLS DATABASE RATING: REGION 01 / LOW WATER USE / 10-30% ETo NATIVE: NO / PERENNIAL SHRUB





New Zealand Flax (Pi leet wide, with bronzy New Zealand Flax (Phomisian tenax) perennial, uprignt to o -10 test tax and vo-elect wide, with bronzy green, stray-shaped leaves and red-orange, bubbal flowers on tall stake in late spring or early summer. Native to various habitats in New Zealand, from seasonally well places to exposed coastal cliff. Most plants svariable are cultivars. Tom Thumb', 2-3 feet tall and wide, has way-edged, olive green leaves with dark bronzy red margins. Dussy Cheff, 6-8 feet tall and 6 feet wide, has variable.

VUCOLS DATABASE RATING: REGION 01 / LOW WATER USE / 10-30% ETO IATIVE: NO / PERENNIAL GRASS



MICOLS DATABASE DATING: DEGION 01 / LOW WATER LISE / 10.30% ET-NATIVE: YES / ORNAMENTAL GRASS



<u>seping Fig</u> (Ficus Pumila) Creeping fig is a broadleaf, evergreen, woody, climbe the mulberry family (Moraceae). It is native to central and southern China and stern Asia. It is a vigorous grower and, in favorable conditions, will climb 8 to 15 kt high and spread 3 to 6 feet wide. Creeping fig can cement itself to porous

WUCOLS DATABASE RATING: REGION 01 / MODERATE WATER USE / 40-60% ETo NATIVE: NO / VINE

#### PROPOSED EXTERIOR LIGHTING



DIRECTIONAL LIGHTING SEE SHEET L2 FOR SPECIFICATION SHEET



LOCATION SHOWN ON THIS PLAN SHEET WITH SYMBOL.



LOCATION SHOWN ON THIS PLAN SHEET WITH SYMBOL:



EXTERIOR WALL / SCONCE LIGHTING SEE SHEET L2 FOR SPECIFICATION SHEET

LOCATION SHOWN ON THIS PLAN SHEET WITH SYMBOL



### GENERAL NOTES - LANDSCAPE / WATER EFFICIENT LANDSCAPE ORDINANCE (WELO)

Please note that there are two (2) separate areas to be installed for storm water treatment (as noted/shown on plan).

vi. If water pressure at the meter is greater than 80psi, a pressure regulator is installed.

viii. Compliant backflow prevention device and accessible manual shutoff

x. Water features and recirculating pools and spas are to be covered when not in use

 Soil Preparation: Organic amendment incorporated at a rate of 6cy per 1000sf in too 6" of soil, except where: i. Existing soil has greater than 6% organic matter in top 6"

ii. amendment is contraindicated by specificaltons for summer-dry s

iii. Native plants adapted to site soils are used.

10. Soil Preparation: Exposed soils mulched with minimum three inch layer of organic material - except in turf areas, creeping or rooting ground covers, or direct seeding applications where mulch is contraindicated.

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Accessor's Parcel Number APN #: 035-132-01

Sheet Title
LANDSCAPE PLAN

As Indicated

PROPERTY LINE FOOT PRINT OF MAIN RESIDENCE PATRAMER 344636363636

PROPOSED LANDSCAPE PLAN SCALE: 1/4" = 1'-0"

AURORALIGHT SKU #: TYPE

## MERIDIAN PTA008105

The Meridian is an ideal solution for uniform spacing and light levels in the absence of a structure. Its small aperture shields against glave while allowing for forward projection with even illumination side to side.

\*\*Thermally Integrated® field serviceable LED module \*\*Cree LED\* XP-L® High Density

·Solid brass and copper construction


	LED	FINISH
PTA008105		
( ) = Most common configuration	(2701) 2700K 1.25W (2001) 2000K 1.25W	(NAT) Natural Brass (ELP) Bronze Living Patins (ELPX) Extra Dark ELP

FIXTURE DIMENSIONS	L6-1/2" x H16" x W1-2/8
LIGHT SOURCE	Integrated LEC
COLOR TEMPERATURES	2700K, 2000K
WATTAGES	1.259
CRI (RA)	80 CF
VOLTAGE	121
DELIVERED LUMENS	45im (2000K
DIMMABLE	Yes, Dim to <10% via Transforme
DRIVER	Yes, 12V Integral Constant Curren
TRANSFORMER	12V AC/DC (Supplied by others
MOUNT	Yes, included 1/2" NPS Adapte
GROUND STAKE	Yes, Included MGS001101
OPTICS	Yes, included 15°, 25°, 40° & 60
FINISH	Included Natura
MATERIAL	Brass & Coppe
WIRE LENGTH	24
LOCATION	Exterior We







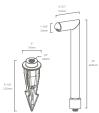

## AURORALIGHT | PROJECT:

MOUNIS	
MGS001510	Ground Stake w/ 2" Brass Cap
MGS001612	Ground Stake w/ 2" Brass Cap
MGS001712	Ground Stake w/ 3-1/4" Brass Cap
MGS005109	9" Deluse Spike
MGS005212	12" Trident Spike
MJB002303	2" Junction Box w/ PVC Stake
MPM003104	Concrete Pedestal Mount
MSM189102	2" Surface Mount
MSM189203	2" Surface Mount











ADD-ONS

AURORALIGHT | PROJECT



## AURORALIGHT | PROJECT



### CABRILLO

Aurora Mount System (AMS™) compatible

Field Serviceable light module featuring Cree LED\*

interchangeable PMMA acrylic optics from 15° to 40°. •Ideal for small greenery, facade & architectural features

## CONFIGURATOR:

	LED	FINISH
DIROB0125 () = Mest common configuration	(2703) 2700K 2W (2003) 2003K 2H	(NAT) Natural Brass (BLP) Stotze Living Patina (BLPX) Extra Dark BLP (NB Nickel PVD

FIXTURE DIMENSIONS	L5-1/8" x H2" x D1"
LIGHT SOURCE	Integrated LED
COLOR TEMPERATURES	2700K, 2000K
WATTAGES	2W
CRI (RA)	80 CRI
VOLTAGE	121
DELIVERED LUMENS	298m (2000K)
DIMMABLE	Yes, Dim to <10% via Transformer
DRIVER	Yes, 12V Integral Constant Current
TRANSFORMER	12V AC(DC (Supplied by others)
MOUNT	Yes, included 1/2" NPS Adapter
GROUND STAKE	Yes, Included MGS001109
ACCESSORIES	No
OPTICS	Yes, included 15", 25" & 40"
FINISH	included Natural Brass
MATERIAL	Brass
WIRE LENGTH	24"
LOCATION	Exterior Wet
CERTIFICATIONS	UL, P64, P67

C. 2742 Loker Ave. W Carlsbad CA 92010



AVAILABLE FI	NISHES:		
177736			
	150		
NAT	BLP	BLPX	NI
Natural Brass	Bronze Living Patina	Extra Dark Bronze Livino Patina	Nickel P











#### ADD-ONS

MOUNTS		
MGS001510	Ground Stake w/ 2" Brass Cap	
MGS001612	Ground Stake w/ 2" Brass Cap	
MGS001712	Ground Stake w/ 2-1/4" Brass Cap	
MGS005109	9" Deluse Spike	
MGS005212	12" Trident Spike	
MJB002303	2" Junction See w/ PVC Stake	
MPM003104	Concrete Pedestal Mount	
MSM189102	2" Surface Mount	
7	N Contract Manual	



Project Submittal Record
Revision Date Issue Description 06/20/2025 | ISSUED | PLANNING REVIEW #1 | ISSUED PLAN | CHECK RESPONSE #1 9/4/2025 ISSUED PLAN CHECK RESPONSE #2 9/25/2025 ISSUED PLANNING ADDENDUM #I

**RIVERVIEW** 

427 RIVERVIEW CAPITOLA, CA 95010

fuse 🔀 architects + builders
512 Capitola Ave + Capitola + California + 95010
fusearchitecture.com 831.479.9295

Seal/ Signature



Project Name Riverview Residence

Accessor's Parcel Number APN #: 035-132-01

Sheet Title
LANDSCAPE LIGHTING SPEC.
SHEETS

Scale As Indicated

L2

### AURORALIGHT

PROJECT:	
SKU #:	TYPE:

## CASCADE STW637104

STW637104

The Cascade is a surface-mounted LED wall light that offers excellent illumination of walls and walkways in a stylish design featuring a precision-machined script optic with a prismatic design for uniform distribution.

Dual listed for interior and exterior well location use

\*Thermally integrated\* w/ Copper Core Technology\*

- Ichee LED\* XP-L Bigh Density

- Ideal for stales, pathways and architecture

	LED	FINSH
STW637104		
() # Most common configuration	(2702) 2700K 2W	(NAT) Natural Brass
	(2704) 2700K 4W	(ELP) Bronze Living Patina
	(2002) 2000K 2W	(ELPX) Extra Dark ELP
	(2004) 2000K 6W	(NO Nickel PVD

FIXTURE DIMENSIONS	D4" x W4
LIGHT SOURCE	Integrated LE
COLOR TEMPERATURES	2700K, 2000
WATTAGES	211, 41
CRI (RA)	80 C
VOLTAGE	12
DELIVERED LUMENS	214in (2000)
DIMMABLE	Yes, Dim to <10% via Transform
DRIVER	Yes, 12V Integral Constant Curre
TRANSFORMER	12V AC/DC (Supplied by other)
MOUNT	Included Backplan
FINISH	Included Natural Bras
MATERIAL	Gras
WIRE LENGTH	2
LOCATION	Interior & Exterior Wi







- P. 760.931.2910 C. 2742 Loker Ave. W Carlsbad CA 92010 W. www.suroralight.com





### RIVERVIEW

427 RIVERVIEW CAPITOLA, CA 95010



ı	Project Submittal Record		
ı	Revision	Date	Issue Description
	- 0	06/20/2025	ISSUED PLANNING REVIEW #
		08/18/2025	ISSUED PLAN CHECK RESPONSE #
	2	9/4/2025	ISSUED PLAN CHECK RESPONSE #
	3	9/25/2025	ISSUED PLANNING ADDENDUM #I

Seal/ Signature



Accessor's Parcel Number APN #: 035-132-01

Sheet Title
LANDSCAPE LIGHTING SPEC.
SHEETS

Scale As Indicated

9/25/2025 5:24 PM

2) THE CONTRACTOR SHALL IMMEDIATELY REPORT TO THE ENGINEER ANY DISCREPANCY OCCURRING BETWEEN THE DRAWINGS AND THE ON-SITE CONSTRUCTION THAT DOES NOT HAVE PRIOR WRITTEN APPROVAL OF THE PROJECT ENGINEER.

3) ANY EGOUEST FOR ALTERATIONS OF SUBSTITUTIONS MUST BE PRESENTED DIRECTLY TO THE PROJECT ENGINEER, ACCOMPANIED BY A DETAILED SECTED, FOR REPORT, REPORT ANY PAPPOVAL MLL BEE GIVEN AND BEEN PROCEEDING WITH THE WORK, ABSOLUTELY NO ALTERATIONS OF THESE DOCUMENTS OF ANY KIND WILL BE APPROVED ON ANY SHOP PRANMOS.

4) ALL CONSTRUCTION SHALL CONFORM TO THE APPLICABLE PROMODIONS OF THE STATE OF CALIFORNIA BUILDING CODE, LATEST APPLICABLE EDITION, THE LATEST EDITION OF THE "COMBITY OF SMATE ACTURE DISSION CRITERIA" CITY OF CAPTICLA STORM MATER AND GRADING GEBNANCES, THE UNIFORM BUILDING CODE, AND ALL OTHER FEDERAL AND STATE LANS, WINCHEVER IS NOST STRINGENT.

5) NO CHANGES IN THE APPROVED IMPROVEMENT PLANS SHALL BE MADE WITHOUT PRIOR APPROVAL OF THE COUNTY OF SANTA CRUZ DEPARTMENT OF PUBLIC WORKS AND THE WRITTEN APPROVAL OF THE PROJECT ENGINEER.

6) ALL PERMITS, CITY, COUNTY AND STATE, SHALL BE OBTAINED BY THE CONTRACTOR PRIOR TO THE START OF CONSTRUCTION.

THE CONTRACTOR SHALL NOTIFY THE COUNTY CONSTRUCTION ENGINEER AT (831) 454-2160 AT LEAST 48 HOURS PRIOR TO THE START OF CONSTRUCTION.

8) THE CONTRACTOR SHALL NOTIFY THE GEOTECHNICAL ENGINEER AT LEAST 4 WORKING DAYS PRIOR TO THE START OF GRADING CONSTRUCTION. GRADING SHALL BE DONE UNDER THE OBSERVATION OF A LICENSED GEOTECHNICAL ENGINEER.


9) ANY EXISTING UTILITIES THAT ARE REQUIRED TO BE RELOCATED AS A PART OF THIS CONSTRUCTION SHALL BE RELOCATED AT THE DEVELOPER'S EXPENSE.

10) THE DIRECTOR OF PUBLIC WORKS OR HIS AUTHORIZED REPRESENTATIVE SHALL HAVE THE AUTHORITY TO "STOP WORK" IF THE WORK IS NOT BEING DONE IN ACCORDANCE WITH THE APPROVED IMPROVEMENT PLANS.

11) ALL FIELD ENGINEERING SHALL BE PERFORMED UNDER THE DIRECT SUPERVISION OF A LAND SURVEYOR OR CIVIL ENGINEER QUALIFIED TO PRACTICE CONSTRUCTION SURVEYING IN THE STATE OF CALIFORNIA.


12) CONTRACTOR JOSES THAT IN ACCORDANCE WITH GENERALY ACCOPTED CONSTRUCTION PRACTICES, CINTRACTOR WILL BE RECOURTED TO ASSUME SOLE AND COMMETE RESPONSIBILITY FOR JOSS STREE CONNITIONS TOWN THE FOREIGN FOR THE PROJECT, INCLUDING SAFETY OF ALL PERSONS AND PROPERTY. THAT THIS REQUIREMENT SHALL BE MADE TO APPLY CONTINUOUSLY AND NOT BE LIMITED TO ROMBAL WORKING HOURS, AND CONTRACTOR FRAL, OR ALLEGED, IN CONNECTION WITH THE PERFORMANCE OF WORK ON THIS PROJECT, EXCEPTING LIABILITY RISING FROM THE SOLE INCLUDENCE OF THE PROJECT CONNECT.

13) WORK SHALL BE LIMITED TO 8:00 AM TO 5:00 PM WEEKDAYS. NON-NOISE PRODUCING ACTIVITIES, SUCH AS INTERIOR PAINTING, SHALL NOT BE SUBJECT TO THIS RESTRICTION.

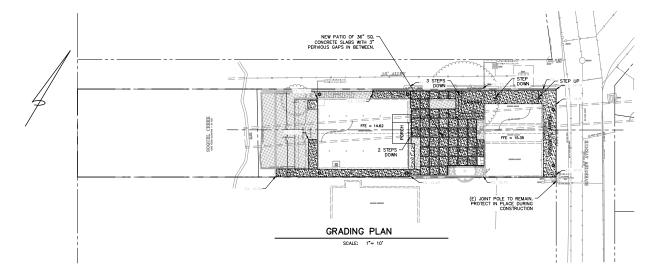

GRAPHIC SCALE

( IN PERT ) 1 inch = 10 ft.

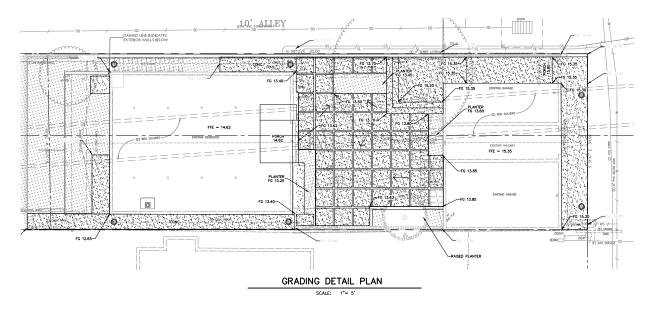



PROPOSED CONCRETE PROPOSED LANDSCAPE PLANTER

STORM DRAIN PIPE EXISTING MAJOR CONTOUR EXISTING MINOR CONTOUR EXISTING SANITARY SEWER LINE

> EXISTING STORM DRAIN LINE EXISTING WATER LINE × REMOVE TREE

> > EXISTING TREE

PROPERTY LINE

#### SHEET INDEX

DATE 2025 06 20

DESIGN JFR

C1.0 GRADING PLAN

C2.0 DRAINAGE PLAN & DETAILS
C2.1 STORM WATER CONTROL PLAN

C3.0 FROSION CONTROL PLAN

TOPOGRAPHIC SURVEY BY ROPER ENGINEERING

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PLAN CHECK ONLY

BOWMAN & WILLIAMS GRADING PLAN MCLEAN RESIDENCE 427 RIVERVIEW AVE CAPITOLA, CAUFORNIA

FILE NO. 29200

C1.0


2) CONTRACTOR SHALL EXPOSE AND VERIFY LOCATION AND ELEVATION OF EXISTING UTILITIES, INCLUDING BUT NOT LIMITED TO SANITARY AND STORM SEWERS, AND WATER LINES BEFORE CONSTRUCTING NEW FACILITIES.

3) MATERIALS FOR PIPE, STORM WATER INLETS, AND CLEANOUTS AND INSTALLATION PROCEDURES SHALL BE IN ACCORDANCE WITH APPLICABLE UBC AND CPC SECTIONS, AND THESE PLANS AND DETAILS SHOWN HEREON. SANTARY SEWER PIPE DESIGNATED '55' SHALL BE FOV OR SDR 26 BELL AND SPIGOT CASKET, SMOOTH INTERIOR PIPE OR APPROVED EQUAL STORM DRAIN PIPE DESIGNATED '55' SHALL BE CY OR AND STALL BE CONCERNING THE PIPE OR APPROVED EQUAL RIGHTS AND SHALL BE CONCERNING SHALL BE CONCERNING THE ORDER OF THE PIPE OR APPROVED EQUAL RIGHTS AND LIBE SOH 40 AND SHALL BE CONCERNED TO SO WITH WEI FITTINGS.

4) ALL DRAINAGE PIPE SHALL BE SHIPPED, STORED AND INSTALLED PER THE PIPE MANUFACTURERS RECOMMENDATIONS.

5) ALL CONCRETE DRAINAGE INLETS CALLED OUT ON THE PLANS SHALL BE:
1) CHRISTY BRAND PRECAST CONCRETE 1/2 OR THE COUNTLENT, OR:
2) DURA DRAIN P-4 MANIFACTURED BY KRISTAR, OR:
3) ADS NYOPLAST.
ALL STRUCTURES SHALL BE STORED, HANDLED AND INSTALLED PER THE MANUFACTURERS RECOMMENDATION.


6) STORM DRAIN TRENCH BACKFILL SHALL CONFORM TO COUNTY OF SANTA CRUZ STANDARD SPECIFICATIONS SECTION AND THE DETAILS SHOWN HEREON, JETTING OF BACKFILL MATERIALS TO ACHIEVE COMPACTION IS NOT ALLOWED.

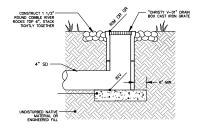



#### V1 BUBBLER DETAIL


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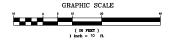
DOWNSPOUT CONNECTION TO STORM DRAIN

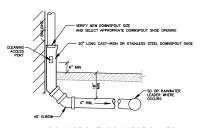SCALE: N.T.S



#### STORM DRAIN MAINTENANCE

- PRIOR TO THE ONSET OF THE RAINY SEASON (OCT 1ST) AND SUBSEQUENT TO LARGE RAIN EVENTS THE OWNER SHALL INSPECT ALL GRATES AND INLETS TO ENSURE SYSTEM IS NOT BLOCKED AND IN OPERATING ORDER.
  - INSPECT GRATES REMOVE ANY DEBRIS ON OR AROUND GRATE INSPECT INLETS REMOVE ANY DEBRIS BY HAND OR VACUUM
- 2) ANY DEBRIS REMOVED FROM SD SYSTEM SHALL BE DISPOSED OF AT COUNTY LANDFILL.
- 3) THE OWNER' SHALL RECORD A MAINTENANCE AGREEMENT WITH THE COUNTY PRIOR TO FINAL INSPECTION.

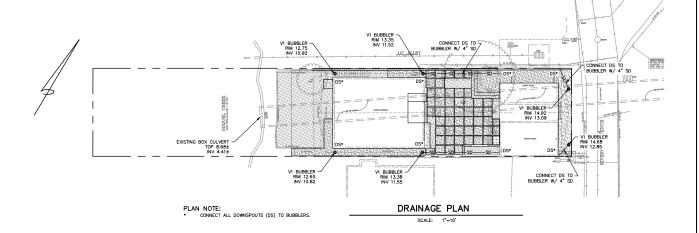




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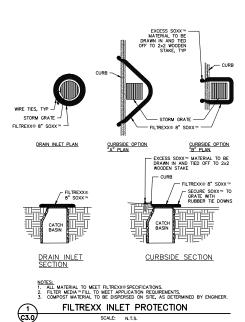
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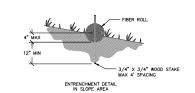
BOWMAN & WILLIAMS IL ENGINEERS   LAND SURVEYORS	DRAINAGE PLAN
949 RESEARCH PARK COURT, SUITE 100 SOQUEL, CA 95073-2094 (831) 426-3560	MCLEAN RESIDENCE 427 RIVERWEW AVE CAPITOLA, CALIFORNIA

DATE 2025 06 20 C2.0




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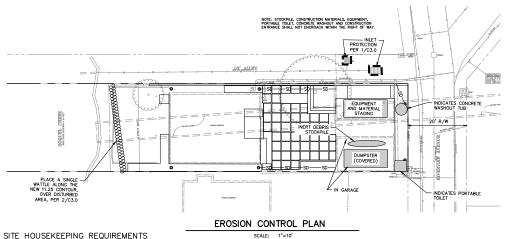
SCALE: N.T.S.



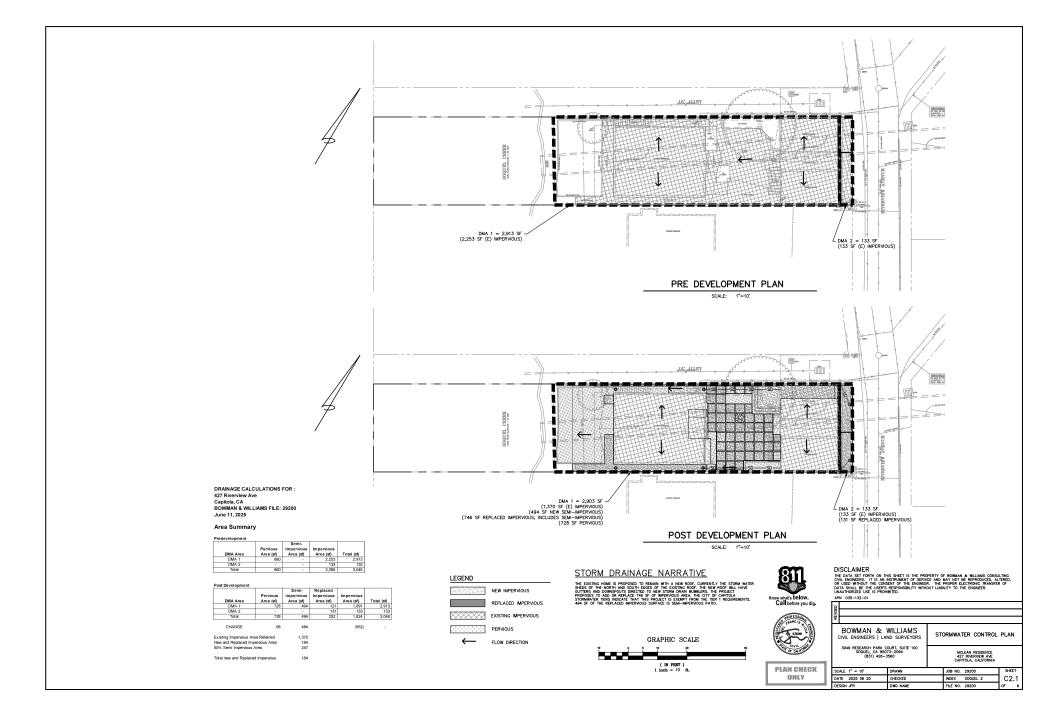

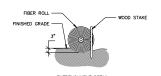

STRAW WATTLE



#### SITE HOUSEKEEPING REQUIREMENTS

#### CONSTRUCTION MATERIALS

- ALL LOOSE STOCKPILED CONSTRUCTION MATERIALS THAT ARE NOT ACTIVELY BEING USED (I.E. SOIL, SPOILS, AGGREGATE, FLY-ASH, STUCCO, HYDRATED LIME, ETC.) SHALL BE COVERED AND BERMED.
- EXPOSURE OF CONSTRUCTION MATERIALS TO PREOPITATION SHALL BE MINIMIZED. THIS DOES NOT INCLUDE MATERIALS AND OLUPHENT THAT ARE DESIGNED TO BE OUTDOORS AND EXPOSED TO ENVIRONMENTAL CONDITIONS (I.E. POLES, EQUIPMENT PAGS, CABBERTS, CONDUCTORS, INSULATORS, BRICKS, ETC.).
- BEST MANAGEMENT PRACTICES TO PREVENT THE OFF-SITE TRACKING OF LOOSE CONSTRUCTION AND LANDSCAPE MATERIALS SHALL BE IMPLEMENTED.


#### WASTE MANAGEMENT

- DISPOSAL OF ANY RINSE OR WASH WATERS OR MATERIALS ON IMPERVIOUS OR PERVIOUS SITE SURFACES OR INTO THE STORM DRAIN SYSTEM SHALL BE PREVENTED.

- 8. COVER WASTE DISPOSAL CONTAINERS AT THE END OF EVERY BUSINESS DAY AND DURING A RAIN EVENT.
- 9. DISCHARGES FROM WASTE DISPOSAL CONTAINERS TO THE STORM WATER DRAINAGE SYSTEM OR RECEIVING WATER SHALL BE PREVENTED.
- STOCKPILED WASTE MATERIAL SHALL BE CONTAINED AND SECURELY PROTECTED FROM WIND AND RAIN AT ALL TIMES UNLESS ACTIVELY BEING USED.
- 2. PROCEDURES THAT EFFECTIVELY ADDRESS HAZARDOUS AND NON-HAZARDOUS SPILLS SHALL BE IMPLEMENTED.
- EQUIPMENT AND MATERIALS FOR CLEANUP OF SPILLS SHALL BE AVAILABLE ON SITE. SPILLS AND LEAKS SHALL BE CLEANED UP IMMEDIATELY AND DISPOSED OF PROPERLY.
- CONCRETE WASHOUT AREAS AND OTHER WASHOUT AREAS THAT MAY CONTAIN ADDITIONAL POLLUTANTS SHALL BE CONTAINED SO THERE IS NO DISCHARGE INTO THE UNDERLYING SOIL AND ONTO THE SURROUNDING AREAS.

- MEASURES SHALL BE TAKEN TO PREVENT OIL, GREASE, OR FUEL TO LEAK INTO THE GROUND, STORM DRAINS OR SURFACE WATERS.
- ALL EQUIPMENT OR VEHICLES, WHICH ARE TO BE FUELED, MAINTAINED AND STORED ONSITE SHALL BE IN A DESIGNATED AREA FITTED WITH APPROPRIATE BMPS.
- 7. LEAKS SHALL BE IMMEDIATELY CLEANED AND LEAKED MATERIALS SHALL BE DISPOSED OF PROPERLY.

- 8. CONTAIN STOCKPILED MATERIALS SUCH AS MULCHES AND TOPSOIL WHEN THEY ARE NOT ACTIVELY BEING USED.
- 9. CONTAIN FERTILIZERS AND OTHER LANDSCAPE MATERIALS WHEN THEY ARE NOT ACTIVELY BEING USED.
- DISCONTINUE THE APPLICATION OF ANY EXCODELE LANDSCAPE MATERIAL WITHIN 2 DAYS BEFORE A FORECASTED RAIN EVENT OR DURING PERIODS OF PRECIPITATION.
- APPLY ERODIBLE LANDSCAPE MATERIAL AT QUANTITIES AND APPLICATION RATES ACCORDING TO MANUFACTURE RECOMMENDATIONS OR BASED ON WRITTEN SPECIFICATIONS BY KNOWLEDGEABLE AND EXPERIENCED FIELD PERSONNEL.

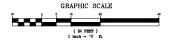



INDICATES INLET PROTECTION, REFER TO DETAIL 1/C3.0



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APN 035-132-01 BOWMAN & WILLIAMS CIVIL ENGINEERS | LAND SURVEYORS EROSION CONTROL PLAN MCLEAN RESIDENCE 427 RIVERVIEW AVE CAPITOLA, CALIFORNIA

SCALE AS NOTED DATE 2025 06 20 INDEX SOQUEL 2 C3.0 DESIGN JFR FILE NO. 29200

