



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➡ BUILDING-A F.F.E. 282'


♦ BUILDING-A F.F.E. 282'

B-B A1.2

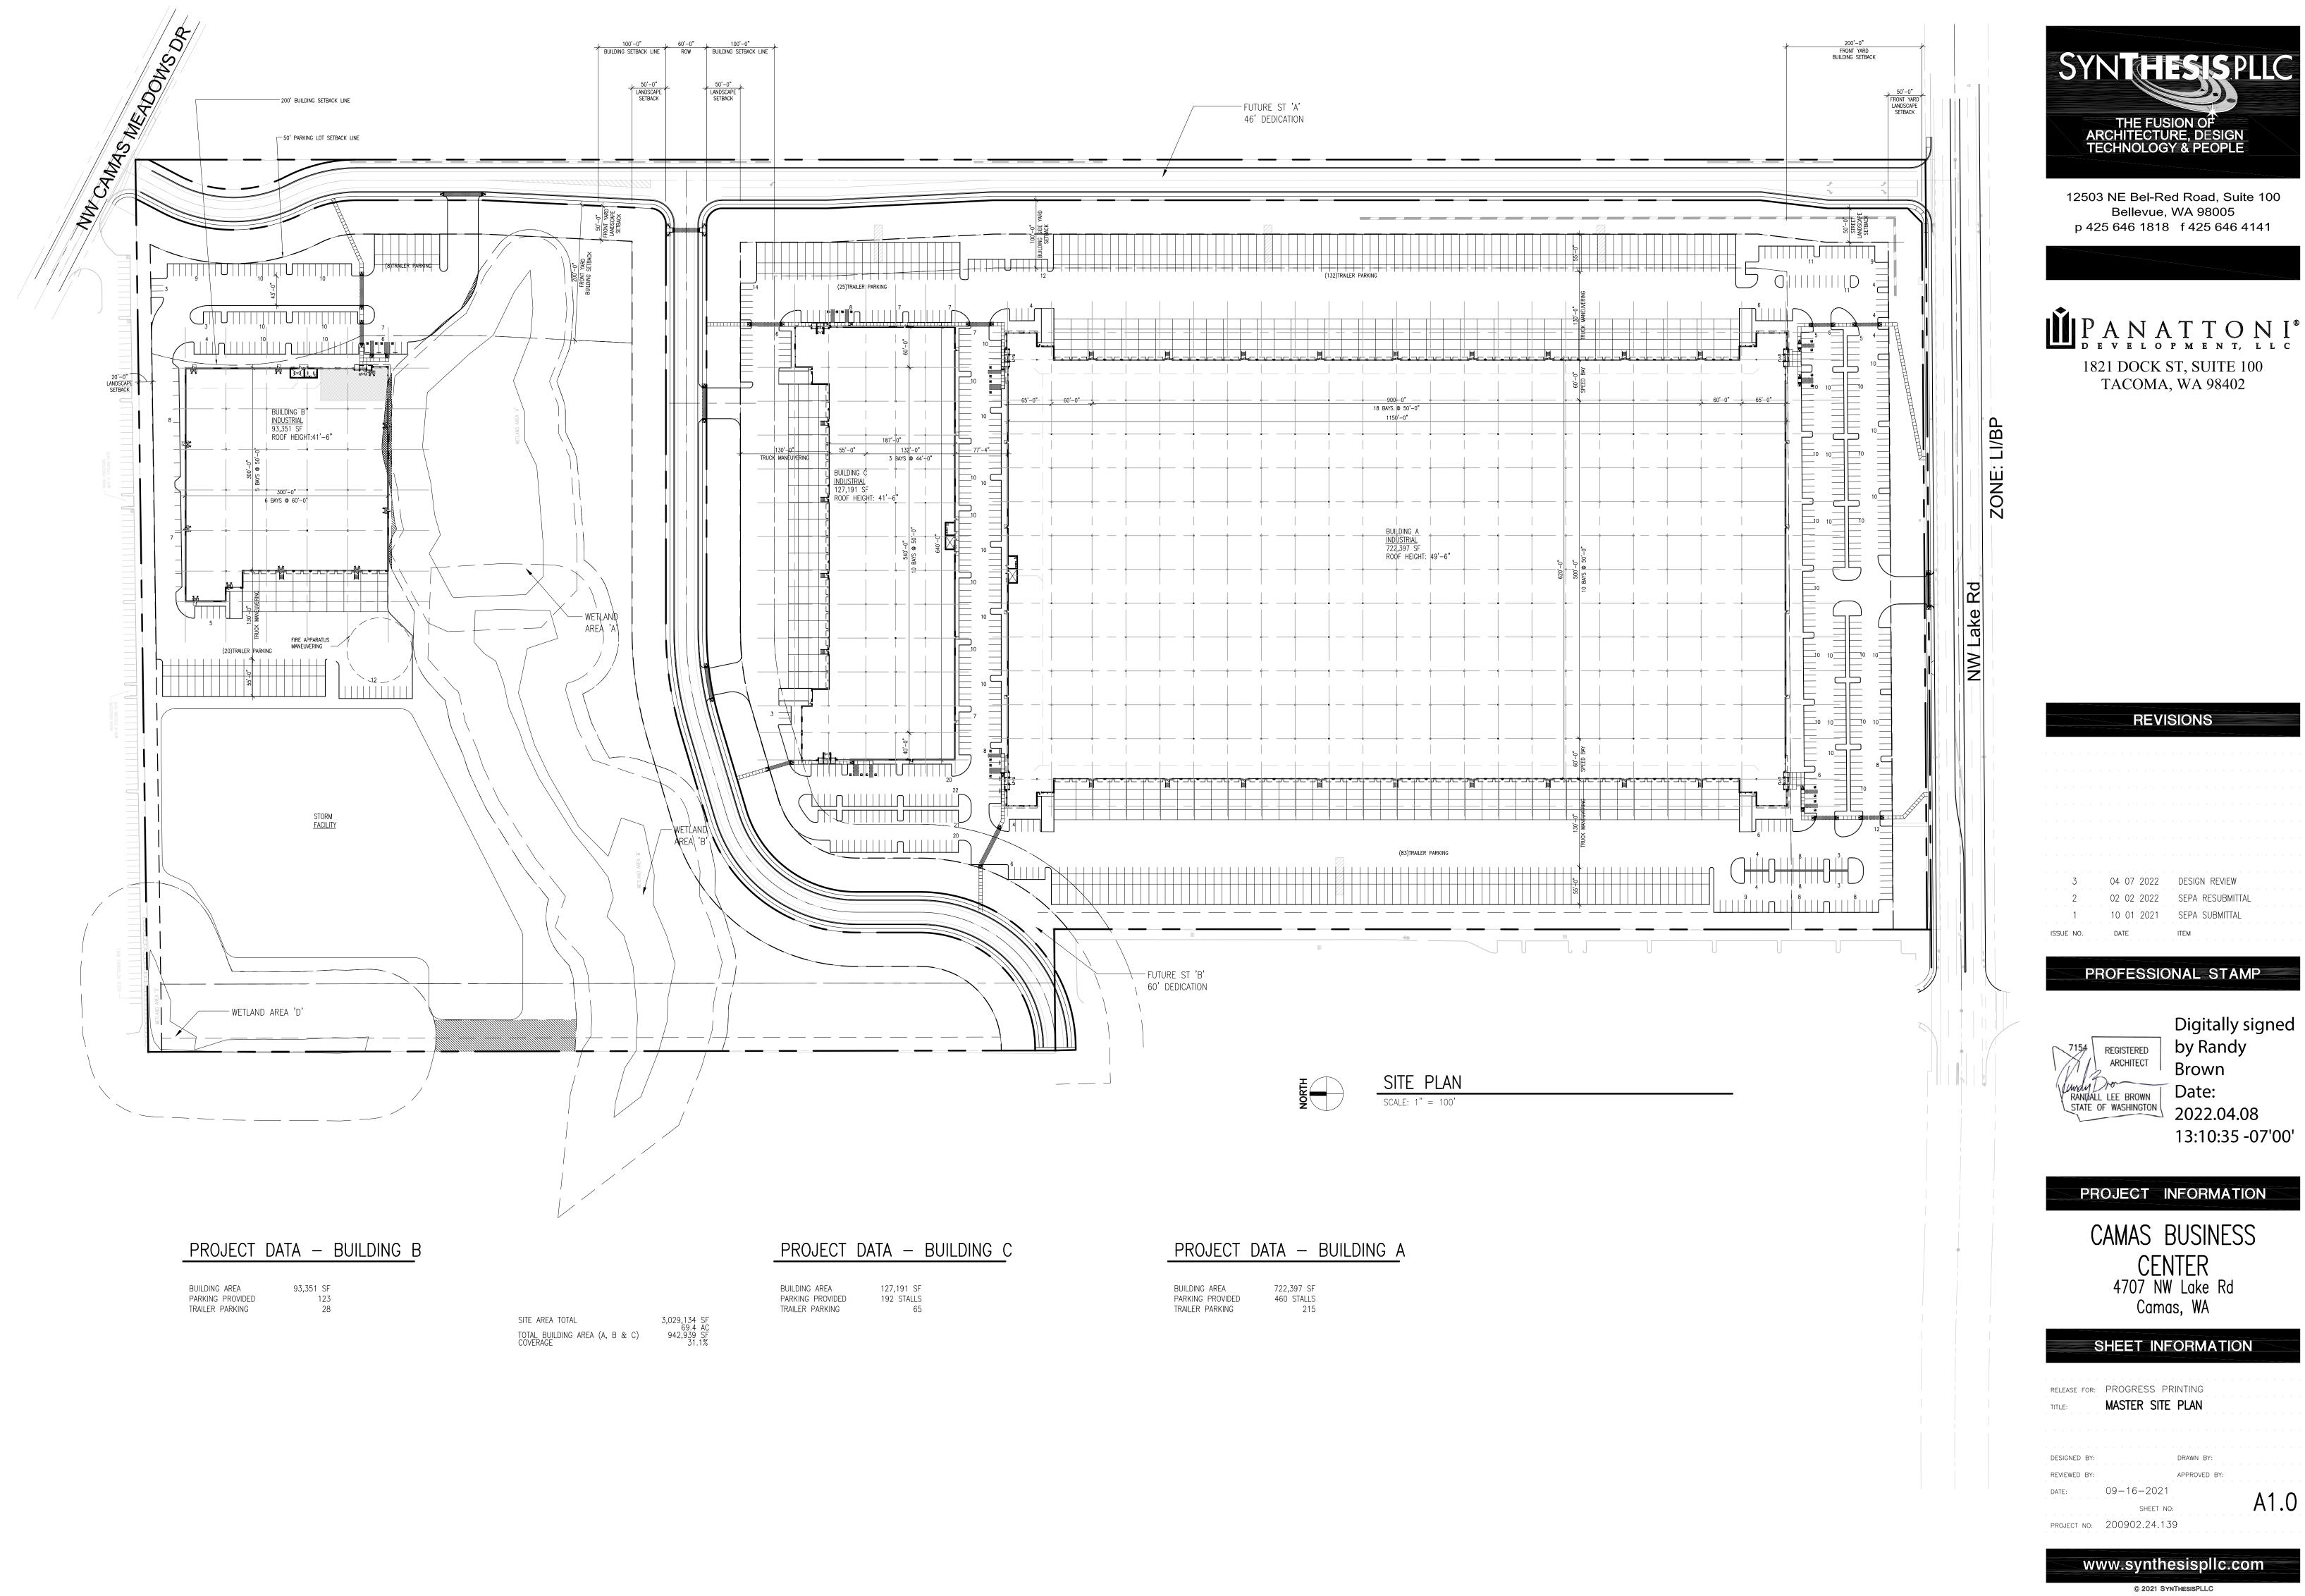


NORTH

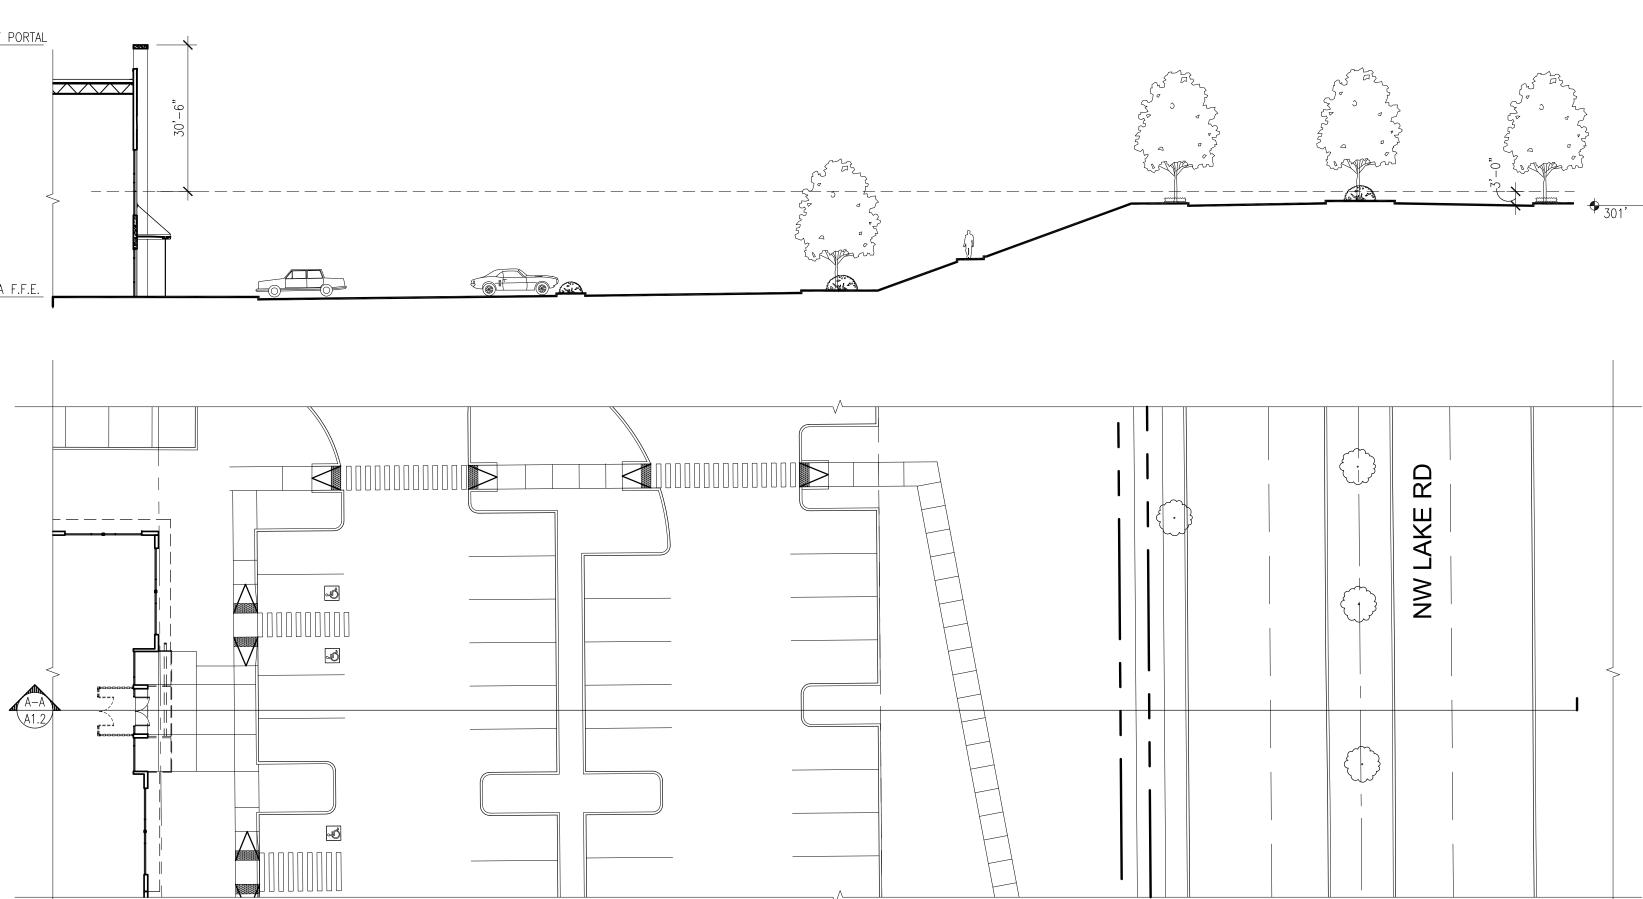
1 SE SITE SECTION A-A SCALE: 1" = 20'

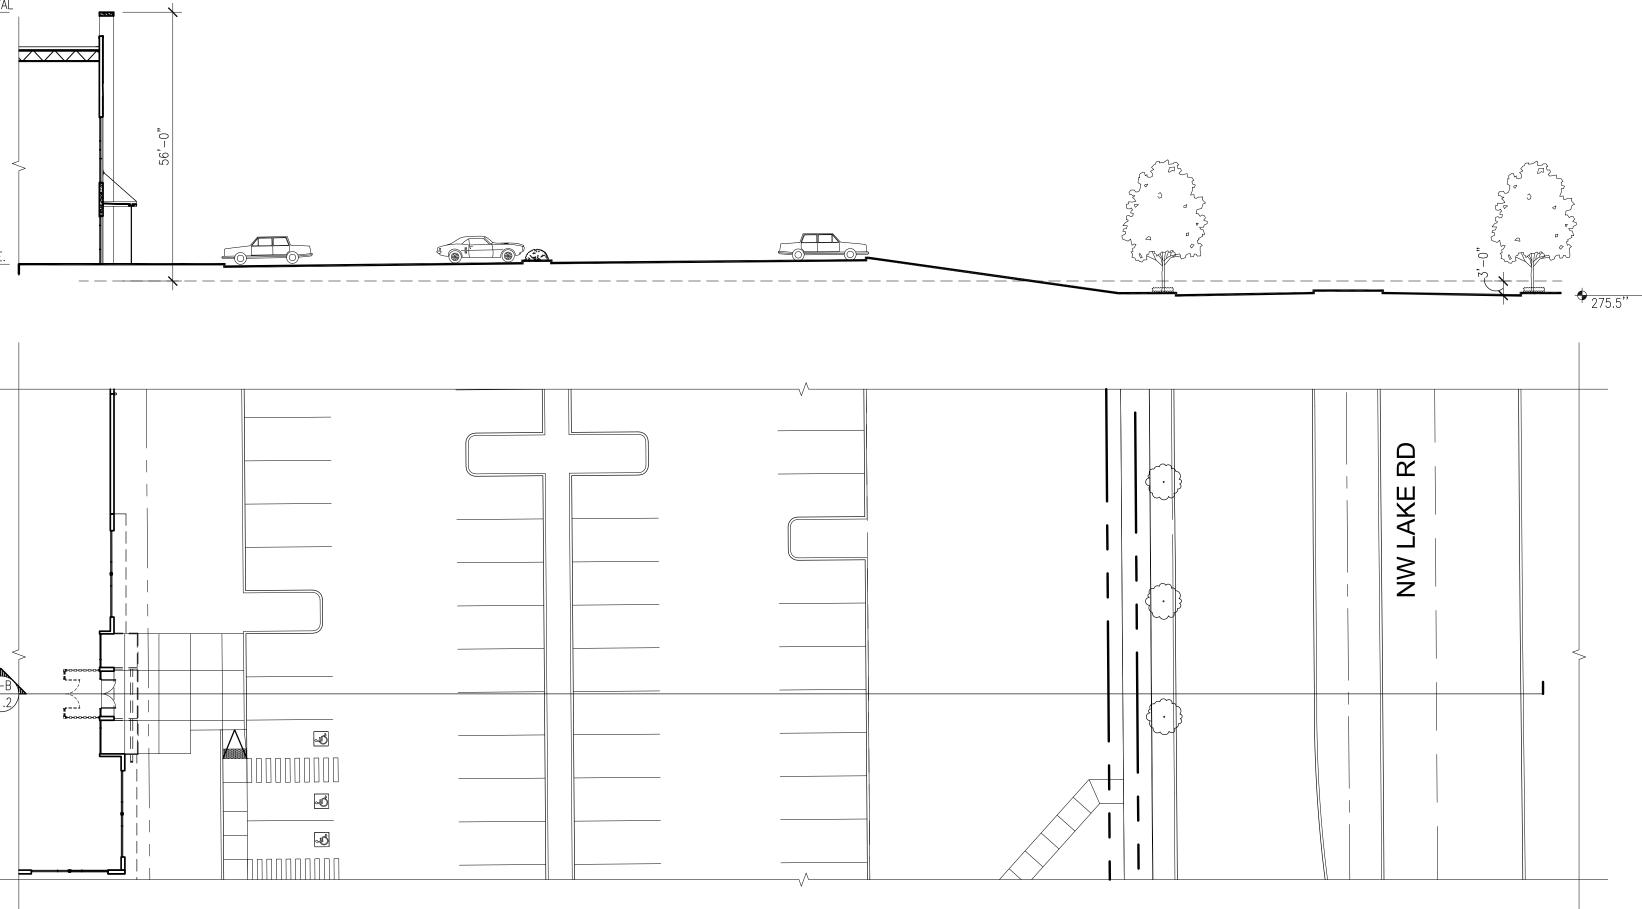





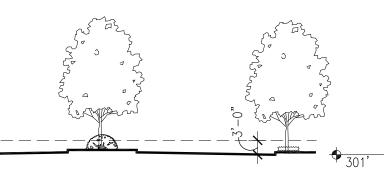

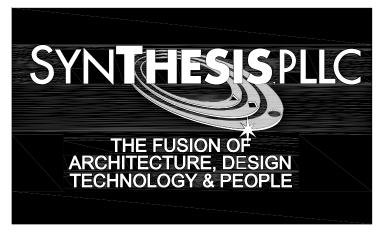


12503 NE Bel-Red Road, Suite 100 Bellevue, WA 98005 p 425 646 1818 f 425 646 4141

PANATTONIC DEVELOPMENT, LLC 1821 DOCK ST, SUITE 100 TACOMA, WA 98402

REVISIONS

3	04 07 2022	DESIGN REVIEW					
2	02 02 2022	SEPA RESUBMITTAL					
1		SEPA SUBMITTAL					
ISSUE NO.	DATE	ITEM					

PROFESSIONAL STAMP

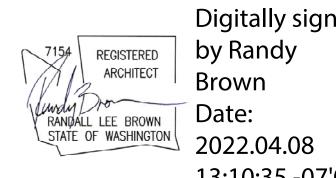

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PROJECT INFORMATION

CAMAS B	USINESS								
CENTER 4707 NW Lake Rd Camas, WA									

SHEET INFORMATION

TITLE:

RELEASE FOR: PROGRESS PRINTING SITE SECTIONS


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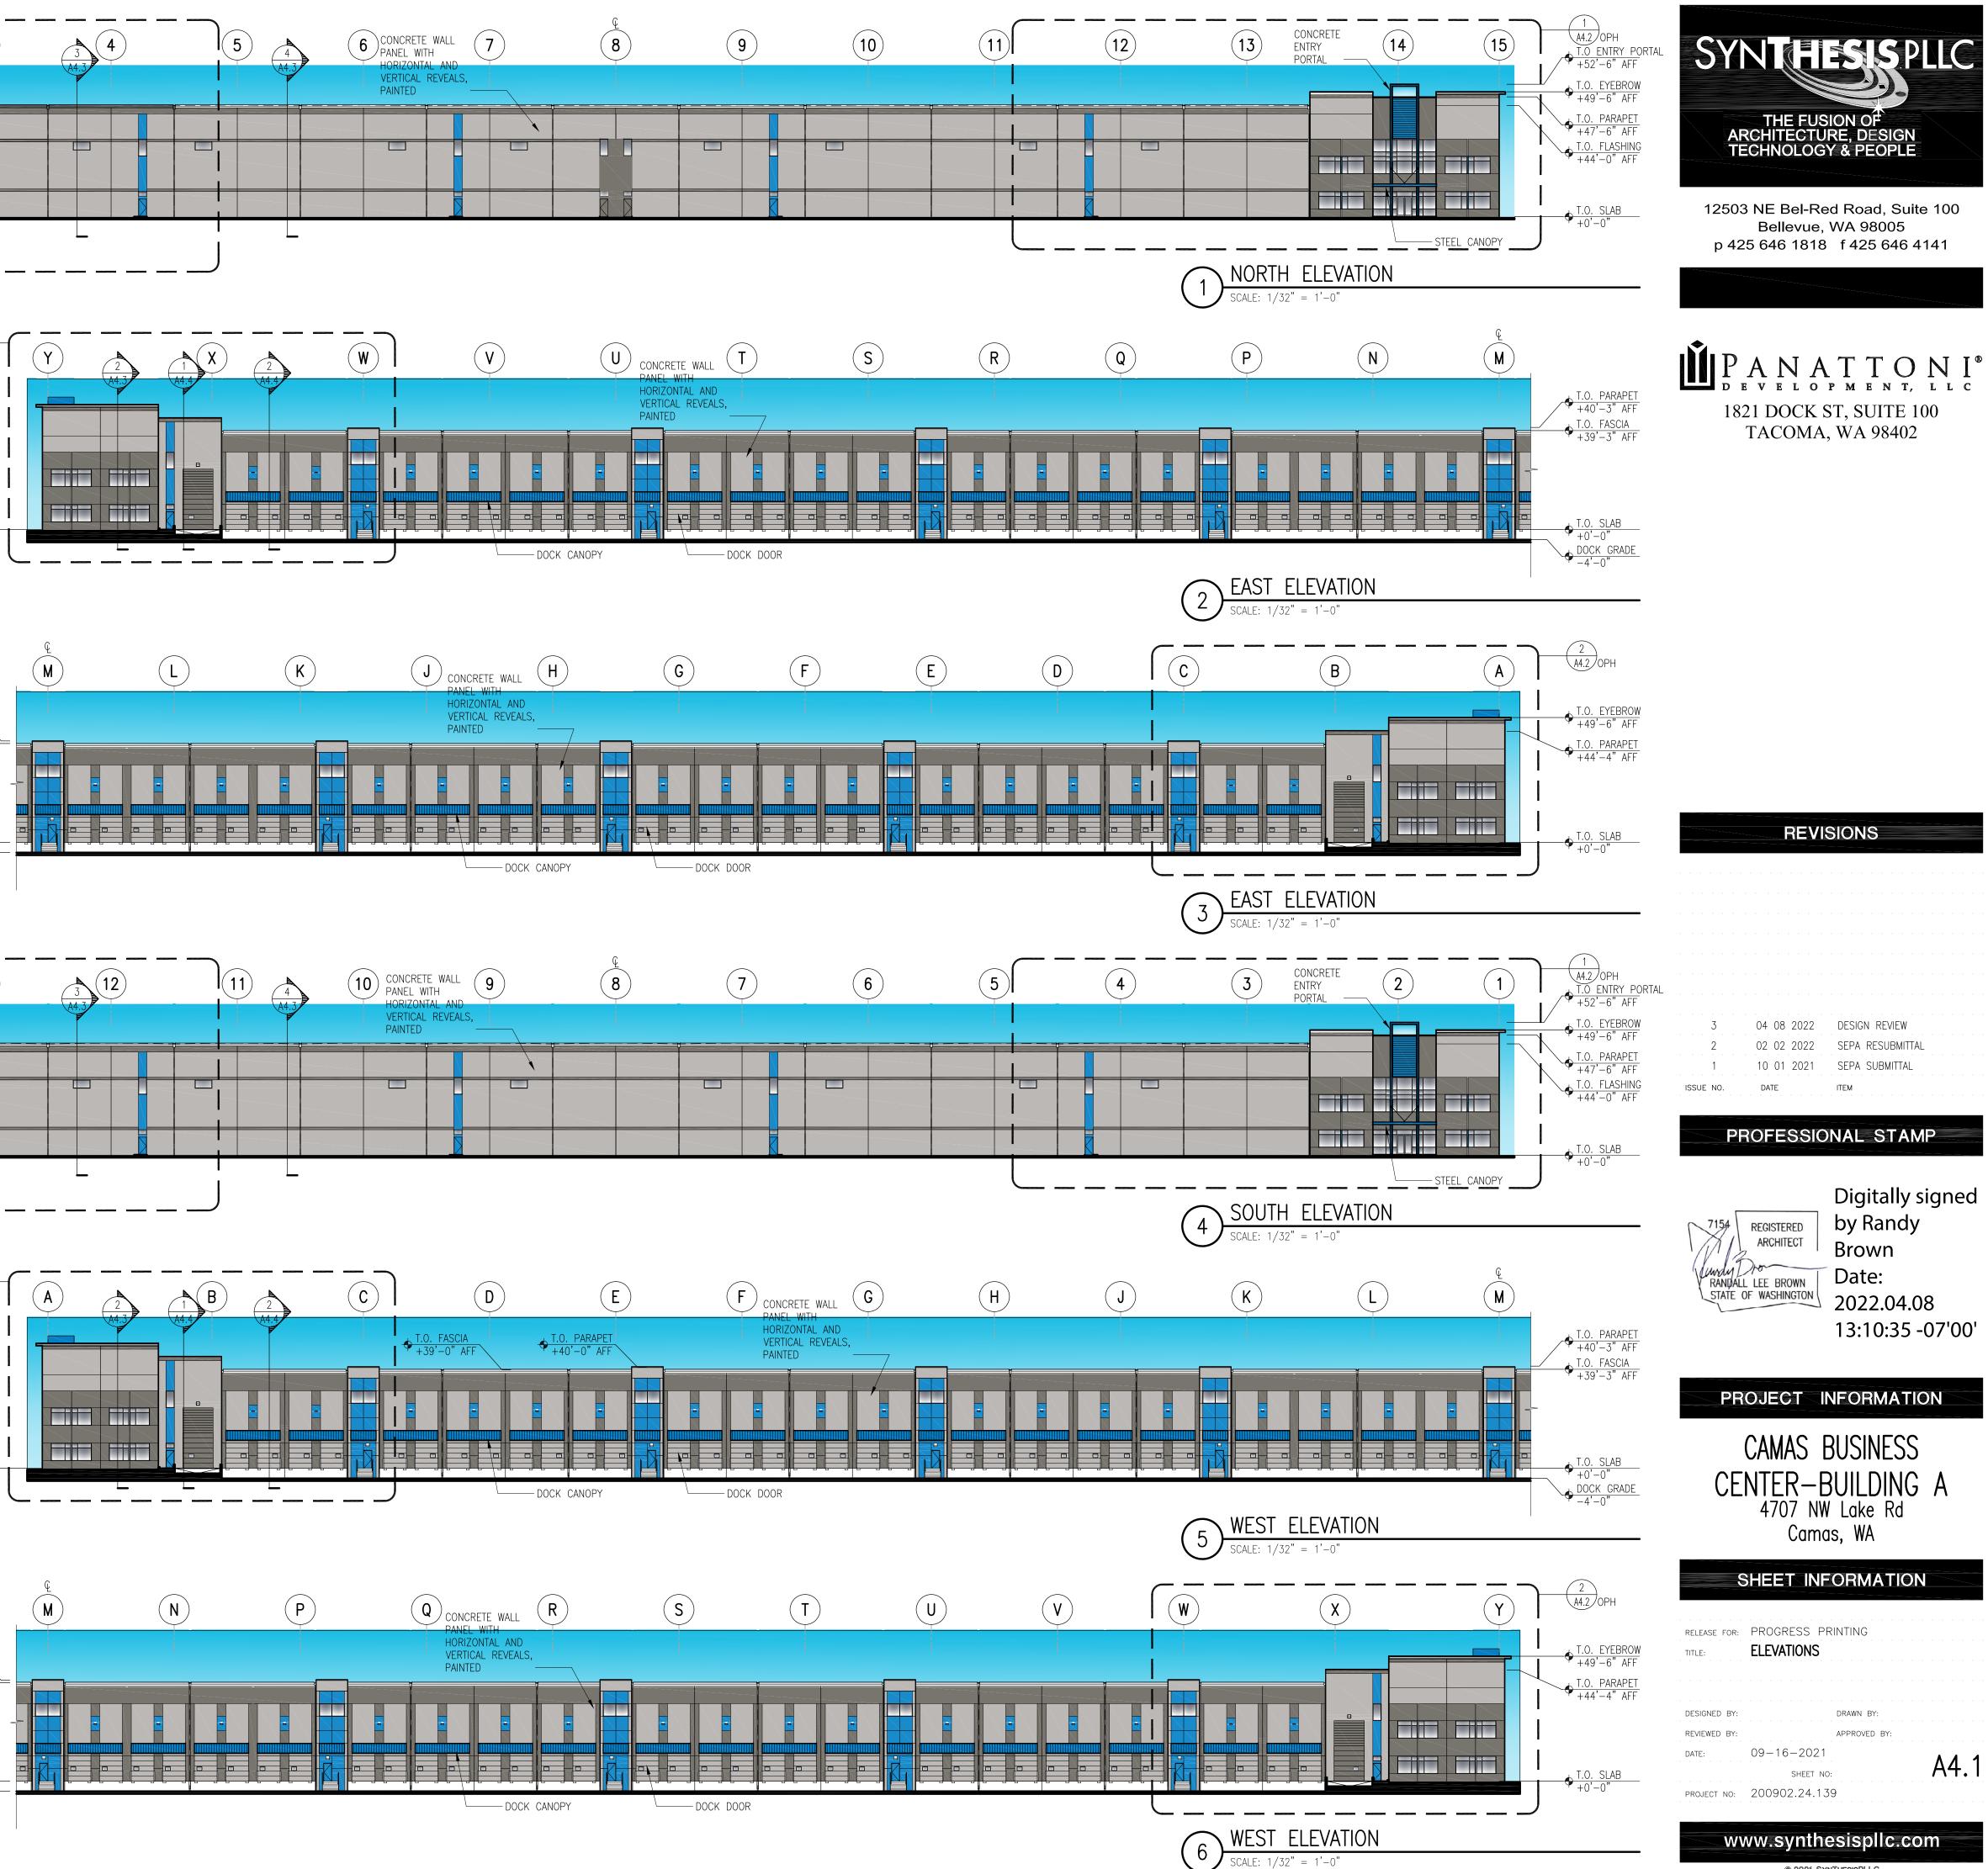
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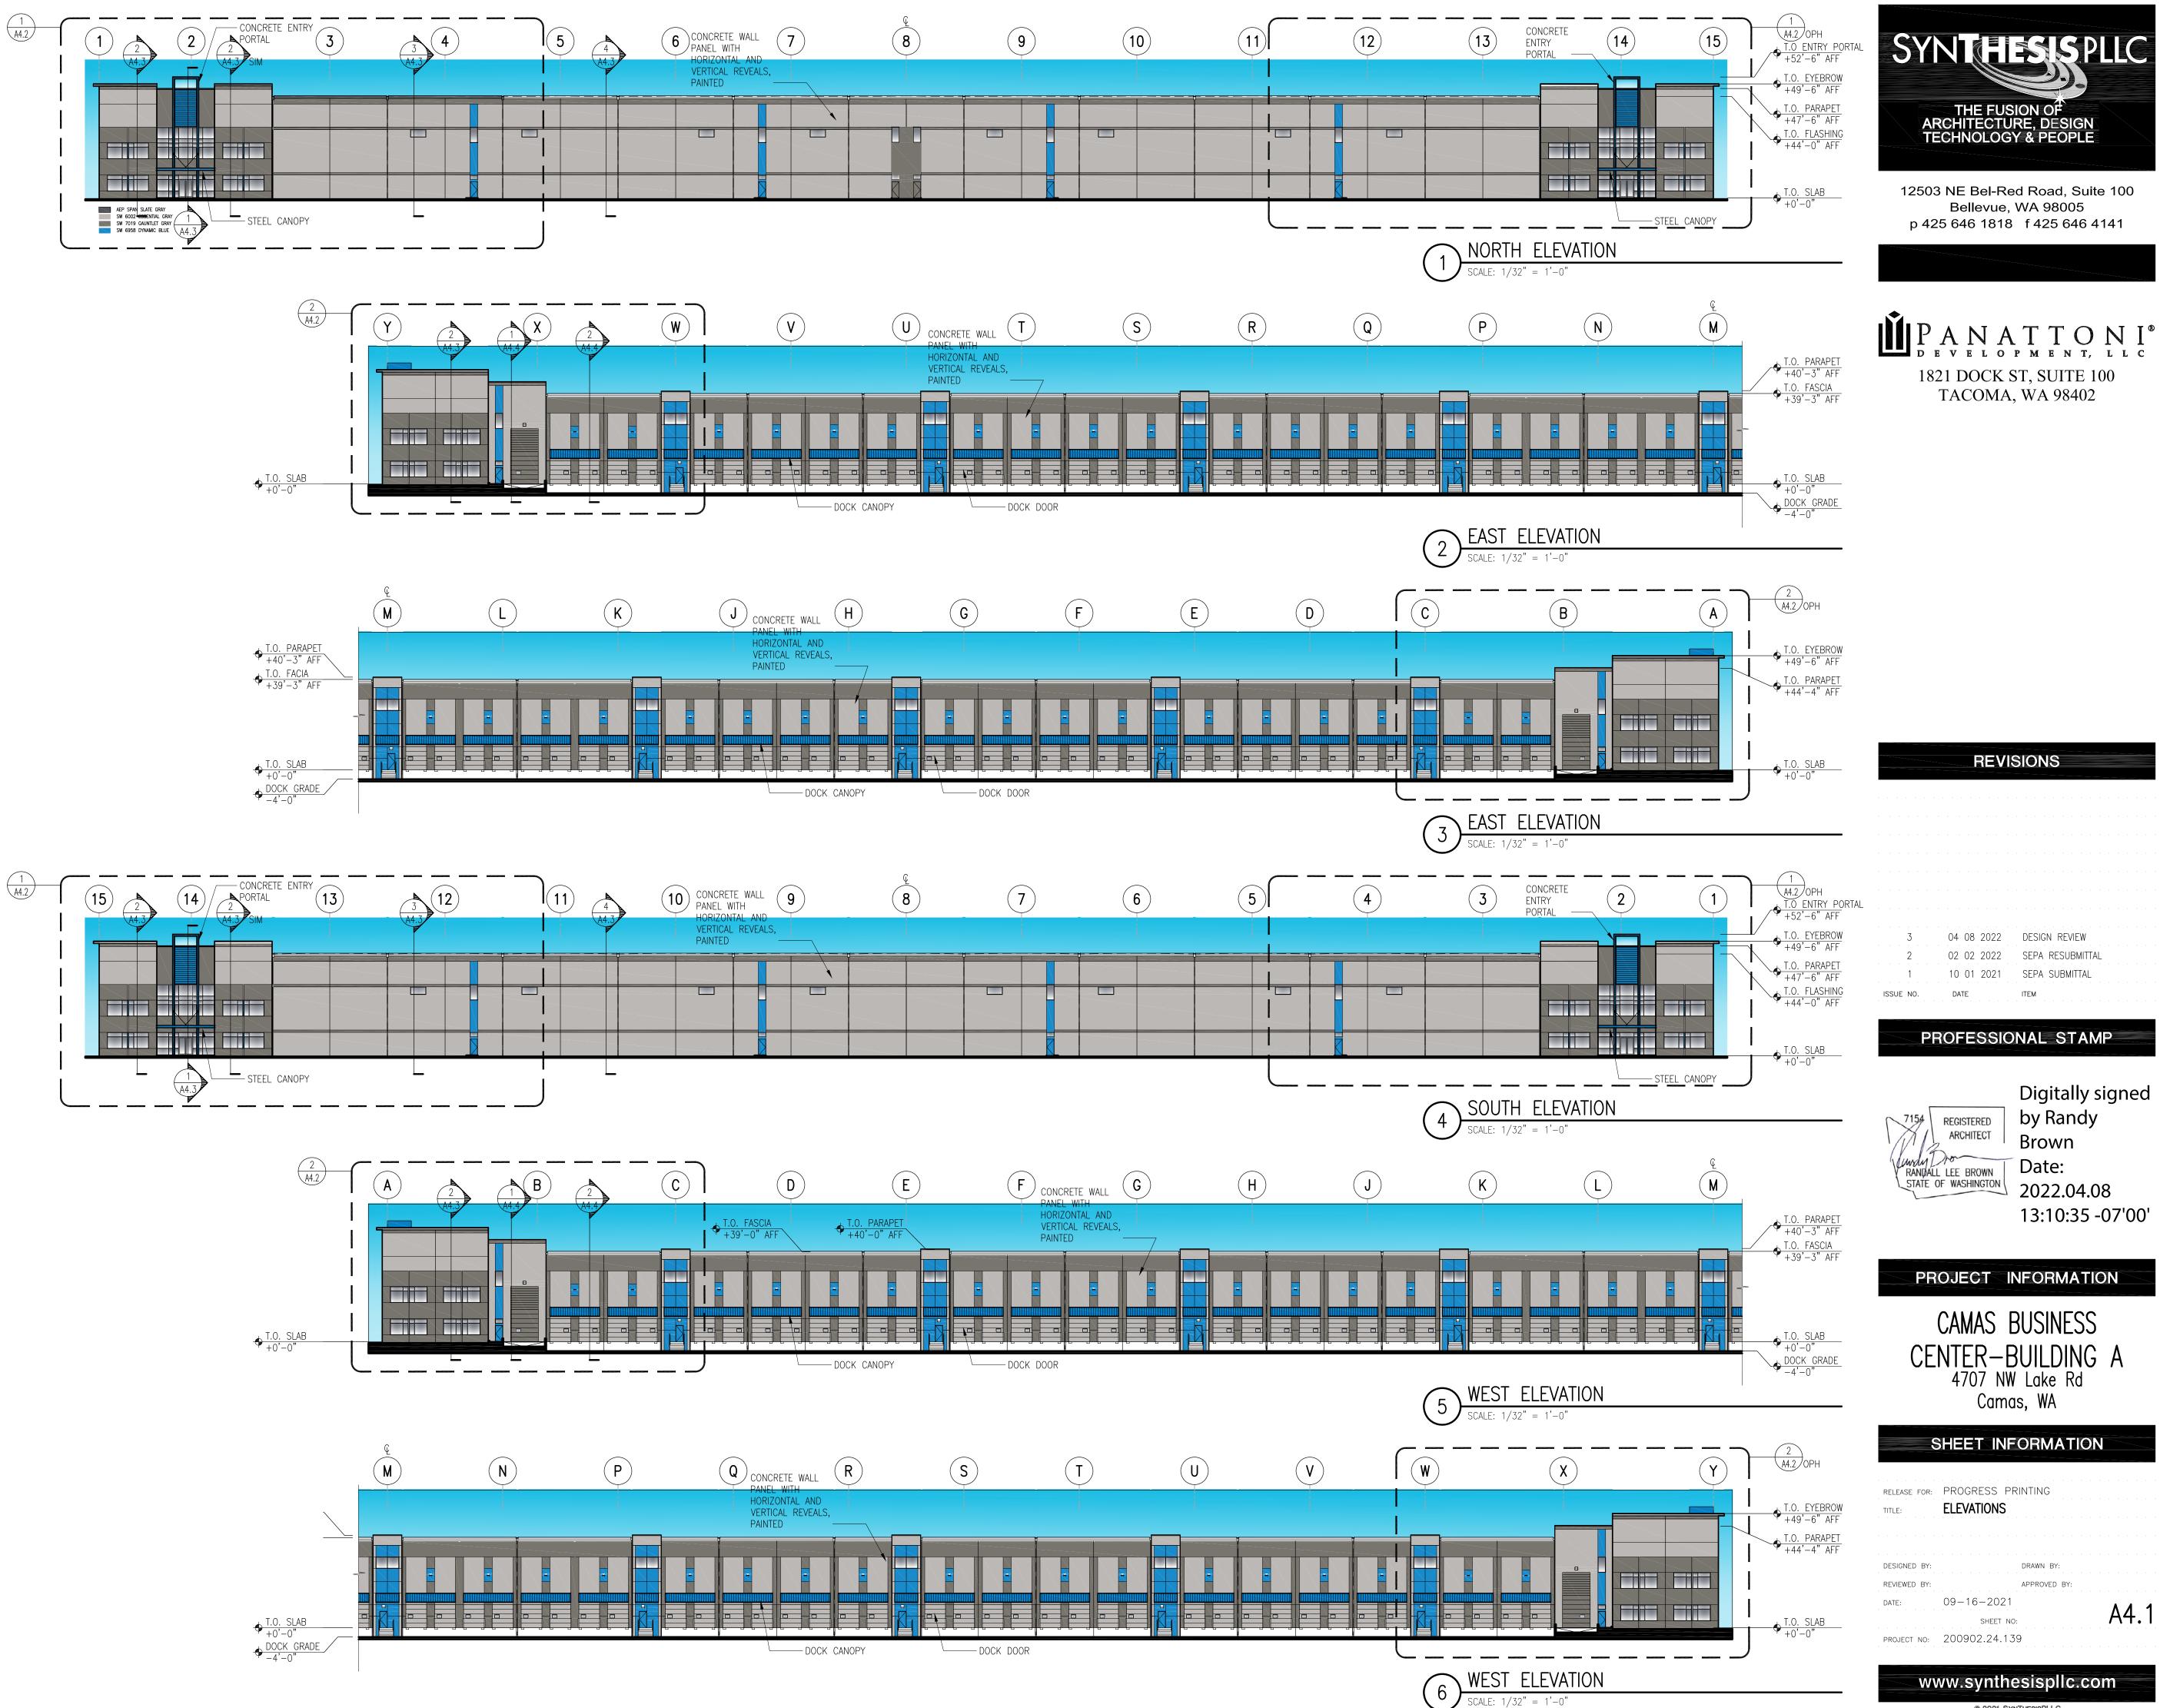
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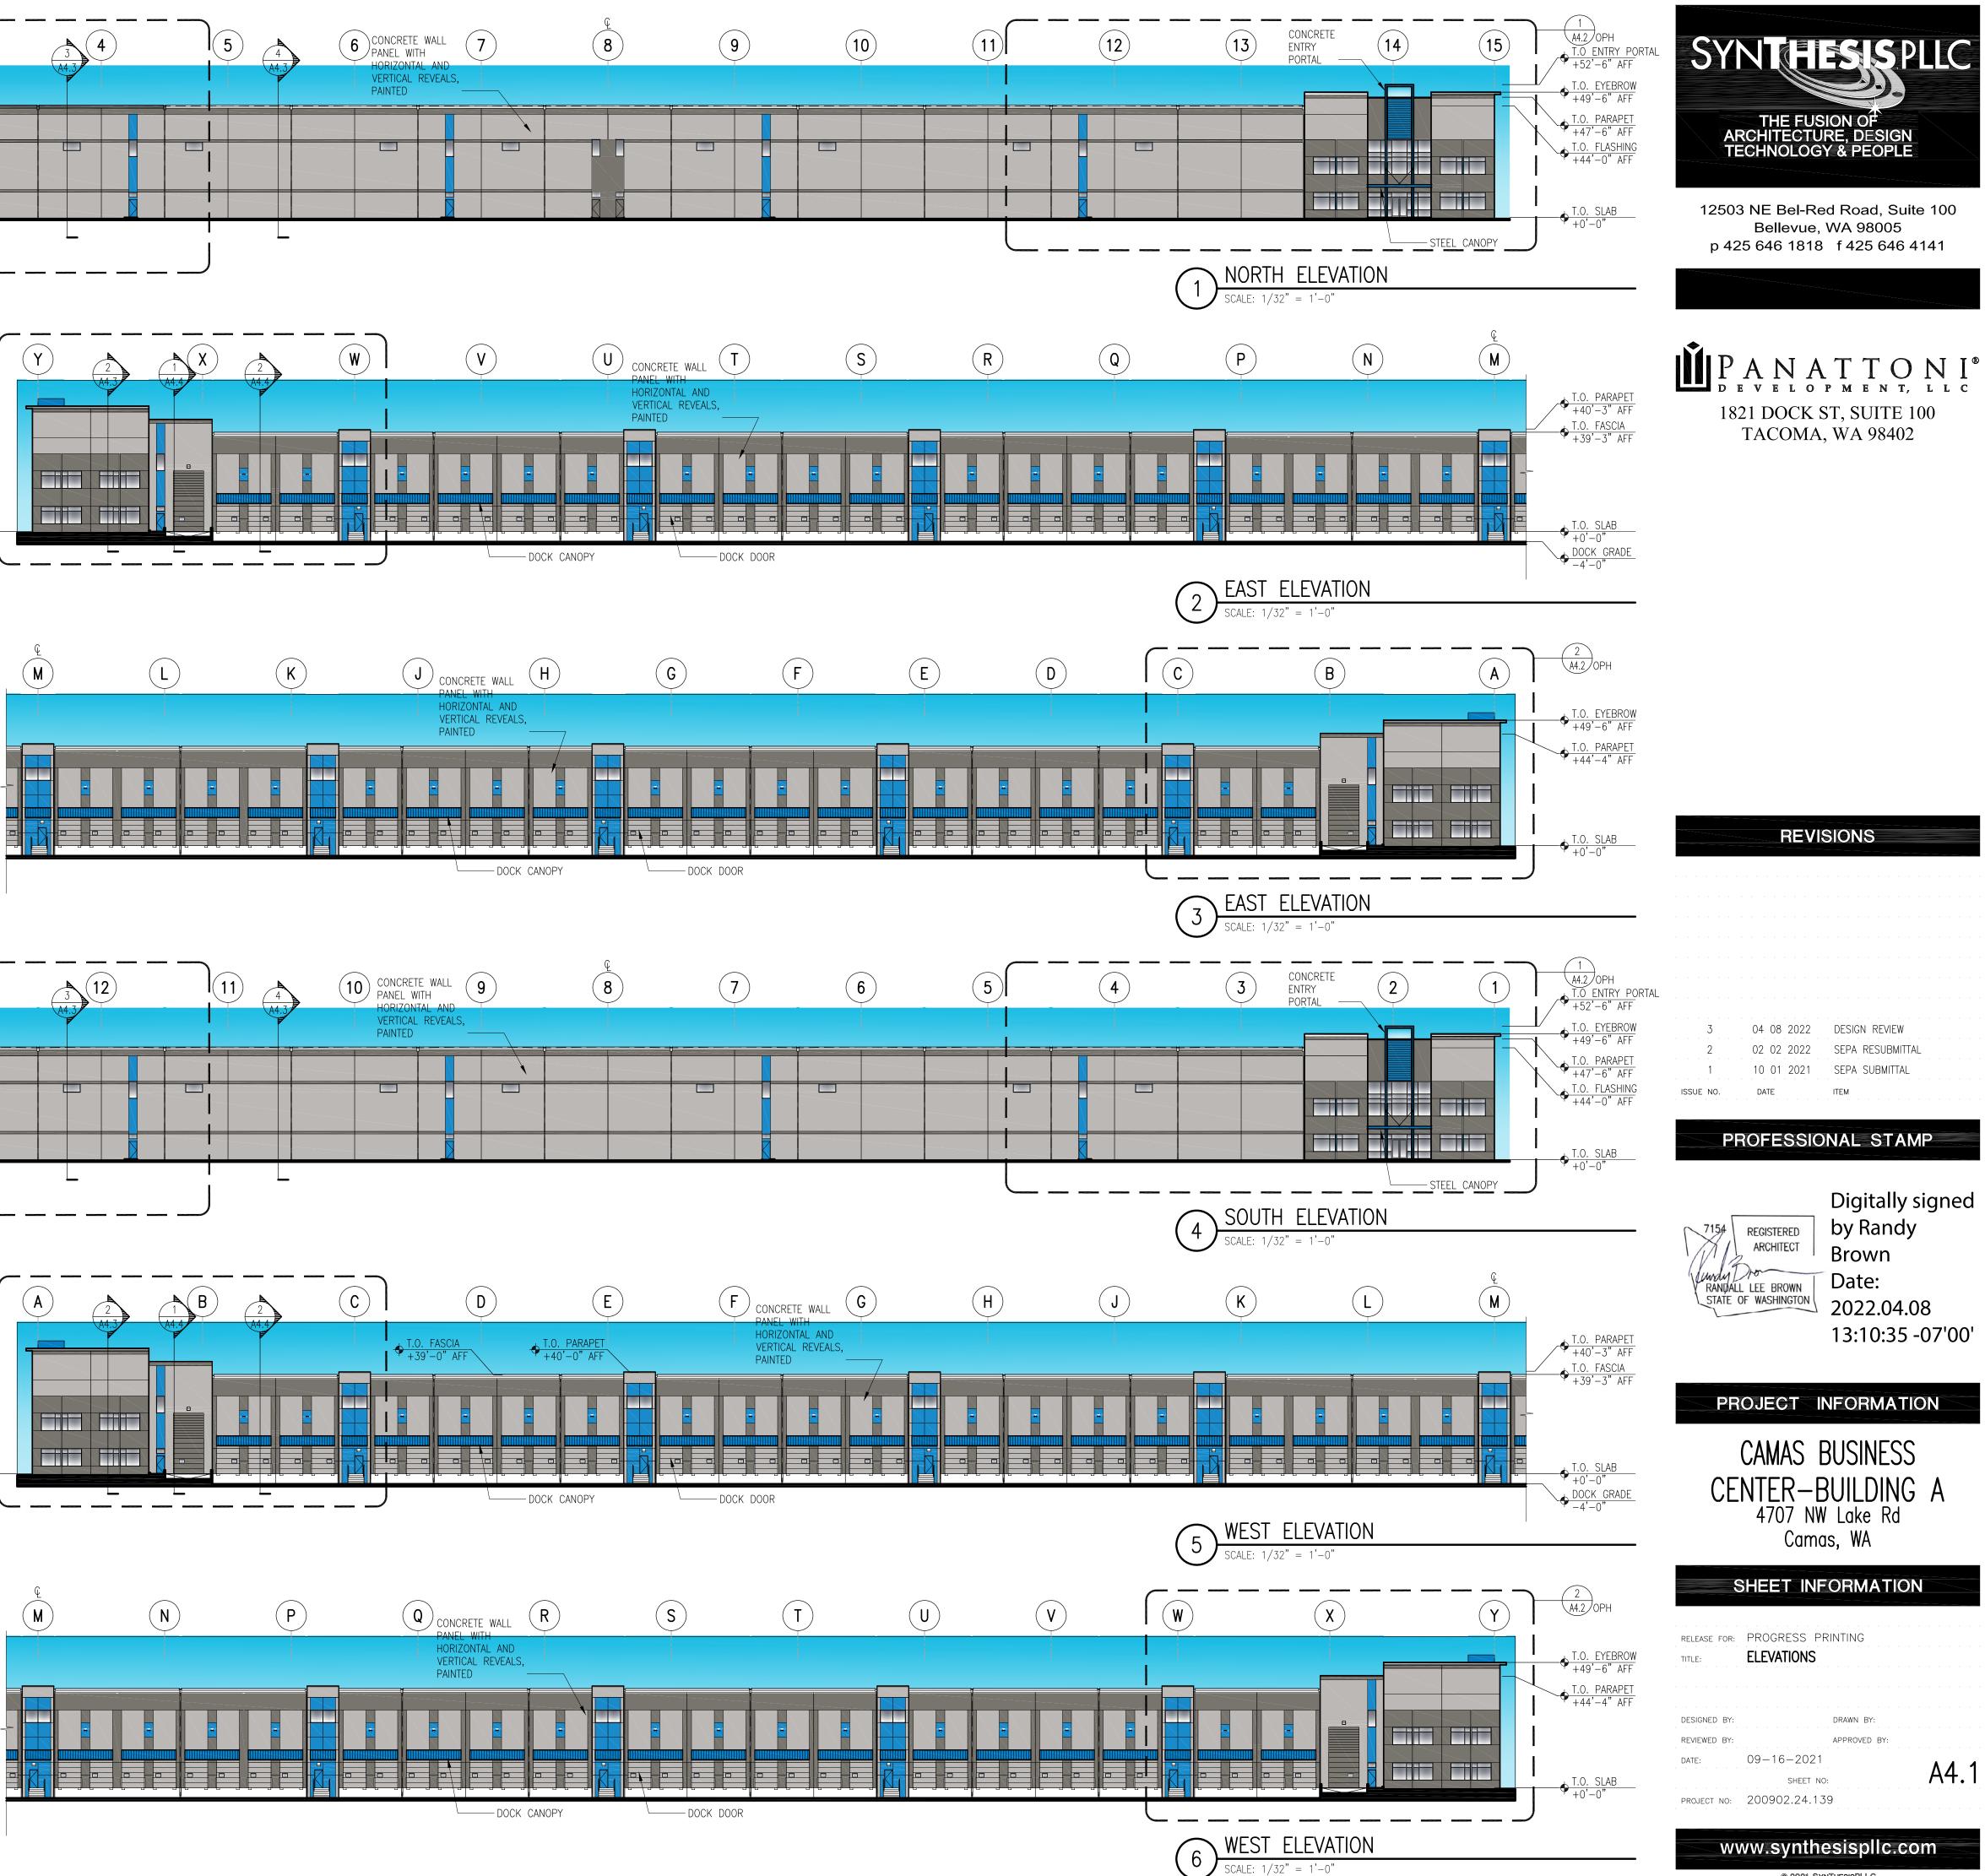
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PROJECT NO: 200902.24.139











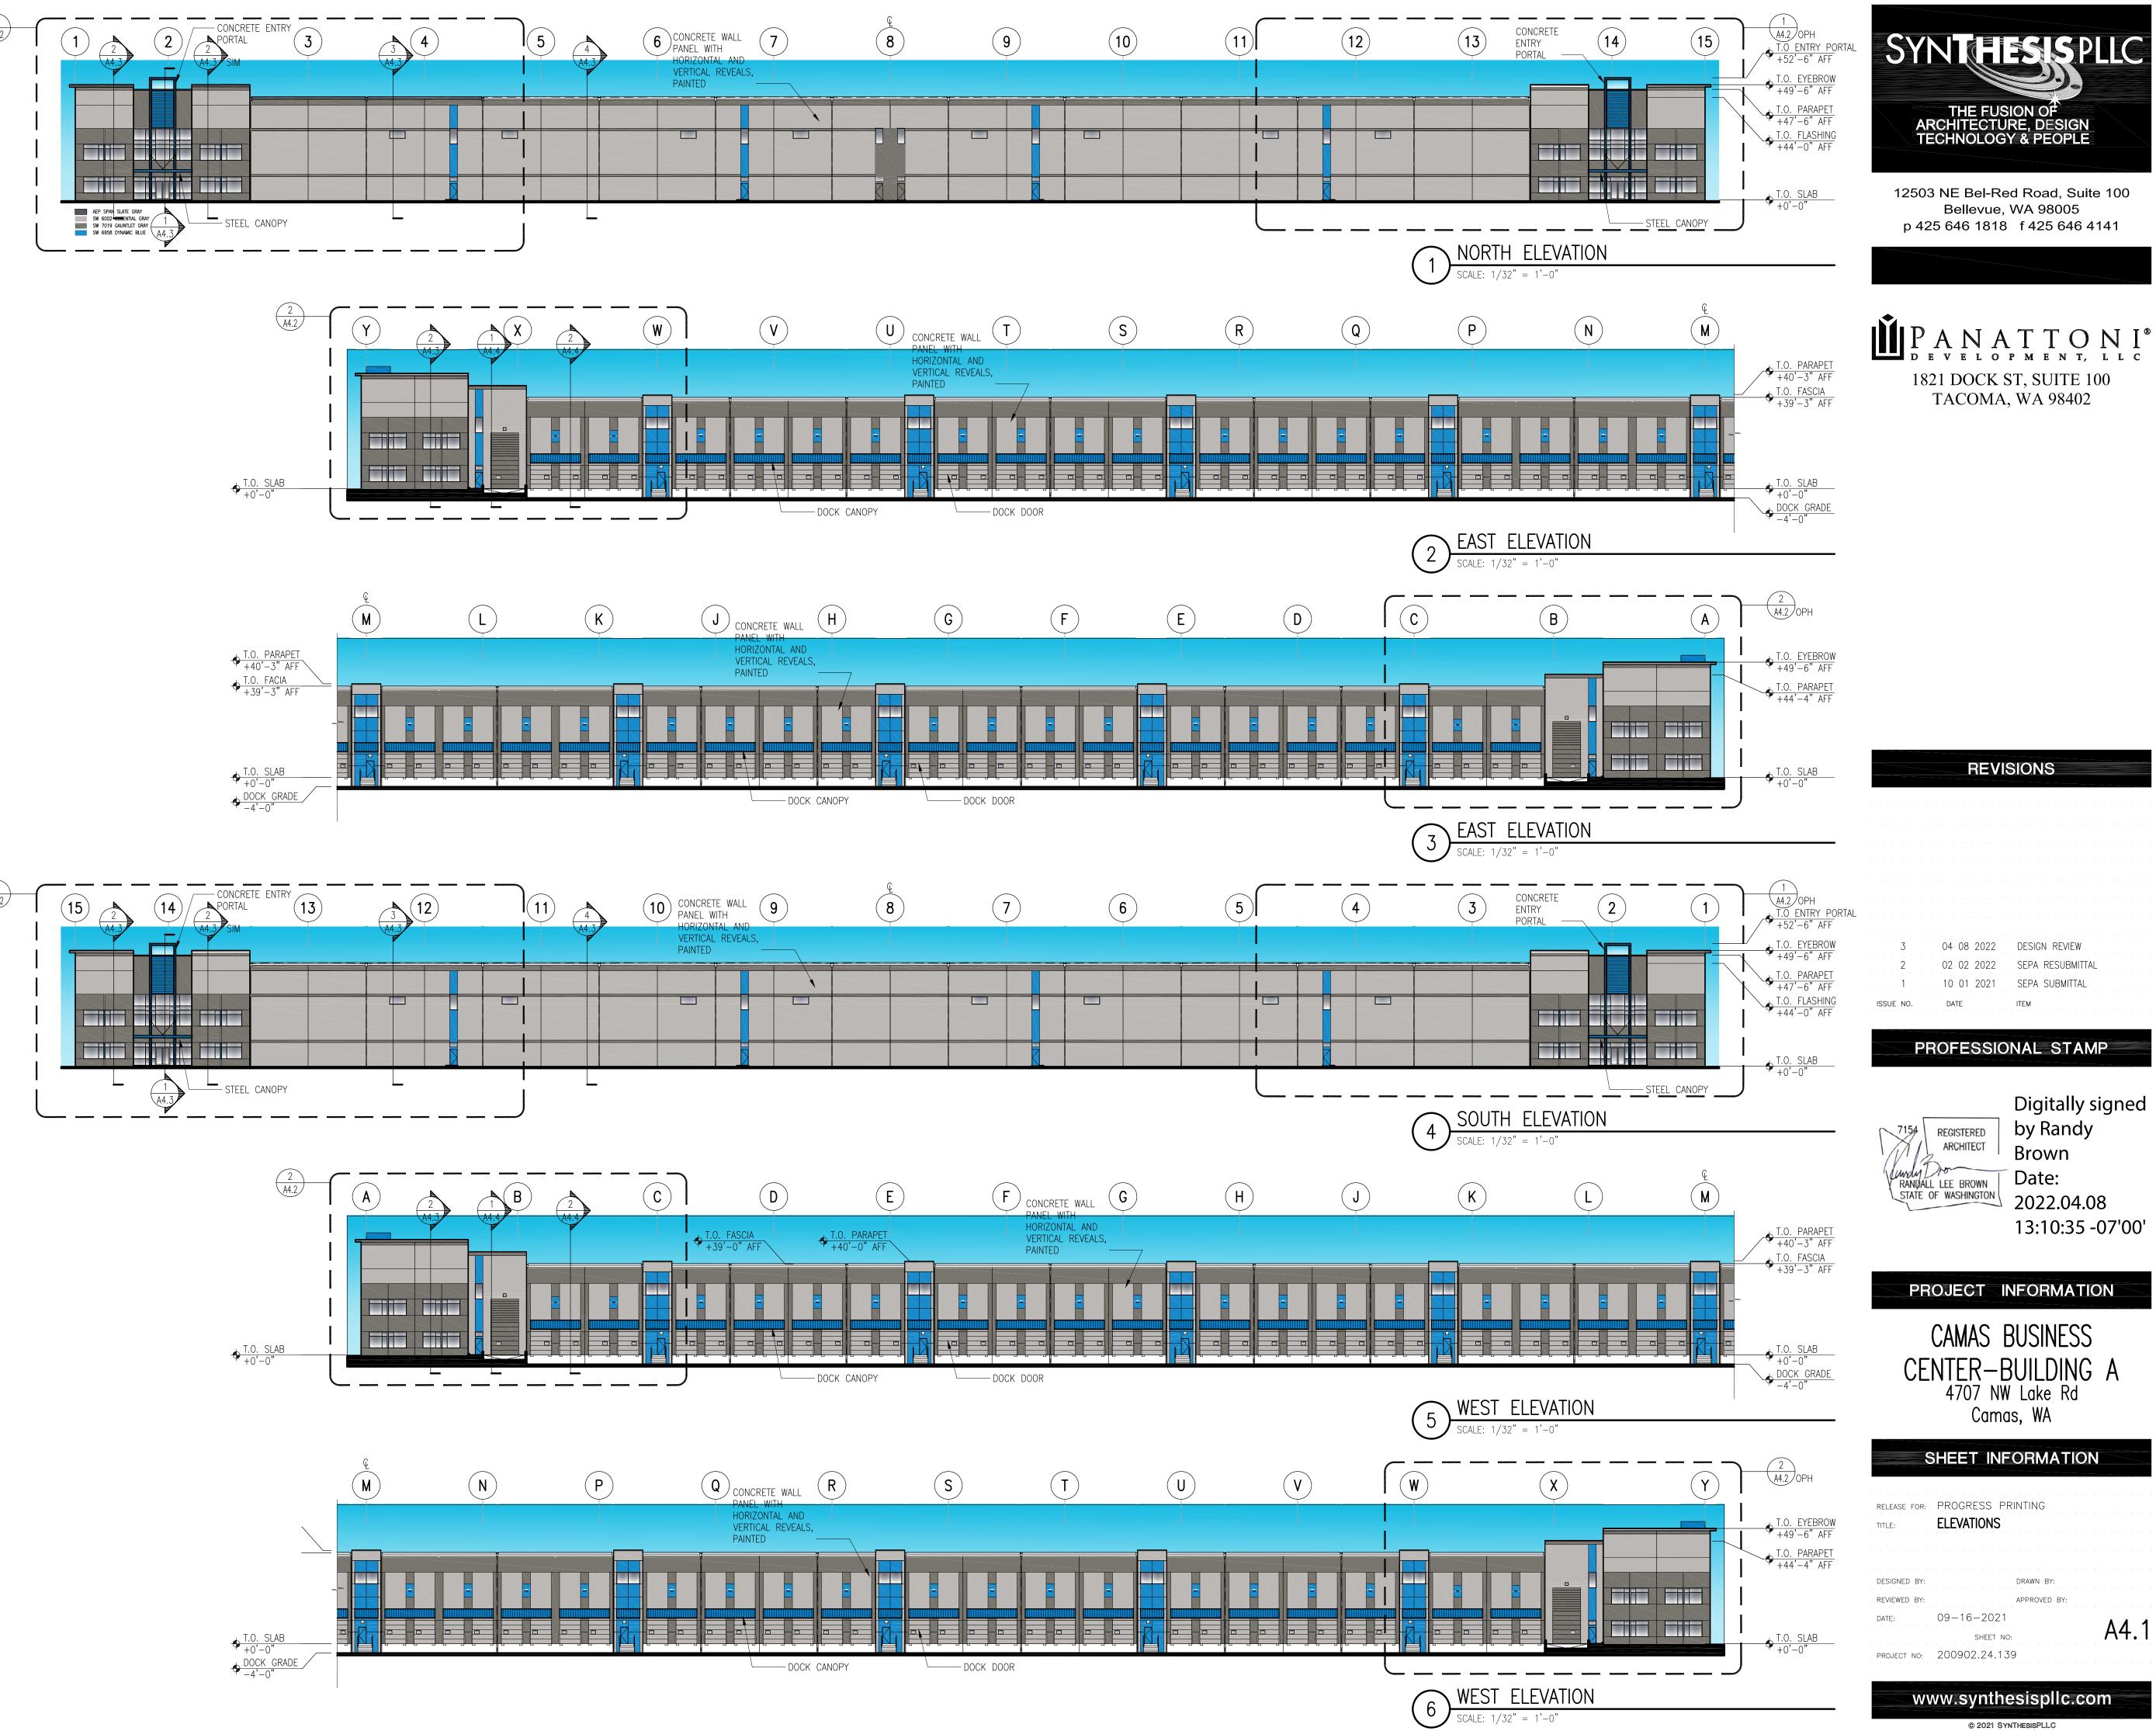

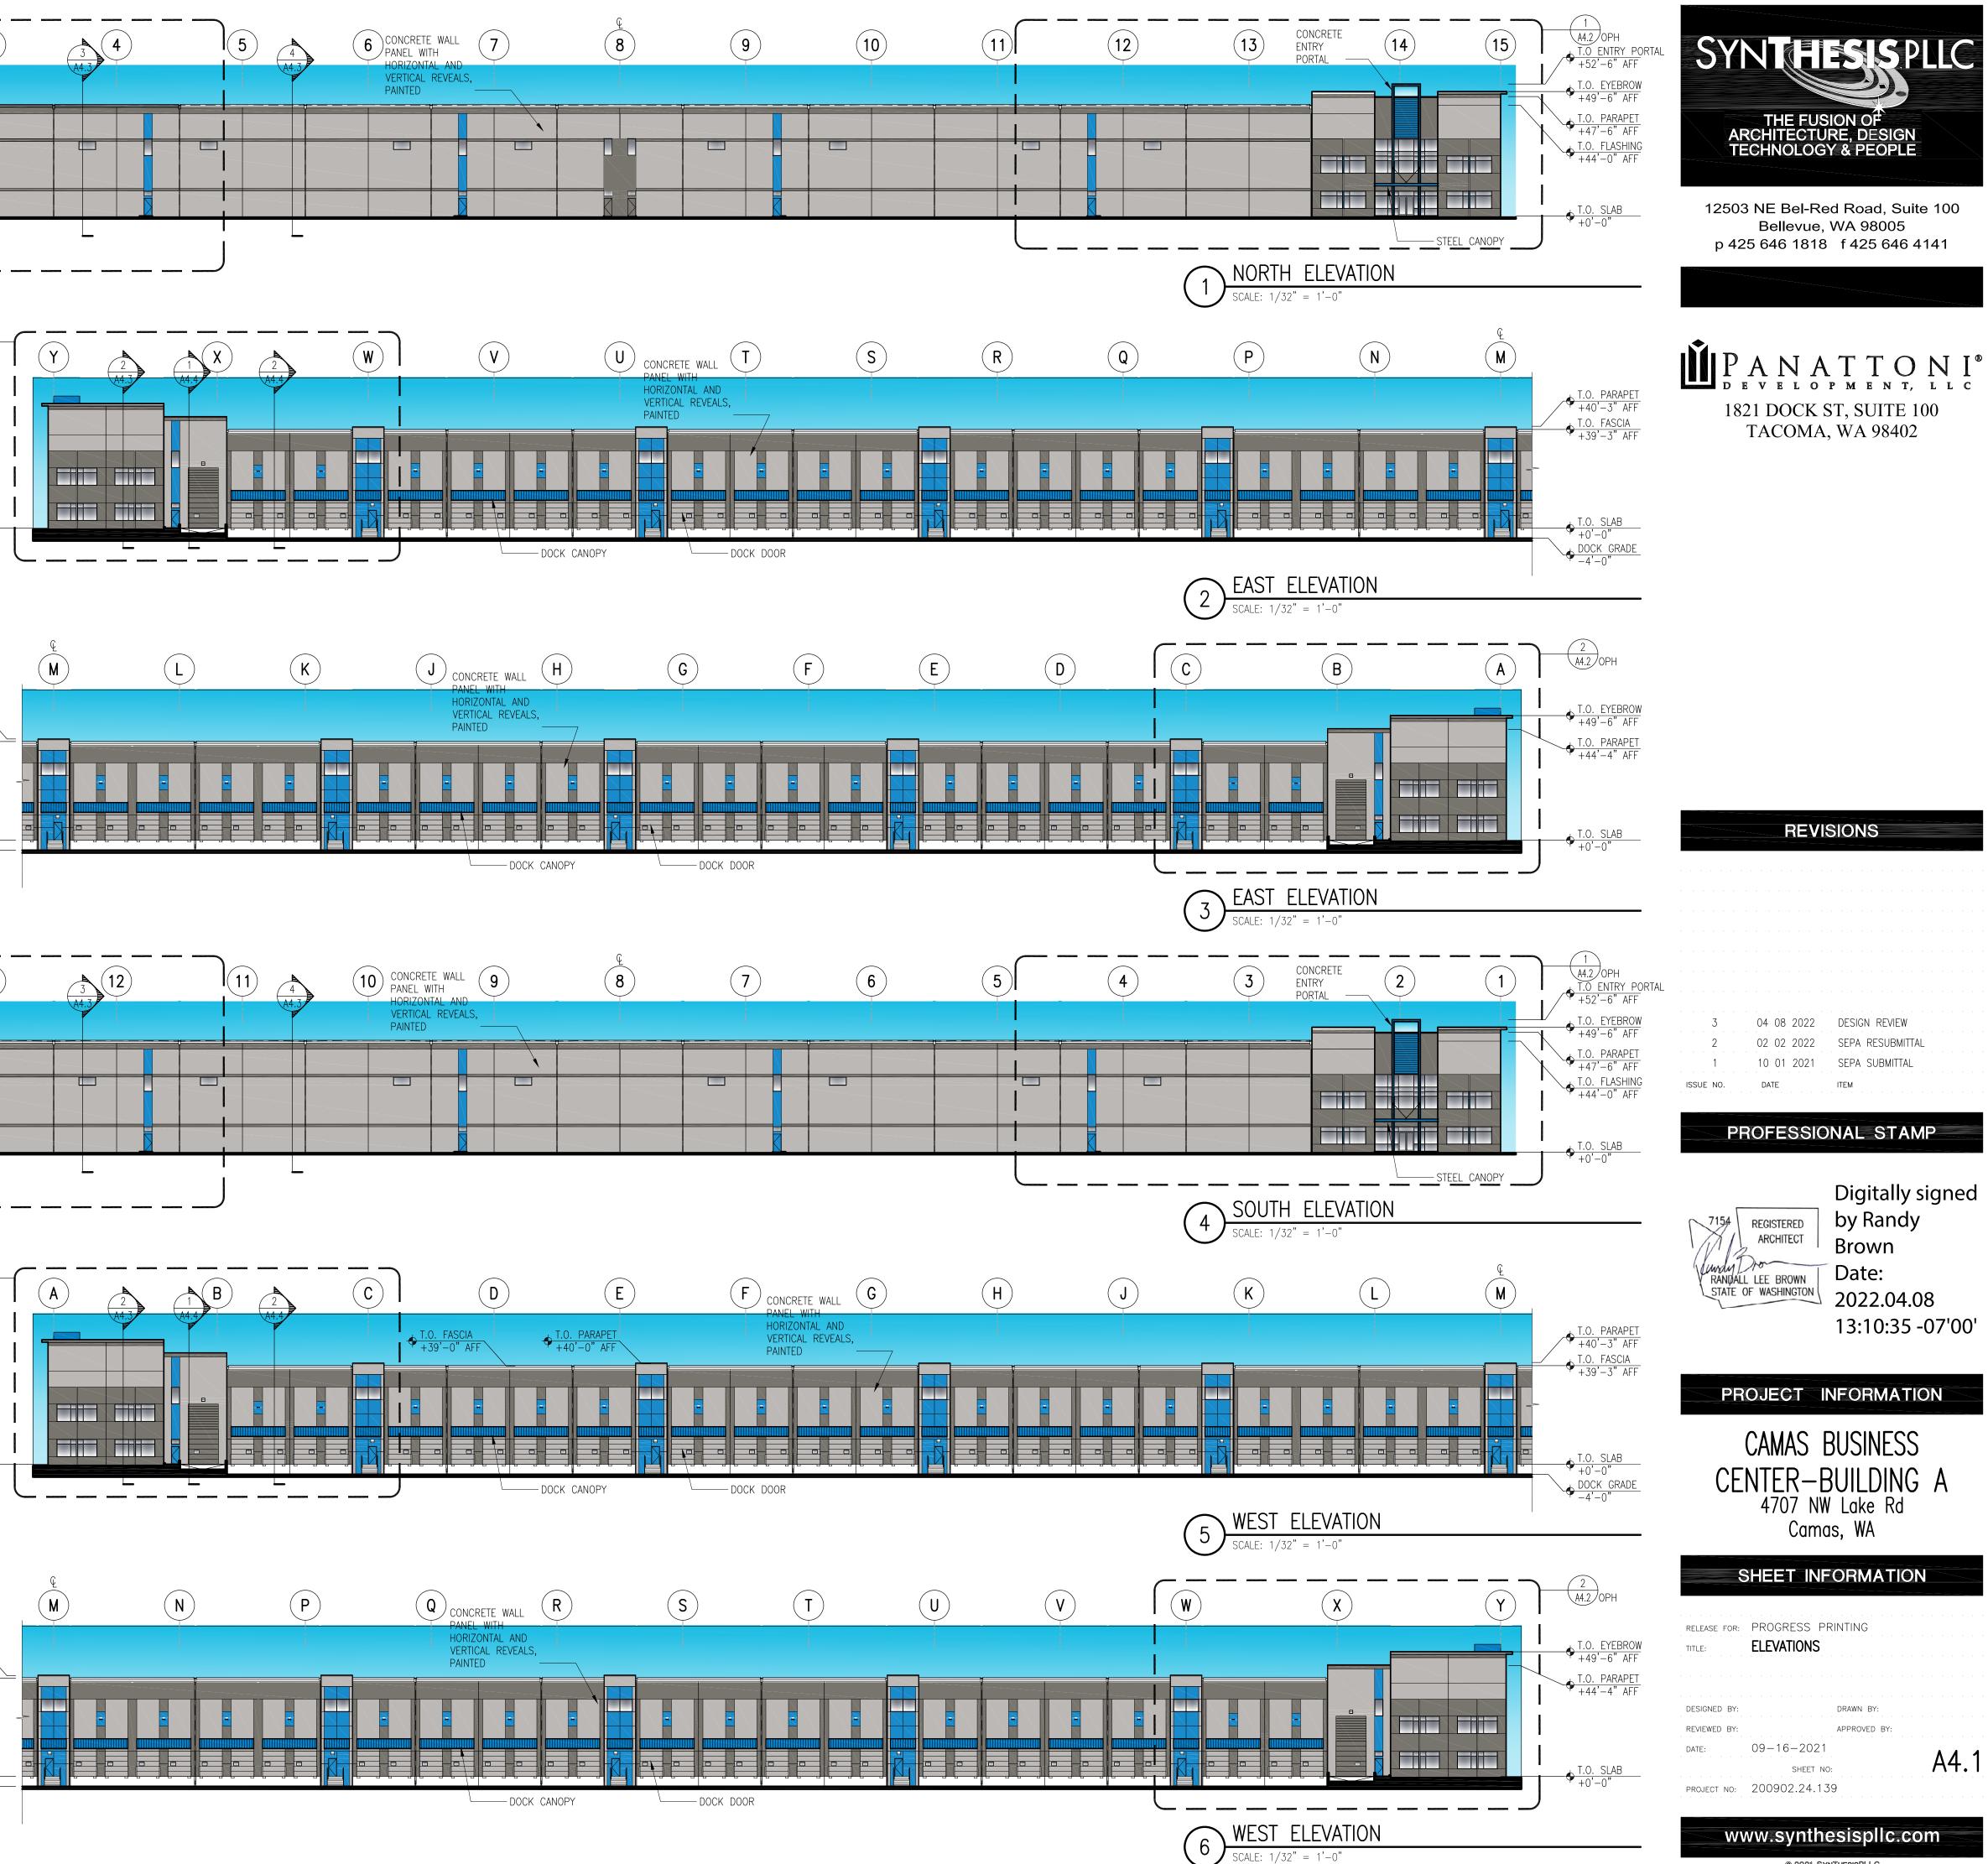






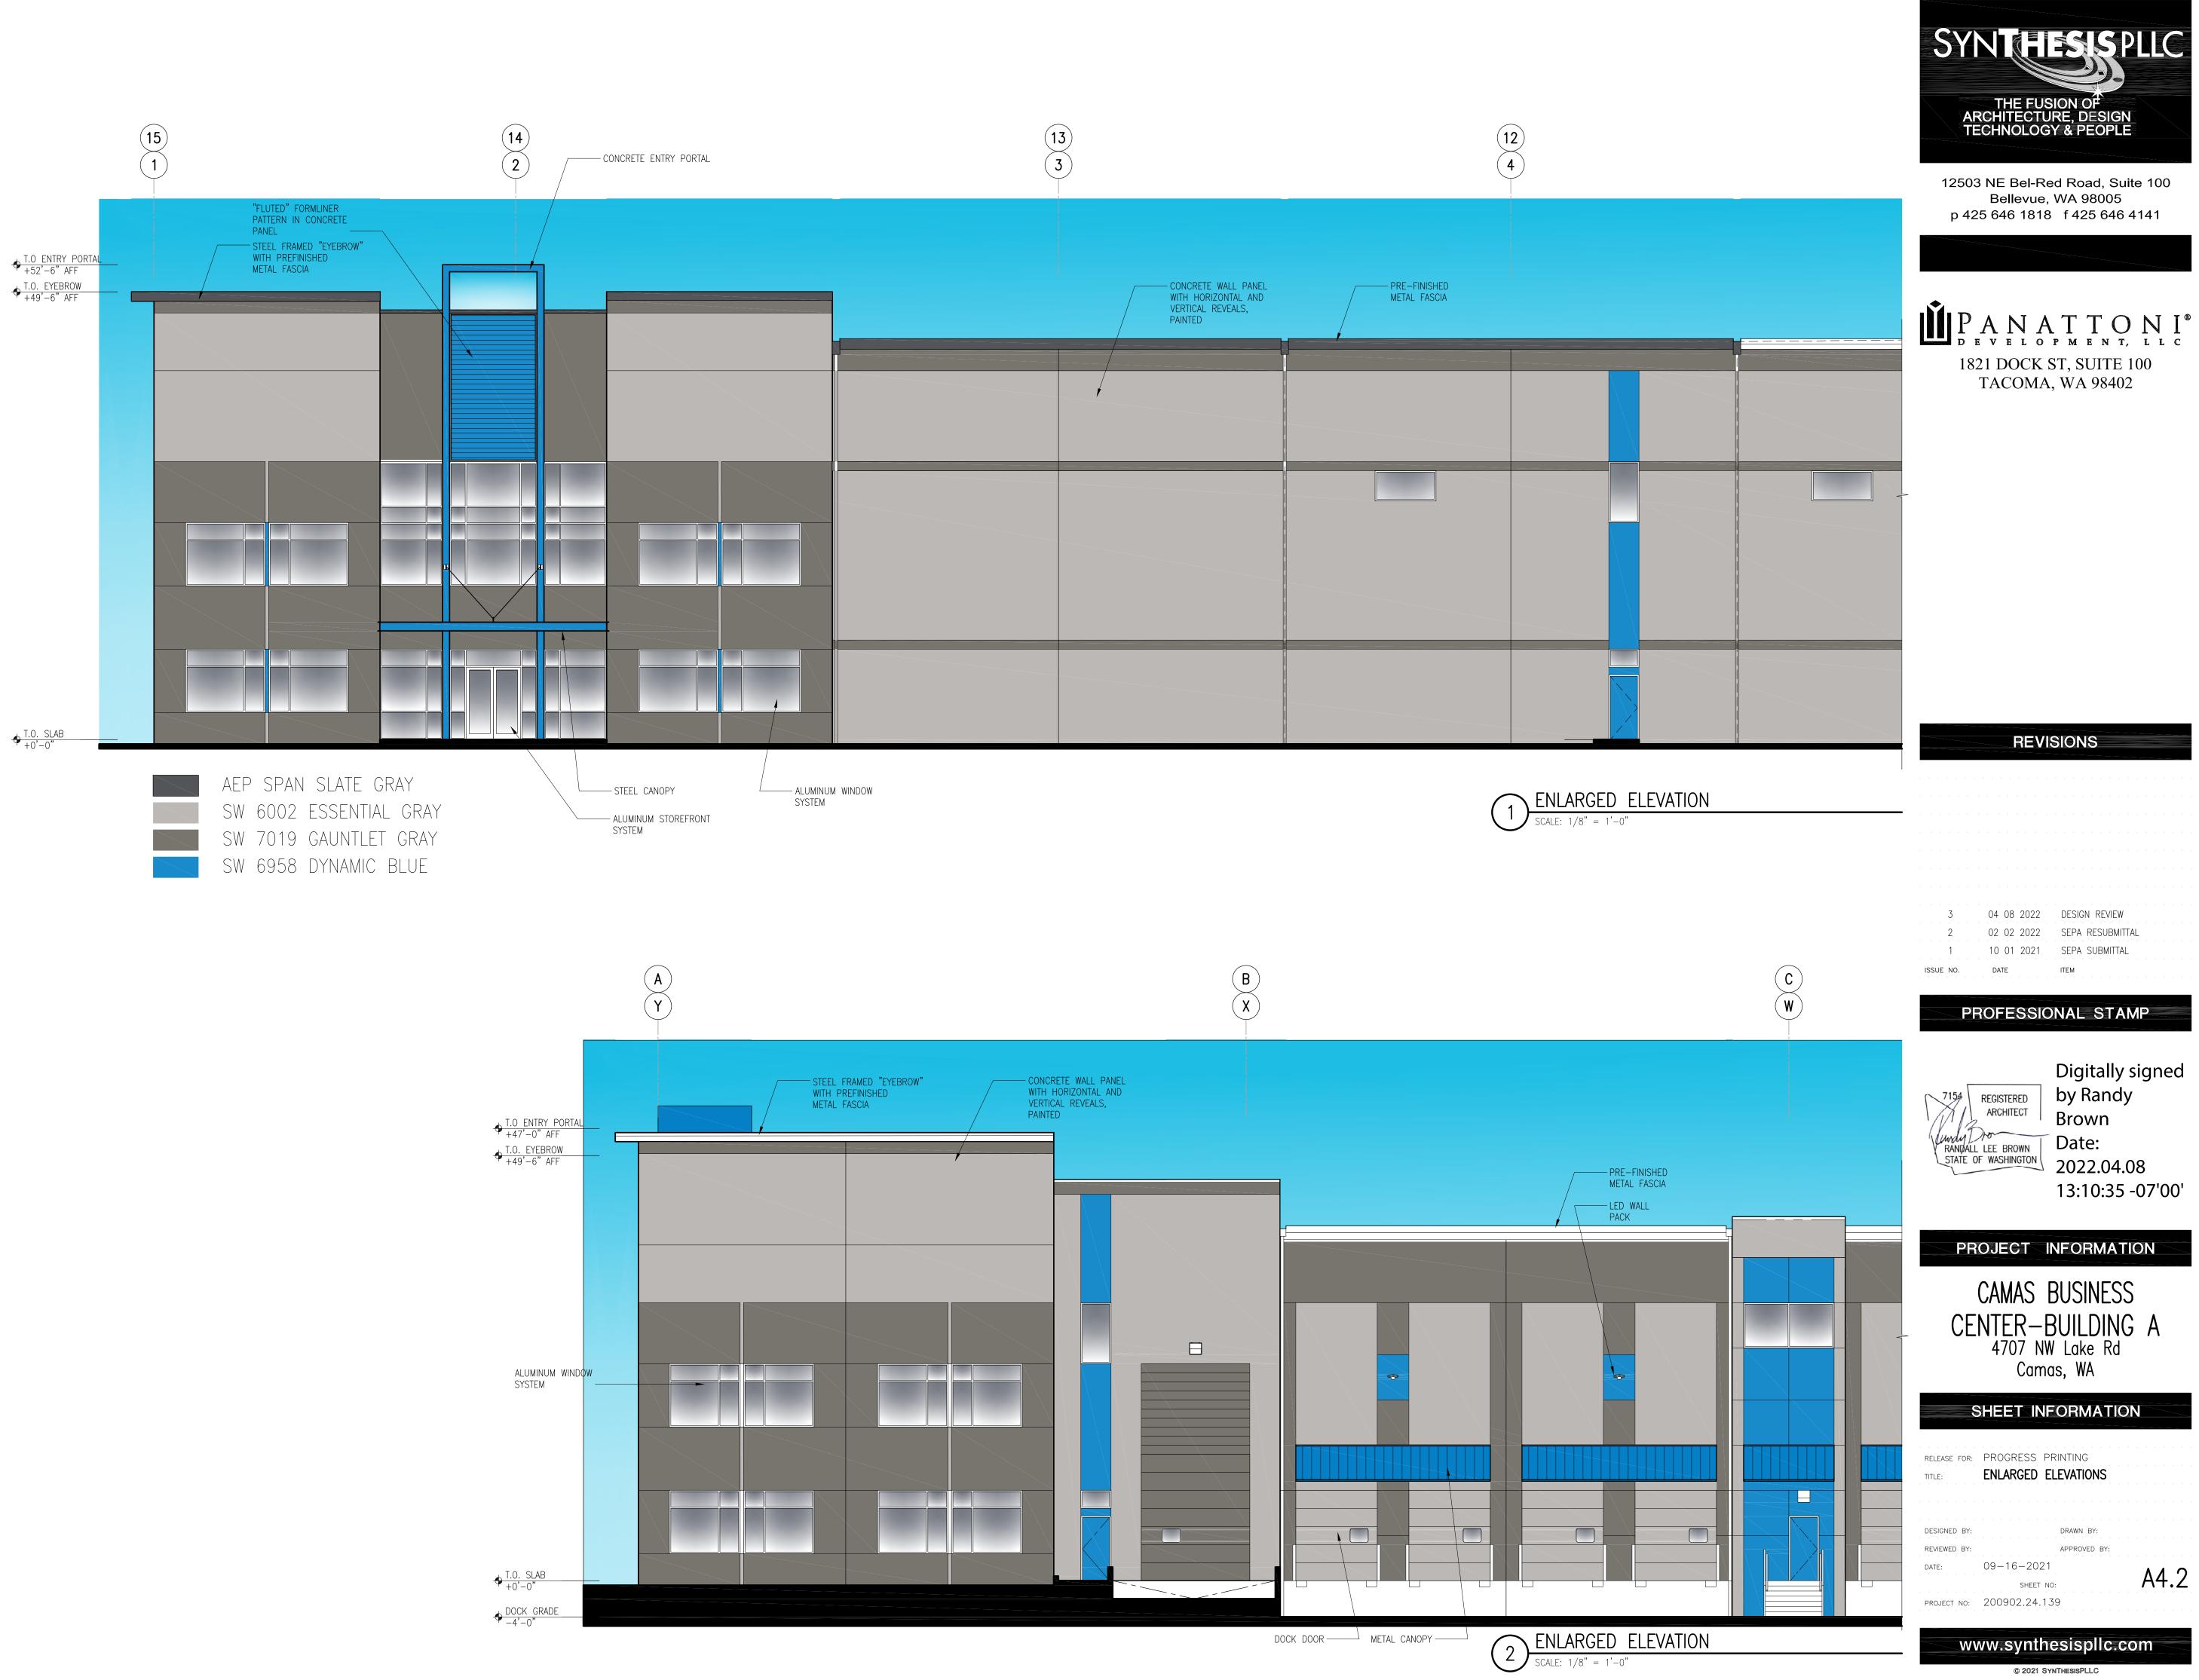








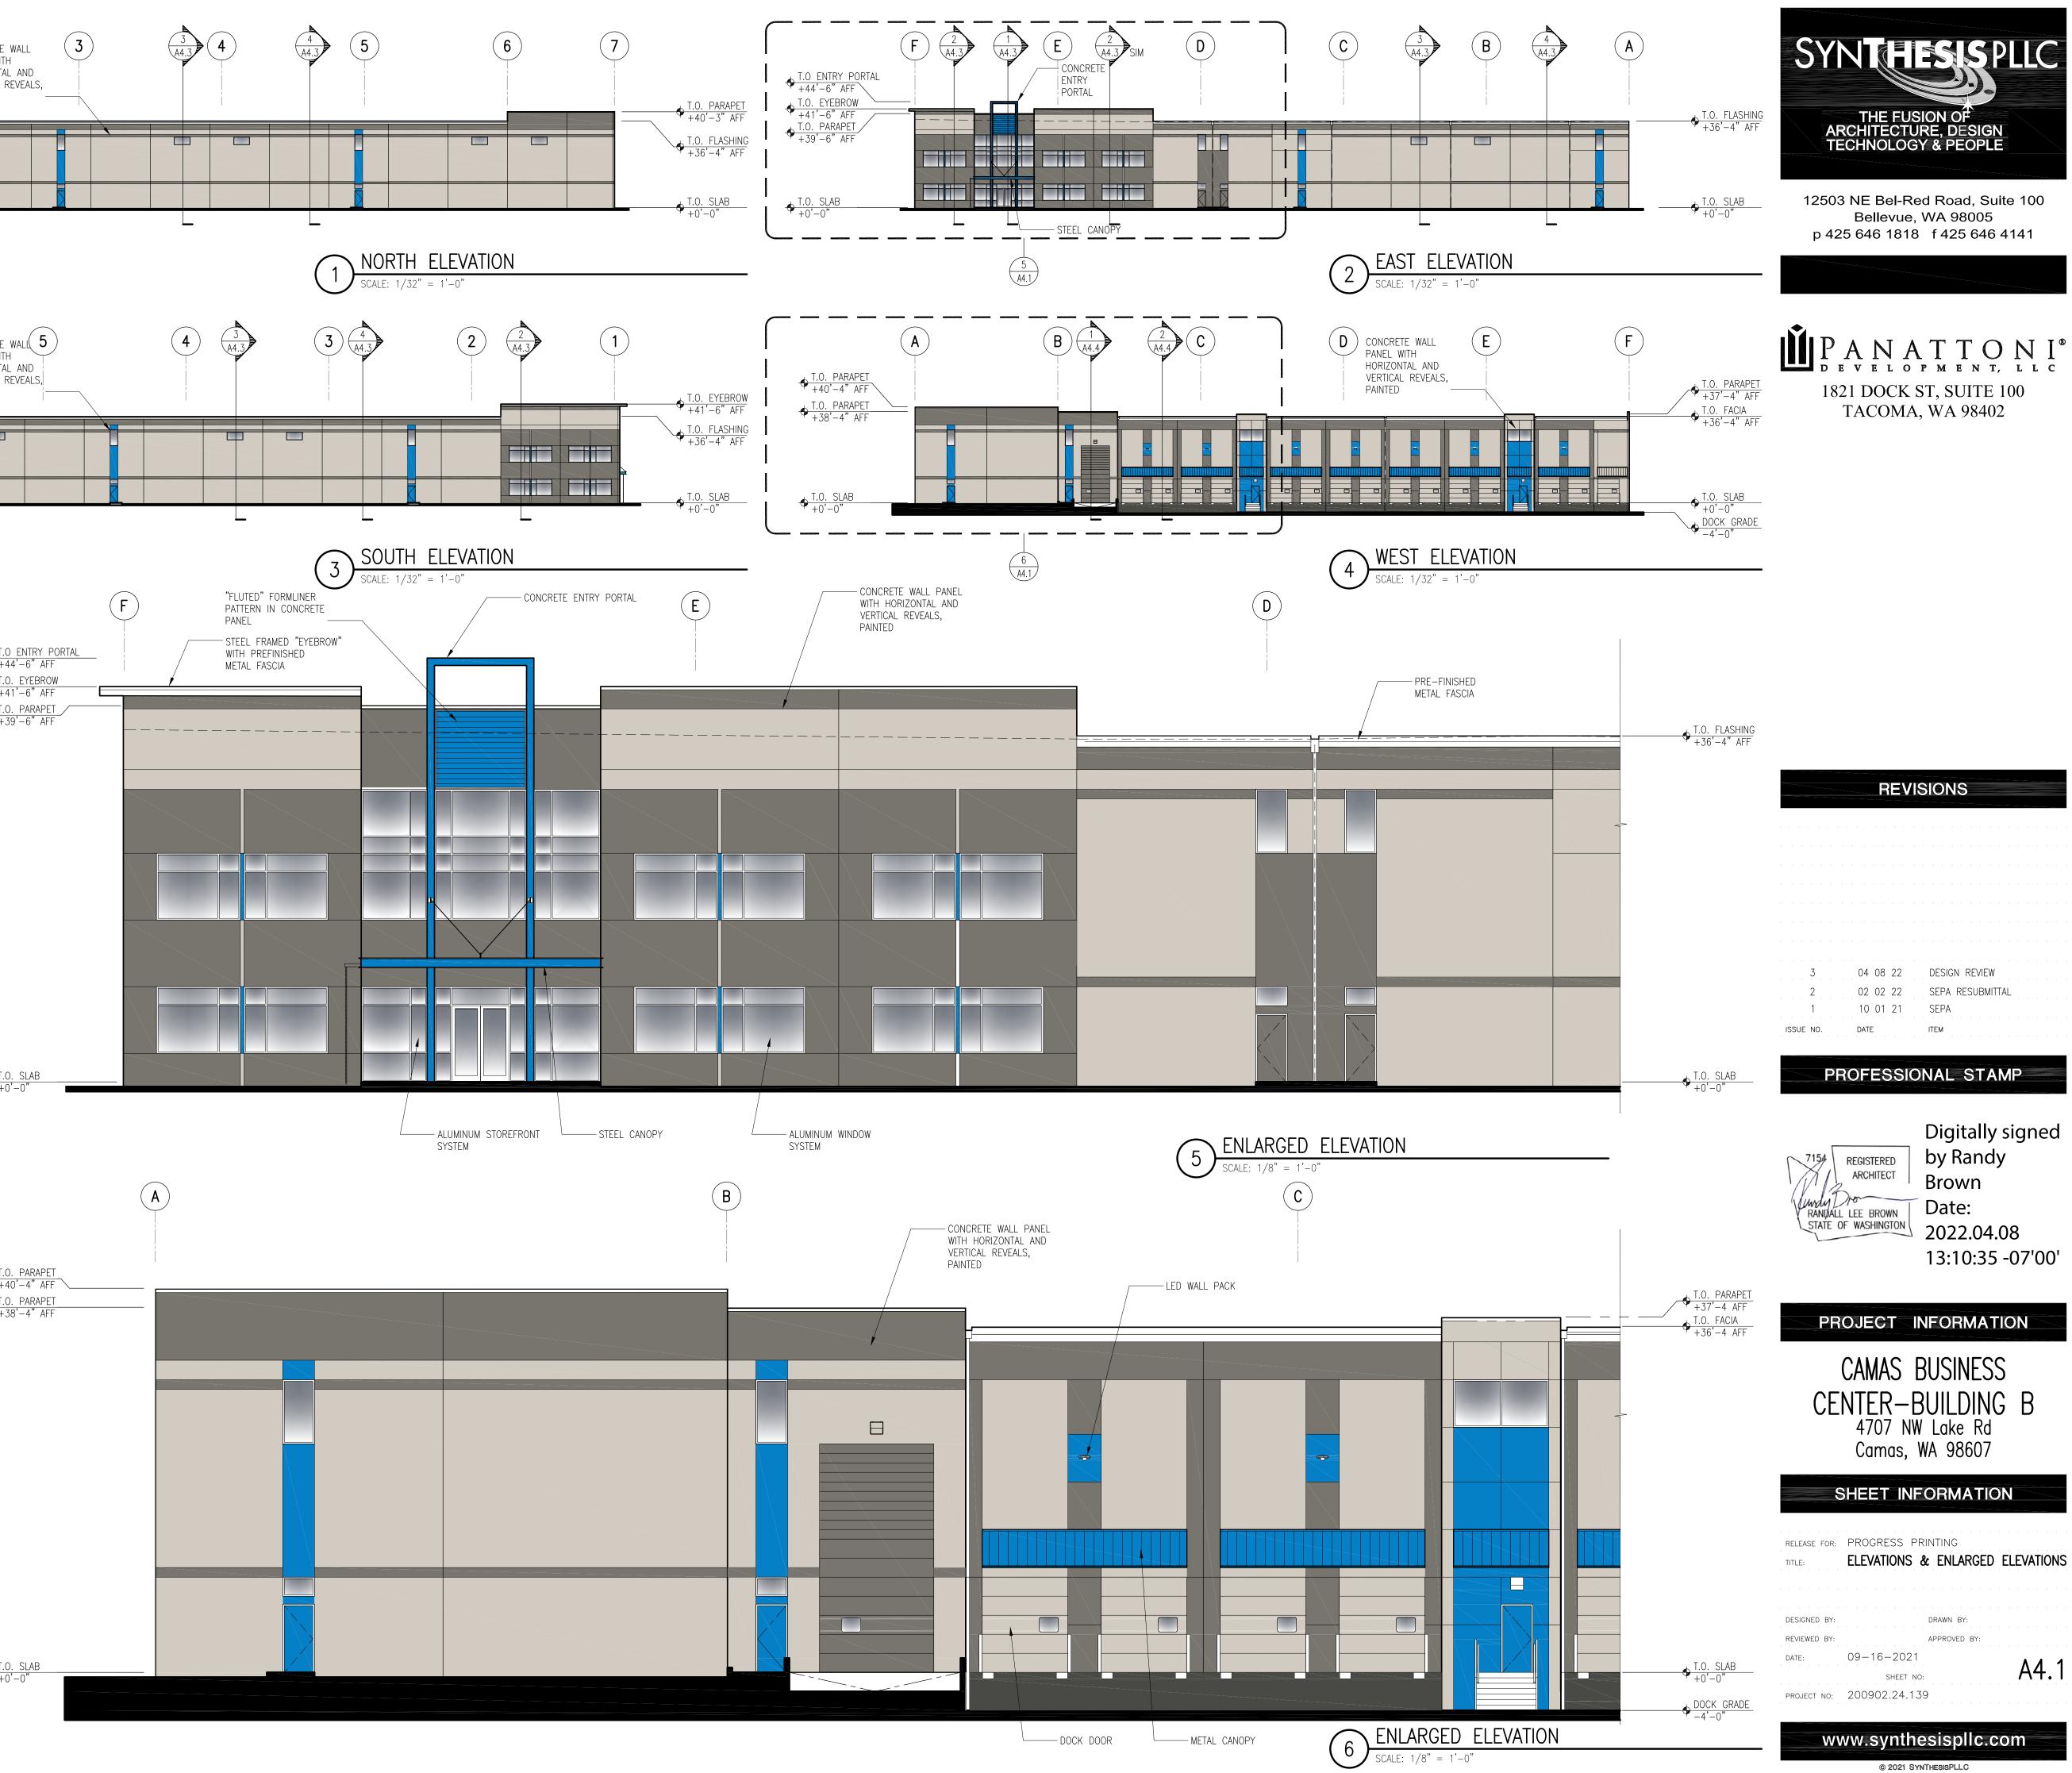




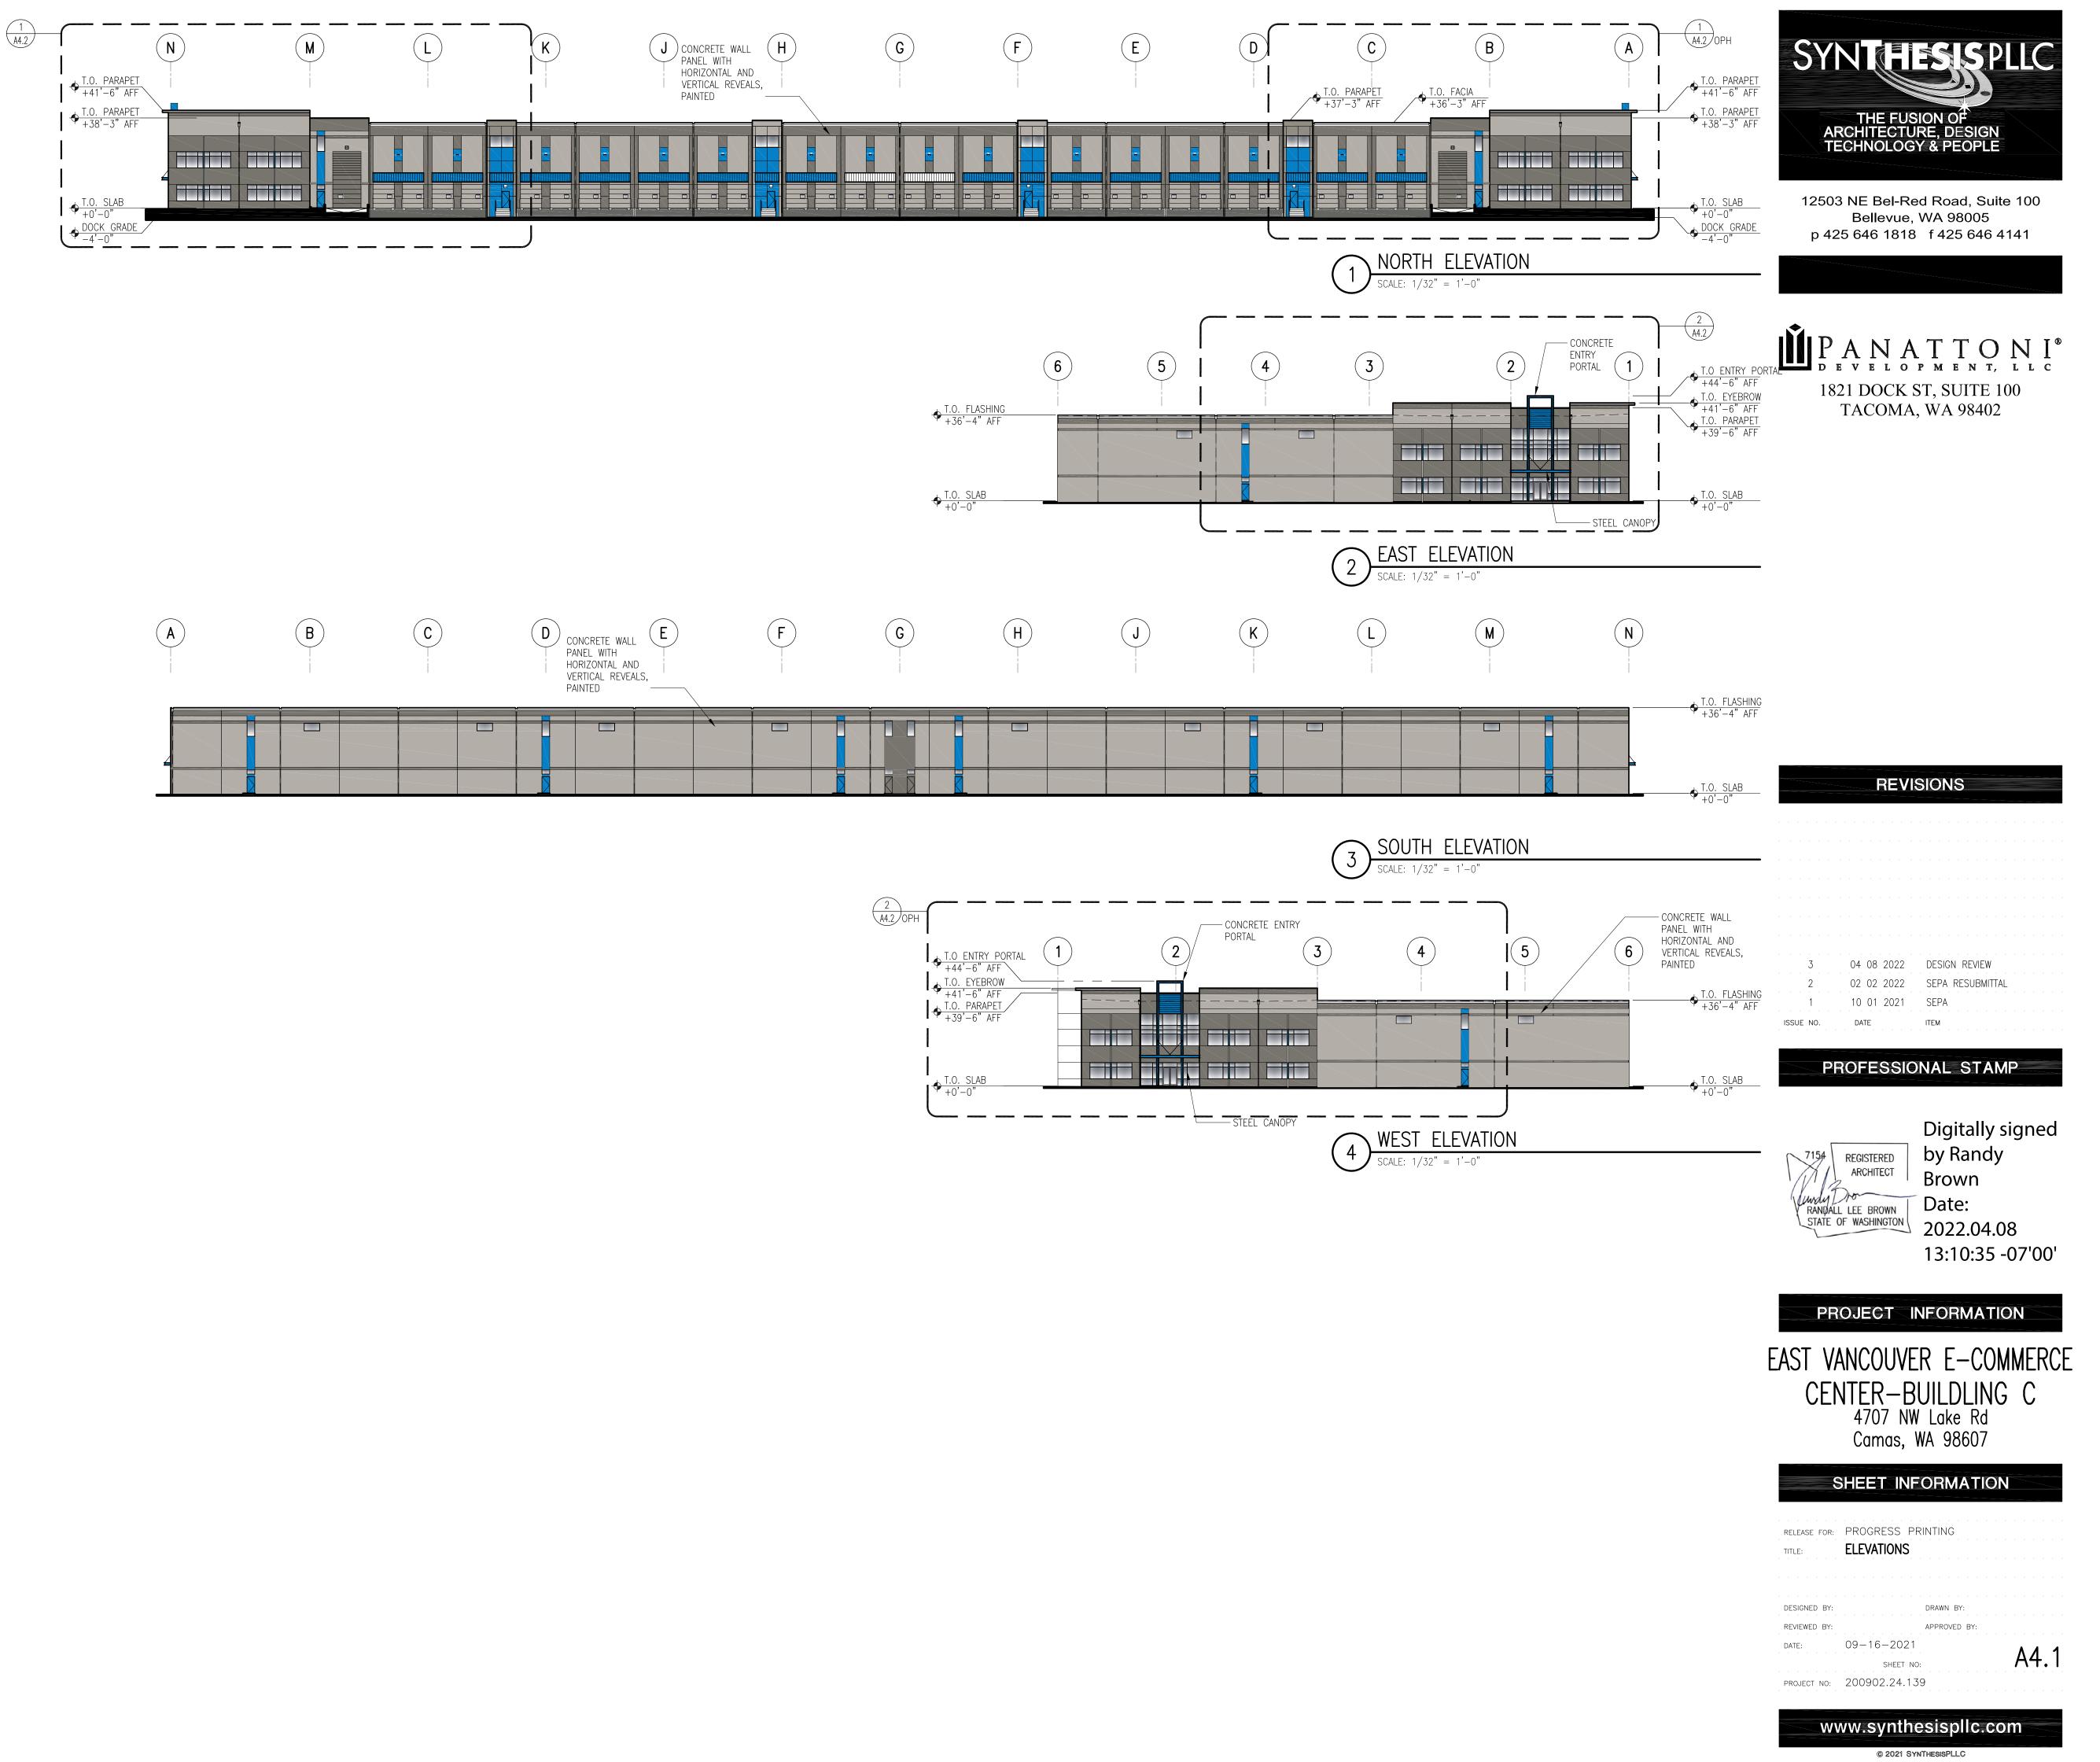


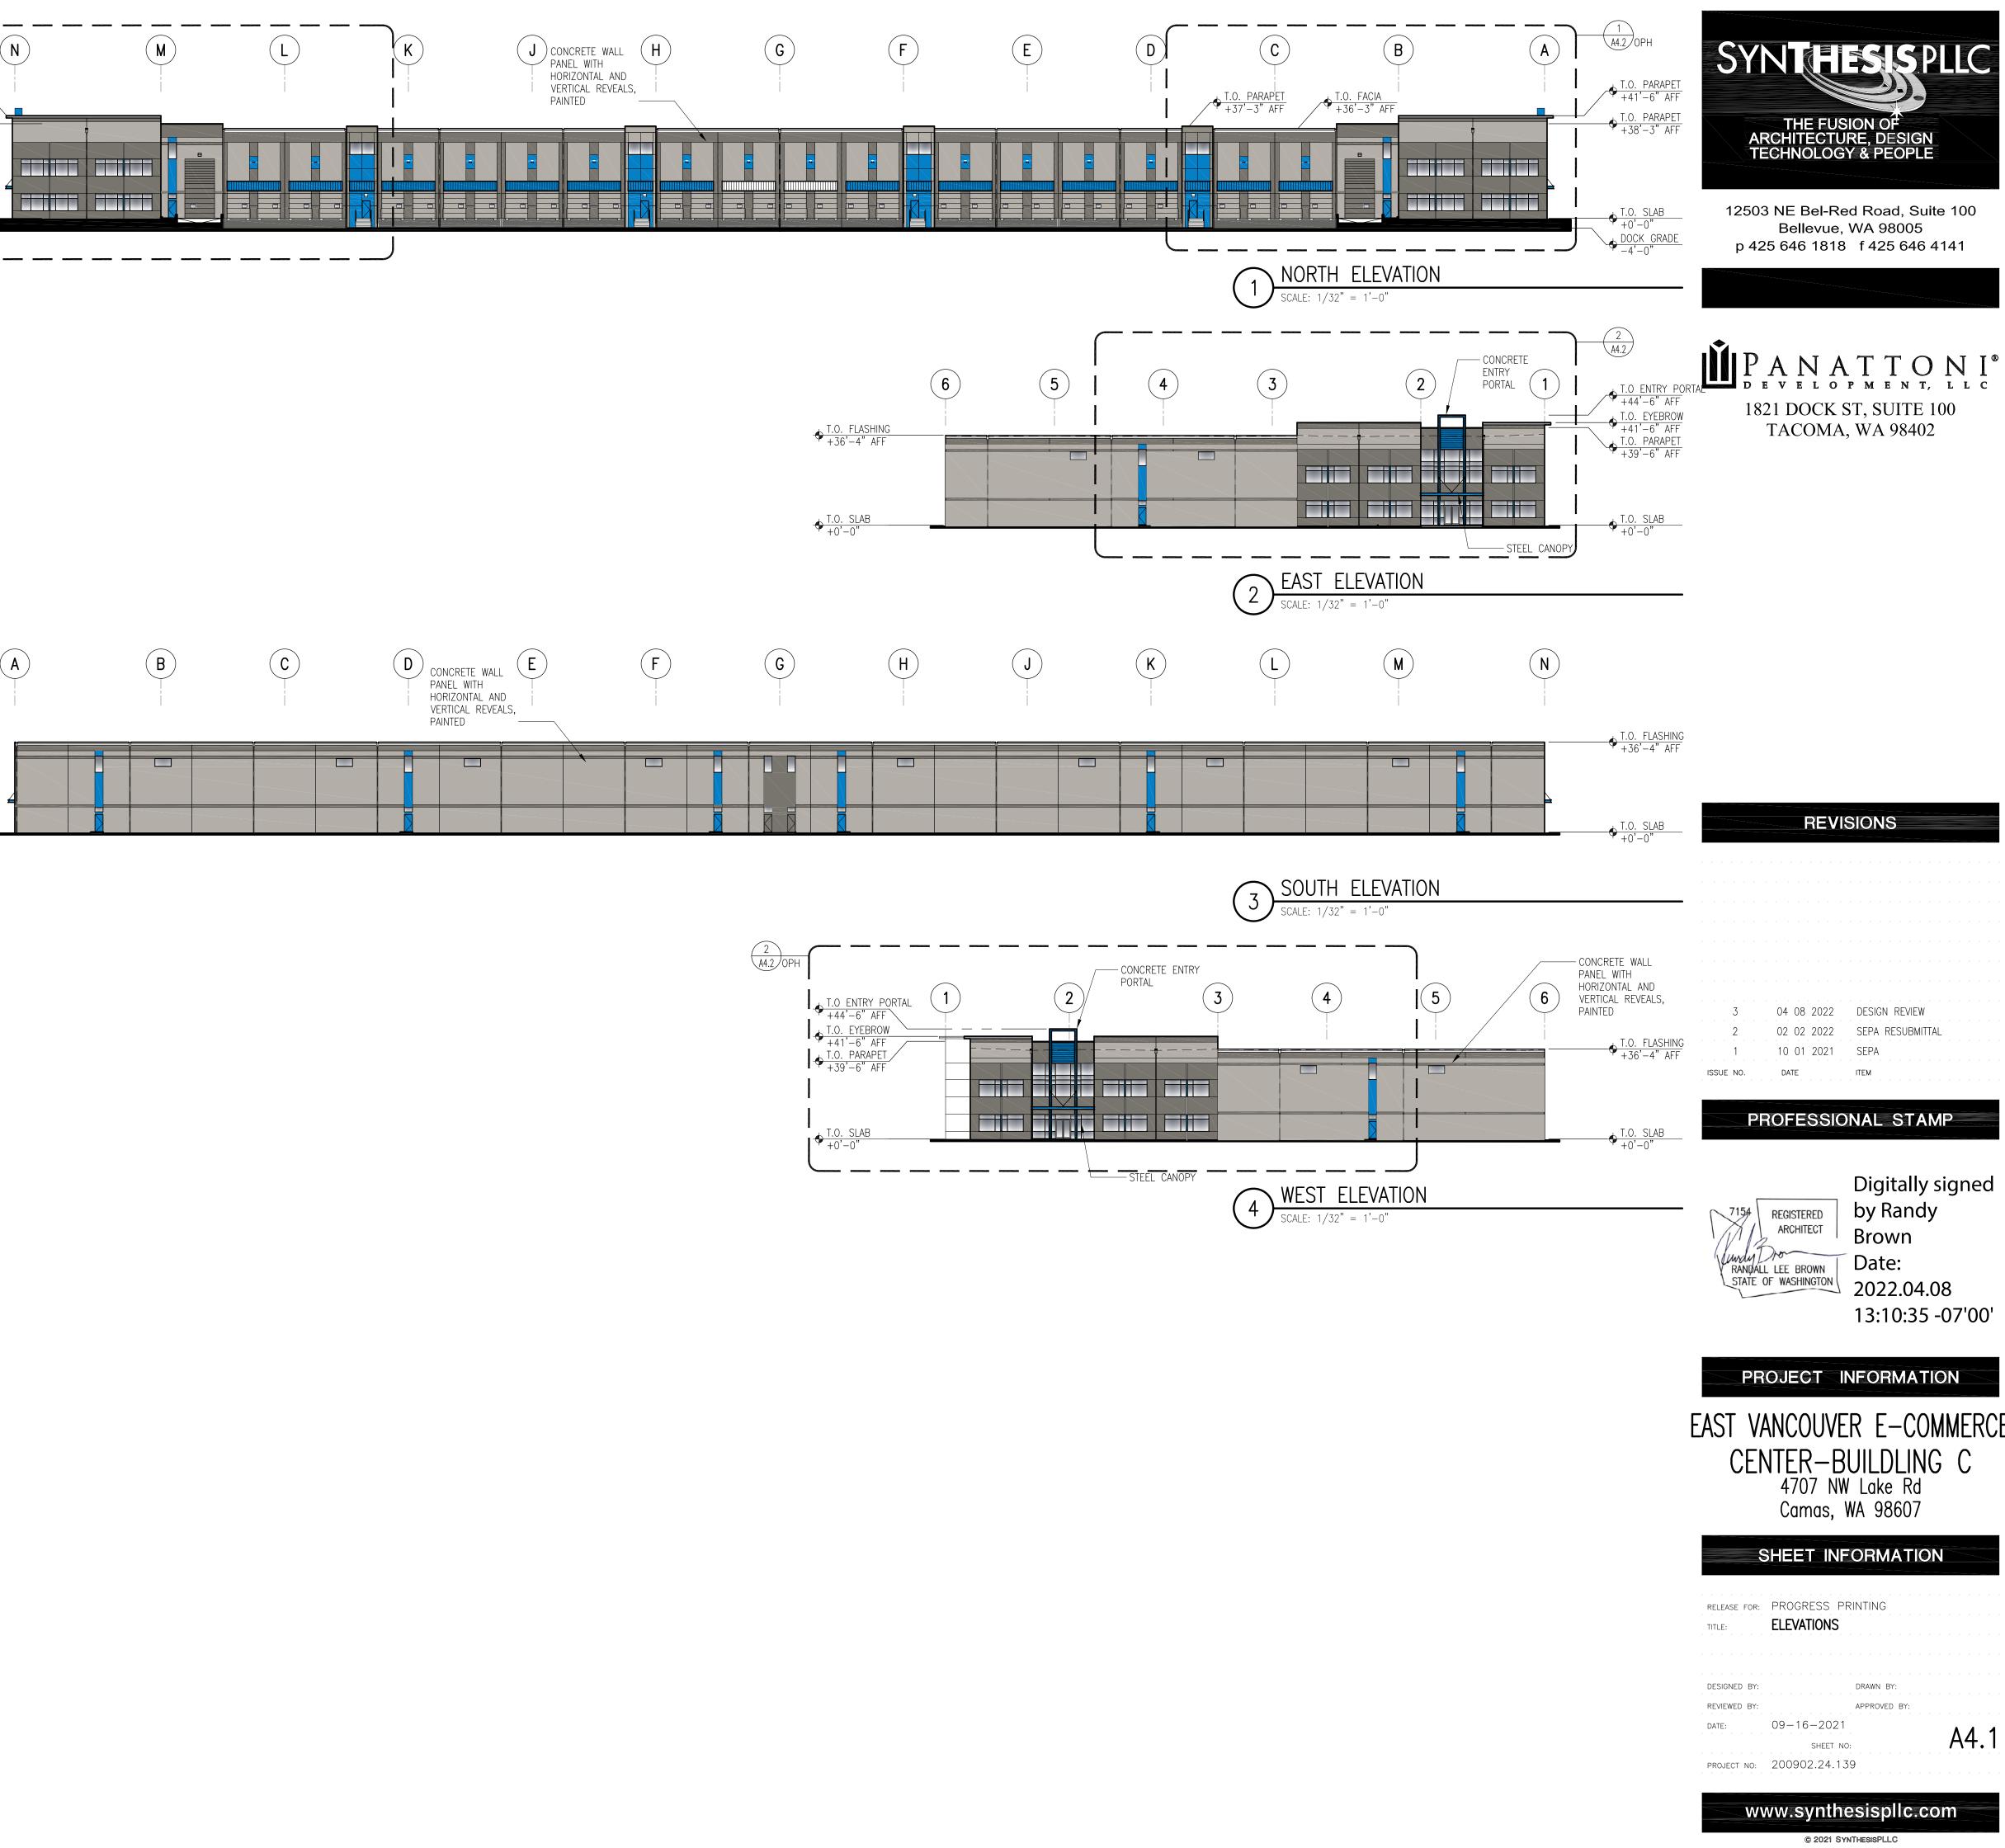

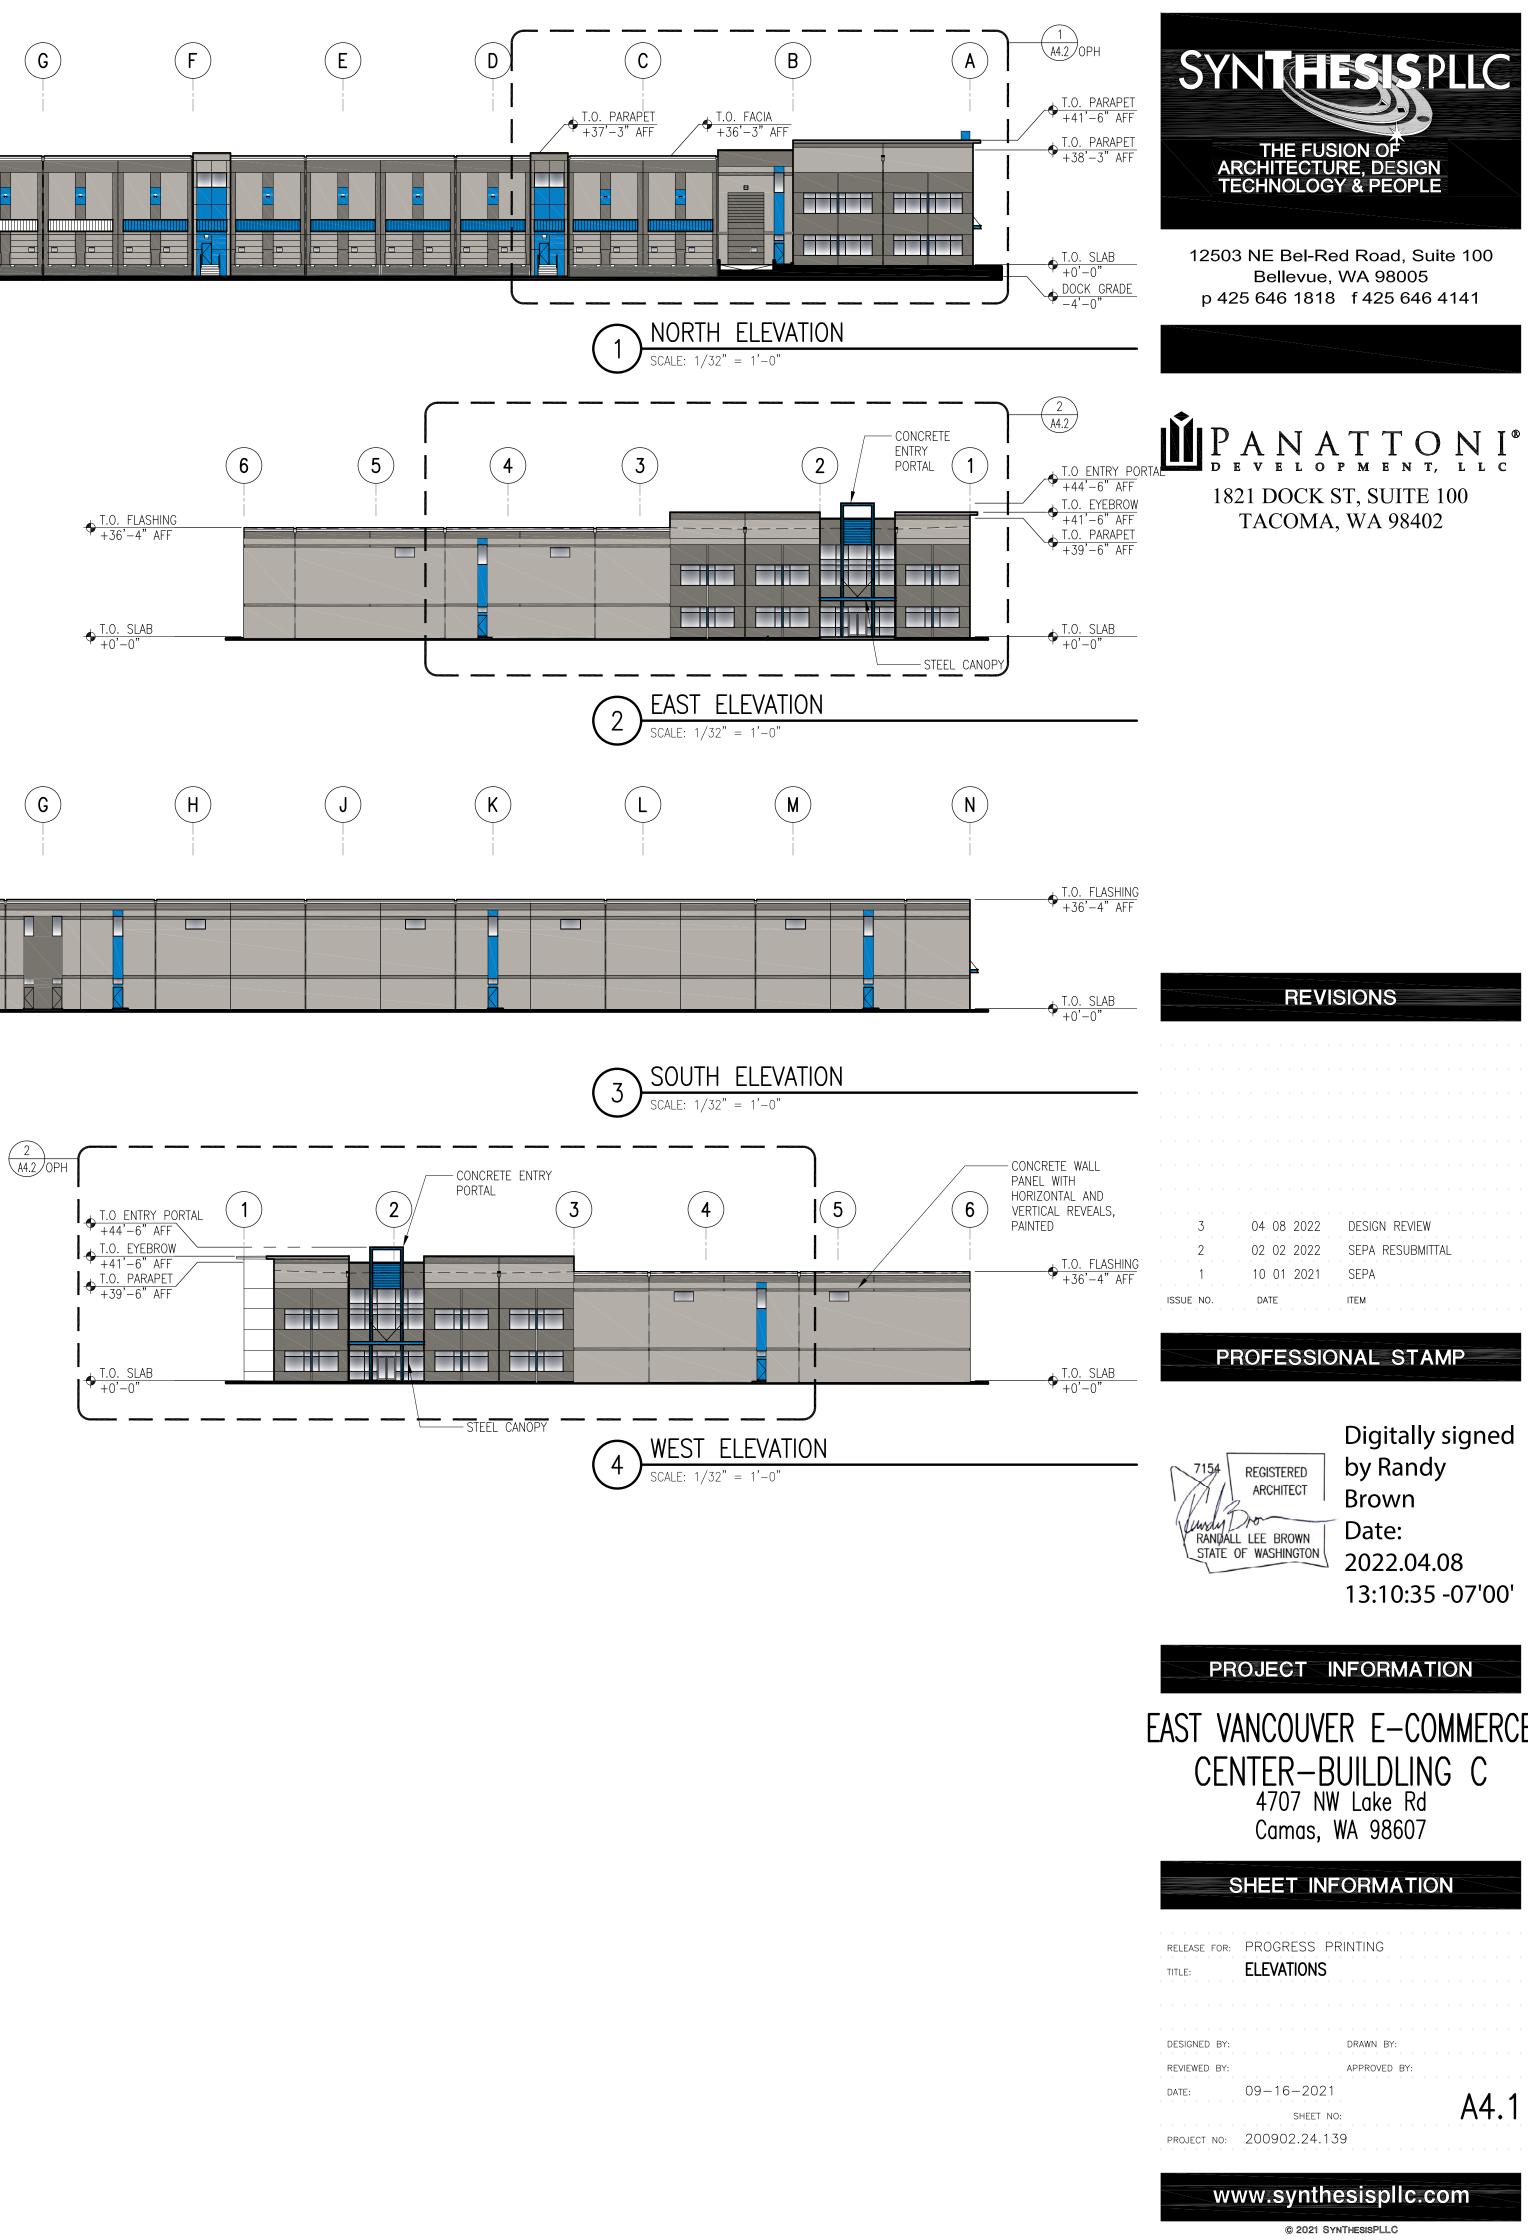

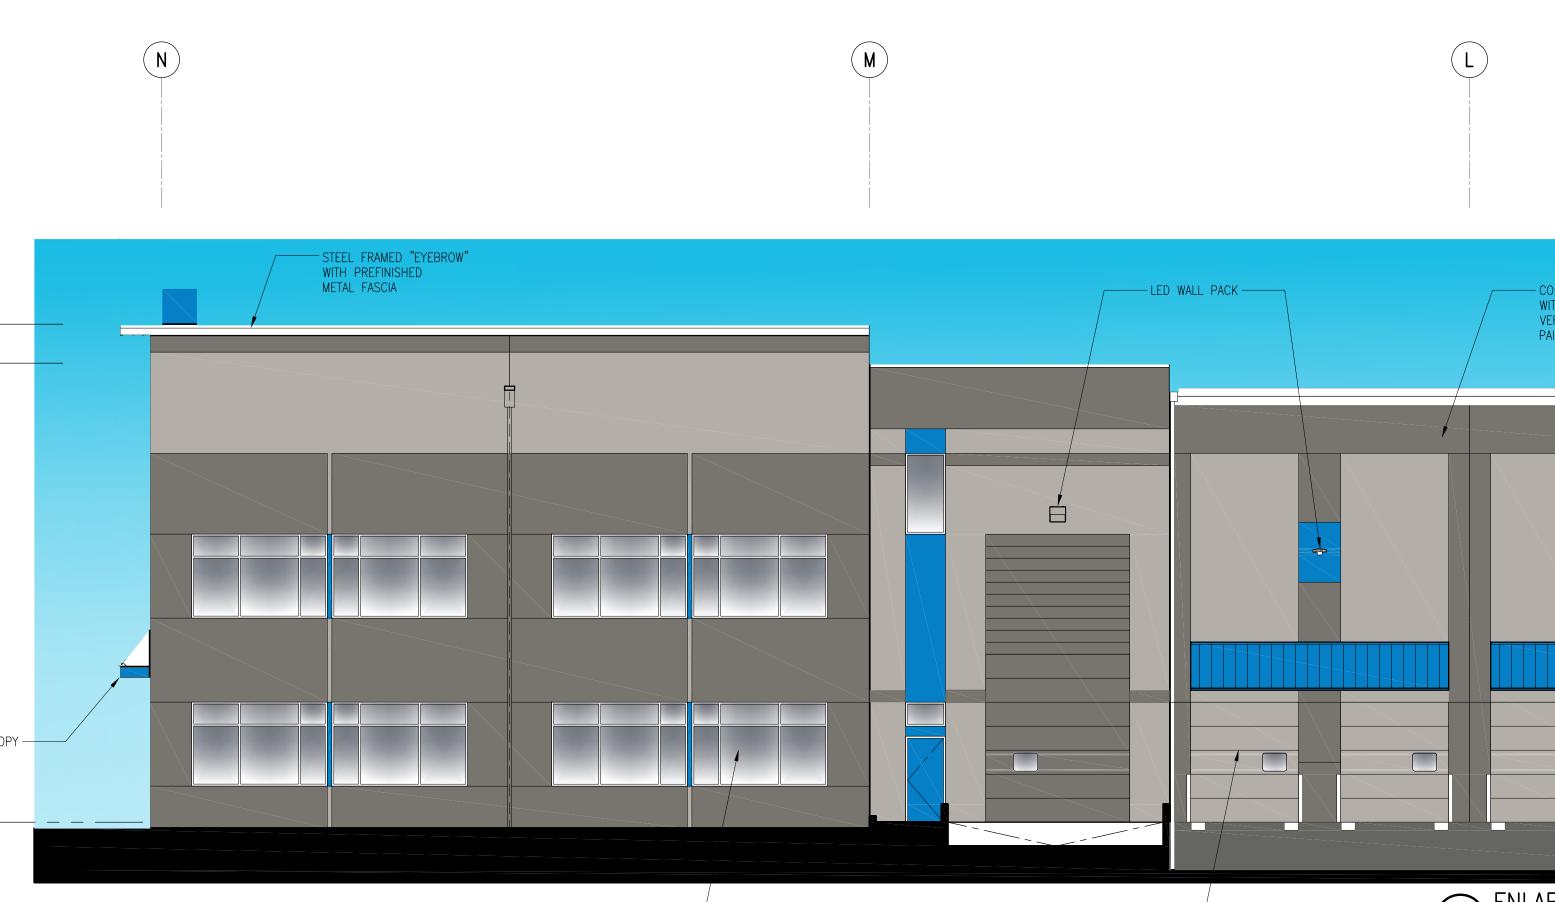

STEEL CANOPY —

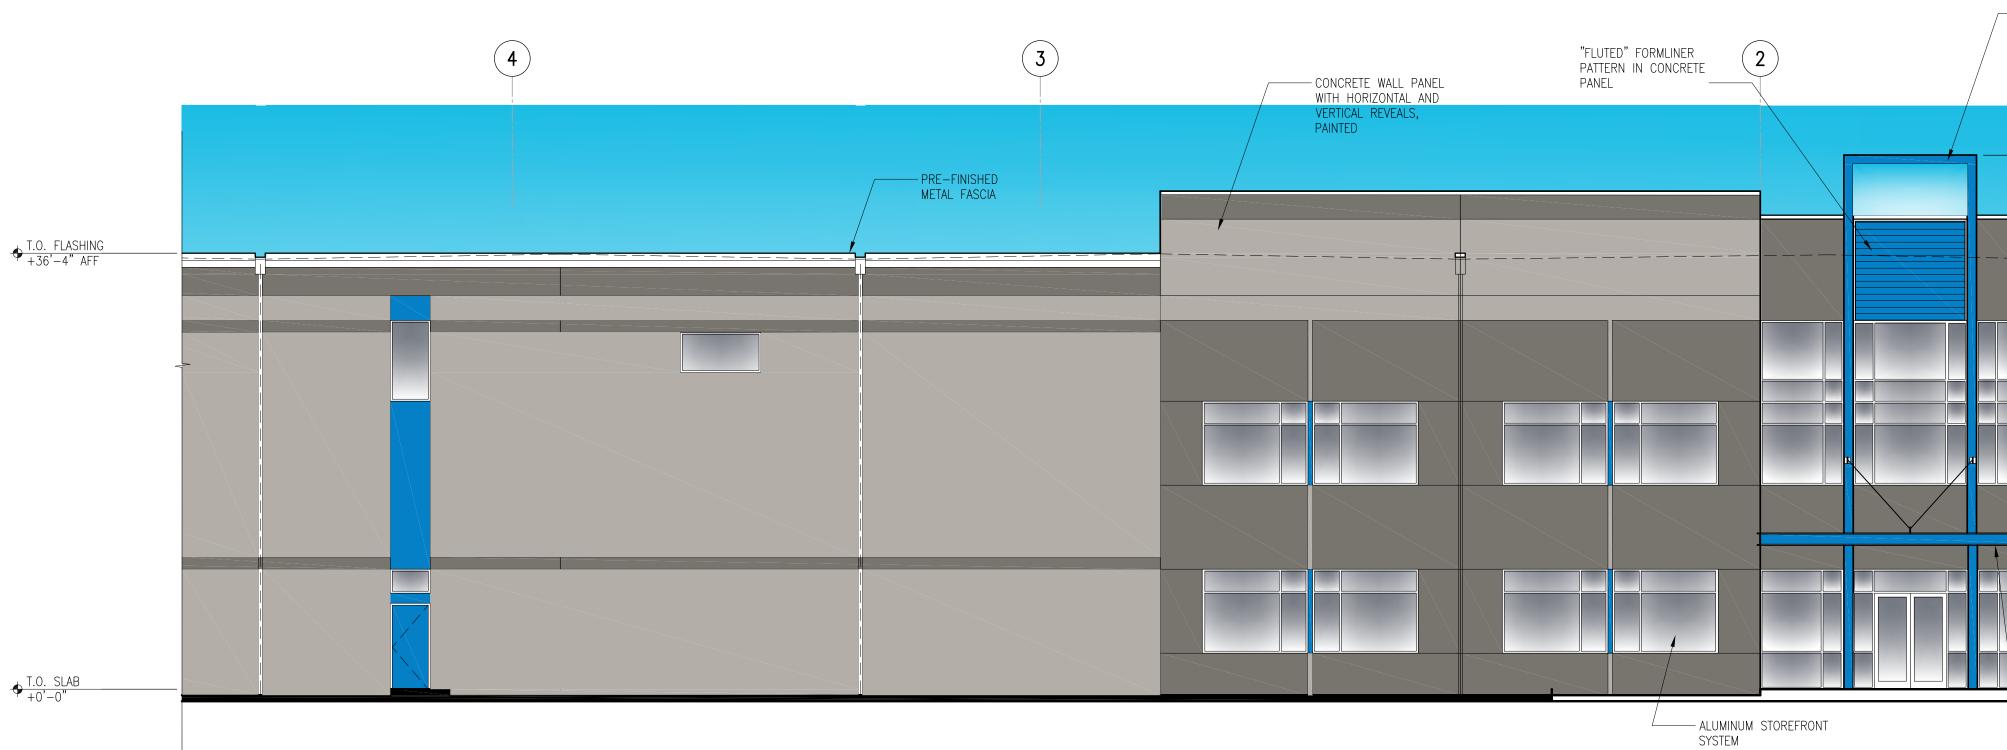

- ALUMINUM WINDOW SYSTEM


L_____ DOCK DOOR



SYNT HESISPLLC

THE FUSION OF ARCHITECTURE, DESIGN TECHNOLOGY & PEOPLE

12503 NE Bel-Red Road, Suite 100 Bellevue, WA 98005 p 425 646 1818 f 425 646 4141

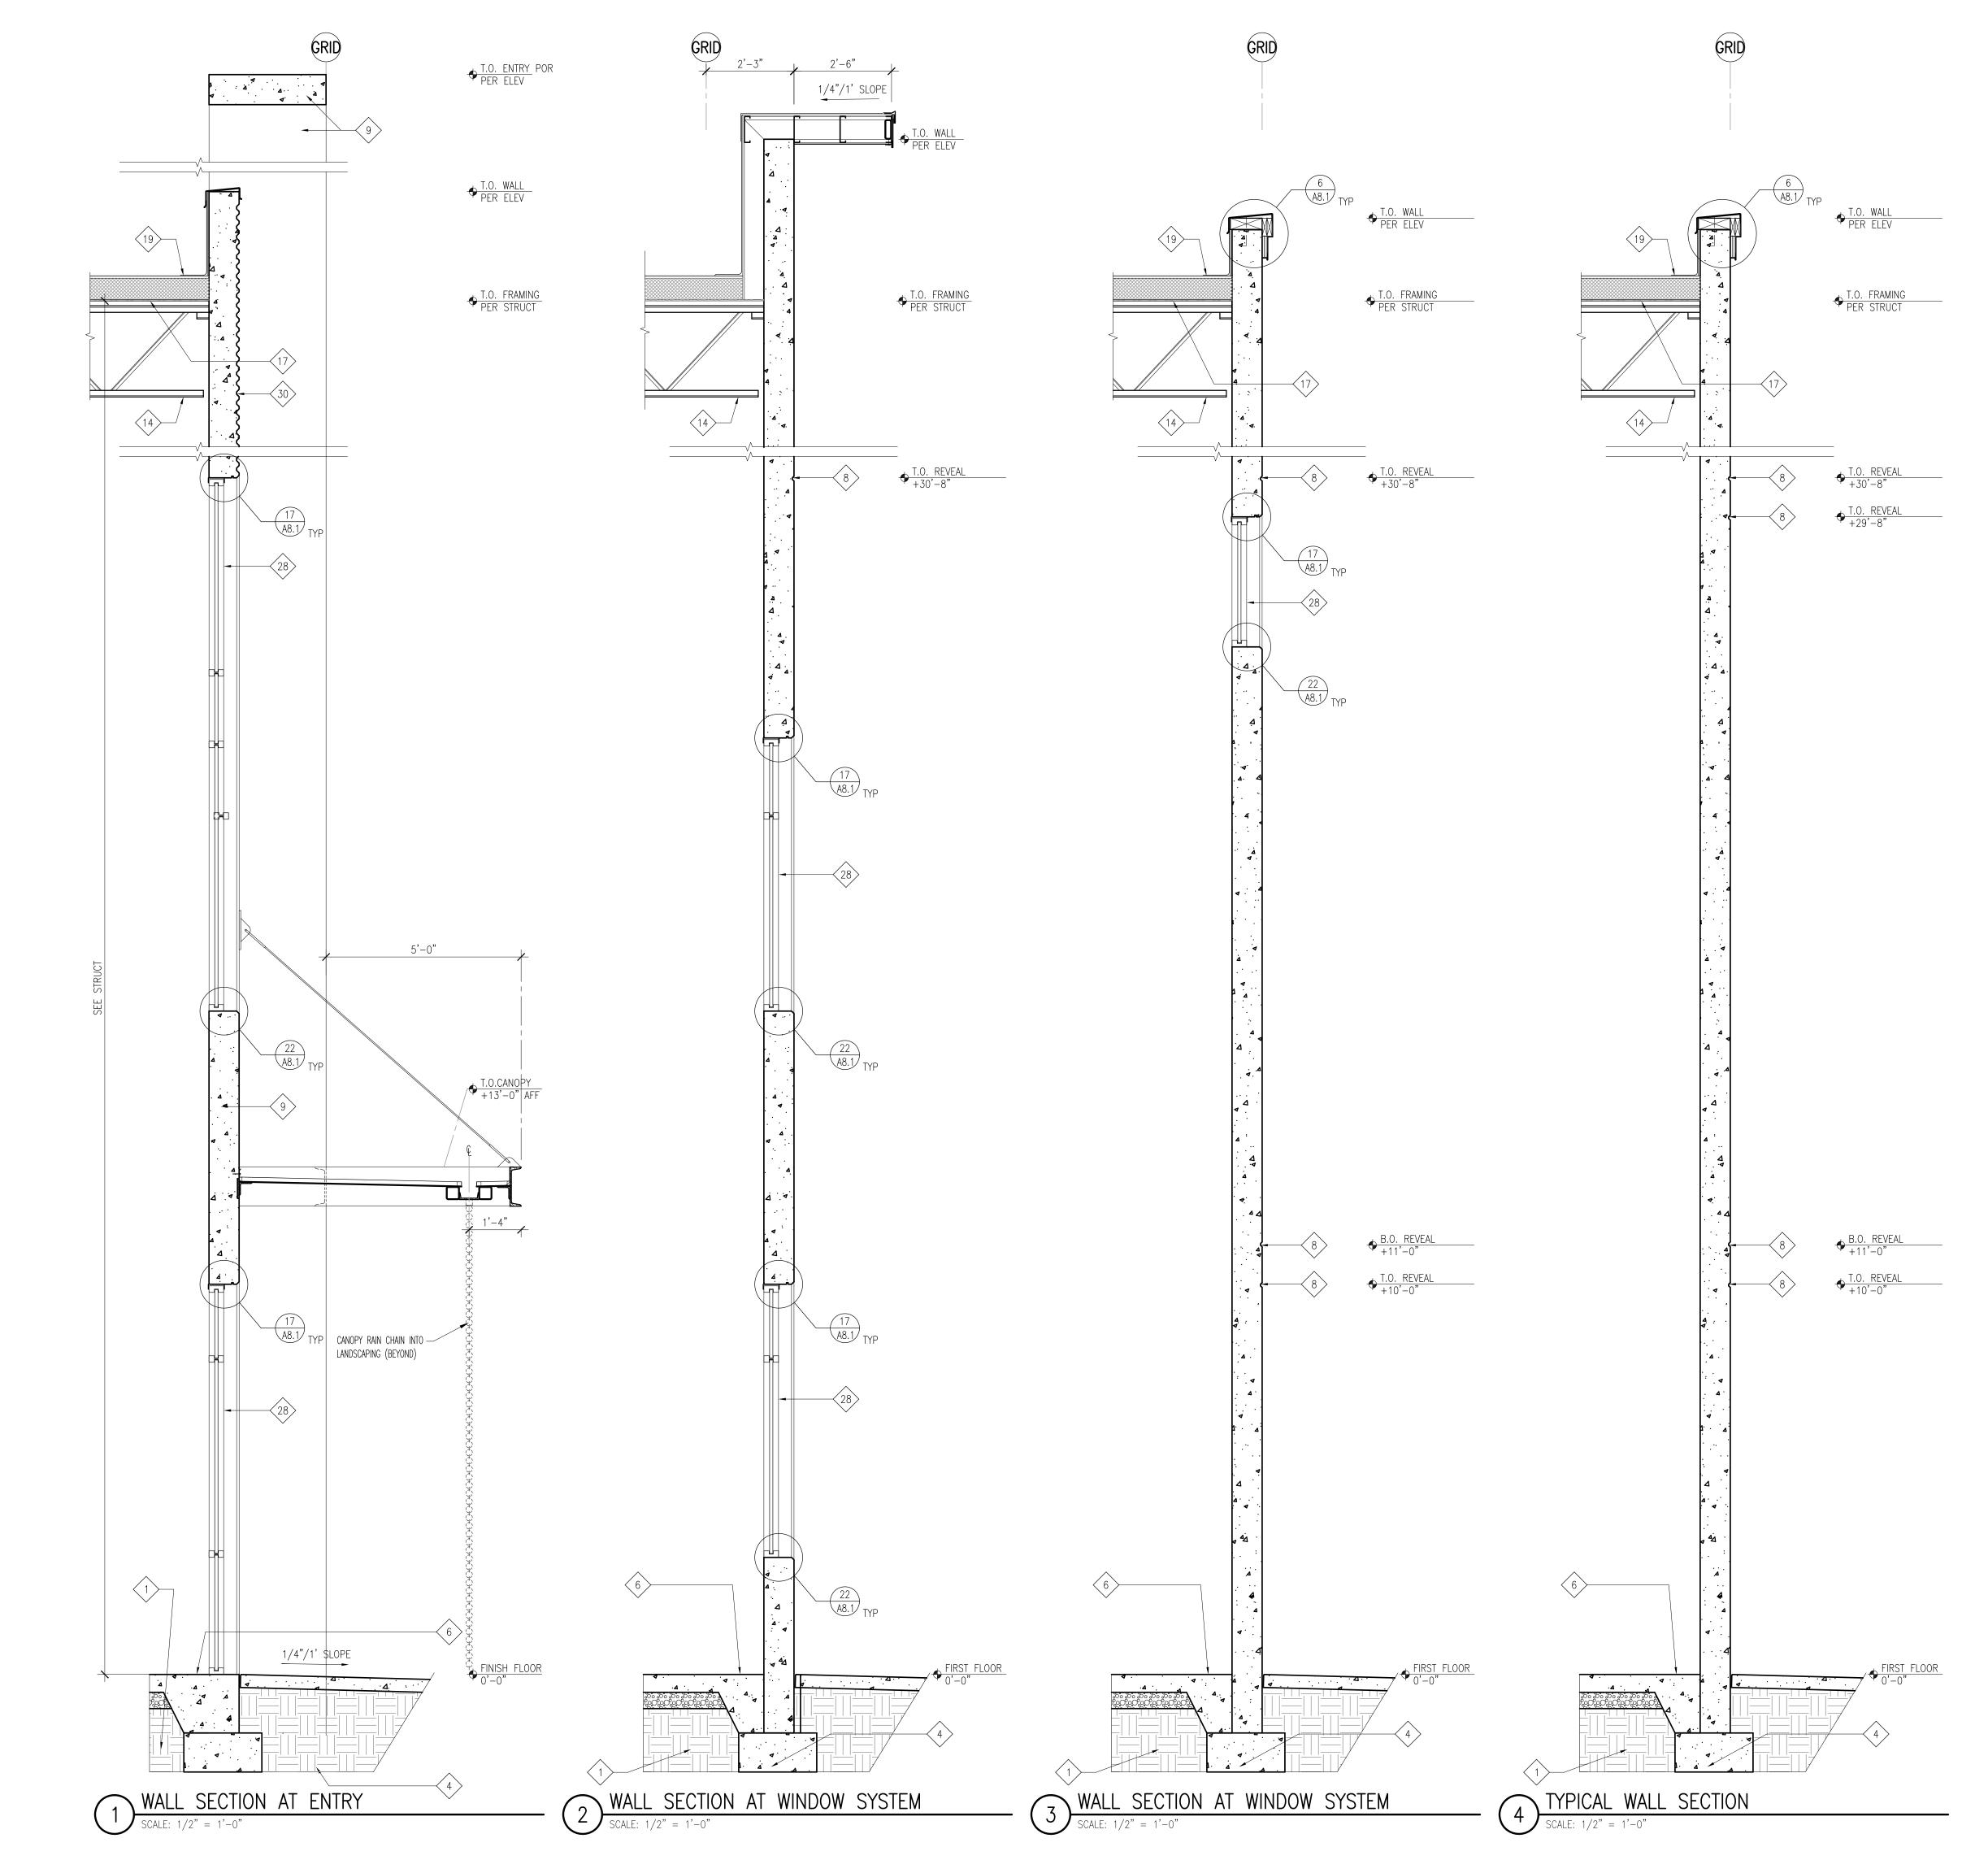

 $\langle 8 \rangle$

(13)

(15)

KEYNOTES - WALL SECTIONS

NOTE: NOT ALL KEYNOTES ARE USED (1) STRUCTURAL FILL

(2) CURTAIN BOARD BEYOND

 $\langle 3 \rangle$ CONCRETE PAVING

4 Conc footing, see struct dwgs for elevation CONC WALK OR LANDING OVER COMPACTED FILL PER SOILS REPORT CONC SLAB—ON—GRADE ON GRAVEL CAPILLARY BREAK ON STRUCTURAL FILL PER SOILS REPORT SEALANT

HORIZONTAL REVEAL, SEE DETAIL 13/A8.1, TYP UON

9 > SITE CAST CONC WALL PANEL, PAINT (10) CANT

(11) STEEL ANGLE, SEE STRUCT DWGS.

(12) STEEL GIRDER, SEE STRUCTURAL FRAMING PLAN

STEEL BEAM, PAINT. SEE STRUCTURAL FRAMING PLAN

(14) STEEL JOIST, SEE STRUCTURAL FRAMING PLAN

TUBE STEEL COLUMN OR BEAM, SEE STRUCTURAL DRAWINGS (16) FILTER FABRIC

(17) WOOD ROOF DECK, SEE STRUCTURAL DWGS

(18) WOOD NAILER AND BLOCKING

 $\langle 19 \rangle$ RIGID INSULATION & PERIMETER WD BLKG AS REQD 20 SINGLE-PLY MEMBRANE ROOF ASSEMBLY, CLASS B, OR HIGHER

21 PREFINISHED METAL FASCIA

 $\langle 22 \rangle$ drip formed in conc panel

 $\langle 23 \rangle$ SURFACE REGLET

 $\langle 24 \rangle$ CRUSHED ROCK

 $\langle 25 \rangle$ DOCK BUMPER

 $\langle 26 \rangle$ SECTIONAL OVERHEAD DOOR TRACK

(27) Aluminum Window System

28 ALUMINUM STOREFRONT SYSTEM

29 FOUNDATION DRAIN

30 FORMLINER WITH "FLUTED RIB" PROFILE

31 N/A

 $\langle 32 \rangle$ STEEL CHANNELS, SEE STRUCTURAL DRAWINGS

(33) N/A

WALL SCONCE LIGHT FIXTURE EA SIDE OF ENTRY DOOR.

35 BELOW GRADE BITUMINOUS DAMP PROOFING



SYNTHESIS PLLC

3	04 08 2022	DESIGN REVIEW
2	02 02 2022	SEPA RESUBMITTAL
1		SEPA SUBMITTAL
ISSUE NO.	DATE	ITEM


REVISIONS

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PROJECT INFORMATION



SHEET INFORMATION

RELEASE FOR: PROGRESS PRINTING TITLE:

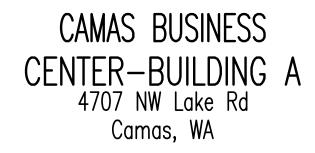WALL SECTIONS

SHEET NO:


09-16-2021

DESIGNED BY: REVIEWED BY: DATE:

DRAWN BY: APPROVED BY:

A4.3

PROJECT NO: 200902.24.139

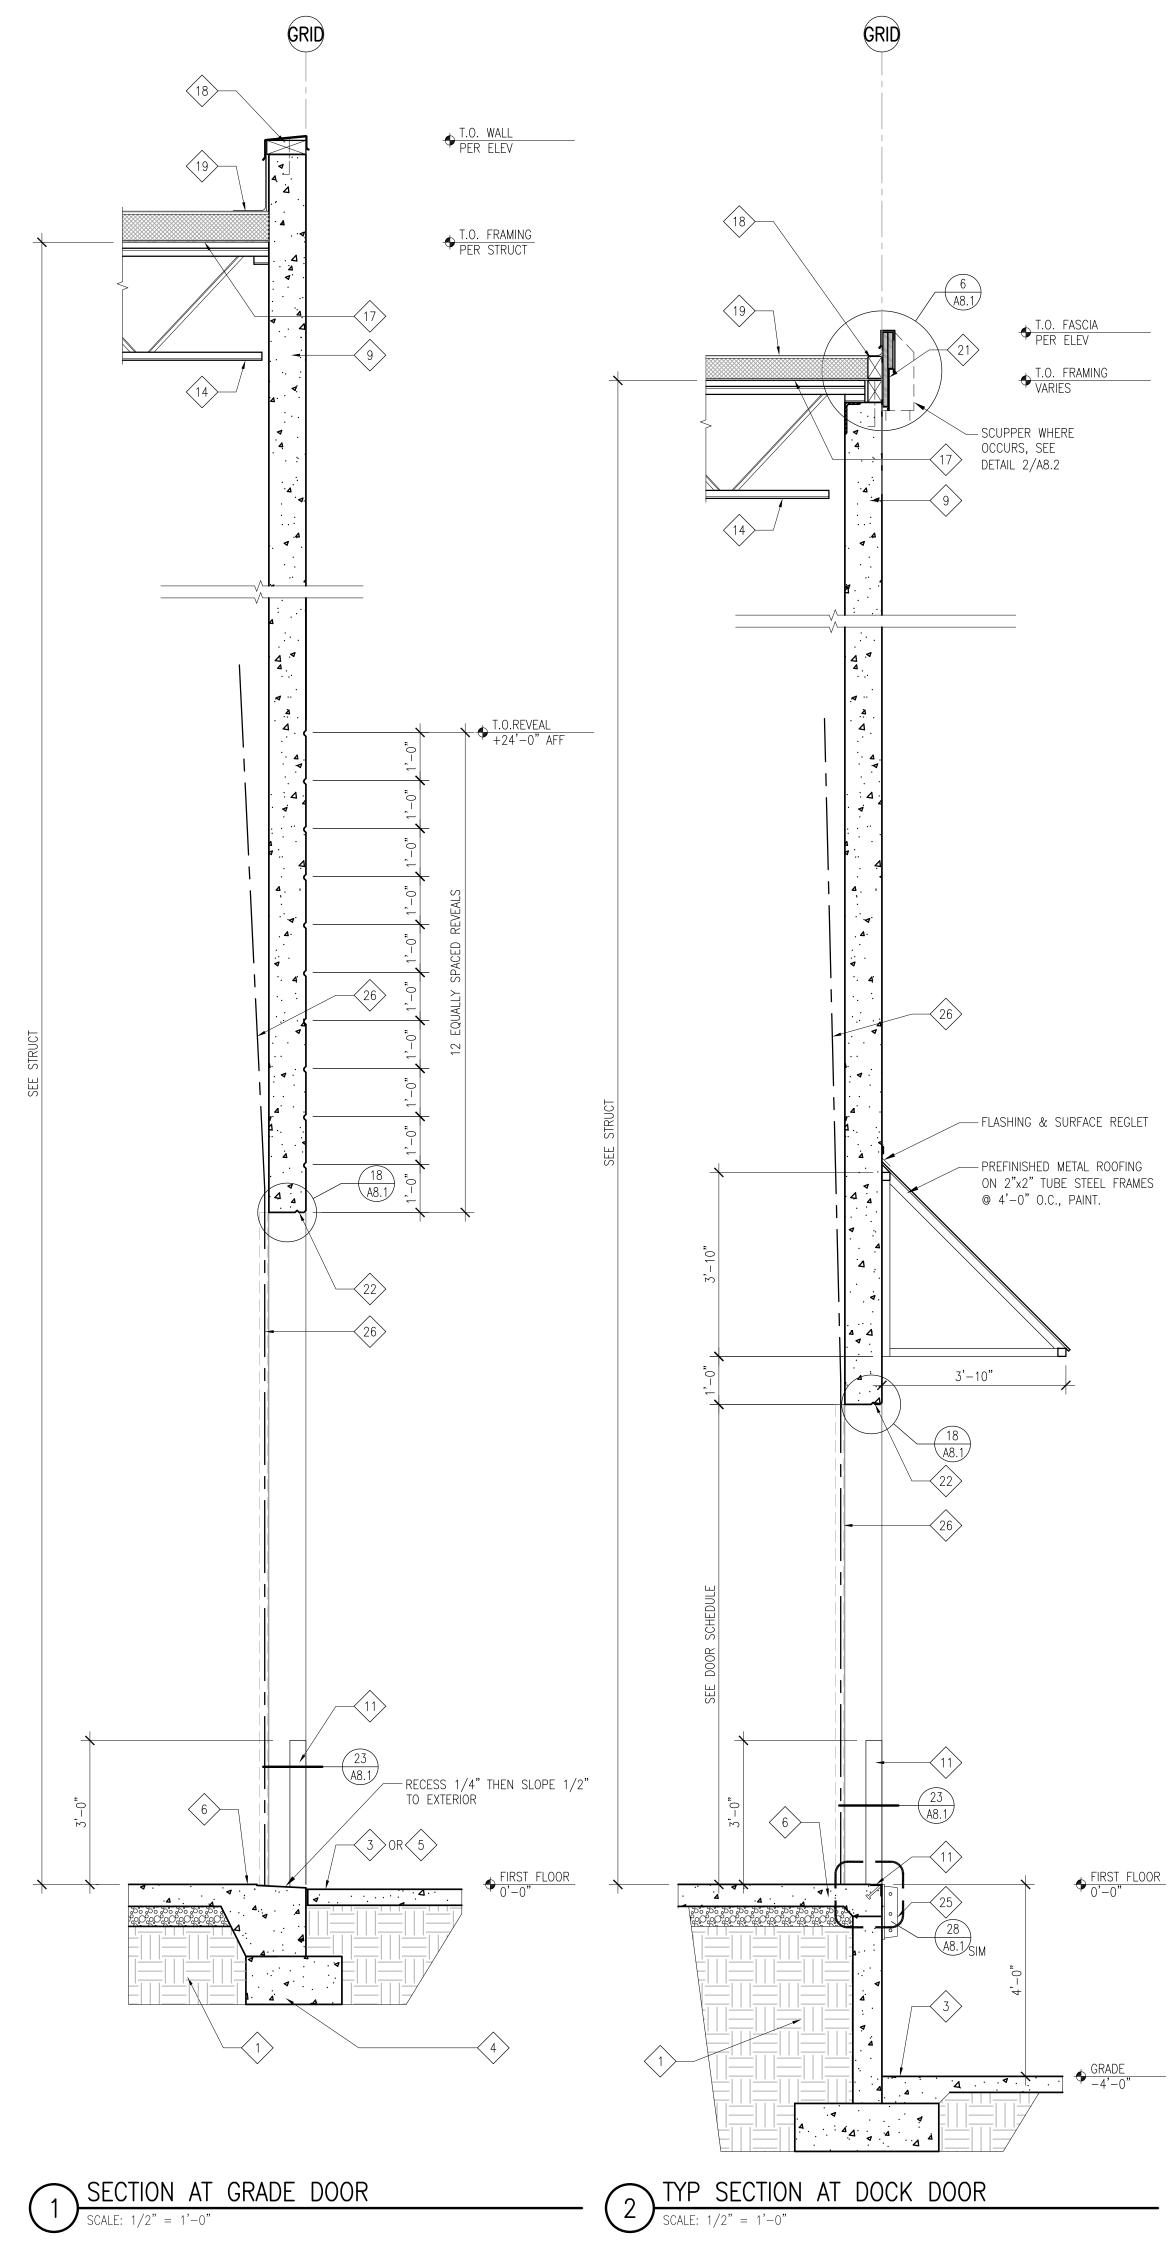

KEYNOTES - WALL SECTIONS

NOTE: NOT ALL KEYNOTES ARE USED $\langle 1 \rangle$ STRUCTURAL FILL

 $\langle 2 \rangle$ CURTAIN BOARD BEYOND

 $\langle 3 \rangle$ CONCRETE PAVING

 $\langle 4 \rangle$ conc footing, see struct dwgs for elevation CONC WALK OR LANDING OVER COMPACTED FILL PER SOILS REPORT CONC SLAB-ON-GRADE ON GRAVEL CAPILLARY 7 > SEALANT

8 HORIZONTAL REVEAL, SEE DETAIL 13/A8.1, TYP

 \langle 9 \rangle SITE CAST CONC WALL PANEL, PAINT $\langle 10 \rangle$ CANT

 $\langle 11 \rangle$ steel angle, see struct dwgs.

 $\langle 12 \rangle$ STEEL GIRDER, SEE STRUCTURAL FRAMING PLAN

13 STEEL BEAM, PAINT. SEE STRUCTURAL FRAMING PLAN

 $\langle 14 \rangle$ STEEL JOIST, SEE STRUCTURAL FRAMING PLAN

TUBE STEEL COLUMN OR BEAM, SEE STRUCTURAL DRAWINGS $\langle 16 \rangle$ FILTER FABRIC

(17) WOOD ROOF DECK, SEE STRUCTURAL DWGS

 $\langle 18 \rangle$ wood nailer and blocking

(15)

 $\langle 19 \rangle$ RIGID INSULATION & PERIMETER WD BLKG AS REQD 20 SINGLE-PLY MEMBRANE ROOF ASSEMBLY, CLASS B, OR HIGHER

 $\langle 21 \rangle$ PREFINISHED METAL FASCIA

 $\langle 22 \rangle$ DRIP FORMED IN CONC PANEL

 $\langle 23 \rangle$ SURFACE REGLET

 $\langle 24 \rangle$ CRUSHED ROCK

 $\langle 25 \rangle$ DOCK BUMPER

 $\langle 26 \rangle$ SECTIONAL OVERHEAD DOOR TRACK

 $\langle 27 \rangle$ Aluminum window system

28 ALUMINUM STOREFRONT SYSTEM

29 FOUNDATION DRAIN

<30> FORMLINER WITH "FLUTED RIB" PROFILE

31 N/A

32 STEEL CHANNELS, SEE STRUCTURAL DRAWINGS

33 N/A

WALL SCONCE LIGHT FIXTURE EA SIDE OF ENTRY DOOR.

35 BELOW GRADE BITUMINOUS DAMP PROOFING



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REVISIONS

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2 02 02 2022 SEPA RESUBMITTAL

10 01 2021 SEPA SUBMITTAL

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PROJECT INFORMATION



SHEET INFORMATION

RELEASE FOR: PROGRESS PRINTING TITLE:

WALL SECTIONS

SHEET NO:

DESIGNED BY: REVIEWED BY: 09-16-2021 DATE:

DRAWN BY: APPROVED BY:

A4.4

PROJECT NO: 200902.24.139