

Statement of Architectural and Contextual Compatibility Capones Hideout 136 West Bufford St. Burleson, Texas

To whom it may concern:

The site is located in the center of the block facing West Bufford Street. Formerly on the site, the structure was a single story wood frame building that had formerly been a residence before being converted into various commercial businesses. The original structure has been demolished. The adjacent structure to the east is a single story wood frame structure. The structure to the north will be a 2 story masonry structure and is currently under construction.


The elevation was designed to conform to the Vernacular Commercial Storefront style w/ larger display windows and a base brick accent, transom windows, recessed street entry, double entry doors and cornice accent treatment at the roof parapet..

DATE 1-17-24

SCALE 1"=20'


SHEET

)F

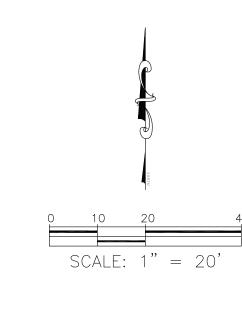

LEGEND

LIMITS OF PAVEMENT REPLACEMENT

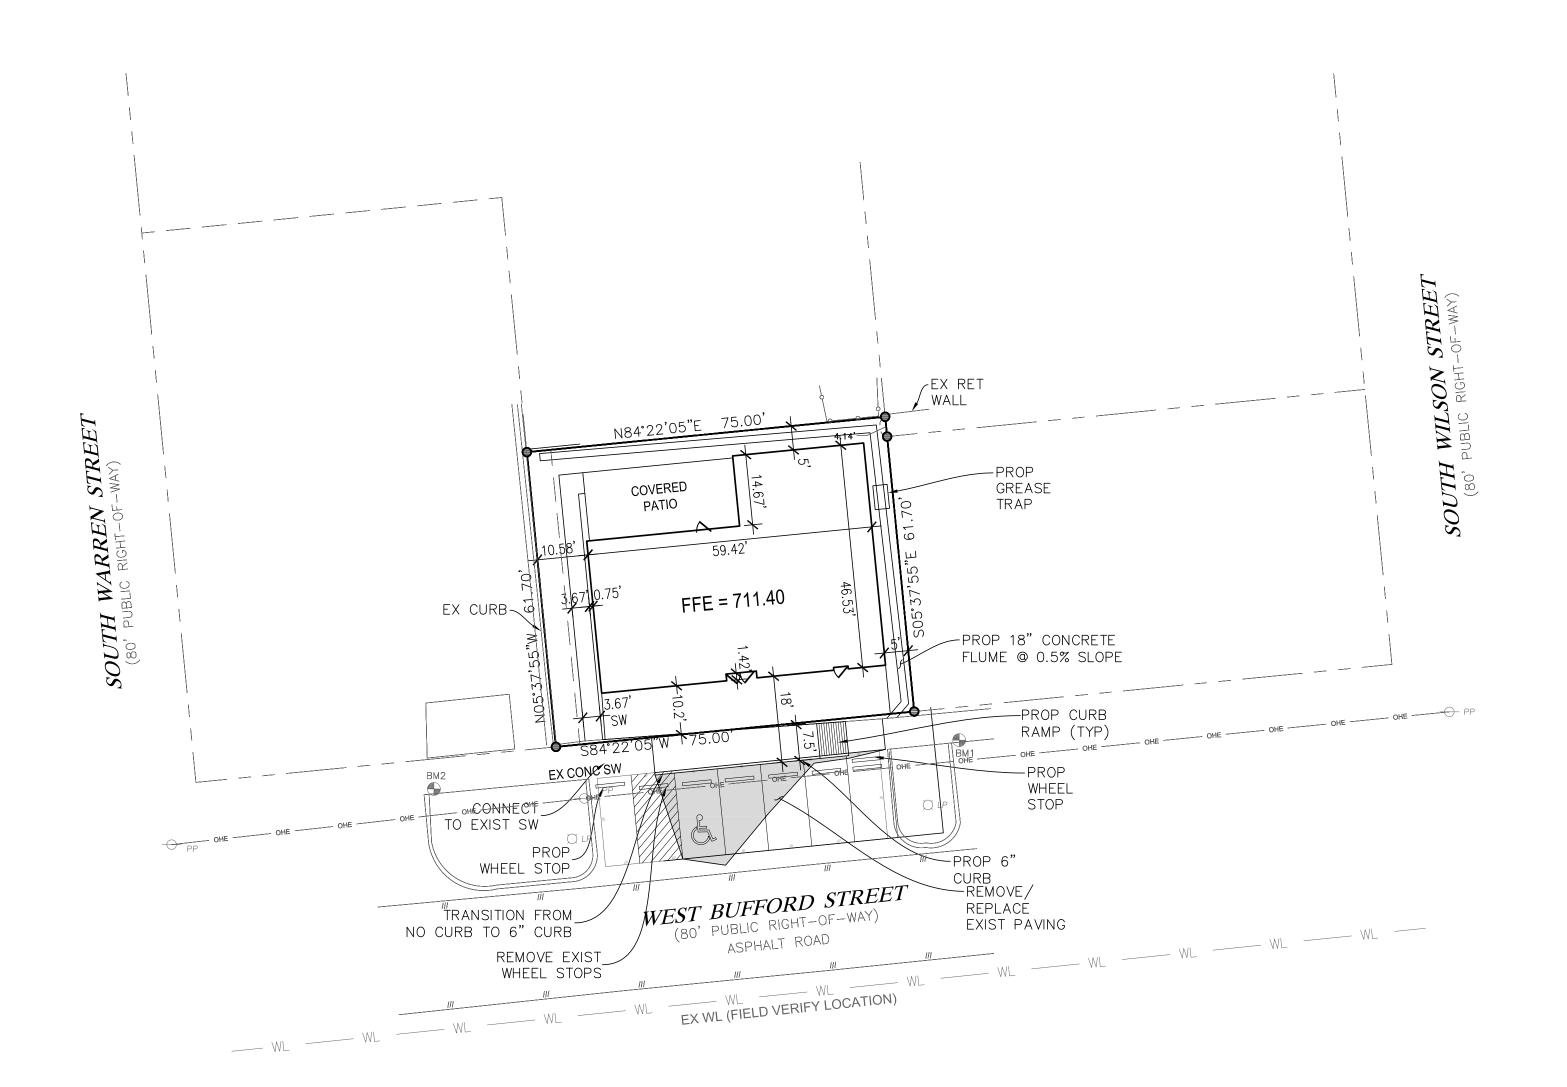

GENERAL NOTES:

- 1. THE CONTRACTOR SHALL VERIFY THE LOCATION, SIZE, AND MATERIAL OF ALL EXISTING UTILITIES AFFECTED BY CONSTRUCTION PRIOR TO COMMENCEMENT. CONTRACTOR SHALL CONTACT A UTILITY LOCATOR 48 HOURS PRIOR TO CONSTRUCTION.
- 2. THE CONTRACTOR SHALL BE RESPONSIBLE FOR OBTAINING ALL NECESSARY PERMITS FROM THE CITY.
- 3. THE CONTRACTOR SHALL BE SOLELY RESPONSIBLE FOR ALL CONSTRUCTION BEING IN ACCORDANCE WITH THE APPLICABLE FEDERAL, STATE, AND LOCAL REQUIREMENTS, REGULATIONS, STATUTES, STANDARDS, AND SPECIFICATIONS.
- 4. ALL MATERIALS AND WORKMANSHIP SHALL CONFORM TO THE STANDARD SPECIFICATIONS FOR PUBLIC WORKS CONSTRUCTION FOR NORTH CENTRAL TEXAS COUNCIL OF GOVERNMENTS, LATEST EDITION.
- 5. CONTRACTOR SHALL PROTECT EXISTING CONTROL MONUMENTATION AND BENCHMARKS. ANY SUCH POINTS WHICH THE CONTRACTOR BELIEVES WILL BE DESTROYED SHALL HAVE OFFSET POINTS ESTABLISHED BY THE CONTRACTOR PRIOR TO CONSTRUCTION, ANY MONUMENTATION DESTROYED BY THE CONTRACTOR SHALL BE REESTABLISHED AT HIS EXPENSE.
- 6. CONTRACTOR SHALL PROTECT ALL PUBLIC UTILITIES IN THE CONSTRUCTION OF THIS PROJECT.
- 7. ALL EARTHWORK OPERATIONS, PAVEMENT INSTALLATION, ETC. SHALL CONFORM TO THE RECOMMENDATION OF THE GEOTECHNICAL REPORT.
- 8. THE CONTRACTOR SHALL VERIFY THE SUITABILITY OF ALL EXISTING AND PROPOSED SITE CONDITIONS, INCLUDING GRADES AND DIMENSIONS BEFORE COMMENCEMENT OF ANY CONSTRUCTION. IN THE EVENT OF ANY CONFLICT, AND PRIOR TO COMMENCEMENT OF ANY CONSTRUCTION, IMMEDIATELY NOTIFY THE ENGINEER.
- 9. DIMENSIONS ARE FACE OF CURB OR FACE OF BUILDING, UNLESS OTHERWISE INDICATED.
- 10. ALL CONNECTIONS TO EXISTING PAVING SHALL HAVE A FULL DEPTH SAWCUT.
- 11. EROSION CONTROL SHALL BE IN PLACE PRIOR TO THE DISTURBANCE OF ANY EXISTING SURFACE.
- 12. REFER TO STORM WATER POLLUTION PREVENTION PLAN (SWPPP).






1.	PLANT LIST FOR THIS SHEET ONLY.
2.	PLANT LIST TO BE USED AS AIDE TO BIDDER ONLY. LANDSCAPE
	CONTRACTOR TO VERIFY ALL QUANTITIES.
3.	<u> </u>
	EXISTING VEGETATION IS EVIDENT, LANDSCAPE CONTRACTOR SHALL
	SPRAY AREA WITH BROAD SPECTRUM HERBICIDE APPLICATION TO
	REMOVE ANY VEGETATION.
4.	AFTER APPROPIATE TIME TO ENSURE A VEGETATION IS DEAD, TILL
	SUBGRADE AND RAKE SMOOTH, REMOVING ALL DEAD VEGETATION,
	STONES, CLODS AND DEBRIS.
5.	AFTER INSTALLATION OF STEEL EDGING, ALL BEDS SHALL BE TILLED
	TO A DEPTH OF 4-6", RAKING OUT ALL DEAD VEGETATION.
6.	APPLY A 2-3" DEPTH OF ORGANIC MATERIAL OVER ENTIRE BED AND
	TILL INTO EXISTING SOIL. ORGANIC MATERIAL SHALL BE ONE OF
	FOLLOWING:
	VITAL EARTH COMPOST
	BACK-TO-EARTH SOIL CONDITIONER
	LIVING EARTH COMPOST
	SOIL BUILDING SYSTEMS COMPOST
	SILVER CREEK MATERIALS COMPOST
7.	TOPDRESS ENTIRE BED WITH MINIMUM 2" DEPTH SHREDDED
	NATIVE CEDAR MULCH.
8.	ALL ORNAMENTAL TREES SHALL BE PLANTED AS PER DETAIL THIS SHEET.
9.	ALL LANDSCAPE AREAS SHALL BE WATERED WITH AUTOMATIC IRRIGATION
	SYSTEM, COMPLETE WITH FREEZE SENSOR, RAIN STAT, AND CONTROLLER.
	SYSTEM SHALL BE DESIGNED TO UTILIZE WATER-SAVING TECHNIQUES AN
	EQUIPMENT. INSTALLATION OF SYSTEM SHALL BE MADE BY A FIRM DULY

LANDSCAPE LEGEND

LICENSED UNDER ARTICLE NO. 8751 VTCS (LICENSED IRRIGATORS ACT),

S.B. NO. 259.

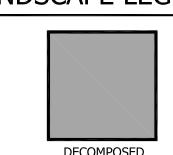

DECOMPOSED GRANITE (SEE NOTE BELOW)

DECOMPOSED GRANITE INSTALLATION NOTES:

a. EXCAVATE AS REQUIRED TO ACHIEVE PROPER FINISH GRADE. b. LANDSCAPE CONTRACTOR SHALL INSPECT D.G. AREAS FOR ANY EXISTING VEGETATION AND PROVIDE BROAD SPECTRUM HERBICIDE

APPLICATION TO REMOVE ANY VEGETATION. c. AFTER APPROPIATE TIME TO ENSURE A VEGETATION IS DEAD, TILL SUBGRADE AND RAKE SMOOTH, REMOVING ALL DEAD VEGETATION. d. TILL TOP 1" OF SUBGRADE AND COMPACT TO 95% PROCTOR.


e. INSTALL FILTER FABRIC OVER COMPACTED SUBGRADE. f. PLACE FOUR (4) INCHES OF 3/4" CLASS II AGGREGATE BASE- INSTALL 1" LIFTS, WITH EACH LIFT COMPACTED TO 95% PROCTOR. g. PLACE FOUR (4) INCHES OF DECOMPOSED GRANITE OVER COMPACTED AGGREGATE BASE, INSTALLING IN 1" LIFTS, COMPACTED TO 95%

h. PLACE FOUR (4) INCHES OF DECOMPOSED GRANITE OVER COMPACTED AGGREGATE BASE, INSTALLING IN 1" LIFTS, COMPACTED TO 95%


. AFTER FINISH GRADING, APPLY WATER-BASED POLYMER FORMULATION TO DECOMPOSED GRANITE AS PER MANUFACTURER'S DIRECTIONS.


CITY REQUIREMENTS

<u> </u>	
MIN. 20% SITE TO BE L	ANDSCAPE AREA
TOTAL SITE	4,627 SF
MIN. REQUIRED	•
PROVIDED	1,246 SF (26.93%)
MIN. 40% REQUIRED LA	ANDSCAPE IN FRONT YARD
MIN. REQUIRED	370 SF (40.00%)
PROVIDED	381 SF (41.19%)

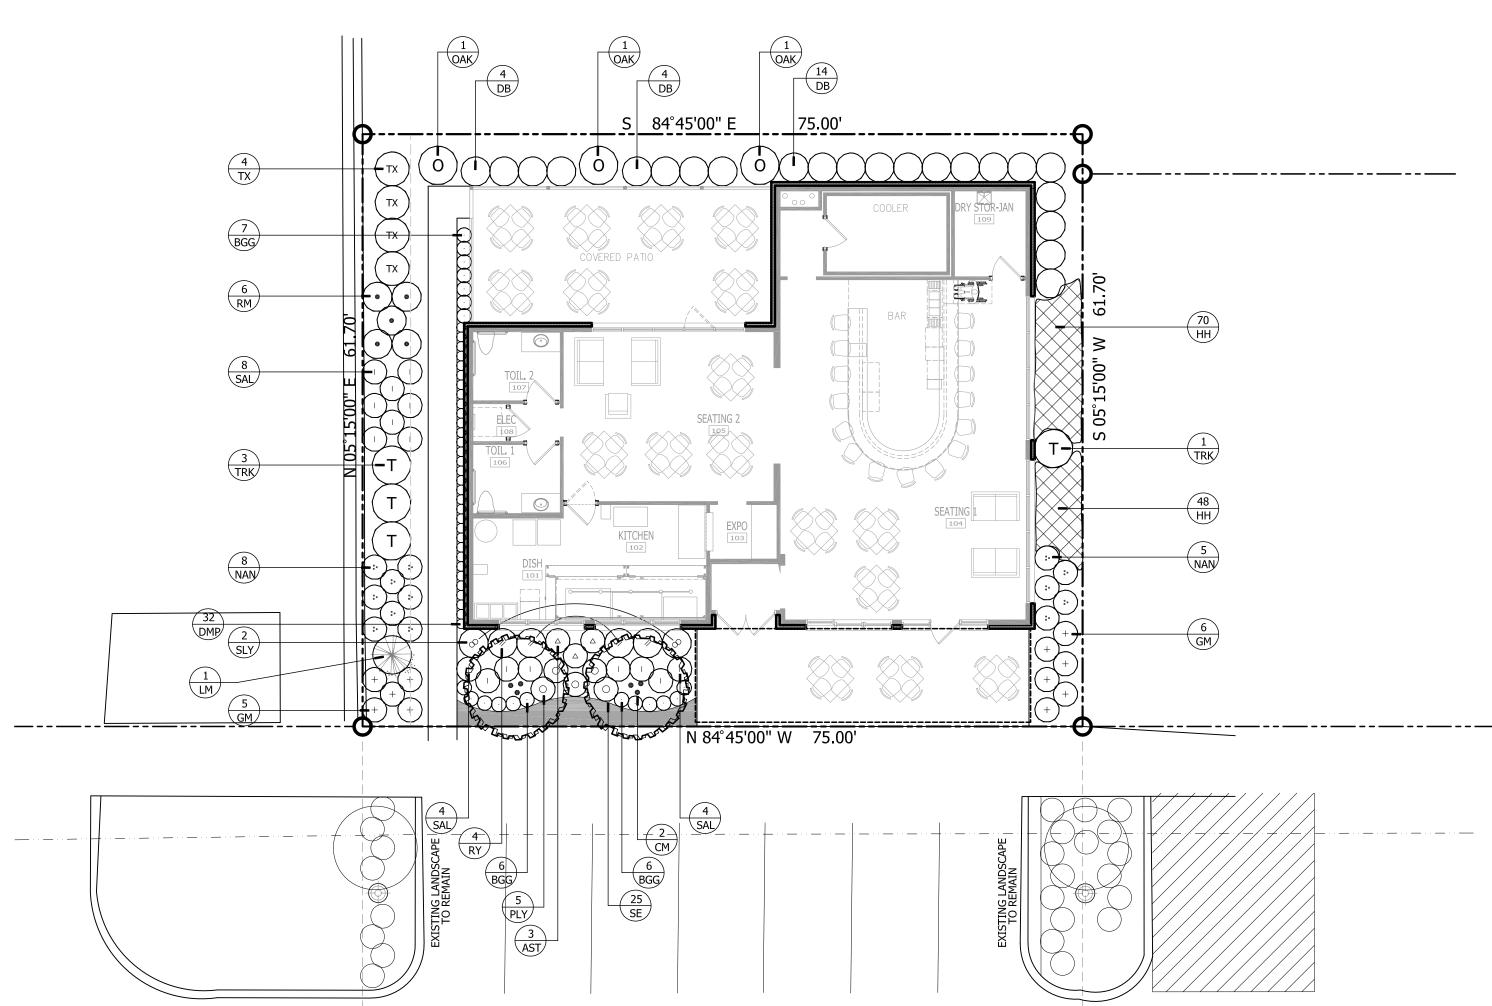

WEST BUFFORD STREET (80' RIGHT-OF-WAY)

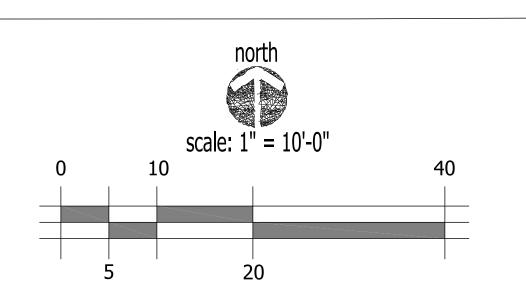

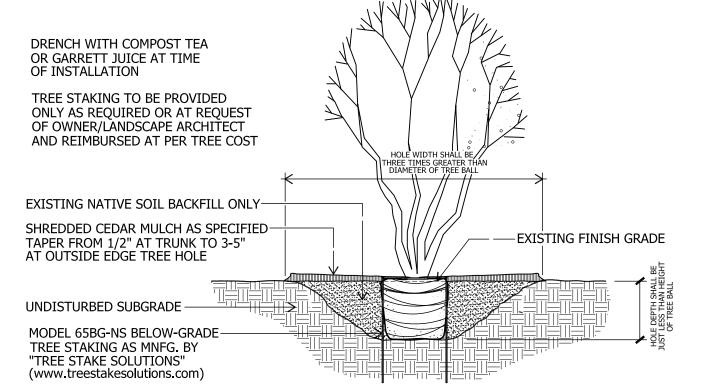

ANGLE EDGING AS SHOWN —


STEEL EDGING AS PER

— 2 1/2"-3" --- SIDEWALK

AT ALL EDGING/PAVEMENT

TREE PLANTING
TYPICAL MULTI-TRUNK TREE
not to scale



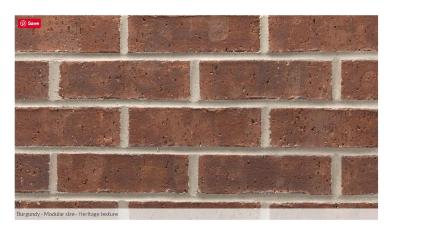

PRIMARY BRICK

COLOR 1



ACCENT BRICK

COLOR 2




BRONZE FINISH MINDOMS, DOORS, AMNING




CAPONES HIDE-OUT

230661

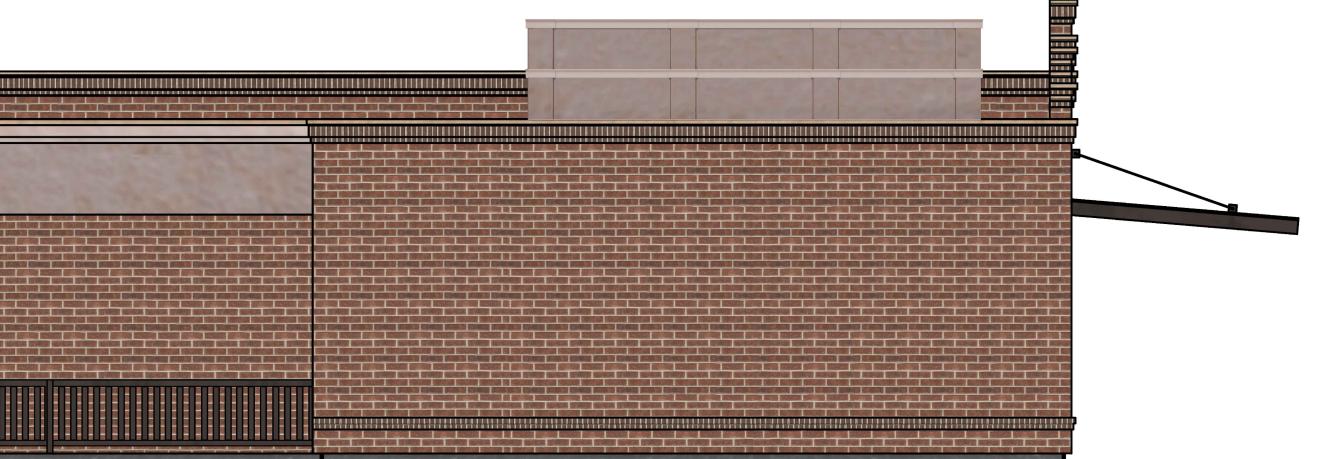

MEST ELEVATION

1/4" = 1'-0"

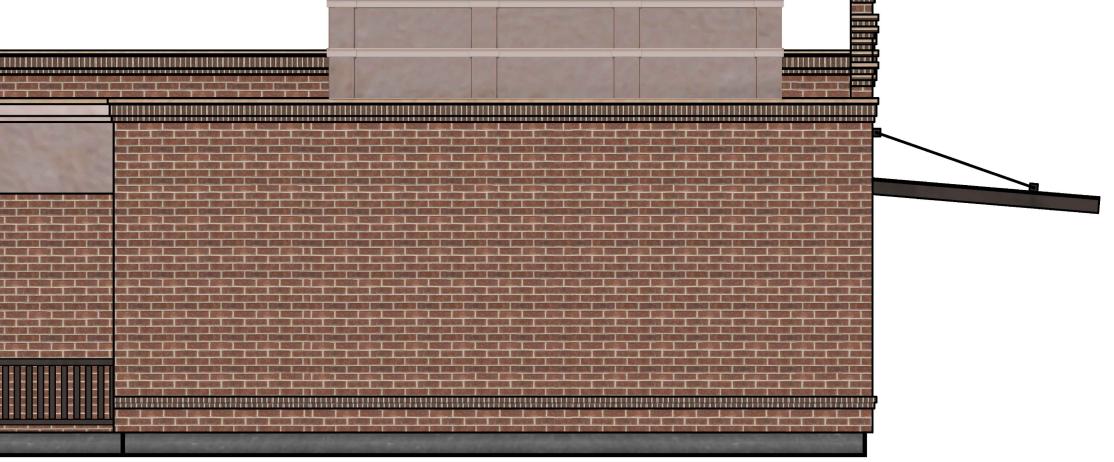



SOUTH ELEVATION- COLORED

ORIGINAL TOWN OF BURLESON BURLESON, TEXAS JOHNSON COUNTY

136 WEST BUFFORD ST. LOT &R BLOCK 13

DATE: 9-22-23 PD1 10-23-23 BID SET 11-03-23 RFI 04-09-24

CSP24-148

SHEET Title:

COLORED ELEVATION SCALE:1/4" = 1'0"



C COPYRIGHT 2024 NO. 10 DESIGN GROUP

SHEET No.:

A2-1a

