LOCATION / KEY MAP

SCALE: I" = 1000'±


SITE PLAN


FOR



PROPOSED BANK WITH REMOTE DRIVE-UP ATM

MAP 150A, LOTS 1 & 15 576 METACOM AVENUE (RHODE ISLAND ROUTE 136) TOWN OF BRISTOL, BRISTOL COUNTY, RHODE ISLAND

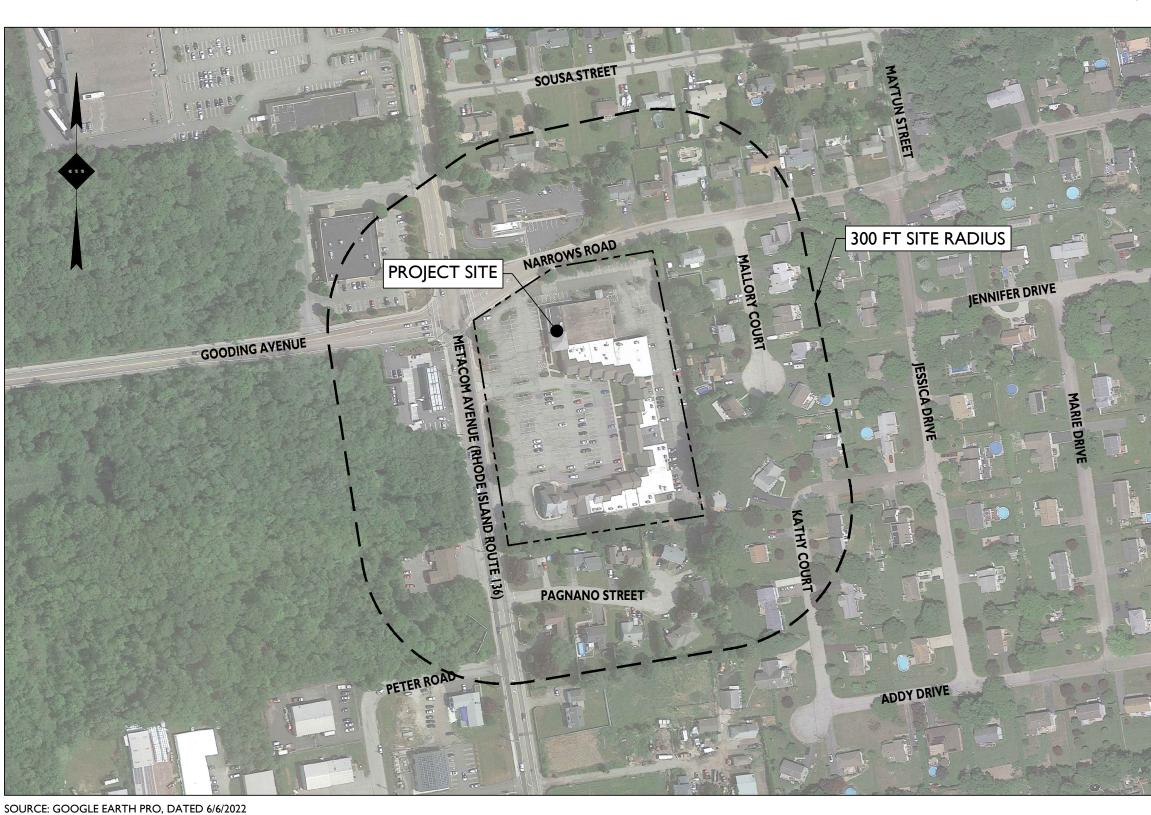

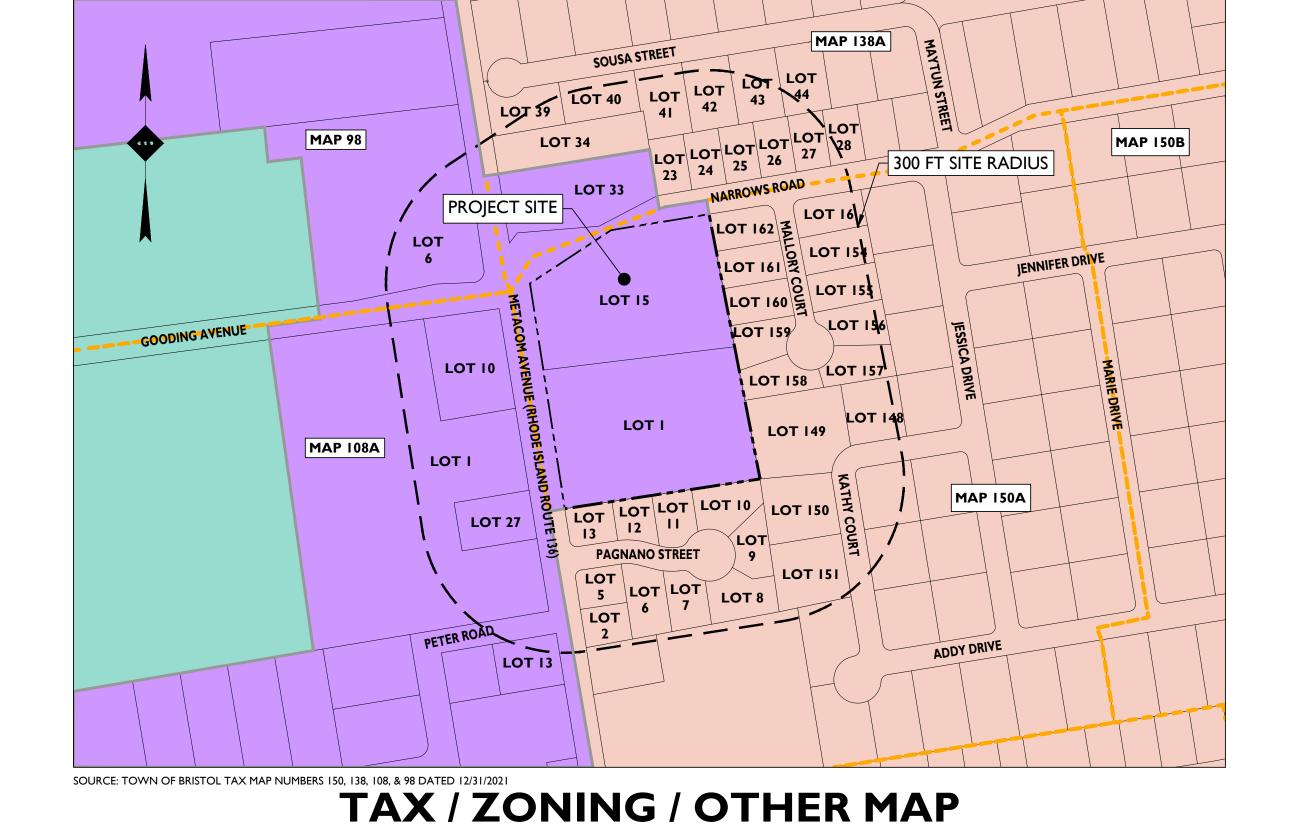

SCALE: $I'' = 200' \pm$

AERIAL MAP

PLAN REFERENCE MATERIALS:

- I. THIS PLAN SET REFERENCES THE FOLLOWING DOCUMENTS **INCLUDING, BUT NOT LIMITED TO:** BOUNDARY, PARTIAL TOPOGRAPHIC & UTILITY
 - SURVEY OF THE SUBJECT PROPERTY, PREPARED BY CONTROL POINT ASSOCIATES, INC., AND DATED 1/13/2023.
 - ARCHITECTURAL PLANS
 - **GEOTECHNICAL REPORT**
 - AERIAL MAP OBTAINED FROM GOOGLE EARTH PRO, **DATED 6/6/2022**
 - KEY MAP OBTAINED FROM USGS QUADRANGLE MAP 7.5 MINUTE SERIES, BRISTOL RI-MA, DATED 2021 & USGS QUADRANGLE MAP 7.5 MINUTE SÉRIES, FALL RIVER RI-MA,
 - TAX & ZONING MAPS OBTAINED FROM TOWN OF BRISTOL GIS, DATED 12/31/2021
- 2. ALL REFERENCE MATERIAL LISTED ABOVE SHALL BE CONSIDERED A PART OF THIS PLAN SET AND ALL INFORMATION CONTAINED WITHIN THESE MATERIALS SHALL BE UTILIZED IN CONJUNCTION WITH THIS PLAN SET. THE CONTRACTOR IS RESPONSIBLE TO OBTAIN A COPY OF EACH REFERENCE AND REVIEW IT THOROUGHLY PRIOR TO THE START OF


PLANS PREPARED BY:

STONEFIELD engineering & design

Rutherford, NJ · New York, NY · Boston, MA Princeton, NJ · Tampa, FL · Detroit, MI www.stonefieldeng.com

I Beacon Street, 15 Floor, Boston, MA 02108 Phone 617.203.2076

SCALE: $I'' = 200' \pm$

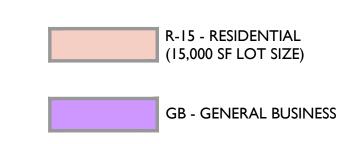

ZONING LEGEND

OS - OPEN SPACE



Know what's **below** Call before you dig.

SHEET IND	EX
DRAWING TITLE	SHEET #
COVER SHEET	C-I
EXISTING CONDITIONS PLAN	C-2
DEMOLITION PLAN	C-3
SITE PLAN	C-4
LIGHTING PLAN	C-5
CONSTRUCTION DETAILS	C-6 - C-7

			SPECIAL PERMIT SUBMISSION	SPECIAL PERMIT SUBMISSION	REVISED DRIVE-THRU CONCRETE MAT	ADDENDUM #1	REVISED PER ADA ENTRANCE LANDING	REVISED PER ADA PARKING IMPROVEMENTS	ISSUED FOR REVIEW	DESCRIPTION	
			EB	EB	JJR	JJR	JJR	JJR	JJR	ВҮ	
			09/08/2023	08/04/2023	5/3/2023	4/10/2023	4/5/2023	3/29/2023	3/3/2023	DATE	
			7	9	2	4	3	7	-	ISSUE	
١	IOT	ΔΡΙ	PRA	VFI) F()	R C	ON'	STR	IIC.	LION	

NOT APPROVED FOR CONSTRUCTION



JOSHUA H. KLINE, P.E. RHODE ISLAND LICENSE No. 13607 LICENSED PROFESSIONAL ENGINEER





SCALE: AS SHOWN PROJECT ID: BOS-220076


COVER SHEET


DRAWING:

C-I

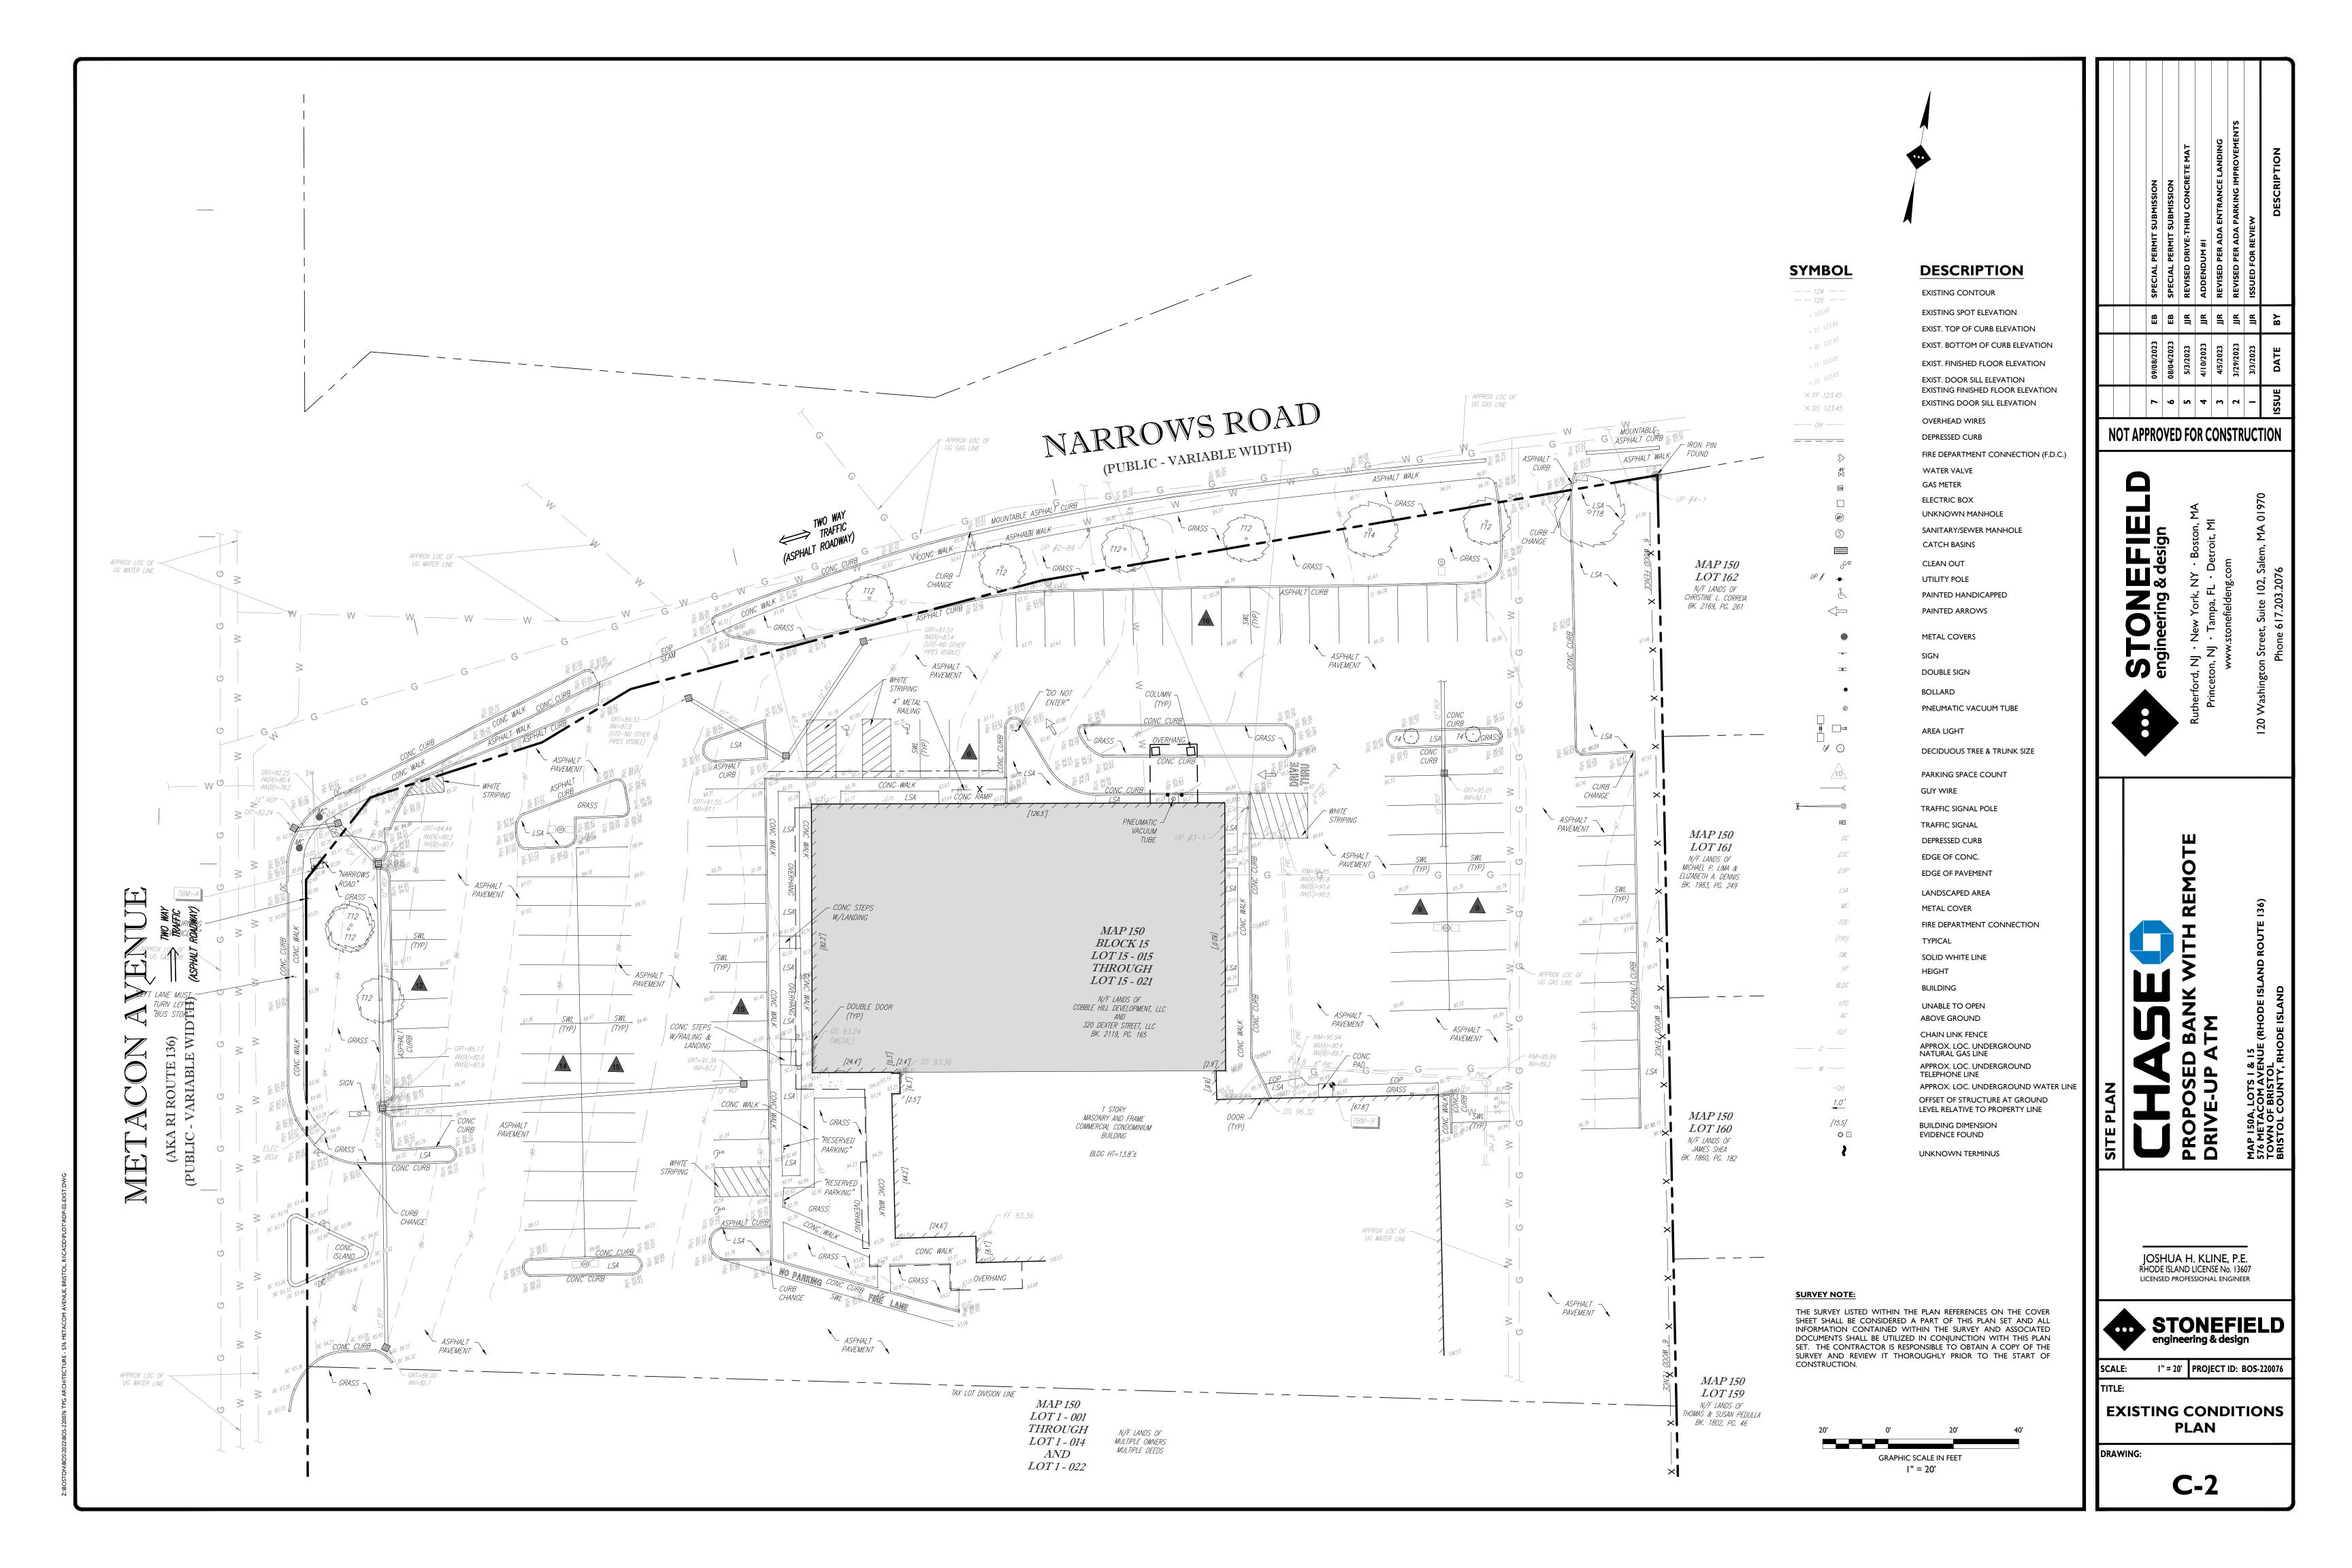

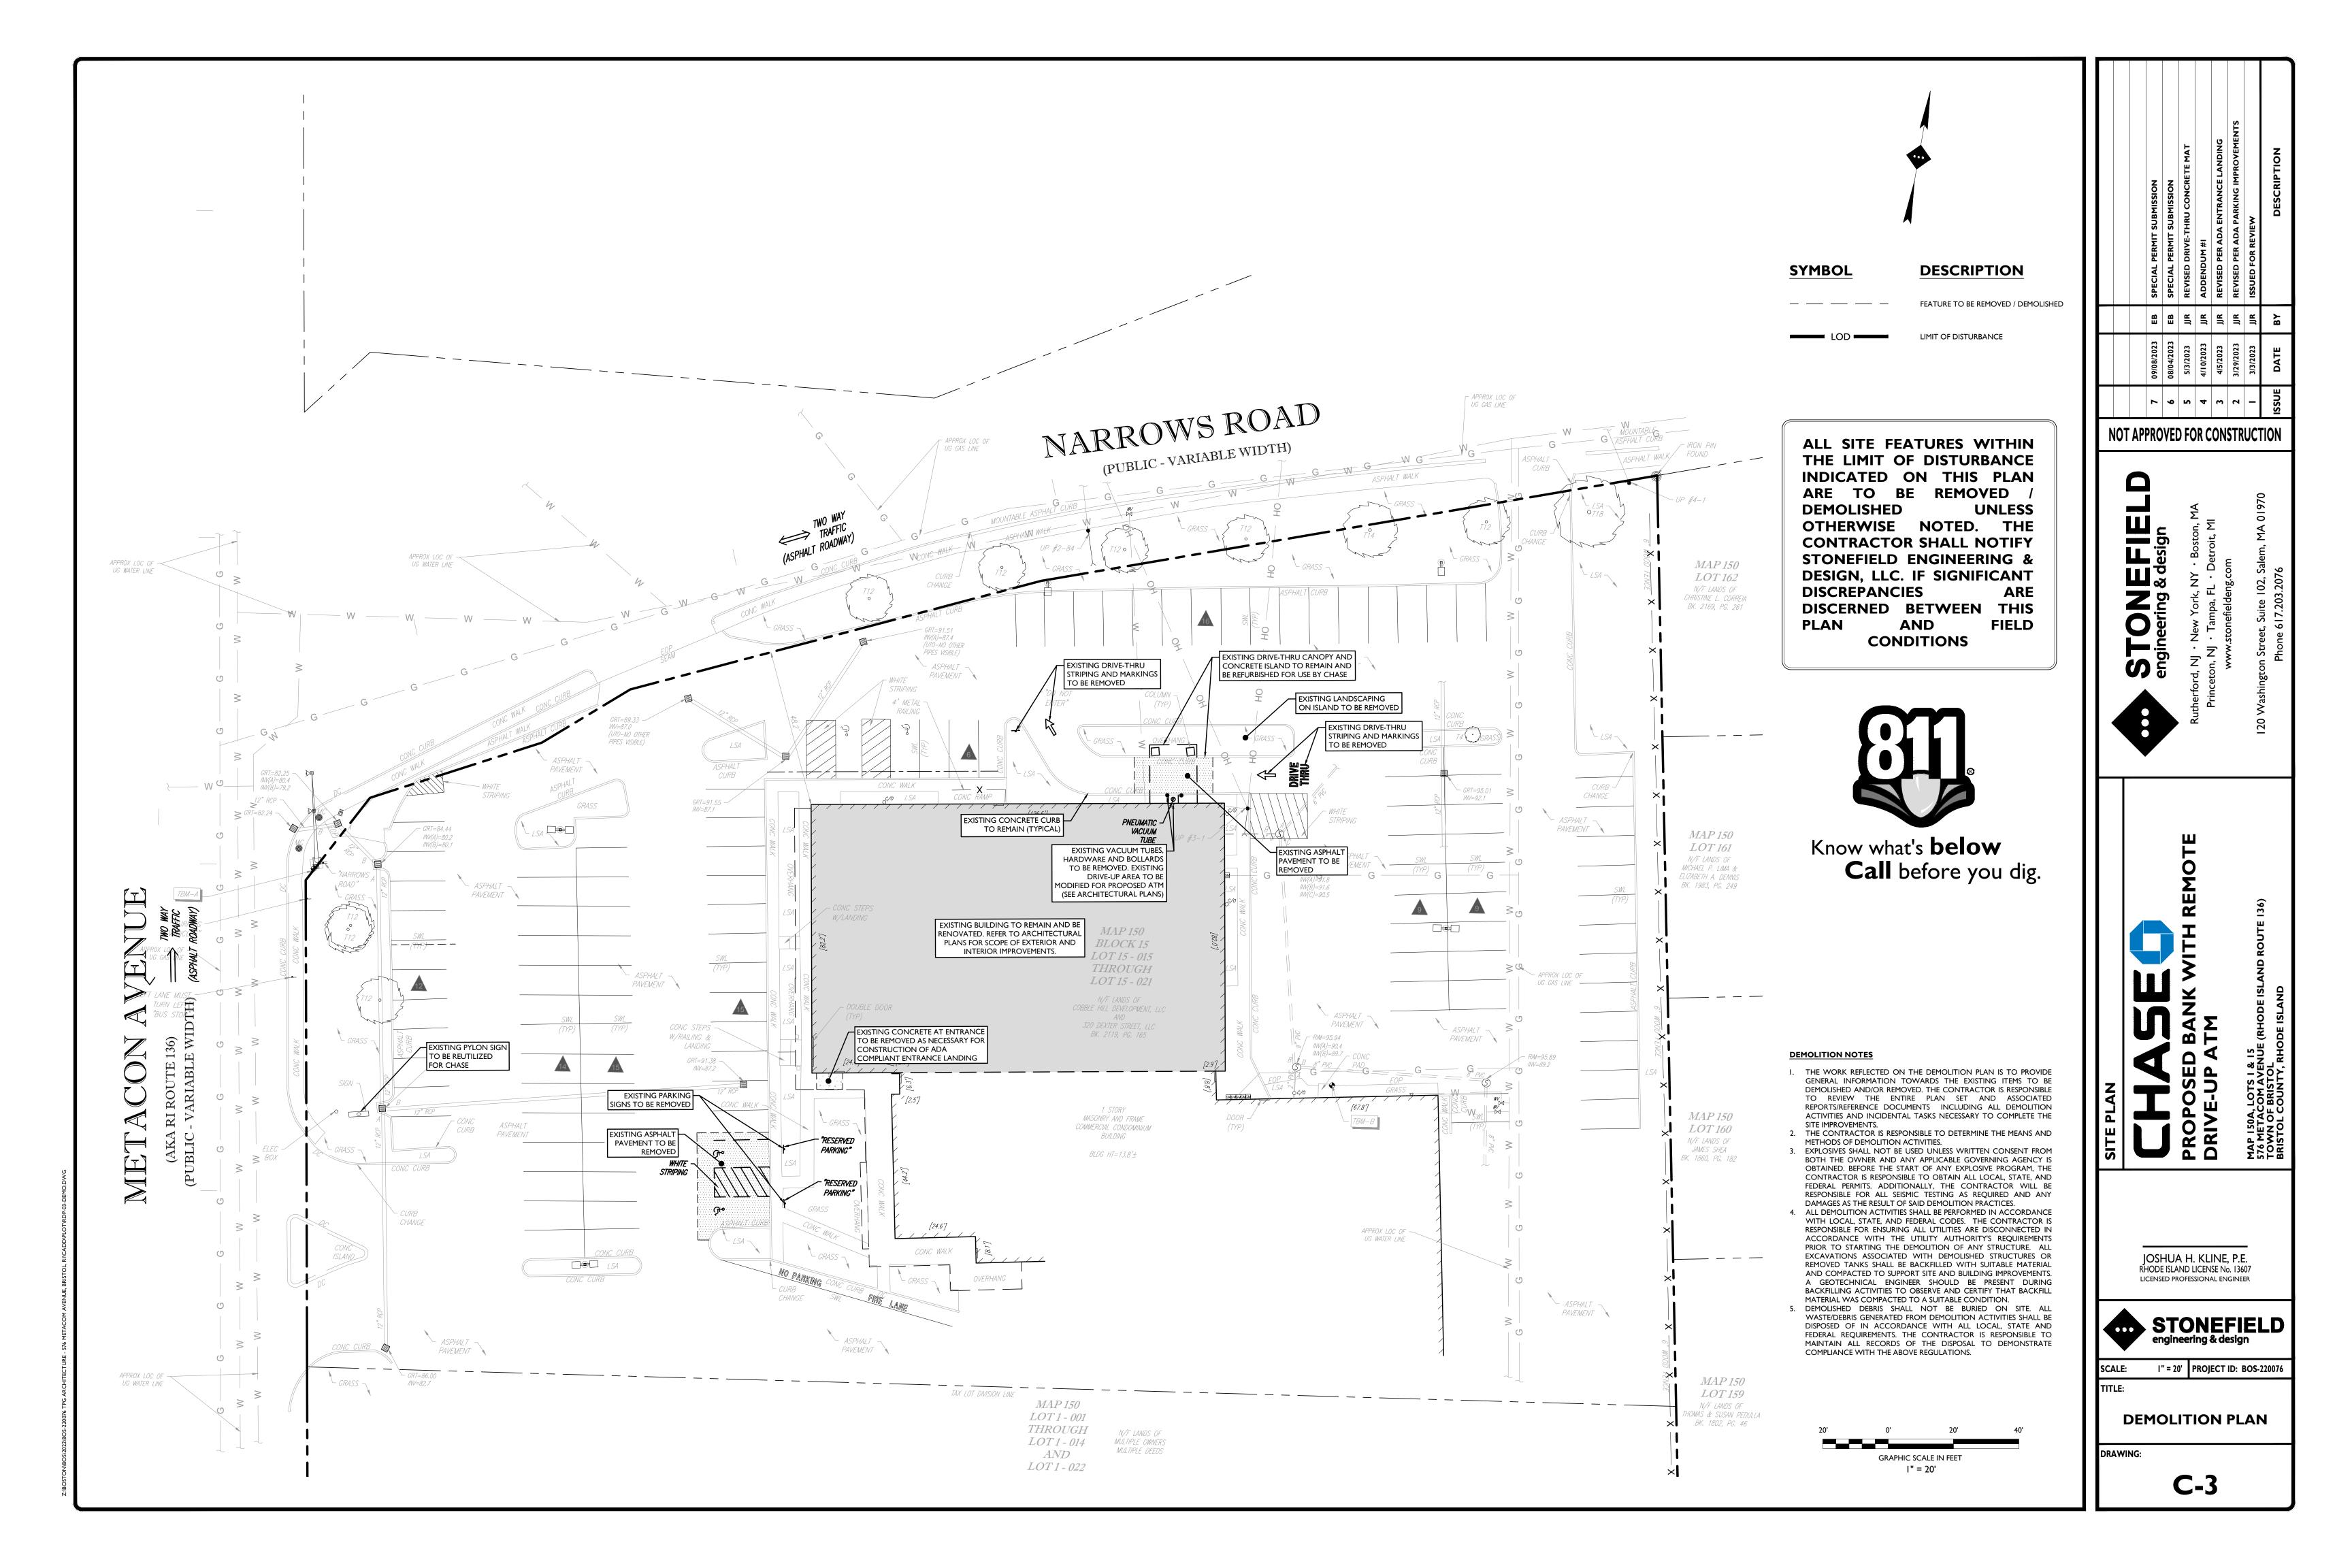

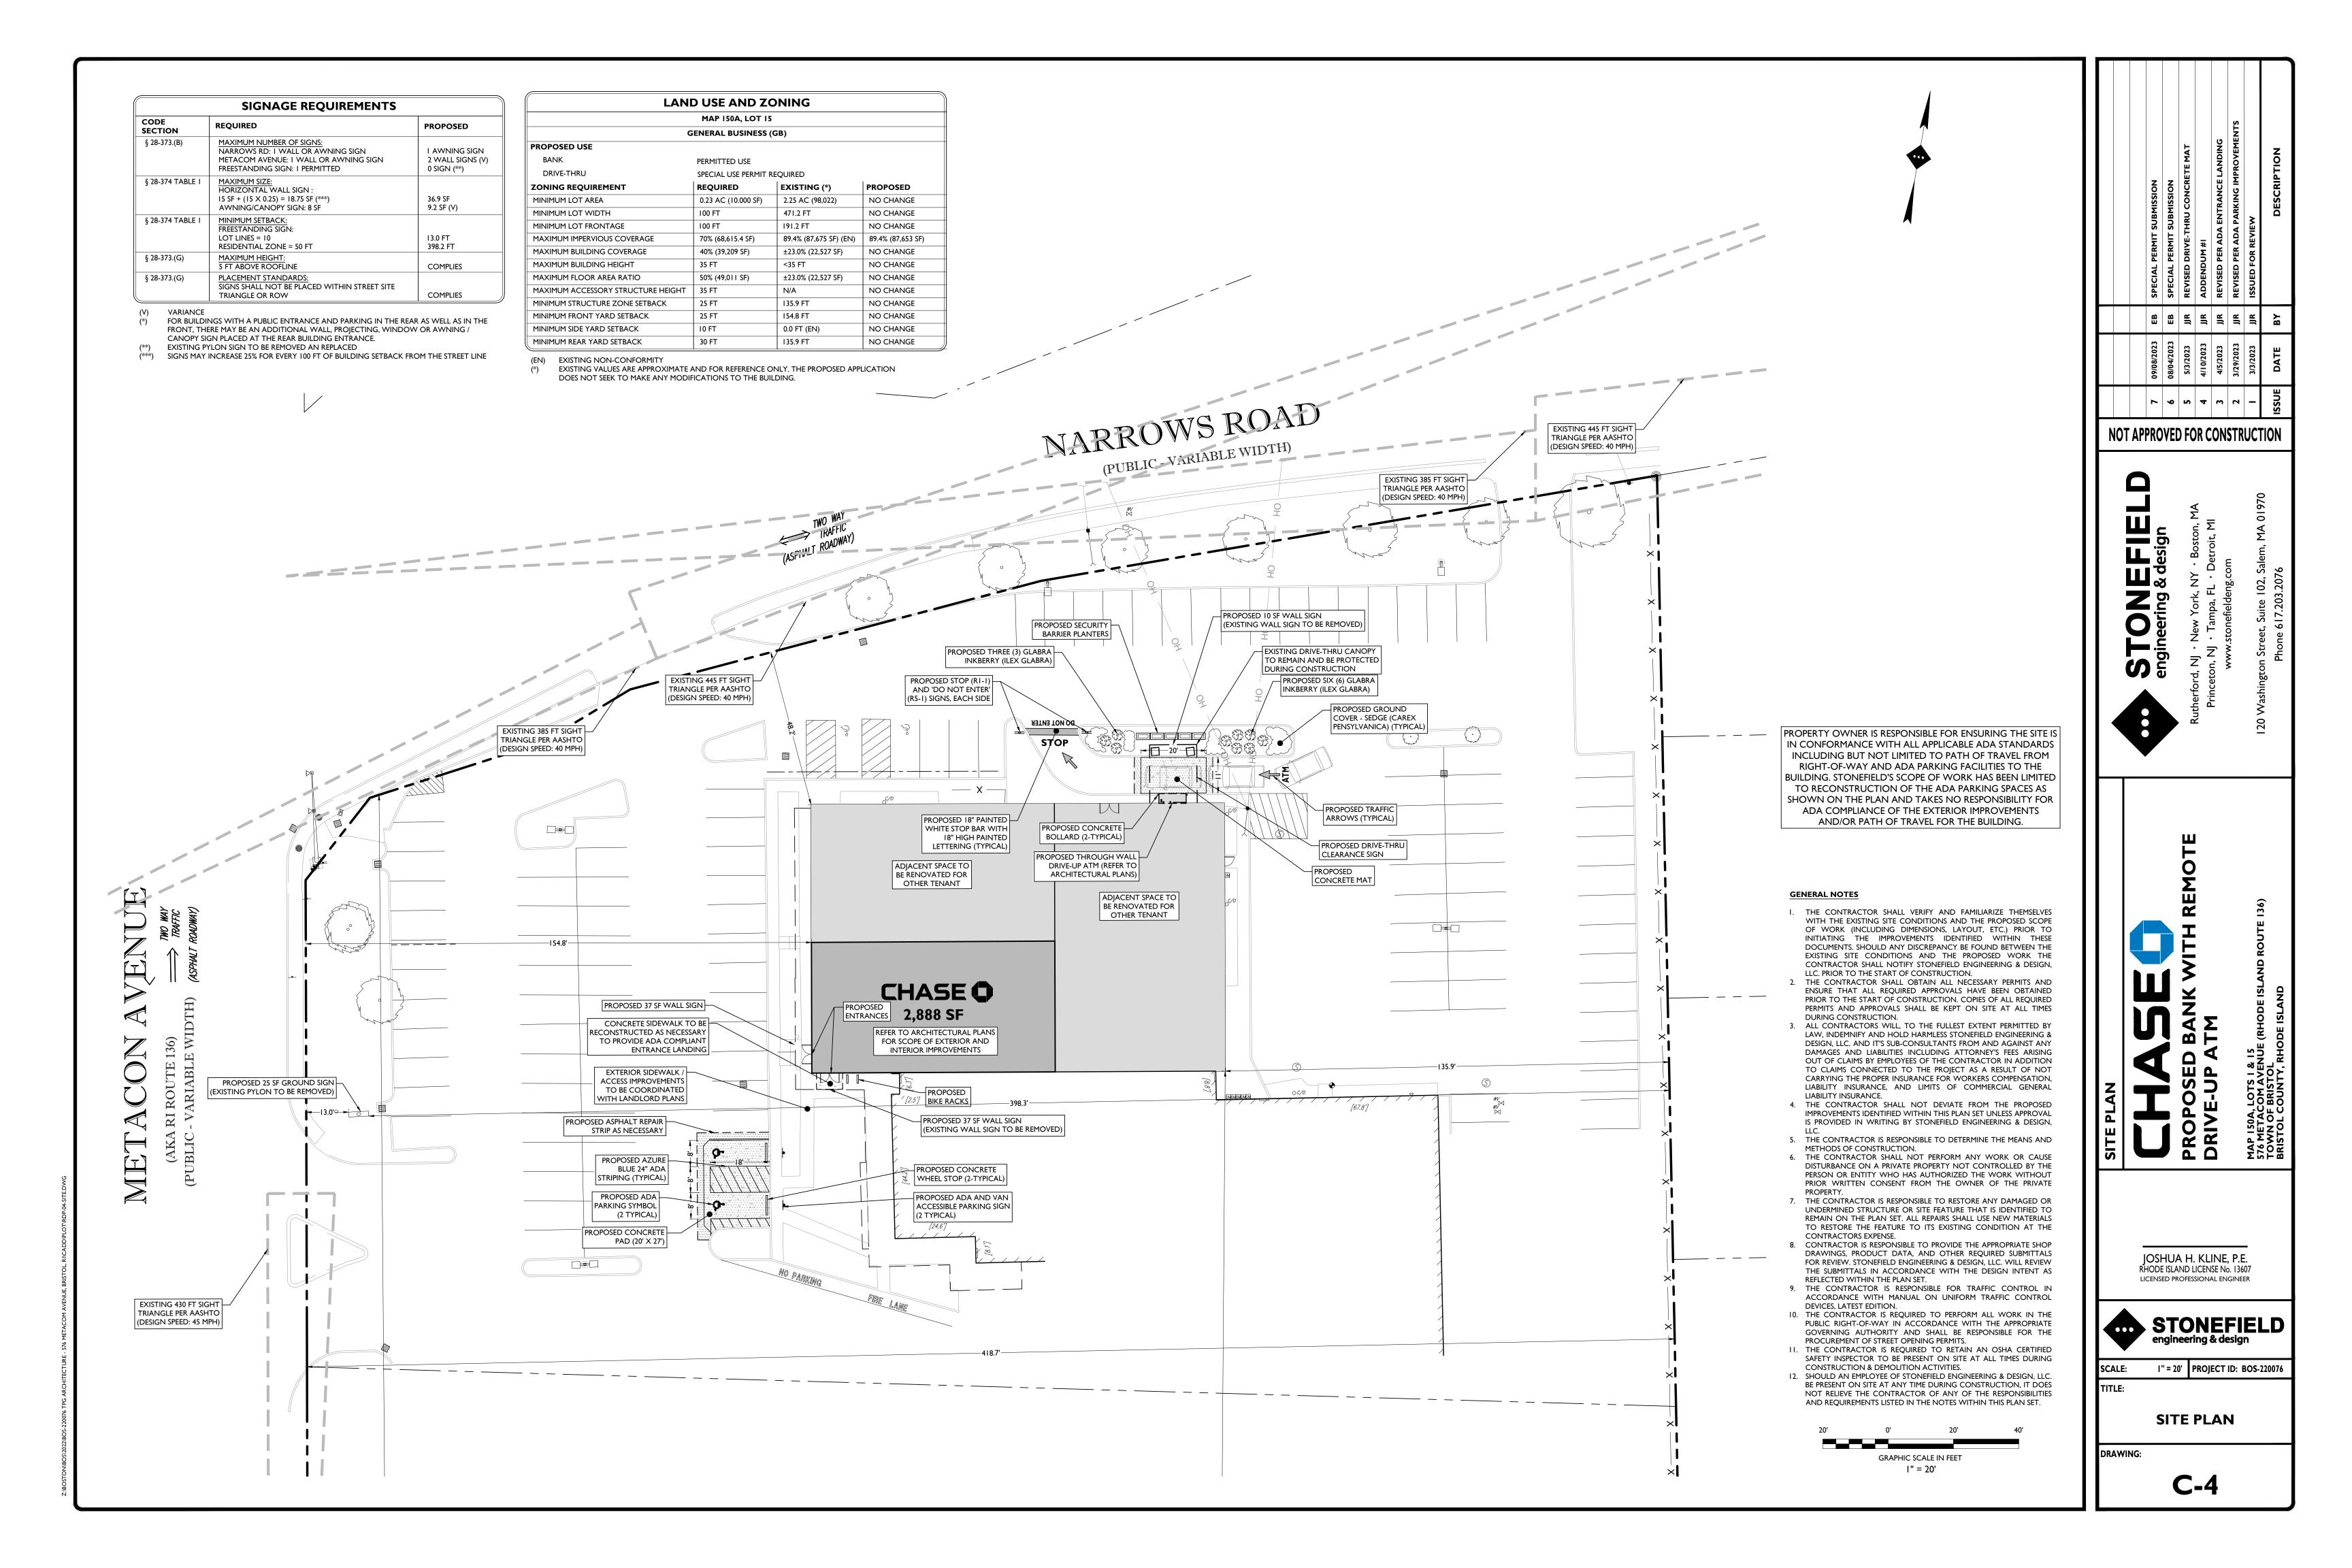

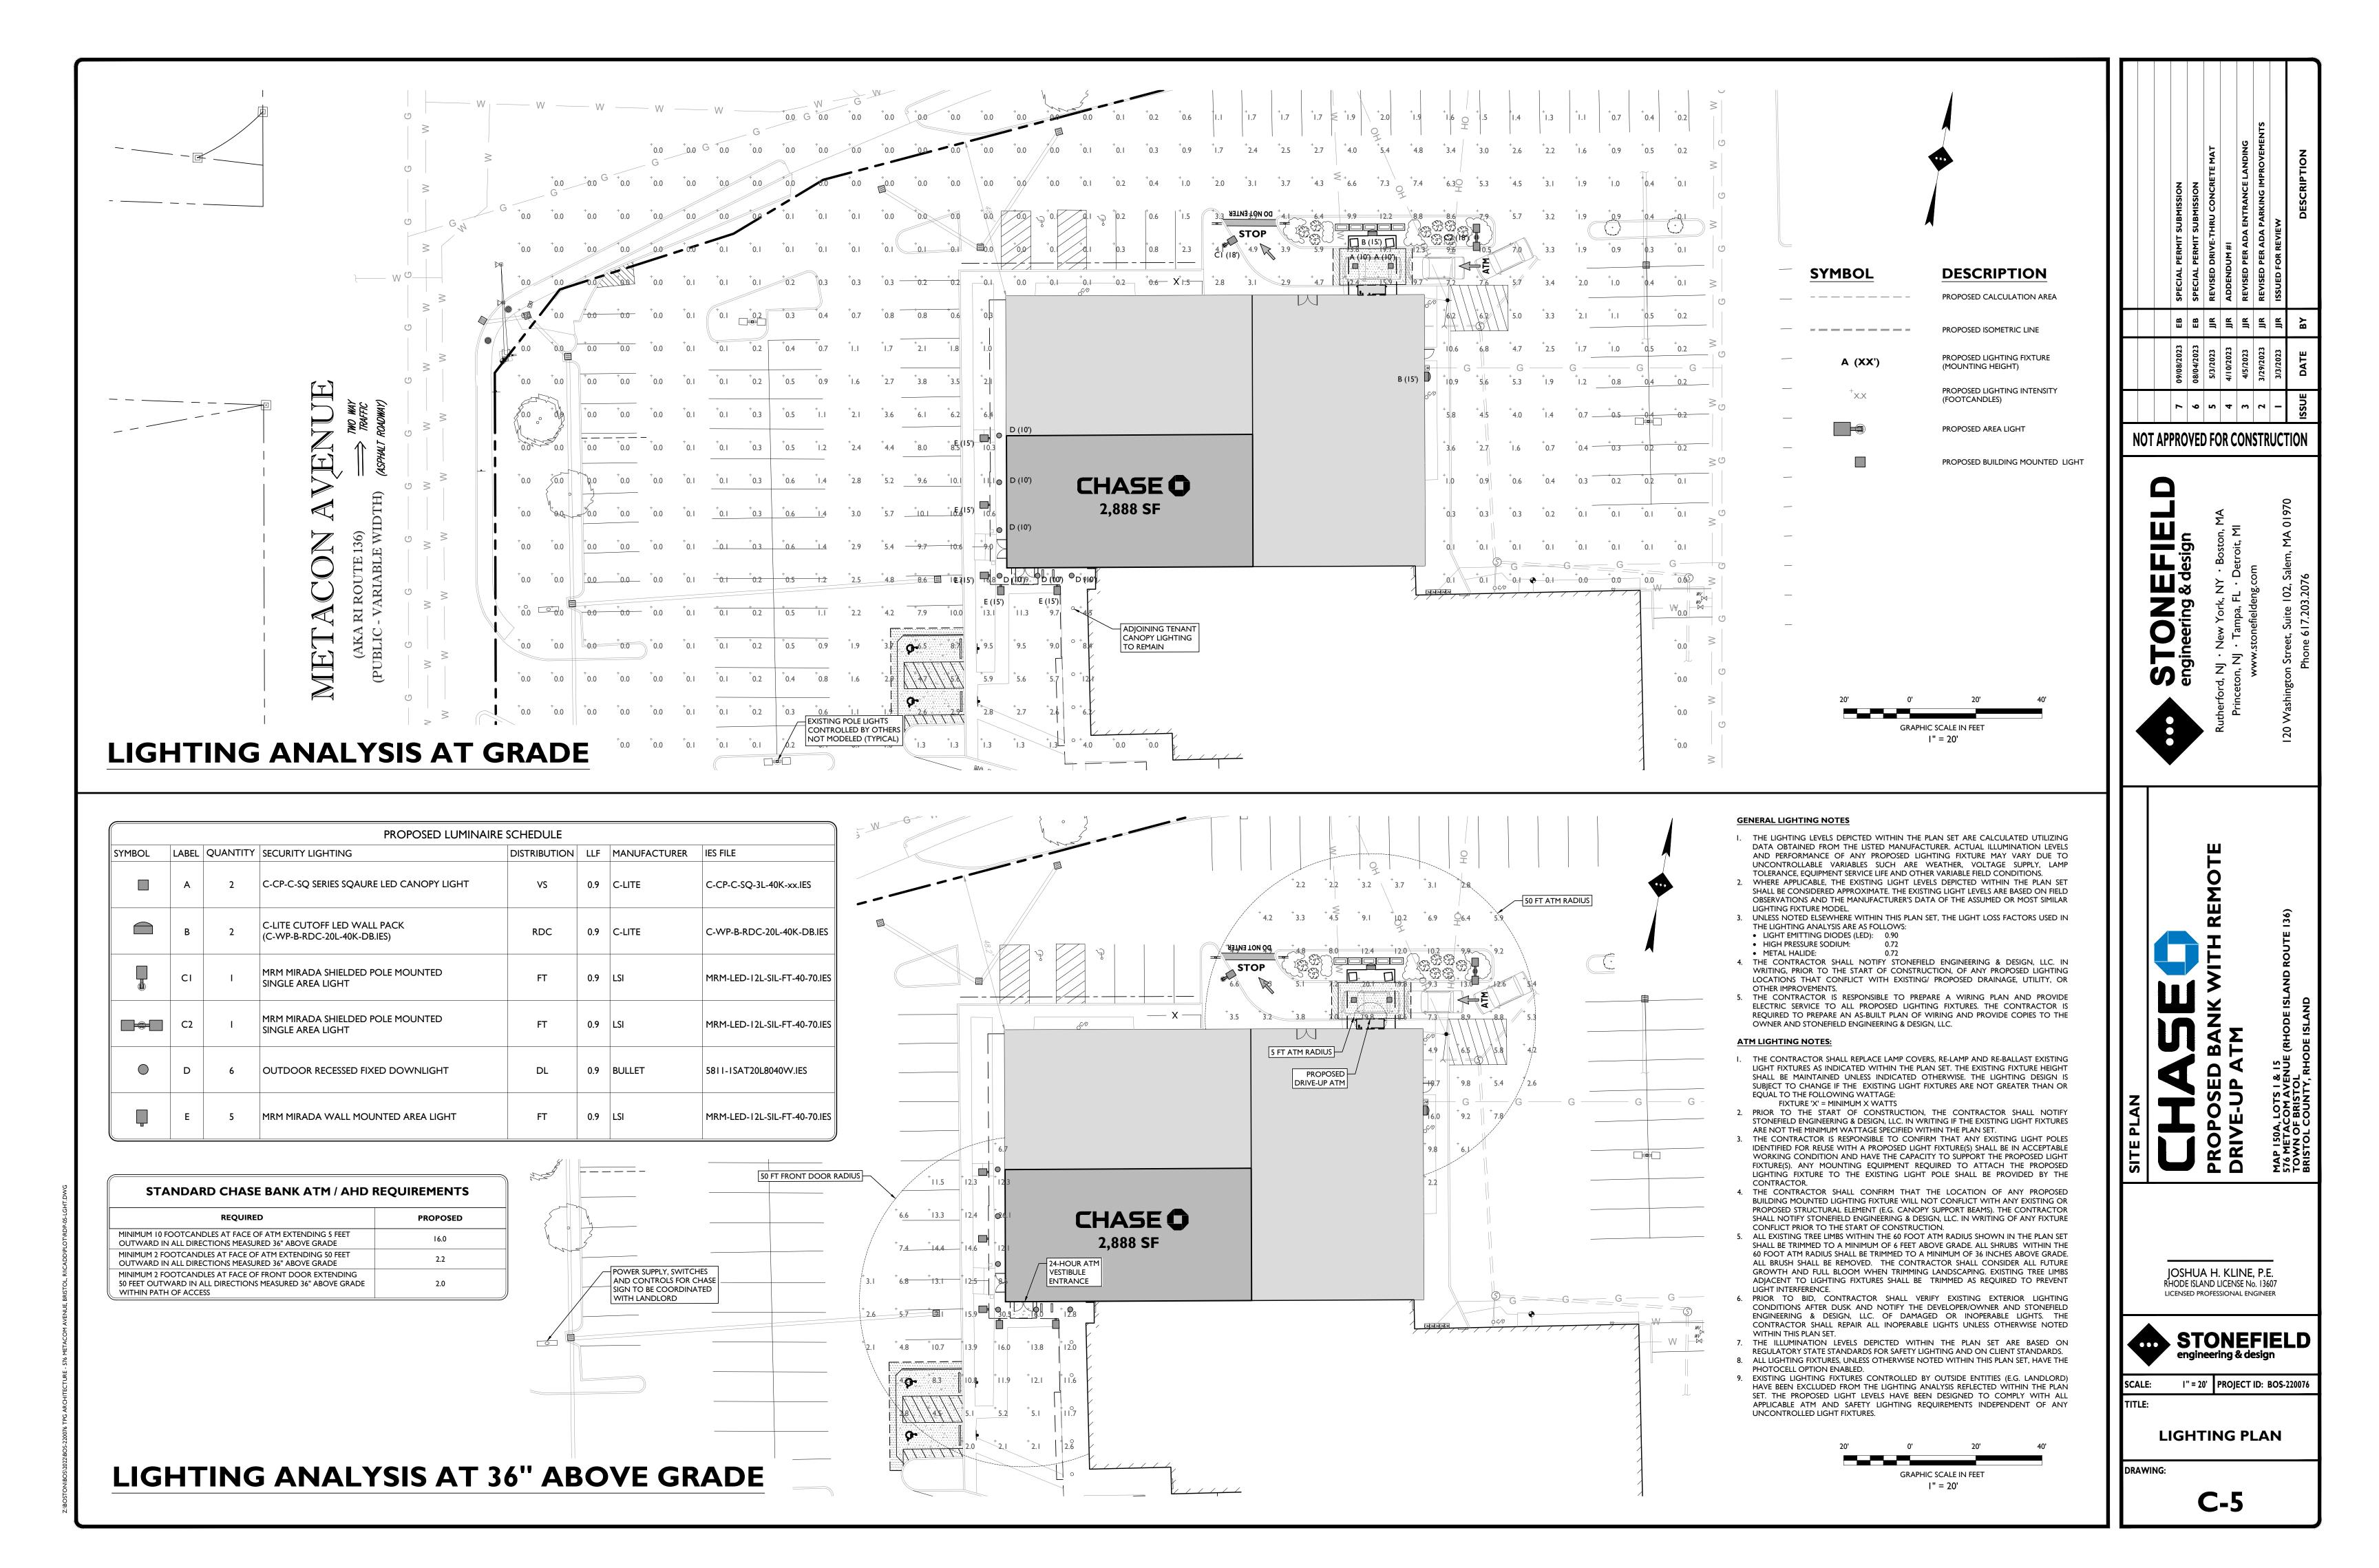



AFFORDABLE, ENERGY EFFICIENT AND MADE TO LAST Our C-CP-C-SQ Series Square LED Canopy Light features a highly durable design and delivers affordability and energy efficiency to any canopy application. It comes cULus Listed for wet locations and is DLC Premium 5.1 Listed, delivering up to 144 LPW.

This means it delivers even more savings on monthly energy

bills than less energy efficient products. It's a perfect option

for added security at entryways and around perimeters.



PRODUCT SPECIFICATIONS

Initial Delivered Lumens: 3800 (3L); 4900 (4L);

- 7000 (7L) ; 13,000 (12L) CRI: ≥ 70
- CCT: Neutral White 4000K, Cool White 5000K Input Power: 27W (3L); 38W (4L); 53W (7L); 90W (12L) Dimmable: 0-10V to 10%
- Estimated L₇₀ Lifetime @ 25°C: >54,000 hours Power Factor: > 0.9
- Operating Temperature Range: -22°F to 104°F (-30°C to 40°C)

TOWELL ACTOL > 0.0
 Total Harmonic Distortion: < 20% at full load
• Limited Warranty: 5-Years*
• 3L & 4L: Replaces 100W PSMH; 7L: Replaces 150W PSMH/175W
MH; 12L: Replaces 250W PSMH
 For use under covered ceilings only

FEATURES	DURABLE	RECOMMENDED USE	INPUT VOLTAGE
 Uses up to 80% less energy than comparable PSMH fixtures Type VS distribution pattern 	Polyester powder-coat finish provides corrosion protection for long-lasting color UV-stabilized acrylic lens designed to last Die-cast aluminum housing	Security Entryways Perimeter Lighting Exterior canopies	• Universal (120V through 277V Operation)

ORDERING INFORMATION Example: C-CP-C-SO-12L-50K-DB

C-CP-C	SQ				
PRODUCT	SHAPE	LUMEN PACKAGE		CCT	COLOR
C-CP-C	SQ Square	3L 3800 Lumens 27W 4L 4900 Lumens 38W	7L 7000 Lumens 53W 12L 13,000 Lumens 90W	40K Neutral White (4000K) 50K Cool White (5000K)	DB Dark Bronze WH White

AREA LIGHT FIXTURE 'A' SPECIFICATIONS

NOT TO SCALE



For informational purposes only. Content is subject to change. *See lighting.cree.com/warranty for details

Replaces up to 400W PSMH

Cutoff LED Wall Pack

C-LITE LEB LIGHTING C-WP-B-RDC Series

OFF THE WALL SAVINGS

Our cULus listed C-Lite Cutoff LED Wall Pack delivers up to 21,100 lumens and is available in 4000K and 5000K. It's dimmable, for maximum energy savings, and comes with a 5-year limited warranty. It also comes with a DLC Premium 5.1 Listing.



• Operating Temperature Range: -40°F to 104°F (-40°C to 40°C)

PRODUCT SPECIFICATIONS

- OVERVIEW • Initial Delivered Lumens: 1500 - 21,000 Lumens
- CRI: ≥ 70
- CCT: 4000K, 5000K Mounting height: 12 - 25 feet Input Power: 12W/22W/47W/77W/144W

Dimmable: Yes, 0-10V

 Estimated L70 Lifetime @ 25°C: > 100,000 hours Power Factor: > 0.9 • Total Harmonic Distortion: < 20%

Limited Warranty: 5 Years*

Replaces up to 400 PSMH


FEATURES	RECOMMENDED USE	INPUT VOLTAGE
Replaces up to 400W PSMH4kV Surge suppressionContractor friendly install	- Security - Perimeter - Commercial	• Universal (120V through 277V Operation)

ORDERING INFORMATION Example: C-WP-B-RDC-1L-40K-DB

C-WP	В	RDC				DB	
PRODUCT	SERIES	TYPE	LUMEN PA	CKAGE	CCT	COLOR	
C-WP	В	RDC Round Cutoff	LUMEN PACKAGE 1L 1500L 1500L 12W 3L 3000L (4000K), 3100L (5000K) 22W 20L 20,900L (4000K), 21,100L (5000K) 144W 6L 6200L (4000K), 6300L (5000K) 47W		40K 4000K (Neutral White) 50K 5000K (Cool White)	DB Dark Bronze	
CERTIFICATIONS-							

LISTED SYEAR For informational purposes only. Content is subject to change. *See lighting.cree.com/warranty for details

AREA LIGHT FIXTURE 'B' SPECIFICATIONS

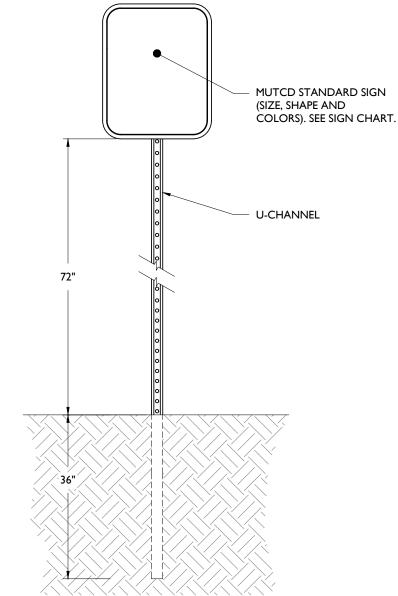


M.U.T.C.D.	TEXT	СО	LOR	SIZE OF SIGN (WIDTH X	TYPE OF
NUMBER	TEXT	LEGEND	BACKGROUND	HEIGHT)	MOUNT
STOP SIGN (RI-I)	STOP	RED	WHITE	36"x36"	GROUND
DO NOT ENTER (R5-1)	DO NOT ENTER	RED	WHITE	30"x30"	GROUND

I. ALL SIGNS SHALL BE IN ACCORDANCE WITH THE FEDERAL HIGHWAY ADMINISTRATION (FHWA) MANUAL ON UNIFORM TRAFFIC CONTROL DEVICES (MUTCD), EXCEPT AS NOTED. 2. ALL SIGNS SHALL BE MOUNTED AS TO NOT OBSTRUCT THE SHAPE OF "STOP" (R1-1) AND "YIELD" (RI-2) SIGNS.

SIGN POST DETAIL

NOT TO SCALE

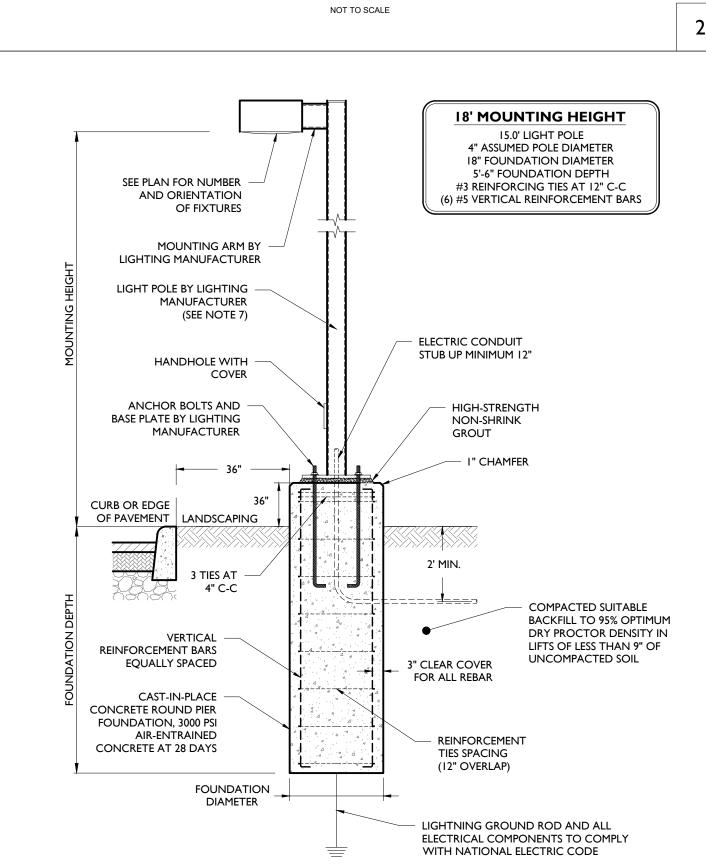


LIGHT POLE 'E' INSTALLATION DETAIL

NOT TO SCALE


I. MINIMUM SOIL BEARING PRESSURE OF 1500 PSF, SOIL FRICTION ANGLE OF 30 DEGREES, AND SOIL DRY UNIT WEIGHT OF 120 PCF SHALL BE CONFIRMED IN THE FIELD BY A QUALIFIED PROFESSIONAL. 2. CAST-IN-PLACE CONCRETE SHALL BE CONSOLIDATED USING VIBRATOR.


- ALL REBAR TO BE NEW GRADE 60 STEEL. 4. PRE-CAST PIERS ACCEPTABLE UPON WRITTEN APPROVAL OF SHOP DRAWING BY ENGINEER.
- 5. CONCRETE TO BE INSTALLED A MINIMUM OF 7 DAYS PRIOR TO INSTALLING LIGHT POLE. POURED CONCRETE MIX REQUIRED TO OBTAIN 80% OF DESIGN STRENGTH PRIOR TO INSTALLING LIGHT POLE. 6. CONCRETE SHALL HAVE A MAXIMUM SLUMP OF 4" (WITHIN I" TOLERANCE). POLE SHALL BE RATED FOR 10 MPH HIGHER THAN MAXIMUM WIND SPEED 33FT ABOVE GROUND FOR THE AREA BASED
- ON ANSI/ASCE 7-93. 8. POUR TO BE TERMINATED AT A FORM. WORK SHALL CONFORM TO ACI BEST PRACTICES FOR APPROPRIATE TEMPERATURE AND WEATHER CONDITIONS. 10. CONTRACTOR TO TEMPORARILY SUPPORT ADJACENT SOIL AND STRUCTURES DURING EXCAVATION IF REQUIRED.

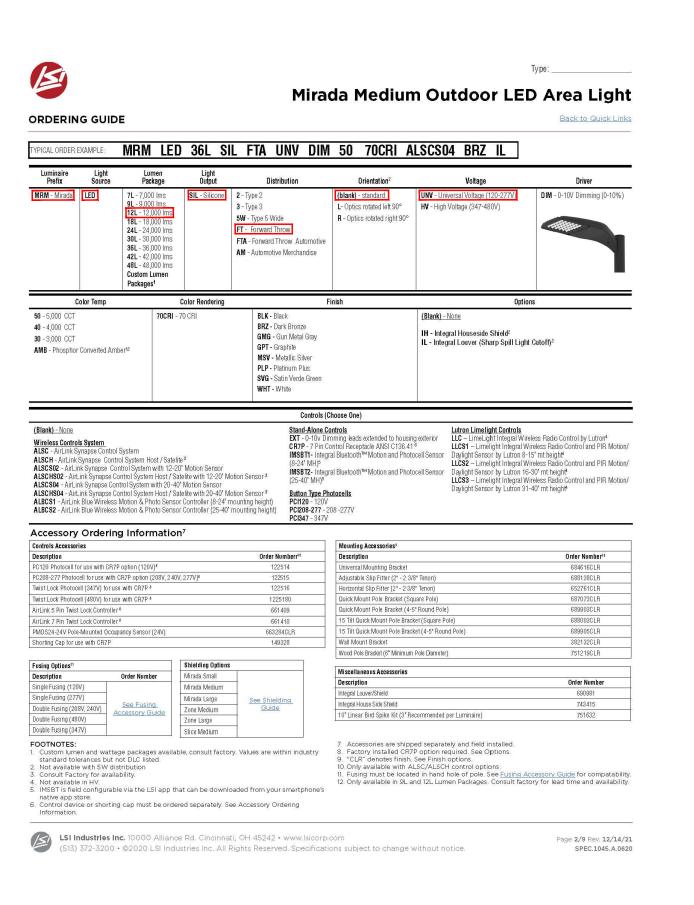

AREA LIGHT FIXTURE 'CI', 'C2' & 'E' SPECIFICATIONS


NOT TO SCALE

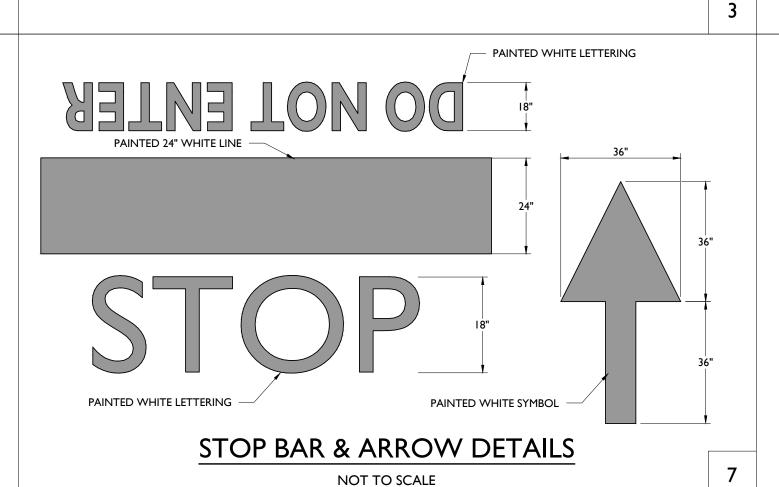

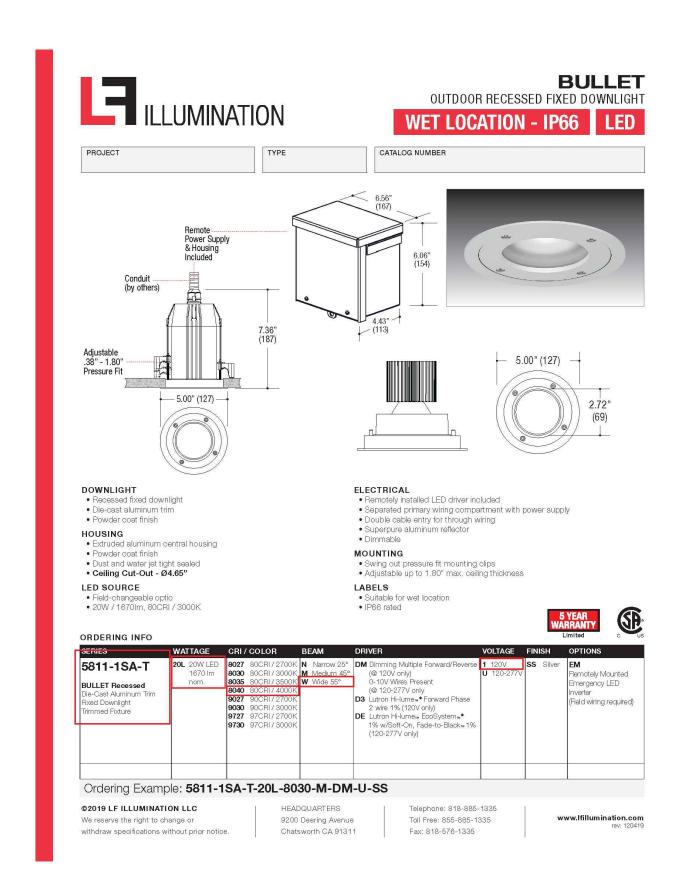



NOT TO SCALE

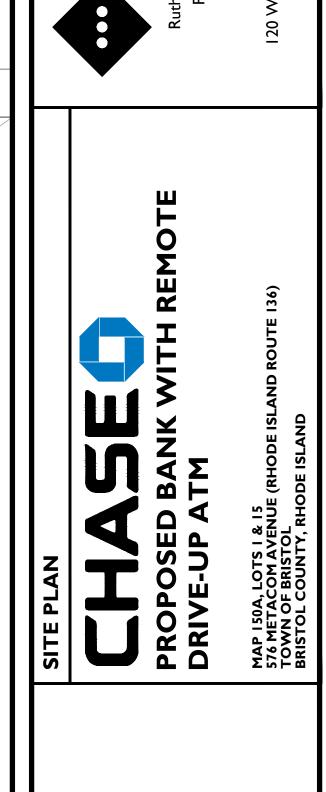

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JOSHUA H. KLINE, P.E. RHODE ISLAND LICENSE No. 13607 LICENSED PROFESSIONAL ENGINEER



SCALE: NO SCALE PROJECT ID: BOS-220076

CONSTRUCTION **DETAILS**

DRAWING:

