

HISTORIC REHABILITATION OF:

467 HOPE STREET

BRISTOL, RHODE ISLAND, 02809

HISTORIC DISTRICT COMMISION SET - OPTION A

NOT FOR CONSTRUCTION

18 NOVEMBER 2024

DRAWING LIST	
Sheet Number	Sheet Name
01 - GENERAL	
G0.00	COVER
G0.01	PROJECT INFORMATION
03 - PROPOSED	
A3.01	EAST EXTERIOR ELEVATIONS
A3.02	SOUTH EXTERIOR ELEVATIONS
A3.03	WEST EXTERIOR ELEVATIONS
A3.04	NORTH EXTERIOR ELEVATIONS



MECHANICAL,
ELECTRICAL,
AND PLUMBING

TO BE
PERMITTED
DESIGN BUILD

PROJECT NUMBER: 230912

HISTORIC REHABILITATION OF:
467 HOPE STREET
467 Hope Street
Bristol, Rhode Island 02809

HISTORIC DISTRICT COMMISION
SET - OPTION A

ISSUED FOR : HDC REVIEW

NOT FOR CONSTRUCTION

18 NOVEMBER 2024

HISTORIC DISTRICT
COMMISION SET - OPTION A

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REVISIONS	

COVER

SHEET SIZE: ARCH D 24" X 36"

G0.00


MATERIAL DRAFTING PATTERNS

	ALUMINUM
	BRICK
	CONCRETE
	CONCRETE BLOCK
	CERAMIC TILE, HORIZONTAL SURFACE
	CERAMIC TILE, VERTICAL SURFACE
	EARTH
	ENGINEERED WOOD (MDF, HDF, ETC.)
	EXISTING, UNEXCAVATED
	GLASS, SPECIALTY
	GLASS, HORIZONTAL SURFACE
	GLASS, VERTICAL SURFACE
	GYPSUM/PLASTER
	METAL (STEEL, ETC.)
	PLASTIC
	PLYWOOD
	POROUS FILL (GRAVEL, CRUSHED STONE, ETC.)
	RIGID INSULATION
	RUBBLE
	SHINGLE
	WOOD (EDGE GRAIN)
	WOOD (END GRAIN)
	WOOD (FACE GRAIN)
	GENERIC 1
	GENERIC 2
	GENERIC 3
	GENERIC 4
	GENERIC 5
	GENERIC 6

SYMBOLS

EXTERIOR ELEVATION		SIM
INTERIOR ELEVATION		
SECTION		SIM
ELEVATION		NAME EL. ELEVATION
SPOT ELEVATION		
COLUMN GRID MARK		
ROOM NAME AND MARK		ROOM NAME
DOOR MARK		
WALL TYPE		
WINDOW TYPE		
FURNITURE / SPECIALTY EQUIPMENT MARK		
BREAK LINE		
LEADER		XX
DIMENSION		
REVISION CLOUD		
ALIGN		ALIGN
FLOOR FINISH		FLOOR FINISH
MOCKUP LOCATION		

TYPICAL DOOR NOTES

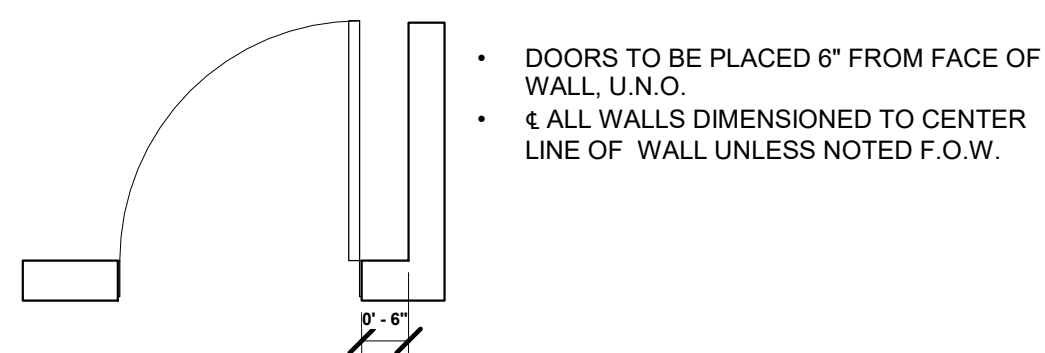

COMMON ABBREVIATIONS

ABOVE	AIR CONDITION	L.E.D.	LIGHT EMITTING DIODE
A/C	ACCESS(BLE)	L.H.	LEFT HAND
ACC.	ACOUSTICAL CEILING TILE	LIB.	LIBRARY
ADDL.	ADDITIONAL	LKR	LOCKER
ADJ.	ADJUSTABLE (OR) ADJACENT	LVL	LAMINATED VENEER LUMBER
AEI	ARCHITECT/ENGINEER	LOC.	LOCATION
A.F.F.	ABOVE FINISH FLOOR	L.O.W.	LIMIT OF WORK
AHJ	AUTHORITY HAVING JURISDICTION	LVR	LOUVER
ALUM.	ALUMINUM	MAS.	MASONRY
ALT.	ALTERNATE	MAT.	MATERIAL
ANOD.	ANODIZED	MAX.	MAXIMUM
ARCH.	ARCHITECT(URAL)	MECH.	MECHANICAL
A.P.	ACCESS PANEL	MED.	MEDIUM
APT.	APARTMENT	MEMB	MEMBRANE
APPROX.	APPROXIMATE	MDF	MEDIUM DENSITY FIBERBOARD
ASI	ARCHITECT'S SUPPLEMENTAL INSTRUCTION	MIN.	MINIMUM
AUTO.	AUTOMATIC	MISC.	MISCELLANEOUS
AUX.	AUXILIARY	M.O.	MASONRY OPENING
		M.R.	MOISTURE RESISTANT
BAS	BUILDING AUTOMATION SYSTEM	MTD	MOUNTED
BD	BOARD	MTL	METAL
BDRM	BEDROOM		
BITUM.	BITUMINOUS	N.A.	NOT APPLICABLE
BLDG	BUILDING	NAT.	NATURAL
BLKG	BLOCKING	N.C.	NOISE CRITERIA
BLW	BELOW	N.I.C.	NOT IN CONTRACT
BSMT	BASEMENT	NKL	NICKEL
BOT.	BOTTOM	NOM.	NOMINAL
BRK	BRICK	N.R.C.	NOISE REDUCTION COEFFICIENT
BRZ	BRONZE	N.T.S.	NOT TO SCALE
BTWN	BETWEEN		
		O.C.	ON CENTER
CAB.	CABINET	OCFI	OWNER FURNISHED CONTRACTOR INSTALLED
C.F.M.F.	COLD-FORMED METAL FRAMING	OFOI	OWNER FURNISHED OWNER INSTALLED
C.L.	CENTER LINE	O.H.	OPPOSITE HAND
CLG	CEILING	OPNG	OPENING
CLR	CLEAR(ANCE)	OPP	OPPOSITE
C.J.	CONTROL JOINT	ORIG.	ORIGINAL
CMU	CONCRETE MASONRY UNIT	OVHD	OVERHEAD
COL.	COLUMN	OZ.	OUNCE
COMP.	COMPRESS(ED), (ION), (IBLE)		
CONC.	CONCRETE	PERP.	PERPENDICULAR
CONST.	CONSTRUCTION	PLAM	PLASTIC LAMINATE
CONT.	CONTINUE(E), (OUS)	PNT	PAINT
COORD.	COORDINATE	PTD	PAINTED
CPT	CARPET	PR	PAIR
CPR	COPPER	P.T.	PRESSURE TREATED
C.T.	CERAMIC TILE	PTN	PARTITION
C.T.E.	CONNECT TO EXISTING	PLYWD	PLYWOOD
C.U.H.	CABINET UNIT HEATER		
		Q.T.	QUARRY TILE
DBL	DOUBLE		
DEMO	DEMO(LISH), (LITION)	R.B.	RESILIENT BASE
DET.	DETAIL	R.D.	ROOF DRAIN
D.F.	DRINKING FOUNTAIN	REF.	REFRIGERATOR
DH	DOUBLE HUNG	REFR	REFRIGERATOR
DIA.	DIAMETER	REQ.	REQUIRE(D)
DIAG.	DIAGONAL	RES.	RESILIENT
DIM.	DIMENSION	REV.	REVISION
DN	DOWN	R.H.	RIGHT HAND
DR	DOOR	RM	ROOM
DS	DOWNSPOUT	R.O.	ROUGH OPENING
DTL	DETAIL		
DWG	DRAWING	SCHED.	SCHEDULE
DX	DUPLEX	SECT.	SECTION
EA.	EACH	SF	SQUARE FEET
EL.	ELEVATION	SHT	SHEET
ELEC.	ELECTRIC(AL)	SHTH	SHEATHING
ELEV.	ELEVATOR	SIM.	SIMILAR
EMER.	EMERGENCY	SPEC.	SPECIFICATION (IFICATION)
EMS	EMERGENCY MANAGEMENT SYSTEM	SRL	SUBMITTAL REVIEW LETTER
EJ	EXPANSION JOINT	SQ.	SQUARE
EQ	EQUAL	S.S.	STAINLESS STEEL
EQUIP.	EQUIPMENT	S.S.M.	SOLID SURFACE MATERIAL
ETR	EXISTING TO REMAIN	STD	SOUND TRANSMISSION COEFFICIENT
EXG	EXISTING	STD	STANDARD
EXT.	EXTERIOR	STOR.	STORAGE
		STL	STEEL
F.A.	FIRE ALARM	STRUCT.	STRUCTURAL
F.A.R.	FLOOR AREA RATIO	SUSP.	SUSPEND(ED)
F.C.U.	FAN COIL UNIT	SYS.	SYSTEM
F.D.	FLOOR DRAIN		
FDN	FOUNDATION	T&G	TONGUE AND GROOVE
F.E.	FIRE EXTINGUISHER	TBD	TO BE DETERMINED
FEC	FIRE EXTINGUISHER CABINET	TEL	TELEPHONE
FFAE	FURNITURE, FIXTURE, AND EQUIPMENT	TEMP	TEMPORARY
FG	FIBERGLASS	THK	THICK(NESS)
FIN.	FINISH	THR	THRESHOLD
FIXT.	FIXTURE	THRU	THROUGH
FL.	FLOOR	T.O.	TOP OF
FLUOR.	FLUORESCENT	TSTAT	THERMOSTAT
F.O.	FACE OF	TYP.	TYPICAL
F.P.	FIRE PROTECTION	TZ	TERRAZZO
FT	FEET		
FTG	FOOTING	U.H.	UNIT HEATER
FURN.	FURNITURE	U.N.O.	UNLESS NOTED OTHERWISE
		U.O.N.	UNLESS NOTED OTHERWISE
GA	GAGE	VERT.	VERTICAL
GALV	GALVANIZED	V.I.F.	VERIFY IN FIELD
GB	GRAB BAR	V.R.	VAPOR RETARDER
GL	GLASS		
GLAM	GLUE LAMINATED BEAM	w/	WITH
GLZ	GLAZING	W.C.	WATER CLOSET
GWB	GYPSPUM BOARD	WD	WOOD
		WIN.	WINDOW
HC	HANDICAP		
HDF	HIGH DENSITY FIBERBOARD	Z.C.C.	ZINC COATED COPPER
HM	HOLLOW METAL		
HDWR	HARDWARE	&	AND
HOR.	HORIZONTAL		
HR	HOUR		
HT	HEIGHT		
IN.	INCHES		
INCL.	INCLUDE(D), (ING)		
INFO.	INFORMATION		
INSUL.	INSULATION		
INT.	INTERIOR		
J.C.	JANITOR'S CLOSET		
J-BOX	JUNCTION BOX		
JT	JOINT		
KIT.	KITCHEN		
LAB.	LABORATORY		
LAV.	LAVATORY		
LB	POUND(S)		

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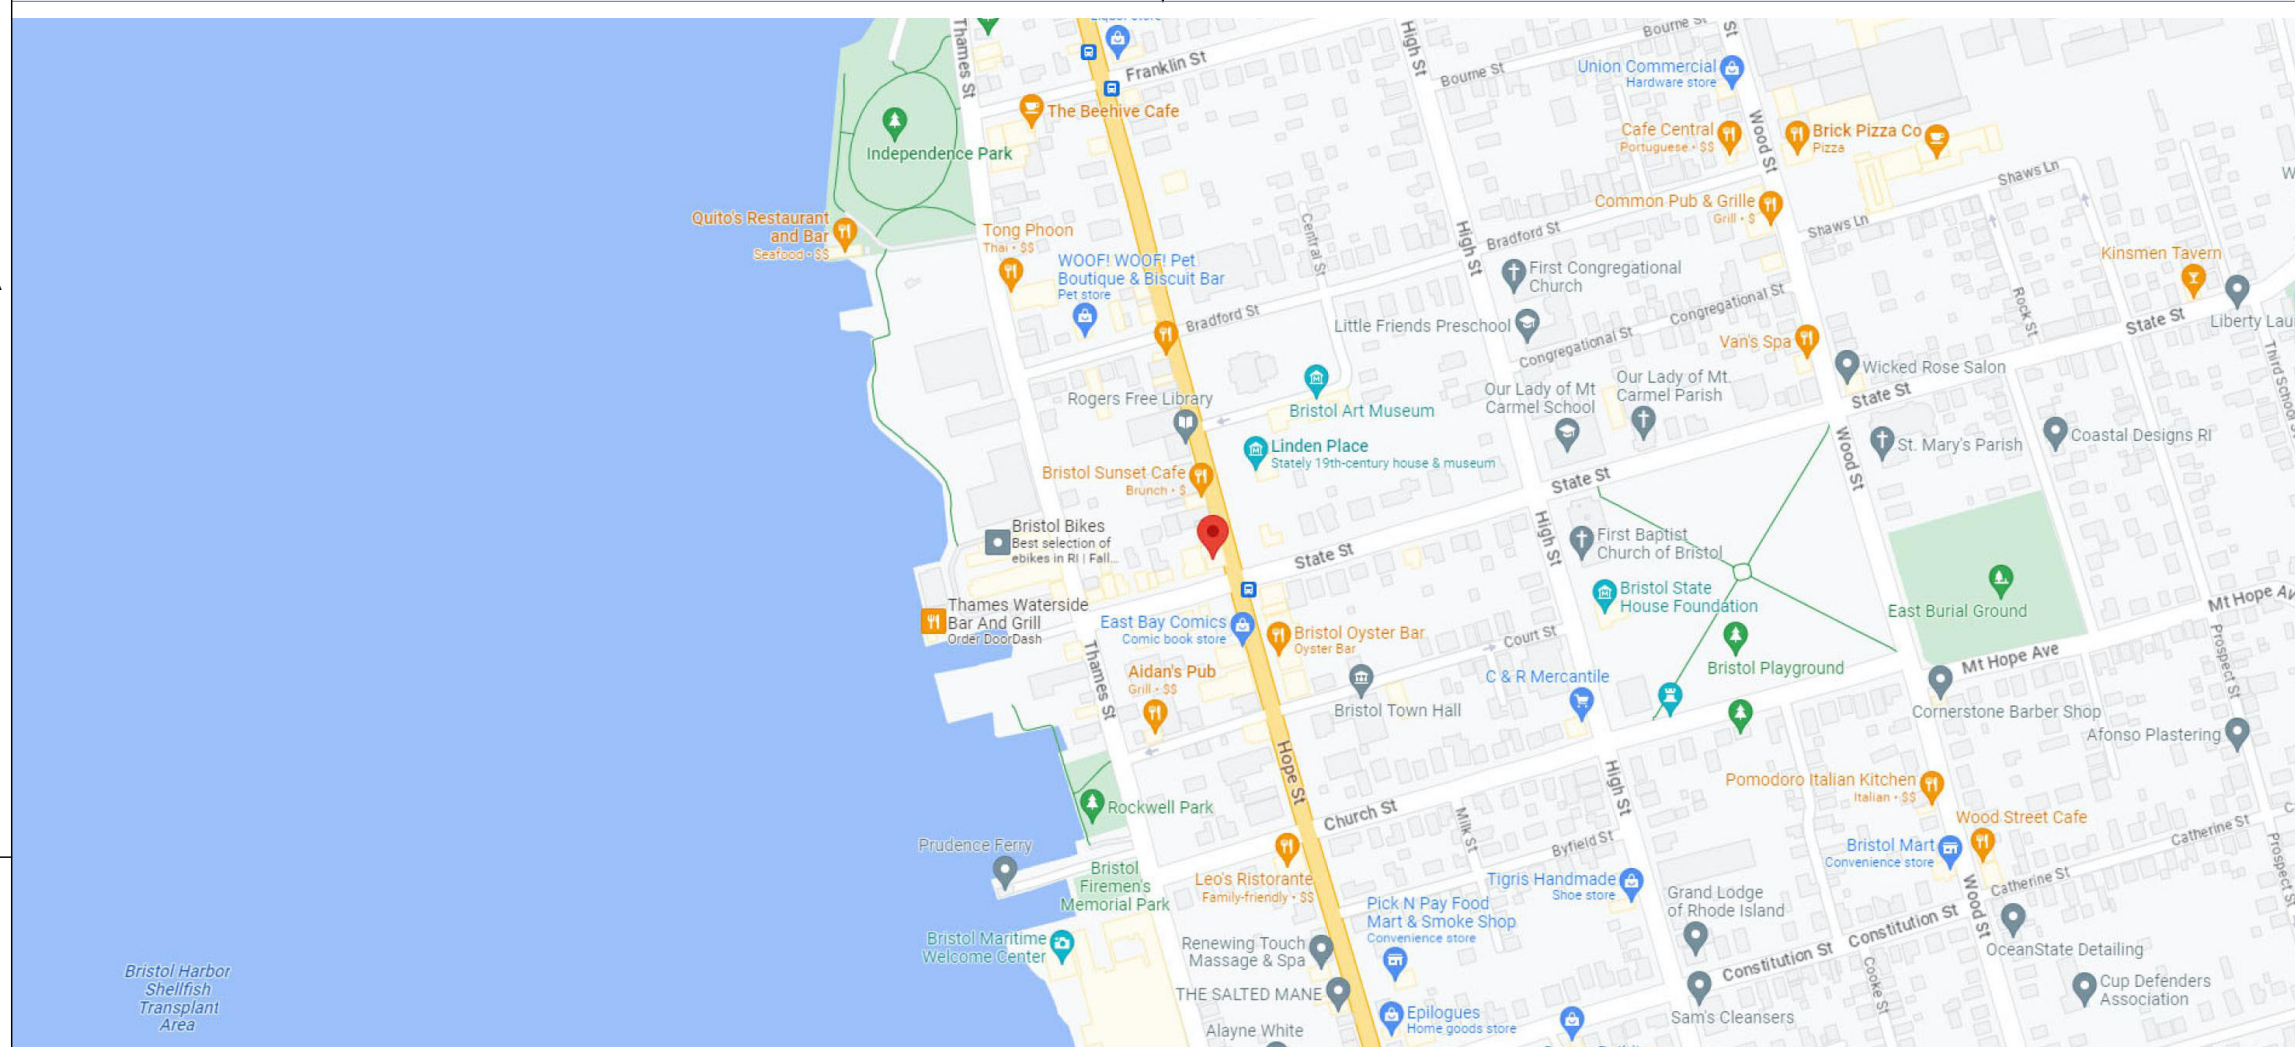
REVISIONS


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PROJECT INFORMATION


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G0.01





B5 EXISTING WEST EXTERIOR ELEVATION
A3.03 Scale: 1/4" = 1'-0"

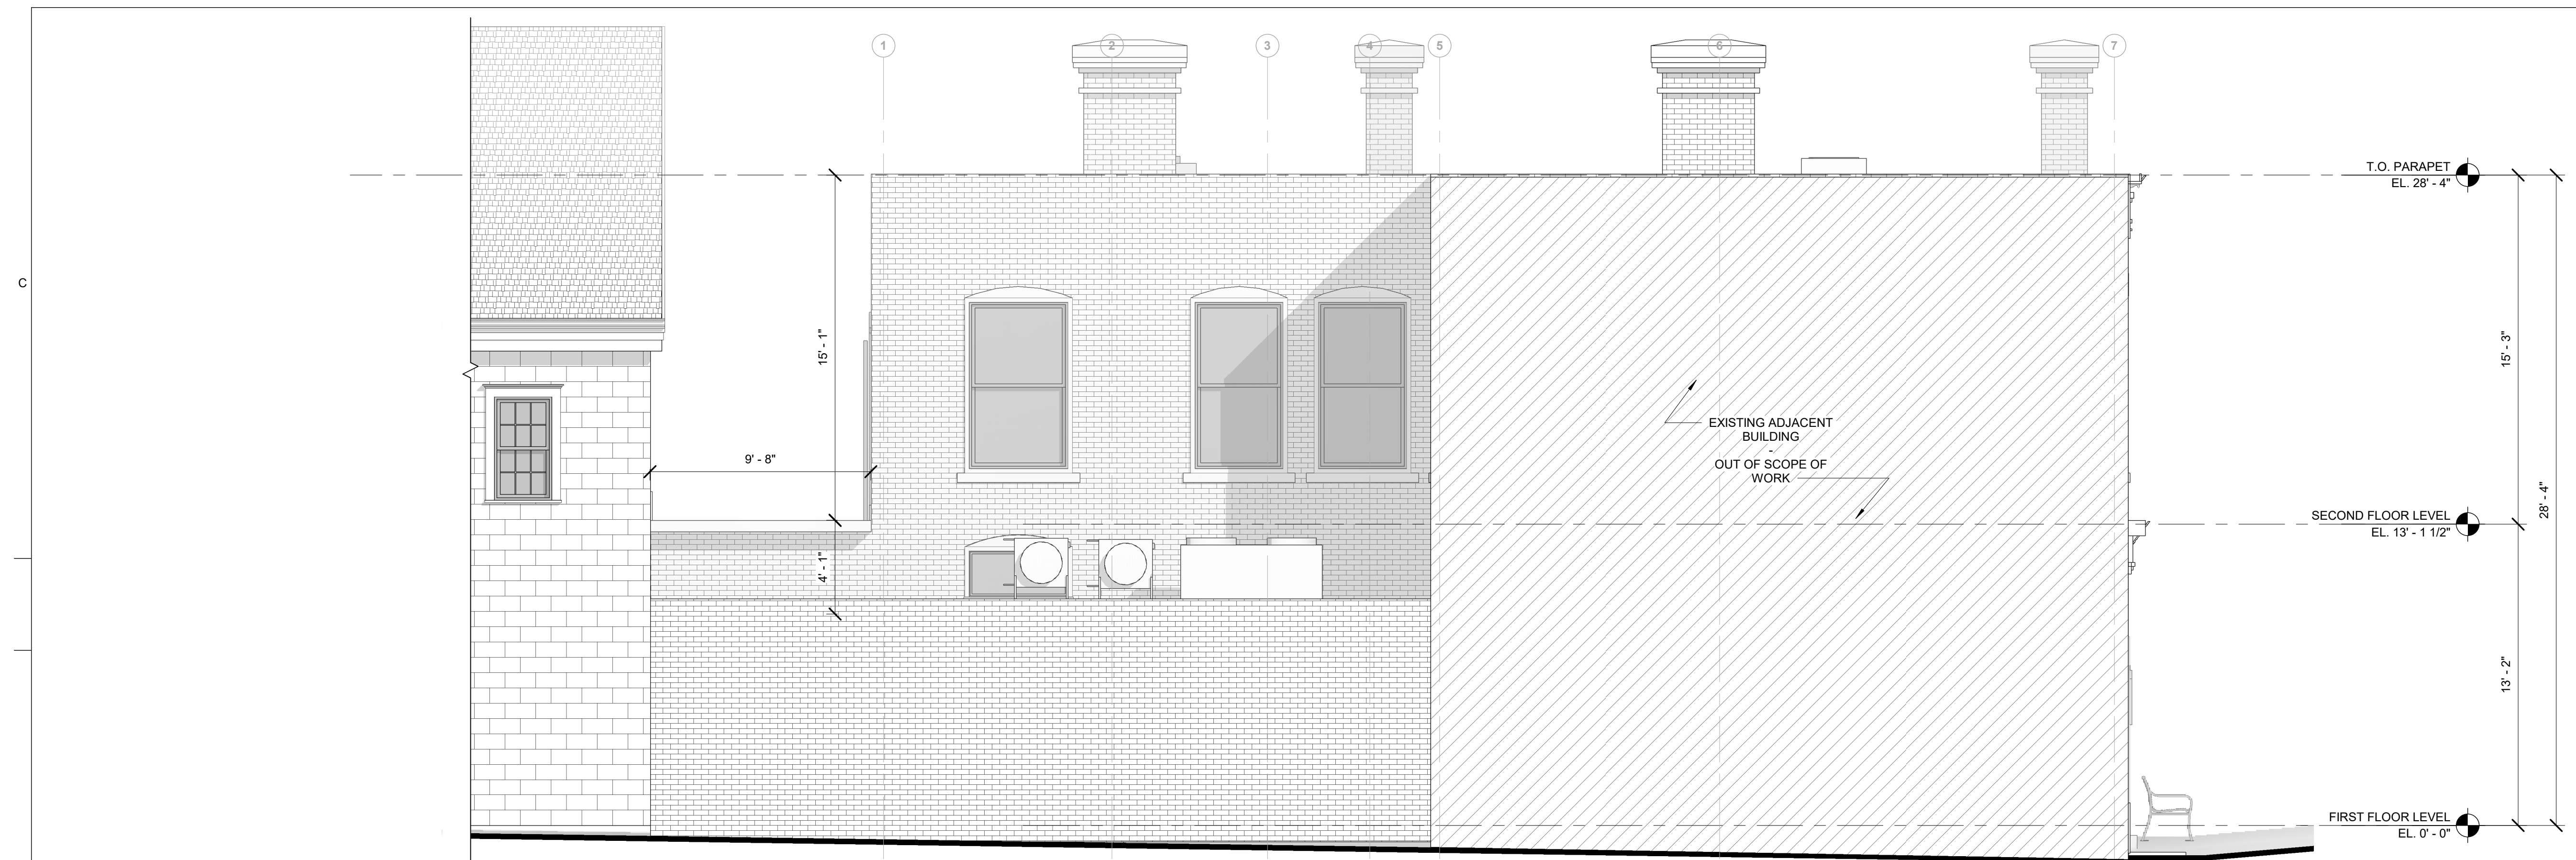

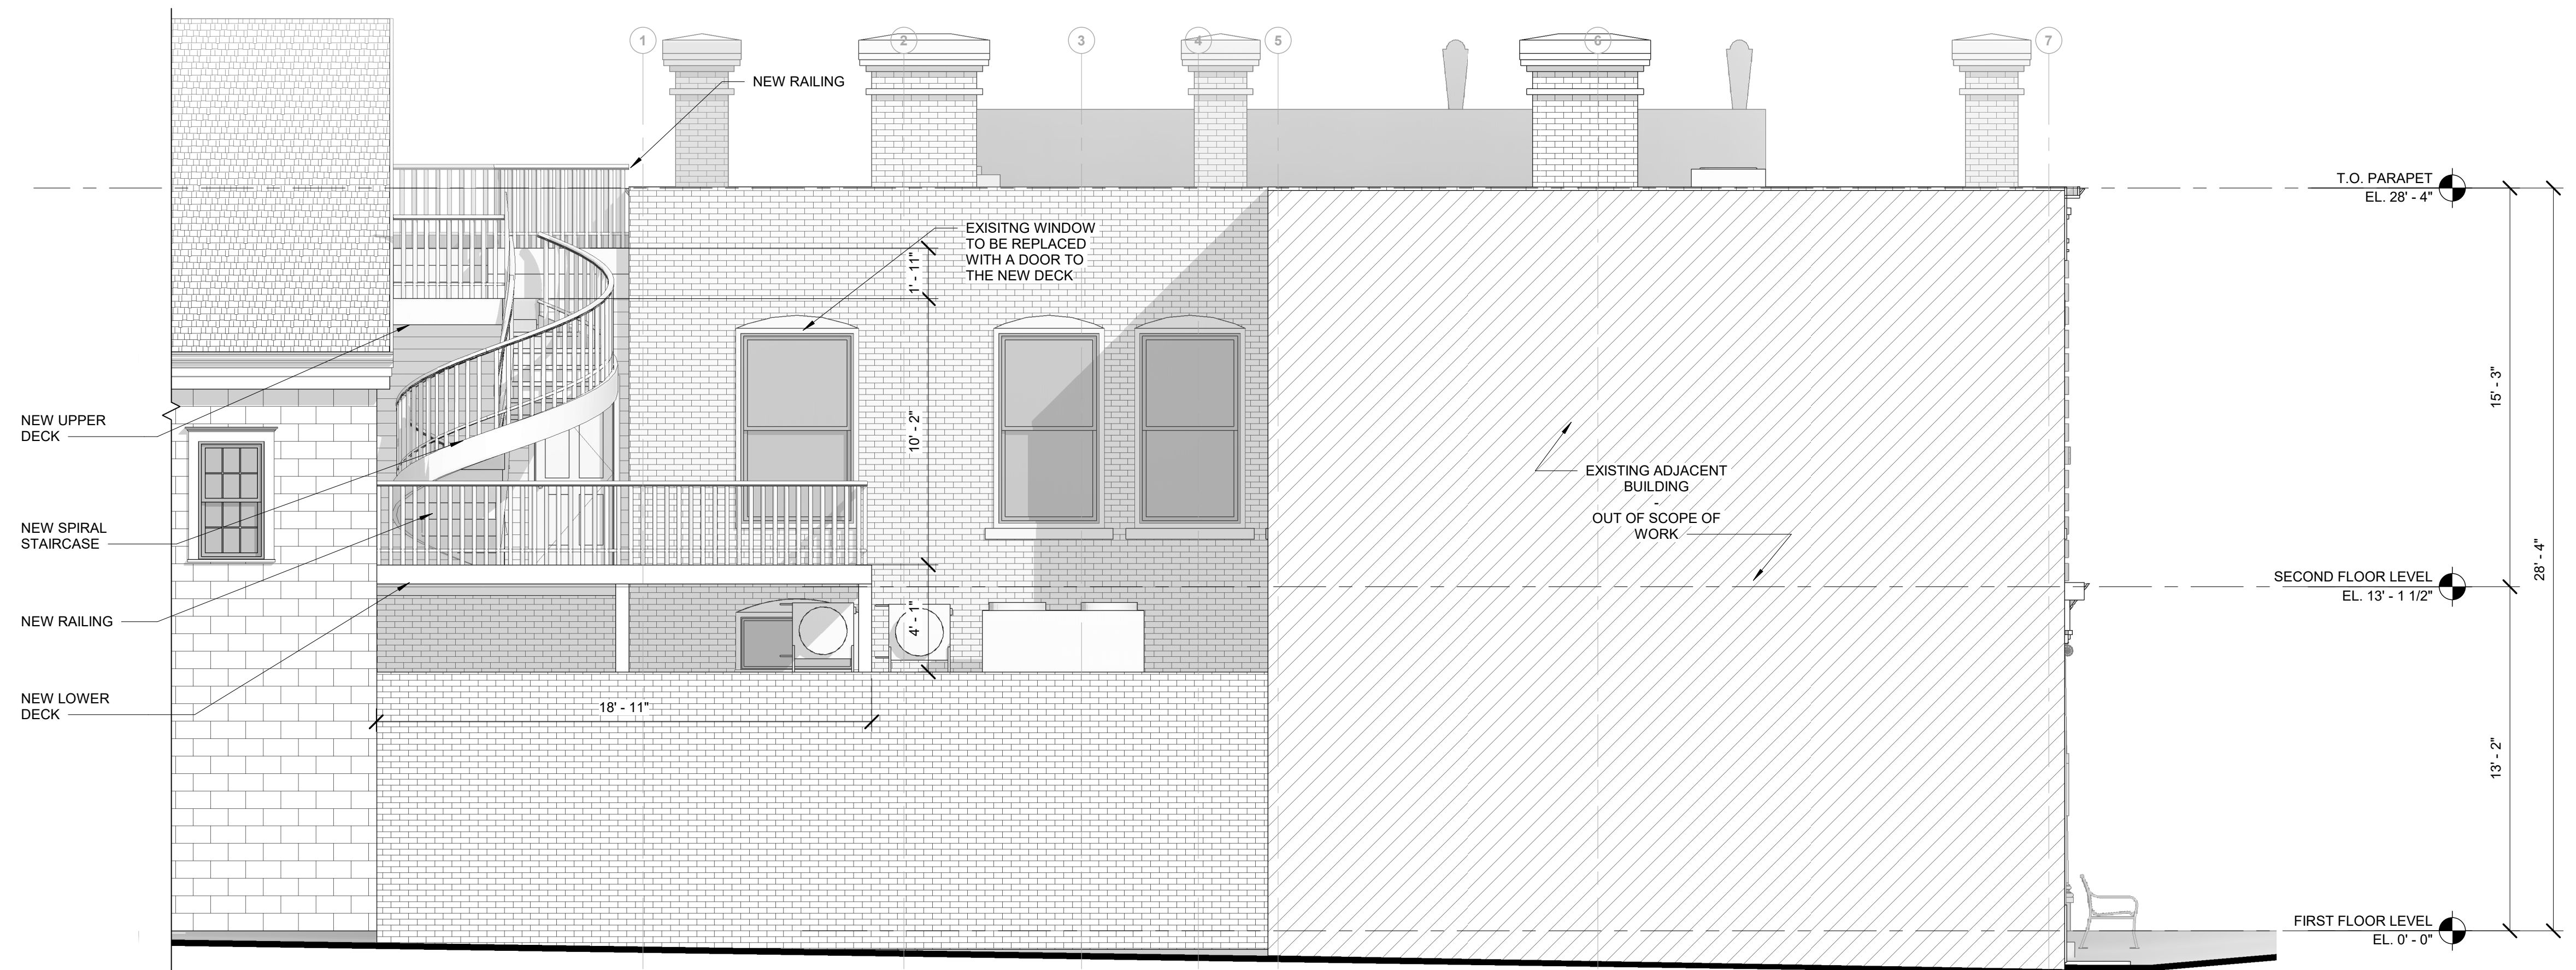A5 PROPOSED WEST EXTERIOR ELEVATION
A3.03 Scale: 1/4" = 1'-0"

PROJECT NUMBER: 230912

467 HOPE STREET

Bristol, Rhode Island, 02809

HISTORIC DISTRICT COMMISSION MET - OPTION A

ISSUED FOR : HDC REVIEW

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3 NOVEMBER 2024

**HISTORIC DISTRICT
OMMISSION SET - OPTION A**

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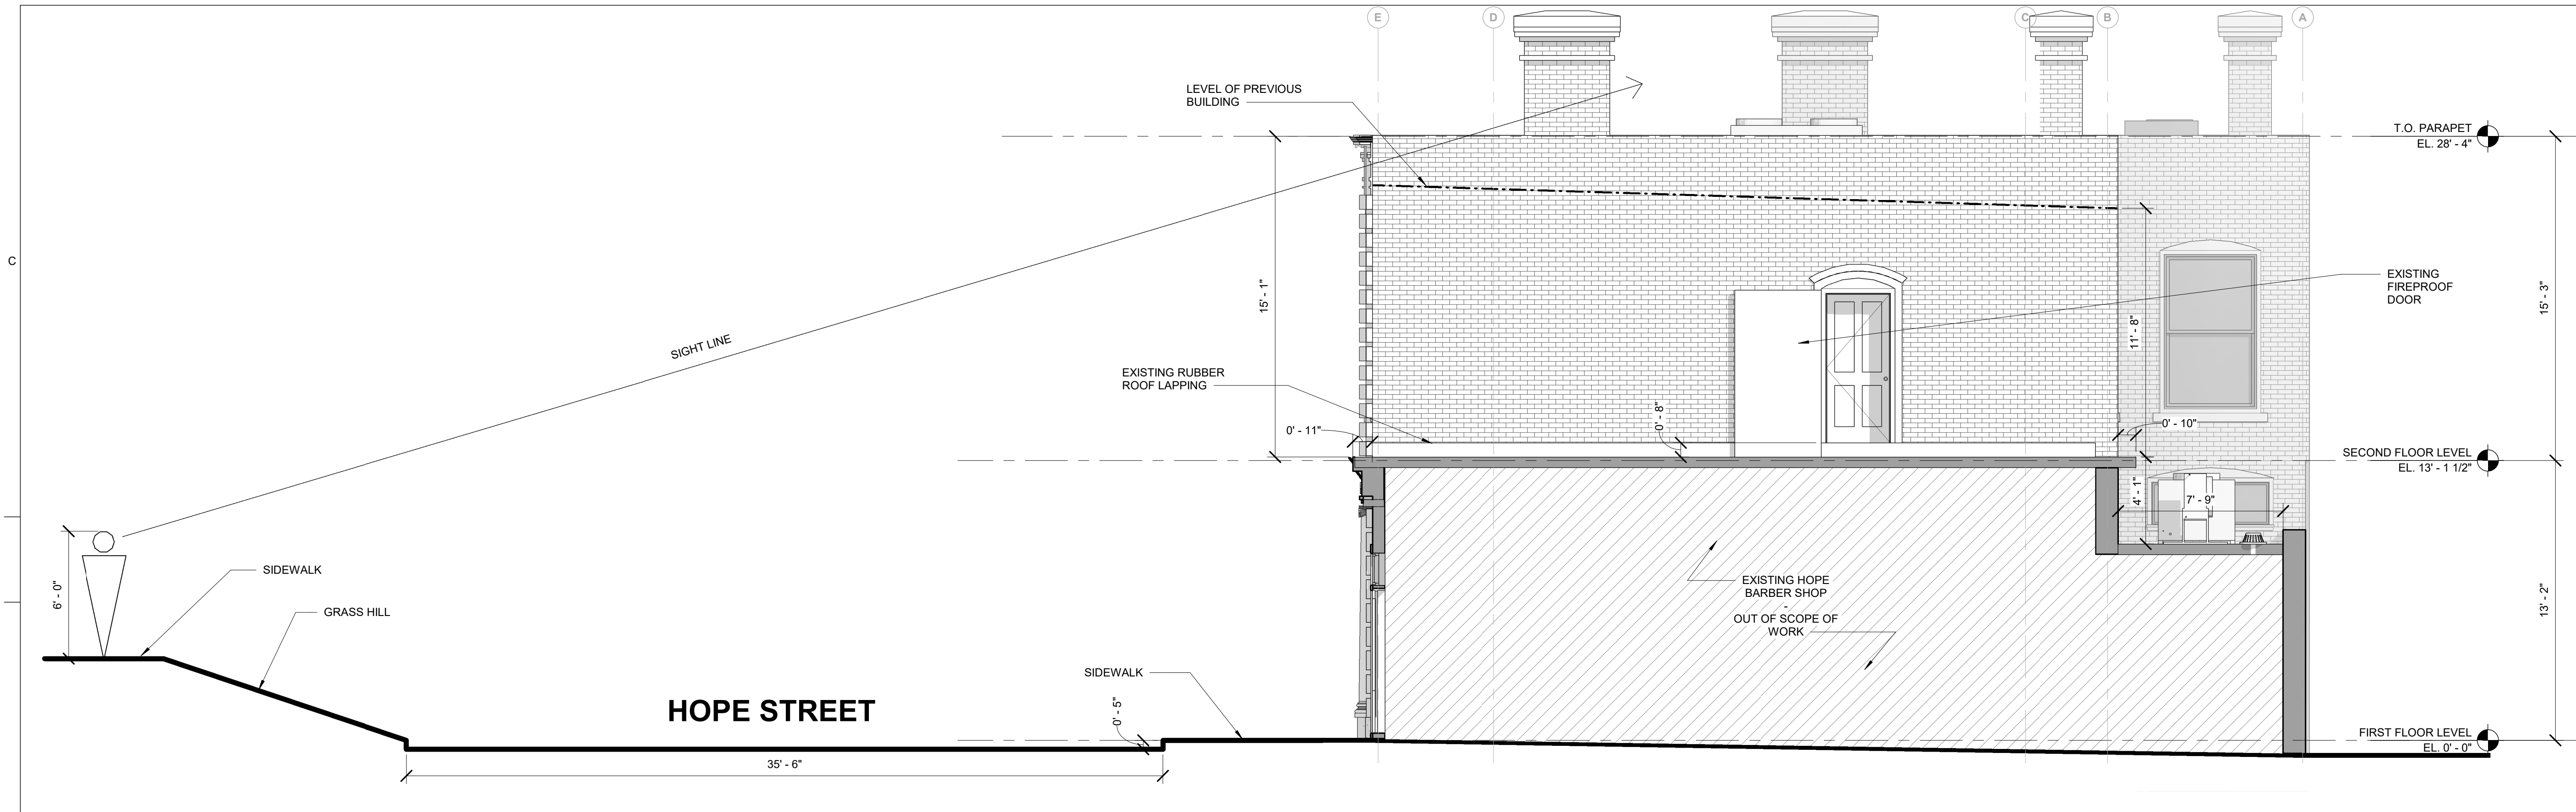
REVISIONS

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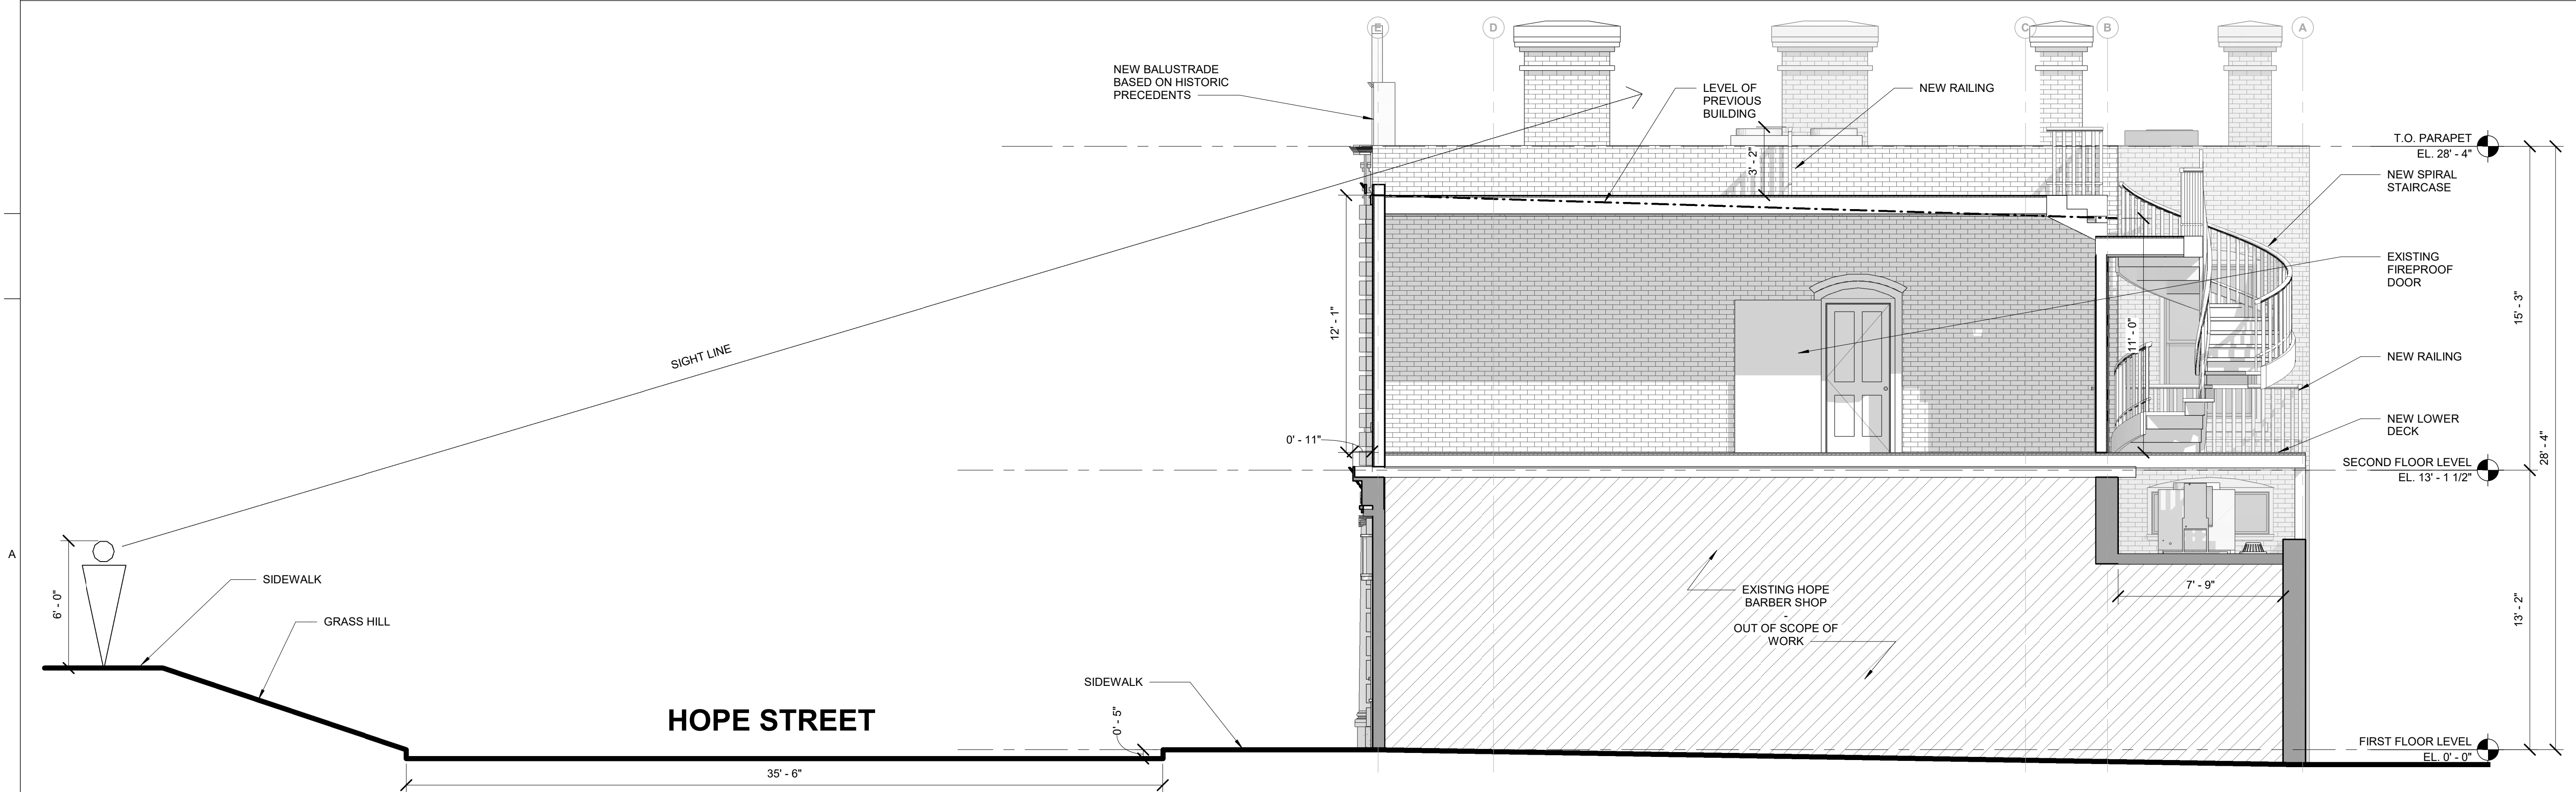
WEST EXTERIOR ELEVATIONS

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A3.03



B5
A3.04
EXISTING NORTH EXTERIOR ELEVATION
Scale: 1/4" = 1'-0"



A5
A3.04
PROPOSED NORTH EXTERIOR ELEVATION
Scale: 1/4" = 1'-0"

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REVISIONS	

NORTH EXTERIOR ELEVATIONS