PRELIMINARY PLAN SUBMISSION

FOR A

COMPREHENSIVE PERMIT APPLICATION

OF

"FAIR WIND VILLAGE" 206 BAYVIEW AVENUE A.P. 47 LOT 3

IN BRISTOL, RHODE ISLAND

OWNER/APPLICANT:
FAIR WIND PROPERTIES, LLC
PO BOX 333
BRISTOL, RI 02809



1) TITLE SHEET

2) AERIAL OVERLAY RADIUS MAP

3) EXISTING CONDITIONS PLAN (PLS 3 OF 10)

4) PROPOSED UTILITY PLAN

5) PROPOSED WATER MAIN EXTENSION PLAN & PROFILE

6) PROPOSED GRADING & DRAINAGE PLAN

7) PROPOSED LAYOUT PLAN

8) PROPOSED LANDSCAPE & SERSC PLAN

9) DETAILS-1

10) DETAILS-2


11) DETAILS-3 12) DETAILS-4

13) DETAILS-5

14) DETAILS-6

SL-1) SITE LIGHTING (BY OTHERS)

SL-2) SITE LIGHTING DETAILS (BY OTHERS)

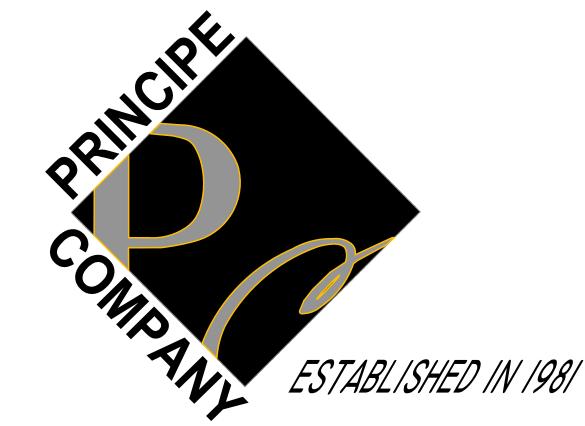

PREPARED BY:

PRINCIPE COMPANY, INC.

ENGINEERING DIVISION

STREET INDEX
BAY VIEW ROAD

BAY VIEW ROAD (PUBLIC - TOWN)

ZONING DESIGNATION:

ZONING DISTRICT: R10 MINIMUM LOT AREA MINIMUM LOT WIDTH

MINIMUM LOT FRONTAGE
FRONT YARD SETBACK
MINIMUM SIDE YARD SETBACK
MINIMUM REAR YARD SETBACK
MAXIMUM BUILDING COVERAGE

MAXIMUM BUILDING COVERAGE 25%
MAXIMUM BUILDING HEIGHT 35' (ACCESSORY 20')

27 SAKONNET RIDGE DRIVE TIVERTON, RHODE ISLAND 02878 401.816.5385

MARCH 27, 2025 REVISED APRIL 21, 2025 REVISED AUGUST 8, 2025

PROJECT DATA:

EXISTING:
PLAT: 47 LOT: 3

LOT AREA: 92,656 SF, 2.127 ACRES

THREE-UNIT DWELLING = 1,753.77 SF

GARAGE/BARN = 1,859.03 SF

SHEDS/WELL HOUSE = 320.1 SF

TOTAL EXISTING BUILDING COVERAGE = 3,932.9 SF, 4.24%

30'

15'

10,000 SQ. FT.

80' FOR 1 DWELLING UNIT,

120' FOR 2 DWELLING UNITS

PROPOSED:

ONE (1) NEW FIVEPLEX BUILDING=3,705 SF

TWO (2) NEW SIXPLEX BUILDING=4,446 SF EACH x 2=8,892 SF

EX. THREE-UNIT DWELLING = 1,753.77 SF

EX. GARAGE/BARN (PROPOSED PROPERTY MANAGEMENT BUILDING)

= 1,859.03 SF

TOTAL BUILDING COVERAGE (EXISTING + PROPOSED)

= 3,612.8 + 8,892 + 3,705 = 16,209.85 SF

16,209.8 / 92,656 = 17.49%


NEW 20' WIDE PRIVATE DRIVEWAY = 460.5 LINEAR FEET

DRIVEWAY & PARKING AREA = 20,282 SQUARE FEET



DRAWING ISSUE:

☐ CONCEPT
☐ CUSTOMER APPROVAL
☐ PERMITTING
☐ CONSTRUCTION
☐ AS—BUILT
☐ OTHER:

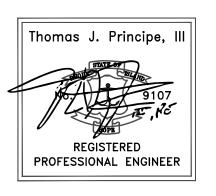



LOCUS MAP SCALE: 1"=100"

REQUESTED RELIEF

WAIVERS REQUESTED

A waiver is requested from Land Development Projects Section 28—282 (d) Standards for Multifamily Buildings:
•Sub—Section (2)

Distance between multifamily buildings on same lot: Minimum 25 feet between multifamily buildings in the same row. 10 feet provided.

•Sub—Section (8)

Not more than four contiguous townhouses shall be built in a row with the same or approximately the same front line. Special architectural design offsets utilized.

• Appendix F.2(F)(1)

Sidewalks shall be required to be installed on one side of new streets in subdivisions and in multifamily developments. No sidewalks are proposed. Variances are requested from the following Zoning Regulations:

• A variance is requested from Zoning Ordinance Article IV Dimensional Regulations Sec. 28—111 Table B requiring 80' of lot frontage. 72.50' of existing frontage provided. 64 feet is permitted after application of the 20% reduction provided for under the Low— and Moderate—Income

•A Variance is requested from Zoning Ordinance Section 28—363 (2)(a1) Municipal subsidies, Density Bonus. For projects providing at least 25 percent low— and moderate—income housing the density bonus shall be five units per acre. The yield map created by Principe Engineering showed that the project site can support 5 dwelling lots without the density bonus. The lot size is 2.1270 acres. Therefore the given lot size multiplied by the density bonus is equal to 10.635 additional units. The total allowed units per the density bonus is 15.635 rounded up to 16 units. 20 units are provided with 17 units

Housing Incentive Section 28-370 (d)(2).

to be newly constructed.

•A variance is requested from Zoning Ordinance Section 28—363

(2)(a1)Municipal subsidies, Density Bonus. For projects providing at least 25 percent low— and moderate—income housing the density bonus shall be five units per acre. Per the calculations 15 units are permitted in total. 20 units are provided with 17 units to be newly constructed.

•A variance is requested from Zoning Ordinance Permitted Uses, Section 28—3 and Section 28—82. This R—10 zone is intended for high density residential areas comprised of single household and two—household structures within a minimum density of 10,000 square feet per dwelling unit where public sewer and/or public water are provided. Multi—household dwelling units are not allowed. The site has public sewer and public water. Multi—household dwelling units are proposed.

Article VIII. Nonconformance. The use of the Existing Garage/Barn will be used for property owner storage and for site maintenance equipment and supplies. A property management office will be added to the building above the garages and will be used for property management offices.

• Variances are requested from Zoning Ordinance Section 28—252

General Requirements for parking as follows: Parking spaces are required to be 10'x18'. The proposed spaces are 9'x18'. The required aisle width is 24' The liphosed aisle width is 20'. Distance between multifamily buildings and property line:


Minimum 50 feet from side and rear property lines.

32.1 feet min. provided. 40 feet is permitted after application of the 20% reduction provided for under the Low— and Moderate—Income Housing Incentive Section 28—370 (d)(2).

	<u>PLAN SET LEGEND</u>		
	EXISTING	PROPOSED	
PERIMETER LINE			
ABUTTER LINE			
FENCE	XXX	XXX	
CONTOUR	122	 122 	
SURVEY BOUND			
UTILITY POLE			
SAWCUT	<u> </u>		
OVERHEAD WIRE	——————————————————————————————————————		
DRAINLINE	D D	D	
WATERLINE	W	W	
WATER GATE VALVEW	WV 		
WELL			
SEWERLINE	z z		
GAS LINE	——————————————————————————————————————	G	
SEWER MANHOLE	(\$)	S	
EROSION CONTROL		——————————————————————————————————————	
CATCH BASIN			
EDGE OF PAVEMENT			
RETAINING WALL			
TREE			
STONEWALL			
SEWER FORCE MAIN		——— FM ————	
SOIL BOUNDARY LINE			
STONE PILLAR			
HYDRANT			

PLANNING BOARD SIGNATURE BY: DATE:



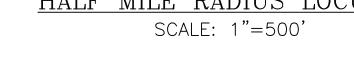



300 FOOT RADIUS MAP
SCALE: 1"=100"


OWNER/APPLICANT
FAIR WIND
PROPERTIES, LLC
PO BOX 333
BRISTOL, RI 02809

GRAPHIC SCALE

100 0 50 100 200 400

(IN FEET)
1 inch = 100 ft.

AERIAL OVERLAY RADIUS MAP

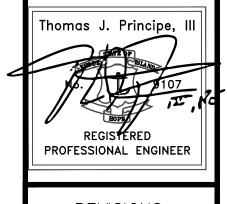

PRINCIPE COMPANY, INC.

ENGINEERING DIVISION

27 SAKONNET RIDGE DRIVE
TIVERTON, RI 02878
401.816.5385

ESTABLISHED IN 1981 www.PrincipeEngineering.com

REVISIONS

o. DATE DRWN CHKD

1. 04/21/25 KAB TJP

2. 8/8/25 KAB TJP

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FOR A
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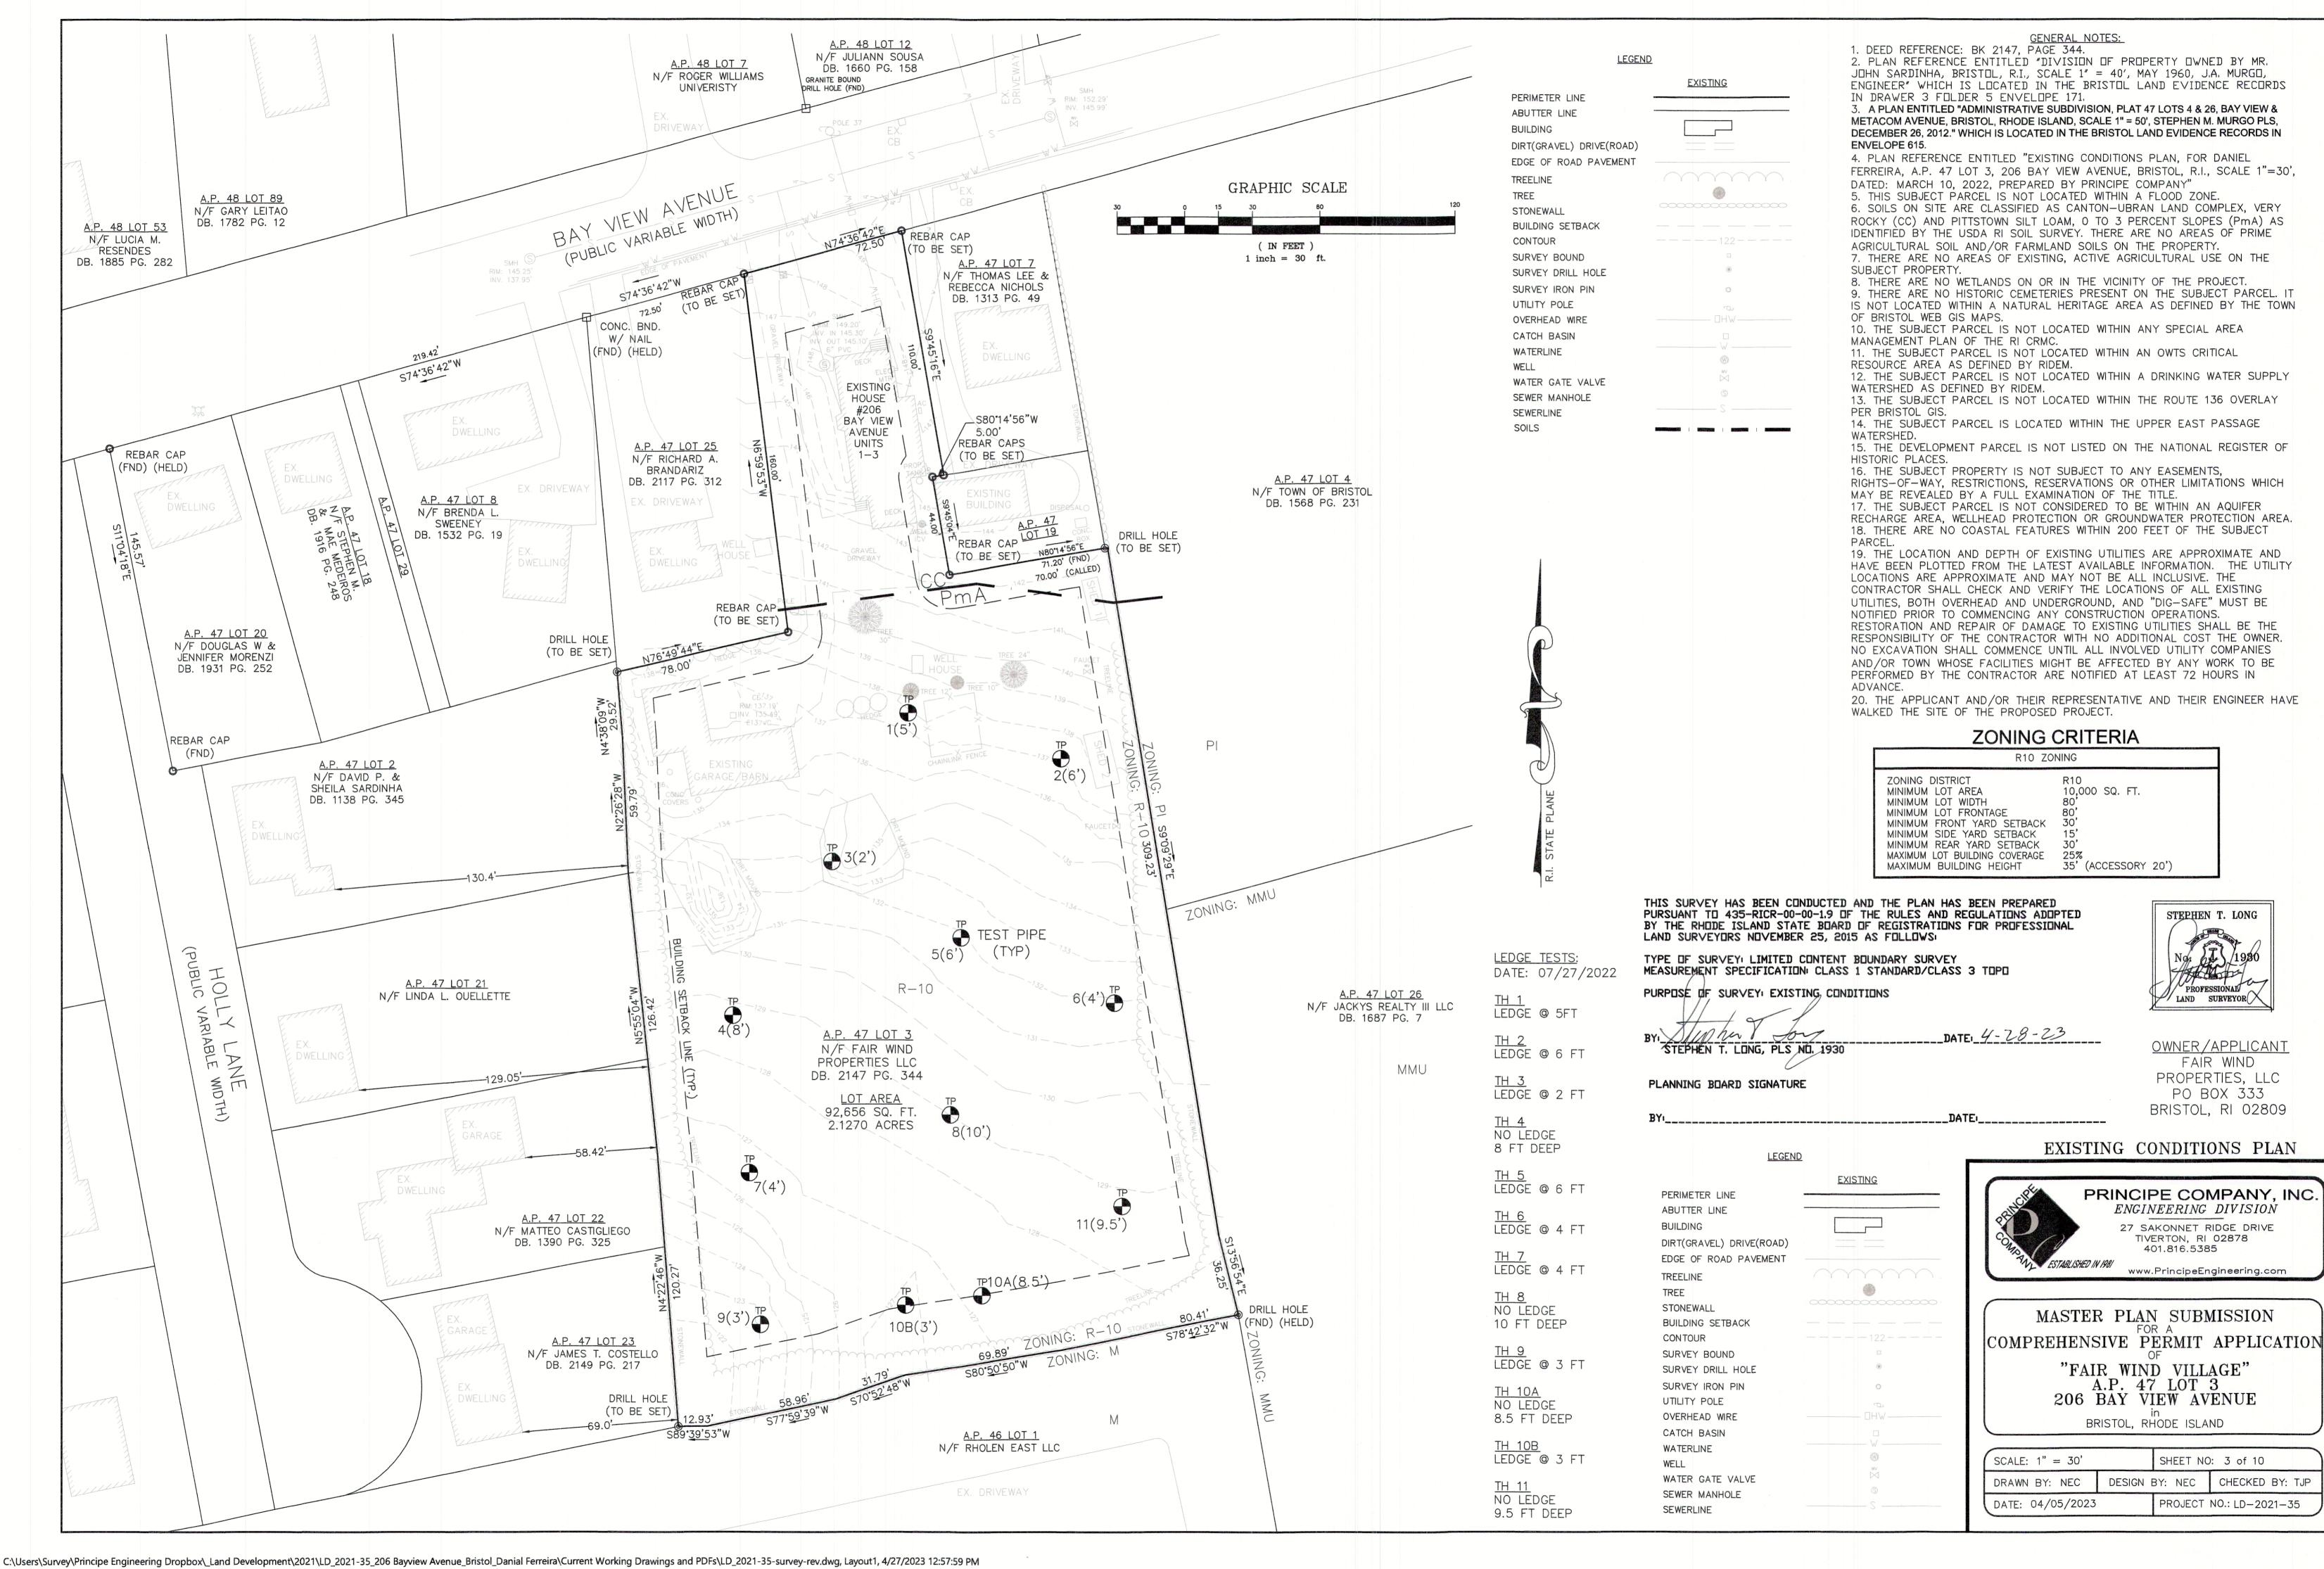
SCALE: AS NOTED		SHEET NO): 2 of 14
DRAWN BY: KAB	DESIGN E	BY: KAB	CHECKED BY: TJP
DATE: 03/27/2025		PROJECT	NO.: LD-2021-35


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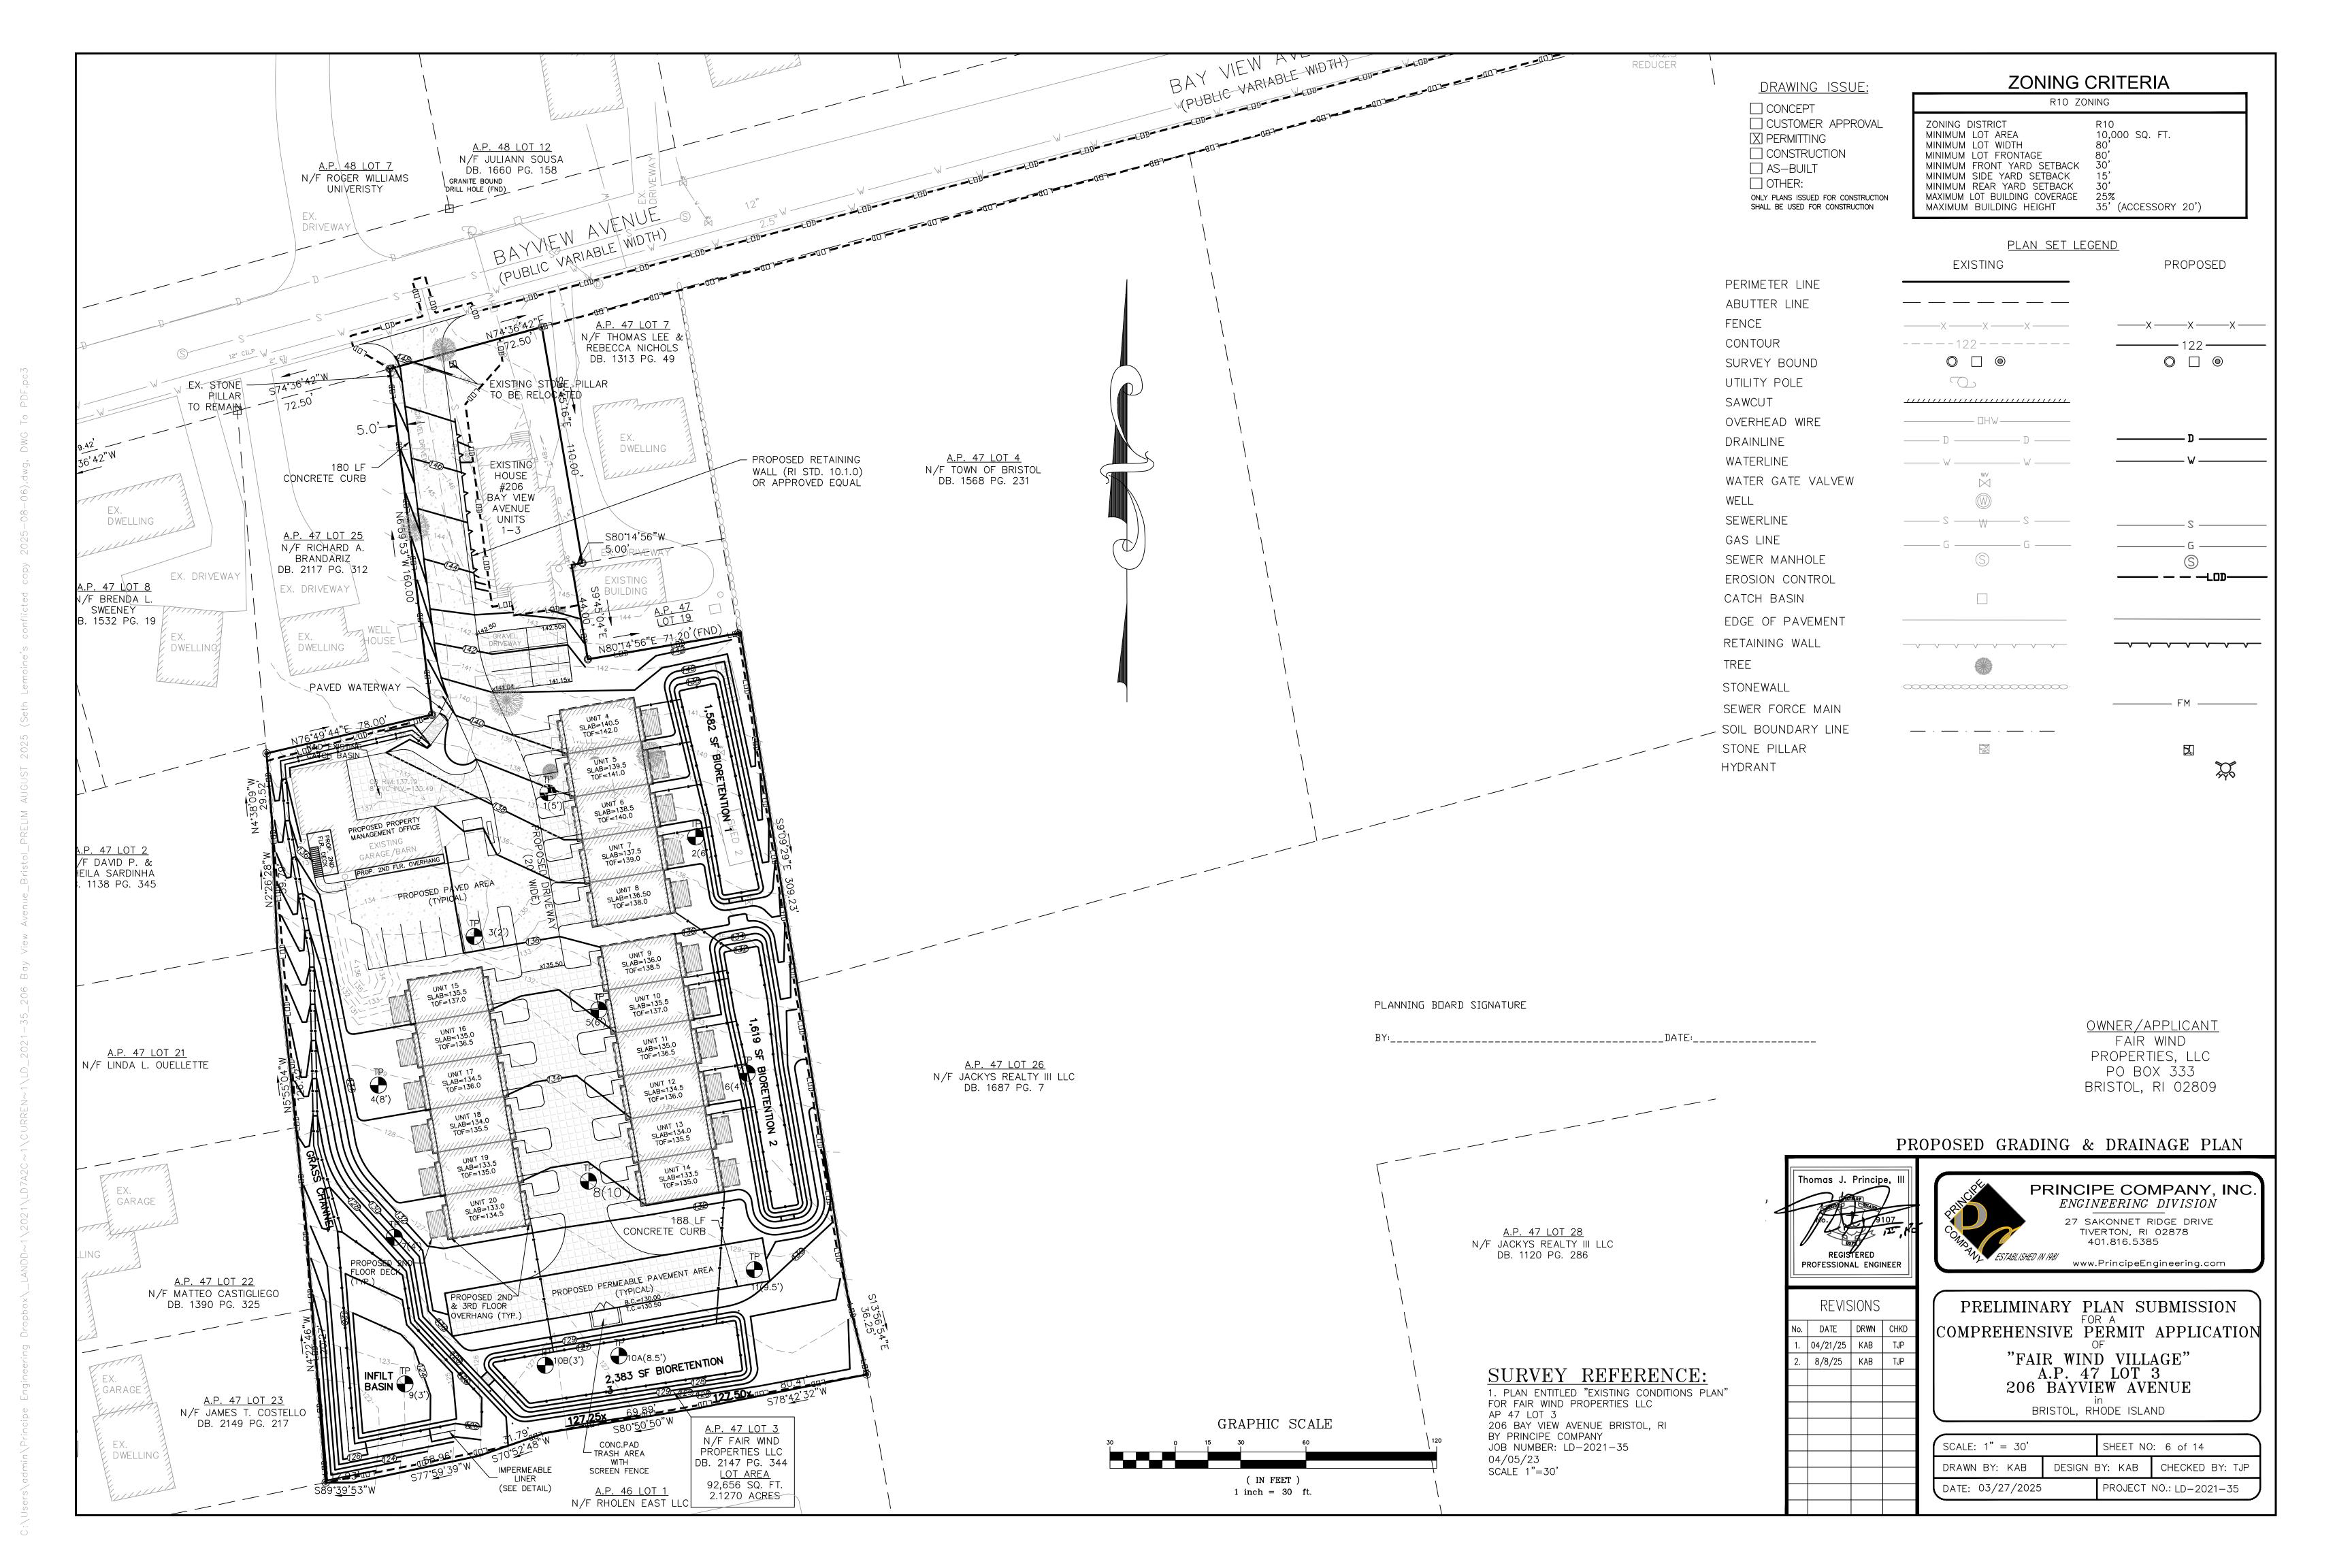
BY:______DATE:_____


GRAPHIC SCALE


(IN FEET) 1 inch = 500 ft.





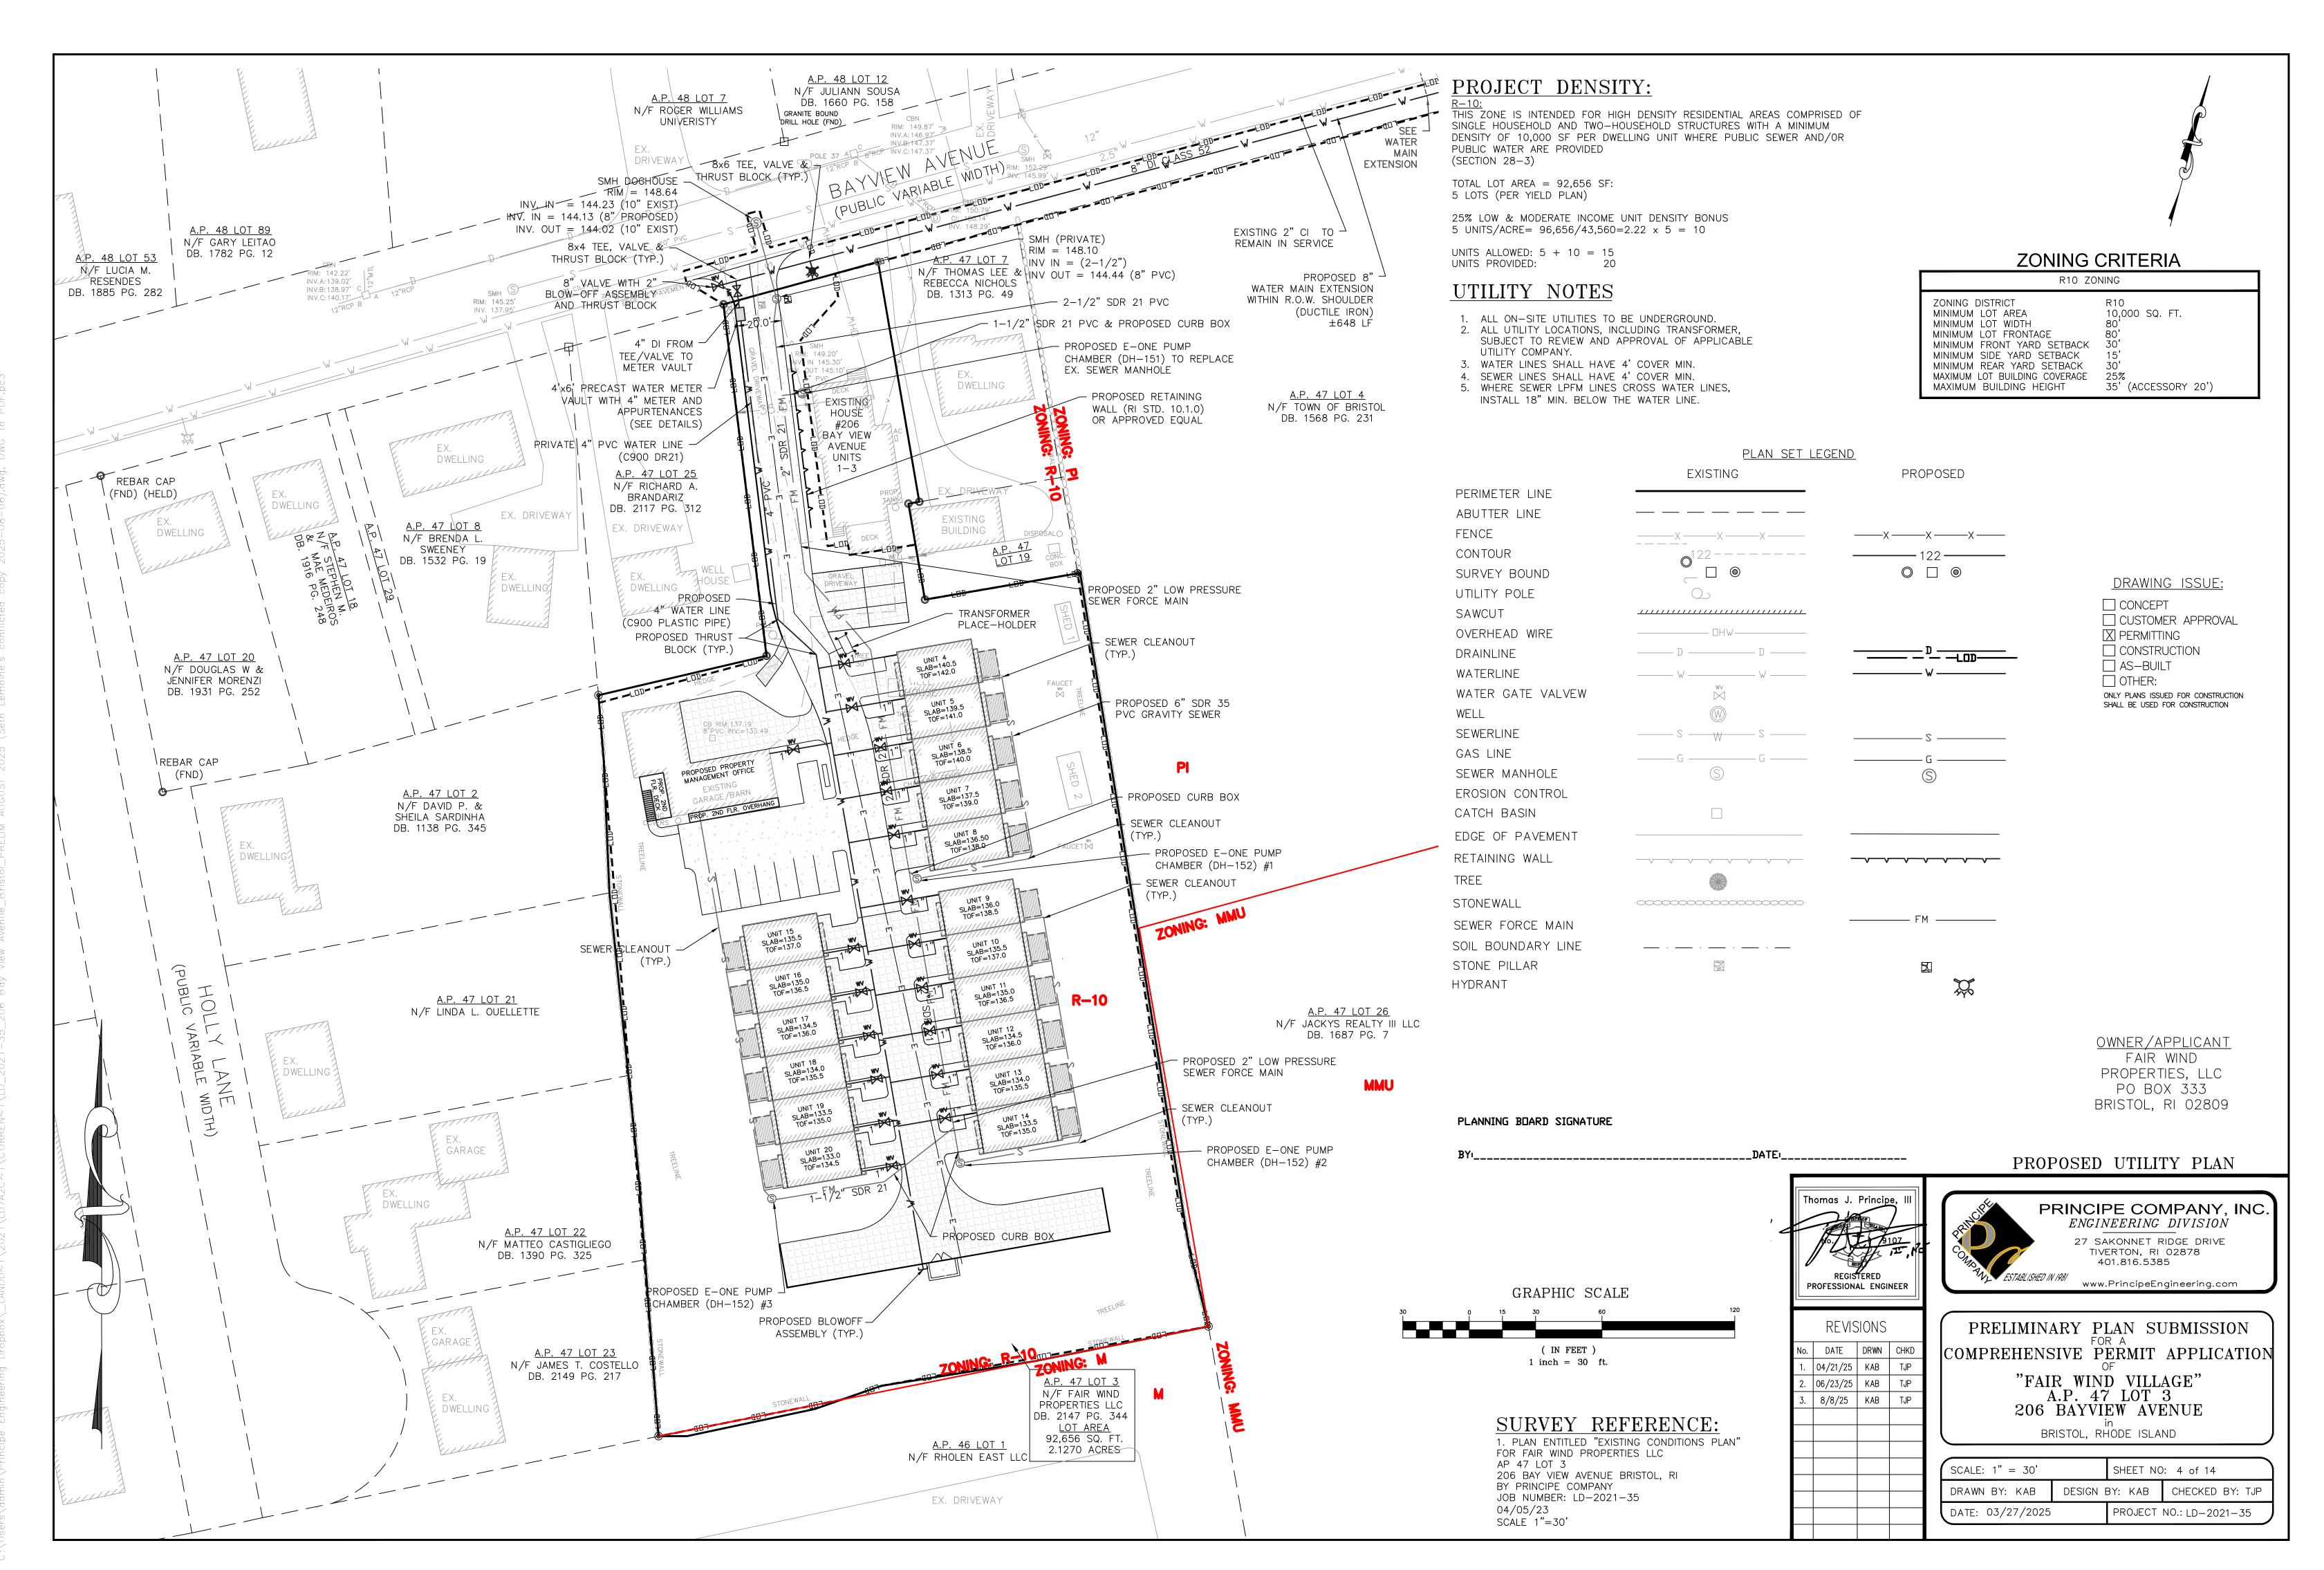

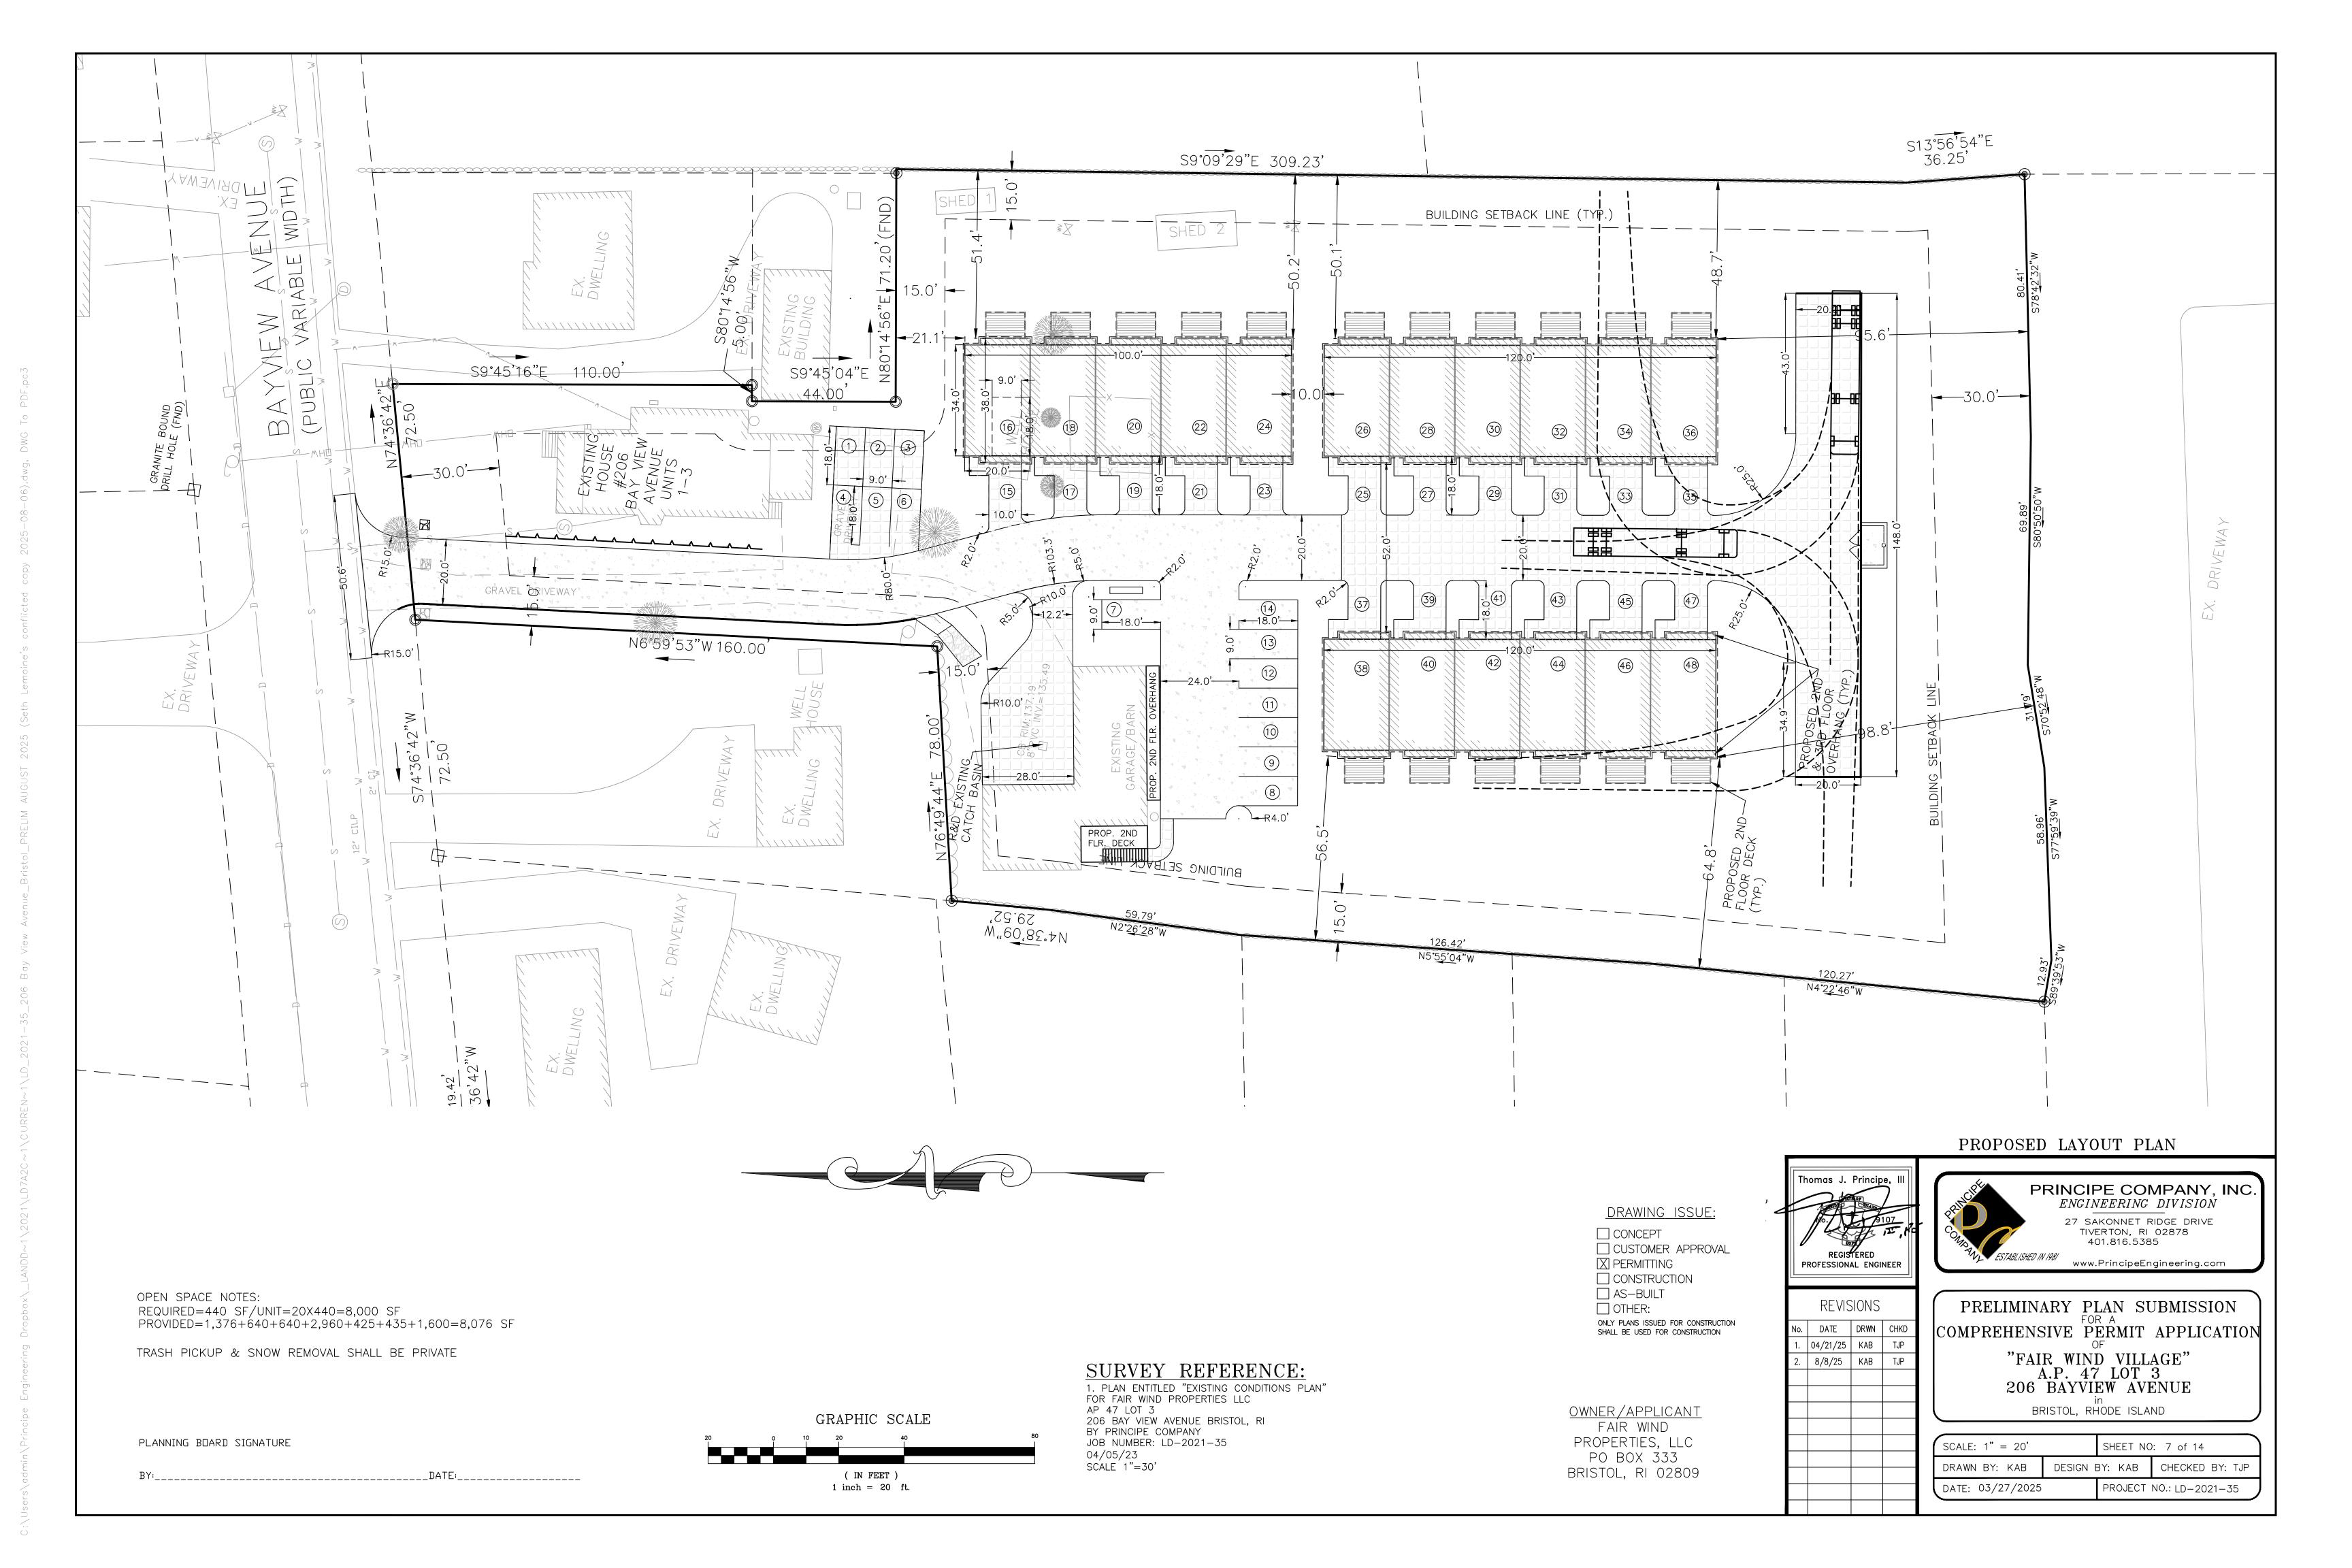

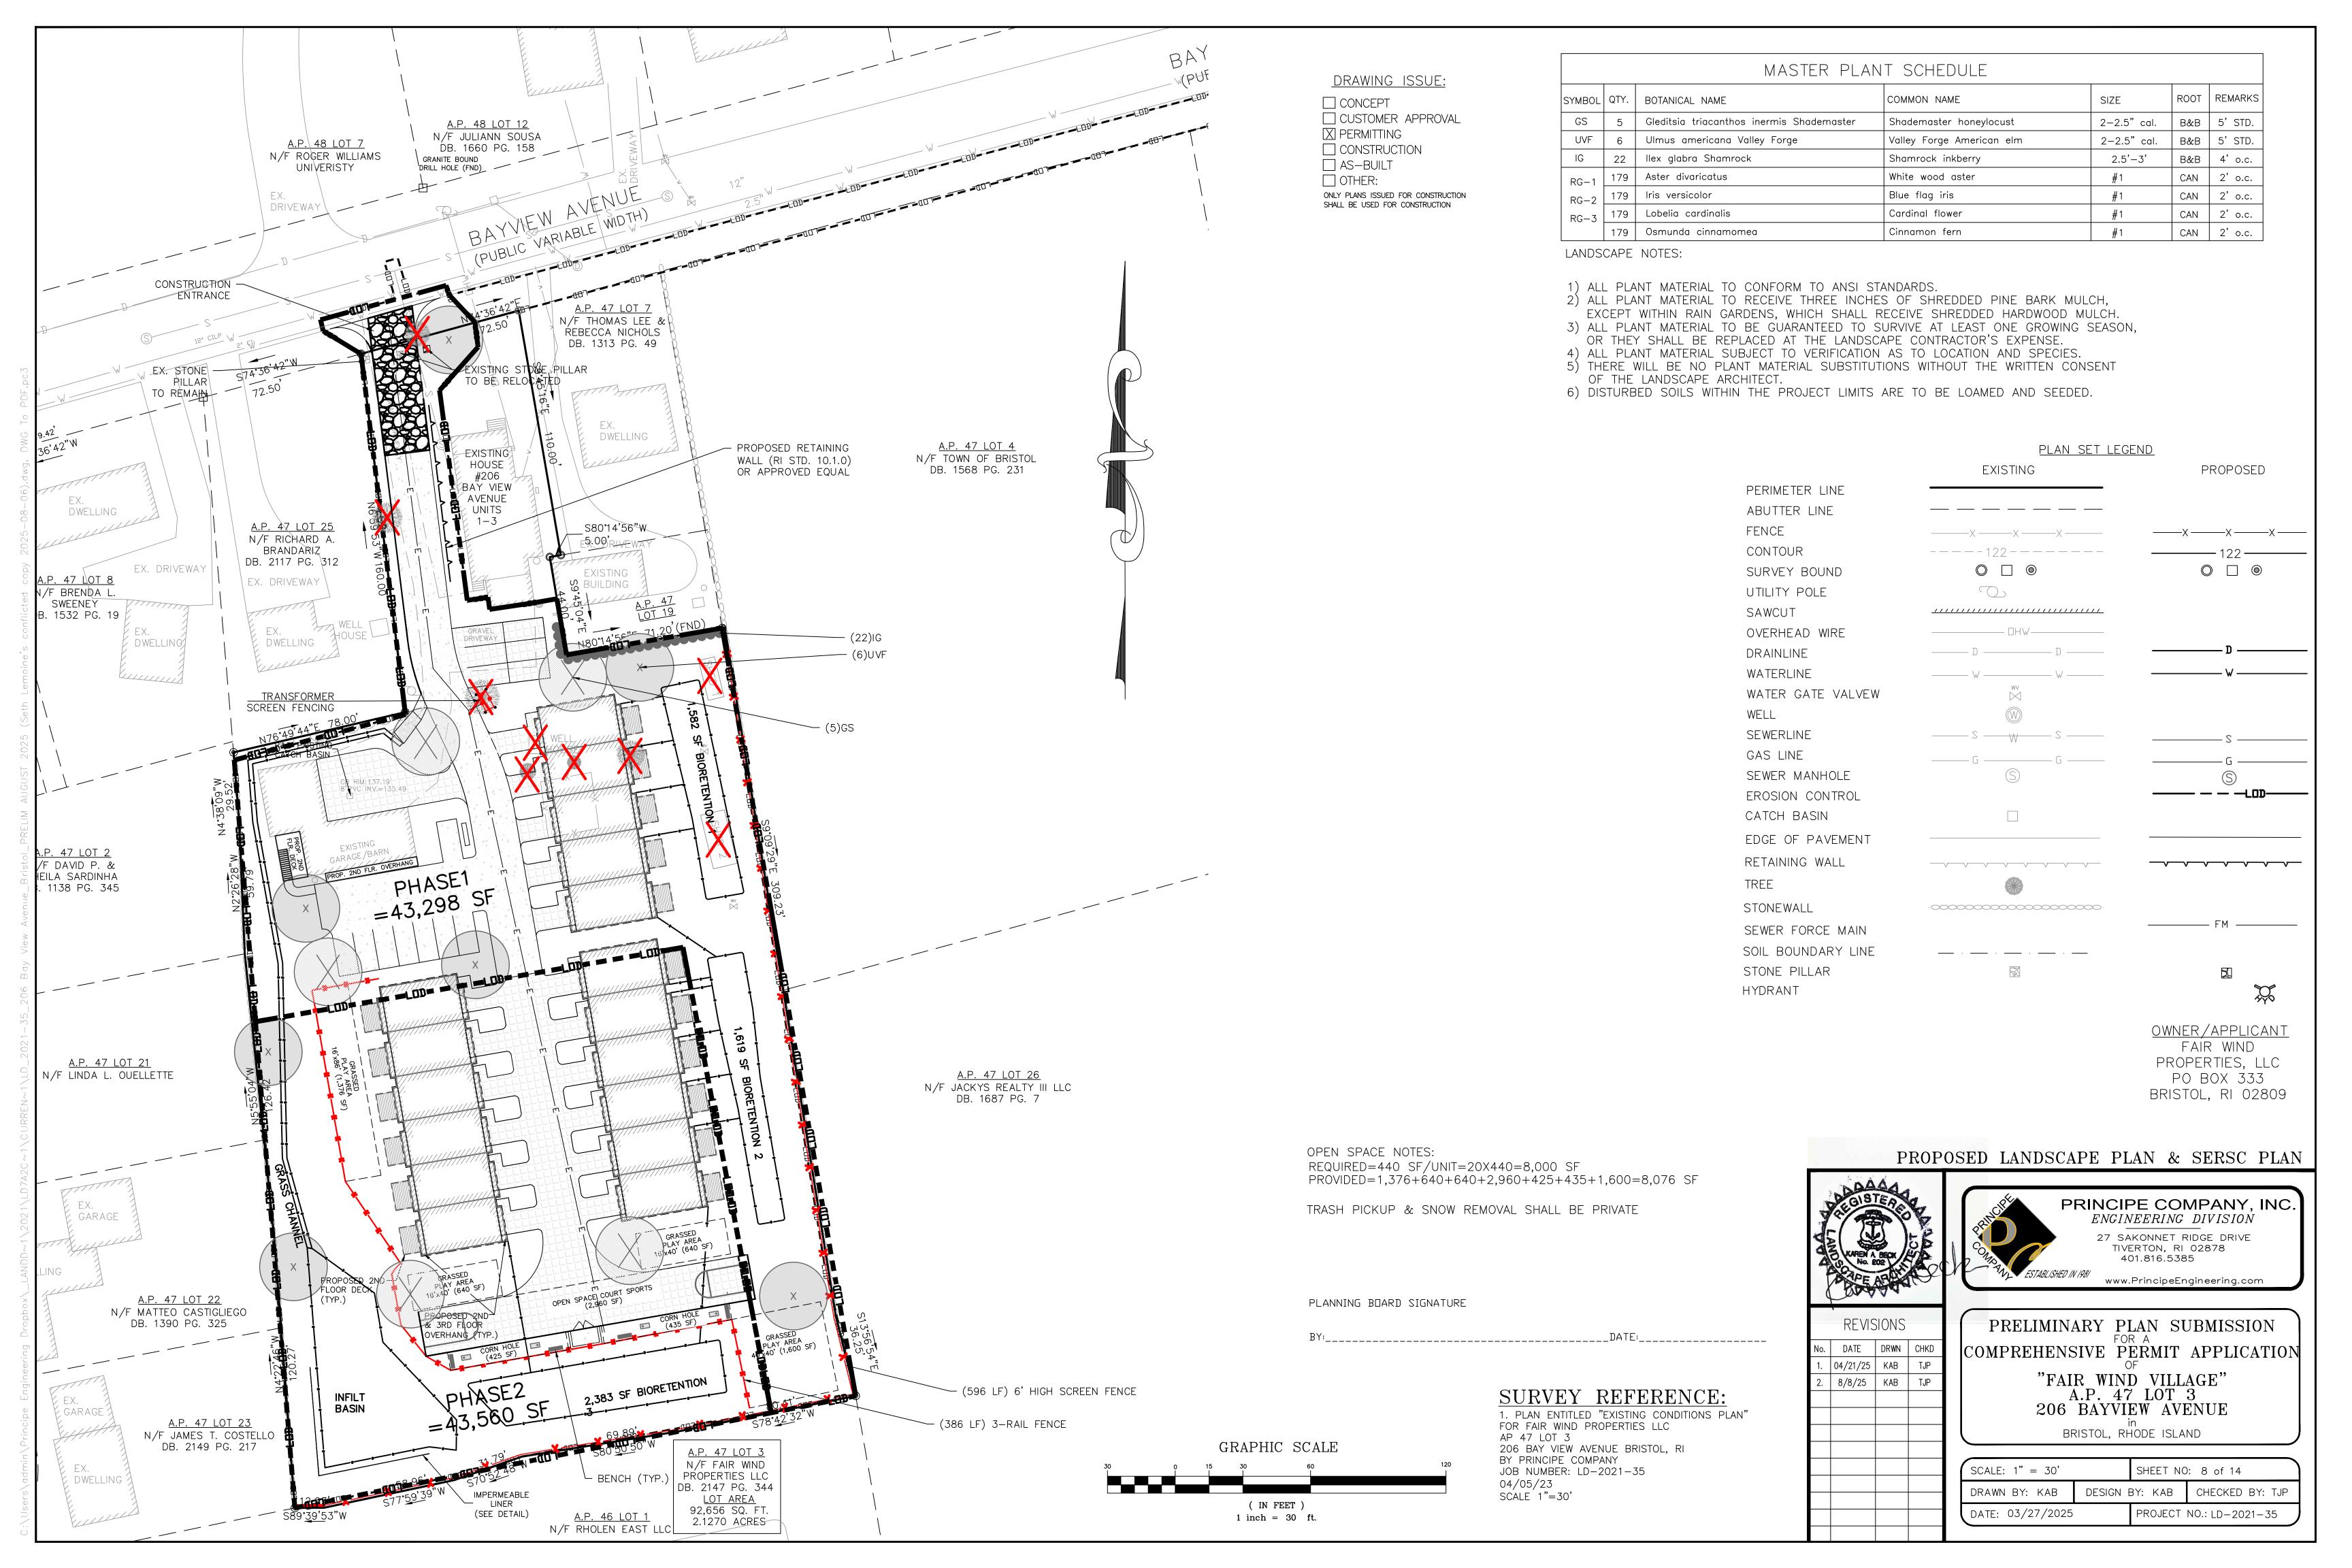

3. THE DESIGN SEED MIX UTILIZED IN ALL DISTURBED AREAS TO BE SEEDED SHALL BE COMPRISED OF THE FOLLOWING:

% BY WEIGHT SEEDING DATE CREEPING RED FESCUE 70 ASTORIA BENTGRASS APRIL 1 - JUNE 15 BIRDFOOT TREFOIL 15 AUGUST 15 - OCTOBER 15

PERENNIAL RYE GRASS APPLICATION RATE - 100 LBS PER ACRE

SEED MIX SHALL BE INOCULATED WITHIN 24 - HOURS BEFORE MIXING AND PLANTING, WITH APPROPRIATE INOCULATION FOR EACH SEED VARIETY. ALTERNATE SEED TYPES DUE TO SITE SPECIFIC CONDITIONS AND SOILS ARE ACCEPTABLE WITH THE ENGINEER'S APPROVAL.

4. IN TOPSOIL SEEDING AREAS, THE CONTRACTOR WILL LIME AND FERTILIZE AS REQUIRED TO COMPLIMENT OR UPGRADE SOIL CONDITIONS.

5. THE CONTRACTOR MUST REPAIR AND/OR RESEED ANY PERMANENT VEGETATIVE COVER AREAS THAT DO NOT DEVELOP OR WHICH ERODE WITHIN A ONE (1) YEAR PERIOD.

EROSION CONTROL, SOIL STABILIZATION AND SEDIMENT CONTROL PLAN

PRIOR TO THE COMMENCEMENT OF ANY CLEARING, GRUBBING, DEMOLITION OR EARTHWORK ACTIVITY, TEMPORARY EROSION AND SEDIMENT CONTROL MEASURES AS INDICATED ON THE PLANS ARE TO BE INSTALLED BY THE CONTRACTOR.

. CONSTRUCTION ACCESS STABILIZATION ENTRANCE PADS ARE TO BE INSTALLED PRIOR TO THE COMMENCEMENT OF SITE GRUBBING OR FARTHWORK ACTIVITY.

3. EXISTING CATCH BASINS ARE TO BE PROTECTED WITH STRAW BALES AND/OR SILT SACS PRIOR TO THE START OF SITE GRUBBING, EARTHWORK OR UNDERGROUND UTILITY AND DRAINAGE INFRASTRUCTURE INSTALLATION TO SERVE THE DEVELOPMENT SITE.

4. THE PROJECT CONSTRUCTION SEQUENCE, TO THE EXTENT PRACTICAL, SHOULD REQUIRE THE INSTALLATION OF DOWN GRADE AND OFF SITE STORM DRAINAGE SYSTEM IMPROVEMENTS BEFORE THE START OF SITE GRUBBING AND EARTHWORK ACTIVITY.

. TEMPORARY SITE SLOPE TREATMENTS FOR SOIL STABILIZATION SHALL CONSIST OF STRAW, FIBER MULCH, RIP RAP OR PROTECTIVE COVERS SUCH AS MAT OR FIBER LINING (BURLAP, JUTE, FIBERGLASS NETTING, AND EXCELSIOR OR EQUAL PRODUCTS). THESE AND OTHER ACCEPTABLE MEASURES SHALL BE INCORPORATED INTO THE SITE WORK AS WARRANTED OR AS ORDERED BY THE ENGINEER.

. CONSTRUCTION SITES ARE DYNAMIC, THE CONTRACTOR IS RESPONSIBLE FOR THE INSTALLATION AND OR MOVEMENT AND MAINTENANCE OF EROSION CONTROLS, SOIL STABILIZATION AND SEDIMENT CONTROL MEASURES AS NEEDED TO MAXIMIZE THE INTENT OF THE PLAN FOR ALL SITE CONDITIONS THROUGHOUT THE CONSTRUCTION PERIOD.

. THE CONTRACTOR SHALL BE RESPONSIBLE FOR PERIODIC INSPECTION, MAINTENANCE, REPAIR, AND REPLACEMENT OF EROSION CONTROLS, SOIL STABILIZATION AND SEDIMENT CONTROL DEVICES UNTIL AN ACCEPTABLE PERMANENT VEGETATIVE GROWTH IS ESTABLISHED. THE CONTRACTOR SHALL MAINTAIN A DETAIL LOG OF ALL EROSION CONTROL INSPECTIONS, COMPLAINTS RELATED TO EROSION OR SEDIMENT, AND CORRECTIVE REMEDIAL MEASURES TAKEN THROUGHOUT THE COURSE OF THE PROJECT CONSTRUCTION.

3. SOIL EROSION AND SEDIMENT CONTROL IS NOT LIMITED TO DAMAGES CAUSED BY WATER BUT ALSO INCLUDES EROSION AND SEDIMENT RESULTING FROM WINDS. MEASURES, SUCH AS TEMPORARY GROUND COVERS, WATER AND CALCIUM APPLICATIONS ARE TO BE UNDERTAKEN AS NEEDED TO MINIMIZE WIND RELATED SOIL AND DUST CONTROL.

9. STOCK PILES OF EARTH MATERIALS SHALL NOT BE LOCATED NEAR WATERWAYS OR WETLANDS. STOCK PILES SHALL HAVE SIDE SLOPES NO GREATER THAN THIRTY PERCENT (30%). STOCK PILES SHALL BE SURROUNDED ON THE DOWN GRADIENT OF THE EXISTING GROUND SURFACE BY HAY BALES OR SILT FENCE. THE STOCK PILES SHALL ALSO BE SEEDED OR STABILIZED IN SOME MANOR TO PREVENT SOIL EROSION. 10. THE SMALLEST POSSIBLE SITE AREAS SHALL BE DISTURBED OR EXPOSED AT ONE TIME AND DENUDED SLOPES OR WORK AREAS SHALL NOT

BE LEFT EXPOSED FOR EXCESSIVE PERIODS OF TIME, SUCH AS INACTIVE PERIODS OR SITE WORK SHUT DOWNS. 11. TO THE EXTENT POSSIBLE, ALL DISTURBED AREAS MUST BE SEEDED OR STABILIZED WITHIN THE CONSTRUCTION SEASON. STABILIZATION OF ONE FORM OR ANOTHER SHALL BE ACHIEVED WITHIN FIFTEEN (15) DAYS OF FINAL GRADING.


DOWN SEEDING OR MULCH APPLICATIONS. 3. IF CONCRETE IS TO BE USED ON SITE, THE CONTRACTOR MUST ESTABLISH AND MAINTAIN SPECIFIC WASHOUT AREAS FOR THE CONCRETE

TRUCKS WITH APPROPRIATE PROTECTION CONTROLS.

14. THE CONTRACTOR IS RESPONSIBLE FOR PROVIDING AND MAINTAINING COLLECTION AND STORAGE LOCATIONS ON-SITE FOR ALL CONSTRUCTION DEBRIS AND TRASH SO THAT THIS MATERIAL DOES NOT BECOME A NEIGHBORHOOD NUISANCE

15. EXISTING TREES AND VEGETATION WILL BE RETAINED WHENEVER FEASIBLE.

16. SITE SOIL EROSION AND SOIL STABILIZATION AND SEDIMENT CONTROLS MUST CONFORM TO ALL REQUIREMENTS OF THE APPLICABLE LOCAL

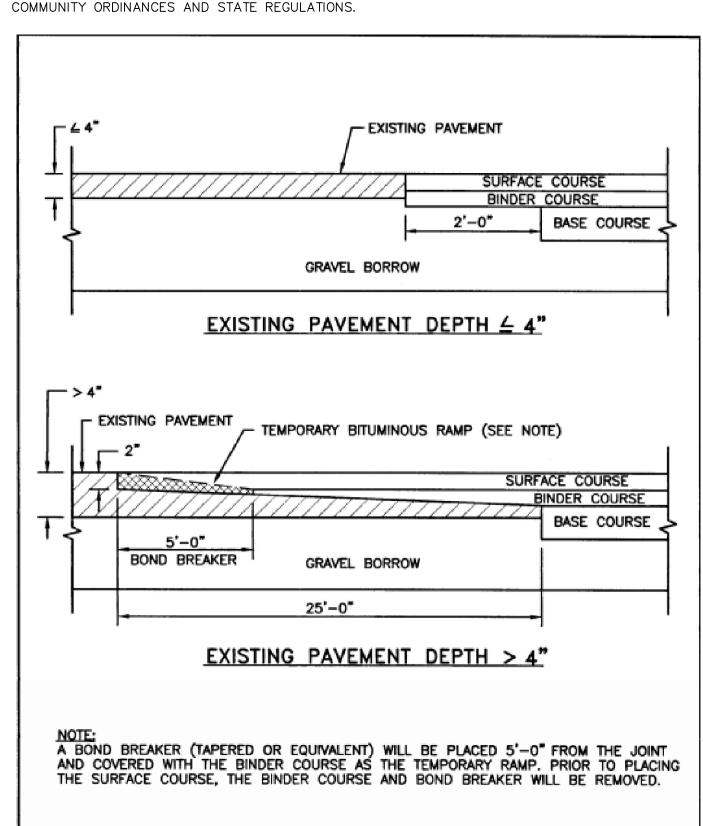

TRANSVERSE PAVEMENT CUT AND MATCH

ORDER OF PROCEDURE:

PRIOR TO ANY CLEARING AND GRUBBING OR ANY ROUGH GRADING, TEMPORARY STRAW BALES AND SANDBAGS SHALL BE PLACED OUTSIDE THE LIMITS OF CONSTRUCTION AS PER THE PLANS (I.E. ALONG ROADWAYS, STREAM BANKS, CRITICAL AREAS, ETC.).

ALL EROSION AND SEDIMENTATION CONTROL STRUCTURES SHALL BE PERIODICALLY MAINTAINED AS PER THE RESPECTIVE PROGRAMS FOR TEMPORARY CONTROL.

IF WORK PROGRESS IS TO BE INTERRUPTED AT ANY TIME, REFERENCE EROSION AND SEDIMENTATION PROGRAMS FOR TEMPORARY CONTROL. TEMPORARY STRAW BALES AND SANDBAGS ALONG AND AT THE ENDS OF ROADWAYS MAY ALSO BE REMOVED AFTER FINAL SOIL STABILIZATION HAS BEEN ACHIEVED AND APPROVED.

STRAW BALES LOCATED AT DRAINAGE OUTLETS MUST REMAIN UNTIL SUCH TIME THAT A DESIRABLE STAND OF GRASS OR COVER HAS BEEN ESTABLISHED AND THE PROJECT RECEIVES A FAVORABLE APPROVAL FOR FINAL ACCEPTANCE FROM THE ENGINEER.

SEDIMENTATION CONTROL PROGRAM:

RIP RAP SPLASH PADS SHALL BE INSTALLED AT THE OUTLETS FOR ALL CULVERTS DISCHARGING INTO A WATERWAY EXTREME CARE SHALL BE EXERCISED SO AS TO PREVENT ANY UNSUITABLE MATERIAL ENTERING THE WETLANDS. ALL DISTURBED AREAS SUBJECT TO EROSIVE TENDENCIES WHETHER THEY BE NEWLY FILLED OR EXCAVATED SHALL BE SEEDED AND PROTECTED WITH A FIBER MULCH.

DURING CONSTRUCTION, THE CONTRACTOR AND/OR DEVELOPER SHALL BE RESPONSIBLE FOR MAINTAINING DRAINAGE AND RUNOFF FLOW DURING STORMS AND PERIODS OF RAINFALL.

SEDIMENTATION CONTROL DEVICES SHALL BE INSPECTED CLOSELY AND MAINTAINED PROMPTLY AFTER EACH RAINFALL. CARE SHOULD BE TAKEN SO AS NOT TO PLACE "REMOVED SEDIMENTS" WITHIN THE PATH OF EXISTING, NEWLY CREATED (BOTH TEMPORARY AND PERMANENT) OR PROPOSED WATERCOURSES OR THOSE AREAS SUBJECTED TO STORM WATER FLOW. ADDITIONAL STRAW BALES OR SANDBAGS SHALL BE LOCATED AS CONDITIONS WARRANT.

ALL SEDIMENTS SHALL BE REMOVED FROM THE DRAINAGE AND DETENTION FACILITIES AS SCHEDULED FOR EACH FACILITY (SEE DETENTION BASIN MAINTENANCE, THIS SHEET).

GENERAL NOTES:

COMMENCING ANY WORK.

1. IT SHALL BE THE CONTRACTOR'S SOLE RESPONSIBILITY TO FAMILIARIZE HIMSELF WITH ANY APPLICABLE LOCAL, STATE AND FEDERAL LAWS GOVERNING HIS INTENDED ACTIVITIES. OSHA REGULATIONS ARE APPLICABLE OF PROJECT SITE CONSTRUCTION ACTIVITIES.


2. ALL CONSTRUCTION WILL BE UNDERTAKEN IN ACCORDANCE WITH THE APPLICABLE REQUIREMENTS OF THE TOWN OF BRISTOL.


3. IT SHALL BE THE CONTRACTOR'S SOLE RESPONSIBILITY TO MAINTAIN THE INTEGRITY OF ALL EXISTING UTILITIES, STRUCTURES, AND ABUTTING PROPERTIES. THE COST OF ANY REPAIR OR REPLACEMENT OF DAMAGED ITEMS SHALL BE BORNE BY THE CONTRACTOR.

4. IF THE MUNICIPALITY REQUIRES A PROJECT PRE-CONSTRUCTION CONFERENCE, THE PROJECT DEVELOPER AND THE PROJECT CONTRACTOR WILL ATTEND AND WILL PROVIDE ALL REQUESTED MATERIALS PRIOR TO

5. IF CEMENT CONCRETE MIX TRUCKS ARE TO BE WASHED OUT ON SITE, THE CONTRACTOR IS RESPONSIBLE FOR ESTABLISHING AND MAINTAINING A WASH OUT AREA WITH APPROPRIATE PROTECTION CONTROLS.

6. THE CONTRACTOR IS RESPONSIBLE FOR PROVIDING AND MAINTAINING COLLECTION AND STORAGE LOCATIONS ON-SITE FOR ALL CONSTRUCTION DEBRIS AND TRASH SO THAT THIS MATERIAL DOES NOT BECOME A NEIGHBORHOOD NUISANCE.

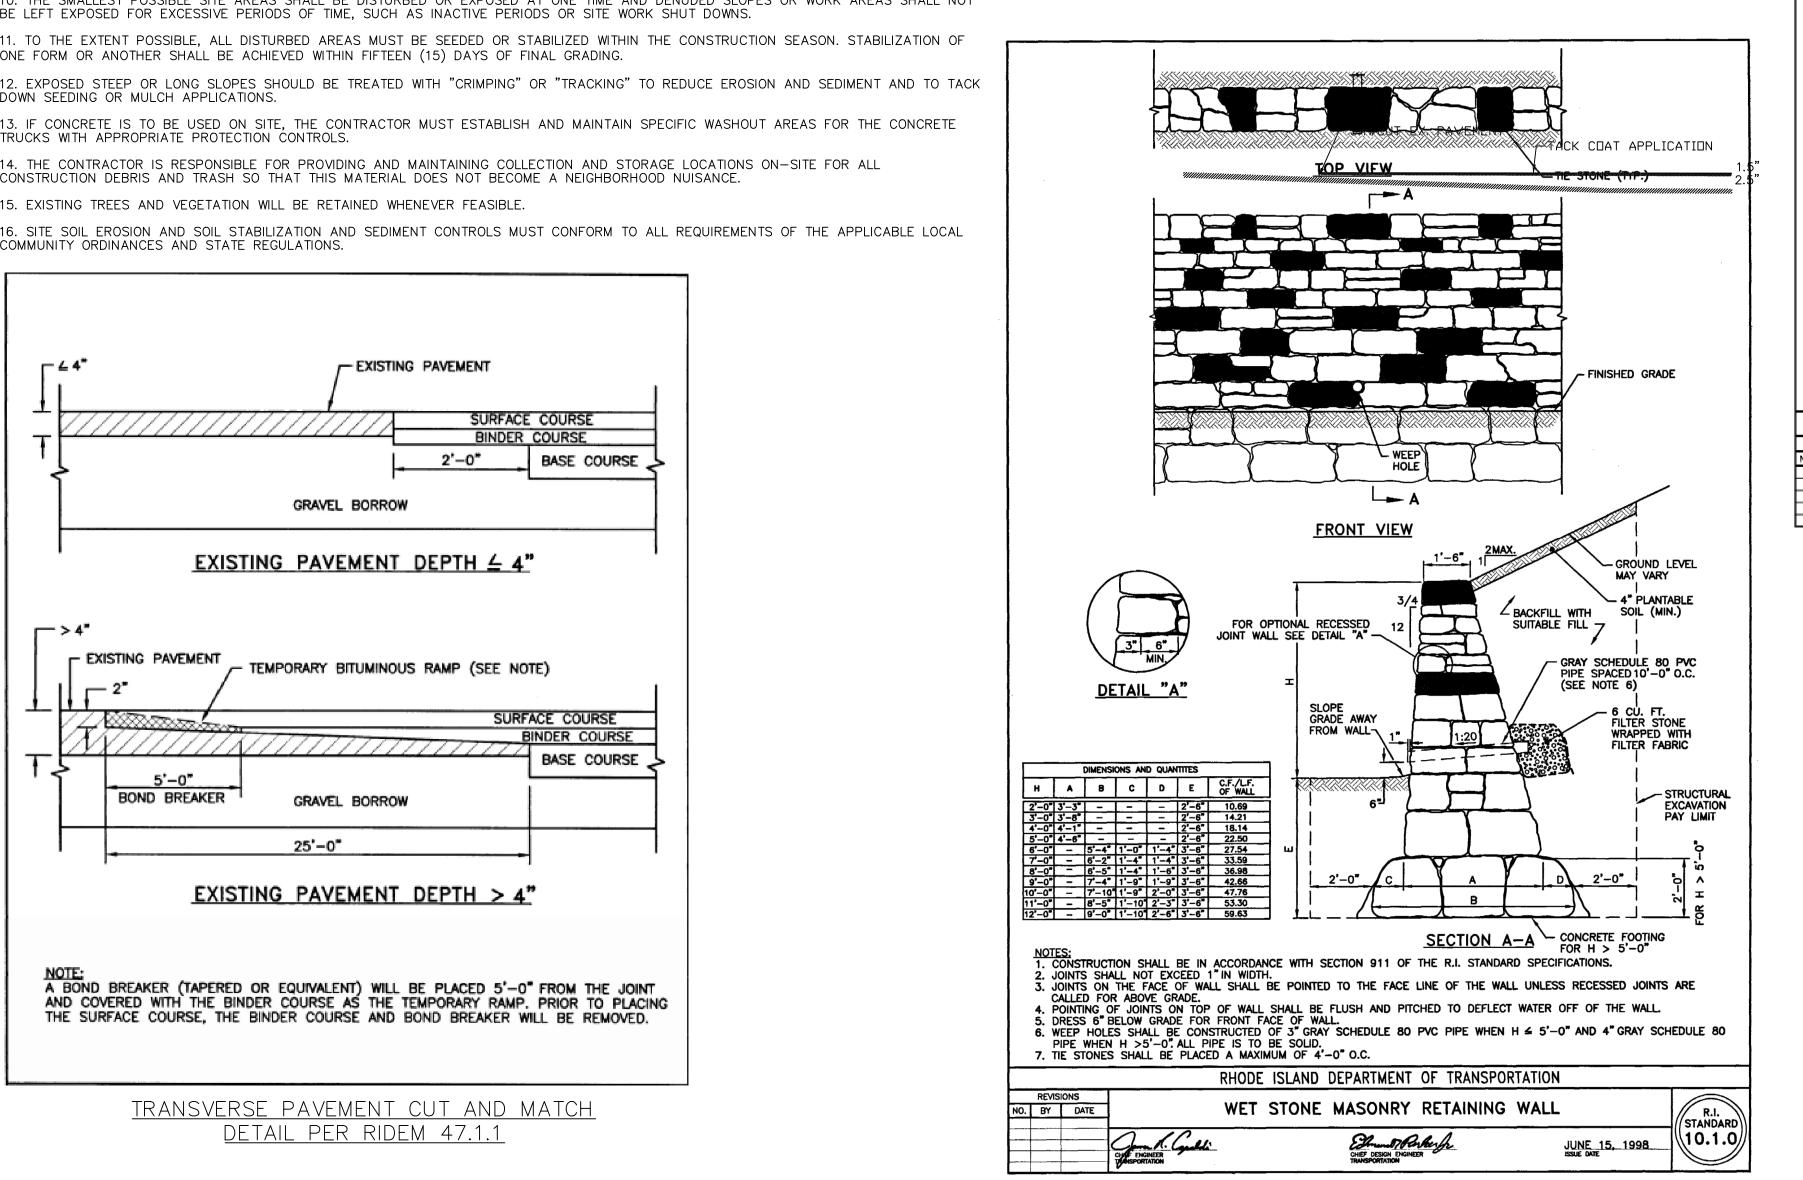


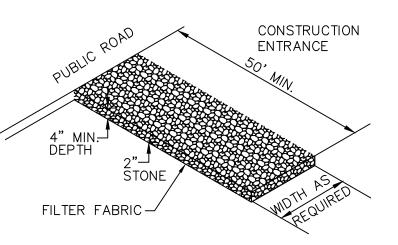


	MATERIALS	SIZE	
OUARE MESH SIEVES	2"CRUSHED STONE OR GRAVEL	ASTM C-33 NO. 2	ASTM C-33 NO. 3
	% FINER	% FINER	% FINER
1/2 INCHES 2 INCHES 1/2 INCHES 1/4 INCHES 1 INCH 3/4 INCH 1/2 INCH 3/8 INCH	100 95-100 30-55 0-25 0-5 - -	90-100 35-70 0-15 - - 0-5 -	100 90-100 35-70 - 0-15 - 0-5
NOTE:			

STABILIZATION PAD TO BE IN COMFORMANCE WITH STANDARDS SET FORTH IN THE "RHODE ISLAND GUIDELINES FOR SOIL & SEDIMENT CONTROL".


RIP-RAP STABILIZATION PAD @ CONSTRUCTION ENTRANCE NOT TO SCALE

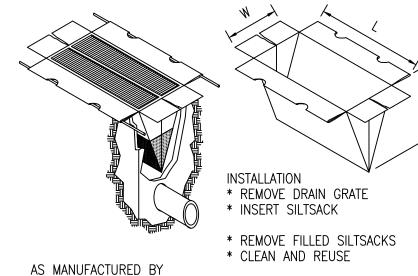


ACF ENVIRONMENTAL OR APPROVED EQUAL

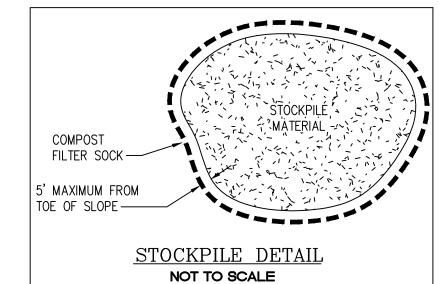

SILTSACK DETAIL NOT TO SCALE

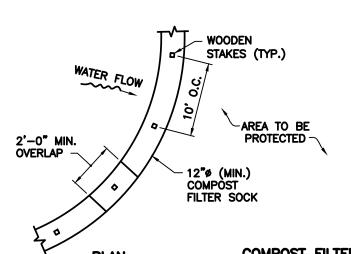


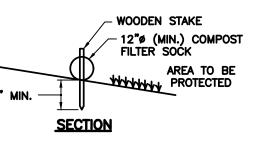

1. ALL MATERIAL TO MEET REQUIREMENTS OF SECTION 206 OF RI STANDARD SPECIFICATIONS.

2. COMPOST MATERIAL MUST BE ACCEPTED BY THE ENGINEER PRIOR TO PLACEMENT.

COMPOST FILTER SOCK

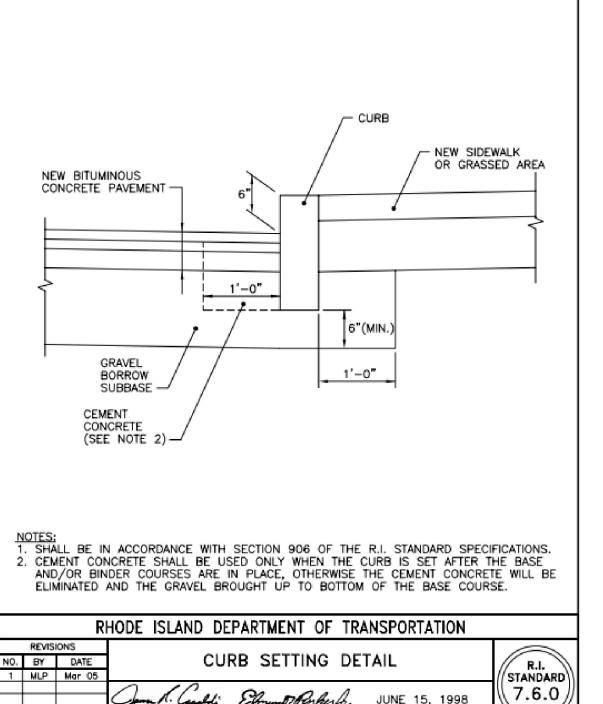

DRAWING ISSUE:

☐ CONCEPT

CUSTOMER APPROVAL X PERMITTING

☐ CONSTRUCTION ☐ AS-BUILT


OTHER: ONLY PLANS ISSUED FOR CONSTRUCTION SHALL BE USED FOR CONSTRUCTION

PLANNING BOARD SIGNATURE


BY:_____DATE:____

FAIR WIND PROPERTIES, LLC PO BOX 333 BRISTOL, RI 02809

OWNER/APPLICANT

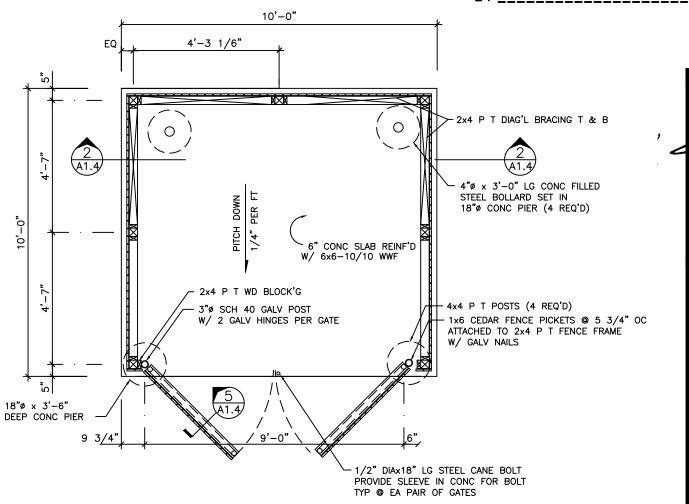

TRASH ENCLOSURE PLAN

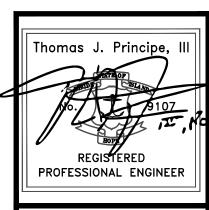



PRINCIPE COMPANY, INC. ENGINEERING DIVISION

27 SAKONNET RIDGE DRIVE TIVERTON, RI 02878 401.816.5385

DETAILS-1

www.PrincipeEngineering.com


REVISIONS PRELIMINARY PLAN SUBMISSION FOR A DATE | DRWN | CHKD COMPREHENSIVE PERMIT APPLICATION 04/21/25 | KAB | "FAIR WIND VILLAGE" 8/8/25 KAB

A.P. 47 LOT 3 206 BAYVIEW AVENUE

BRISTOL, RHODE ISLAND


SCALE: AS NOTED SHEET NO: 9 of 14 DESIGN BY: KAB CHECKED BY: TJP DATE: 03/27/2025 PROJECT NO.: LD-2021-35


DETAIL PER RIDEM 47.1.1

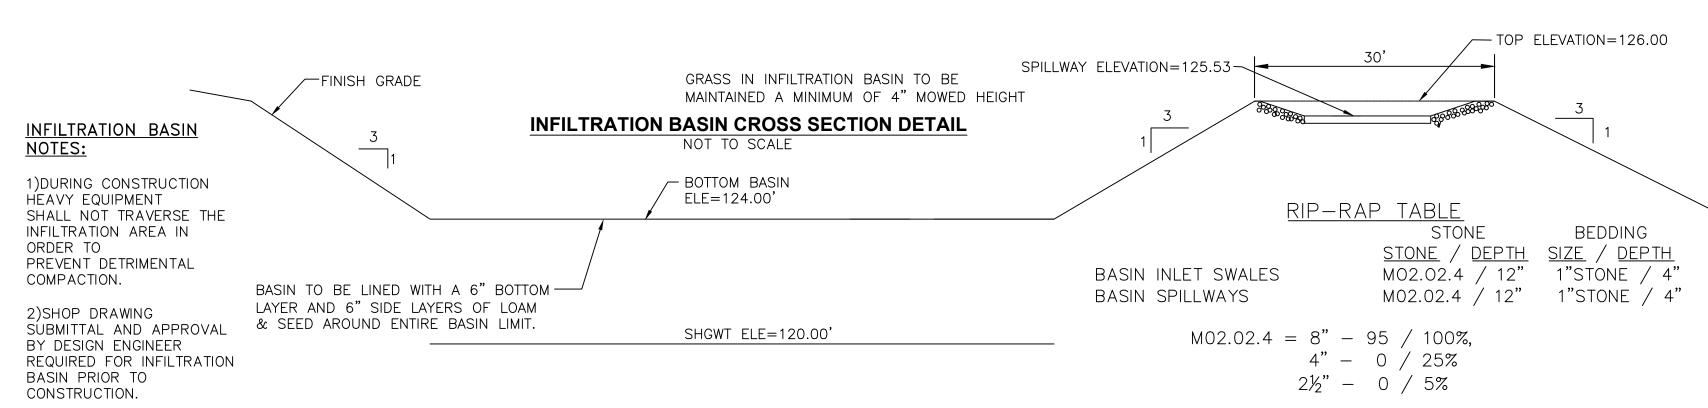

INFILTRATION BASIN MAINTENANCE SCHEDULE:

- 1. Side—slopes, embankments, and the basin floor will be mowed at least once per growing season, to prevent unwanted woody growth. This storm water facility is to be managed for wildlife habitat, therefore, mowings will be conducted after mid August to prevent mortality to ground nesting birds and animals.
- 2. All trash and litter and other debris will be removed from the storm water facility including inlet and outlet structures. This will be accomplished at least twice per year, preferably spring and fall.
- 3. Sediments will be removed from the basin immediately following site stabilization and every year thereafter. Accumulated sediments may have to be removed more frequently if the sediment storage capacity of the forebays or sediment storage areas are within the last 10 percent of available capacity. Sediment removal within the basin will restore the original capacity and design depth.
- 4. If blockage of a basin outlet structure occurs it may be necessary to dewater the pond for access to the blockage. The dewatering flow must be adequately filtered prior to discharge into a receiving water body to remove suspended solids.
- 5. Pools of stagnant water in the infiltration basin indicates failure due to erosion and scouring of the basin bottom, particularly near an inlet device. This deficiency will be corrected immediately to prevent a nuisance habitat for insects, especially
- 6. All outlet structures and outflow channels will be inspected annually. Inspections will be accomplished several times during the first six months of operation, especially after rainfall events to check for clogging or, conversely, too rapid of a release.
- 7. The grassed areas of the basin will be inspected at least twice per year to check for erosion problems. Problem areas must be reseeded immediately to stabilize exposed soils, thereby preventing erosion and potential clogging of outflow devices.
- 8. Repairs or replacement of inlet/outlet structures, rip-rap channels, fences, or other elements of the facility will be done within 30 days of deficiency reports. If an emergency situation is imminent then repair/replacement must be done immediately to avert failure or danger to nearby residents.
- 9. All sediment generated during construction and as a result of maintenance of the drainage system must be disposed of properly. Sediment shall not be disposed of in or near State or Federal regulated waters.
- 10. Records of the first two years of maintenance following construction shall be submitted to RIDEM Division of Water Resources. Maintenance records for subsequent years shall be kept on file and submitted to RIDEM, Division of Water Resources, upon request.
- 11. All drainage facilities will be maintained by a Homeowner's Association.

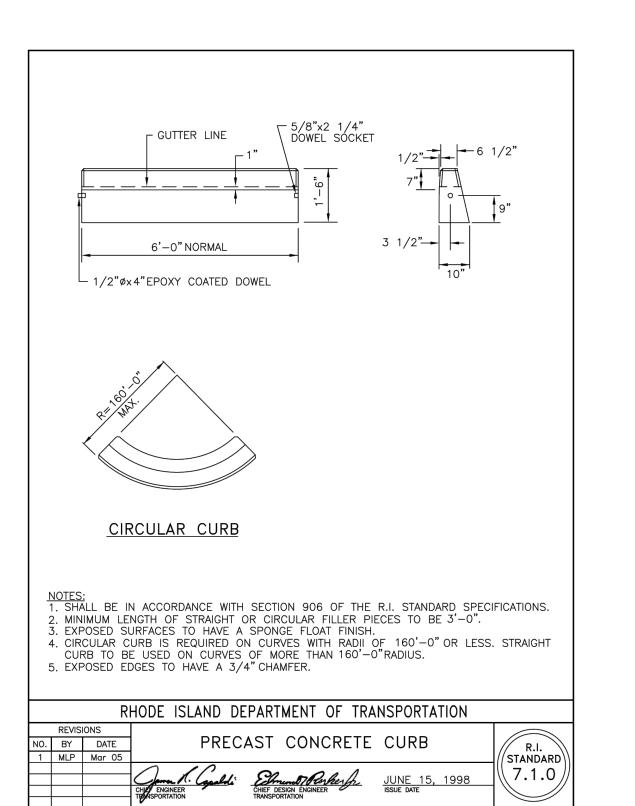

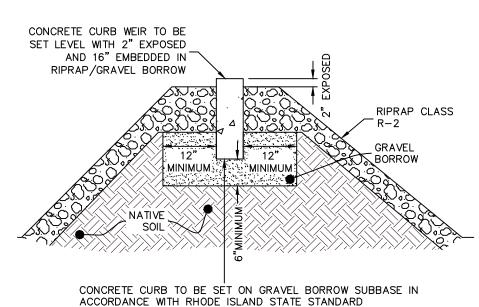

Curb Outlet Weir Cross Section

SPECIFICATIONS. GRAVEL BORROW TO EXTEND MINIMUM 6" BELOW EXISTING TOP/SUBSOIL. ALL BACKFILL SHALL BE FREE

FROM ORGANIC MATERIALS. ALL MATERIAL PLACED BELOW CURBING SHALL BE COMPACTED TO 95% DENSITY.

Rhode Island Stormwater Design and Installation Standards Manual Amended March 2015

Figure F-2 Typical Parking Area Cross-Section for Pervious Pavement System

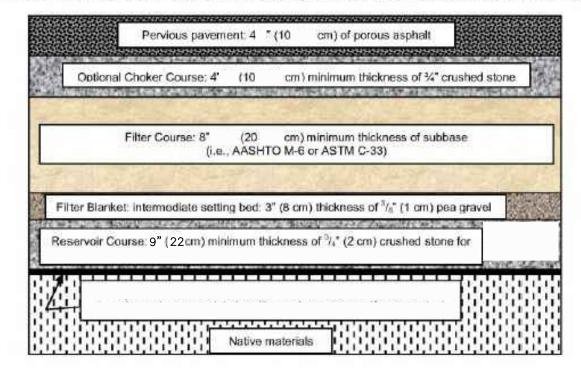



Table F-7 Gradations and compaction of choker, filter, and reservoir course

US Standard Sieve Size (inches/mm)	Percent Passing (%)				
	Choker Course (AASHTO No. 57)	Filter Course (AASHTO No. M-6)	Reservoir Course (AASHTO No.3)	Reservoir Course Alternative* (AASHTO No.5)	
6/150	2.5		5		
21/2/63	880		100	i e	
2 /50	5¥9		90 - 100	1/2	
11/2/37.5	100		35 – 70	100	
1/25	95 - 100		0 – 15	90 - 100	
3/4/19	74		2	20 - 55	
1/2/12.5	25 - 60		0 - 5	0 - 10	
3/8/9.5	28	100	*	0 - 5	
#4/4.75	0 - 10	70-100	<u> </u>	9. 1.81	
#8/2.36	0 - 5		=		
#200/0.075		0 - 6**			
% Compaction ASTM D698 / AASHTO T99	95	95	95	95	


Alternate gradations (e.g. AASHTO No. 5) may be accepted upon Engineer's approval. ** Preferably less than 4% fines

APPENDIX F: GUIDANCE ON BMP CONSTRUCTION SPECIFICATIONS

F-42

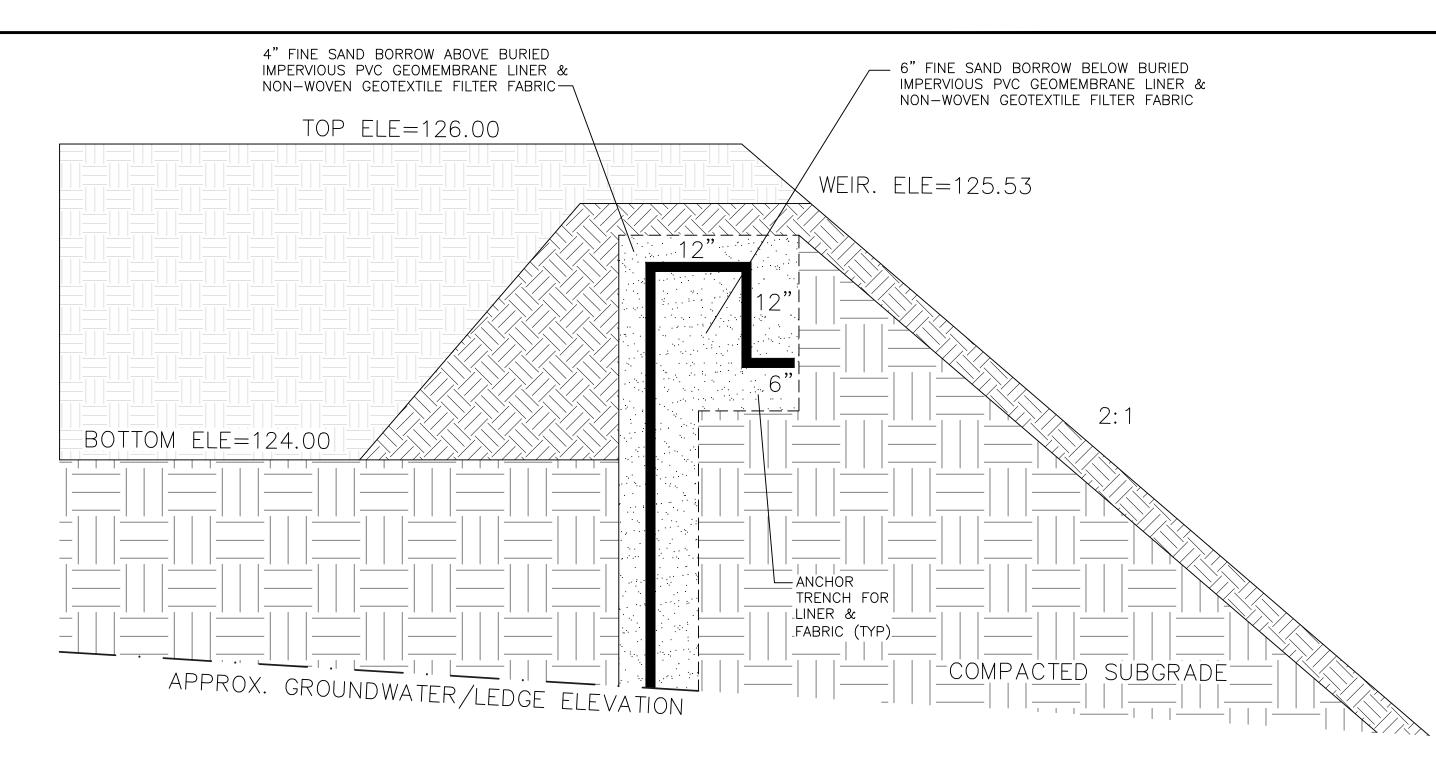


IMPERVIOUS LINER DETAIL (DOWNSLOPE OF INFILTRATION BASIN ONLY) NOT TO SCALE

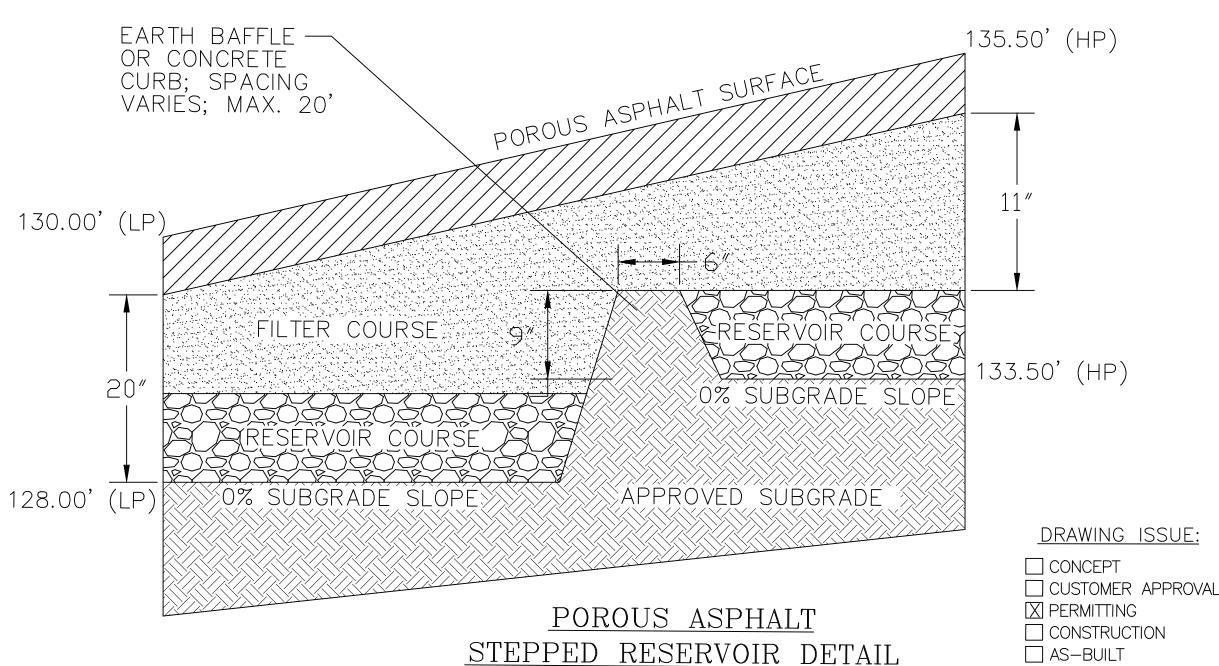

NOT TO SCALE

OWNER/APPLICANT PROPERTIES, LLC PO BOX 333 BRISTOL, RI 02809 OTHER: ONLY PLANS ISSUED FOR CONSTRUCTION

DETAILS-2

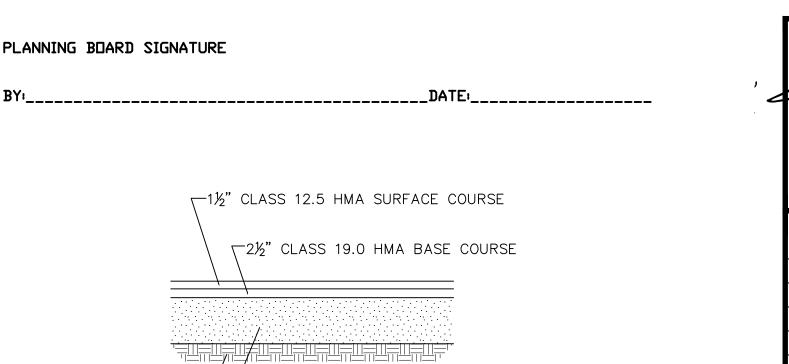


COMPACTED SUBBASE/IMPORTED GRAVEL SITE PAVEMENT TYPICAL CROSS SECTION NOT TO SCALE

12"GRAVEL BORROW BASE COURSE

∠(PLACED AND COMPACTED IN TWO

6" LAYERS)

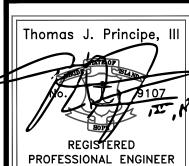



SHALL BE USED FOR CONSTRUCTION

PRINCIPE COMPANY, INC. ENGINEERING DIVISION

FAIR WIND

27 SAKONNET RIDGE DRIVE TIVERTON, RI 02878 401.816.5385

www.PrincipeEngineering.com


PRELIMINARY PLAN SUBMISSION REVISIONS COMPREHENSIVE PERMIT APPLICATION DATE DRWN CHKD 04/21/25 | KAB | "FAIR WIND VILLAGE" 8/8/25 KAB A.P. 47 LOT 3 206 BAYVIEW AVENUE


BRISTOL, RHODE ISLAND


SCALE: AS NOTED SHEET NO: 10 of 14 DESIGN BY: KAB | CHECKED BY: TJP DRAWN BY: KAB PROJECT NO.: LD-2021-35 DATE: 03/27/2025


GENERAL NOTES - WATER:


- 1) CONTRACTOR SHALL OBTAIN A ROAD OPENING PERMIT FROM THE TOWN OF BRISTOL PRIOR TO THE START OF WORK WITHIN THE RIGHT OF WAY.
- 2) CONTRACTOR SHALL PROVIDE PRODUCT SUBMITTALS TO THE BCWA.
- 3) CONTRACTOR MUST MAINTAIN INSURANCE COVERAGE AS REQUIRED BY THE BCW FOR THE LIFE OF THE PROJECT AND PROVIDE THE BCWA WITH THE CERTIFICATE OF INSURANCE.
- 4) CONTRACTOR SHALL FURNISH THE BCWA WITH A SITE IMPROVEMENT BOND IN THE AMOUNT EQUAL TO THE COST OF THE WORK.
- 5) AT ALL POINTS OF CONNECTION OF NEW WATER MAINS TO EXISTING MAINS, THE CONTRACTOR SHALL BE RESPONSIBLE FOR EXCAVATING AND VERIFYING LOCATION OF THE EXISTING LINES PRIOR TO ANY CONSTRUCTION.
- 6) A TEMPORARY BYPASS SYSTEM SHALL BE INSTALLED AND THE PROPERTIES CURRENTLY SERVICED BY THE EXISTING 2" WATER MAIN SHALL BE CONNECTED UNTIL THE NEW 8" WATER SYSTEM IS RELAYED.
- 7) EXCEPT IN CASE OF AN EMERGENCY, VALVES ON THE BRISTOL COUNTY WATER AUTHORITY (BCWA) WATER SYSTEM SHALL BE OPERATED BY OR UNDER THE DIRECTION OF THE APPROPRIATE PERSONNEL. THE CONTRACTOR SHALL GIVE THE BCWA STAFF 48 HOURS NOTICE TO ARRANGE FOR OPERATING VALVES. BOTH THE CONTRACTOR AND THE APPROPRIATE BCWA PERSONNEL SHALL BE PRESENT WHEN THE VALVES ARE OPERATED.
- 8) WATER AND SANITARY SEWER LINES SHALL HAVE A MINIMUM HORIZONTAL SEPARATION OF TEN (10) FEET. WHEN A TEN (10) FOOT SEPARATION IS NOT PROVIDED OR WHEN SEWER LINES CROSS WATER LINES WITH LESS THAN 18 INCHES OF VERTICAL SEPARATION, SEWER LINE JOINTS SHALL BE CONCRETE ENCASED. FOR PERPENDICULAR CROSSINGS, ENCASED JOINTS SHALL EXTEND TEN (10) FEET, PERPENDICULAR TO THE WATER LINE IN BOTH DIRECTIONS.
- 9) ALL WATER LINES SHALL HAVE A MINIMUM OF FORTYEIGHT (48) INCHES OF COVER AND BE LOCATED A MINIMUM OF TEN (10) FEET FROM THE SANITARY SEWER.
- 10) CHANGES IN DIRECTION OF WATERLINE PIPE SHALL REQUIRE BENDS IN ALL INSTANCES. AXIAL DEFLECTION AT THE JOINTS SHALL NOT BE ALLOWED.
- 11) DISTANCES FOR WATER LINES ARE THE HORIZONTAL DISTANCE BETWEEN THE CENTERS OF THE FITTINGS. THEREFORE, DISTANCES SHOWN ON THE PLANS ARE APPROXIMATE AND COULD VARY DUE TO VERTICAL ALIGNMENT AND FITTING DIMENSIONS.
- 12) ALL WATER LINE VALVES SHALL BE SET ADJACENT TO THE TEE, EXCEPT FOR POINTS THAT FALL IN THE FLOW LINE OF A CONCRETE CROSS PAN. IN WHICH CASE, THE VALVE SHALL BE LOCATED SO THAT SURFACE DRAINAGE DOES NOT INFILTRATE THE VALVE BOX. VALVE BOXES SHALL BE SET AT AN ELEVATION IN ACCORDANCE WITH TOWN PAVING **REQUIREMENTS.**
- 13) FIRE HYDRANT ASSEMBLY INCLUDES THE FIRE HYDRANT, SIX (6) INCH VALVE, AND SIX (6) INCH PIPE. INSTALLATION SHALL BE IN ACCORDANCE WITH THE BCWA STANDARDS AND SPECIFICATIONS
- 14) ALL FITTINGS SHALL BE MADE FROM DUCTILE IRON, FURNISHED WITH MECHANICAL JOINT ENDS OR INTEGRAL RESTRAINED JOINTS, AND SHALL CONFORM TO BCWA APPROVED MATERIAL LIST.
- 15) MAGNETIC WARNING TAPE SHALL BE INSTALLED 12" MINIMUM AND 18" MAXIMUM ABOVE WATER PIPE.
- 16) BEDDING MATERIAL SHALL CONFORM TO BCWA STANDARDS AND SPECIFICATIONS.
- 17) VALVE BOXES IN NON-PAVED AREAS SHALL HAVE A CONCRETE COLLAR AROUND THE VALVE LID IN ACCORDANCE WITH THE DETAIL
- 18) CONCRETE THRUST BLOCKS AND/OR "MEGA-LUG" MECHANICAL RESTRAINTS ARE REQUIRED AT ALL MECHANICAL FITTINGS. THRUST BLOCKS MAY NOT BE REQUIRED IF PIPE RESTRAINT IS PROVIDED IN ACCORDANCE WITH RESTRAINED PIPE DETAIL.
- 19) NO WORK SHALL BE BACKFILLED (INCLUDING BEDDING MATERIAL ABOVE THE SPRING LINE OF THE PIPE) UNTIL THE CONSTRUCTION HAS BEEN INSPECTED AND APPROVED FOR BACKFILLING BY BCWA ENGINEERING STAFF.
- 20) ONLY ONE CONNECTION TO THE EXISTING WATER DISTRIBUTION SYSTEM SHALL BE MADE UNTIL ALL HYDROSTATIC TESTING, CHLORINATION AND FLUSHING HAS BEEN COMPLETED.
- 21) DISINFECTION AND HYDROSTATIC TESTING SHALL BE DONE IN THE PRESENCE OF A BCWA ENGINEERING STAFF. CONTACT THE BCWA ENGINEERING DIVISION FORTY-EIGHT (48) HOURS PRIOR TO DISINFECTING AND/OR TESTING.
- 22) DISINFECTION AND FLUSHING SHALL BE DONE IN ACCORDANCE SET FORTH IN AWWA B300 AND C651, "STANDARD FOR DISINFECTING WATER MAINS", LATEST REVISION. DISINFECTION PRODUCT SHALL BE NSF-61 APPROVED FOR CONTACT WITH DRINKING WATER. A CERTIFICATE OF COMPLIANCE SHALL BE PROVIDED TO THE BCWA ANDNSF-61 LABEL SHALL BE AFFIXED TO THE CONTAINER OF CHLORINE. THE CHLORINATION OF THE WATER LINE SHALL BE PERFORMED PRIOR TO THE HYDROSTATIC TESTING. ALL VALVES, FIRE HYDRANTS AND OTHER APPURTANCES SHALL BE OPERATED WHILE PIPELINE IS FILLED WITH THE CHLORINATING AGENT TO ENSURE THAT HIGH CHLORINE CONTACT IS MADE WITH ALL INTERNAL SURFACES.
- 23) TWO TWENTY-FOUR (24) HOUR BACTERIOLOGICAL TESTS, FROM MULTIPLE POINTS TO BE DETERMINED BY THE BCWA ENGINEER, FOR TOTAL COLI-FORM BACTERIA SHALL BE PERFORMED A MINIMUM OF 24 HOURS APART. IF EITHER OF THESE TESTS FAIL, THE LINE SHALL BE RE-CHLORINATED, RE-FLUSHED AND THEN RETESTED. THE DEVELOPER AND/OR CONTRACTOR SHALL BE RESPONSIBLE FOR REIMBURSING THE BCWA FOR ALL COSTS ASSOCIATED WITH THE WATER QUALITY TESTING.
- 24) ALL WATER LINES SHALL BE HYDROSTATIC TESTED. PRESSURE AND LEAKAGE TESTS SHALL BE CONDUCTED ACCORDING TO THE APPLICABLE SECTIONS OF AWWA C600/605 TO A MINIMUM PRESSURE OF ONE HUNDRED AND FIFTY (150) POUNDS PER SQUARE (PSI) INCH AT THE LOW POINT OF THE SECTION BEING TESTED FOR THE DURATION OF TWO (2) HOURS. THE MAXIMUM LENGTH OF LINE TO BE TESTED SHALL BE ONE THOUSAND (1,000) FEET. ALL JOINTS IN CONNECTIONS ARE TO BE WATERTIGHT WITHIN TOLERANCES ALLOWED BY THE SPECIFICATIONS IN AWWA C600/605. ANY LEAKAGE THAT IS DISCOVERED BY OBSERVATION OR TESTS SHALL BE LOCATED AND MADE WATERTIGHT BY THE CONTRACTOR. PRESSURE AND LEAKAGE TESTS SHALL NOT BE CONDUCTED UNTIL THE LINE HAS PASSED ALL REQUIRED DISINFECTION TESTS.
- 25) ALL WATER VAULTS SHALL BE WATERTIGHT. CONTRACTOR SHALL SEAL VAULTS TO ENSURE SURFACE WATER DOES NOT INFILTRATE INTO THE VAULTS. VAULT LIDS SHALL BE PLACED TO ENSURE THAT SURFACE WATER DOES NOT FLOW INTO THE VAULTS.

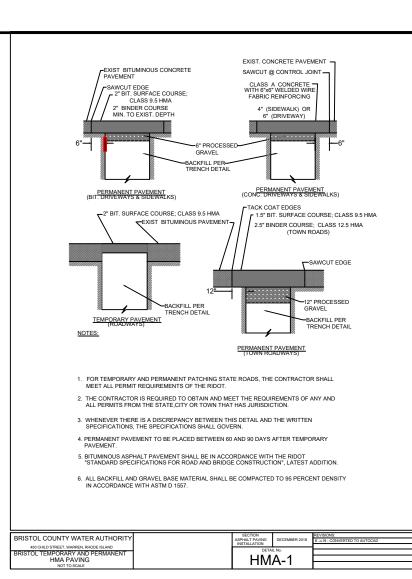


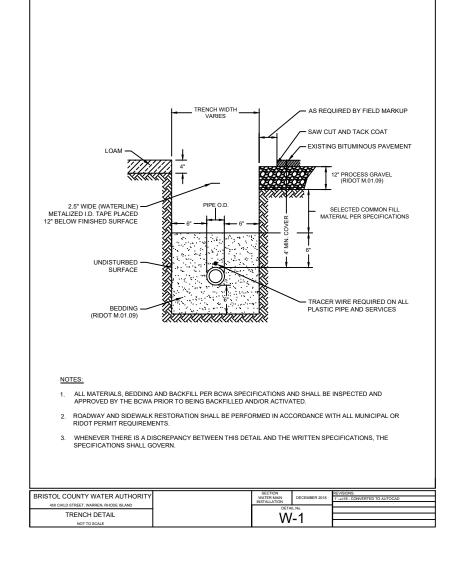


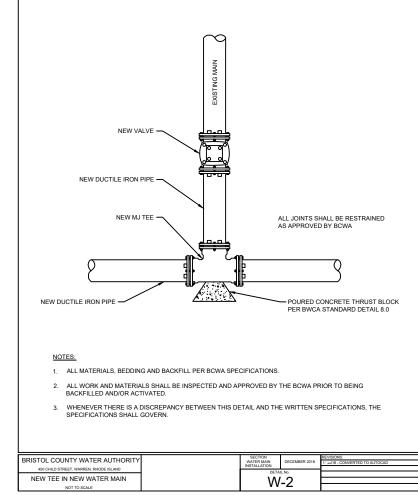


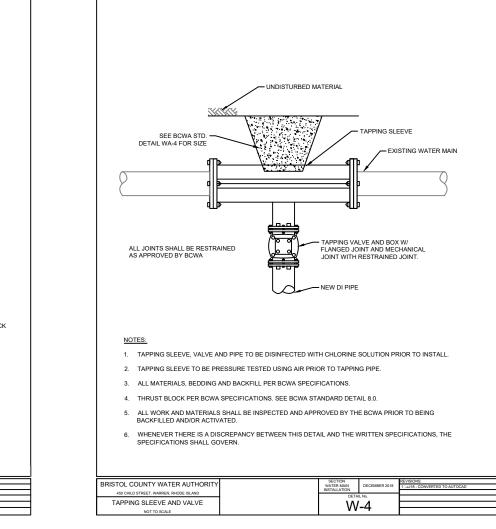


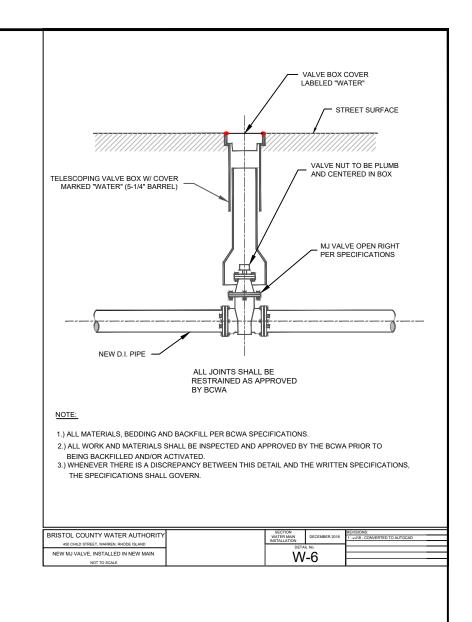


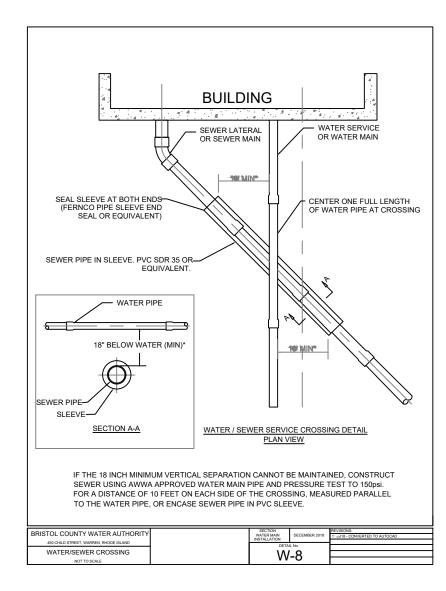


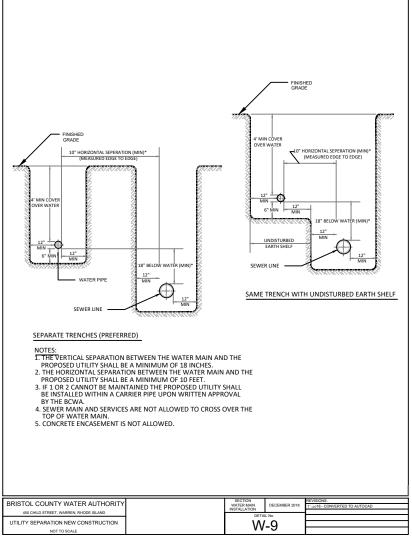

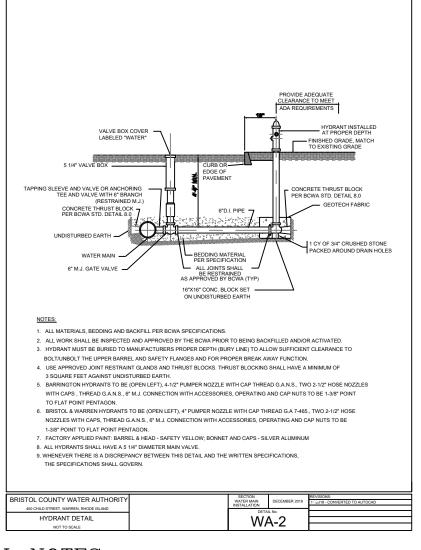

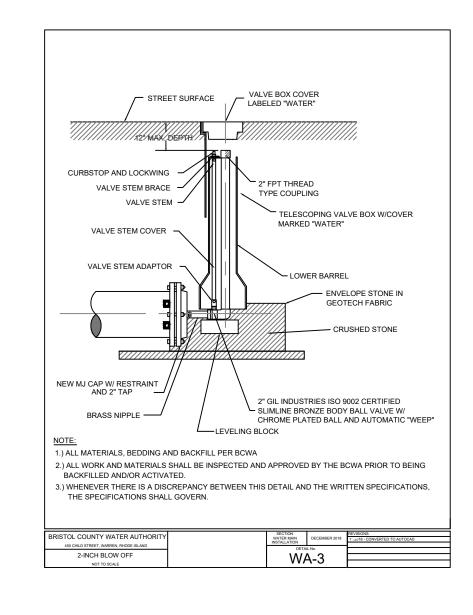

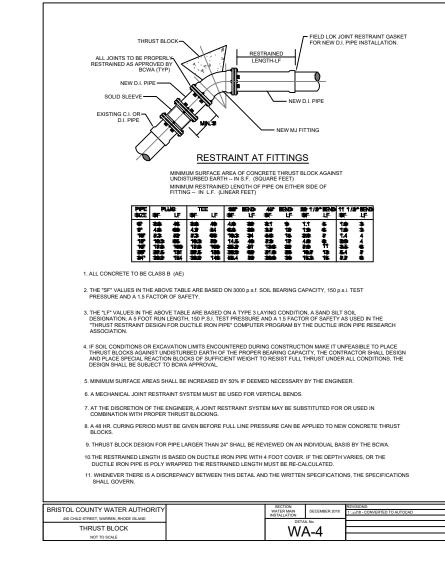

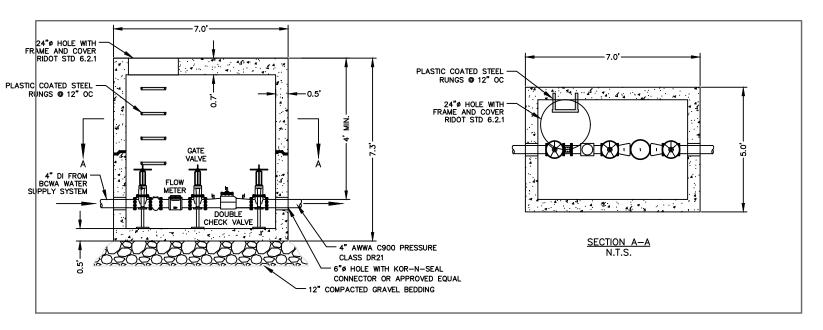

PRECAST CONCRETE METER VAULT DETAIL N.T.S

- 1. PRECAST CONCRETE VAULT SHALL CONFORM TO OLD CASTLE PRECAST MP4X6X6 OR APPROVED EQUAL AND BE H-20 RATED.
- 2. APPURTENANCES SHALL CONFORM TO BCWA APPROVED MATERIALS LIST.

GENERAL NOTES:

ALL REQUIRED SITE IMPROVEMENTS SHALL BE INSPECTED BY THE TOWN ENGINEER TO ENSURE SATISFACTORY COMPLETION. IN NO CASE SHALL THE INSTALLATION OF ANY IMPROVEMENTS BE STARTED UNTIL PRIOR NOTIFICATION IS GIVEN TO THE TOWN ENGINEER. AT LEAST A 48-HOUR NOTICE SHALL BE GIVEN TO THE TOWN ENGINEER PRIOR TO ANY SUCH START OF CONSTRUCTION. A FINAL INSPECTION OF ALL SITE IMPROVEMENTS, UTILITIES AND GRADING WILL BE MADE TO DETERMINE WHETHER THE WORK IS SATISFACTORY AND IN SUBSTANTIAL AGREEMENT WITH THE APPROVED. FINAL CONSTRUCTION DRAWING AND THE TOWN SPECIFICATIONS.

2. LOCATION AND DEPTH OF EXISTING UTILITIES ARE APPROXIMATE AND HAVE BEEN PLOTTED FROM THE BEST AVAILABLE INFORMATION. THE CONTRACTOR SHALL CHECK AND VERIFY LOCATIONS OF ALL EXISTING UTILITIES BOTH UNDERGROUND AND OVERHEAD. ANY DAMAGE TO EXISTING UTILITIES AS SHOWN OR NOT SHOWN ON THE PLANS SHALL BE THE CONTRACTOR'S RESPONSIBILITY. COSTS OF SUCH DAMAGE SHALL BE BORNE BY THE CONTRACTOR. NO EXCAVATION SHALL BE DONE UNTIL ALL INVOLVED UTILITY COMPANIES ARE NOTIFIED 48-HOURS IN ADVANCE. THE CONTRACTOR SHALL BE RESPONSIBLE TO NOTIFY DIG-SAFE (1-800-344-7233) A MINIMUM OF 48 WORKING HOURS, EXCLUDING WEEKENDS AND HOLIDAYS, PRIOR TO THE START OF ANY EXCAVATION AND/OR BLASTING WORK. THE NAME OF THE COMPANY PERFORMING THE EXCAVATION AND/OR BLASTING WORK MUST BE SUPPLIED TO DIG-SAFE, IF IT IS DIFFERENT FROM THE CALLER.

4. IT SHALL BE THE CONTRACTOR'S SOLE RESPONSIBILITY TO OBTAIN ANY AND ALL PERMITS REQUIRED BY, BUT NOT LIMITED TO, THE STATE OF MASSACHUSETTS, THE FEDERAL GOVERNMENT, THE TOWN OF MARION AND ALL INDIVIDUAL UTILITY COMPANIES PRIOR TO COMMENCING ANY WORK.


5. THE CONTRACTOR SHALL BE RESPONSIBLE FOR ESTABLISHING AND MAINTAINING ALL TEMPORARY SEDIMENTATION AND EROSION CONTROLS.

7. ALL MATERIAL FOR FILL SHALL BE CLEAN AND FREE OF MATTER WHICH COULD POLLUTE ANY DOWN STREAM WATERCOURSE.

9. FILL MATERIAL SHALL BE COMPACTED IN ONE FOOT (MAXIMUM) LIFTS TO AT LEAST 95% OF THE MAXIMUM DRY DENSITY AS DETERMINED IN ACCORDANCE WITH ASTM D-1557 (MODIFIED PROCTOR TEST).

OWNER / APPLICANT FAIR WIND PROPERTIES, LLC PO BOX 333 BRISTOL, RI 02809

DETAILS-3

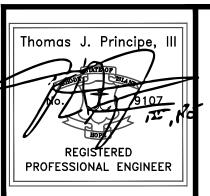

REVISIONS

DATE DRWN CHKD



401.816.5385 www.PrincipeEngineering.com

PRELIMINARY PLAN SUBMISSION

COMPREHENSIVE PERMIT APPLICATION "FAIR WIND VILLAGE" A.P. 47 LOT 3 206 BAYVIEW AVENUE BRISTOL, RHODE ISLAND

SCALE: AS NOTED SHEET NO: 11 of 14 DRAWN BY: SJL DESIGN BY: SJL CHECKED BY: TJP DATE: 08/08/2025 PROJECT NO.: LD-2021-35

PLANNING BOARD SIGNATURE


___DATE:_____

DRAWING ISSUE: ☐ CONCEPT CUSTOMER APPROVAL X PERMITTING ☐ CONSTRUCTION ☐ AS-BUILT

ONLY PLANS ISSUED FOR CONSTRUCTION

SHALL BE USED FOR CONSTRUCTION

OTHER:

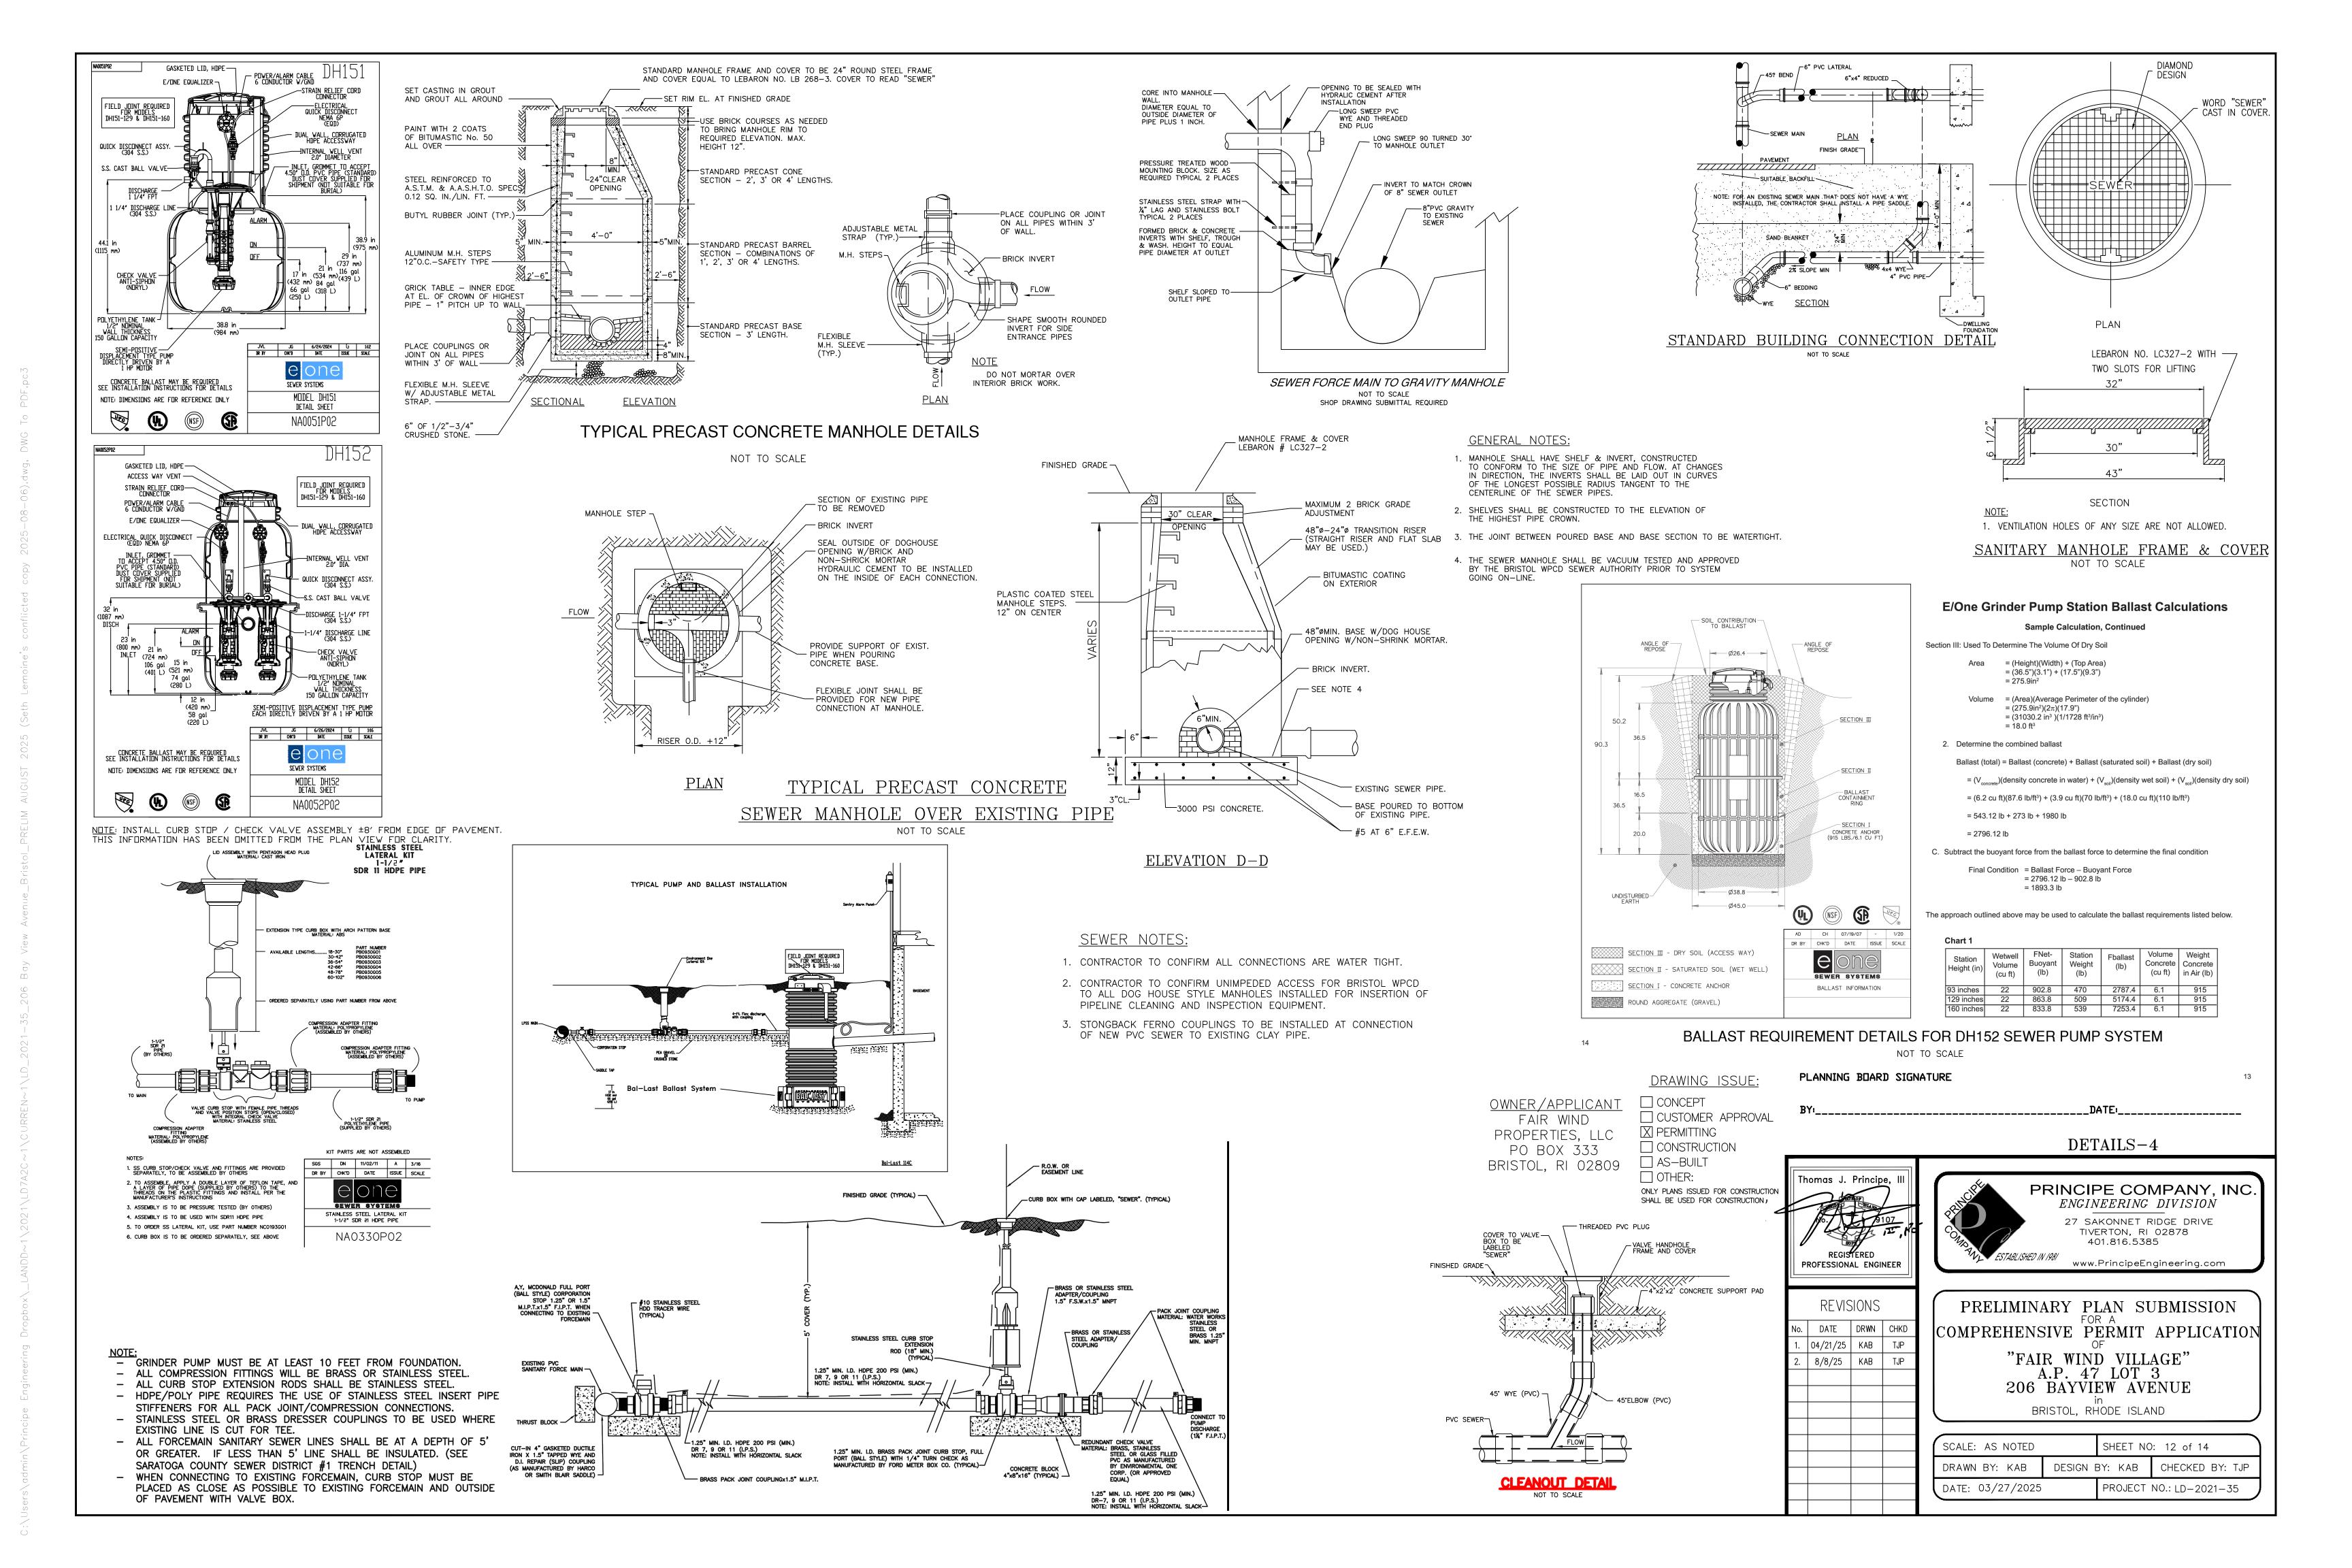

PLANT SPECIES TO BE USED

BOTANICAL NAME COMMON NAME

ASTER DIVARICATUS

IRIS VERSICOLOR

LOBELIA CARDINALIS

OSMUNDA CINNAMOMEA


WHITE WOOD ASTER

BLUE FLAG IRIS

CARDINAL FLOWER

CINNAMON FERN

*PLANT SPECIES IN ONE GALLON CONTAINERS TO BE INSTALLED AT 2' O.C. IN GROUPS OF THREE WITHIN EACH BIORETENTION AREA.

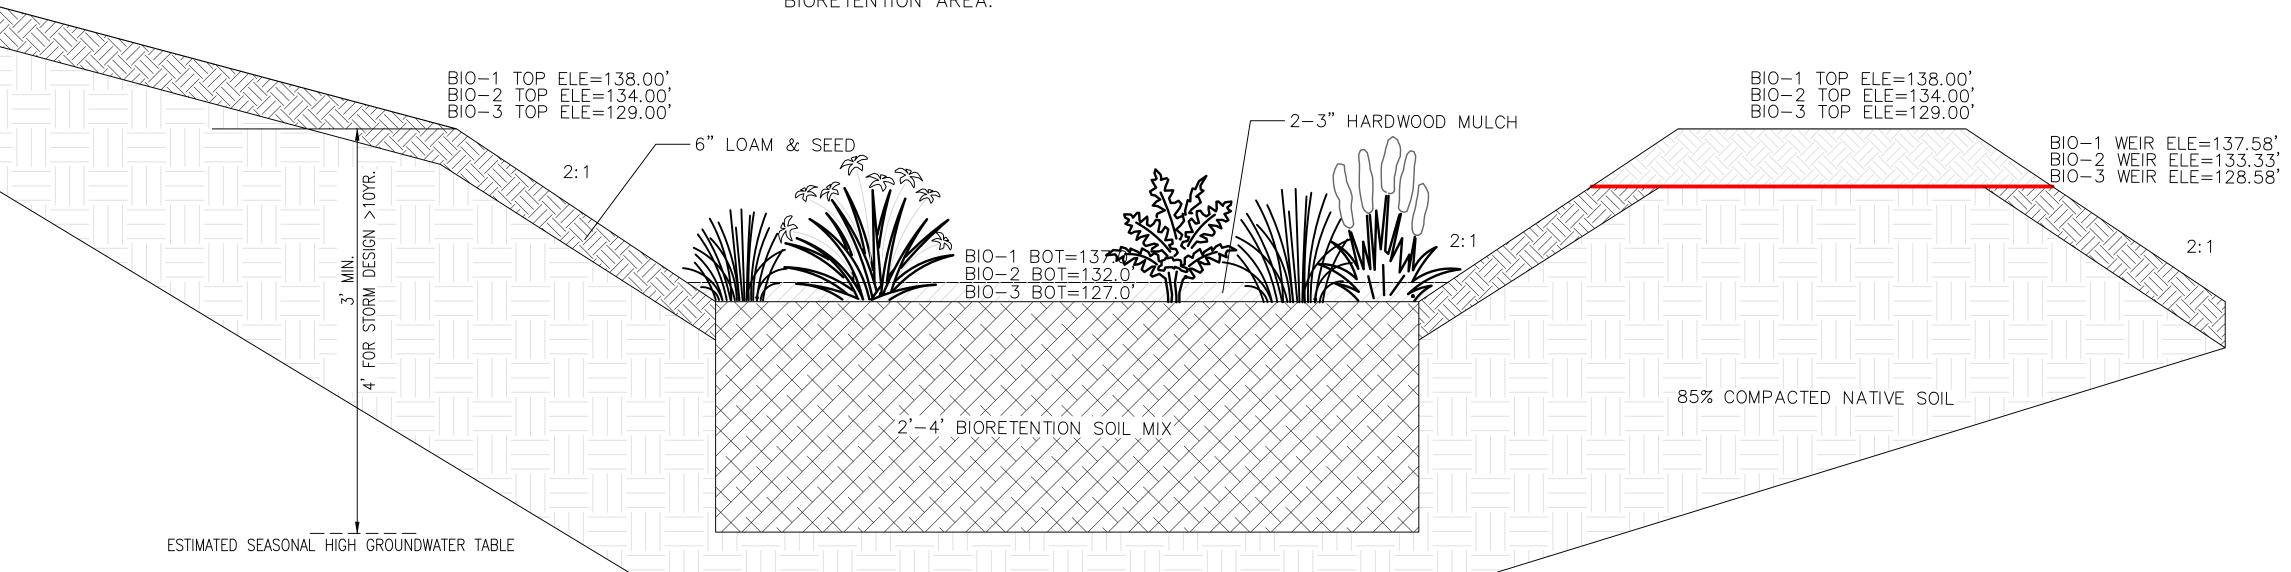

BMP REQUIRED MAINTENANCE:

-GRASS FILTER STRIP

(SLOPE VARIES)

MONTHLY:

INSPECT AND REMOVE ANY TRASH REMOVE ANY INVASIVE SPECIES PLANTS

ANNUALLY:

MULCH- SPRING, AS NEEDED
REPLACE ANY DEAD VEGETATION-SPRING
REMOVE DEAD VEGETATION-FALL OR SPRING
PRUNE-SPRING

AS NEEDED:

REPLACE SOIL MEDIA AND PLANTS WHEN PONDING DOES NOT SUBSIDE WITHIN 72 HRS

(CAREFUL MAINTENANCE SHOULD PROLONG THIS REQUIREMENT)

*ALL PLANT MATERIAL SHALL BE WATERED AND MAINTAINED BY THE OWNER TO ASSURE THAT SUITABLE GROWTH HAS BEEN ESTABLISHED.

BIORETENTION AREA DETAIL

NOT TO SCALE

F.5.2.3 Mulch Layer Specifications.

A finely shredded, well—aged organic hardwood mulch is the preferred accepted mulch; a finely shredded, well—aged organic dark pine mulch may be accepted on a case—by case basis. Bark dust mulches and wood chips will float and move to the perimeter of the bioretention area during a storm event and are not acceptable.

Shredded mulch must be well aged (6—12 months) for acceptance.

Mix approximately ½ the specified mulch layer into the planting soil to a depth of approximately 4 inches to help foster a highly organic surface layer.

NOTES:

- (1) BIORETENTION AREA TO BE PROTECTED FROM CONSTRUCTION TO PREVENT COMPACTION AND SURROUNDED BY COMPOST FILTER SOCK UNTIL UPSLOPE AREAS ARE STABILIZED.
- (2) BIORETENTION DESIGN AND INSTALLATION SHALL CONFORM TO THE STATE OF RHODE ISLAND STORMWATER DESIGN AND INSTALLATION STANDARDS MANUAL (LATEST REVISION).

F.5.2.2 Bioretention Soil

The soil should be a uniform mix, free of stones, stumps, roots or other similar objects larger than two inches. No other materials or substances should be mixed or dumped within the bioretention area that may be harmful to plant growth, or prove a hindrance to the planting or maintenance operations. The bioretention soil should be free of noxious weeds

The bioretention system shall utilize planting soil having a composition as follows: Sand: 85-88%


Soil fines: 8 to 12% (no more than 2% clay)

Organic Matter*: 3 to 5%

*Note: For bioretention applications with a soil depth of less than 4 feet, add 20% (by volume) of well aged (3 months), well aerated, leaf compost (or approved equivalent) to the above planting soil mixture. Where soil fines content is less than 12%, add a corresponding % of leaf compost.


A textural analysis is required to ensure the bioretention soil meets the specification listed above. The bioretention soil should also be tested for the following criteria: pH range 5.2 — 7.0


magnesium not to exceed 32 ppm
phosphorus P205 not to exceed 69 ppm
potassium K20 not to exceed 78 ppm
soluble salts not to exceed 500 ppm

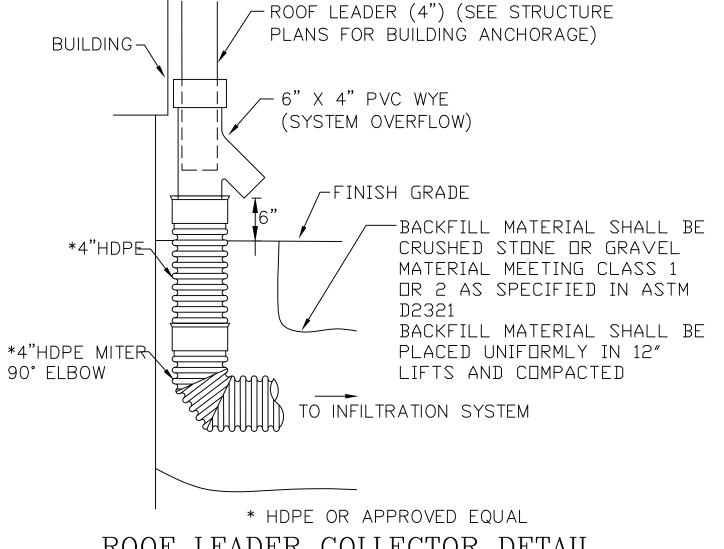

ROOF LEADER COLLECTOR DETAIL

NOT TO SCALE

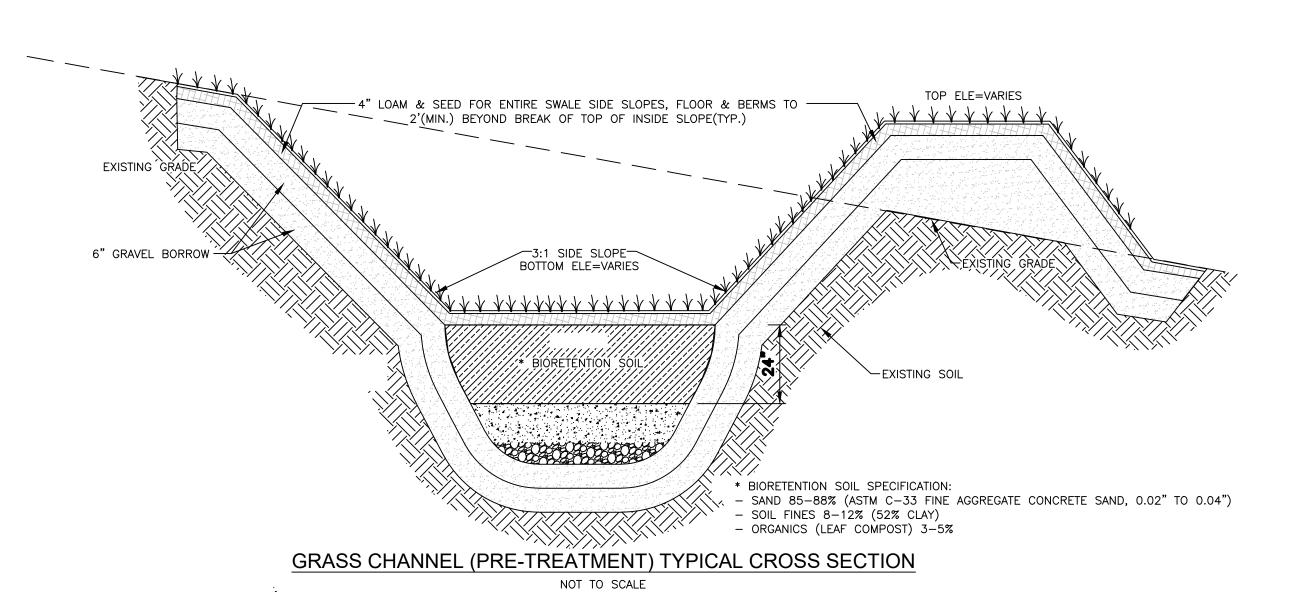

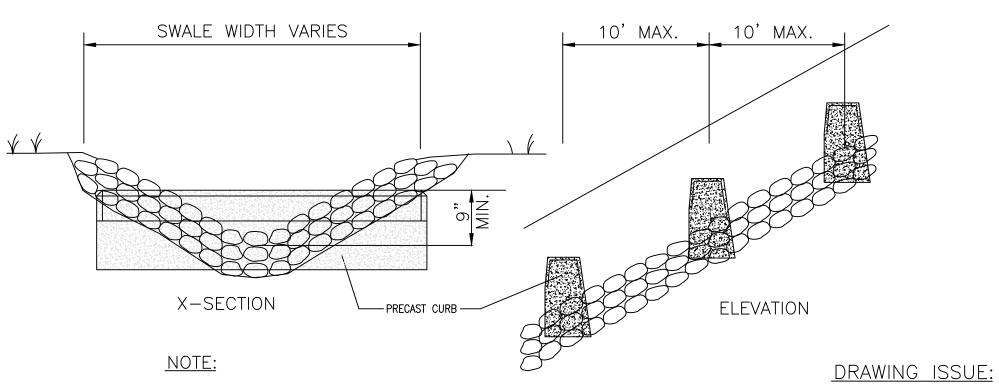

1. PRECAST CONCRETE CURB SHALL BE USED FOR CHECK DAMS WITHIN SWALES WITH SLOPES GREATER THAN 4%. MULTIPLE CURB SECTIONS MAY BE NECESSARY TO SPAN SWALE WIDTH.

CHECK DAM DETAIL

NOT TO SCALE

Thomas J. Principe, III

No. 19107

REGISTERED

PROFESSIONAL ENGINEER

REVISIONS

No. DATE DRWN CHKD

BY:_____DATE:____

PLANNING BOARD SIGNATURE

☐ CONCEPT

X PERMITTING

☐ AS—BUILT

OTHER:

☐ CONSTRUCTION

CUSTOMER APPROVAL

ONLY PLANS ISSUED FOR CONSTRUCTION SHALL BE USED FOR CONSTRUCTION

PRIN
EN

CONTRACTOR ESTABLISHED IN 1981

PRINCIPE COMPANY, INC.

ENGINEERING DIVISION

OWNER/APPLICANT
FAIR WIND
PROPERTIES, LLC

PO BOX 333 BRISTOL, RI 02809

27 SAKONNET RIDGE DRIVE
TIVERTON, RI 02878
401.816.5385

TABLISHED IN 1981
www.PrincipeEngineering.com

DETAILS-5

PRELIMINARY PLAN SUBMISSION
COMPREHENSIVE PERMIT APPLICATION
OF
"FAIR WIND VILLAGE"

A.P. 47 LOT 3
206 BAYVIEW AVENUE
in
BRISTOL, RHODE ISLAND

NOTED SHEET NO: 13 of 14

KAB DESIGN BY: KAB CHECKED BY: TJP


PROJECT NO.: LD-2021-35


D. DATE DRWN CHKD
D. 04/21/25 KAB TJP
D. 8/8/25 KAB TJP


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DRAWN BY: KAB DESIGN


DATE: 03/27/2025




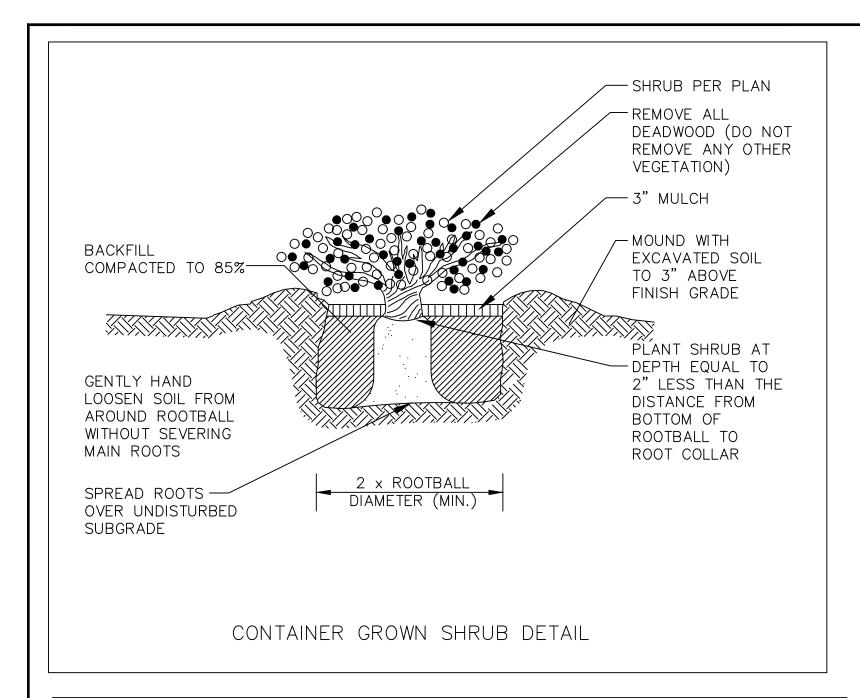

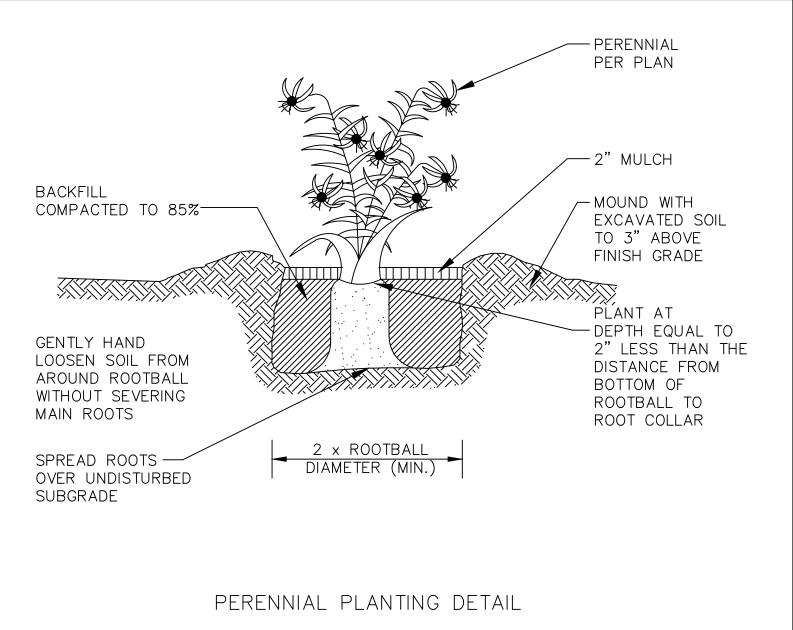

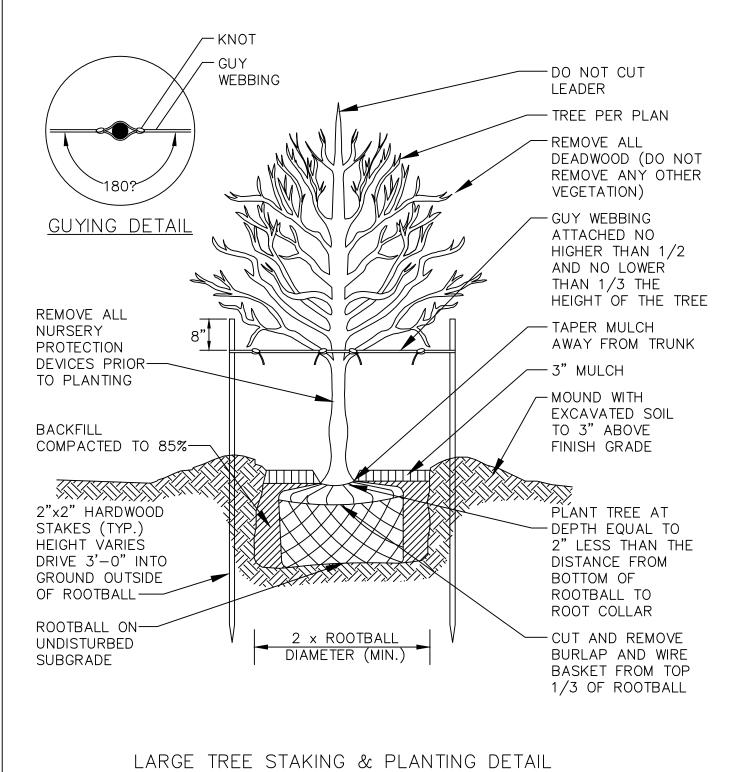(2" CALIPER AND ABOVE)

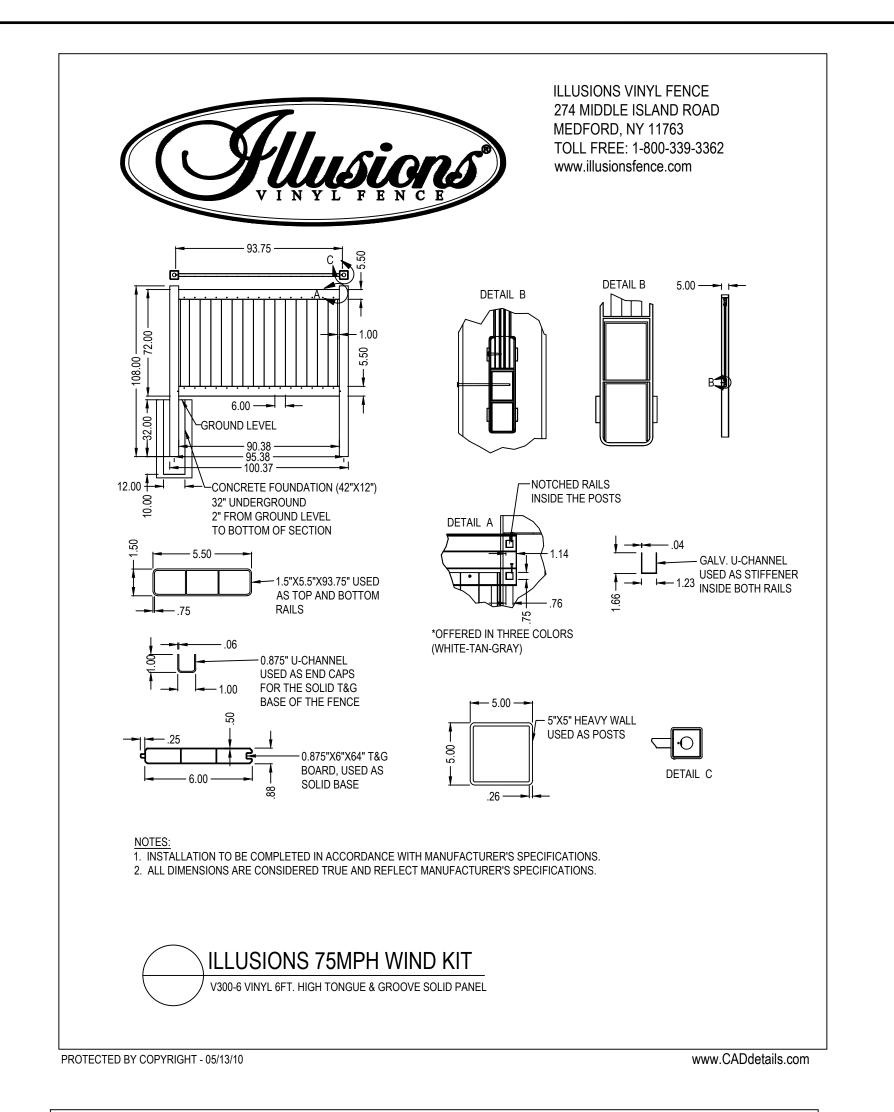

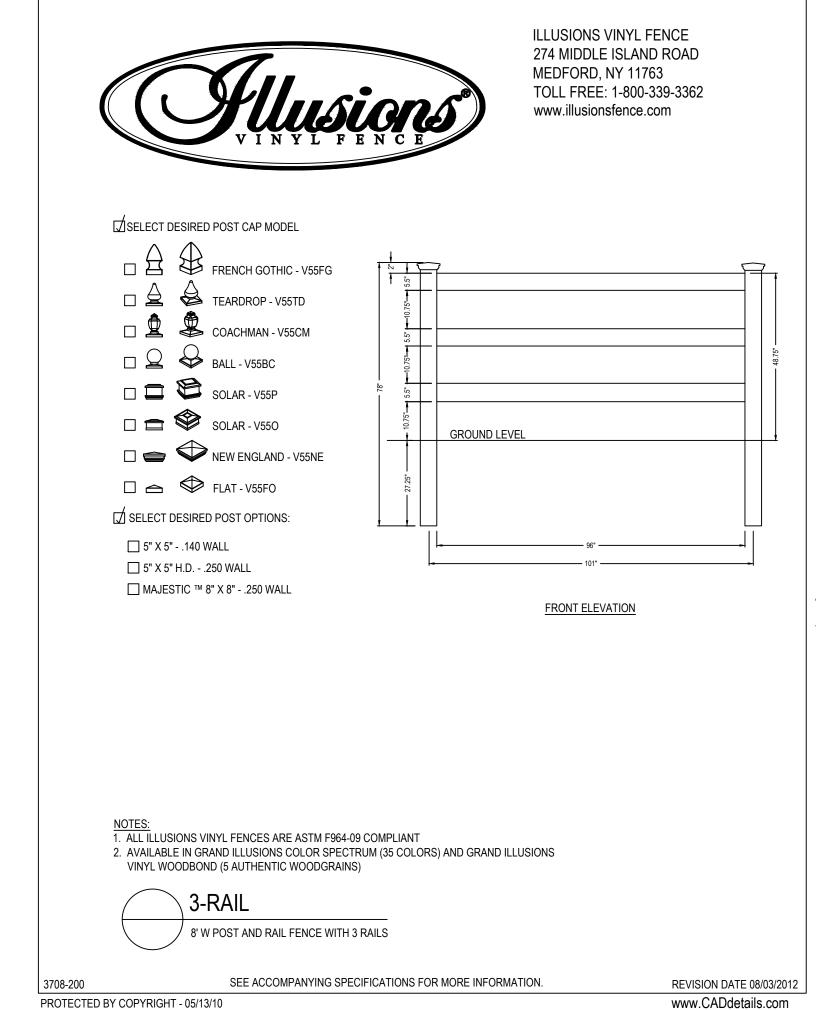

FAIR WIND PROPERTIES, LLC PO BOX 333 BRISTOL, RI 02809



☐ CONCEPT☐ CUSTOMER APPROVAL☐ PERMITTING☐ CONSTRUCTION☐


AS—BUILT
OTHER:

ONLY PLANS ISSUED FOR CONSTRUCTION SHALL BE USED FOR CONSTRUCTION

PLANNING BOARD SIGNATURE

Y'_____DATE:____

DETAILS-6

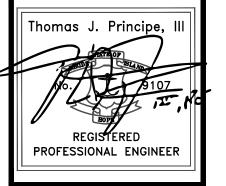



TIVERTON, RI 02878 401.816.5385

ESTABLISHED IN 1981 www.PrincipeEngineering.com

PRELIMINARY PLAN SUBMISSION
FOR A
COMPREHENSIVE PERMIT APPLICATION
OF
"FAIR WIND VILLAGE"
A.P. 47 LOT 3
206 BAYVIEW AVENUE
in
BRISTOL, RHODE ISLAND

SCALE: AS NOTED

SHEET NO: 14 of 14

DRAWN BY: KAB

DESIGN BY: KAB

CHECKED BY: TJP

DATE: 03/27/2025

PROJECT NO.: LD-2021-35

