




YERIFY ALL EXISTING CONDITIONS AND MEASUREMENTS PRIOR TO ORDERING OF MATERIALS AND CONSTRUCTION

NOTES:

ALL NECESSARY ENGINEERING DATA TO BE SUPPLIED BY CONTRACTOR OR OWNER,


ALL ENGINEERED LUMBER OR PREFABRICATED STRUCTURAL MEMBERS (I-JOISTS, LVL SUPPORT BEAMS, ROOF TRUSSES) TO BE ENGINEERED BY MANUFACTURER

VERIFY ROUGH OPENING SIZES, EGRESS REQUIREMENTS AND TEMPERED GLASS REQUIREMENTS PRIOR TO CONSTRUCTION

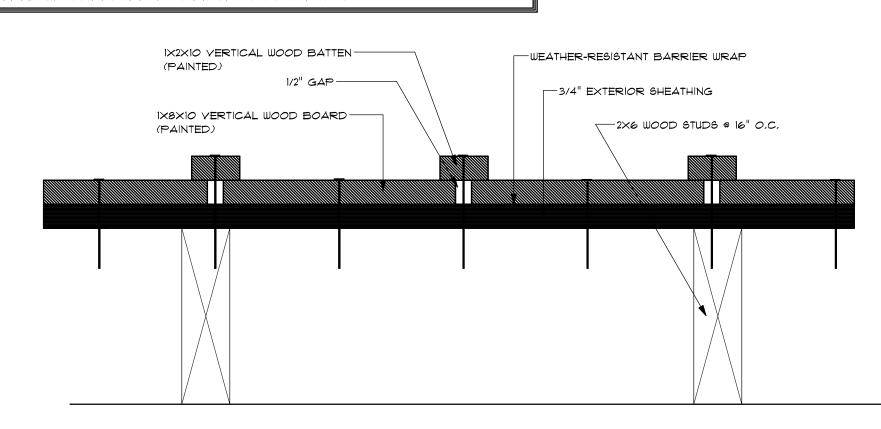

SIDING DETAIL SCALE: NOT TO SCALE



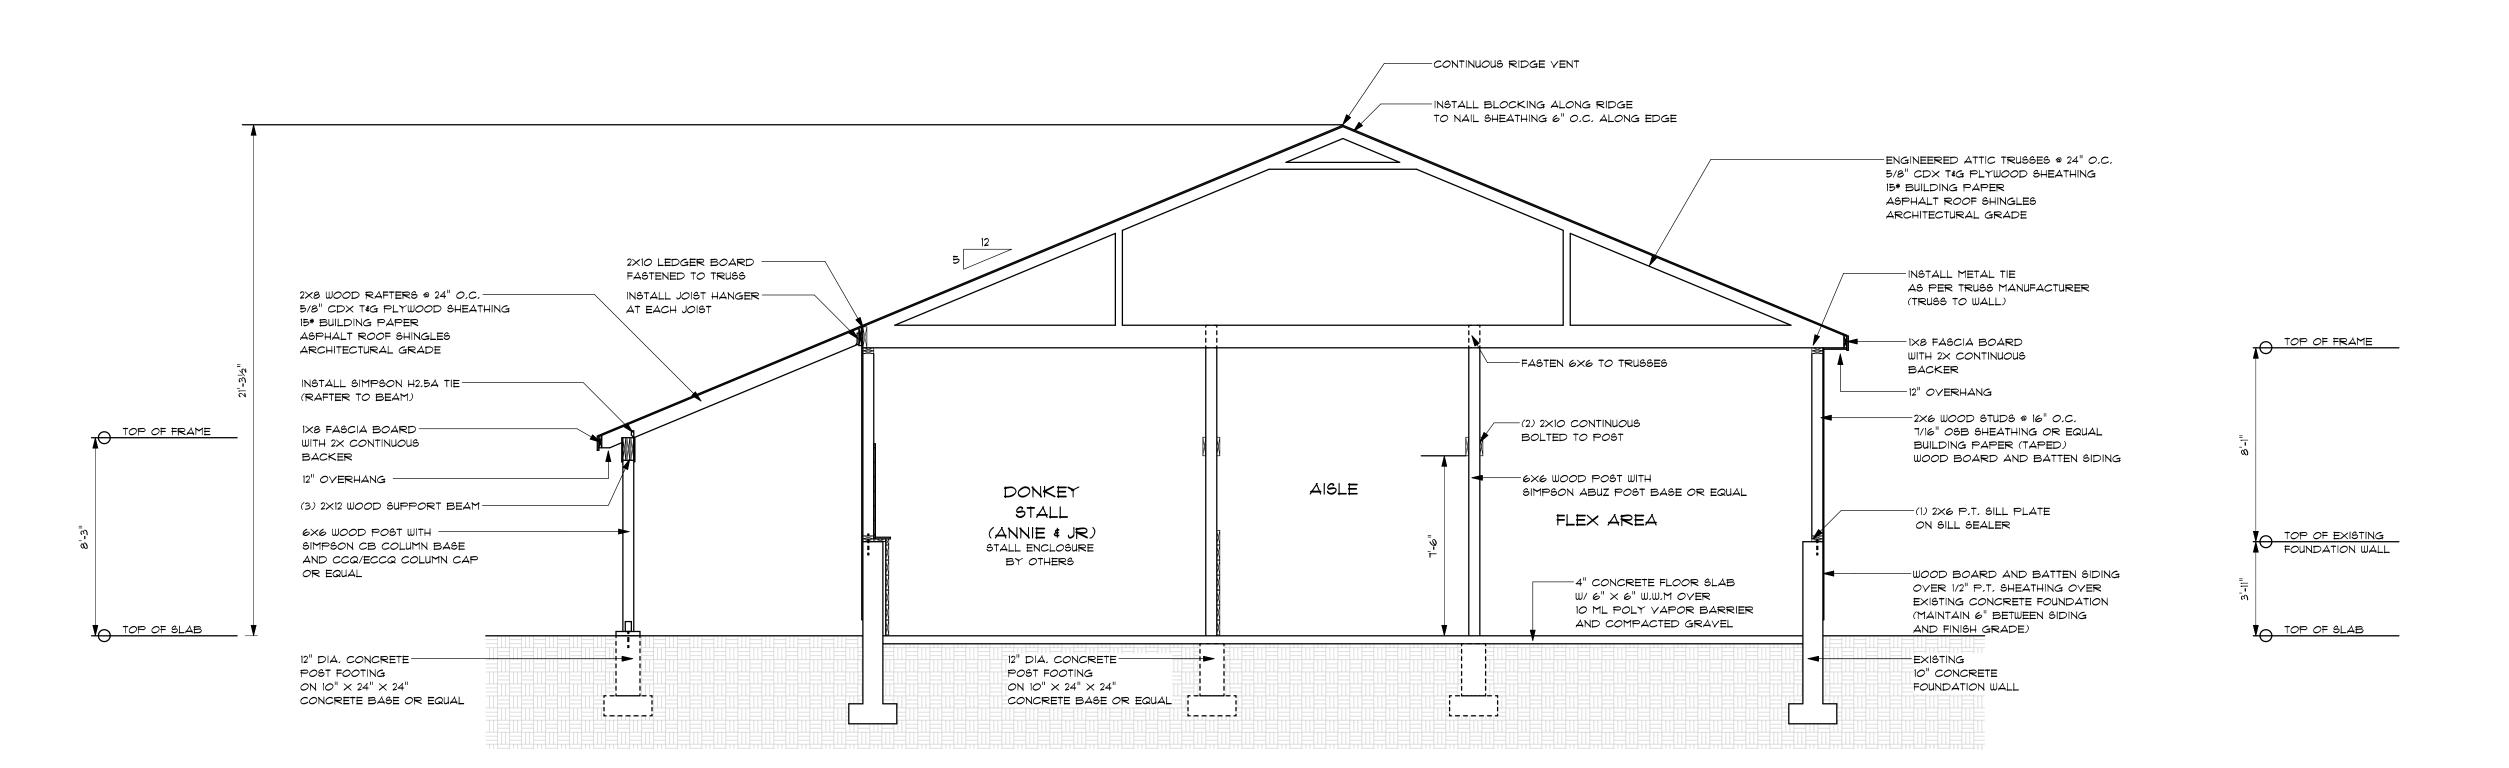

SECTION DETAIL A-2,A

SCALE : 1/4" = 1'-0"

ALL METAL FASTENERS SHALL BE CORROSION RESISTANT THESE PLANS ARE FOR THE CONSTRUCTION OF ONE BUILDING ONLY AND ARE NOT TO BE COPIED IN ANY FORM WITHOUT THE EXPRESS WRITTEN PERMISSION OF CORNERSTONE DESIGN/BUILD SERVICES,IN. ALTHOUGH A LOT OF CARE HAS GONE INTO THE PREPARATION OF THE DRAWINGS TO ENSURE THAT THEY ARE ERROR FREE, IT IS THE RESPONSIBILITY OF THE CONTRACTOR TO CHECK THE DRAWINGS FOR ERRORS OR OMISSIONS AND TO ADAPT THEM TO ANY SITE CONDITIONS, WRITTEN DIMENSIONS ALWAYS HAVE PRECEDENCE OVER SCALED DIMENSIONS.

THE GENERAL CONTRACTOR SHALL NOT SCALE DRAWINGS FOR MEASUREMENTS, BUT SHALL VERIFY AT THE SITE ALL LEVELS AND MEASUREMENTS NECESSARY FOR COMPLETE FABRICATION, ASSEMBLY AND INSTALLATION OF HIS OR HER WORK, MINOR DETAILS OF THE WORK NOT SPECIFICALLY SHOWN ON THE DRAWINGS SHALL BE ASCERTAINED BY THE CONTRACTOR AT THE SITE OF THE WORK, AND SHALL BE ACCOMPLISHED BY HIM WITH THE INTENT OF THIS PROJECT.

REVISIONS

NO. DATE BY CHANGE

T HOPE FARM

PROJECT LOCATION:

250 METACOM AVEN
BRISTOL, RHODE 18L

PROJE



538 WILBUR AYENUE SWANSEA, MASSACHUSETTS 02777 TEL - (508)-679-2500 FAX - (508)-679-2600

CORNERSTONI DESIGN/BUILD SERVICES, INC.

SHEET TITLE:

EXTERIOR ELEVATIONS


DRAWN BY: M. POTOCKI
REVIEWED BY: M. POTOCKI

CSTONE PROJECT *: ----
DATE: 01 MAR 22

SCALE: AS NOTED

DRAWING NO.

A-2

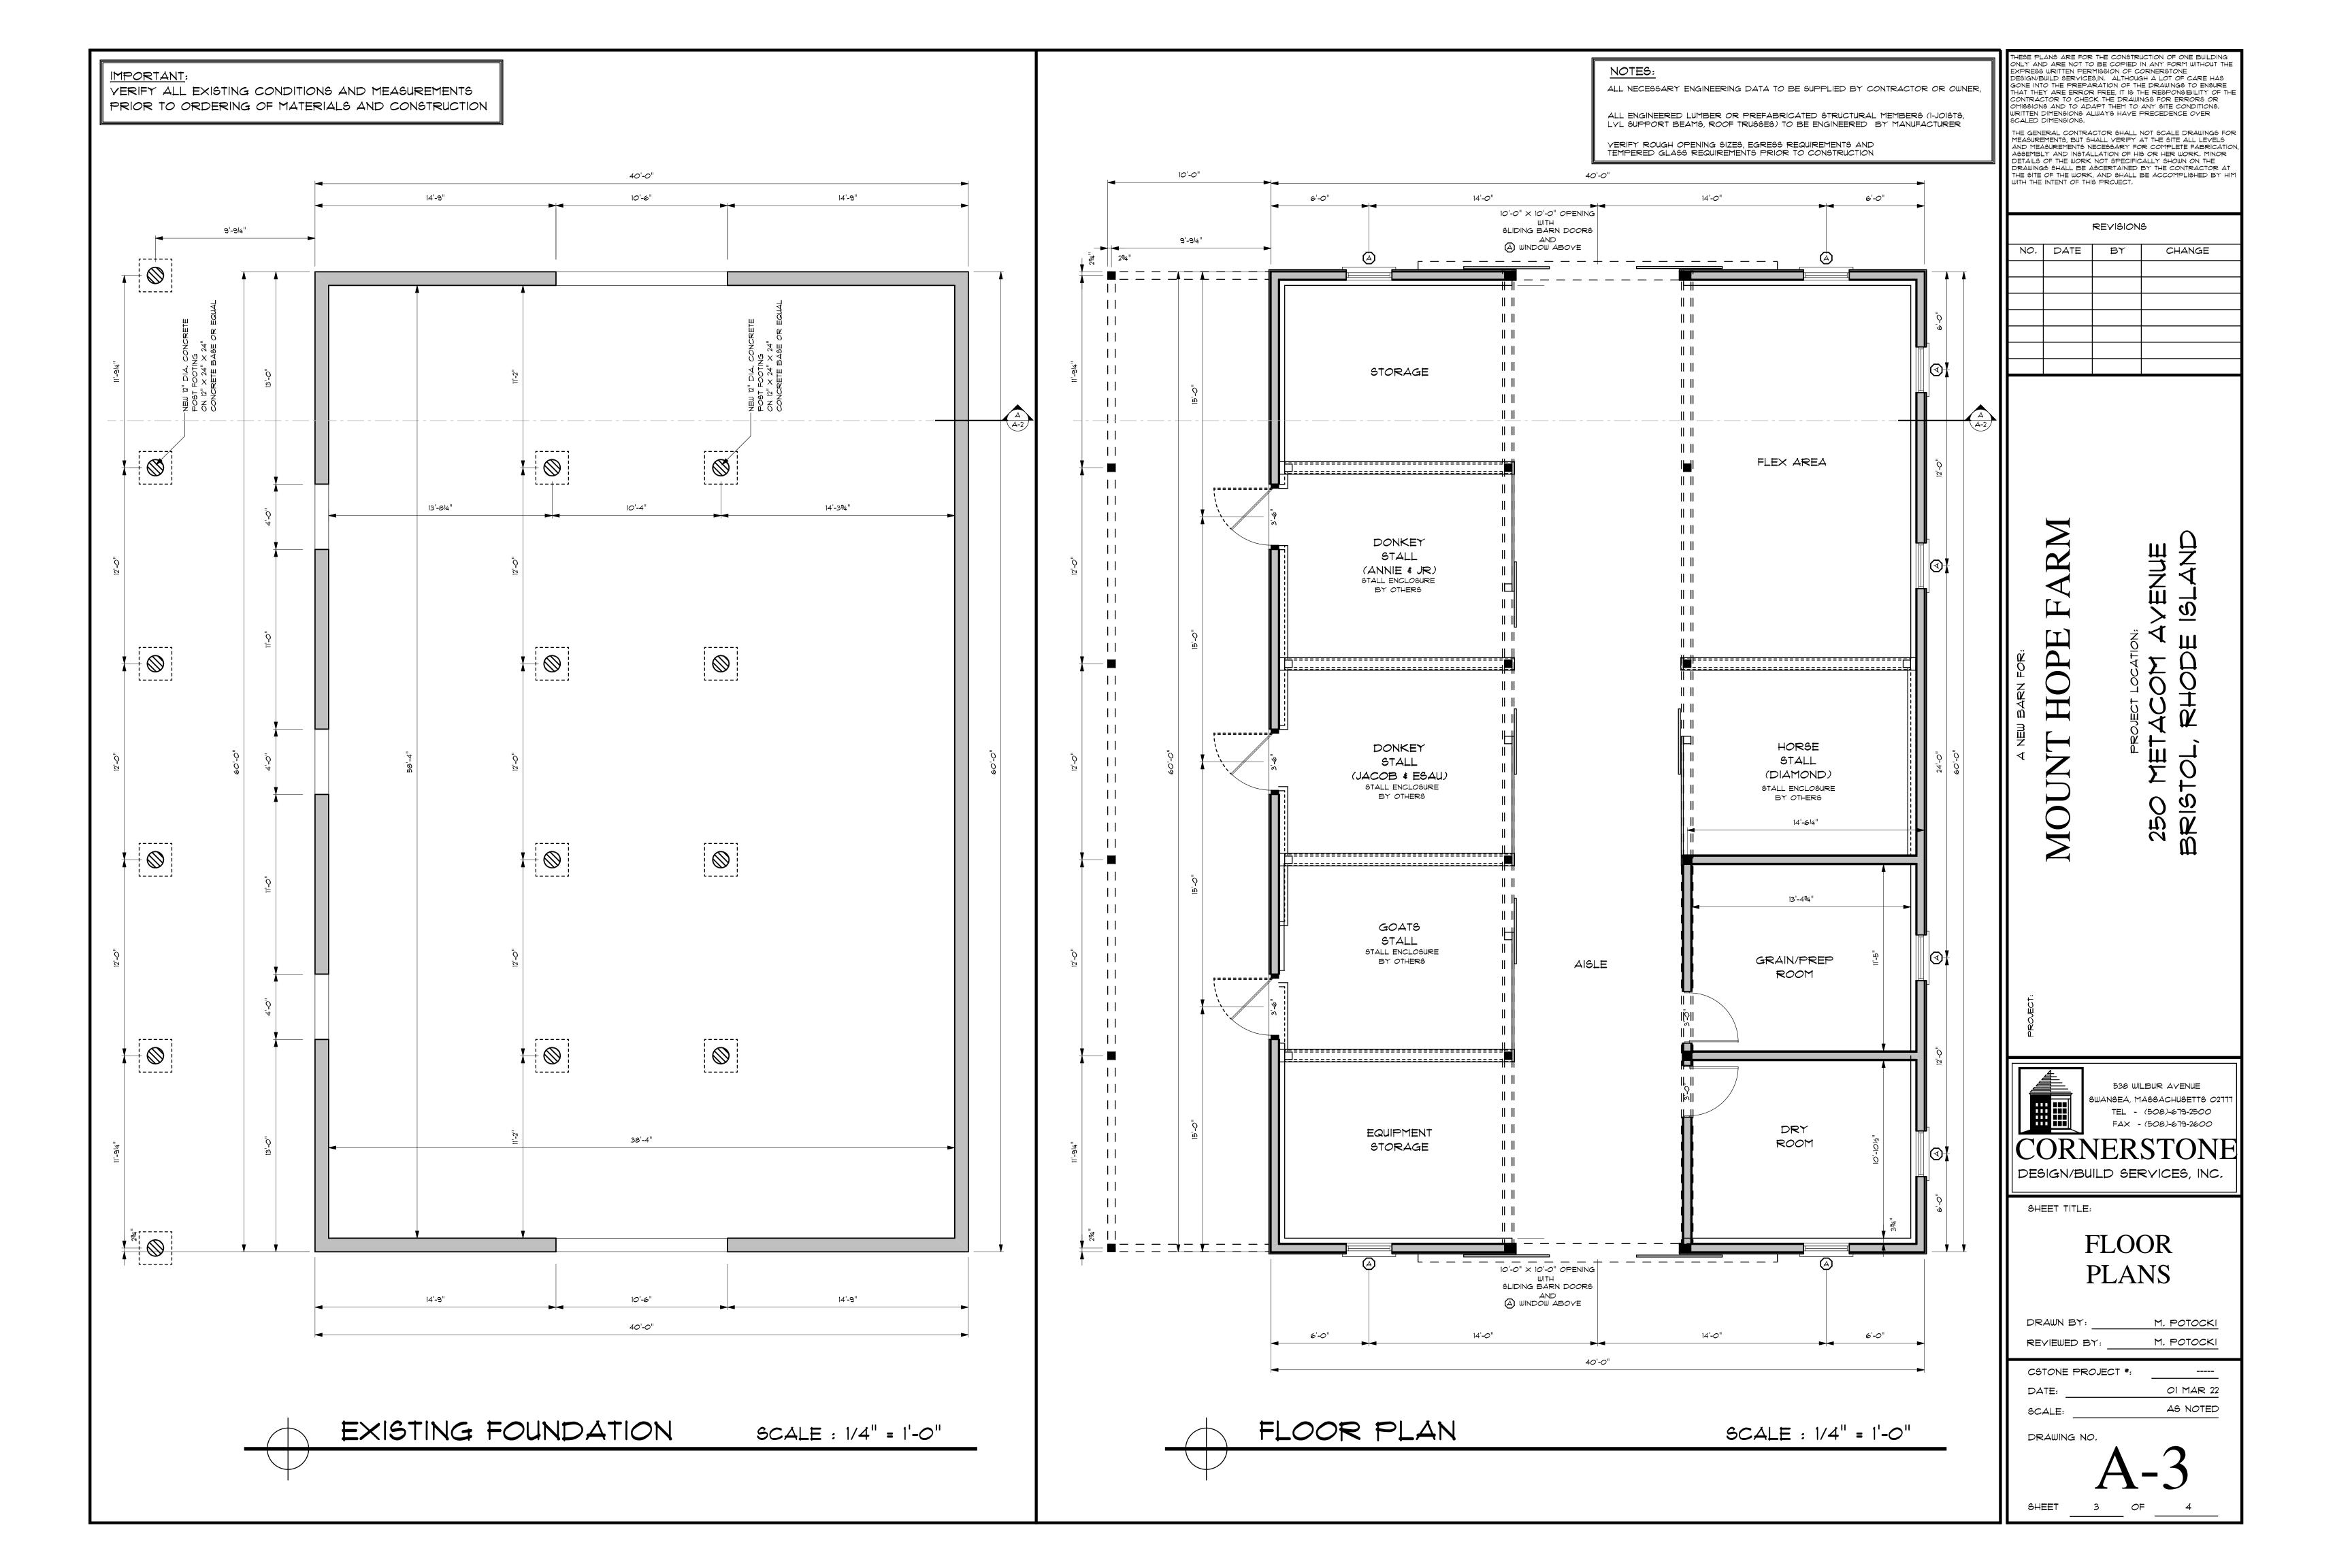

IMPORTANT:

YERIFY ALL EXISTING CONDITIONS AND MEASUREMENTS PRIOR TO ORDERING OF MATERIALS AND CONSTRUCTION

NOTES:

ALL NECESSARY ENGINEERING DATA TO BE SUPPLIED BY CONTRACTOR OR OWNER,

ALL ENGINEERED LUMBER OR PREFABRICATED STRUCTURAL MEMBERS (1-JOISTS, LVL SUPPORT BEAMS, ROOF TRUSSES) TO BE ENGINEERED BY MANUFACTURER

YERIFY ROUGH OPENING SIZES, EGRESS REQUIREMENTS AND TEMPERED GLASS REQUIREMENTS PRIOR TO CONSTRUCTION

> THIS PROJECT SHALL MEET OR EXCEED RISBC-2-2021 RHODE ISLAND STATE ONE AND TWO FAMILY DWELLING BUILDING CODE (EFFECTIVE 2/01/22)

AA202.3 ROOF NAILING, ROOF ATTACHMENT SHALL BE ACCOMPLISHED WITH MINIMUM 8D NAILS AF FOLLOWS:

1. IN THE 4 FOOT PERIMETER EDGE ZONE ALONG THE EDGES: 6" O.C.

2. TO THE INTERMEDIATE SUPPORTS WITHIN THE 4 FOOT PERIMETER EDGE ZONE: 6" O.C. 3. ALONG THE GABLE END WALL OR RAKE: 4" O.C.

4. ALL OTHER AREA: 6" O.C. EDGE: 12" O.C. INTERMEDIATE.

ALL SHEATHING EDGES WITHIN THE 4 FOOT PERIMETER EDGE ZONE SHALL BE BLOCKED WITH 2X3 MINIMUM INCLUDING THE RIDGE LINE AND SOFFIT/ FASCIA AREA, PROVISIONS FOR VENTILATION AIR SHALL BE MAINTAINED.

EXCEPTION: 2X3 INTERMEDIATE BLOCKING CAN BE ELIMINATED PROVIDED ALL SHEATHING IS 5/8" NOMINAL TONGUE AND GROOVE STRUCTURAL PANELS.

AA203,1 WALL SHEATHING, WALL SHEATHING SHALL BE A MINIMUM 7/16" STRUCTURAL PANEL, NAILING

SHALL BE IN ACCORDANCE WITH TABLE R602,3(1) AND THE FOLLOWING I. AT THE TOP PLATE OR PLATES, THE SHEATHING SHALL EXTEND FROM THE TOP OF THE PLATE TO A MINIMUM OF 16" BEYOND THE STUD-TO-BOTTOM OF THE TOP PLATE CONNECTION, A MINIMUM OF 4 NAILS SHALL BE USED AT EACH STUD FASTENING, AND EDGE-NAILED TO EACH PLATE AT

6" O.C. ALTERNATE: PREFABRICATED AND PRE-ENGINEERED CONNECTION STRAPS APPROVED BY THE BUILDING OFFICIAL. 2. IF THE STUDS ARE NOT CONTINUOUS TO THE FOUNDATION PLATE SUCH AS AT AN INTERMEDIATE FLOOR, THE WALL SHEATHING SHALL BE CONTINUOUS AND UNINTERRUPTED FO A DISTANCE OF 16" BEYOND FROM TOP OF BOTTOM WALL PLATE TO 16" BEYOND BOTTOM OF BOTTOM WALL TOP PLATE BELOW, WITH A MINIMUM OF 4 NAILS AT EACH STUD, FIELD-NAILED AT 6" O.C. TO FLOOR JOIST HEADER FRAMING.

ALTERNATE: PREFABRICATED AND PRE-ENGINEERED CONNECTION ANCHORS OR FASTENERS APPROVED BY THE BUILDING OFFICIAL. 3. AT THE BOTTOM OF THE WALL ASSEMBLY TO THE FOUNDATION SILL PLATE, THE WALL SHEATHING SHALL BE CONTINUOUS FROM POINT 16" ABOVE THE TOP OF THE BOTTOM WALL PLATE TO THE BOTTOM OF THE FOUNDATION SILL, WITH A MINIMUM OF 4 NAILS AT EACH STUD, 6" FIELD NAILED AND EDGE NAILED TO THE FOUNDATION SILL PLATE AT 6" O.C. ALTERNATE: PREFABRICATED AND PRE-ENGINEERED CONNECTION ANCHORS OR FASTENERS APPROVED

AA203,2 SHEAR WALLS, A 4' SEGMENT OF WALL SHEATHING SHALL BE DESIGNATED AS A SHEAR WALL AT EACH CORNER OF THE STRUCTURE AT EACH FLOOR, AND NO MORE THAN 24' APART ALONG A WALL LENGTH, THE FOLLOWING ADDITIONAL REQUIREMENTS APPLY:

> 1. NO OPENINGS ARE PERMITTED WITHIN THIS 4' SECTION, EXCEPTION: WINDOW OPENINGS ARE ALLOWED NO CLOSER THAN 2' TO CORNER PROVIDING THE LENGTH OF THAT SHEAR PANEL IS INCREASED TO 8'.

2. ALL EDGES SHALL BE BLOCKED AND NAILED AT 6" O.C., AND FIELD NAILED

AT 6" O.C. 3. STUDS SHALL BE DOUBLED AT EACH END OF THE SHEAR PANEL.

AA203.2.1 EXCEPTIONS:

SHEAR WALL HOLD-DOWNS SHALL NOT BE REQUIRED IN WIND ZONE | OR 11 (100MPH OR 110 MPH) SHEAR WALL ANCHORS SHALL NOT BE REQUIRED PROVIDED 1/2"

ANCHOR BOLTS AT 48" O/C MAX ARE INSTALLED WITH THE TOP OF THE BOLTS ANCHORED THROUGH THE FLOOR SYSTEM TO THE BOTTOM PLATE OF THE EXTERIOR

WALL FRAME FOR THE ENTIRE FOUNDATION PERIMETER.

AA203.3 FOUNDATION ANCHOR BOLTS, ANCHOR BOLTS SHALL

BY THE BUILDING OFFICIAL.


BE INSTALLED IN ACCORDANCE WITH SECTION R403.1.6 AND THE FOLLOWING: 1 + 2 STORY BUILDINGS - ½" @ 48" O.C. OR 5/8" @ 72" O.C.

3 STORY BUILDINGS - ½" @ 24" O.C. OR 5/8" @ 36" O.C.

ALTERNATE: PREFABRICATED AND PRE-ENGINEERED CONNECTIONS IN DESIGN AND QUANTITY

SUFFICIENT TO EQUAL STRENGTH OF ANCHOR BOLT SPECIFICATION ABOVE

EXCEPTION: SEE EXCEPTION #2 TO AA203.2.1 ABOVE

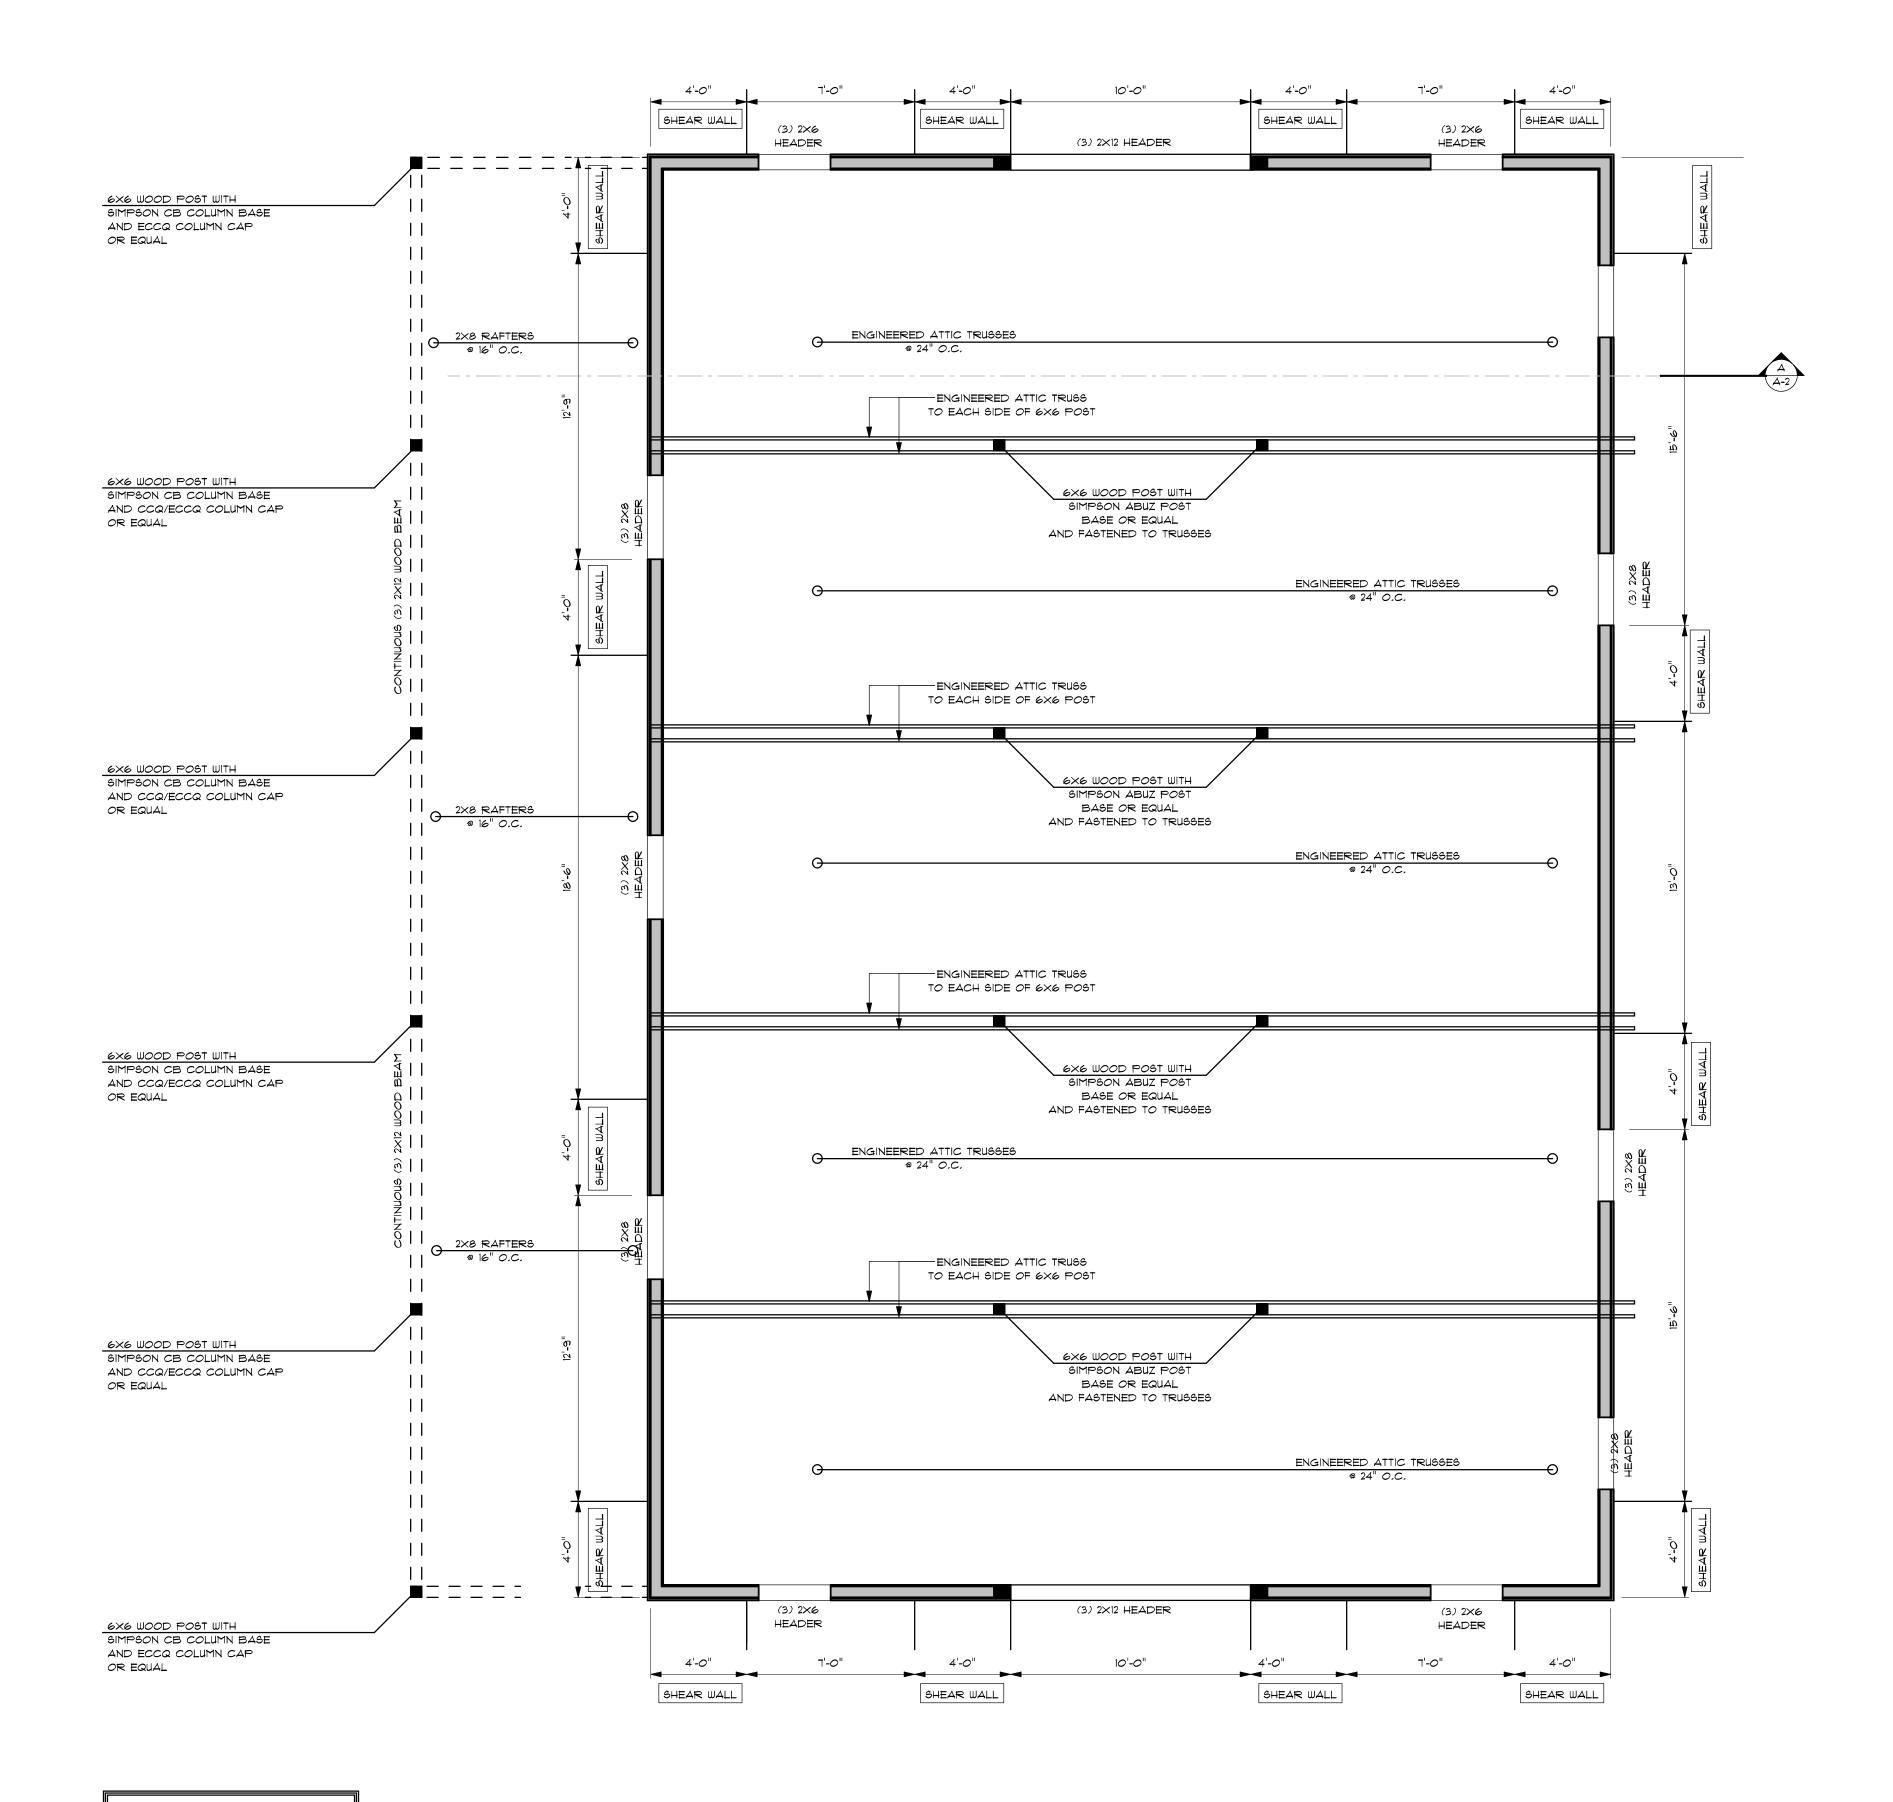

FRAMING PLAN

ALL METAL FASTENERS SHALL BE

CORROSION RESISTANT

SCALE : 1/4" = 1'-0"

HESE PLANS ARE FOR THE CONSTRUCTION OF ONE BUILDING NLY AND ARE NOT TO BE COPIED IN ANY FORM WITHOUT TH XPRESS WRITTEN PERMISSION OF CORNERSTONE DESIGN/BUILD SERVICES,IN. ALTHOUGH A LOT OF CARE HAS GONE INTO THE PREPARATION OF THE DRAWINGS TO ENSURE THAT THEY ARE ERROR FREE, IT IS THE RESPONSIBILITY OF TH CONTRACTOR TO CHECK THE DRAWINGS FOR ERRORS OR MISSIONS AND TO ADAPT THEM TO ANY SITE CONDITIONS. URITTEN DIMENSIONS ALWAYS HAVE PRECEDENCE OVER SCALED DIMENSIONS.

THE GENERAL CONTRACTOR SHALL NOT SCALE DRAWINGS FOR MEASUREMENTS, BUT SHALL VERIFY AT THE SITE ALL LEVELS AND MEASUREMENTS NECESSARY FOR COMPLETE FABRICATION ASSEMBLY AND INSTALLATION OF HIS OR HER WORK, MINOR DETAILS OF THE WORK, NOT SPECIFICALLY SHOWN ON THE DRAWINGS SHALL BE ASCERTAINED BY THE CONTRACTOR AT THE SITE OF THE WORK, AND SHALL BE ACCOMPLISHED BY HIM WITH THE INTENT OF THIS PROJECT.

> REVISIONS BY CHANGE

况 **以**



538 WILBUR AVENUE SWANSEA, MASSACHUSETTS *0*277 TEL - (508)-679-2500 FAX - (508)-679-2600

DESIGN/BUILD SERVICES, INC.

SHEET TITLE:

FRAMING PLAN

M. POTOCKI DRAWN BY: M. POTOCKI REVIEWED BY

CSTONE PROJECT #: 01 MAR 22 AS NOTED

DRAWING NO