CHANGE ORDER NO.: $\underline{4}$

Owner: Engineer:	Town of Bristol Commonwealth Engineers, Inc.	Owner's Project No.: Engineer's Project No.	WW22532001 .: S22145
Liigineer.	commonwealth Engineers, me.	Contractor's Project	322113
Contractor:	Crosby Construction	No.:	24105-01
Project:	WWTP Improvement Project		
Contract Name:	WWTP Improvement Project		
	Effecti	ive Date of Change	
Date Issued:	Order	:	
The Contract is mo	dified as follows upon execution of	f this Change Order:	
Description: <u>Instal</u>	lation of a new manhole at Lift Stat	tion #8 and the NIPSCO-reques	ted adjustment of
the transformer. Lo	ocation onsite.		
	ommendation Letter, Change Orde		d associated
Contractor proposa	al, RFI-39 and associated Contracto	or proposal	
		Change in Contr	
		[State Contract Tim	
Char	ige in Contract Price	a specific date or a nu	umber of days]
Original Contract	Price:	Original Contract Times: Cale	•
		Substantial Completion:	630
\$ 24,293,7	749.0 <u>0</u>	Ready for final payment:	30
		_	
[Increase] [Decrea	ase] from previously approved	[Increase] [Decrease] from pr	eviously approved
Change Orders No	o. 1 to No. 3:	Change Orders No. 1 to No. <u>1</u>	
		Substantial Completion:	90
\$ 261,0	033.70	Ready for final payment:	0
,		_	
Contract Price pri	or to this Change Order:	Contract Times prior to this C	hange Order:
		Substantial Completion:	720
\$ 24,032,7	715.30	Ready for final payment:	30
[Increase] [Decrea	ase] this Change Order:	[Increase] [Decrease] this Cha	inge Order:
		Substantial Completion:	
\$\$ 38,4	121.00	Ready for final payment:	
			
Contract Price inc	orporating this Change Order:	Contract Times with all appro	ved Change Orders:
	. 5		720

24,071,136.30

Ready for final payment: 30

Town of Bristol WWTP Improvements Project Change Order #4

	Recommended by Engineer (if required)		Accepted by Contractor
Ву:	Chong L. Mandrya	By:	Russell Jacobs
Title:	Project Engineer	Title:	Vice President
Date:	6/4/25	Date:	6/4/2025
	Authorized by Owner		Approved by Funding Agency (if applicable)
Ву:		By:	
Title:		Title:	
Date:		Date:	



June 3, 2025

Mike Yoder Town of Bristol 303 E Vistula St Bristol, IN 46507

RE: Job Number S22145

WWTP Improvement Project Proposed Change Order No. 4

Dear Mr. Yoder:

Enclosed, please find the proposed Change Order No. 4 (CO #4) for the Town of Bristol's consideration and approval.

This CO #4 includes a contract price increase of \$38,421.00 and no additional contract time resulting in a new total contract price of \$24,071,136.30 and no additional contract time; this keeps allowed time to overall project substantial completion at 720 days.

Recommendation

We have reviewed the cost items and determined them to be fairly priced. This proposed change order consists of the following items:

- Installation of a new manhole at Lift Station #8
- Relocation of NIPSCO transformer

Further details can be found in the attached memorandum. We recommend acceptance of this change order. The table below provides a summary of components included within this change order:

Description	Cost Change	Time Extension (Days)	Summary Notes					
Lift Station #8 Additional Manhole	\$11,391.75	0	The existing concrete wet well at Lift Station #8 is not suitable for reuse as originally planned to route flow to the new LS. Instead, a new manhole will be installed in place of the existing lift station and a new sewer will be constructed to a new doghouse manhole over the flow from the east.					
NIPSCO Transformer Relocation	27,029.25	0	NIPSCO would like to relocate the transformer to the west due to primary routing and accessibility issues.					
Total:	\$38,421.00	0						

If you have any questions, please feel free to contact us.

Sincerely,

COMMONWEALTH ENGINEERS, INC.

Amy Mendoza, P.E.

any L. Merdye



CHANGE ORDER SUMMARY MEMORANDUM

100 East Wayne St., Suite 315 South Bend, IN 46601 PH: (574) 800-7177

DATE: June 2, 2025

SUBJECT: Wastewater Treatment Plant Improvements

Work Item Breakdown for Change Order No. 4

Change Order No. 4 for this project includes a cost increase associated with the installation of a new doghouse manhole at Lift Station #8 and costs associated with the power company's requested adjustment of the transformer location. The Engineer has reviewed the costs submitted by the Contractor and considers them fair. No change to the Contract duration is associated with this change order.

The attached request for change includes the resulting increase associated with the items described below.

1) Lift Station #8 Additional Manhole

Originally, the Engineer planned to use the existing Lift Station #8 structure as a flow-through structure. During construction, the Contractor notified the Engineer that the condition of the existing concrete at Lift Station #8 is poor, and the wet well is not suitable for reuse. To resolve this issue, a doghouse manhole will be installed to the east of the existing lift station to facilitate the final connection to the new lift station once the start-up has been completed. The cost for this change is considered already included in the contract. A new manhole will be constructed in place of the existing lift station to route flows from the west to the new doghouse manhole. The cost of this additional manhole is outside the current scope of the contract. The existing lift station will be completely removed and replaced with the new manhole. The total cost for this item is \$11,391.75

2) NIPSCO Transformer Relocation

After a meeting between NIPSCO, the power utility company, and D&D Electric, the electrical Subcontractor, NIPSCO indicated that due to primary routing and accessibility issues, they do not want the transformer located as shown in the original drawings. NIPSCO would like to relocate the transformer to the west, which will incur additional costs

for increasing the length of conduit and wire to the secondary feeders. The total cost for this item is \$27,029.25.

The table below provides a summary of components included within this change order:

Description	Cost Change	Adjustment in Contract Time (Calendar Days)
Lift Station #8 Doghouse Manhole	\$11,391.75	0
NIPSCO Transformer Relocation	\$27,029.25	0
Total:	\$38,421.00	0





Commonwealth Engineers 7256 Company Drive Indianapolis, Indiana 46237 P: (317) 888-1177 F: (317) 887-8641 Project: S22145 Bristol - Wastewater Treatment
Plant Improvements

Bristol, Indiana 46507

RFI #RFI-35: Lift Station #3

Status Closed on 06/02/25

To Darren Wells (Commonwealth Engineers, Inc. -

North) (Response Required)

Amy Mendoza (Commonwealth Engineers Inc.

(CP))

From Russell Jacobs (Robert E. Crosby)

2805 Freeman Street?Fort Wayne

Fort Watne, Indiana 46802

Date InitiatedApr 15, 2025Due DateJun 4, 2025

Location Project Stage Course of Construction

Cost Impact TBD Schedule Impact TBD

Spec Section Cost Code

Drawing Number Reference

Linked Drawings

Received From Russell Jacobs (Robert E. Crosby)

Copies To Jeff Carlson (Commonwealth Engineers, Inc. -

North), Baylee Girdham (Commonwealth Engineers Inc. - South Bend), Russell Jacobs (Robert E. Crosby), Zack Lambert (Commonwealth Engineers Inc. (CP)), Dan Lauer (Robert E. Crosby), Chris Markley (Robert E. Crosby), Mike Mattingly (Robert E. Crosby), Amy Mendoza (Commonwealth Engineers Inc. (CP)), Luke Parrish (Robert E. Crosby), Cody Powers (Commonwealth Engineers Inc. - South Bend), Ron Severns (Commonwealth

Engineers Inc. (Indy)), Darren Wells (Commonwealth Engineers, Inc. - North)

Activity

Question

Question from Russell Jacobs Robert E. Crosby on Tuesday, Apr 15, 2025 at 11:33 AM EDT

The condition of the existing concrete at the lift station #8 is poor and wanted to discuss installing a doghouse manhole instead of using the wet well. This would be the same as we are doing on lift station #3. For Niblock to core into the North side of the wet well, we would have the control panel and electric service completely exposed. Our proposal is to install a doghouse manhole to the East of the existing lift station to make the final connection once the start-up has been completed. We would also connect the West leg to the new doghouse manhole instead of converting the lift station into a manhole. All existing lift station components would be removed and the structure filled in the same manner as lift station #3. My plan is submit a drawing sent today so we can move forward once we have approval. I have attached a drawing to show our plan.

Attachments

Updated doghouse manhole at LS#8.pdf

Official Response

Response from Amy Mendoza Commonwealth Engineers Inc. (CP) on Monday, Jun 2, 2025 at 11:18 AM EDT

The pricing for the MH at LS 8 has been reviewed with Owner and will be included in next combined CO.

Official Response

Response from Russell Jacobs Robert E. Crosby on Wednesday, May 28, 2025 at 08:43 AM EDT

See attached pricing associated with the Doghouse manhole at LS #3

Attachments

RFI 35 LS #3 Dog House Structure Pricing 52825.pdf

Official Response

Response from Amy Mendoza Commonwealth Engineers Inc. (CP) on Monday, Apr 28, 2025 at 10:19 AM EDT

The Engineer and Town are amenable to the proposed revision to construct a new doghouse manhole over the sewer to the east, then run the new gravity sewer line to the new LS from there. However, based on the record drawings available, it appears the sewer to the west is at an angle that is not coming directly to the new doghouse manhole. A new standard manhole in the place of the existing lift station (or west of it) is required as part of this revision and then route the flows from the west to the new doghouse manhole via a new 8-inch sewer. The west side of the pipe from the east shall be plugged from within the doghouse structure, then cut and capped outside of the manhole, filled with grout, and abandoned between the new doghouse structure and the existing LS. See attached revised plan sheets. Note, inverts shown for the west and east lines are based on existing record drawings. Contractor to confirm depth of these prior to ordering structures.

Contractor submitted doghouse MH submittal; comments in last page of attached pdf. Revise and resubmit. Contractor to clarify what measured depth is of existing line from east (is submitted here 0.65' lower than old As Builts suggest). As submitted, the new invert to the north does not provide enough drop to maintain planned invert into new LS 8 (planned for 759.64). If invert out must be 759.62 as submitted, provide adjusted invert at new LS.

Other comments:

- Per WM 9, All exterior manhole joints shall have a joint collar equal to MacWrap Exterior Joint Sealer, RUBR-NEK External Joint Wrap, or equal. Collar shall be a minimum of 9" wide.
- Crystalline waterproofing required for all precast MHs. Does not appear that Conshield meets definition of crystalline waterproofing.

Attachments

LS 8 MARKUP DHMH 4.28.25.pdf

All Replies

Response from Amy Mendoza Commonwealth Engineers Inc. (CP) on Monday, Jun 2, 2025 at 11:18 AM EDT

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Attachments

LS 8 MARKUP DHMH 4.28.25.pdf

5/28/2025	Description: RFI #35 Doghouse manhole LS #3 Job: 24105																	
Description	Qnty.	В	Н	L	TOT.	UM	Crew	МН	UM	UPL	Labor	UPM	Materials	UP JE	Job Exp.	UPS	Subcontracts	Totals
Project Manager							PM	1	HR	\$ 225	225							225
Site Supervision / As-Builts											0							0
Layout / As-Builts											0							0
Tools / Equipment											0							0
Dumpster / Cleanup											0							0
Mobilization											0							0
Temp. Utilities / Fuel											0							0
Winter Protection											0							0
Testing											0							0
<u> </u>											0		0					0
Niblock	1										0		0				10500	10500
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Subtotal											225		0		0		10500	10725
Sucontractor Bond										,						0	0	0
Sales Tax (If YES, Tax General Condition	s ONLY)									Tax	Exempt (YE	S or NO):	YES		>	7%	0	0
Project Insurance														•		0	0	0
Builders Risk																	0	0
Job Bond																1%	108	108
Architectural																0%	0	0
Sub Total											225		0		0		10608	10833
OverHead & Profit															&M Columns		34	34
OverHead & Profit															actor Column		525	525
Total Job											225		0		0		11167	\$11,391.75



RFI #35 @ LS3

5/27/2025

• ADD 1 each 48" Manhole

• ADD 20 lft 8" Sewer Pipe

Pricing Breakdown

Material \$4,704.80


Labor \$3,176.60


Equipment <u>\$2,618.60</u>

Total Additional Cost \$10,500.00

Kevin Crouch

Project Manager

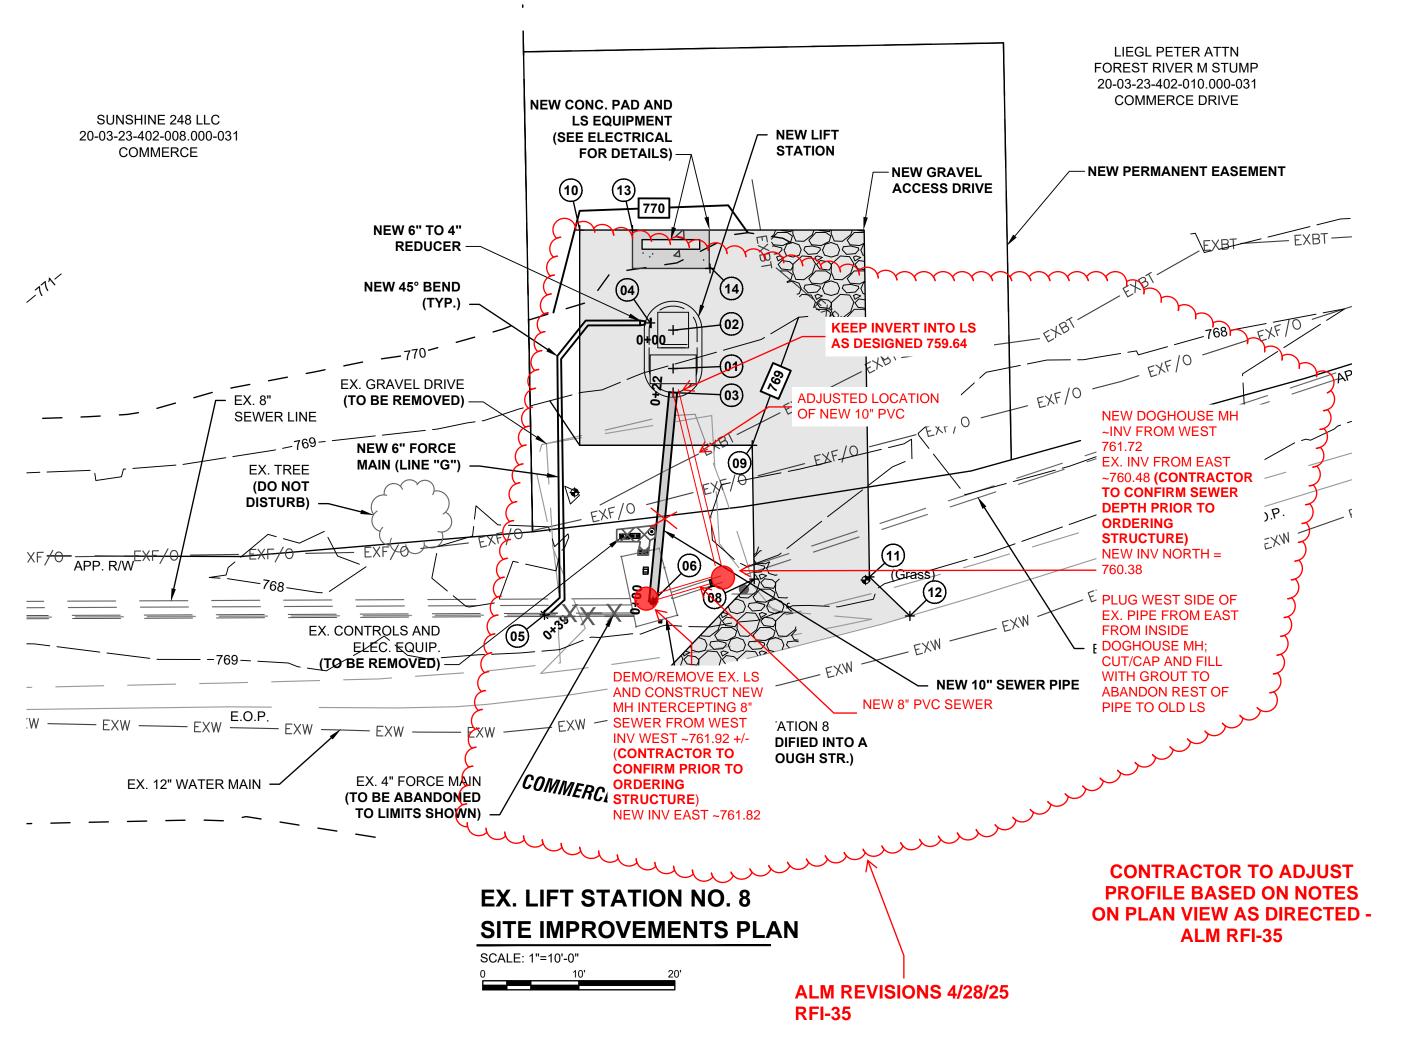

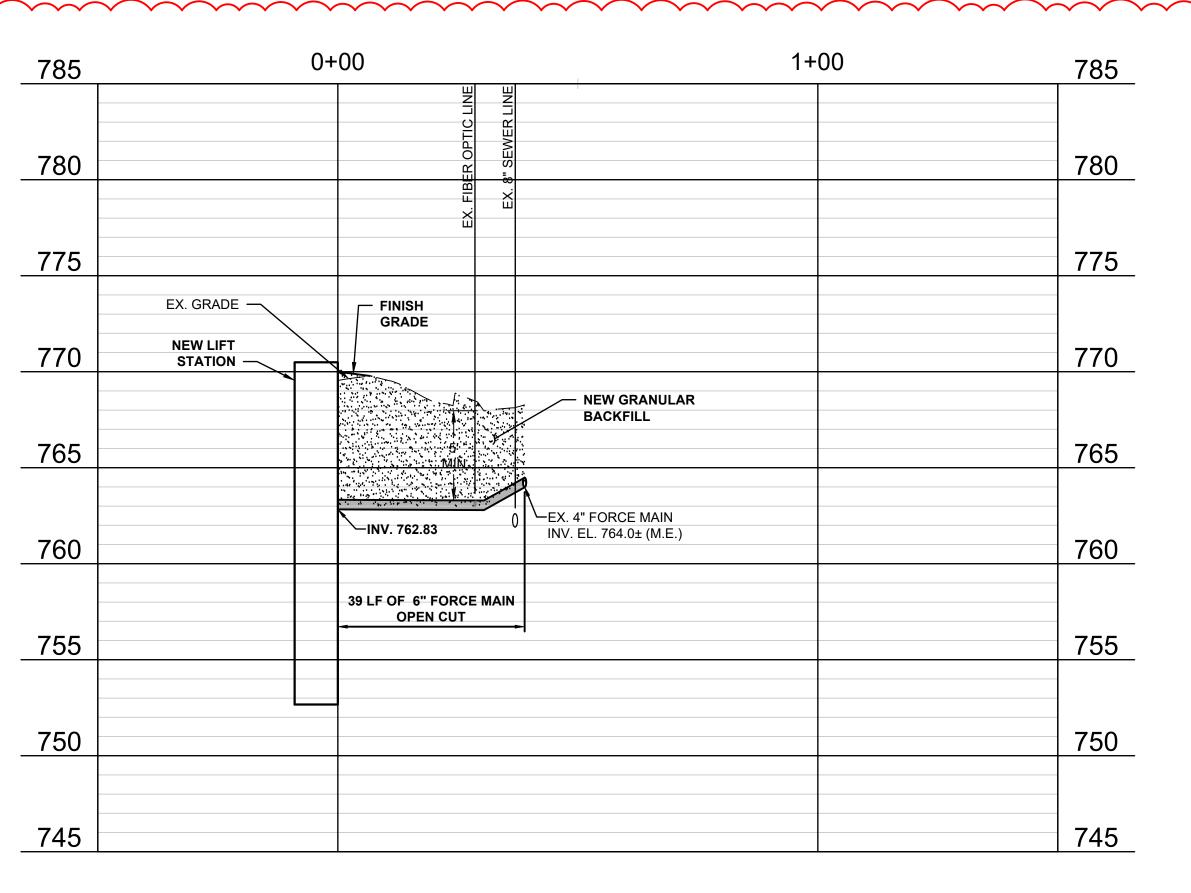


PROFILE - LINE "G"

- 1. CONTRACTOR SHALL PROTECT/ SECURE CONSTRUCTION SITE PERIMETER FROM PUBLIC ACCESSIBILITY AT ALL TIMES.
- 2. INSTALL EROSION CONTROL PRIOR TO ANY GROUND DISTURBING ACTIVITY IN ACCORDANCE WITH INDIANA STORM WATER CONTROL CONCEPT AND DETAILS.
- 3. CONTRACTOR SHALL OBTAIN COUNTY R/W PERMITTING PRIOR TO STARTING WORK ACTIVITY.
- 4. TRAFFIC SHALL NOT BE RESTRICTED WHEN PERFORMING WORK. FOLLOW SIGNING REQUIREMENTS ON SHEET MOTXX. IF ONE LANE OF TRAFFIC REQUIRES BRIEF INTERRUPTION, IT SHALL BE DONE DURING OFF PEAK TRAFFIC PERIODS AND UTILIZING THE FLAGGING REQUIREMENTS OF THE IMUTCD, CURRENT EDITION.

MANDATORY ALTERNATES

- MA1 LIFT STATION 1 REPLACEMENT
- MA2 LIFT STATION 3 REPLACEMENT
- MA3 LIFT STATION 8 REPLACEMENT
- MA4 LIFT STATION 10 UPGRADES
- MA5 LIFT STATIONS SYSTEM-WIDE SCADA **UPGRADES (PER SHEET E9-7)**

	SITE LOCATION COORDI	NATES	
POINT NO.	DESCRIPTION	NORTHING	EASTING
01	WETWELL CENTER	2360833.19	291221.46
02	VALVE VAULT CENTER	2360837.19	291221.46
03	WETWELL INFLUENT	2360830.69	291221.46
04	VALVE VAULT EFFLUENT	2360837.94	291219.07
05	FORCEMAIN CONNECTION	2360807.52	291208.06
06	EX. LIFT STN 8 NEW EFFLUENT	2360808.92	291219.36
07	NEW GRAVEL ACCESS DRIVE CORNER	2360800.65	291219.74
08	NEW GRAVEL ACCESS DRIVE CORNER	2360811.25	291229.91
09	NEW GRAVEL ACCESS DRIVE CORNER	2360825.19	291229.69
10	NEW GRAVEL ACCESS DRIVE CORNER	2360847.61	291211.72
11	NEW GRAVEL ACCESS DRIVE CORNER	2360811.48	291241.90
12	NEW GRAVEL ACCESS DRIVE CORNER	2360807.42	291246.12
13	NEW CONC. PAD NEW CORNER	2360847.61	291217.22
14	NEW CONC. PAD SE CORNER	2360843.61	291225.30

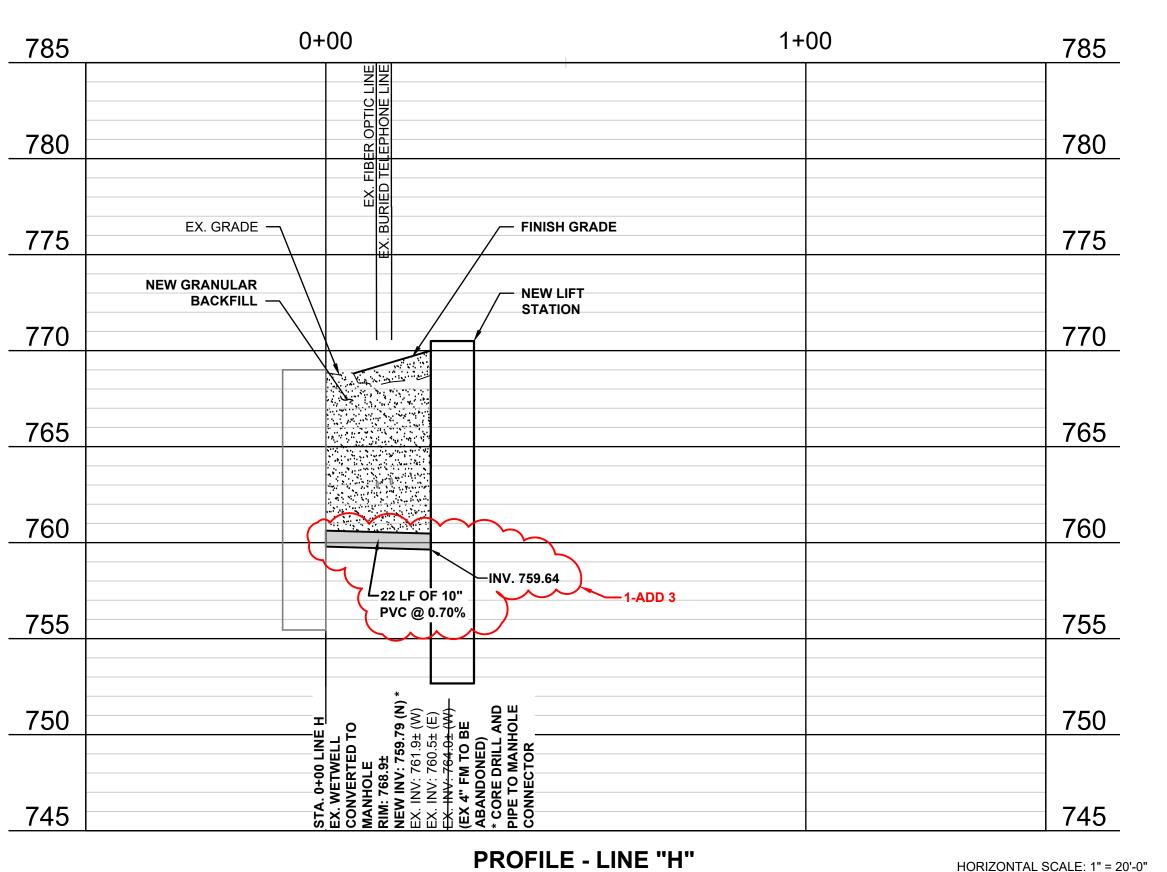

CONFORMED SET DATE: 06/2024

HORIZONTAL SCALE: 1" = 20'-0"

Drawing No:

Designed By: Drawn By: Checked By

JAJ ssue Date: Project No: Scale: 12/21/2023 | S22145 | AS SHOWN

EXISTING LIFT STATION NO 8. SITE **IMPROVEMENTS PLAN** (MA3)


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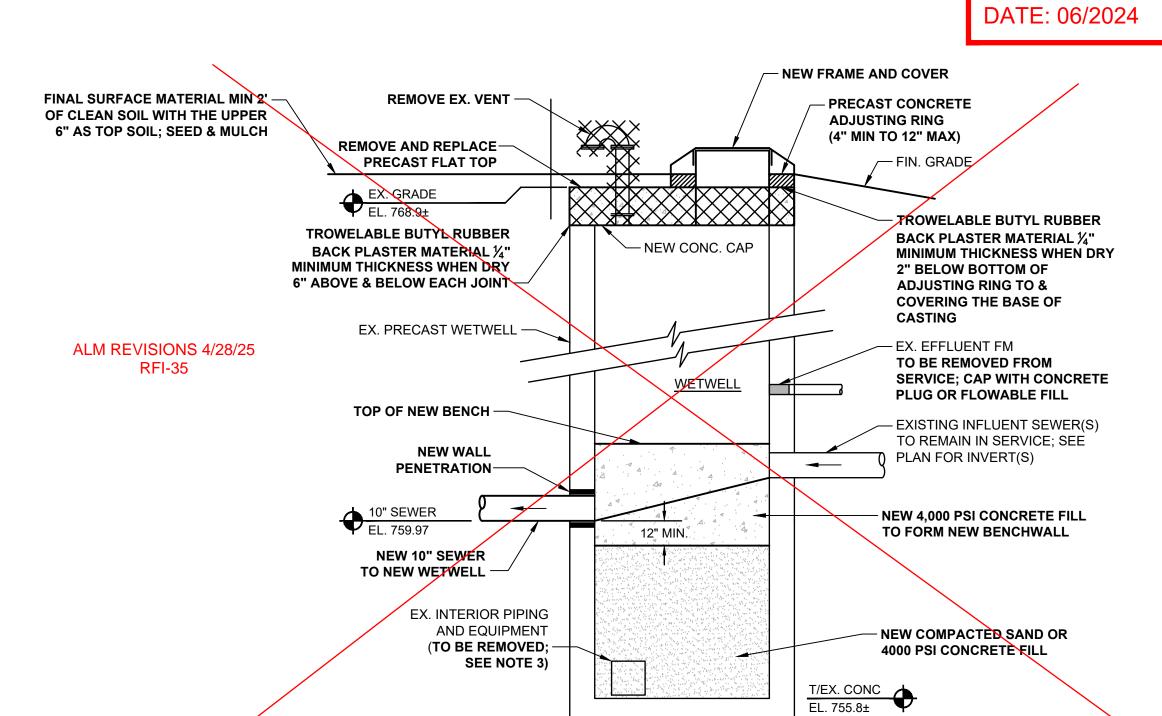
TOWN OF BRISTOL
ELKHART COUNTY, INDIANA
WASTEWATER TREATMENT
PLANT IMPROVEMENTS
PROJECT

Date

D9-06 Sheet: 75 OF 216

DSW



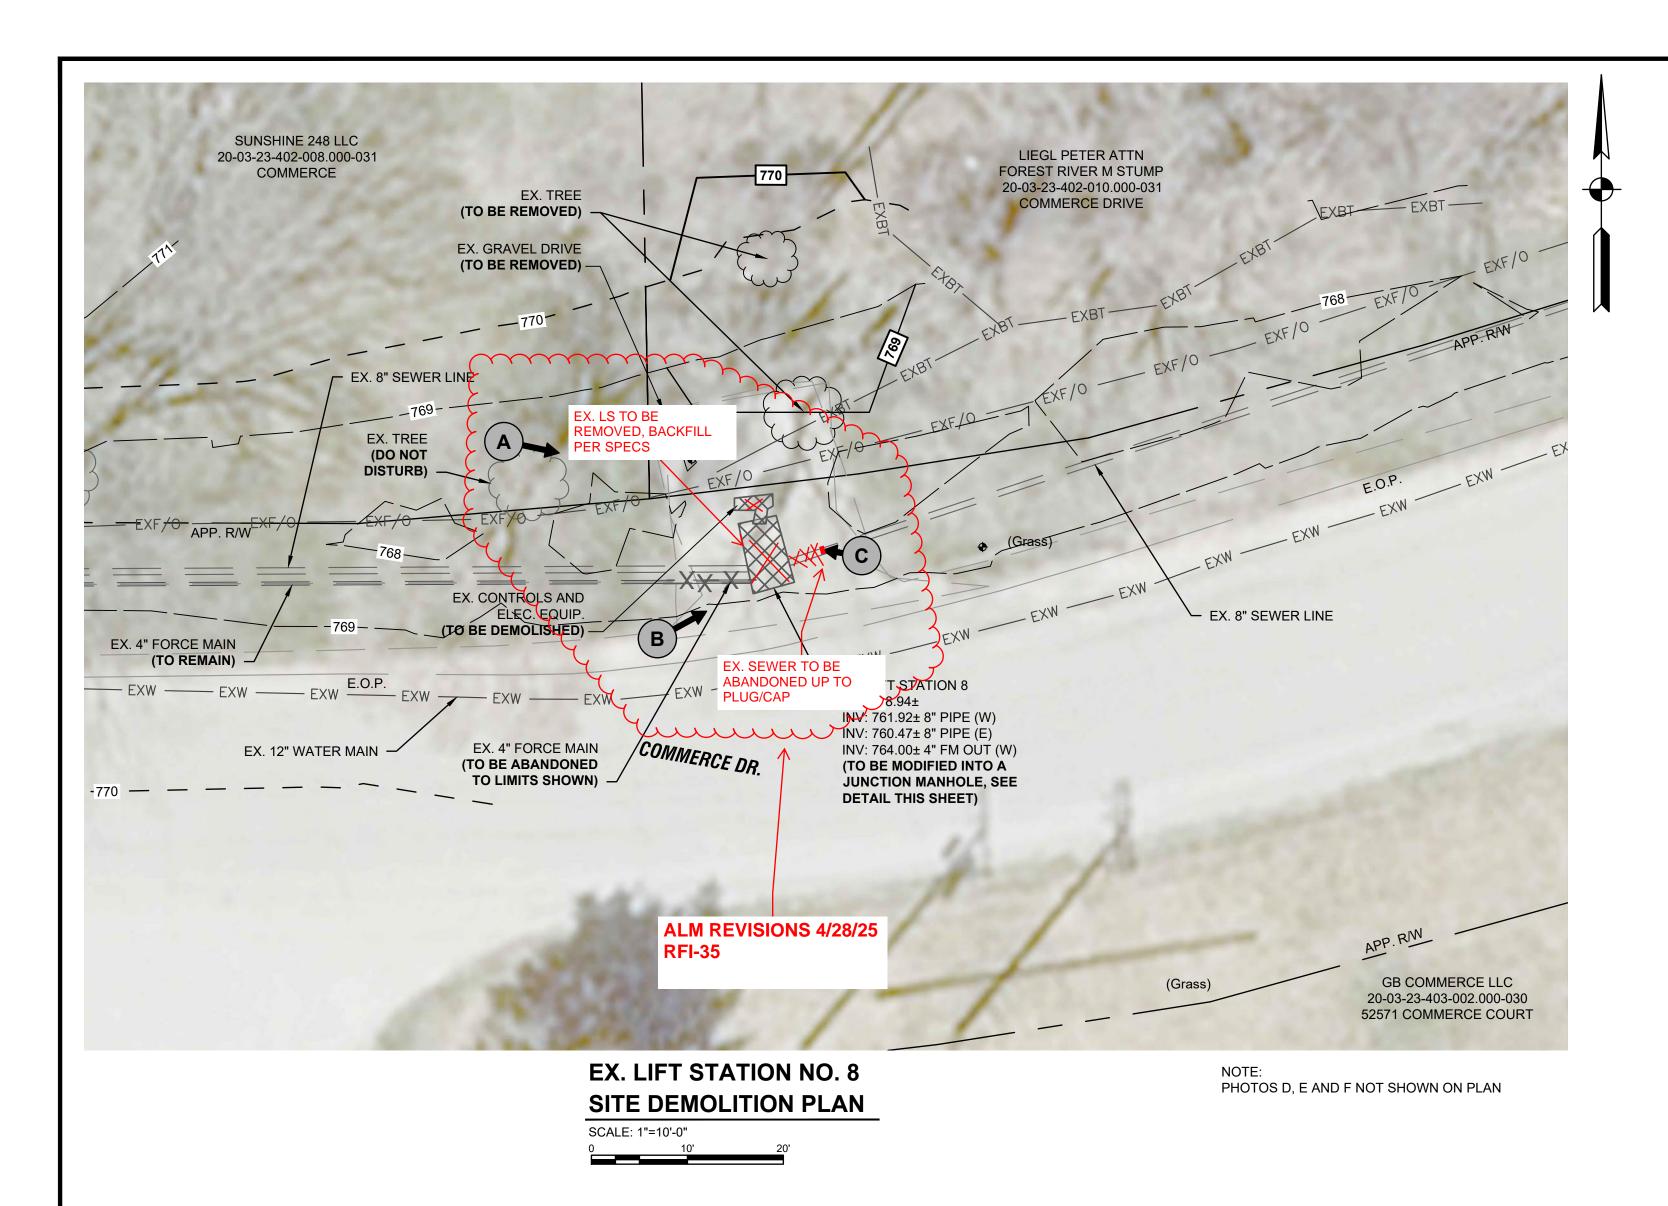

MODIFICATION OF EX. WET WELL TO JUNCTION MANHOLE

NOT TO SCALE

NOTES:

- 1. THE STRUCTURE SHALL BE CLEANED WITH A POWER WASHER AND ALL MATERIAL AND LIQUID REMOVED BEFORE DEMOLITION.
- 2. CONTRACTOR TO FIELD VERIFY EXISTING **DIMENSIONS, ELEVATIONS, AND INTERIOR**

EQUIPMENT OF STRUCTURE.

- 3. OWNER HAS FIRST RIGHT OF REFUSAL OF ALL REGARDING ITEM(S) TO BE REMOVED AND DELIVERED TO OWNER'S DESIGNATED LOCATION
- 4. REFER TO ELEC. DRAWINGS FOR ADDITIONAL REMOVAL REQUIREMENTS

MANDATORY ALTERNATES

- MA1 LIFT STATION 1 REPLACEMENT
- MA2 LIFT STATION 3 REPLACEMENT
- MA3 LIFT STATION 8 REPLACEMENT
- MA4 LIFT STATION 10 UPGRADES

MA5 - LIFT STATIONS SYSTEM-WIDE SCADA



LIFTSTATION 8 SITE (LOOKING EAST) **PHOTO** NOT TO SCALE



LIFT STATION 8 (LOOKING NE) **PHOTO** NOT TO SCALE



(LOOKING WEST) **PHOTO** NOT TO SCALE



LIFT STATION 8 WET WELL (INTERIOR) **PHOTO** NOT TO SCALE



LIFT STATION 8 WET WELL (INTERIOR) **PHOTO** NOT TO SCALE



LIFT STATION 8 VALVE VAULT (INTERIOR) **PHOTO**

NOT TO SCALE

LEGEND:



INDICATES PHOTO NUMBER AND DIRECTION OF PHOTO (PHOTOS TAKEN BY COMMONWEALTH ENGINEERS, INC. AT **VARIOUS SITE VISITS FROM SEPTEMBER 2022 TO JANUARY 2023)**

CONFORMED SET




© 2023 ВУ СОММ	ENGINEERS, INC	BY ANY METHO	OR IN PART WIT			<u> </u>	3 3 3		-	Know what's below. 8	1-800-38	
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By												
Submittal / Revision												
No.												
Designed By: DSW			Dr	awr JA	n By J	/ :	C	he	cke AR	d B	y:	
		Dat '202		Project No: Scale S22145 AS SHO							N	

D9-05

EXISTING LIFT STATION

NO 8. SITE DEMOLITION PLAN (MA3)

Sheet: **74** OF 216

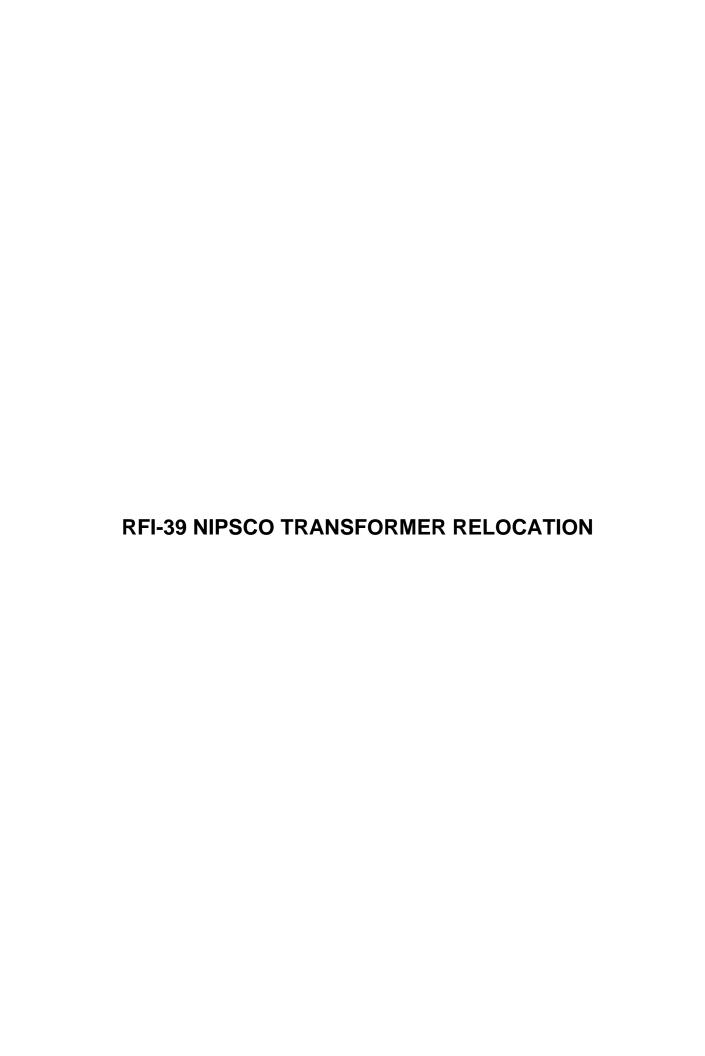



Commonwealth Engineers 7256 Company Drive Indianapolis, Indiana 46237 P: (317) 888-1177 F: (317) 887-8641 Project: S22145 Bristol - Wastewater Treatment Plant Improvements

Russell Jacobs (Robert E. Crosby)

2805 Freeman Street?Fort Wayne

Fort Watne, Indiana 46802

Bristol, Indiana 46507

RFI #RFI-39: NIPSCO Transformer relocation

From

Status Closed on 06/02/25

To Jack Sizemore (Commonwealth Engineers Inc.

(Indy)) (Response Required)

Darren Wells (Commonwealth Engineers, Inc. - North) (Response Required)
Steve Dugan (Commonwealth Engineers Inc.

(Indy))

Amy Mendoza (Commonwealth Engineers Inc.

(CP))

Date Initiated May 19, 2025 Due Date May 26, 2025

Location Project Stage Course of Construction

Cost Impact \$27,029.25 Schedule Impact No.

Spec Section Cost Code

Drawing Number Reference

Linked Drawings

Received From Russell Jacobs (Robert E. Crosby)

Copies To Jeff Carlson (Commonwealth Engineers, Inc. -

North), Baylee Girdham (Commonwealth Engineers Inc. - South Bend), Russell Jacobs (Robert E. Crosby), Zack Lambert (Commonwealth Engineers Inc. (CP)), Dan Lauer (Robert E. Crosby), Chris Markley (Robert E. Crosby), Mike Mattingly (Robert E. Crosby), Amy Mendoza (Commonwealth Engineers Inc. (CP)), Luke Parrish (Robert E. Crosby), Cody Powers (Commonwealth Engineers Inc. - South Bend), Robert Market

Engineers Inc. (Indy)), Darren Wells (Commonwealth Engineers, Inc. - North)

Activity

Question

Question from Russell Jacobs Robert E. Crosby on Monday, May 19, 2025 at 12:22 PM EDT

Please find attached costs associated with relocating NIPSCO's electrical transformer

Attachments

Transformer relocate NIPSCO.pdf

Official Response

Response from Amy Mendoza Commonwealth Engineers Inc. (CP) on Monday, Jun 2, 2025 at 11:15 AM EDT

We have reviewed this item with the Owner and plan to incorporate it into the next combined change order.

Official Response

Response from Jack Sizemore Commonwealth Engineers Inc. (Indy) on Wednesday, May 28, 2025 at 08:06 AM EDT

 $Commonweal th\ acknowledges\ and\ approves\ the\ costs\ associated\ with\ relocating\ NIPSCO's\ transformer.$

All Replies Response from Amy Mendoza Commonwealth Engineers Inc. (CP) on Monday, Jun 2, 2025 at 11:15 AM EDT

We have reviewed this item with the Owner and plan to incorporate it into the next combined change order.

Response from Jack Sizemore Commonwealth Engineers Inc. (Indy) on Wednesday, May 28, 2025 at 08:06 AM EDT Commonwealth acknowledges and approves the costs associated with relocating NIPSCO's transformer.

	Description: Relocated Transformer Per NIPSCO Job: 24105																	
Description	Qnty.	В	Н	L	TOT.	UM	Crew	MH	UM	UPL	Labor	UPM	Materials	UP JE	Job Exp.	UPS	Subcontracts	Totals
Project Manager										\$ 225	0							0
Site Supervision / As-Builts										\$ 125	0							0
Layout / As-Builts											0							0
Tools / Equipment											0							0
Dumpster / Cleanup											0							0
Mobilization											0							0
Temp. Utilities / Fuel											0							0
Winter Protection											0							0
Testing											0							0
											0		0					0
Trench Excavation		3'	2'	70'			LO	16	5	\$ 95.00	1520		0		750			2270
Electrical											0		0				23015	23015
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Subtotal											1520		0		750		23015	25285
Sucontractor Bond														-		0	0	0
Sales Tax (If YES, Tax General Condition	ns ONLY)									Ta	x Exempt (YF	ES or NO):	YES		>	7%	0	0
Project Insurance																0	0	0
Builders Risk																	0	0
Job Bond																1%	253	253
Architectural																0%	0	0
Sub Total											1520		0		750	-	23268	25538
OverHead & Profit															&M Columns		341	341
OverHead & Profit														Subcontr	actor Column	5%	1151	1151
Total Job											1520		0		750		24759	\$27,029.25




RE Crosby Fort Wayne, In 5.7.2025

Job: Bristol XFMR Re-locate

We are pleased to submit the following bid for the above-described job. Our number includes all needed labor and material for the following items.

- After meeting with NIPSCO on site and reviewing transformer location on the drawings and the
 location of future structures. NIPSCO indicated due to primary routing and accessibility they do not
 want the transformer located as shown on the drawings they would like to relocate it to the
 location shown below. This will add length to our secondary feeders.
- Added cost for extending permanent feed to new transformer location on the west side of the building per NIPSCOs requirement.
- Includes added cost for extending the conduit and wire. (3) sets of 4 wire 500MCM in 4" PVC conduit

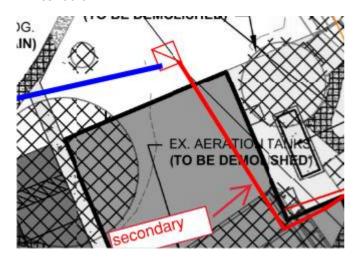

Excludes: Excavation

Labor: \$5,450.00 Materials: \$17,565.00 Total: \$23,015.00